

NOTES:

- 1. REFER TO GRADING PLAN, SHEET C-07 OF WINKELMANN & ASSOCIATES, INC. PLANS FOR TOP OF WALL (T/W) ELEVATIONS. T/W ELEVATIONS CORRESPOND TO TOP OF PILES AND REINFORCED SHOTCRETE FACING (I.E., NOT INCLUDING STONE CAP THICKNESS).
- 2. BOTTOM OF WALL (B/W) ELEVATIONS SHOWN ON THIS PROFILE ARE 1.5' TYP. BELOW BW ELEV'S INDICATED ON WINKELMANN DRAWINGS IN ORDER TO PROVIDE MINIMUM EMBEDMENT BELOW FINISHED GRADE.
- 3. BOTTOM OF WALL (B/W) ELEVATIONS ARE APPROXIMATE AND SHALL BE FIELD ADJUSTED AS REQUIRED TO PROVIDE 1.5' MINIMUM EMBEDMENT BELOW EXISTING GRADE.

2	RETAINING	WALL	PROFILE	
4 5				Scale: 1" = 20'

SOLDIER PILE SCHEDULE													
I DIE NOS I		E LENGTH PILE SECTION	PILE SPACING (FT)	UPPER TIEBACKS			LOWER TIEBACKS						
	PILE LENGTH (FT)			X1 (FT)	BAR	MIN. UNBONDED (FT)	MIN. BONDED (FT)	DESIGN LOAD (KIPS)	X2 (FT)	BAR	MIN. UNBONDED (FT)	MIN. BONDED (FT)	DESIGN LOAD (KIPS)
1 - 8, 36	15	W12 X 22	8.0		:								
9-10, 35	20	W12 X 26	8.0	-									
11-12, 34	25	W12 X 45	8.0										
31-33	25	DBL C12 X 20.7	8.0	6.0	1-1/4"	15	30	45					
13, 29-30	30	DBL C12 X 20.7	8.0	6.0	1-1/4"	15	35	54					
14, 26-28	35	DBL C12 X 20.7	8.0	6.0	1-1/4"	15	45	68					
15-25	40	DBL C12 X 20.7	8.0	6.0	1-1/4"	15	43	65	15.0	1-1/4"	10	35	52

AS BUIL

TO THE BEST OF HAYWARD BAKER'S BELIEF AND KNOWLEDGE THE AS-BUILT CONDITIONS SHOWN ON THIS DRAWING CONSTITUTE AN ACCURATE AND COMPLETE DEPICTION OF THE MANNER IN WHICH THIS PORTION OF WORK WAS ACTUALLY INSTALLED.

FOR CONSTRUCTION



HAYWARD BAKER

Geotechnical Constructi TEXAS FIRM REGISTRATION NO. F-13273

OLDEN

Craig Olden Division

KELLER

- CONSTRUCTION
- ENGINEERING
- DESIGN / BUILD

661 E SHAHAN PRAIRIE RD LITTLE ELM, TEXAS 75068 TEL (972) 294-5000 FAX (972) 294-2664

ANCHORED SOLDIER PILE WALL REMEDIATION SWC HORIZON RD & RIDGE RD (FM 740) ROCKWALL, TEXAS 07464 STORE NO. CVS

© 2014 HAYWARD BAKER, INC.

The design concepts included hereon are the copyrighted property of Hayward Baker, Inc. Disclosure, copying or distribution of all or part of the concepts contained on this drawing is strictly prohibited without the express written consent of Hayward Baker,

DESIGNED BY: HB

CHECKED BY: CHECK

DRAWN BY:

SCALE:


PROJECT NO: OP9173

DATE:

WALL **PROFILE**

NOV 2014

RW 1.1

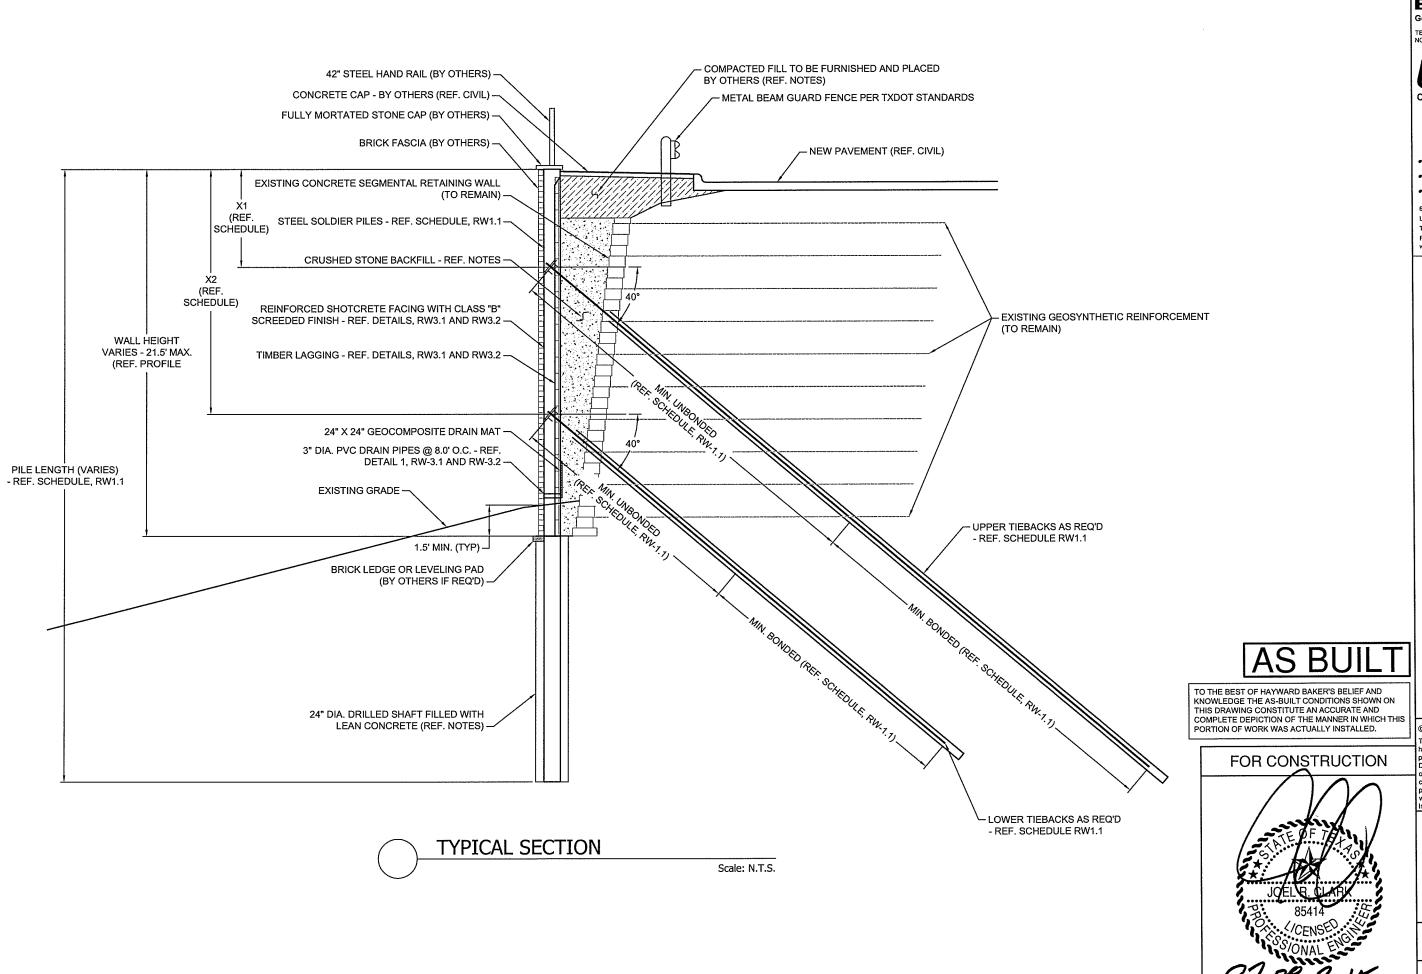

HAYWARD BAKER

TEXAS FIRM REGISTRATION NO. F-13273



Craig Olden Division

KELLER

- CONSTRUCTION
- ENGINEERING
- DESIGN / BUILD

661 E SHAHAN PRAIRIE RD LITTLE ELM, TEXAS 75068 TEL (972) 294-5000 FAX (972) 294-2664

TEL (972) 294-5000 FAX (972) 294-2664 www.craigoldeninc.com

CVS STORE NO. 07464 ANCHORED SOLDIER PILE WALL REMEDIATION SWC HORIZON RD & RIDGE RD (FM 740) ROCKWALL, TEXAS

© 2014 HAYWARD BAKER, INC

The design concepts included hereon are the copyrighted property of Hayward Baker, Inc. Disclosure, copying or distribution of all or part of the concepts contained on this drawing is strictly prohibited without the express written consent of Hayward Baker,

DESIGNED BY: HB

CHECKED BY: CHECK

DRAWN BY: HB

SCALE: SHOWN


PROJECT NO: OP9173


DATE: NOV 2014

TYPICAL

SECTION RW 2.0


SHEET NO.

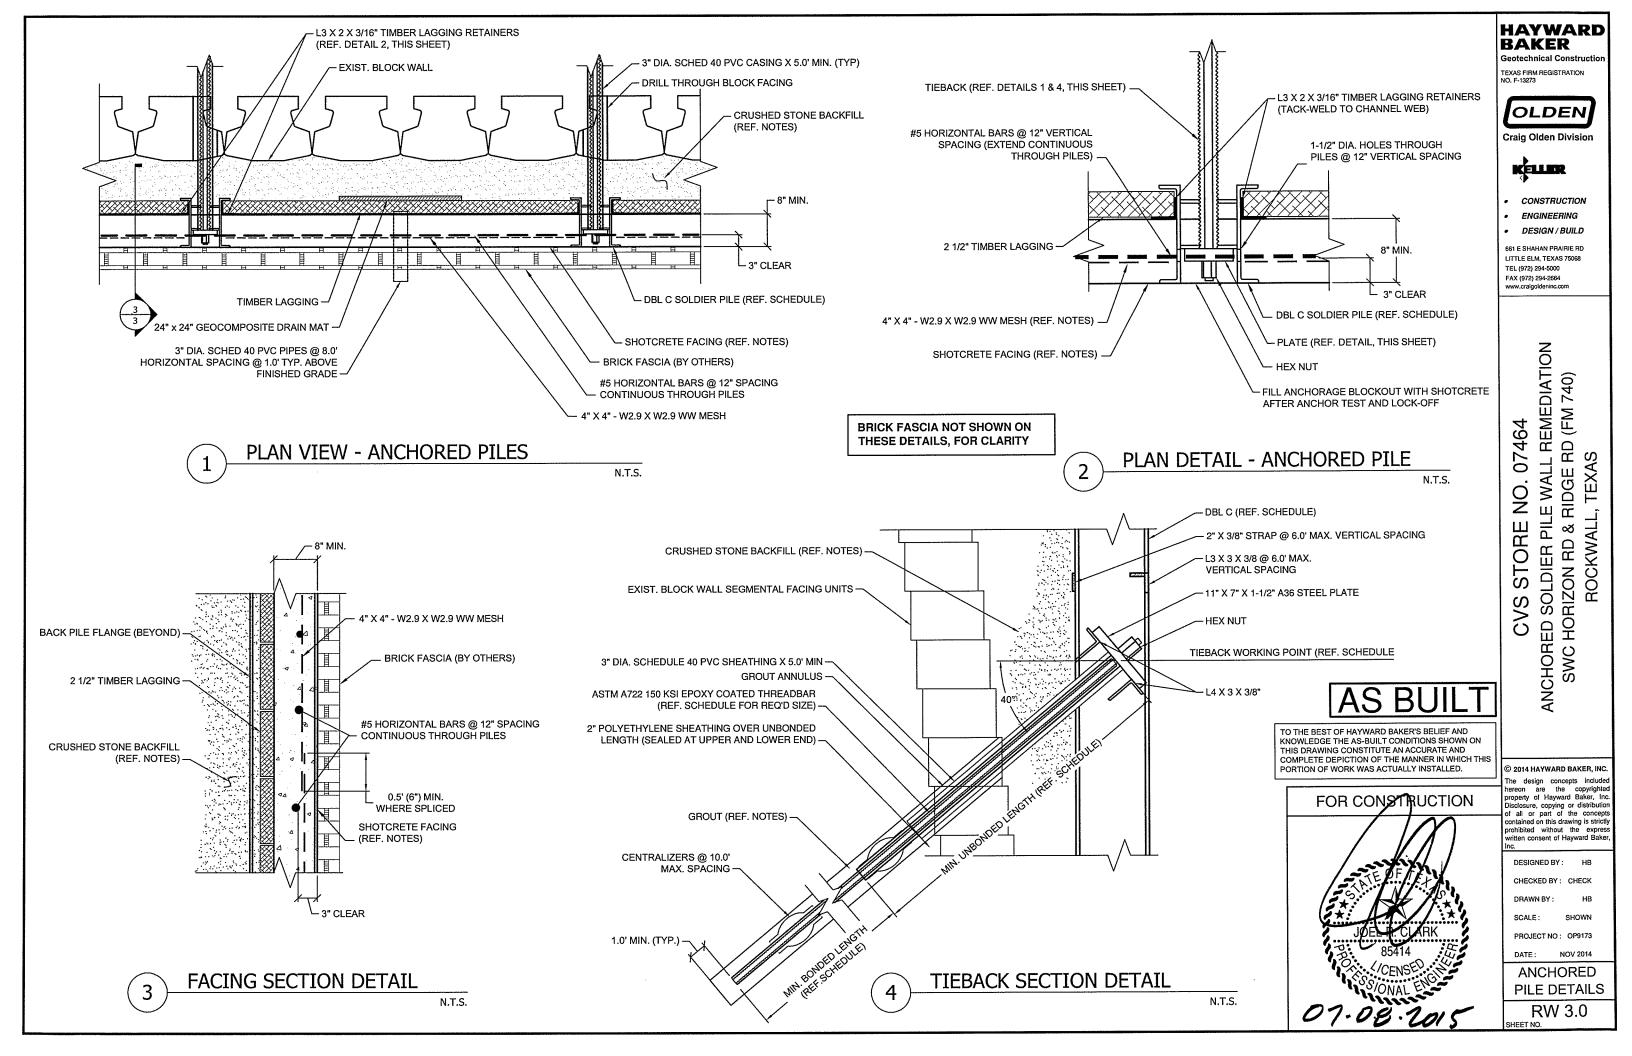

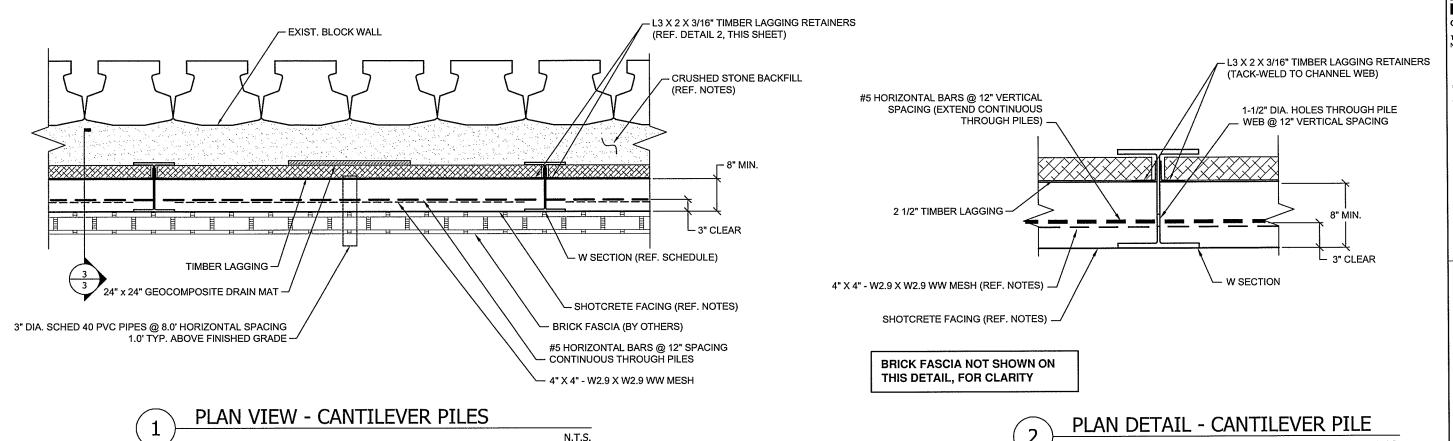

4" X 4" - W2.9 X W2.9 WW MESH BACK PILE FLANGE (BEYOND) BRICK FASCIA (BY OTHERS) 2 1/2" TIMBER LAGGING -#5 HORIZONTAL BARS @ 12" SPACING CONTINUOUS THROUGH PILES CRUSHED STONE BACKFILL (REF. NOTES) 0.5' (6") MIN. WHERE SPLICED SHOTCRETE FACING (REF. NOTES) └─ 3" CLEAR

> **FACING SECTION DETAIL** N.T.S.

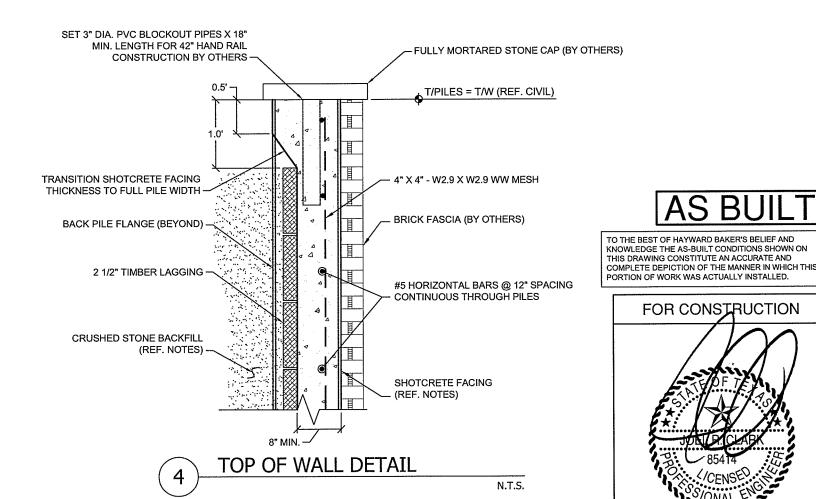

HAYWARD **BAKER**

Geotechnical Constructi TEXAS FIRM REGISTRATION NO. F-13273

OLDEN

Craig Olden Division

KELLER

CONSTRUCTION

ENGINEERING

DESIGN / BUILD

661 E SHAHAN PRAIRIE RD LITTLE ELM, TEXAS 75068 TEL (972) 294-5000 FAX (972) 294-2664

LE WALL REMEDIATION RIDGE RD (FM 740) 07464 ROCKWALL, TEXAS STORE NO. ANCHORED SOLDIER PIL SWC HORIZON RD & CVS

N.T.S.

AS BU

FOR CONSTRUCTION

© 2014 HAYWARD BAKER, INC

The design concepts include hereon are the copyrighted property of Hayward Baker, Inc. Disclosure, copying or distribution of all or part of the concepts ontained on this drawing is strictly rohibited without the express tritten consent of Hayward Baker

DESIGNED BY: HB

CHECKED BY: CHECK DRAWN BY

SCALE:

PROJECT NO: OP9173

NOV 2014 DATE: **CANTILEVER**

PILE DETAILS

RW 3.2

NOTES:

GENERAL

- 1. THE PURPOSE OF THIS SHOP DRAWING IS TO DETAIL THE PROPOSED ANCHORED SOLDIER PILE WALL REMEDIATION AT CVS STORE NO. 07464, ROCKWALL, TEXAS. REFER TO APPROVED PLANS FOR ALL OTHER INFORMATION.
- 2. LOCATIONS OF ALL UTILITIES SHALL BE FIELD VERIFIED PRIOR TO COMMENCEMENT OF CONSTRUCTION. ANY CONFLICTS WITH THE PROPOSED WORK SHALL BE RESOLVED UNDER THE DIRECTION OF THE DESIGN ENGINEER.

SOLDIER PILES

- 1. SOLDIER PILES SHALL BE FABRICATED FROM HOT-ROLLED STEEL W AND C SECTIONS CONFORMING TO ASTM A572, GRADE 50.
- 2. SOLDIER SHAFTS SHALL BE FILLED WITH A 2-SACK/CY LEAN CONCRETE/FLOWABLE FILL.
- 3. STEEL REINFORCEMENT SHALL CONFORM TO ASTM A615, GRADE 60.
- 4. ALL REINFORCEMENT LAP SPLICES SHALL BE ACI CLASS "B" TENSION LAP SPLICES.
- 5. WELDED WIRE FABRIC REINFORCEMENT SHALL CONFORM TO ASTM A185 (Fy = 65,000 PSI).
- 6. GEOCOMPOSITE DRAIN MATERIAL SHALL BE TERRADRAIN OR EQUAL.
- 7. ALL WELDING FOR SOLDIER PILE FABRICATION SHALL CONFORM TO AWS CODE USING E70 ELECTRODES.

SHOTCRETE

- 1. SOLDIER PILE WALL FACING SHALL CONSIST OF PNEUMATICALLY PLACED CONCRETE USING THE WET-MIX PROCESS.
- 2. SHOTCRETE SHALL ACHIEVE A MINIMUM 28-DAY COMPRESSIVE STRENGTH OF 4000 PSI.

TIEBACKS

- 1. TIEBACK BARS SHALL CONFORM TO ASTM A722, GRADE 150 AS MANUFACTURED BY DYWIDAG SYSTEMS INTERNATIONAL OR WILLIAMS FORM ENGINEERING.
- 2. TIEBACK BARS SHALL HAVE AN ELECTROSTATICALLY APPLIED EPOXY COATING CONFORMING TO ASTM A775.
- 3. HEX NUTS SHALL BE CAPABLE OF DEVELOPING 100% OF THE MINIMUM GUARANTEED ULTIMATE TENSILE STRENGTH OF THE BAR.
- 4. GROUT SHALL BE NEAT CEMENT AND SHALL ACHIEVE A MINIMUM 3-DAY COMPRESSIVE STRENGTH OF 1,500 PSI AND A MINIMUM 28-DAY COMPRESSIVE STRENGTH OF 4,000 PSI (ASTM C109).
- 5. TIEBACKS SHALL BE PROOF TESTED TO 133% OF THE DESIGN LOAD IN ACCORDANCE WITH FHWA-IF-99-015.

EARTHWORK

- CRUSHED STONE BACKFILL BETWEEN SOLDIER PILE WALL AND EXISTING SEGMENTAL CONCRETE BLOCK WALL SHALL BE ASTM, C33 SIZE 67 (1-1/2" MINUS).
- 2. WHERE EXISTING SEGMENTAL CONCRETE BLOCK WALL IS BEING DEMOLISHED AND REMOVED, 18 INCHES MINIMUM CRUSHED STONE BACKFILL SHALL BE INSTALLED BEHIND THE SOLDIER PILE WALL WITH THE REMAINING BACKFILL BEING COMPRISED OF SUITABLE SITE-EXCAVATED SOILS OR IMPORTED FILL MATERIAL AS NECESSARY.
- 3. COMPACTED FILL MATERIAL ABOVE EXISTING RETAINING WALL AND BELOW PROPOSED CONCRETE CAP AND PAVEMENT SHALL BE FURNISHED AND PLACED BY OTHERS IN ACCORDANCE WITH PROJECT GEOTECHNICAL RECOMMENDATIONS.
- 4. ONLY HAND-OPERATED COMPACTION EQUIPMENT SHALL BE ALLOWED WITHIN 5.0 FEET OF BACK OF SOLDIER PILE RETAINING WALL.

HAYWARD BAKER

TEXAS FIRM REGISTRATION
NO. F-13273



raig Olden Divisio

KELLER


- CONSTRUCTION
- ENGINEERING
- DESIGN / BUILD

661 E SHAHAN PRAIRIE RD LITTLE ELM, TEXAS 75068 TEL (972) 294-5000 FAX (972) 294-2664 www.craigoldeninc.com

CVS STORE NO. 07464
ANCHORED SOLDIER PILE WALL REMEDIATION
SWC HORIZON RD & RIDGE RD (FM 740)

AS BUILT

TO THE BEST OF HAYWARD BAKER'S BELIEF AND KNOWLEDGE THE AS-BUILT CONDITIONS SHOWN ON THIS DRAWING CONSTITUTE AN ACCURATE AND COMPLETE DEPICTION OF THE MANNER IN WHICH THIS PORTION OF WORK WAS ACTUALLY INSTALLED.

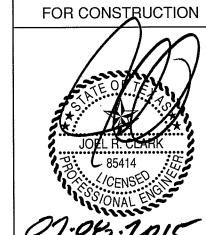

© 2014 HAYWARD BAKER, INC

The design concepts included hereon are the copyrighted property of Hayward Baker, Inc. Disclosure, copying or distribution of all or part of the concepts contained on this drawing is strictly prohibited without the express written consent of Hayward Baker, Inc.

DESIGNED BY: HB

CHECKED BY: CHECK

SCALE: SHOWN

•

PROJECT NO: OP9173

WALL

NOV 2014

NOTES RW 4.0

SHEET NO.

DATE: