
CONSTRUCTION PLANS FOR

LA JOLLA POINTE, PHASE 2, LOT 15, BLOCK A 550 EAST INTERSTATE 30 AN ADDITION TO CITY OF ROCKWALL, TEXAS

DRAWING INDEX

	PLAT				
SP	SITE PLAN				
C1	EXISTING TOPOGRAPHY				
C2	PAVING PLAN				
C3	GRADING PLAN				
C4	Drainage Area Map				
C5	UTILITY PLAN				
C6	EROSION CONTROL PLAN				
C7	DETAILS (PRIVATE)				

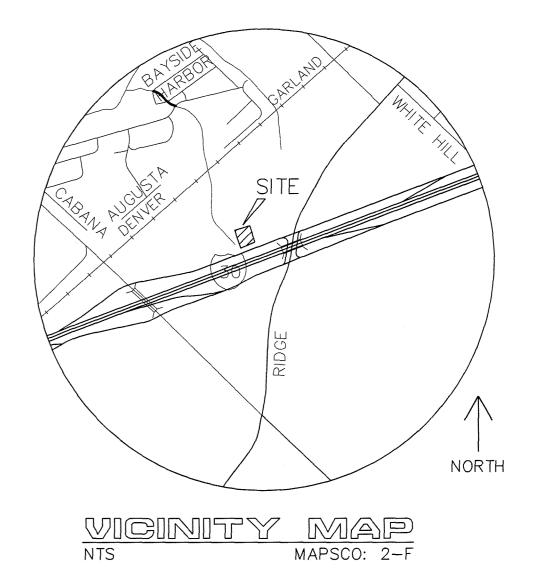




THESE PLANS HAVE BEEN REVISED TO CONFORM WITH CONSTRUCTION RECORDS PROVIDED BY CONTRACTOR.

> CUMULUS DESIGN, INC. P.O. BOX 2119 EULESS, TEXAS 76039 PH: 214-235-0367 CONTACT: PAUL CRAGUN


ROCKWALL MUSHROOM LLC 4739 MARINER DRIVE FRISCO, TEXAS 75034 PHONE: 214-783-5405 EMAIL: PAUL@CUMULUSDESIGN.NET EMAIL: JAUBUCHON@PREMIER-US.NET




		REVISIONS
REV NO.	DATE	DESCRIPTION
\triangle	06/18/2013	MINOR SITE REVISIONS
2	06/22/2013	MINOR SITE REVISIONS

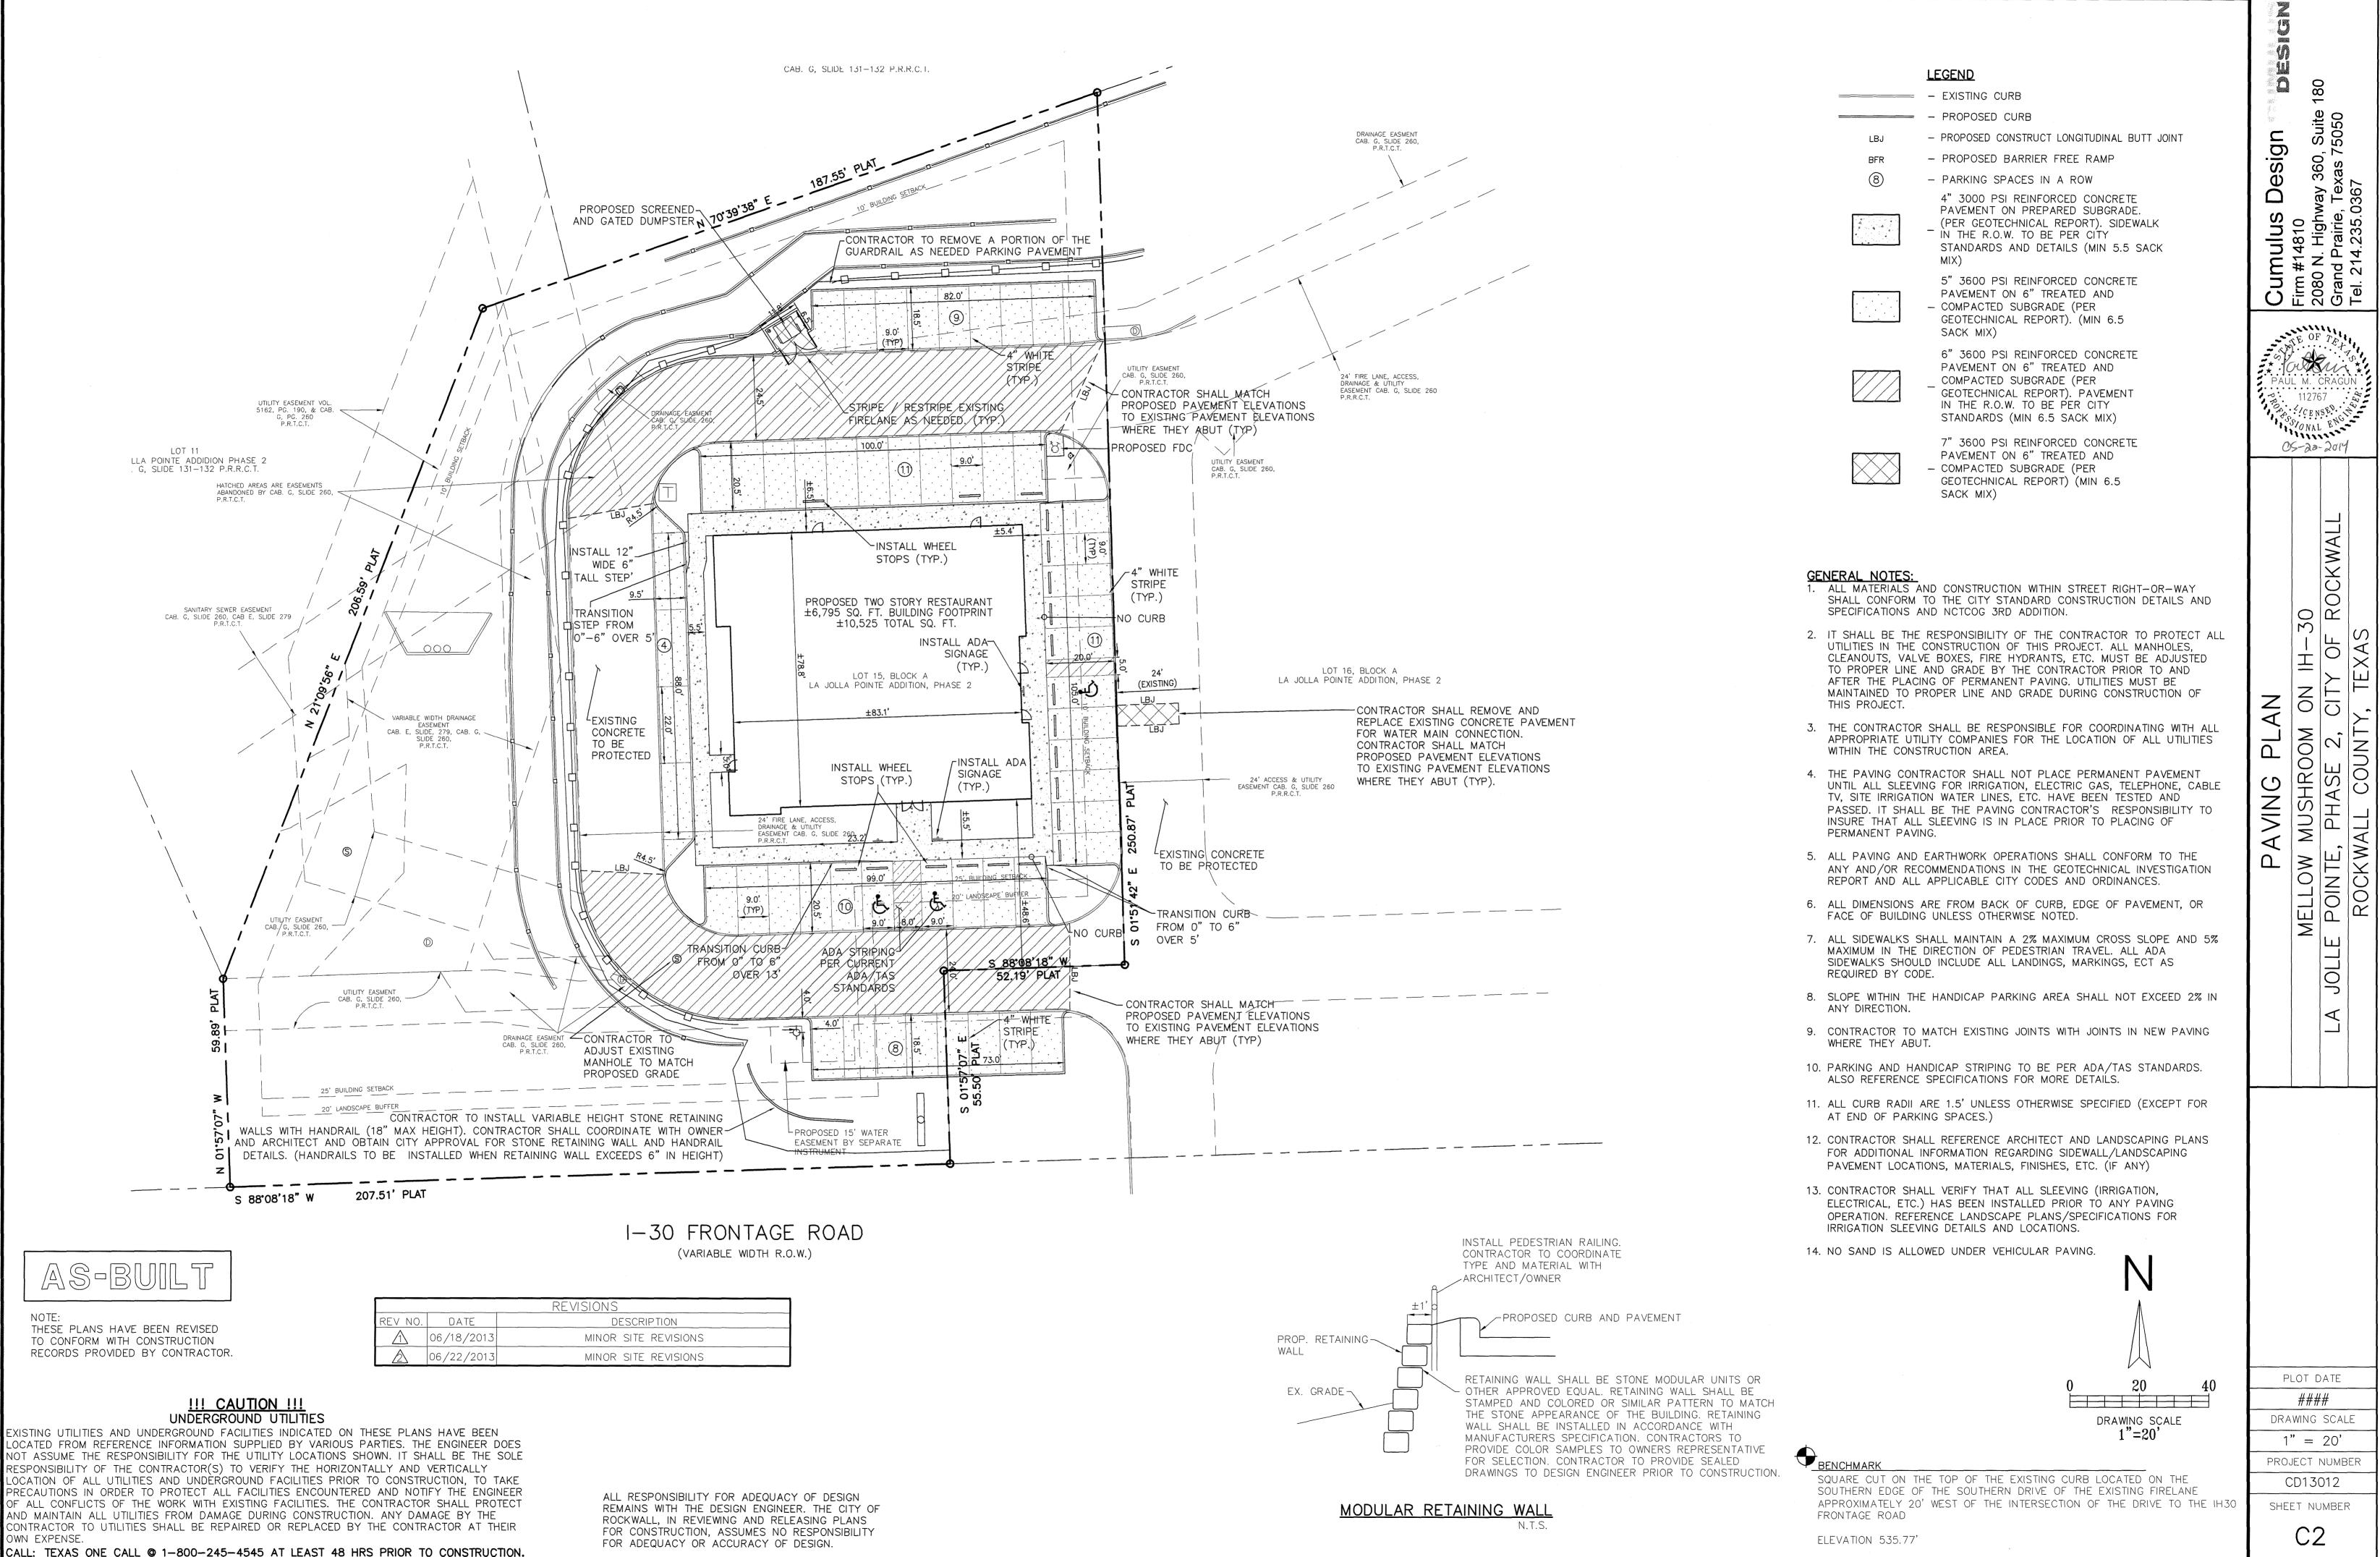

\\SERVER-PC\SERVER\2013 PROJECTS\CD13012 - MELLOW MUSHROOM IN ROCKWALL\PLANS\PAVING PLAN CD13012.DWG

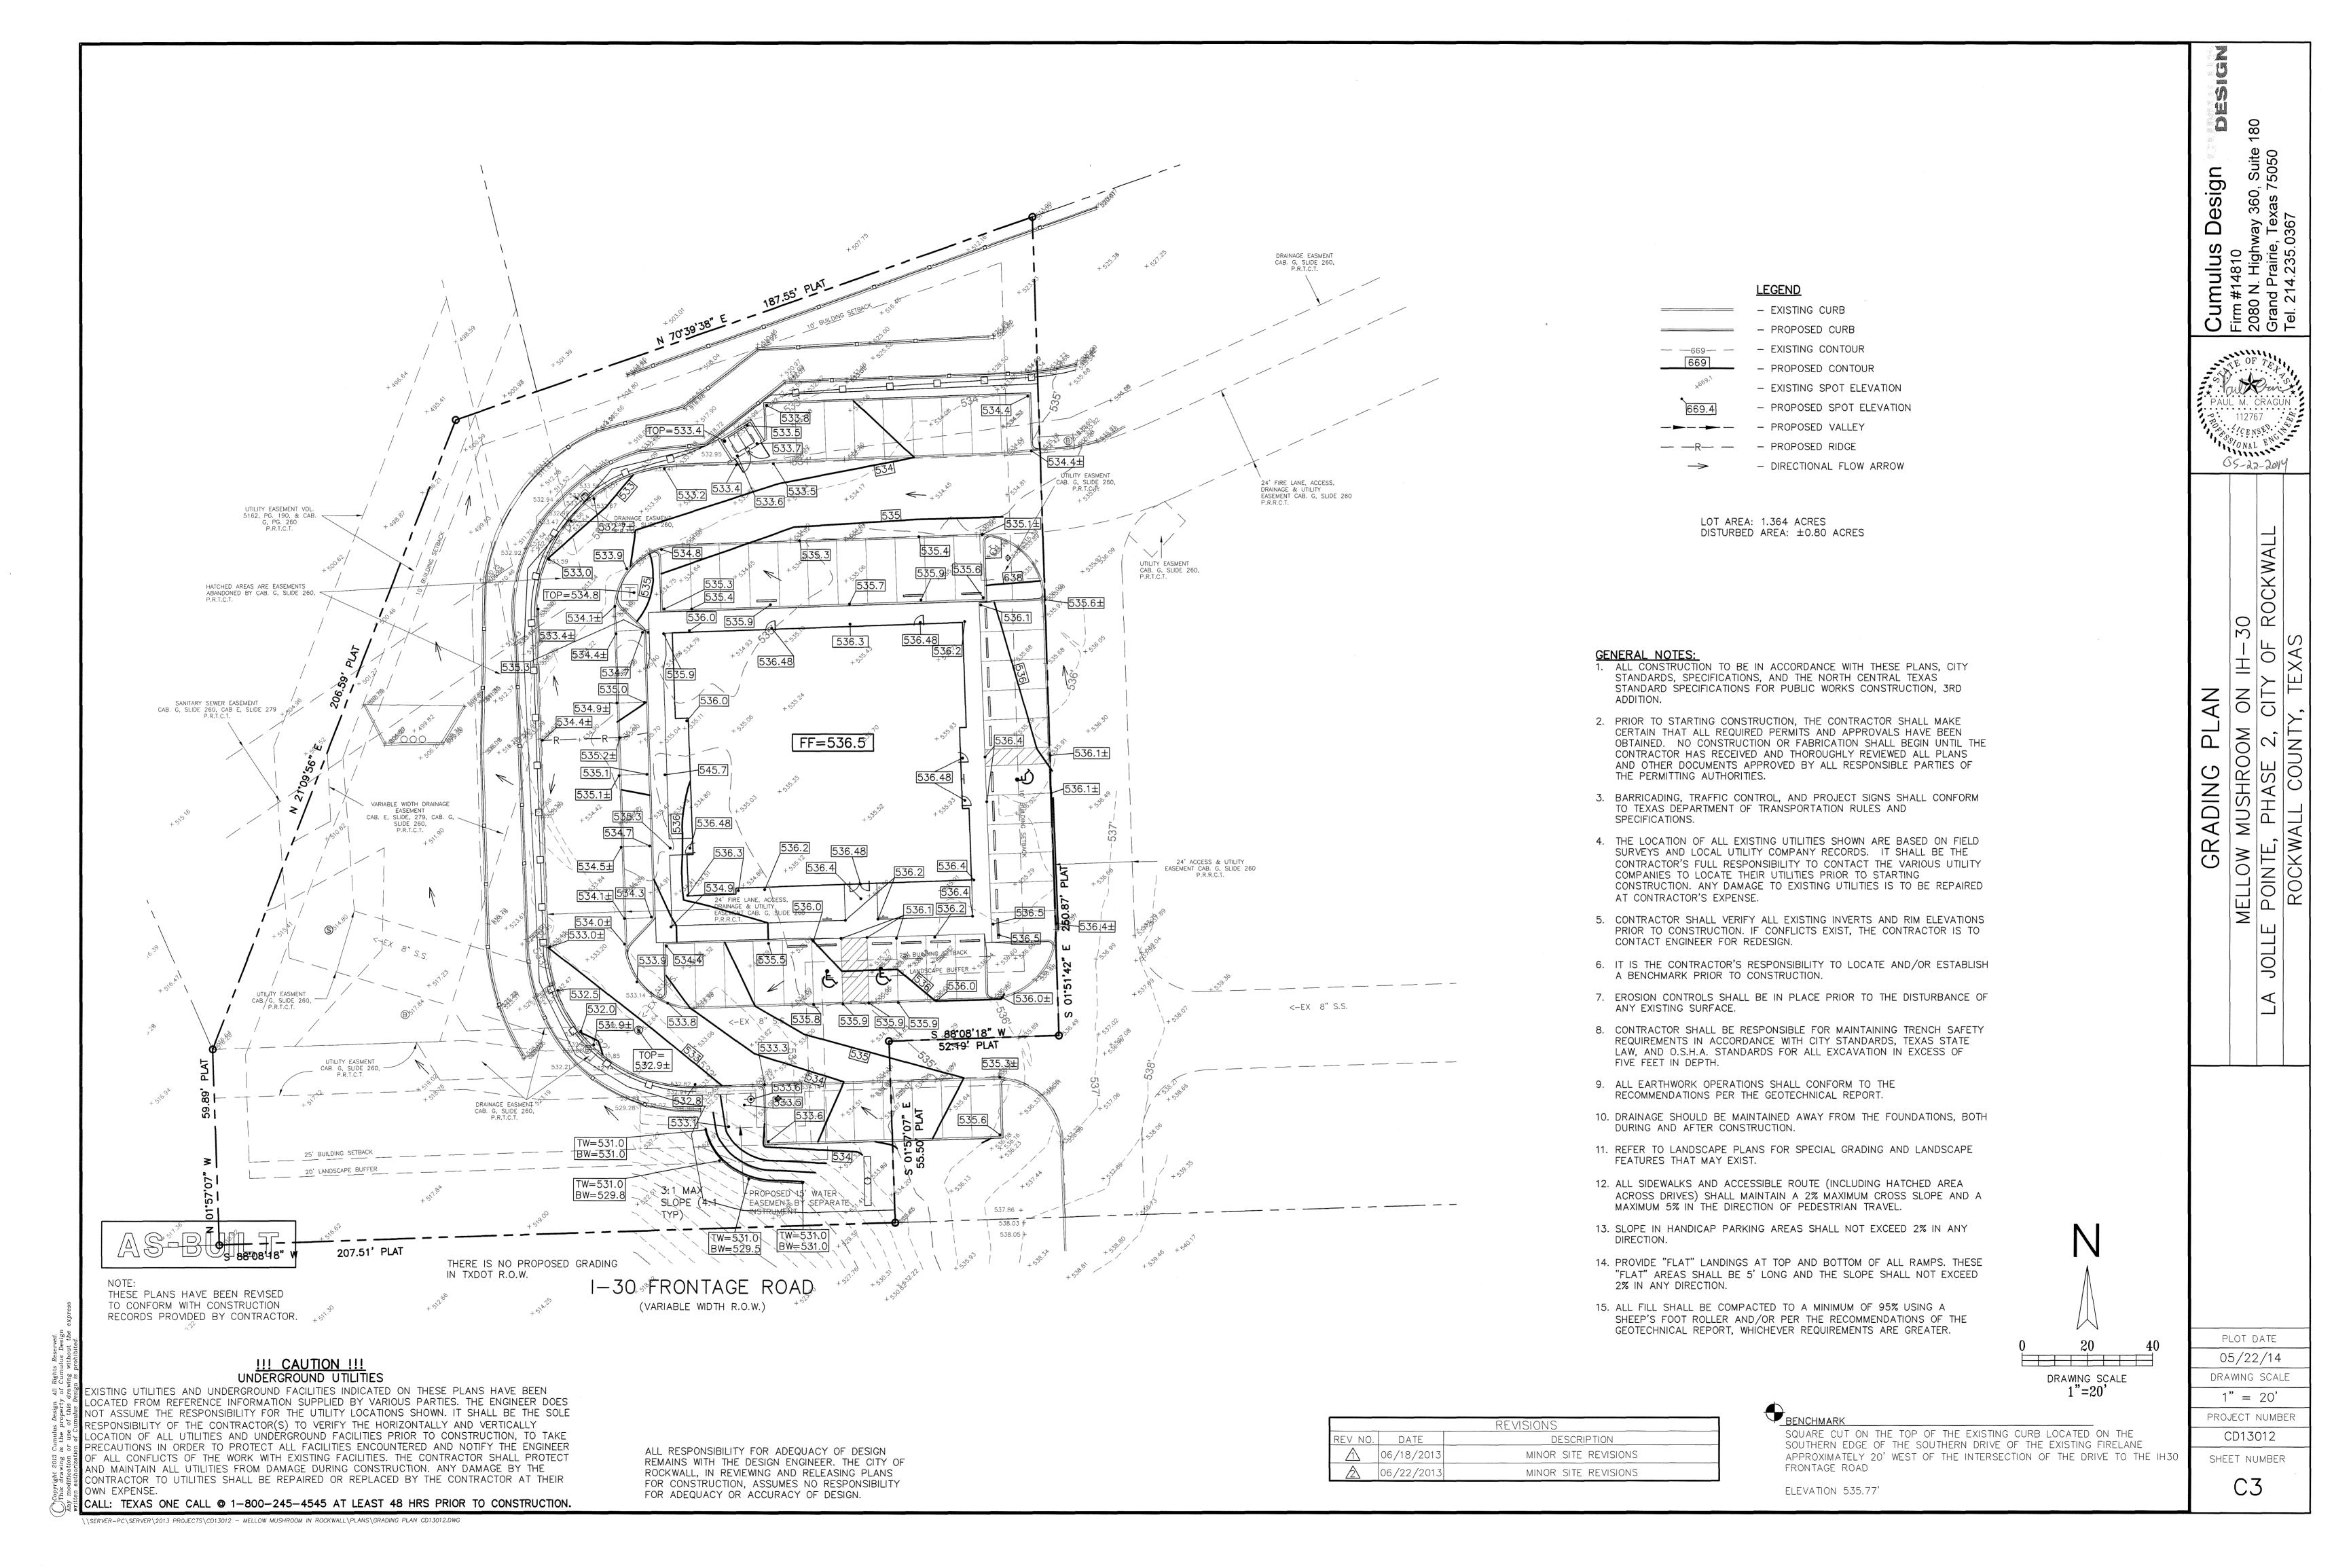

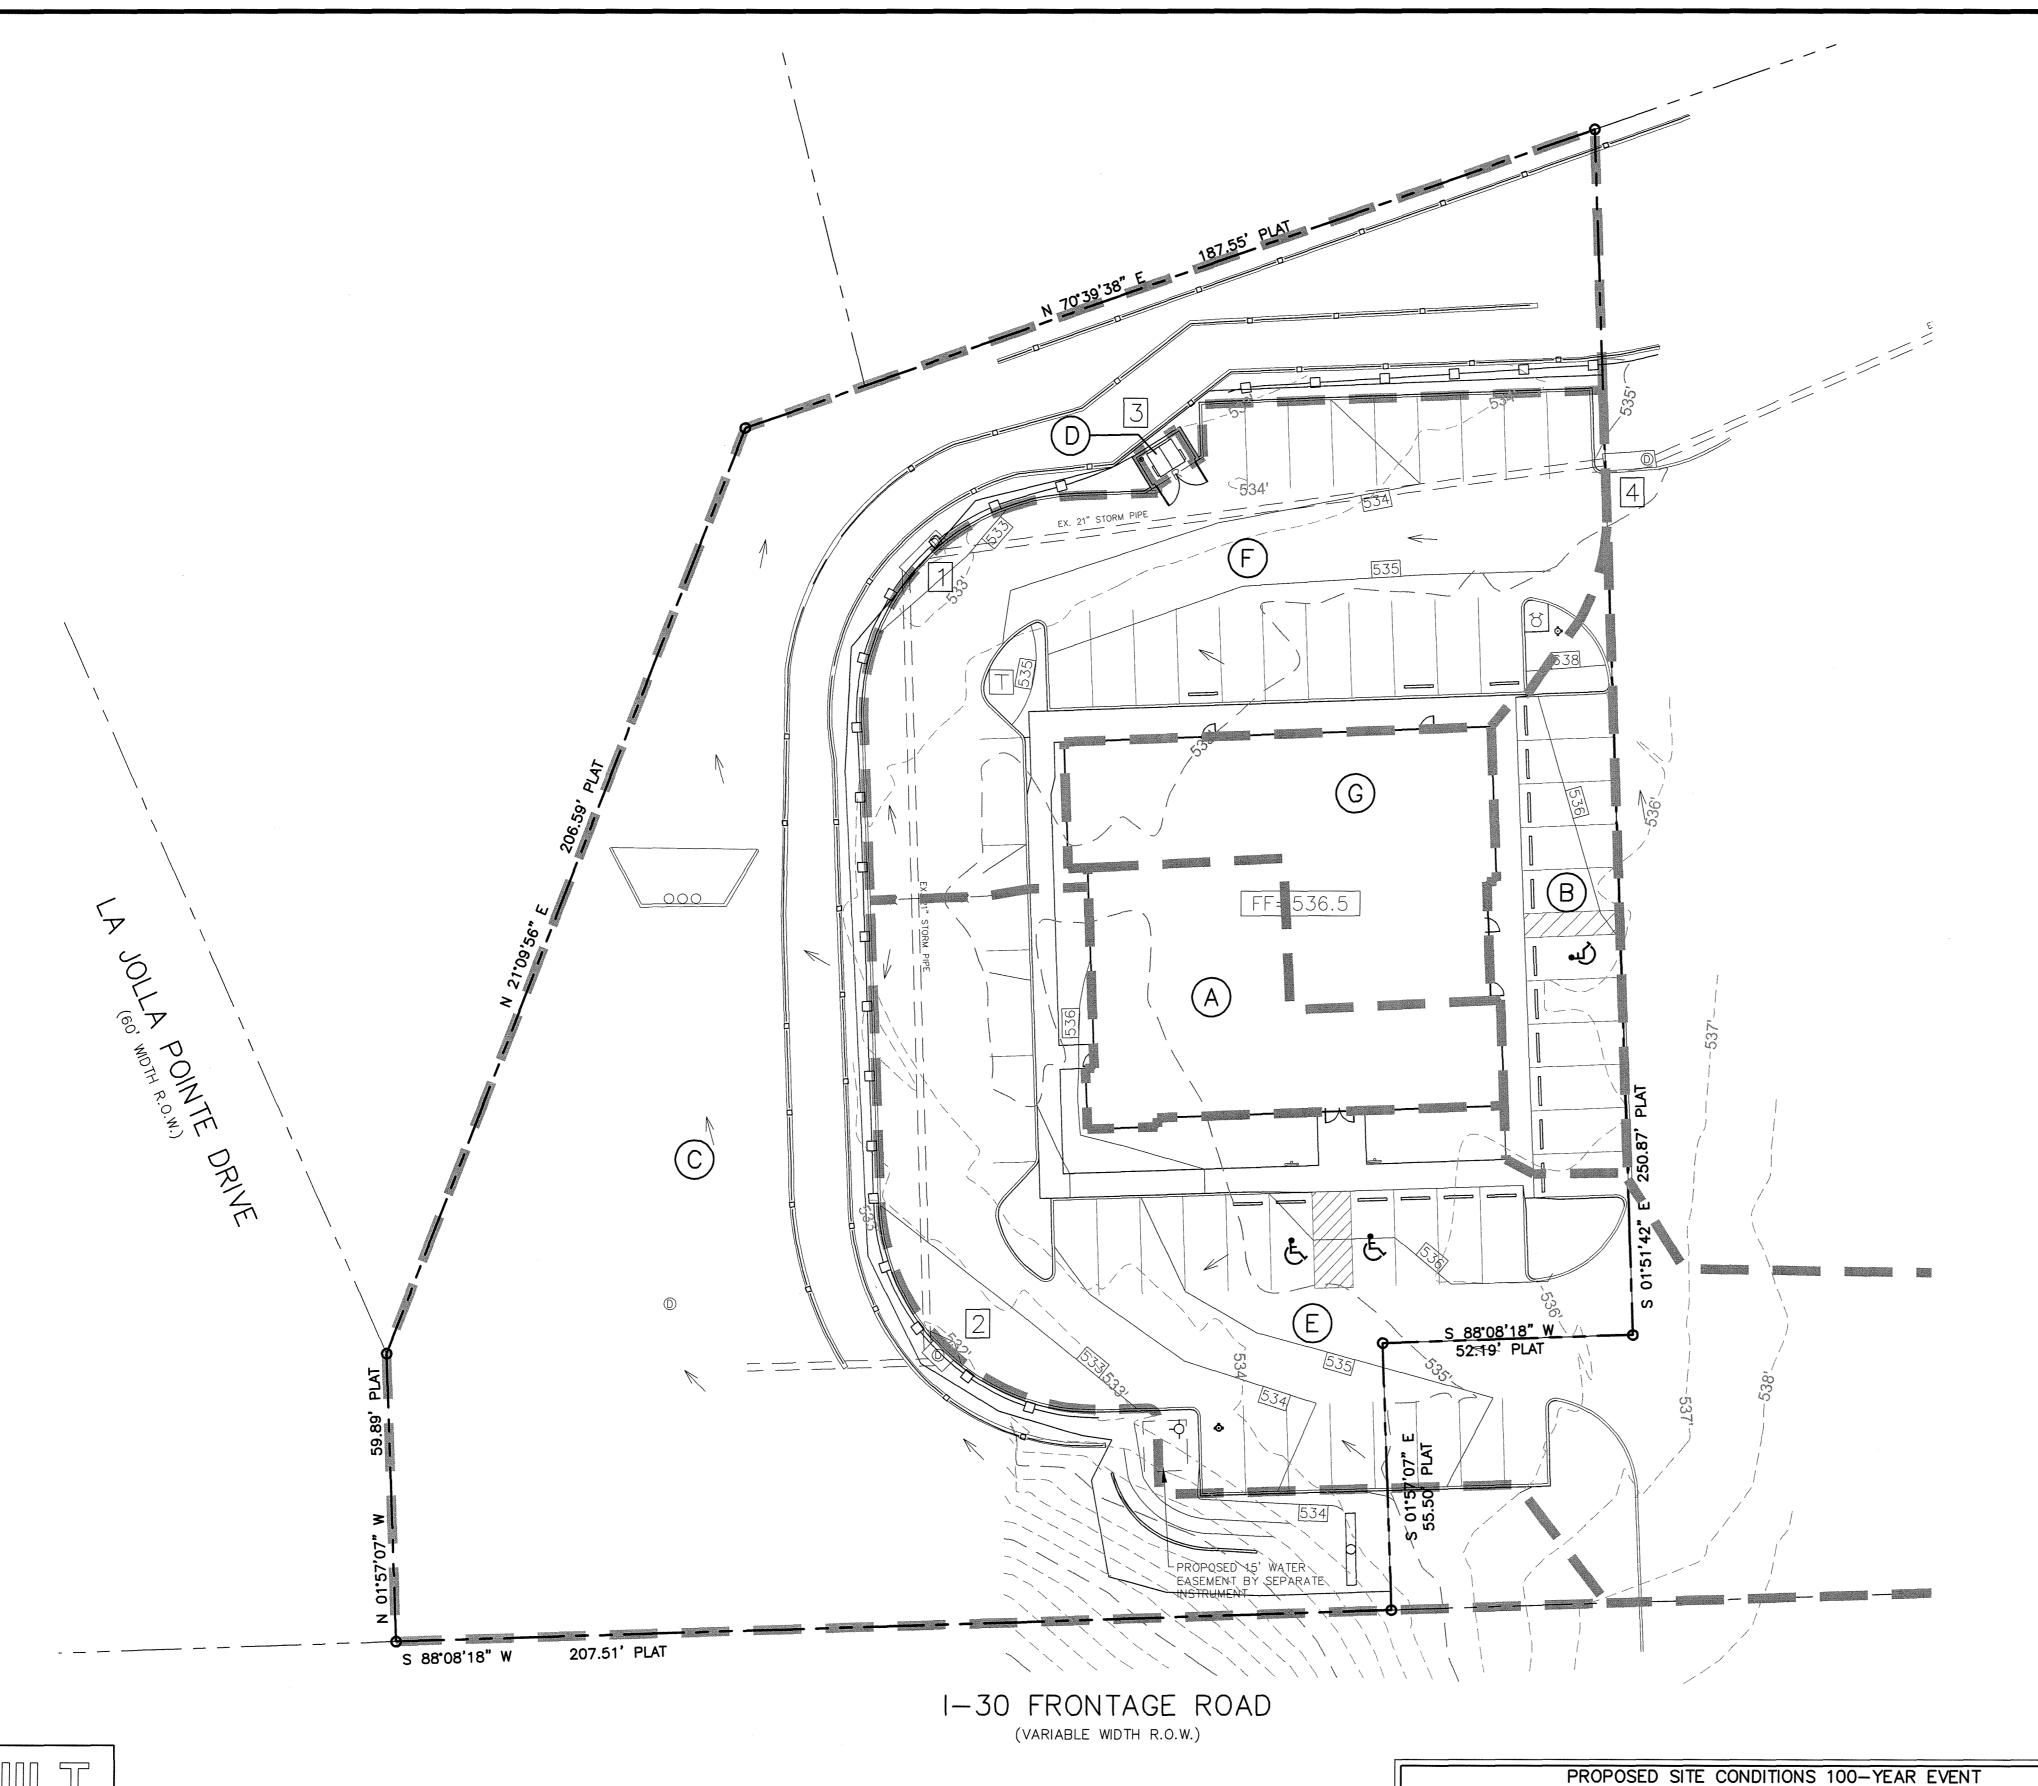

ALL RESPONSIBILITY FOR ADEQUACY OF DESIGN

FOR ADEQUACY OR ACCURACY OF DESIGN.

REMAINS WITH THE DESIGN ENGINEER. THE CITY OF

ROCKWALL, IN REVIEWING AND RELEASING PLANS

FOR CONSTRUCTION, ASSUMES NO RESPONSIBILITY

LEGEND

- EXISTING CURB

- PROPOSED CURB - EXISTING CONTOUR

- PROPOSED VALLEY - PROPOSED RIDGE

- PROPOSED CONTOUR

- PROPOSED FLOW ARROW

- DRAINAGE AREA DIVIDE



- AREA DESCRIPTION



- INLET DESCRIPTION

REGIONAL DETENTION IS PROVIDED FOR THE ENTIRE DEVELOPMENT, INCLUDING THIS LOT. NO MODIFICATION OF THE EXISTING STORM SYSTEM OR FLOW PATHS WILL OCCUR AS PART OF THIS DEVELOPMENT.

REVISIONS							
REV NO.	DATE	DESCRIPTION					
\triangle	06/18/2013	MINOR SITE REVISIONS					
\wedge	06/22/2013	MINOR SITE REVISIONS					

DRAWING SCALE 1"=20'

THESE PLANS HAVE BEEN REVISED TO CONFORM WITH CONSTRUCTION RECORDS PROVIDED BY CONTRACTOR.

> !!! CAUTION !!! UNDERGROUND UTILITIES

XISTING UTILITIES AND UNDERGROUND FACILITIES INDICATED ON THESE PLANS HAVE BEEN OCATED FROM REFERENCE INFORMATION SUPPLIED BY VARIOUS PARTIES. THE ENGINEER DOES NOT ASSUME THE RESPONSIBILITY FOR THE UTILITY LOCATIONS SHOWN. IT SHALL BE THE SOLE RESPONSIBILITY OF THE CONTRACTOR(S) TO VERIFY THE HORIZONTALLY AND VERTICALLY LOCATION OF ALL UTILITIES AND UNDERGROUND FACILITIES PRIOR TO CONSTRUCTION, TO TAKE PRECAUTIONS IN ORDER TO PROTECT ALL FACILITIES ENCOUNTERED AND NOTIFY THE ENGINEER OF ALL CONFLICTS OF THE WORK WITH EXISTING FACILITIES. THE CONTRACTOR SHALL PROTECT AND MAINTAIN ALL UTILITIES FROM DAMAGE DURING CONSTRUCTION. ANY DAMAGE BY THE CONTRACTOR TO UTILITIES SHALL BE REPAIRED OR REPLACED BY THE CONTRACTOR AT THEIR OWN EXPENSE.

CALL: TEXAS ONE CALL @ 1-800-245-4545 AT LEAST 48 HRS PRIOR TO CONSTRUCTION.

DRAINAGE CRITERIA Q=C*I*A 1100=9.8 in/hr tc=10 min.

- 1						
4	DRAINAGE AREA NO.	DRAINAGE AREA (acres)	С	100 (in/hr)	Q 100 (cfs)	COMMENTS
	А	0.07	0.90	9.8	0.6	DRAINS TO ROOF DRAINS THEN INTO STORM SYSTEM
	В	0.07	0.90	9.8	0.6	FLOWS TO EXISTING 5' CURB INLET (#4)
	С	0.68	0.90	9.8	6.0	FLOWS TO EXISTING DRAINAGE CHANNEL
	D	0.01	0.90	9.8	0.1	DUMPSTER AREA (GOES TO SANITARY SEWER) (#3)
	Е	±1.28	0.90	9.8	±11.3	FLOWS TO EXISTING 5' CURB INLET (#2) **
	F	0.23	0.90	9.8	2.0	FLOWS TO EXISTING 10' CURB INLET (#1)
	G	0.08	0.90	9.8	0.7	DRAINS TO ROOF DRAINS THEN INTO STORM SYSTEM

** AREA E ALSO RECEIVES CARRYOVER FLOW FROM UPSTREAM PORTIONS OF THE OVERALL DEVELOPMENT. THE INTENT OF THE SITE GRADING AND THE DRAINAGE AREA MAP IS TO MAINTAIN THE PREVIOUSLY APPROVED DRAINAGE AREA MAP AREAS AND FLOW. ALL OF THE EXISTING CURB INLETS ON SITE CONNECT INTO THE SAME STORM SYSTEM.

SQUARE CUT ON THE TOP OF THE EXISTING CURB LOCATED ON THE SOUTHERN EDGE OF THE SOUTHERN DRIVE OF THE EXISTING FIRELANE APPROXIMATELY 20' WEST OF THE INTERSECTION OF THE DRIVE TO THE 1H30 FRONTAGE ROAD

ELEVATION 535.77'

PLOT DATE 05/22/14 DRAWING SCALE 1" = 20'PROJECT NUMBER CD13012 SHEET NUMBER

C4


Design

OS-22-2014

50 ROCKWALL

DRAINAGE

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INSTALL SILT FENCE OR TRIANGULAR SEDIMENT FILTER DIKE (TYP.) Y-INSTALL INLET PROTECTION STABILIZED CONSTRUCTION - ENTRANCE. EXACT LOCATION TO 2INSTALL INLET BE DETERMINED BY THE OWNER. -INSTALL SILT FENCE OR NOTE: CONTRACTOR SHALL ADD/ADJUST SILT TRIANGULAR FENCE OR OTHER EROSION CONTROL DEVICES SEDIMENT DURING CONSTRUCTION AS NEED TO PREVENT FILTER DIKE SEDIMENT FROM LEAVING THE CONSTRUCTION (TYP.) SITE AT ANY TIME. CONTRACTOR SHALL REMOVE ALL TEMPORARY EROSION CONTROL DEVICES UPON COMPLETION OF CONSTRUCTION. INSTALL INLET S 88'08'18" V PROTECTION 52. 19' PLAT INSTALL SILT FENCE OR TRIANGULAR SEDIMENT 000 CONTRACTOR TO OBTAIN FILTER DIKE (TYP.) -PERMISSION FROM PROPERTY OWNER/CITY, TO INSTALL SILT FENCE PRIOR TO CONSTRUCTION S 88'08'18" W 207.51' PLAT I-30 FRONTAGE ROAD (VARIABLE WIDTH R.O.W.) THESE PLANS HAVE BEEN REVISED TO CONFORM WITH CONSTRUCTION RECORDS PROVIDED BY CONTRACTOR.

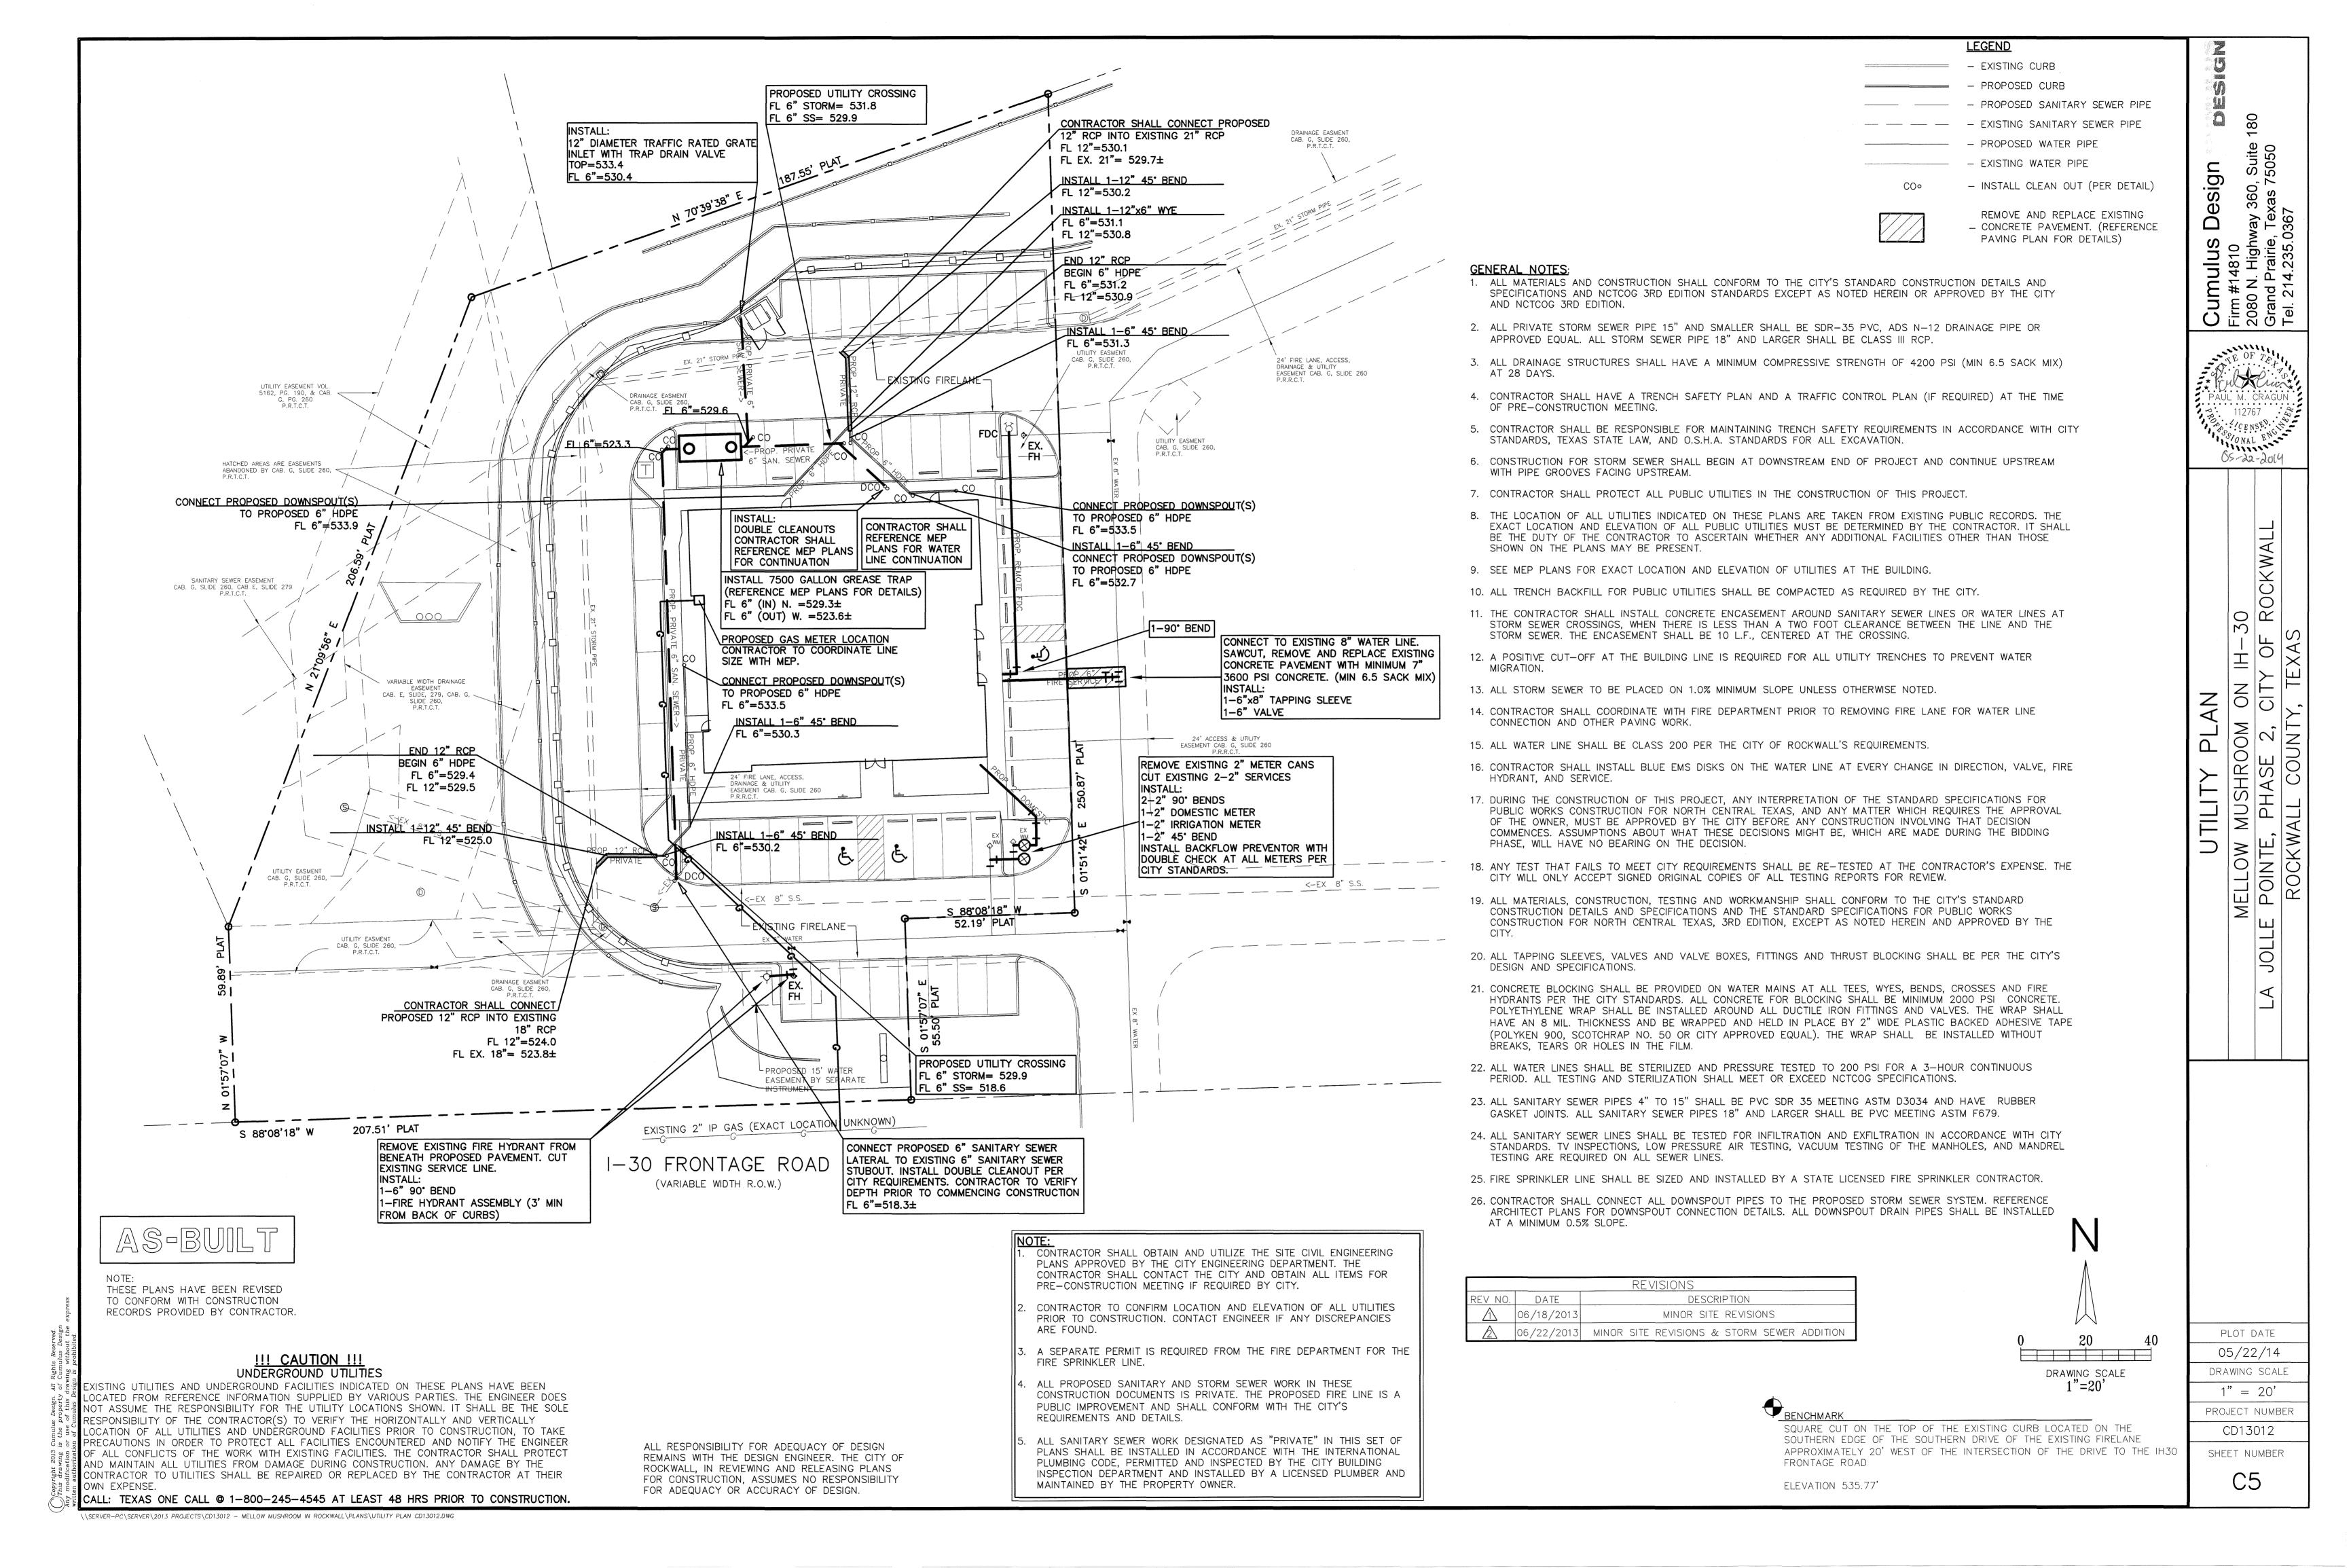ALL RESPONSIBILITY FOR ADEQUACY OF DESIGN

ROCKWALL, IN REVIEWING AND RELEASING PLANS

FOR CONSTRUCTION, ASSUMES NO RESPONSIBILITY

FOR ADEQUACY OR ACCURACY OF DESIGN.

REMAINS WITH THE DESIGN ENGINEER. THE CITY OF

LEGEND

EXISTING CURB

PROPOSED CURB

- - 600- - EXISTING CONTOUR - PROPOSED CONTOUR

 PROPOSED RIDGE PROPOSED FLOW ARROW

INLET PROTECTION

- SILT FENCE OR SILT DIKE



- CONSTRUCTION ENTRANCE

GENERAL NOTES:

1. EROSION CONTROL DEVICES AS SHOWN ON THE EROSION CONTROL PLAN FOR THE PROJECT SHALL BE INSTALLED PRIOR TO THE START OF THE LAND DISTURBING ACTIVITIES ON THE PROJECT.

2. ALL EROSION CONTROL DEVICES ARE TO BE INSTALLED IN ACCORDANCE WITH THE APPROVED PLANS AND SPECIFICATIONS FOR THE PROJECT.

3. IF THE EROSION CONTROL PLAN AS APPROVED CANNOT CONTROL EROSION AND OFF-SITE SEDIMENT FROM THE PROJECT THE EROSION CONTROL PLAN WILL BE REQUIRED TO BE REVISED AND/OR ADDITIONAL EROSION CONTROL DEVICES WILL BE REQUIRED ON SITE.

4. IF OFF-SITE SOIL BORROW OR SPOIL SITES ARE USED IN CONJUNCTION WITH THIS PROJECT, THIS INFORMATION SHALL BE DISCLOSED AND SHOWN ON THE EROSION CONTROL PLAN. THESE AREAS SHALL BE STABILIZED WITH PERMANENT GROUND COVER PRIOR TO FINAL APPROVAL OF THE PROJECT.

5. THE CONTRACTOR IS RESPONSIBLE FOR PROVIDING THE STORM WATER POLLUTION AND PREVENTION PLAN (SWPPP) IF REQUIRED.

6. REFERENCE LANDSCAPE PLAN FOR TREE PROTECTION INFORMATION. (IF

7. 75% TO 85% OF ALL DISTURBED AREAS TO BE COVERED WITH A MINIMUM OF 1" TALL GRASS PRIOR TO ENGINEERING ACCEPTANCE.

> THIS PLAN REFLECTS MINIMUM REQUIREMENTS ONLY, AND DOES NOT CONSTITUTE A STORM WATER POLLUTION PREVENTION PLAN. THE CONTRACTOR SHALL PROVIDE ADDITIONAL CONTROLS AS REQUIRED BY FIELD CONDITIONS AND CONSTRUCTION SCHEDULING. THE CONTRACTOR SHALL COMPLY FULLY WITH ANY APPLICABLE REQUIREMENTS AS ESTABLISHED IN THE CURRENT TPDES GENERAL PERMITS FOR STORM WATER DISCHARGES FROM CONSTRUCTION ACTIVITIES IN REGION 6.

NCTCOG PUBLISHES ACCEPTABLE CONTROLS IN A REFERENCE MANUAL ENTITLED "STORM WATER QUALITY BEST MANAGEMENT PRACTICES FOR CONSTRUCTION ACTIVITIES,". THIS MANUAL CAN BE OBTAINED THROUGH THE INTERNET AT: WWW.DFWSTORMWATER.COM.

> DRAWING SCALE 1"=20'

BENCHMARK

REVISIONS

DESCRIPTION

MINOR SITE REVISIONS

MINOR SITE REVISIONS

REV NO. DATE

06/18/2013

06/22/2013

SQUARE CUT ON THE TOP OF THE EXISTING CURB LOCATED ON THE SOUTHERN EDGE OF THE SOUTHERN DRIVE OF THE EXISTING FIRELANE APPROXIMATELY 20' WEST OF THE INTERSECTION OF THE DRIVE TO THE 1H30 FRONTAGE ROAD

ELEVATION 535.77'

PROJECT NUMBER CD13012 SHEET NUMBER

PLOT DATE

05/22/14

DRAWING SCALE

1" = 20'

30 ROCKWAL

EROSION
MELLOW M
E POINTE,
ROCKWA

PLAN

CONTROL

\\SERVER-PC\SERVER\2013 PROJECTS\CD13012 - MELLOW MUSHROOM IN ROCKWALL\PLANS\EROSION CONTROL PLAN CD13012.DWG

WN EXPENSE.

!!! CAUTION !!!

UNDERGROUND UTILITIES

EXISTING UTILITIES AND UNDERGROUND FACILITIES INDICATED ON THESE PLANS HAVE BEEN

RESPONSIBILITY OF THE CONTRACTOR(S) TO VERIFY THE HORIZONTALLY AND VERTICALLY

OCATED FROM REFERENCE INFORMATION SUPPLIED BY VARIOUS PARTIES. THE ENGINEER DOES NOT ASSUME THE RESPONSIBILITY FOR THE UTILITY LOCATIONS SHOWN. IT SHALL BE THE SOLE

OCATION OF ALL UTILITIES AND UNDERGROUND FACILITIES PRIOR TO CONSTRUCTION, TO TAKE


PRECAUTIONS IN ORDER TO PROTECT ALL FACILITIES ENCOUNTERED AND NOTIFY THE ENGINEER

F ALL CONFLICTS OF THE WORK WITH EXISTING FACILITIES. THE CONTRACTOR SHALL PROTECT

CONTRACTOR TO UTILITIES SHALL BE REPAIRED OR REPLACED BY THE CONTRACTOR AT THEIR

CALL: TEXAS ONE CALL @ 1-800-245-4545 AT LEAST 48 HRS PRIOR TO CONSTRUCTION.

AND MAINTAIN ALL UTILITIES FROM DAMAGE DURING CONSTRUCTION. ANY DAMAGE BY THE

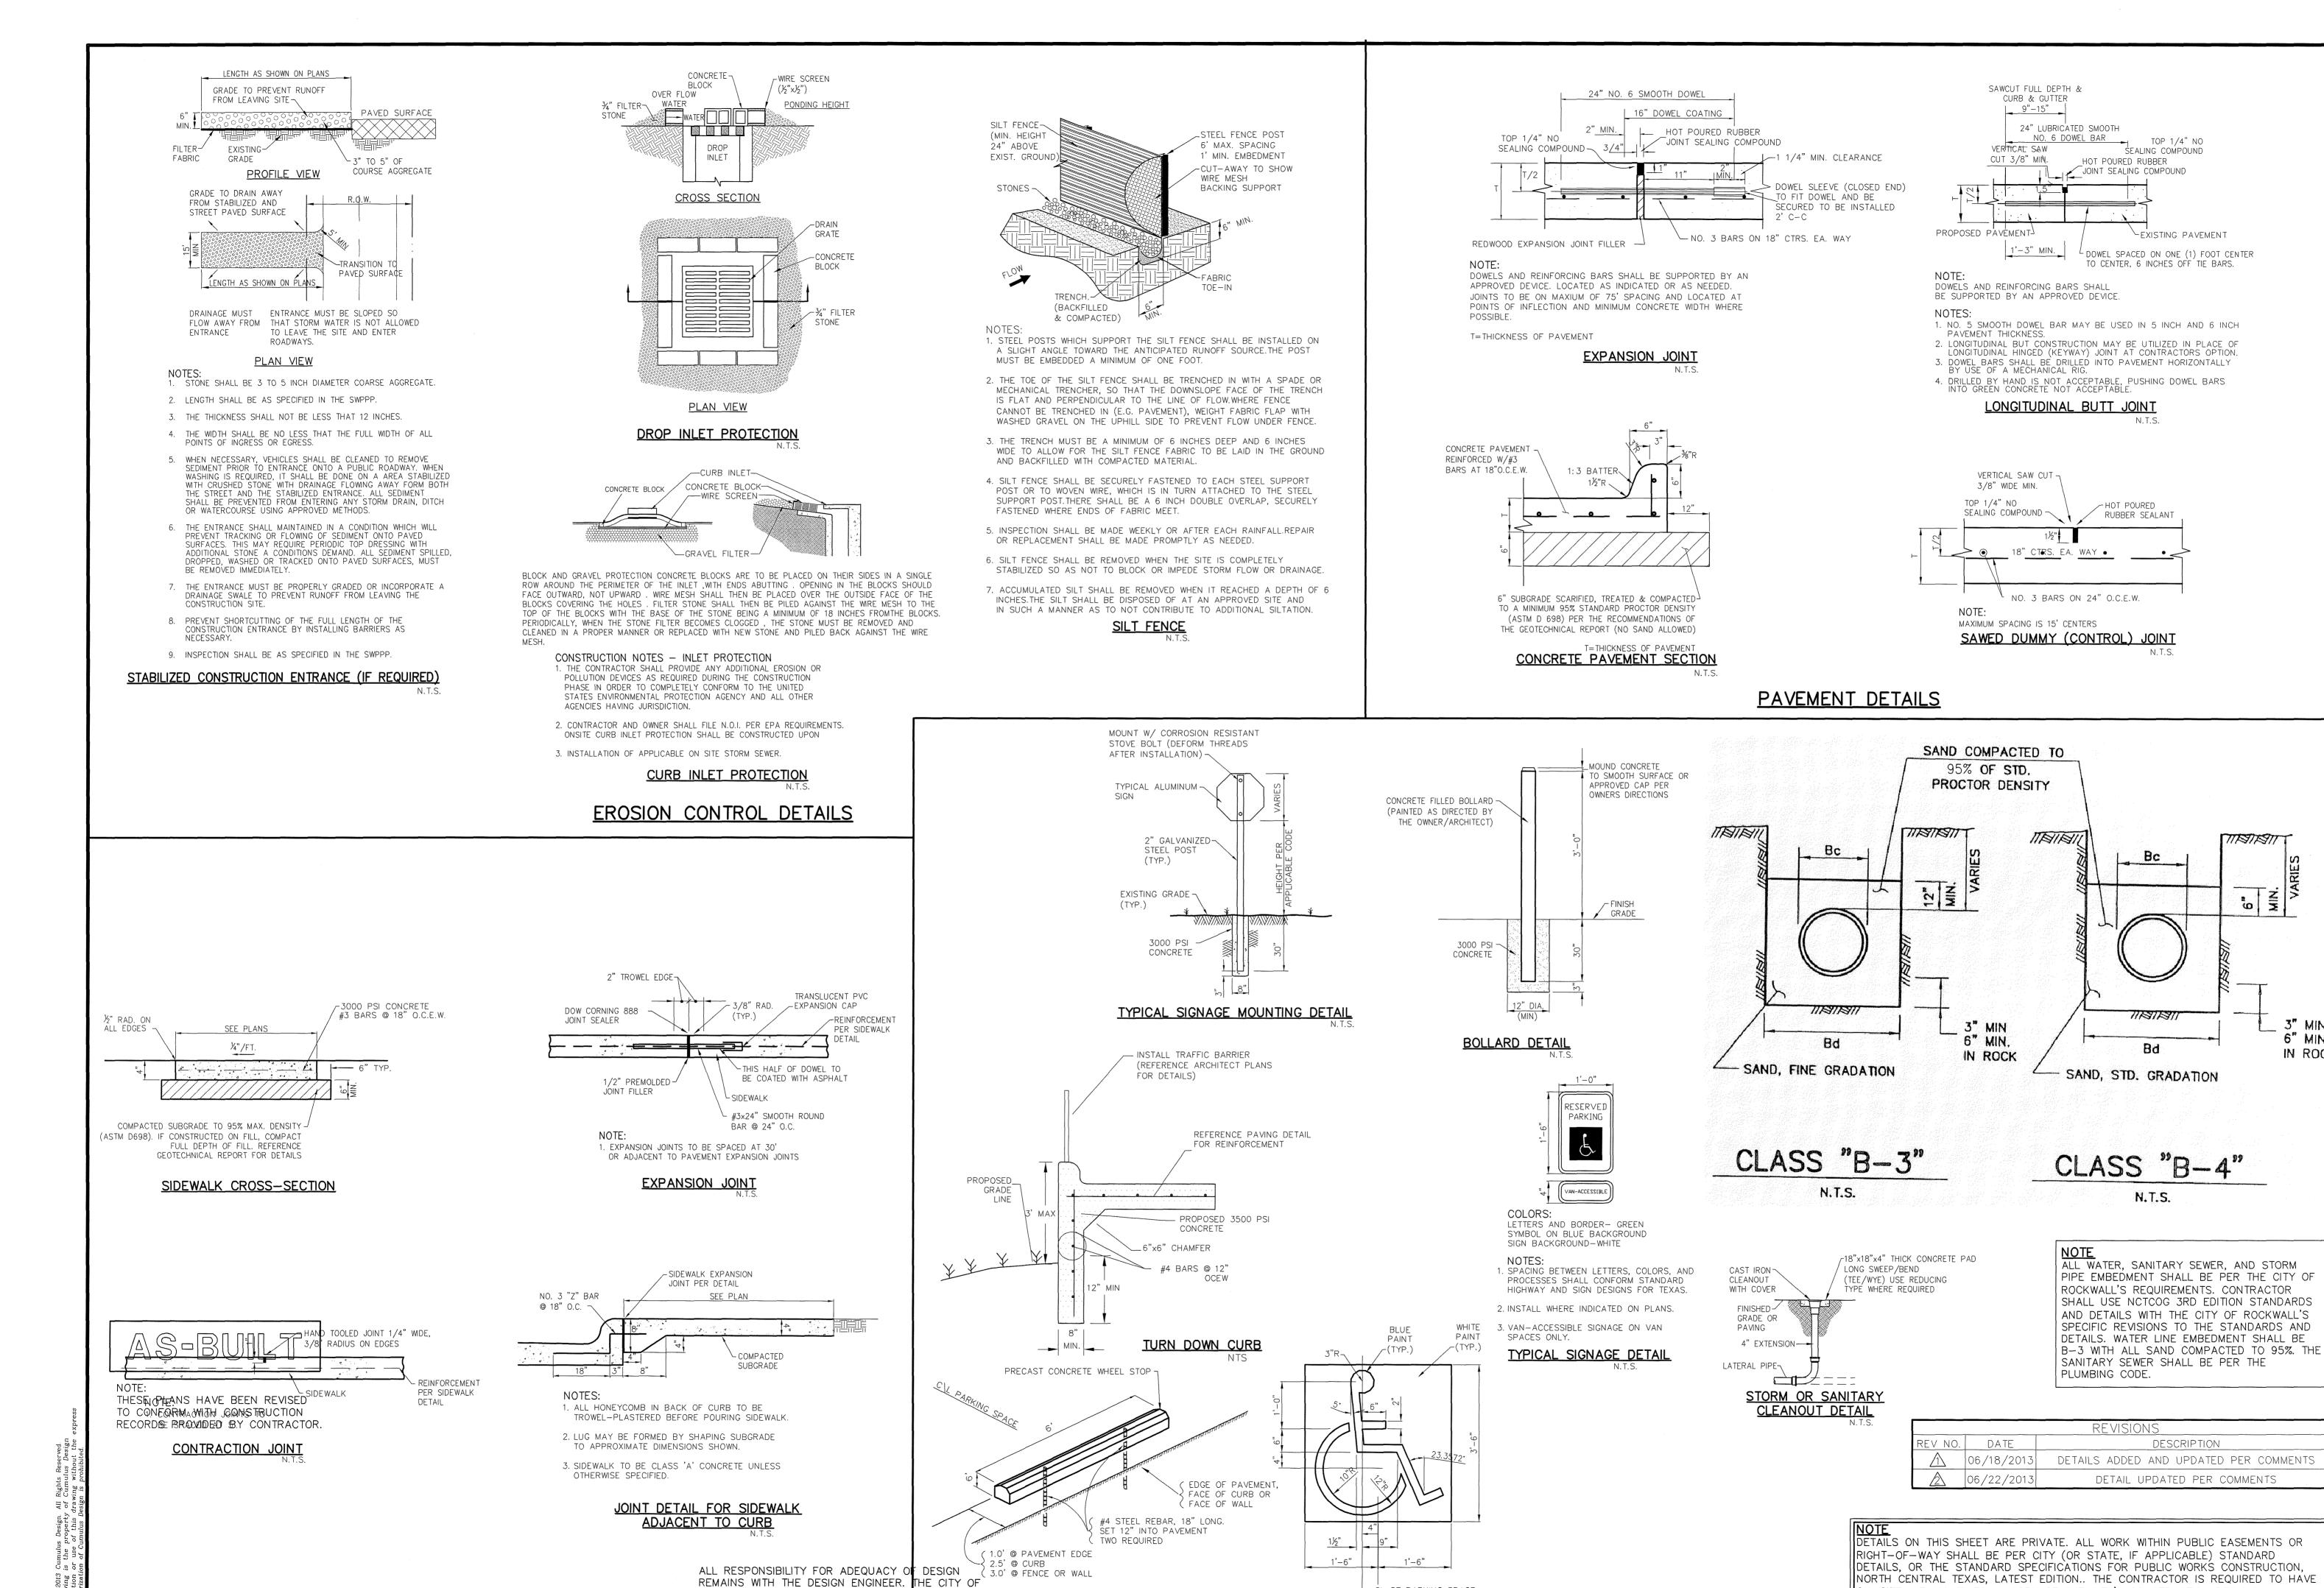

WHEEL STOP DETAIL

ROCKWALL, IN REVIEWING AND RELEASING PLANS FOR CONSTRUCTION, ASSUMES NO RESPONSIBILITY

FOR ADEQUACY OR ACCURACY OF DESIGN.

SIDEWALK DETAILS

\SERVER-PC\SERVER\2013 PROJECTS\CD13012 - MELLOW MUSHROOM IN ROCKWALL\PLANS\DETAILS (PRIVATE) ROCKWALL MODIFIED CD13012.DWG

CL OF PARKING SPACE

HANDICAP PARKING SYMBOL DETAIL

MISCELLANEOUS DETAILS

OCK \triangleleft \smile $\mathbb{A}_{\mathbb{Q}}$ \equiv FLLOW POINTE ROCKW DE JOLL 1

* N

ON-SITE, AT ALL TIMES, A COPY OF THE CITY'S CONSTRUCTION DETAILS.

6" MIN.

IN ROCK

sig

(1)

Secretary.

SSIONAL ENG

05-22-2014

WAL

PLOT DATE 05/22/14 DRAWING SCALE

CD13012 SHEET NUMBER

PROJECT NUMBER