CONSTRUCTION PLANS

PLATINUM SELF-STORAGE ON TOWNSEND DRIVE


AN ADDITION TO

CITY OF ROCKWALL, TEXAS

PLAN DRAWING INDEX

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	as built survey (by others)		

REVISIONS		
REV NO.	DATE	DESCRIPTION

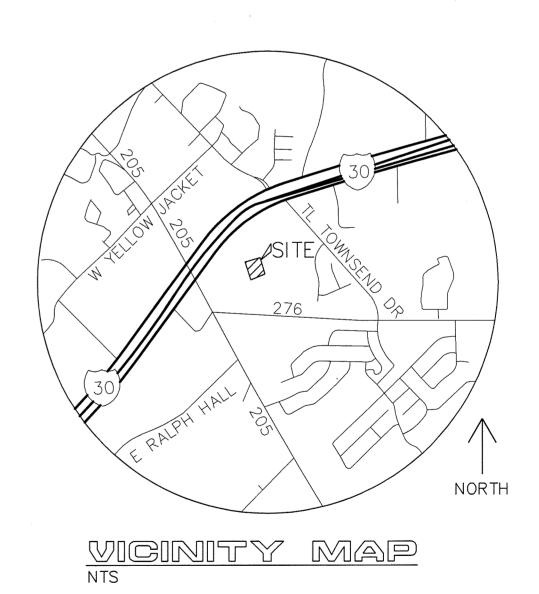

ENGINEER:
CUMULUS DESIGN, INC.
P.O. BOX 2119

EULESS, TEXAS 76039

PH: 214-235-0367 CONTACT: PAUL CRAGUN


EMAIL: PAUL@CUMULUSDESIGN.NET

OWNER: RON VALK 1834 S FM 551 FATE, TX 75189

PROBABLE START OF CONSTRUCTION:
MAY 2015

AS-BUILT

NOTE: THESE AS BUILT PLANS HAVE BEEN REVISED TO CONFORM WITH CONSTRUCTION RECORDS PROVIDED BY THE CONTRACTOR AND A POST CONSTRUCTION SURVEY.

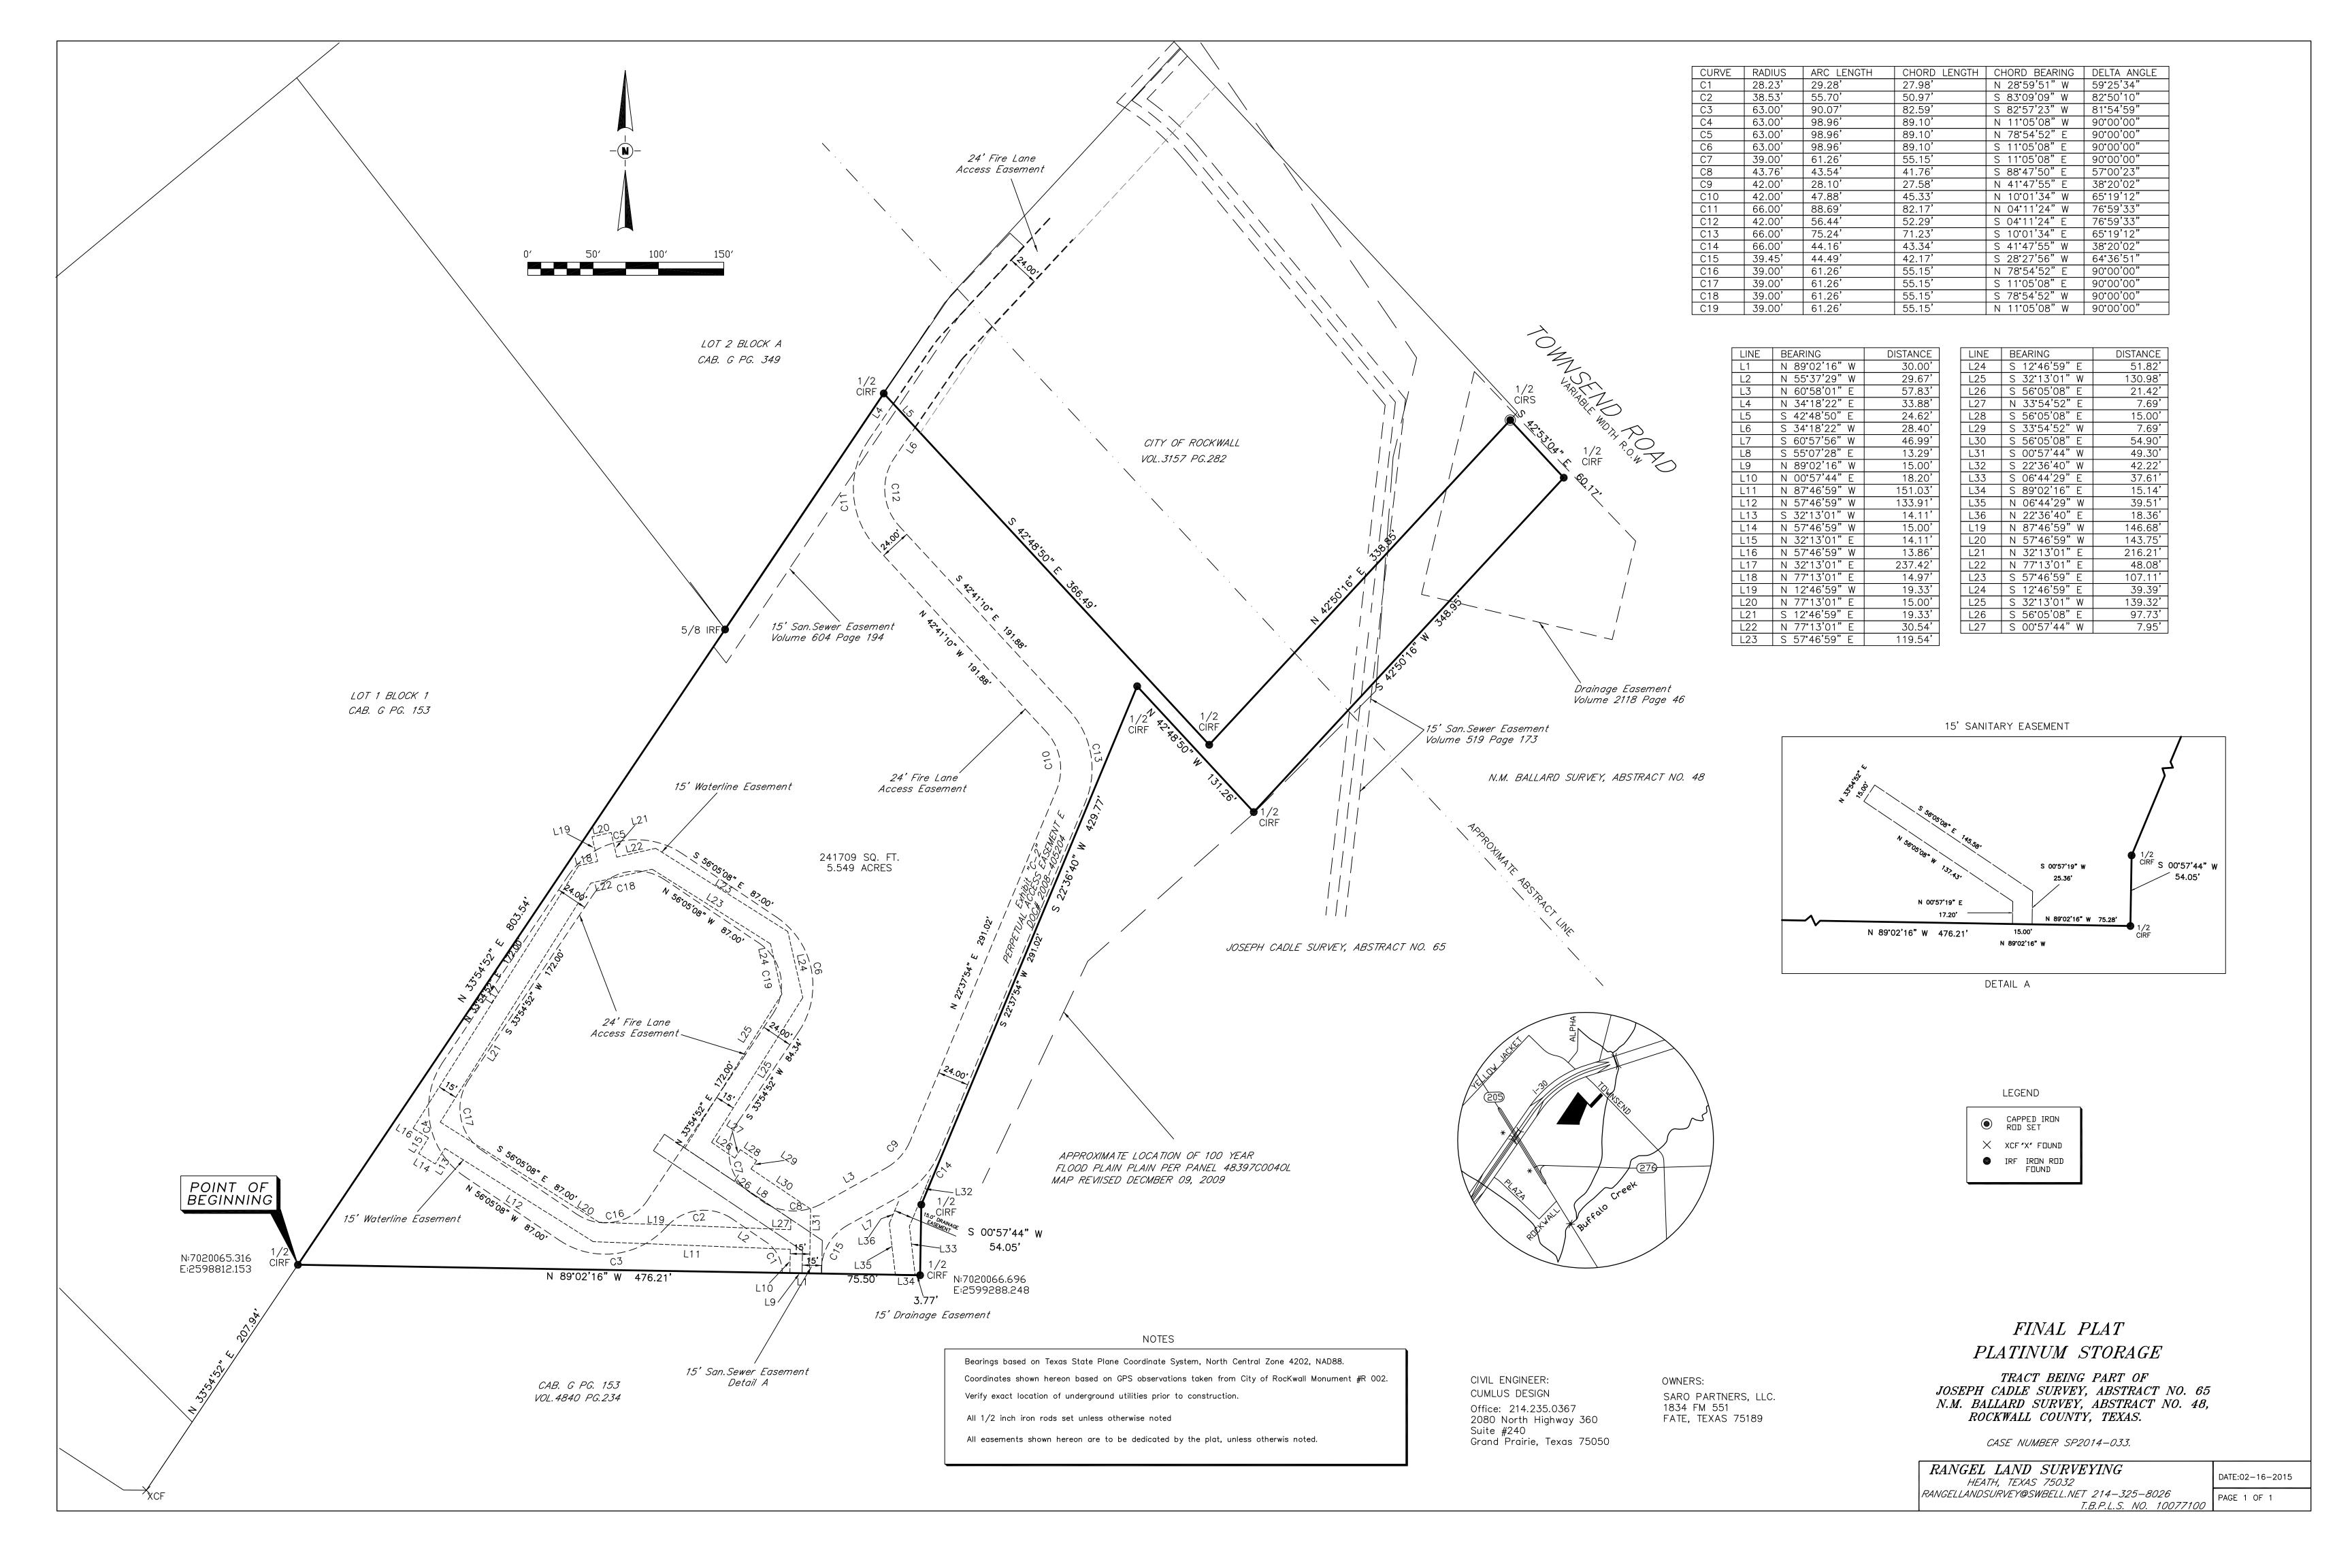

STATE OF TEXAS: COUNTY OF ROCKWALL:

WHEREAS SARO PARTNERS, LLC. BEING THE OWNER OF A TRACT OF land in the County of Rockwall, State of Texas, said tract being described as follows:

Being a 5.549 acre of land situated in the JOSEPH CADLE SURVEY, ABSTRACT NO. 65 and the N.M. BALLARD SURVEY, ABSTRACT NO. 48, in the City of Rockwall, Rockwall County, Texas and being a portion of a 65.96 acre tract of land recorded in Volume 4663, Page 281 of the Official Public Records of Rockwall County, Texas and being more particularly described as follows:

Point of Beginning at a 5/8 inch iron rod found for the northerly northwest corner of Lot 1,Block 1 of Rockwall Centre Corners Addition according to the plat recorded in Cabinet G. Slide 299 of the Plat Records of Rockwall County, Texas and being located in the southeasterly line of Lot1, Block 1 of Toyota of Rockwall according to the plat recorded in Cabinet G, Slide 153—155 of the Plat Records of Rockwall County, Texas, from which a found score X bears S 33°54' 52" W a distance of 207.94 feet;

THENCE N 33°54'52" E with said southeasterly line and passing a 5/8 inch iron at 585.86 feet and continuing a total distance of 803.54 feet to a set 1/2 iron rod with cap in the west line of City of Rockwall tract according to deed recorded in Volume 3157, Page 282 of the Official Public Records of Rockwall County, Texas;

THENCE S 42°48'50" E with said tract, a distance of 366.49 feet to a set 1/2 iron rod with cap from which a iron rod bears S 59°51′53" E, a distance of 3.02 feet;

THENCE N 42°50'16" E, a distance of 338.85 feet to a set 1/2 iron rod with cap from which a iron rod bears N 58°19 '35" E, a distance of 8.64 feet found in the south line of Townsend Road a variable width right of way;

THENCE S 42°53'04" E, a distance of 60.17 feet to a set 1/2 iron rod with cap;

THENCE S 42°50'16" W, a distance of 348.95 feet a set 1/2 iron rod with cap;

THENCE N 42°48'50" W. a distance of 131.26 feet a set 1/2 iron rod with cap:

THENCE S 22°36'40" W, a distance of 429.77 feet a set 1/2 iron rod with cap;

THENCE S 00°57'44" W, a distance of 54.05 feet a set 1/2 iron rod with cap in the north line of the aforementioned Lot 1 Block 1 from which a 5/8 inch iron found for corner bears S 88°50'40E, a distance of 139.33 feet;

THENCE N 89°02'16" W, a distance of 476.21 feet to the POINT OF BEGINNING containing 241,709 square feet or 5.549 acres.

NOW, THEREFORE, KNOW ALL MEN BY THESE PRESENTS:

STATE OF TEXAS COUNTY OF ROCKWALL

We the undersigned owner of the land shown on this plat, and designated herein as the whose name is subscribed hereto, hereby dedicate to the use of the public forever all streets, alleys, parks, watercourses, drains, easements and public places thereon shown on the purpose and consideration therein expressed. We further certify that all other parties who have a mortgage or lien interest in the_____ subdivision have been notified and signed this plat.

We understand and do hereby reserve the easement strips shown on this plat for the purposes stated and for the mutual use and accommodation of all utilities desiring to use or using same. We also understand the following;

1. No buildings shall be constructed or placed upon, over, or across the utility easements as described herein.

2. Any public utility shall have the right to remove and keep removed all or part of any buildings, fences, trees, shrubs, or other growths or improvements which in any way endanger or interfere with construction, maintenance or efficiency of their respective system on any of these easement strips; and any public utility shall at all times have the right of ingress or egress to, from and upon the said easement strips for purpose of construction, reconstruction, inspecting, patrolling, maintaining, and either adding to or removing all or part of their respective system without the necessity of, at any time, procuring the permission of anyone.

3. The City of Rockwall will not be responsible for any claims of any nature resulting from or occasioned by the establishment of grade of streets in the subdivision.

4. The developer and subdivision engineer shall bear total responsibility for storm drain improvements.

5. The developer shall be responsible for the necessary facilities to provide drainage patterns and drainage controls such that properties within the drainage area are not adversely affected by storm drainage from the development.

6. No house dwelling unit, or other structure shall be constructed on any lot in this addition by the owner or any other person until the developer and/or owner has complied with all requirements of the Subdivision Regulations of the City of Rockwall regarding improvements with respect to the entire block on the street or streets on which property abuts, including the actual installation of streets with the required base and paving, curb and gutter, water and sewer, drainage structures, storm structures, storm sewers, and alleys, all according to the specifications of the City of Rockwall; or

Until an escrow deposit, sufficient to pay for the cost of such improvements, as determined by the city's engineer and/or city administrator, computed on a private commercial rate basis, has been made with the city secretary, accompanied by an agreement signed by the developer and/or owner, authorizing the city to make such improvements at prevailing private commercial rates, or have the same made by a contractor and pay for the same out of the escrow deposit, should the developer and/or owner fail or refuse to install the required improvements within the time stated in such written agreement, but in no case shall the City be obligated to make such improvements itself. Such deposit may be used by the owner and/or developer as progress payments as the work progresses in making such improvements by making certified requisitions to the city secretary, supported by evidence of work done; or Development Process Guidelines (Updates 2012) Page 99 of 154 Until the developer and/or owner files a corporate surety bond with the city secretary in a sum equal to the cost of such improvements for the designated area, guaranteeing the installation thereof within the time stated in the bond, which time shall be fixed by the city council of the City of Rockwall.

We further acknowledge that the dedications and/or exaction's made herein are proportional to the impact of the Subdivision upon the public services required in order that the development will comport with the present and future growth needs of the City; We, our successors and assigns hereby waive any claim, damage, or cause of action that We may have as a result of the dedication of exactions made herein.

REPRESENTATIVE ______

SARO PARTNERS, LLC. 1834 FM 551

FATE, TEXAS 75189

STATE OF TEXAS COUNTY OF ROCKWALL

Before me, the undersigned authority, on this day personally appeared _____, known to me to be the person whose name is subscribed to the foregoing instrument, and acknowledged to me that he executed the same for the purpose and consideration therein stated.

Given upon my hand and seal of office this _____day of _____,

Notary Public in and for the State of Texas

My Commission Expires:

Signature of Party with Mortgage or Lien Interest

NOTE: It shall be the policy of the City of Rockwall to withhold issuing building permits until all streets, water, sewer and storm drainage systems have been accepted by the City. The approval of a plat by the City does not constitute any representation, assurance or guarantee that any building within such plat shall be approved, authorized or permit therefore issued, nor shall such approval constitute any representation, assurance or guarantee by the City of the adequacy and availability for water for personal use and fire protection within such plat, as required under Ordinance 83—54.

SURVEYOR'S CERTIFICATE NOW, THEREFORE KNOW ALL MEN BY THESE PRESENTS: THAT I, RUDY RANGEL, do hereby certify that I prepared this plat from an actual and accurate survey of the land, and that the corner monuments shown thereon were properly placed under my personal supervision.

DATE: _____

RUDY RANGEL REGISTERED PUBLIC SURVEYOR NO.5664

STATE OF TEXAS COUNTY OF ROCKWALL

Before me, the undersigned authority, on this day personally appeared __, known to me to be the person whose name is subscribed to the foregoing instrument, and acknowledged to me that he executed the same for the purpose and consideration therein stated.

Given upon my hand and seal of office this _____day of _____,

Notary Public in and for the State of Texas

My Commission Expires:

RECOMMENDED FOR FINAL APPROVAL

Planning and Zoning Commission

CIVIL ENGINEER:

CUMLUS DESIGN

Suite #240

Office: 214.235.0367

2080 North Highway 360

Grand Prairie, Texas 75050

OWNERS:

1834 FM 551

SARO PARTNERS, LLC.

FATE, TEXAS 75189

APPROVED

Date

I hereby certify that the above and foregoing plat of an addition to the City of Rockwall, Texas, was approved by the City Council of the City of Rockwall on the _____ day of _____, 20___, This approval shall be invalid unless the approved plat for such addition is recorded in the office of the County Clerk of Rockwall, County, Texas, within one hundred eighty (180) days from said date of final approval.

WITNESS OUR HANDS, this _____ day of _____, ____, ____.

City of Rockwall City Secretary

City Engineer

FINAL PLAT PLATINUM STORAGE

TRACT BEING PART OF JOSEPH CADLE SURVEY, ABSTRACT NO. 65 N.M. BALLARD SURVEY, ABSTRACT NO. 48, ROCKWALL COUNTY, TEXAS.


CASE NUMBER SP2014-033.


RANGEL LAND SURVEYING HEATH, TEXAS 75032

DATE:02-16-2015


RANGELLANDSURVEY@SWBELL.NET 214-325-8026 T.B.P.L.S. NO. 10077100

PAGE 2 OF 2

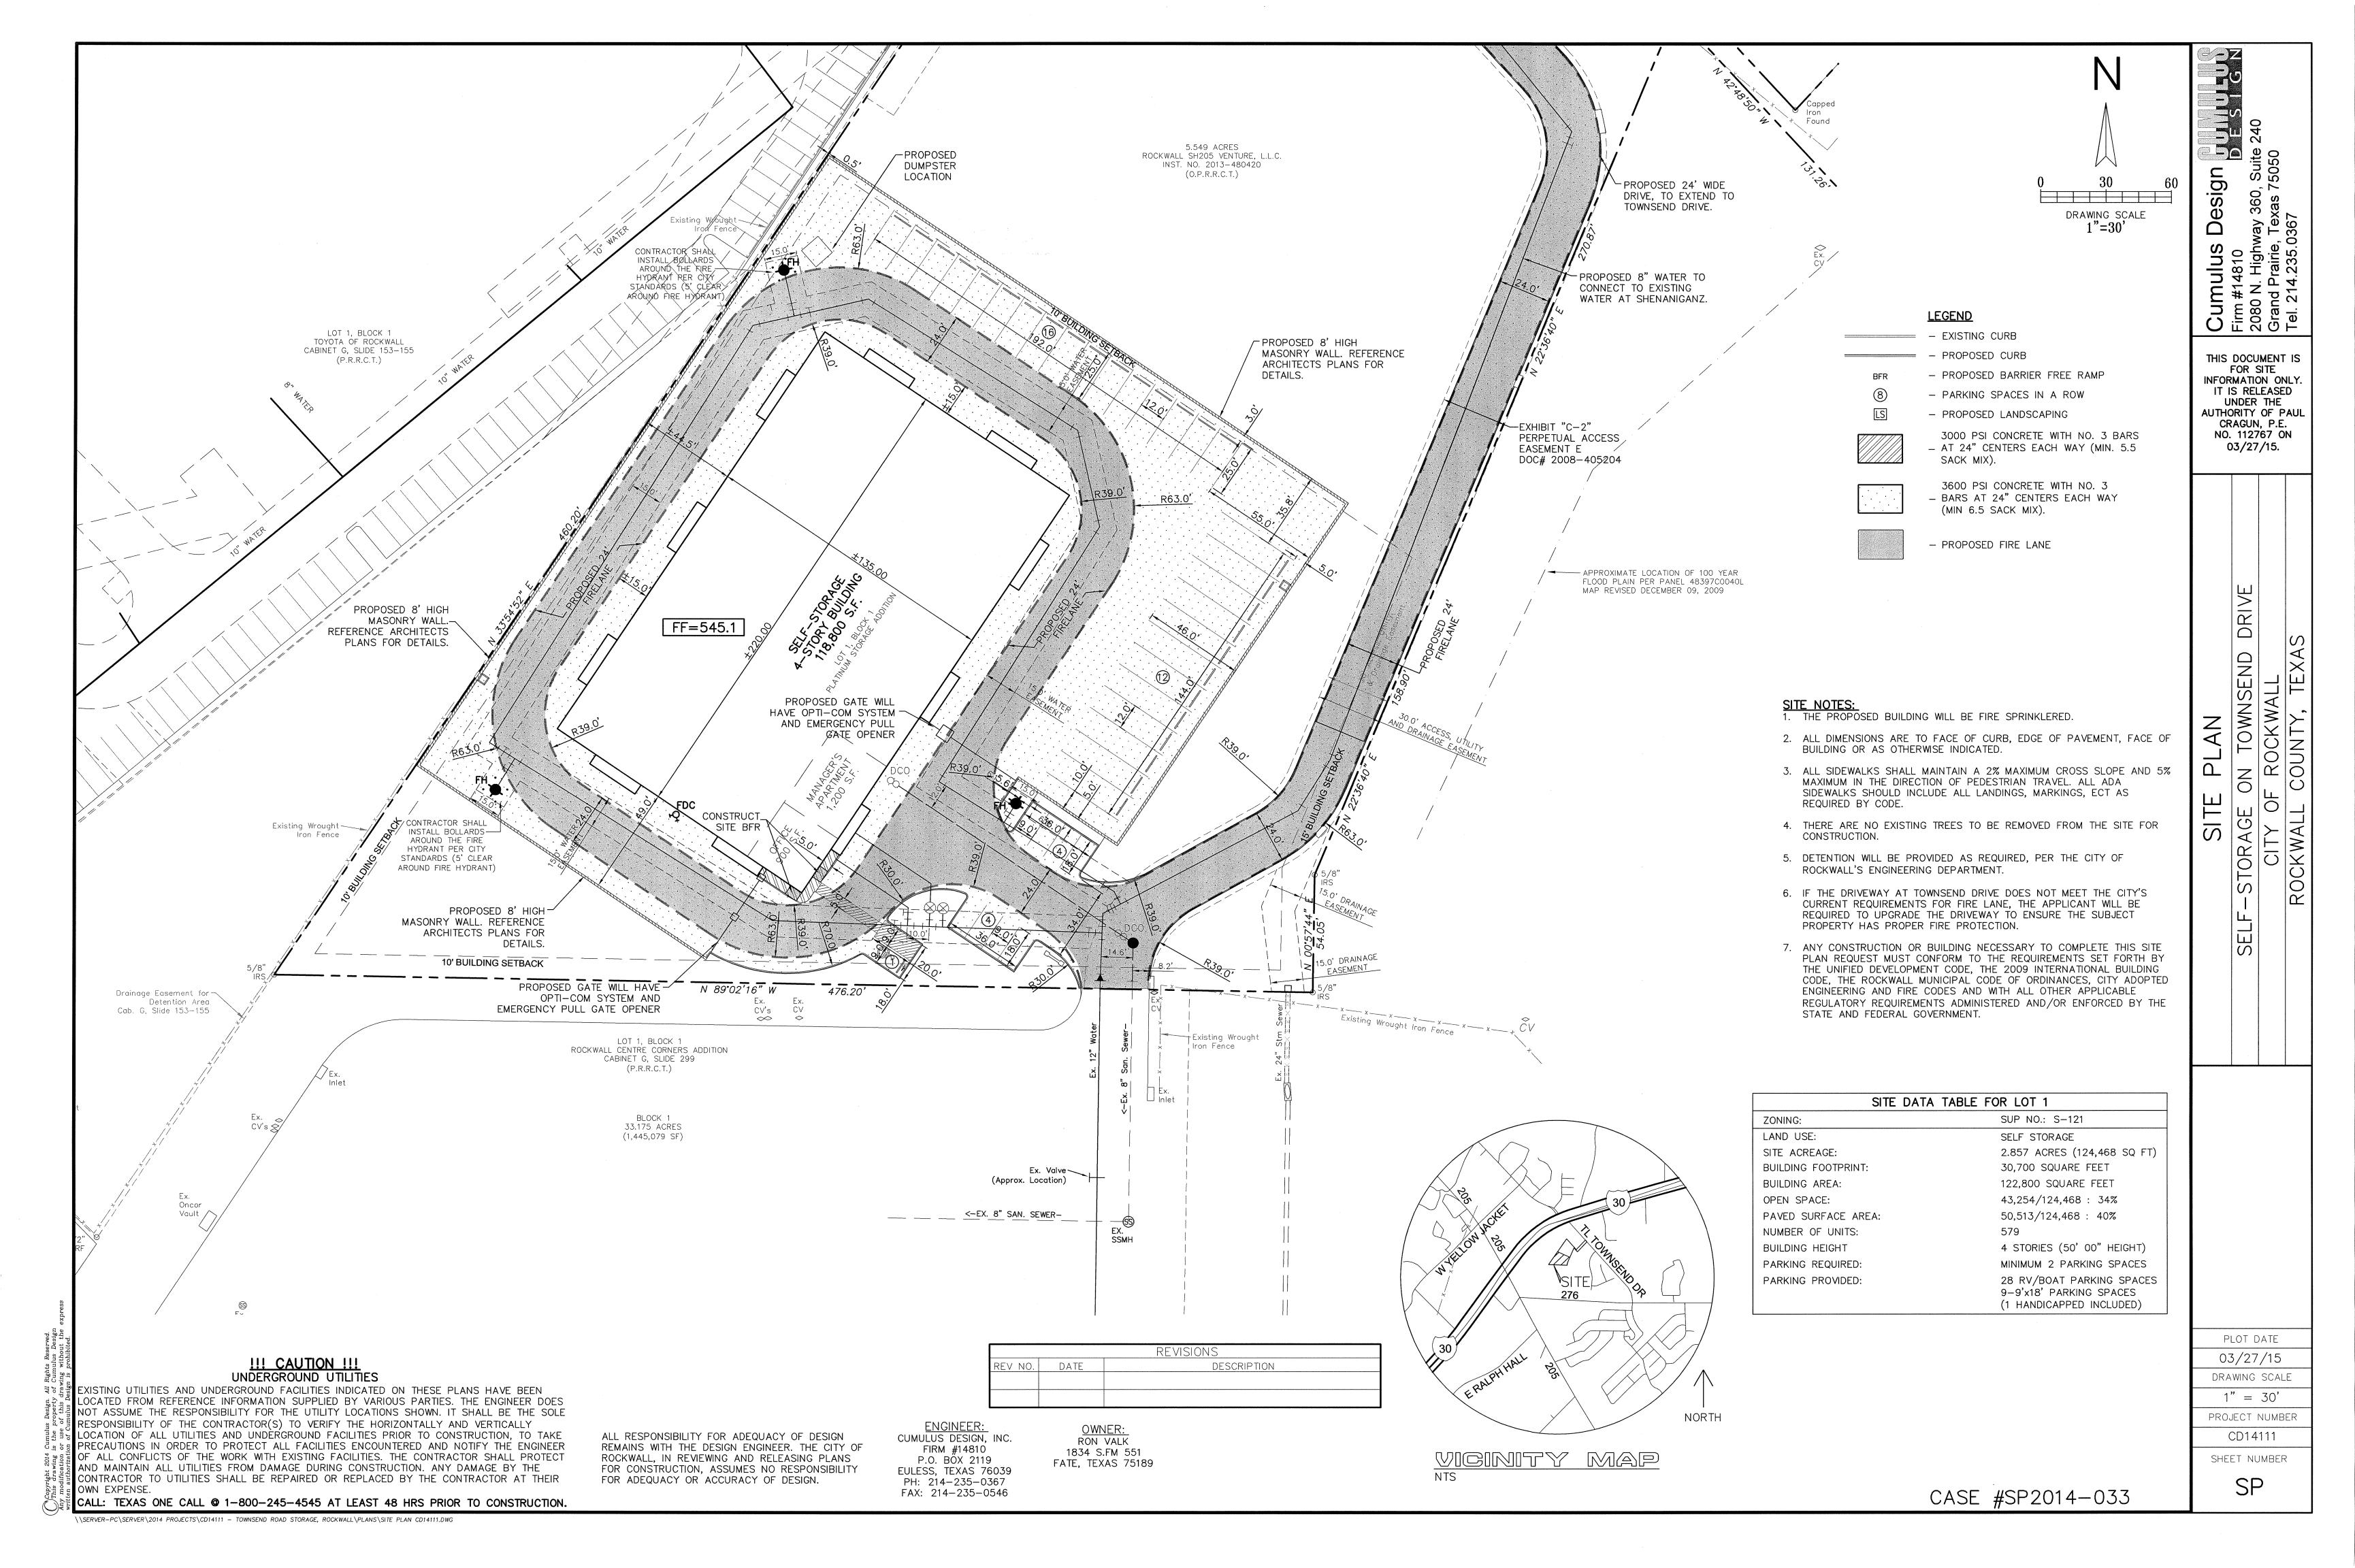

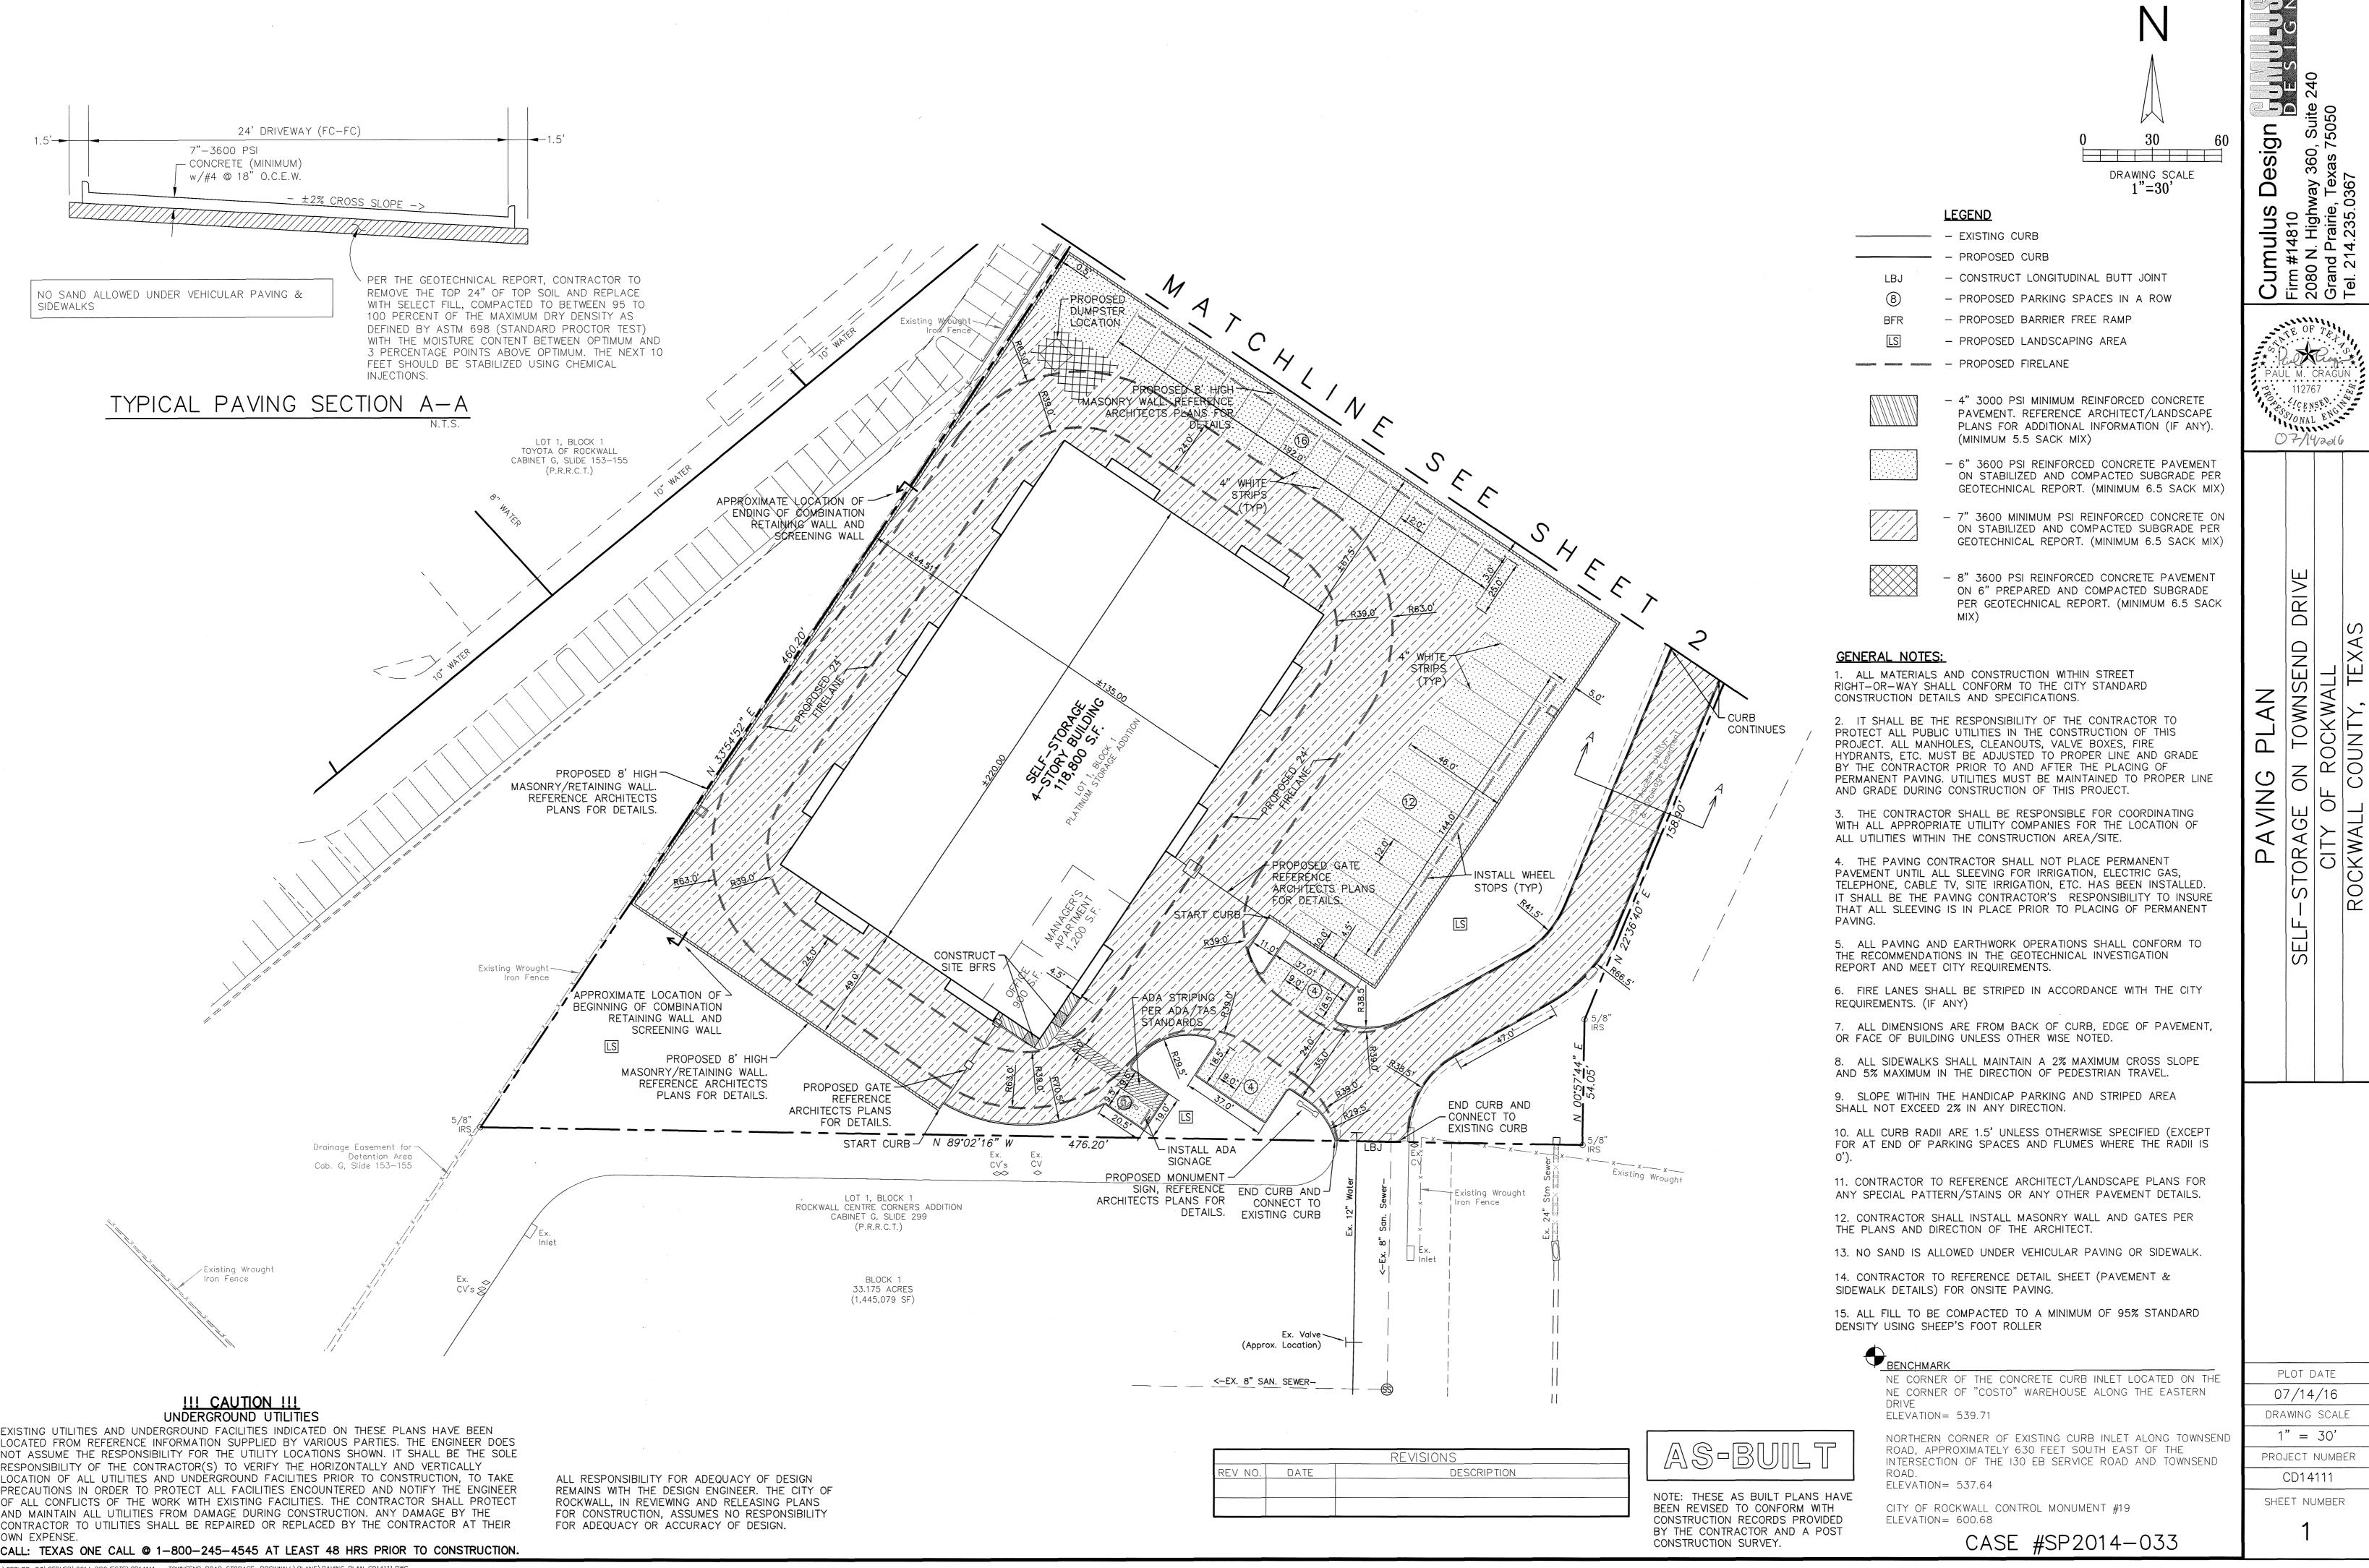

\SERVER-PC\SERVER\2014 PROJECTS\CD14111 - TOWNSEND ROAD STORAGE, ROCKWALL\PLANS\PAVING PLAN CD14111.DWG

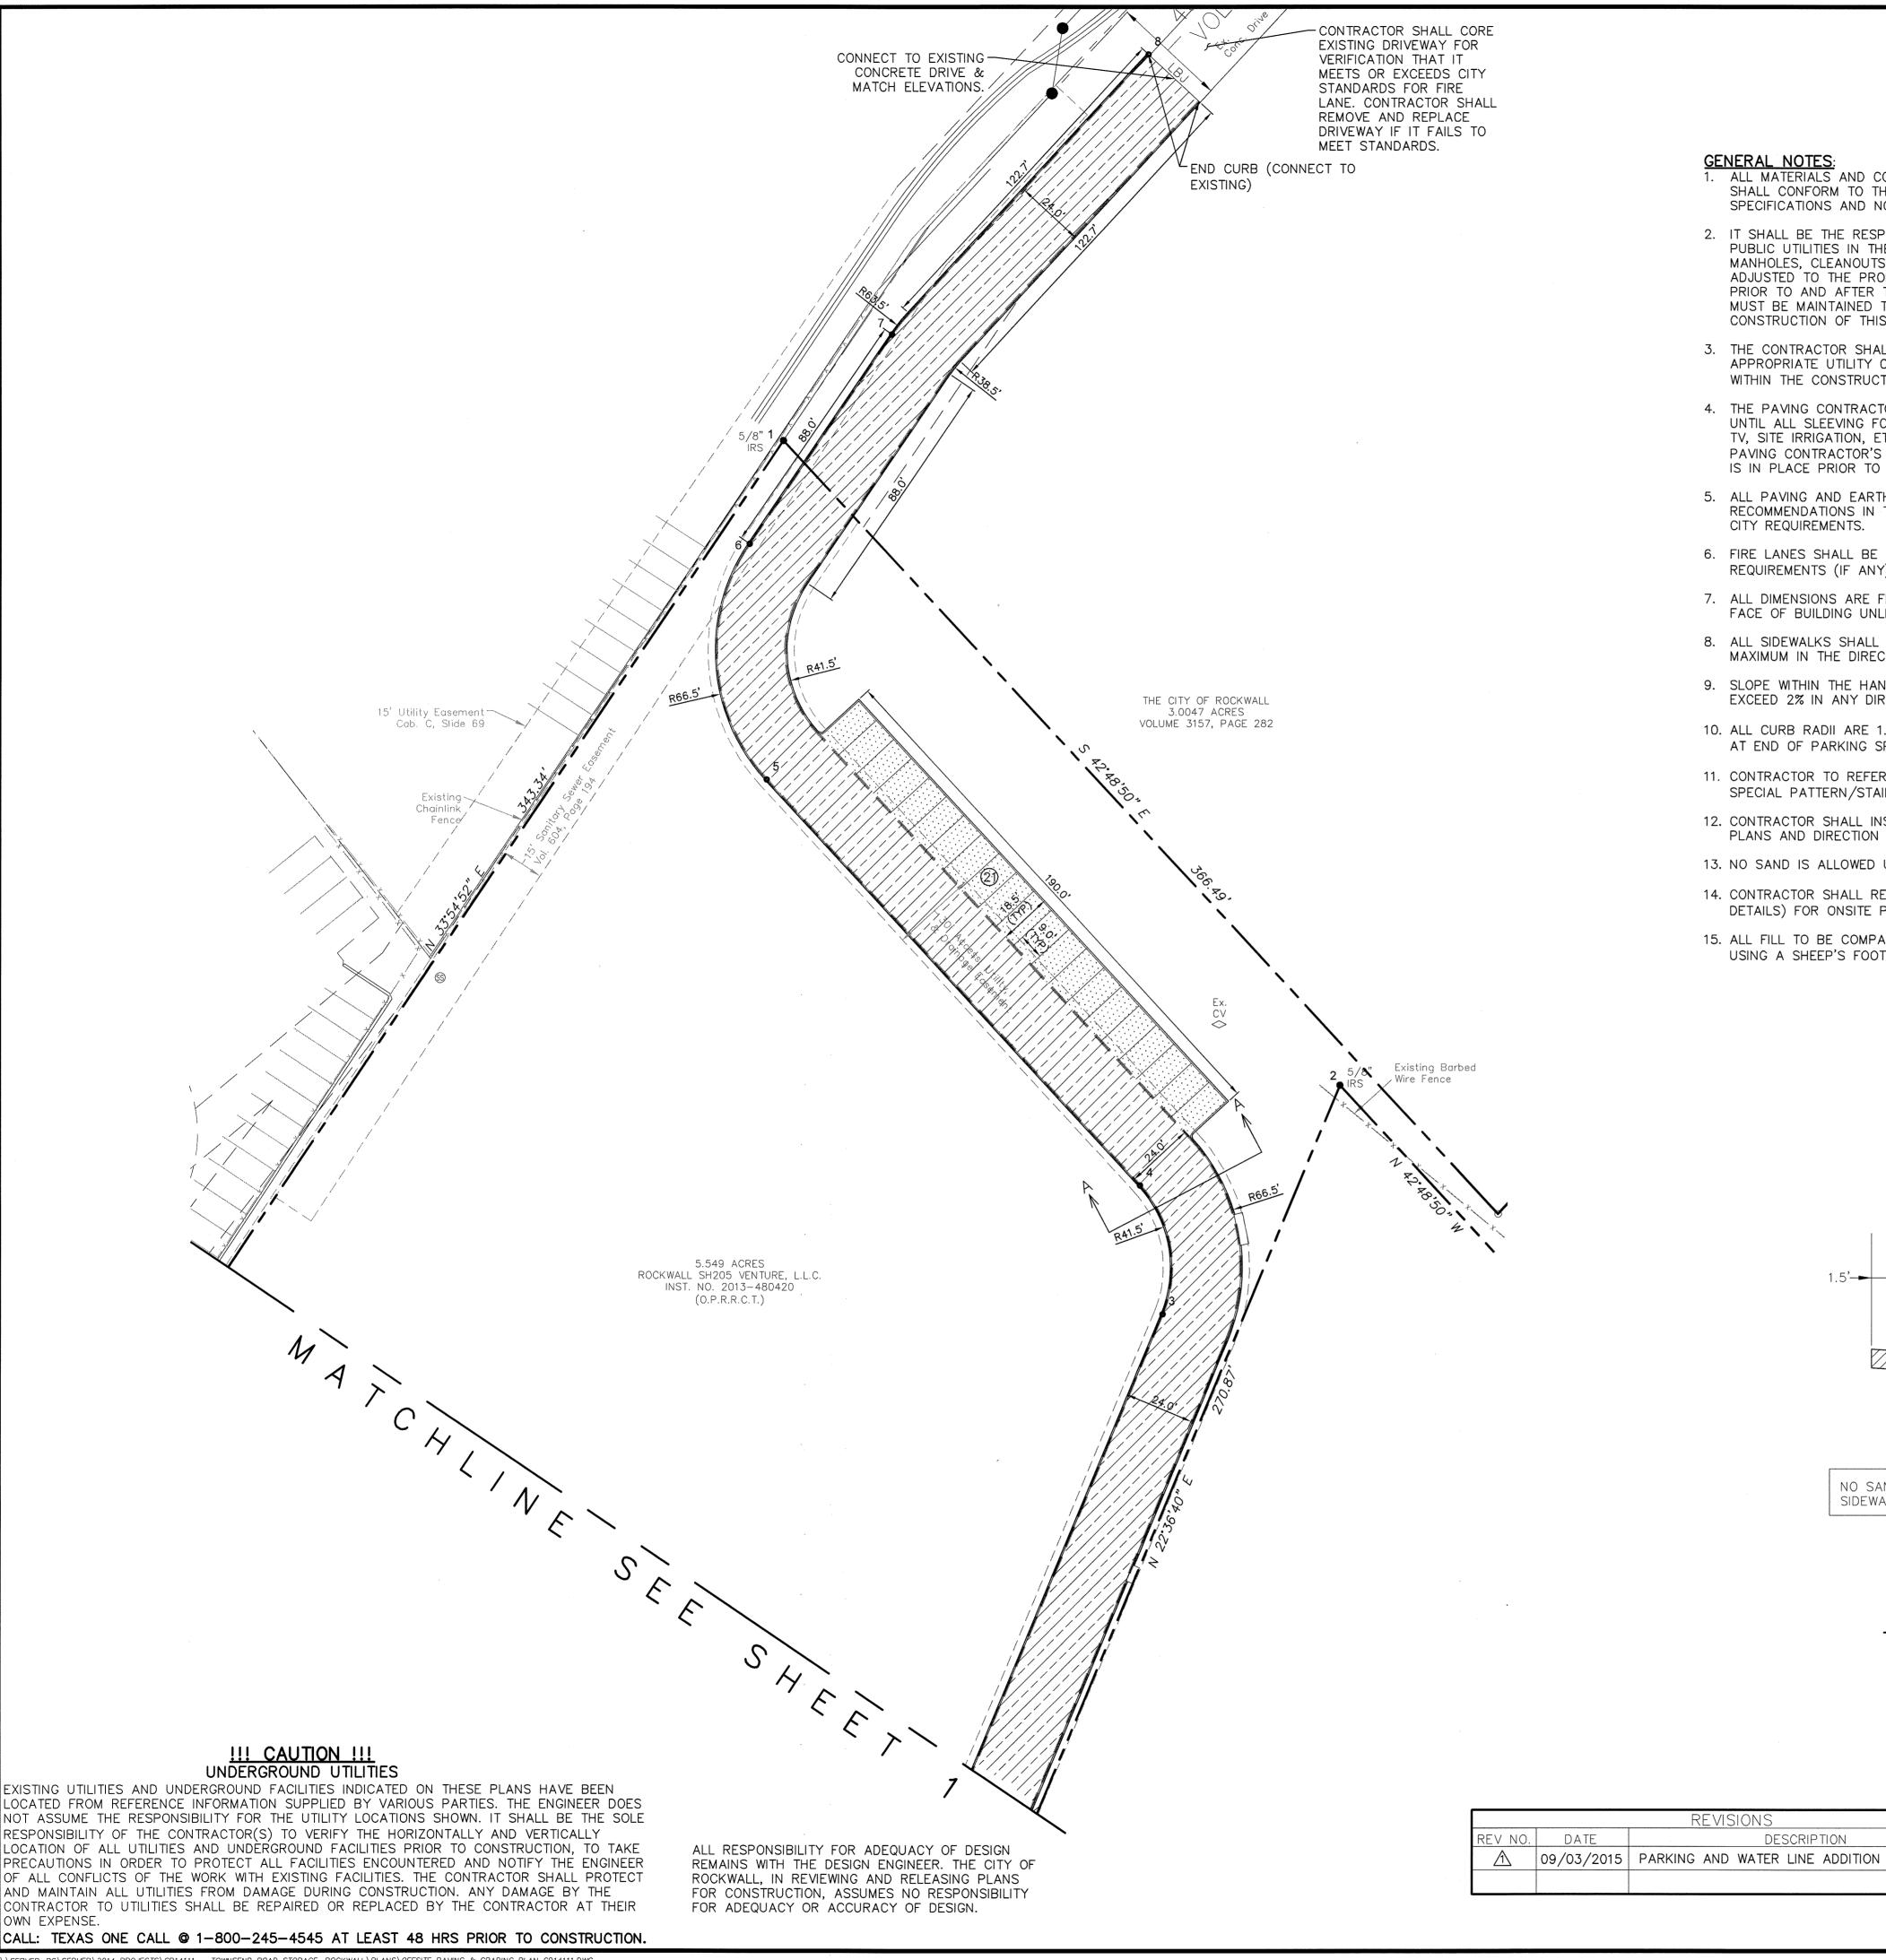

GENERAL NOTES

. ALL MATERIALS AND CONSTRUCTION WITHIN STREET RIGHT-OF-WAY SHALL CONFORM TO THE CITY STANDARD CONSTRUCTION DETAILS AND SPECIFICATIONS AND NCTCOG 3RD EDITION.

- 2. IT SHALL BE THE RESPONSIBILITY OF THE CONTRACTOR TO PROTECT ALL PUBLIC UTILITIES IN THE CONSTRUCTION OF THIS PROJECT. ALL MANHOLES, CLEANOUTS, VALVE BOXES, FIRE HYDRANTS, ETC. MUST BE ADJUSTED TO THE PROPER LINE AND GRADE BY THE CONTRACTOR PRIOR TO AND AFTER THE PLACING OF PERMANENT PAVING. UTILITIES MUST BE MAINTAINED TO PROPER LINE AND GRADE DURING CONSTRUCTION OF THIS PROJECT.
- 3. THE CONTRACTOR SHALL BE RESPONSIBLE FOR COORDINATING WITH ALL APPROPRIATE UTILITY COMPANIES FOR THE LOCATION OF ALL UTILITIES WITHIN THE CONSTRUCTION AREA/SITE.
- 4. THE PAVING CONTRACTOR SHALL NOT PLACE PERMANENT PAVEMENT UNTIL ALL SLEEVING FOR IRRIGATION, ELECTRIC, GAS, TELEPHONE, CABLE TV, SITE IRRIGATION, ETC. HAS BEEN INSTALLED. IT SHALL BE THE PAVING CONTRACTOR'S RESPONSIBILITY TO ENSURE THAT ALL SLEEVING IS IN PLACE PRIOR TO PLACING OF PERMANENT PAVING.
- 5. ALL PAVING AND EARTHWORK OPERATIONS SHALL CONFORM TO THE RECOMMENDATIONS IN THE GEOTECHNICAL INVESTIGATION REPORT & CITY REQUIREMENTS.
- 6. FIRE LANES SHALL BE STRIPED IN ACCORDANCE WITH THE CITY REQUIREMENTS (IF ANY).
- 7. ALL DIMENSIONS ARE FROM BACK OF CURB, EDGE OF PAVEMENT, OR FACE OF BUILDING UNLESS OTHERWISE NOTED.
- 8. ALL SIDEWALKS SHALL MAINTAIN A 2% MAXIMUM CROSS SLOPE AND 5% MAXIMUM IN THE DIRECTION OF PEDESTRIAN TRAVEL.
- 9. SLOPE WITHIN THE HANDICAP PARKING AND STRIPED AREA SHALL NOT EXCEED 2% IN ANY DIRECTION.
- 10. ALL CURB RADII ARE 1.5' UNLESS OTHERWISE SPECIFIED (EXCEPT FOR AT END OF PARKING SPACES AND FLUMES WHERE THE RADII IS 0').
- 11. CONTRACTOR TO REFERENCE ARCHITECT/LANDSCAPE PLANS FOR ANY SPECIAL PATTERN/STAINS OR ANY OTHER PAVEMENT DETAILS.
- 12. CONTRACTOR SHALL INSTALL MASONRY WALL AND GATES PER THE PLANS AND DIRECTION OF THE ARCHITECT.
- 13. NO SAND IS ALLOWED UNDER VEHICULAR PAVING AND SIDEWALKS.
- 14. CONTRACTOR SHALL REFERENCE DETAIL SHEET (PAVEMENT & SIDEWALK DETAILS) FOR ONSITE PAVING.
- 15. ALL FILL TO BE COMPACTED TO A MINIMUM OF 95% STANDARD DENSITY USING A SHEEP'S FOOT ROLLER.

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07/14/2018

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LEGEND

- EXISTING CURB


- PROPOSED CURB

7" 3600 PSI REINFORCED CONCRETE ON - STABILIZED AND COMPACTED SUBGRADE PER GEOTECHNICAL REPORT (MINIMUM 6.5 SACK MIX).



6" 3600 PSI REINFORCED CONCRETE PAVEMENT - ON STABILIZED AND COMPACTED SUBGRADE PER GEOTECHNICAL REPORT. (MINIMUM 6.5 SACK MIX)

Point #	Northing	Easting
1	-7683.2597	2585.0138
2	-7907.3106	2778.9604
3	-7986.7890	2717.2307
4	-7942.1533	2709.3392
5	-7801.1063	2579.2481
6	-7719.1609	2573.2447
7	-7646.4813	2622.8347
8	-7549.1609	2712.1229

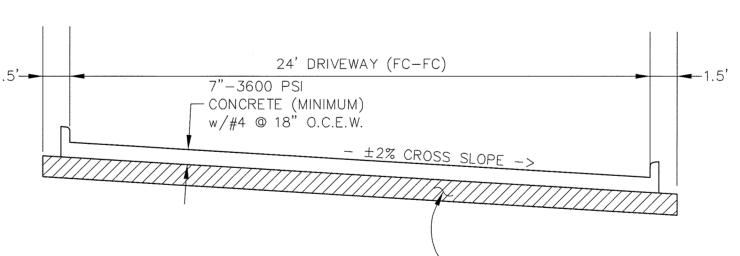

NO SAND ALLOWED UNDER VEHICULAR PAVING &

REVISIONS

PER THE GEOTECHNICAL REPORT, CONTRACTOR TO REMOVE THE TOP 24" OF TOP SOIL AND REPLACE WITH SELECT FILL, COMPACTED TO BETWEEN 95 TO 100 PERCENT OF THE MAXIMUM DRY DENSITY AS DEFINED BY ASTM 698 (STANDARD PROCTOR TEST) WITH THE MOISTURE CONTENT BETWEEN OPTIMUM AND 3 PERCENTAGE POINTS ABOVE OPTIMUM. THE NEXT 10 FEET SHOULD BE STABILIZED USING CHEMICAL INJECTIONS.

TYPICAL PAVING SECTION A-A

NOTE: THESE AS BUILT PLANS HAVE

BEEN REVISED TO CONFORM WITH

CONSTRUCTION RECORDS PROVIDED

BY THE CONTRACTOR AND A POST

CONSTRUCTION SURVEY.

NE CORNER OF THE CONCRETE CURB INLET LOCATED ON THE NE CORNER OF "COSTO" WAREHOUSE ALONG THE EASTERN ELEVATION= 539.71

NORTHERN CORNER OF EXISTING CURB INLET ALONG TOWNSEND ROAD, APPROXIMATELY 630 FEET SOUTH EAST OF THE INTERSECTION OF THE 130 EB SERVICE ROAD AND TOWNSEND ELEVATION= 537.64

CITY OF ROCKWALL CONTROL MONUMENT #19 ELEVATION= 600.68

CASE #SP2014-033


\\SERVER-PC\SERVER\2014 PROJECTS\CD14111 - TOWNSEND ROAD STORAGE, ROCKWALL\PLANS\OFFSITE PAVING & GRADING PLAN CD14111.DWG

PLOT DATE 07/14/16 DRAWING SCALE

1" = 30'

PROJECT NUMBER CD14111

SHEET NUMBER

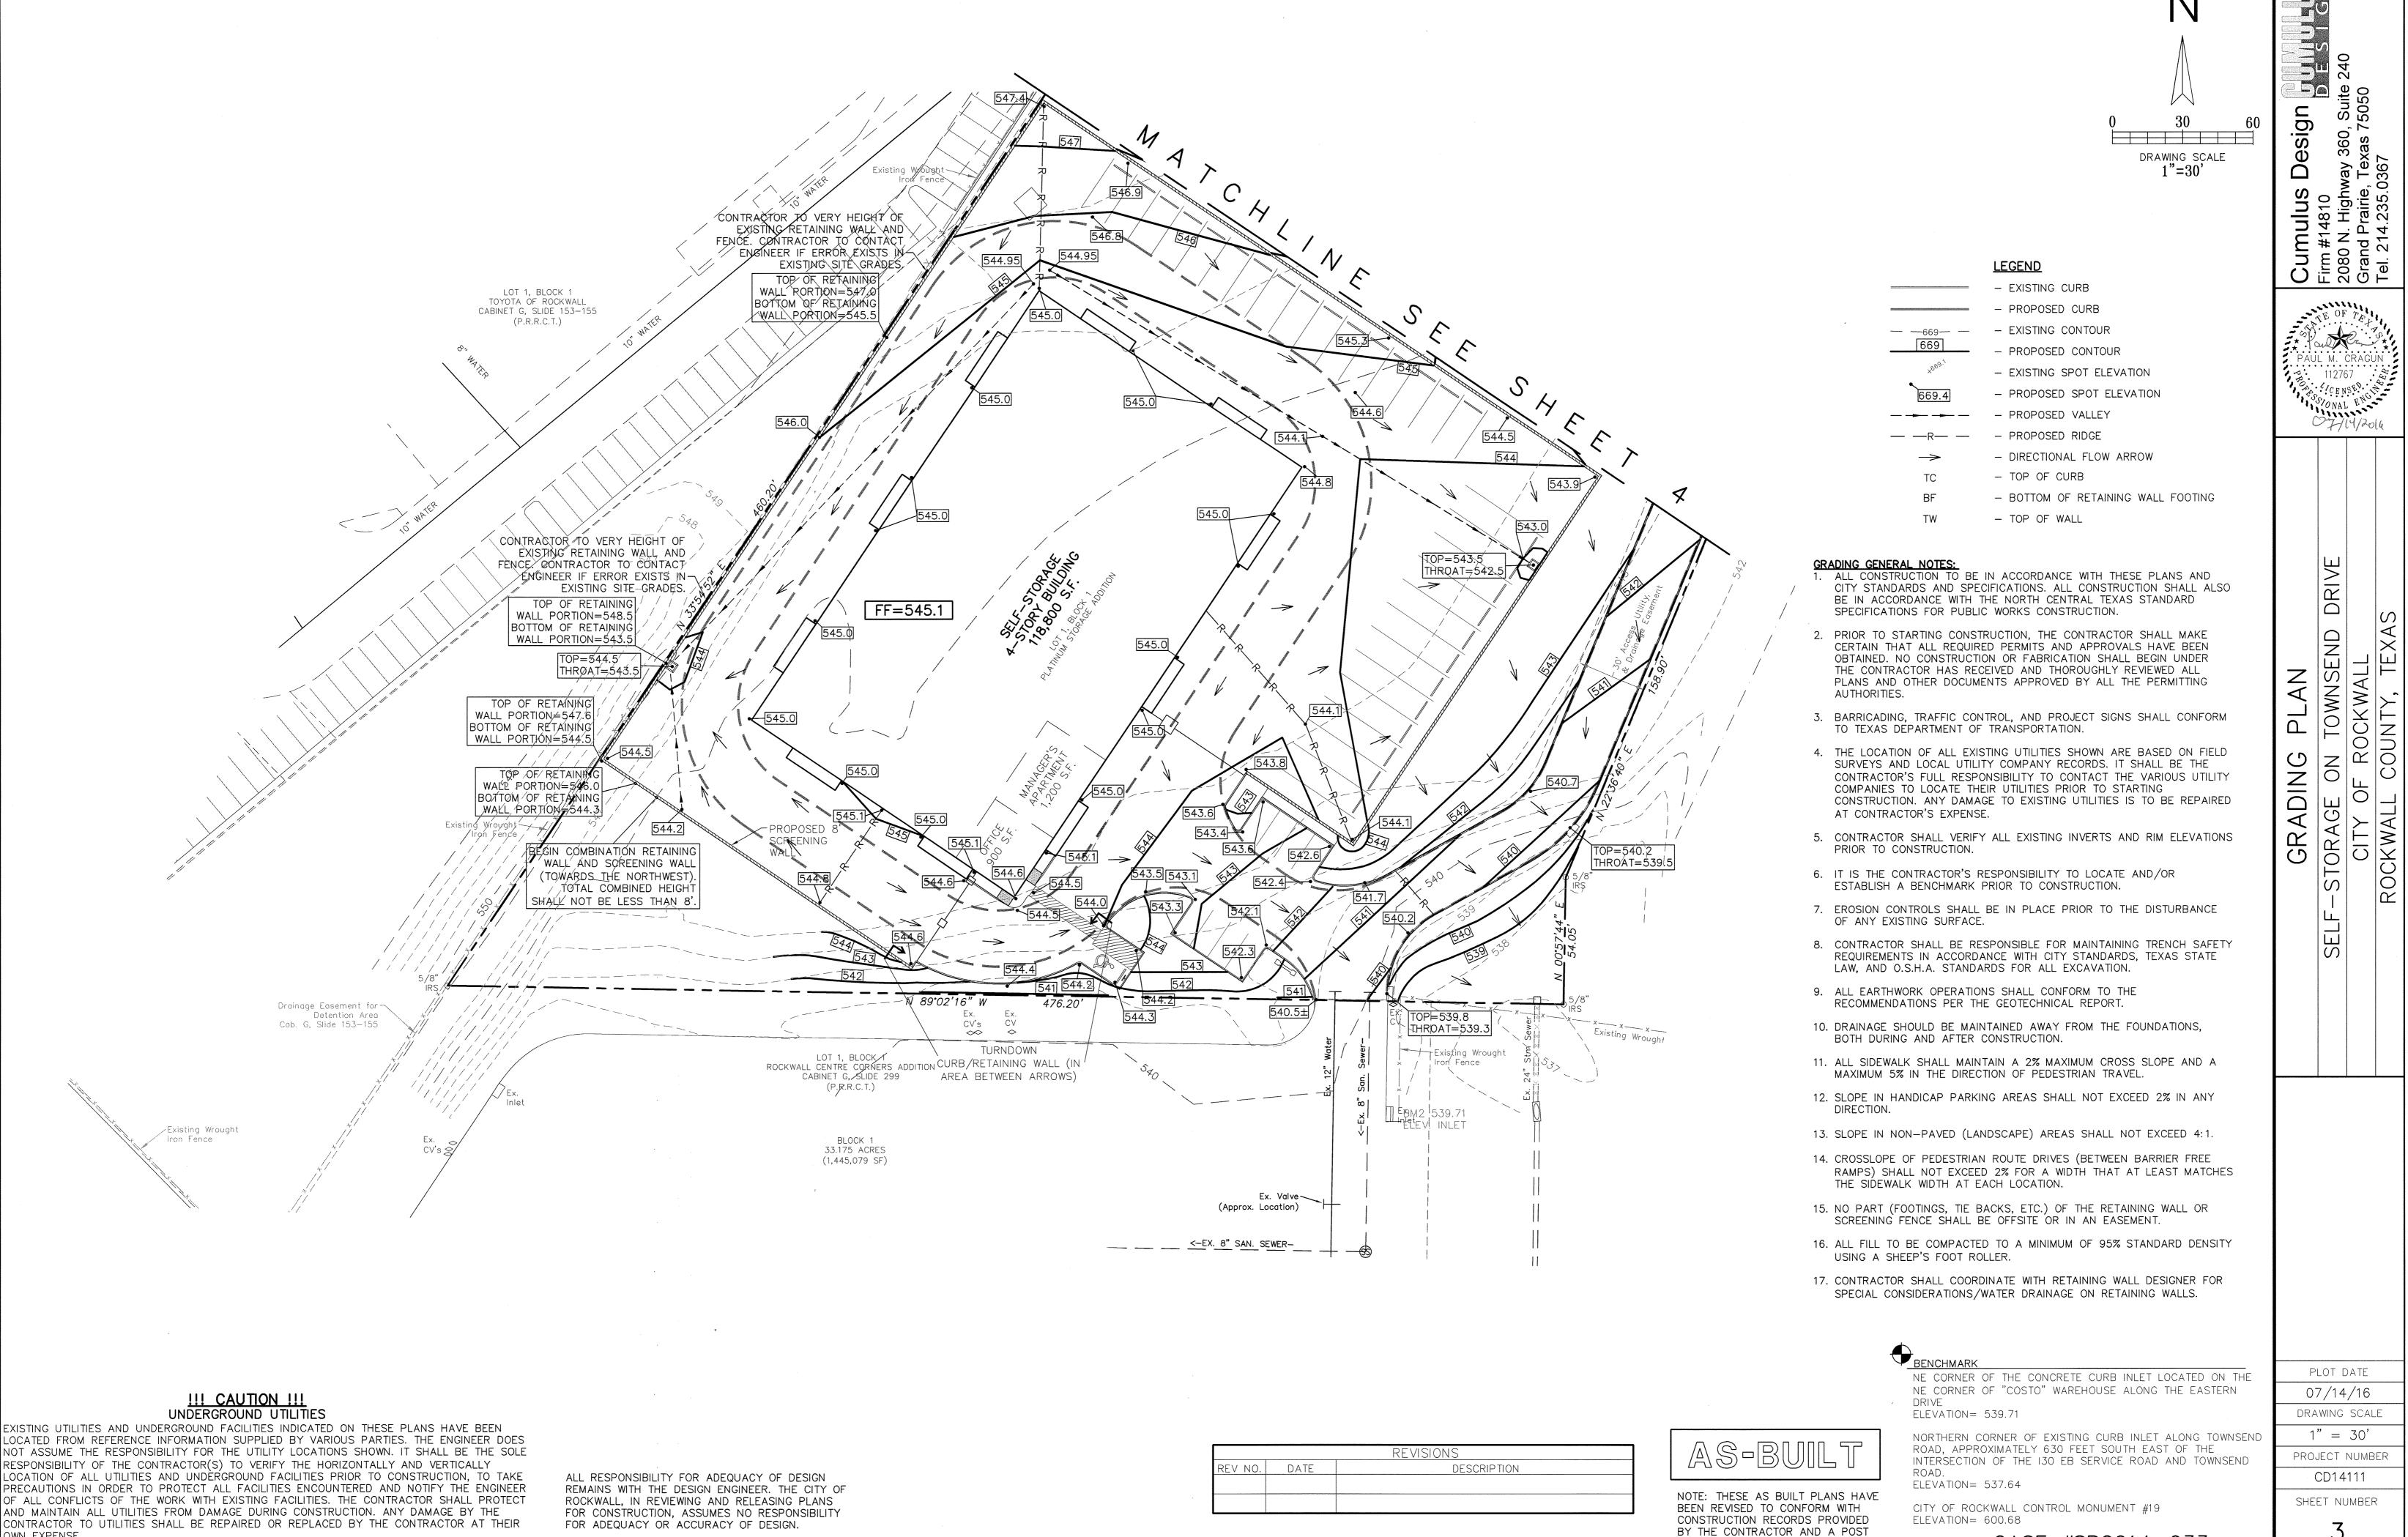



CALL: TEXAS ONE CALL @ 1-800-245-4545 AT LEAST 48 HRS PRIOR TO CONSTRUCTION


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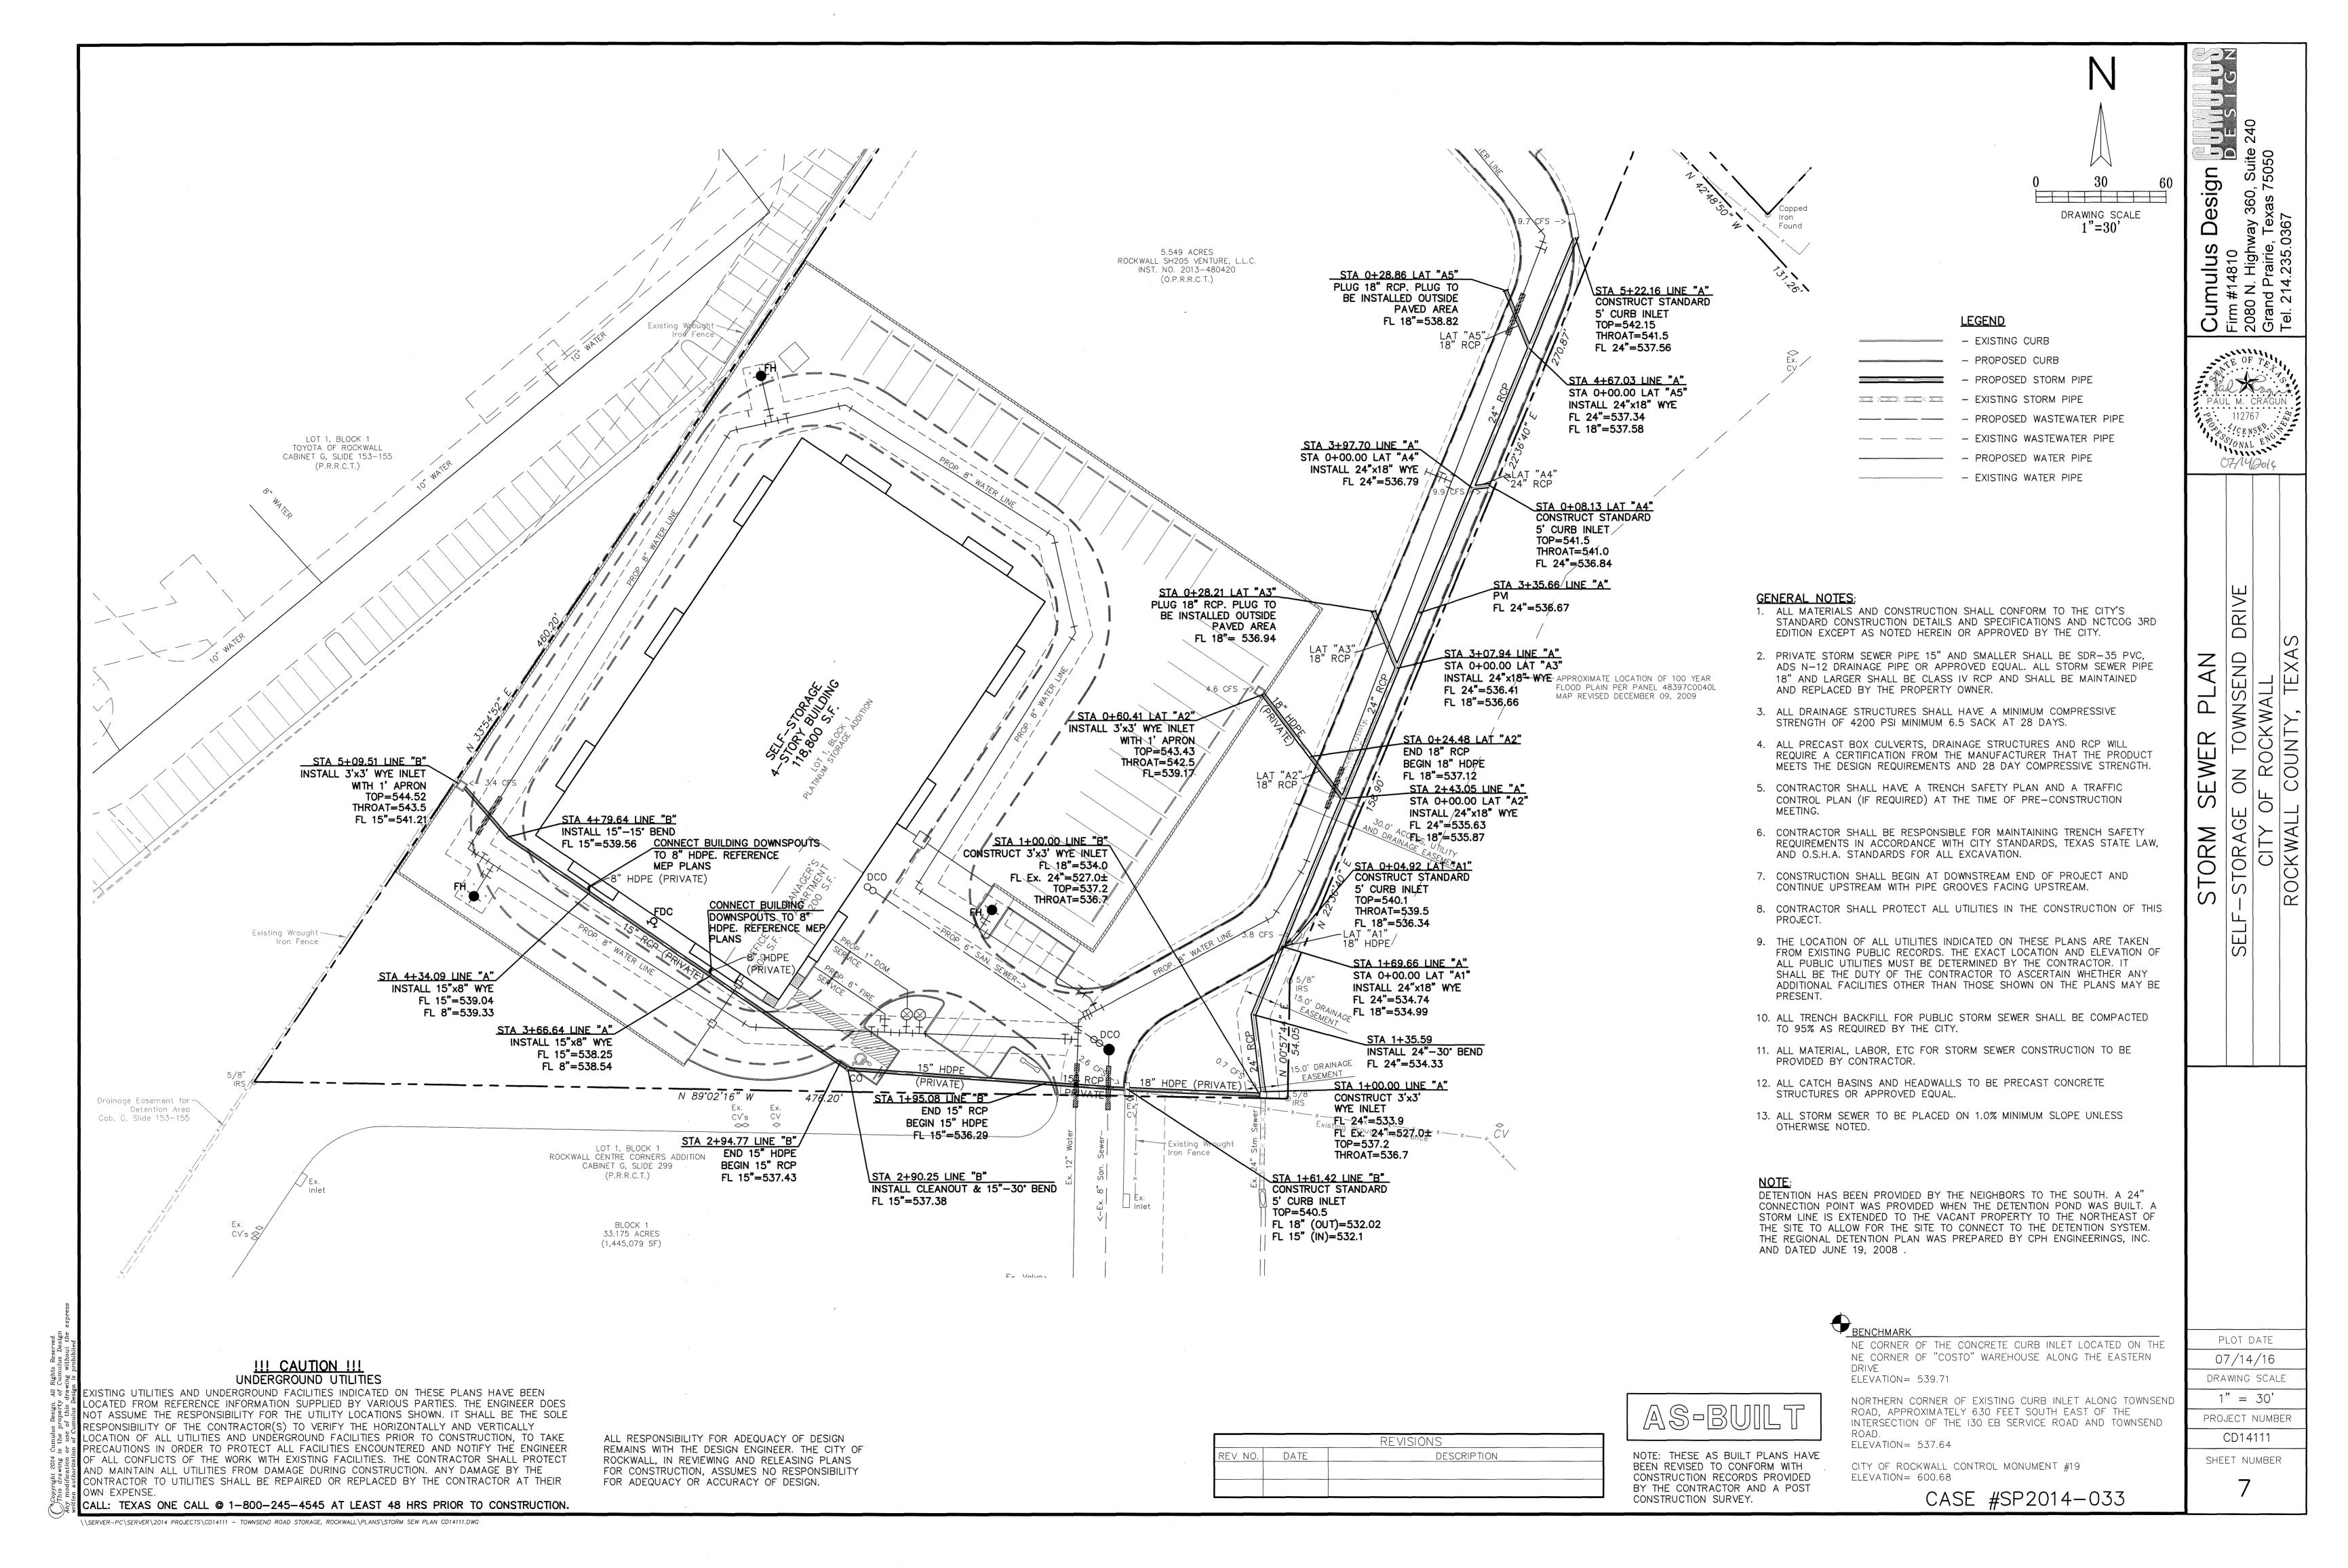
CASE #SP2014-033

CONSTRUCTION SURVEY.




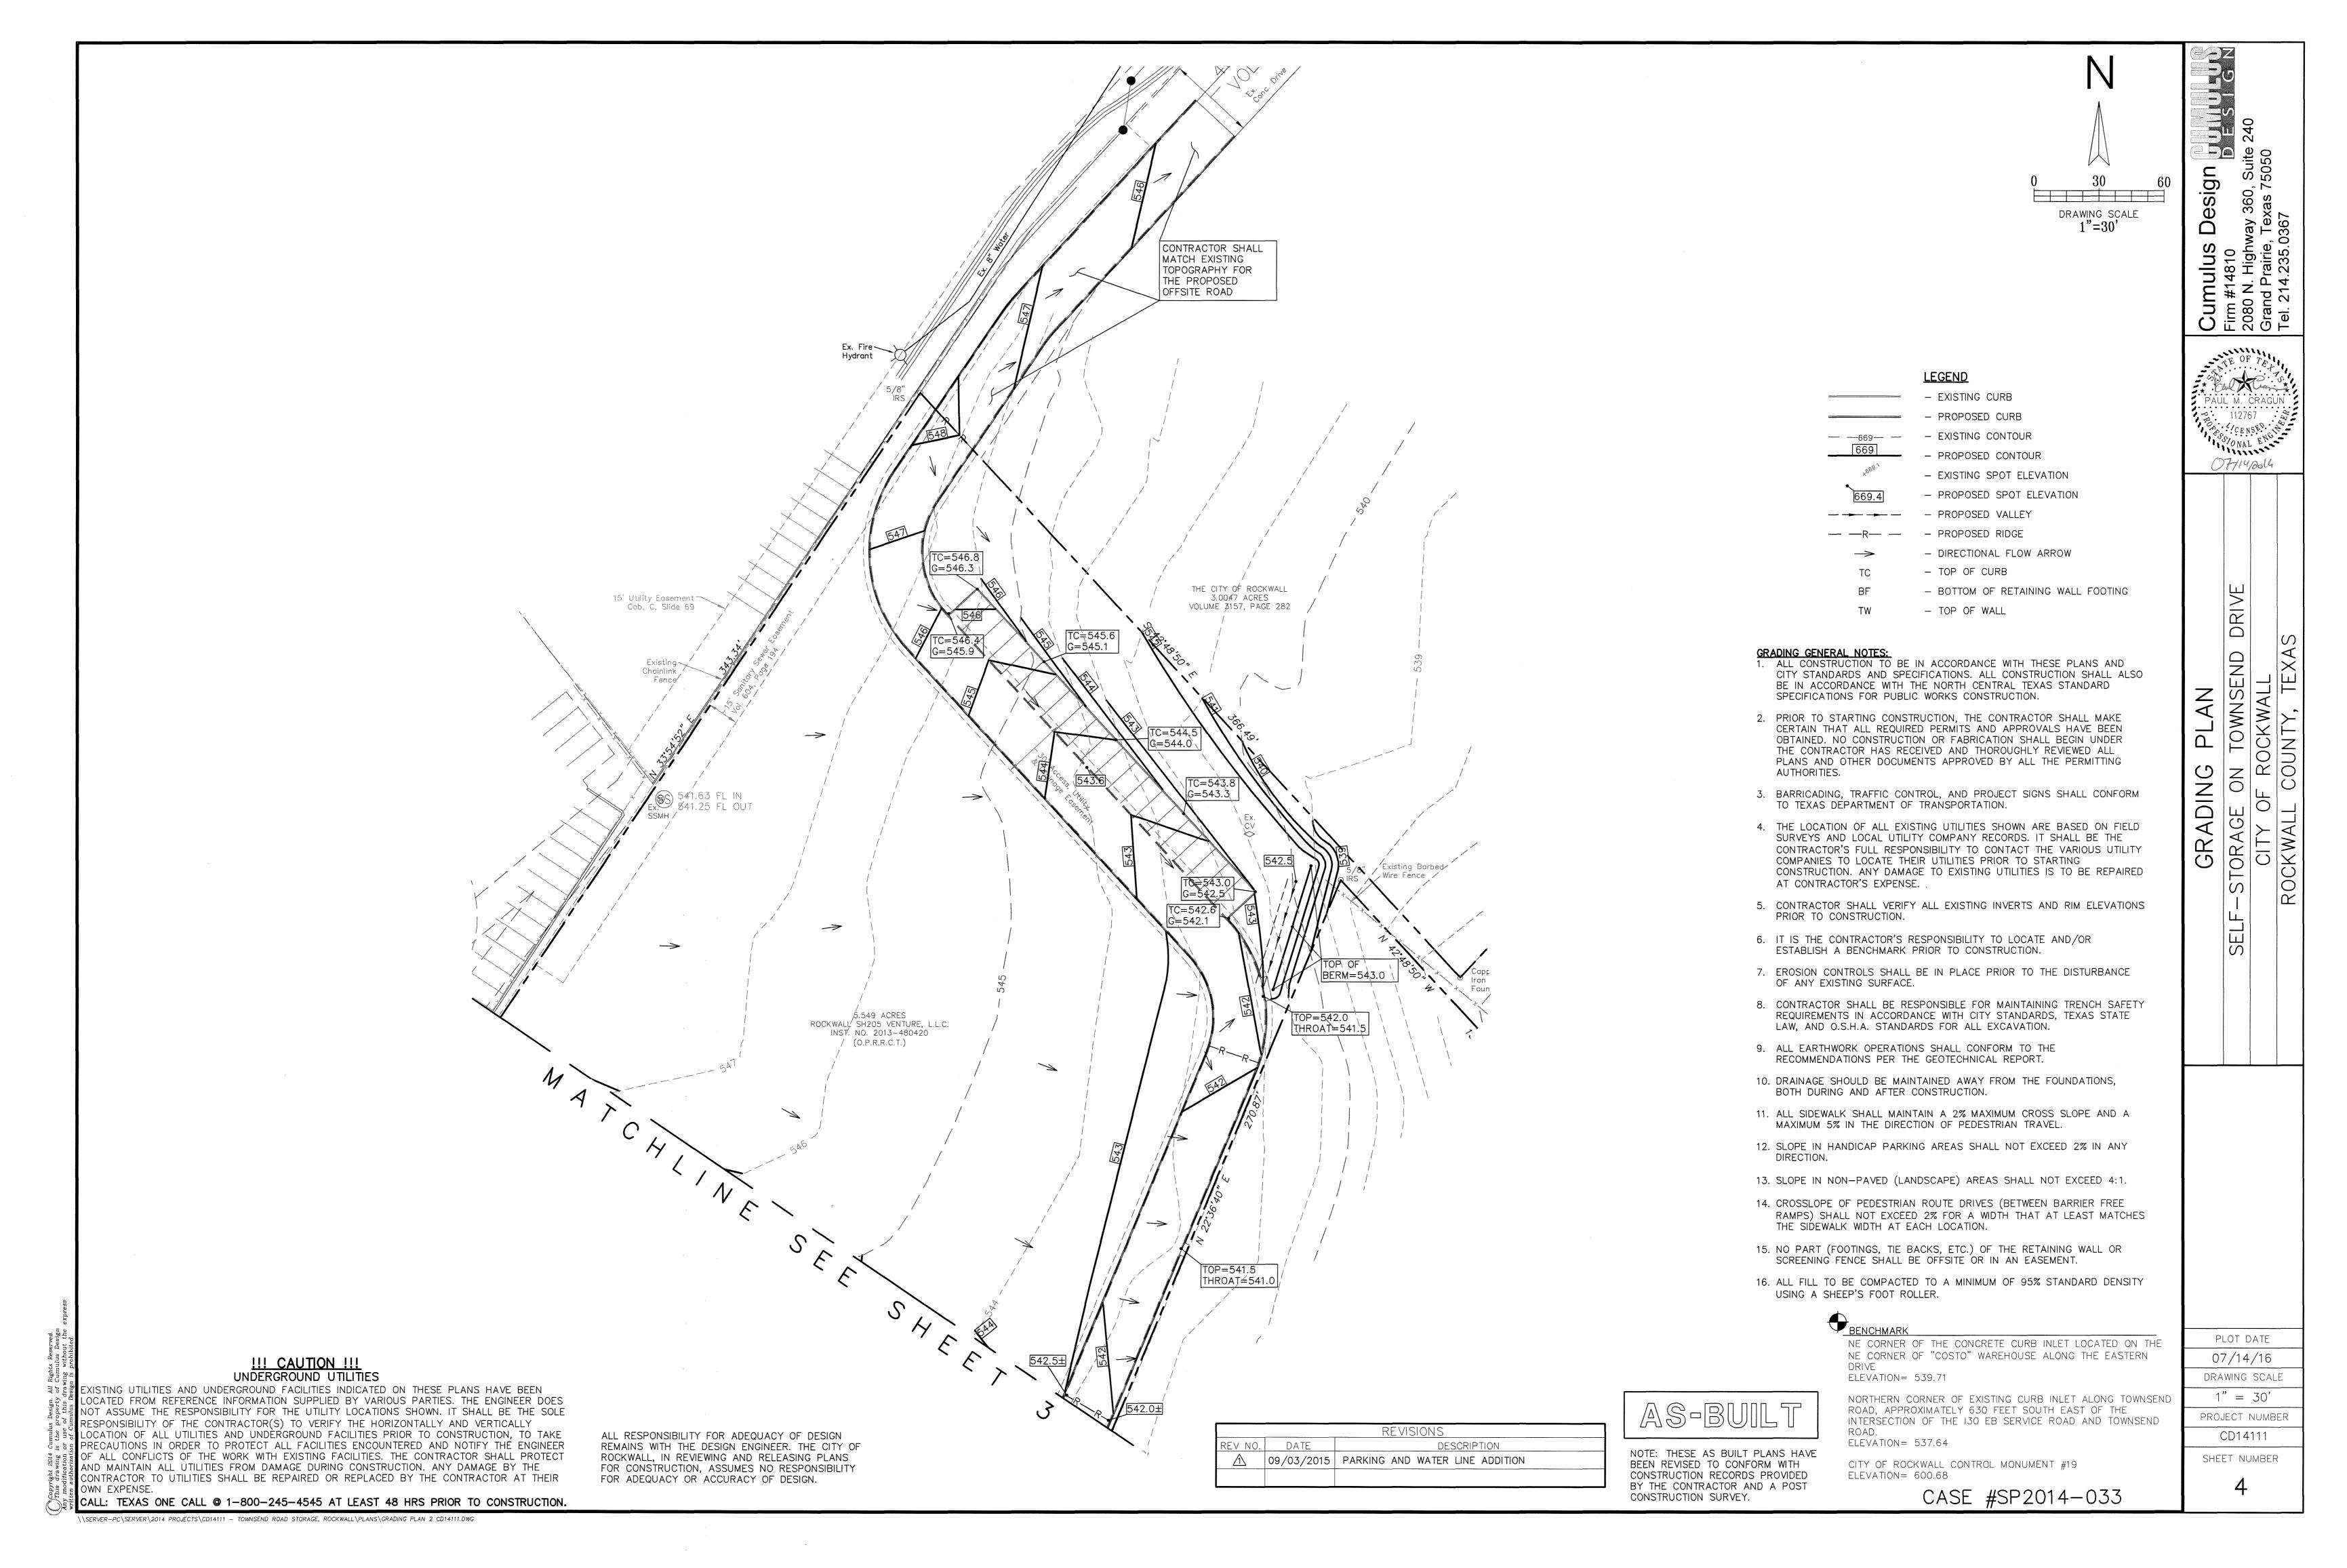

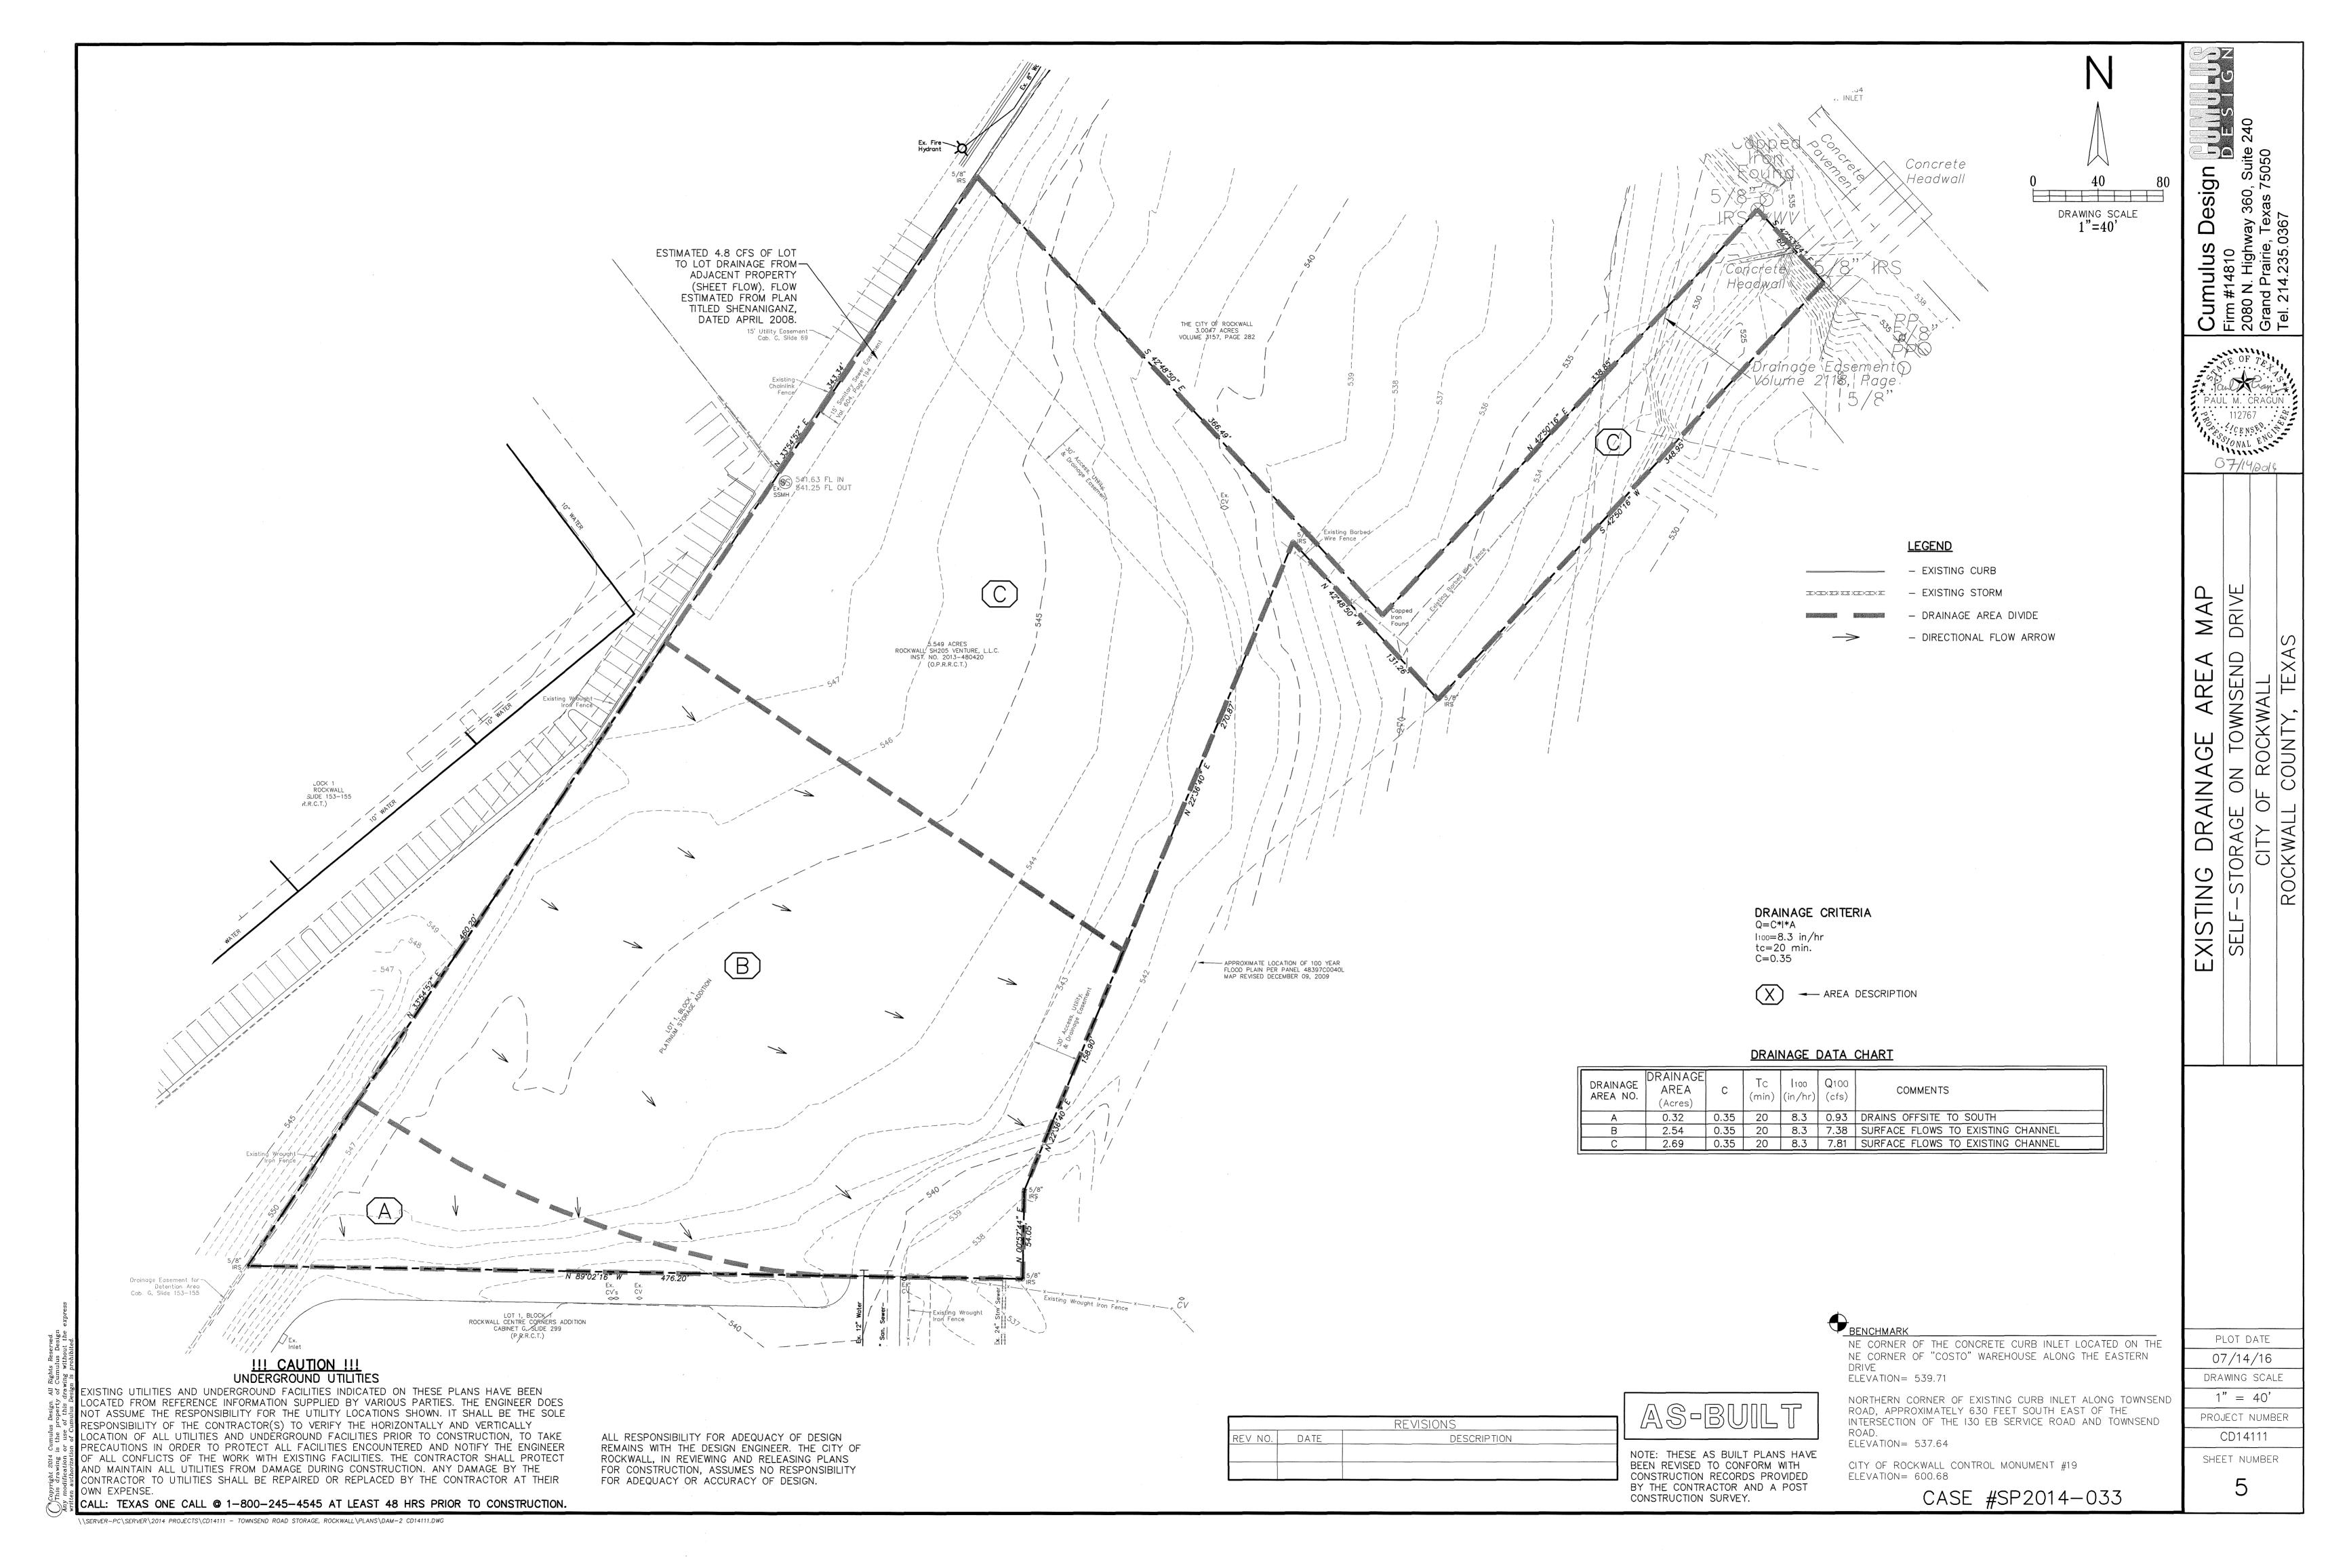

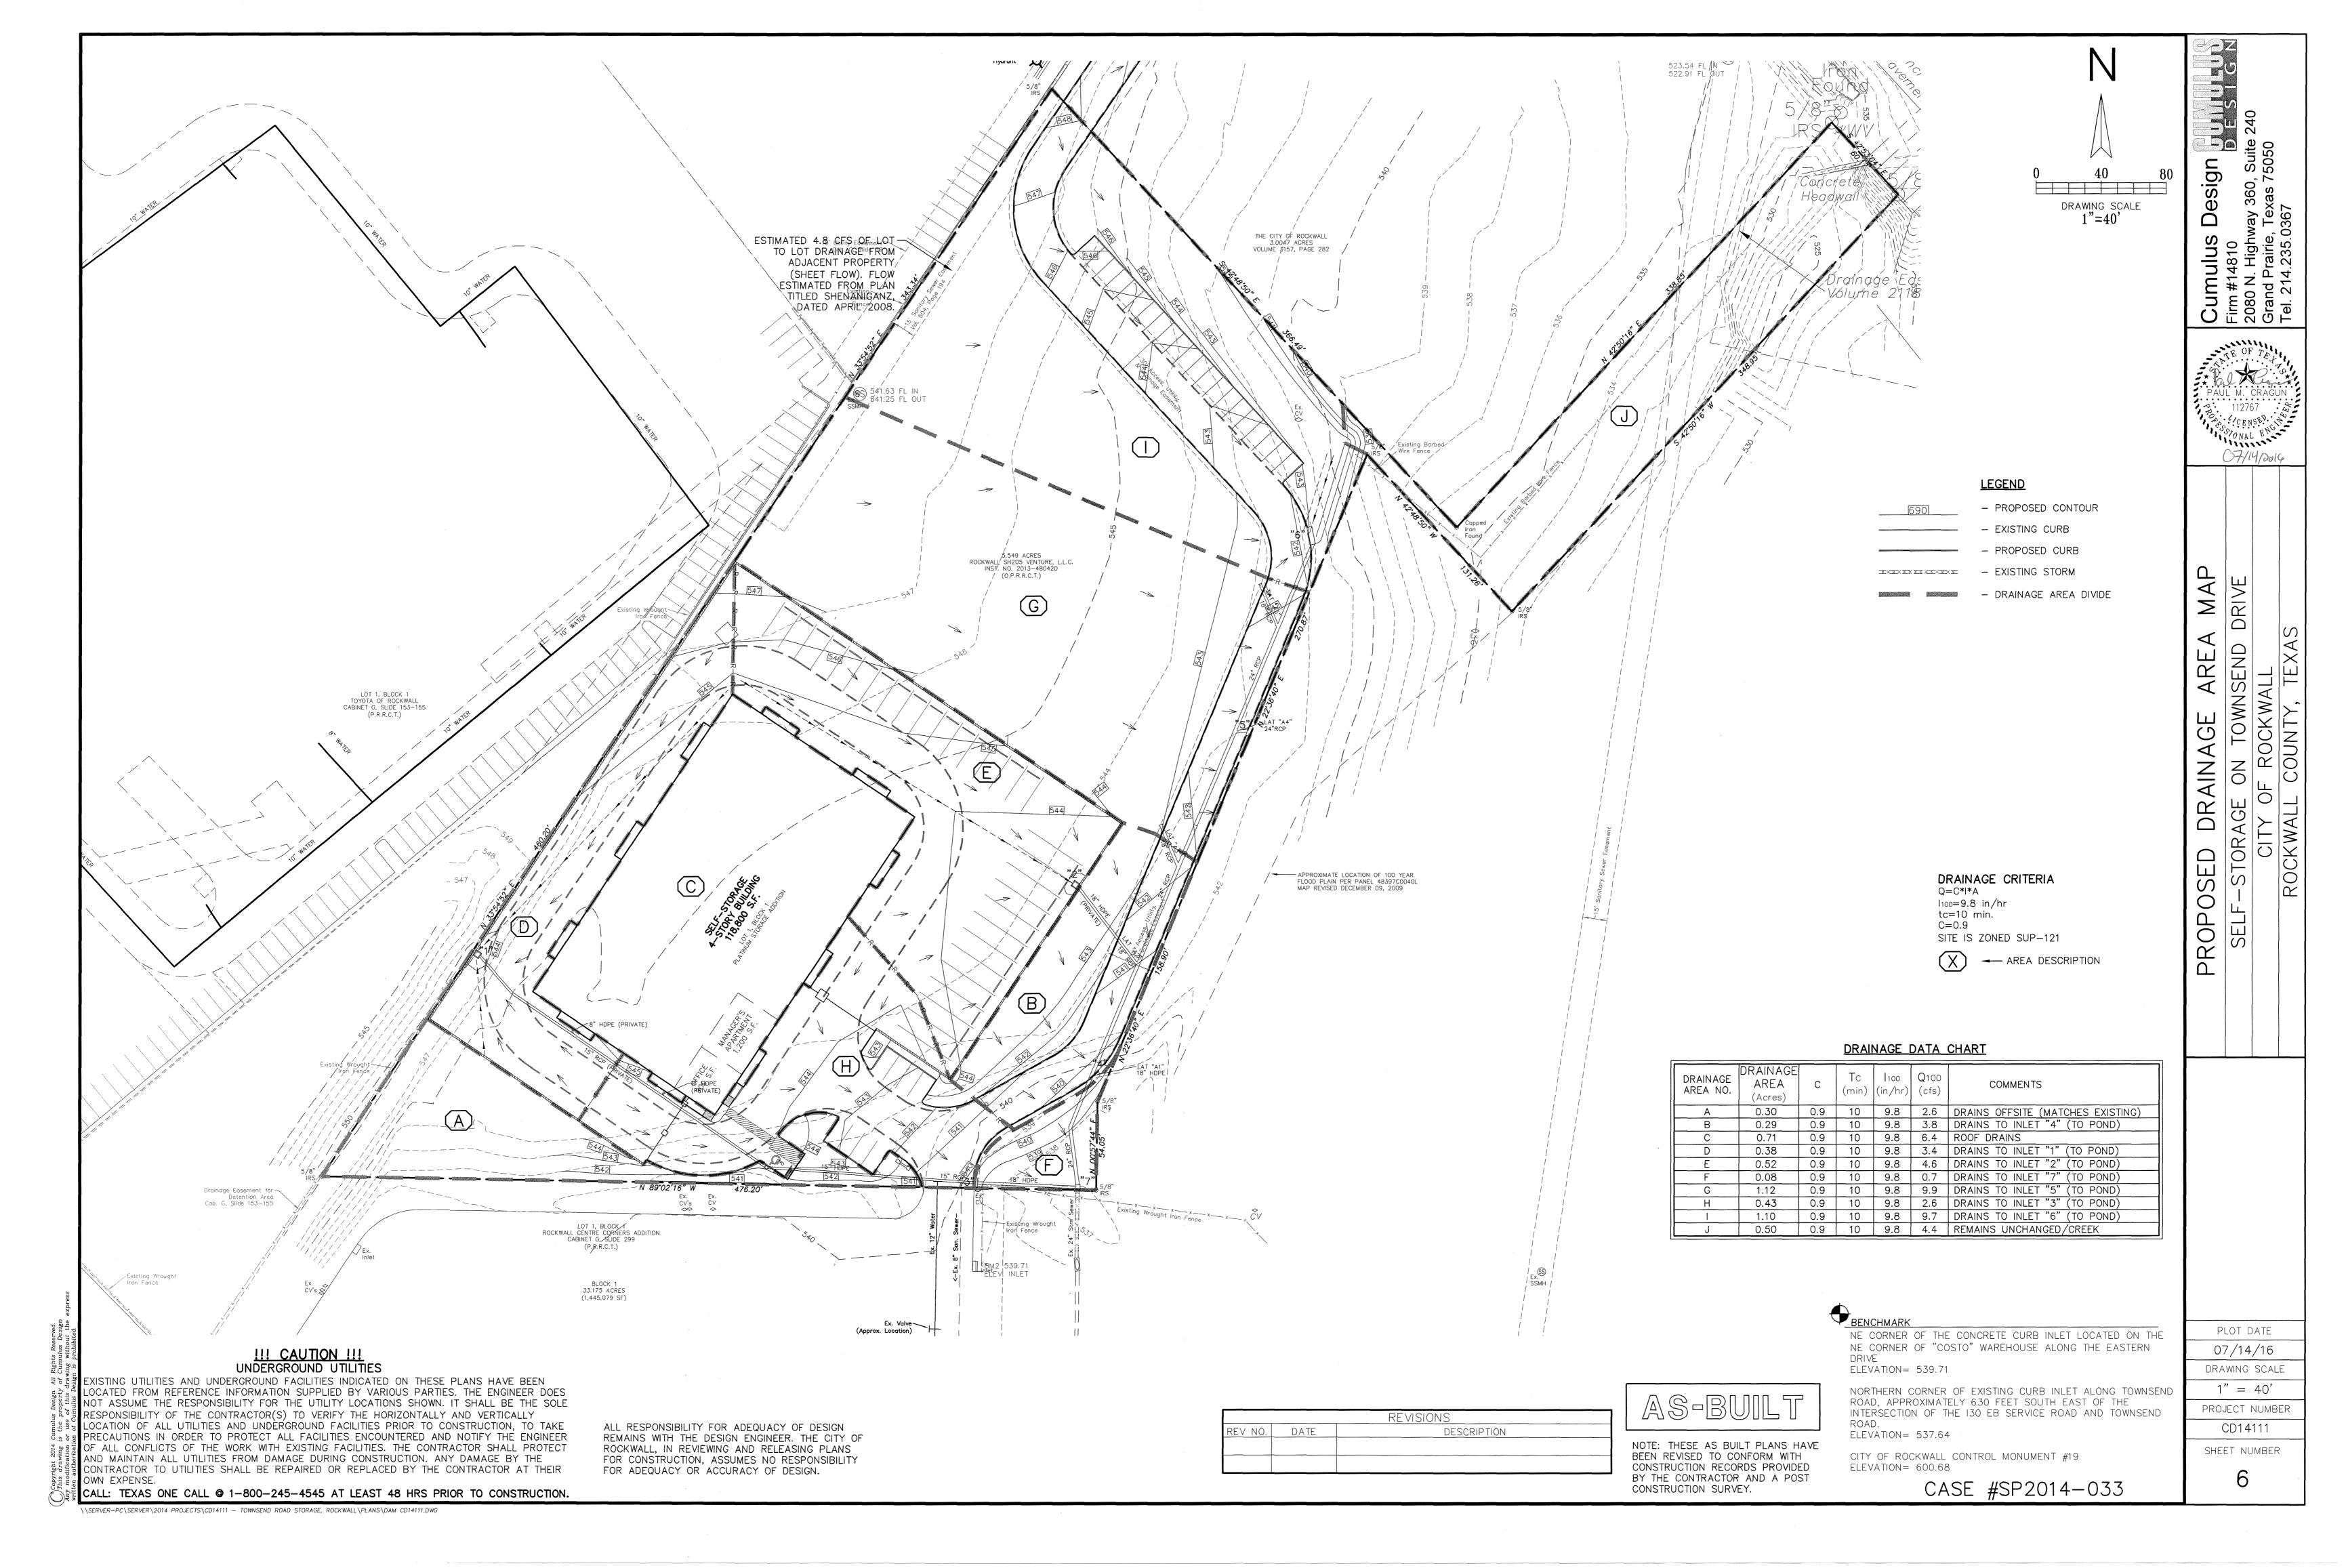

565 565 560 560 555 555 550 550 <u>24" RCP</u> Q100=28.0 cfs Qcap=24.9 cfs V=8.9 fps PROPOSED GRADE 545 545 S=0.0152 ft/ft @ Q OF PIPE T 24" RCP Q100=28.0 cfs EXISTING GRADE ● € OF PIPE Qcap=24.9 cfs 540 540 V=8.9 fps S=0.0152 ft/ft RCP ON 0.5% (CLASS IV) 24" RCP ON 1.2% 24" RCP Q100=9.7 cfs 535 24" RCP Q100=9.7 cfs Qcap=16.0 cfs V=3.1 fps 535 <u>24" RCP</u> Q100=19.6 cfs Qcap=16.0 cfs V=3.1 fps 24" RCP Q100=24.2 cfs Qcap=24.9 cfs V=7.7 fps S=0.0114 ft/ft Qcap=16.0 cfs Qcap=24.9 cfs V=6.2 fps S=0.0075 ft/ft V=6.2 fps S=0.0035 ft/ft D=1.25 S=.0075 ft/ft S=0.0018 ft/ft 530 530 Q100=19.6 cfs Qcap=24.9 cfs V=6.2 fps S=.0075 ft/ft 525 1"=40' H "= 6' V 520 0+00 3+00 5+00 6+00 4+00 1+00 2+00 7+00

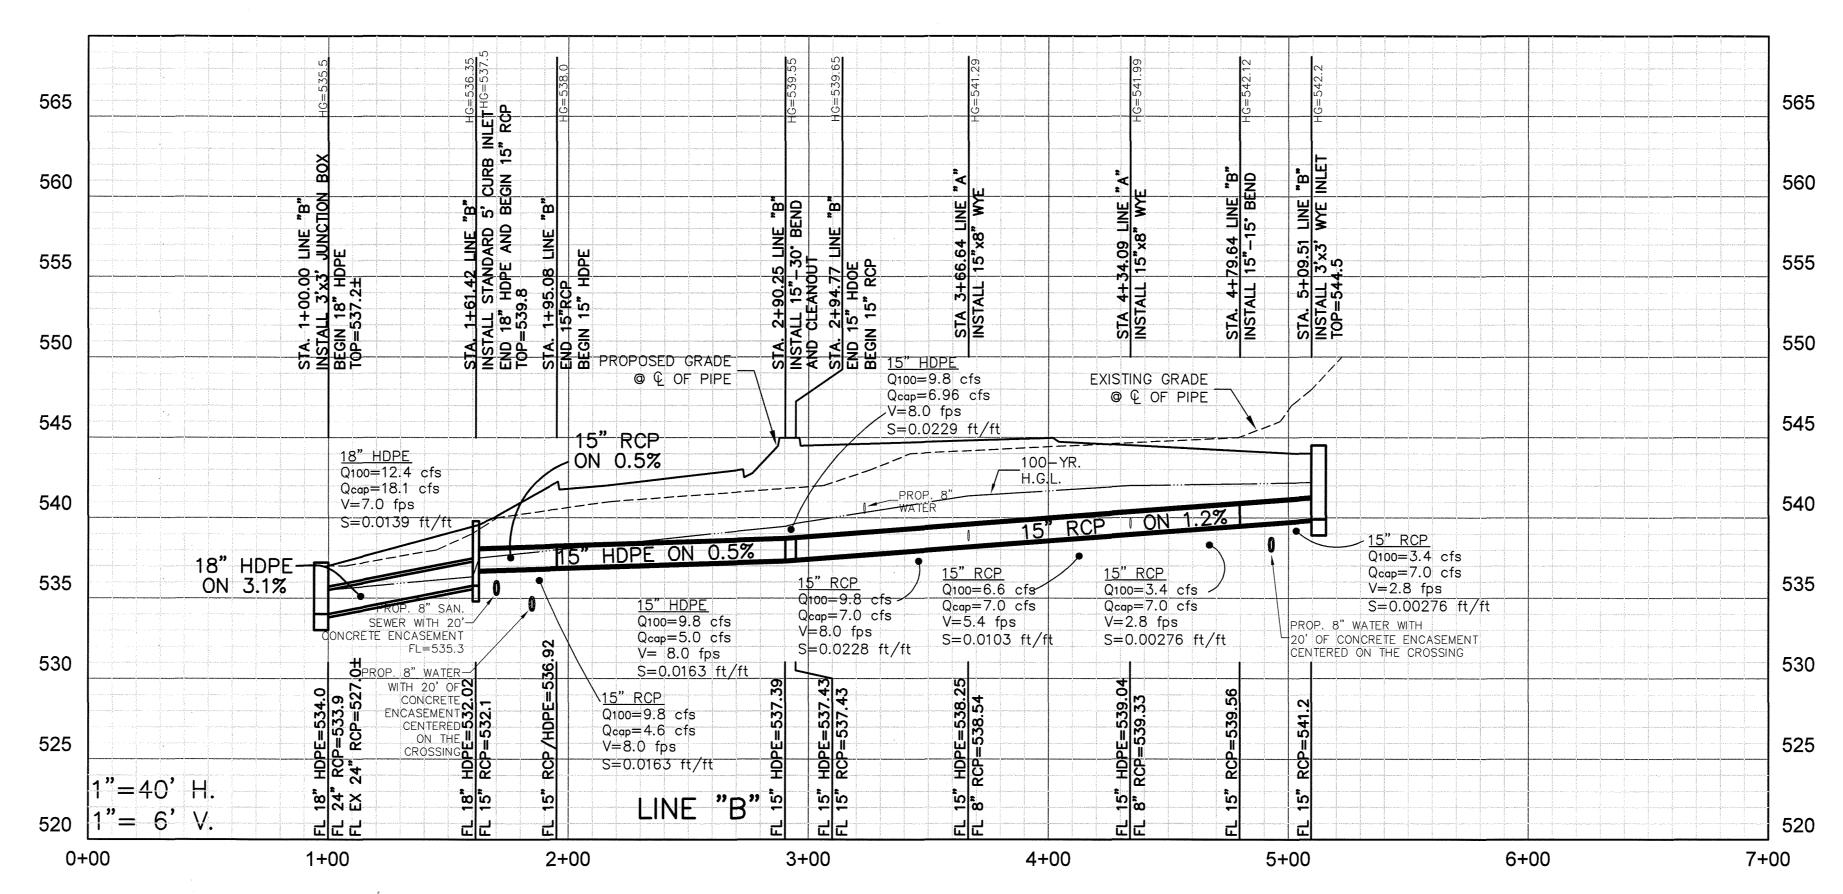

!!! CAUTION !!! UNDERGROUND UTILITIES

XISTING UTILITIES AND UNDERGROUND FACILITIES INDICATED ON THESE PLANS HAVE BEEN OCATED FROM REFERENCE INFORMATION SUPPLIED BY VARIOUS PARTIES. THE ENGINEER DOES NOT ASSUME THE RESPONSIBILITY FOR THE UTILITY LOCATIONS SHOWN. IT SHALL BE THE SOLE RESPONSIBILITY OF THE CONTRACTOR(S) TO VERIFY THE HORIZONTALLY AND VERTICALLY LOCATION OF ALL UTILITIES AND UNDERGROUND FACILITIES PRIOR TO CONSTRUCTION, TO TAKE PRECAUTIONS IN ORDER TO PROTECT ALL FACILITIES ENCOUNTERED AND NOTIFY THE ENGINEER OF ALL CONFLICTS OF THE WORK WITH EXISTING FACILITIES. THE CONTRACTOR SHALL PROTECT AND MAINTAIN ALL UTILITIES FROM DAMAGE DURING CONSTRUCTION. ANY DAMAGE BY THE CONTRACTOR TO UTILITIES SHALL BE REPAIRED OR REPLACED BY THE CONTRACTOR AT THEIR OWN EXPENSE.

ALL RESPONSIBILITY FOR ADEQUACY OF DESIGN REMAINS WITH THE DESIGN ENGINEER. THE CITY OF ROCKWALL, IN REVIEWING AND RELEASING PLANS FOR CONSTRUCTION, ASSUMES NO RESPONSIBILITY FOR ADEQUACY OR ACCURACY OF DESIGN.

REVISIONS DESCRIPTION REV NO. DATE

NOTE: THESE AS BUILT PLANS HAVE BEEN REVISED TO CONFORM WITH CONSTRUCTION RECORDS PROVIDED BY THE CONTRACTOR AND A POST CONSTRUCTION SURVEY.

NE CORNER OF "COSTO" WAREHOUSE ALONG THE EASTERN ELEVATION= 539.71

NORTHERN CORNER OF EXISTING CURB INLET ALONG TOWNSEND ROAD, APPROXIMATELY 630 FEET SOUTH EAST OF THE INTERSECTION OF THE 130 EB SERVICE ROAD AND TOWNSEND ELEVATION= 537.64

NE CORNER OF THE CONCRETE CURB INLET LOCATED ON THE

CITY OF ROCKWALL CONTROL MONUMENT #19 ELEVATION= 600.68

CASE #SP2014-033

67/14/201e TORM PLOT DATE 07/14/16 DRAWING SCALE PROJECT NUMBER CD14111 SHEET NUMBER

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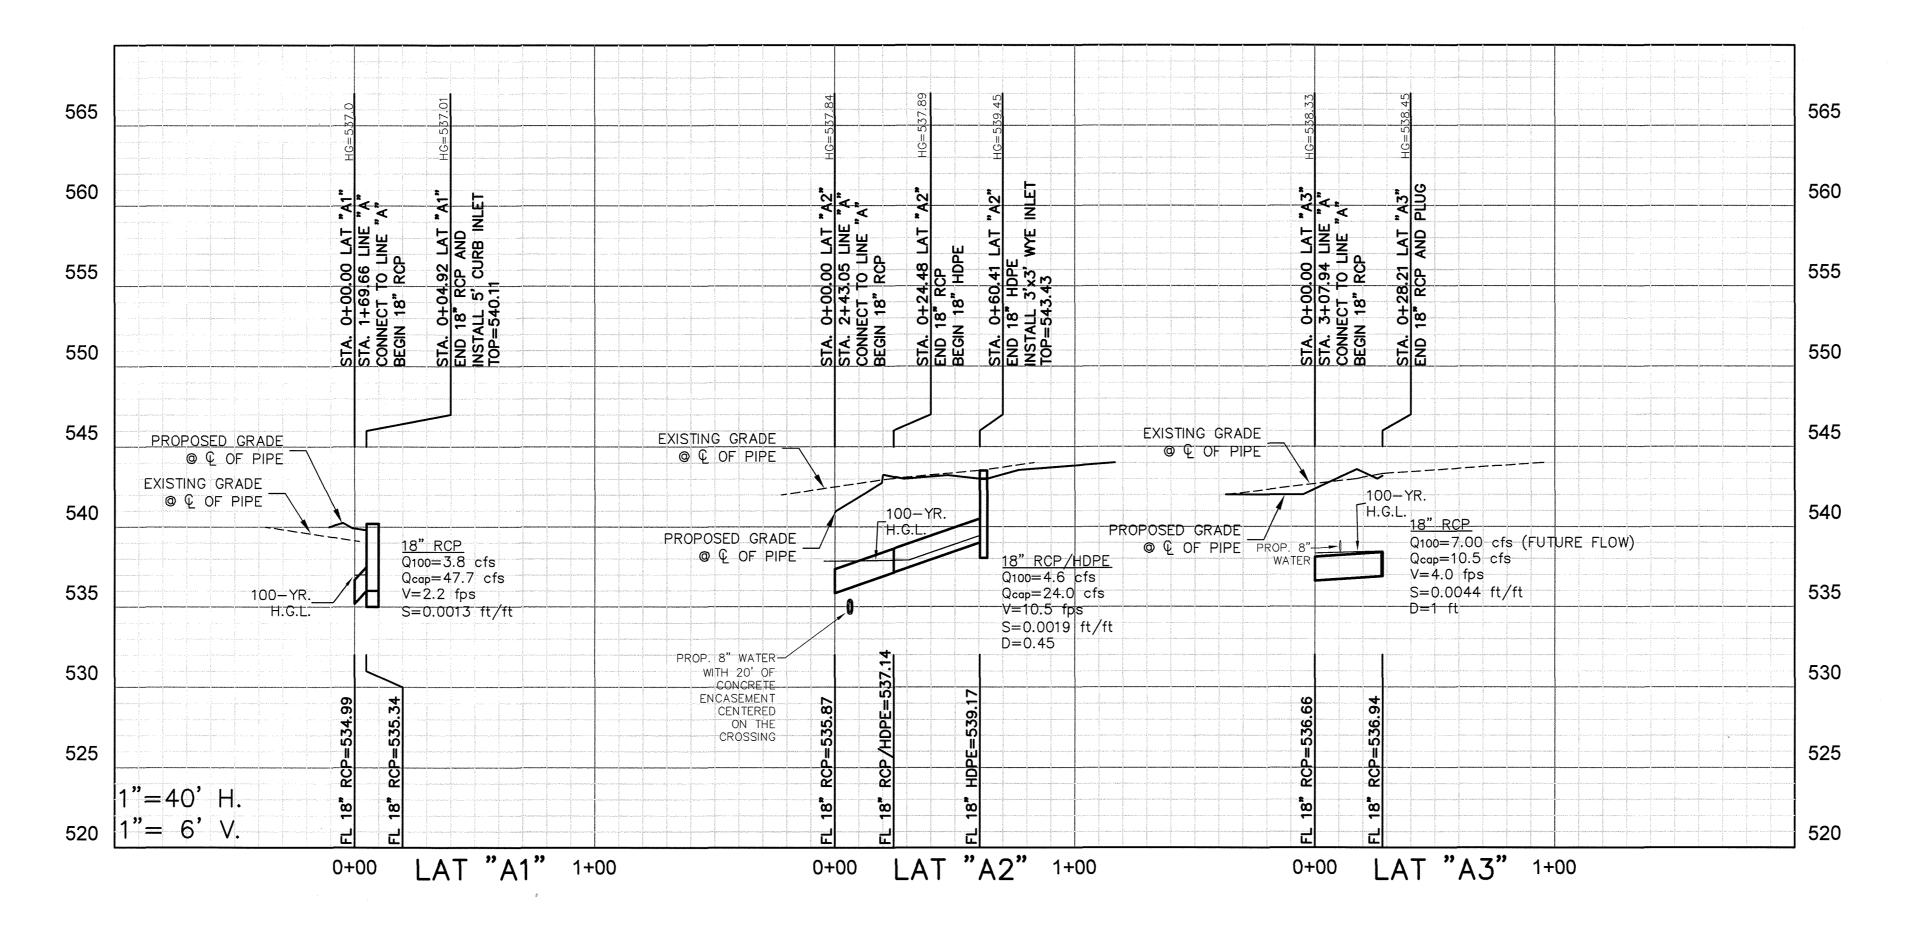
Sumulus Design irm #14810


nway 360, Suite e, Texas 75050 0367

Cun Firm # 2080 Granc Tel. 2

CALL: TEXAS ONE CALL @ 1-800-245-4545 AT LEAST 48 HRS PRIOR TO CONSTRUCTION.

\\SERVER-PC\SERVER\2014 PROJECTS\CD14111 - TOWNSEND ROAD STORAGE, ROCKWALL\PLANS\STORM SEW PROFILE CD14111.DWG



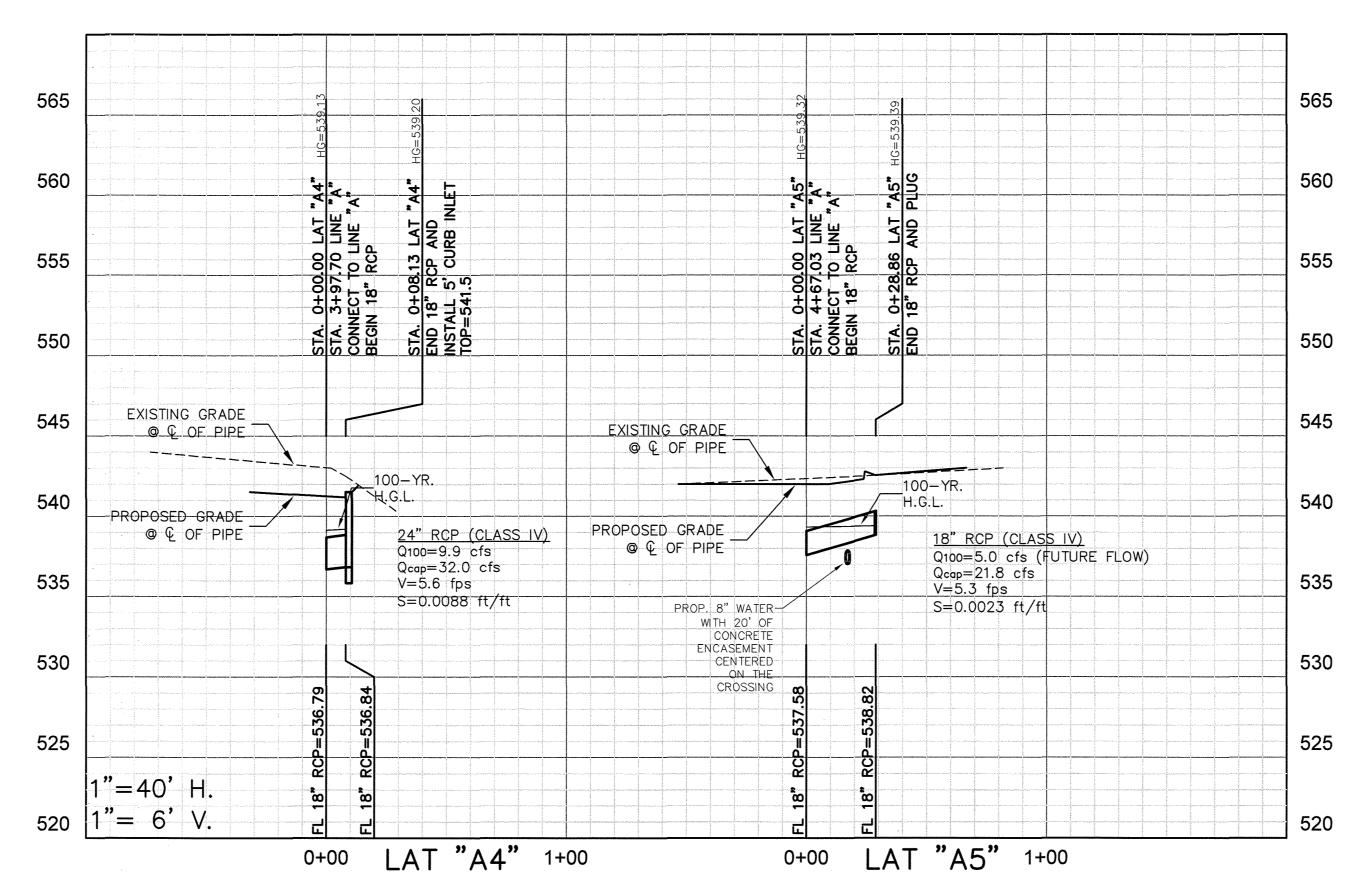

!!! CAUTION !!!
UNDERGROUND UTILITIES

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REVISIONS REV NO. DATE DESCRIPTION

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ELEVATION= 539.71 NORTHERN CORNER OF EXISTING CURB INLET ALONG TOWNSEND ROAD, APPROXIMATELY 630 FEET SOUTH EAST OF THE INTERSECTION OF THE 130 EB SERVICE ROAD AND TOWNSEND

NE CORNER OF THE CONCRETE CURB INLET LOCATED ON THE NE CORNER OF "COSTO" WAREHOUSE ALONG THE EASTERN

ELEVATION= 537.64

CITY OF ROCKWALL CONTROL MONUMENT #19 ELEVATION= 600.68

CASE #SP2014-033

PLOT DATE 07/14/16 DRAWING SCALE PROJECT NUMBER CD14111 SHEET NUMBER

way 360, Suite 2, Texas 75050 3367

Cumulus Design
Firm #14810
2080 N. Highway 360, Suite
Grand Prairie, Texas 75050
Tel. 214.235.0367


LATERALS TOWNSEND DR


SEWER


STORM


F ROCKWALL COUNTY, TE

CALL: TEXAS ONE CALL @ 1-800-245-4545 AT LEAST 48 HRS PRIOR TO CONSTRUCTION. \\SERVER-PC\SERVER\2014 PROJECTS\CD14111 - TOWNSEND ROAD STORAGE, ROCKWALL\PLANS\STORM SEW PROFILE 2 CD14111.DWG

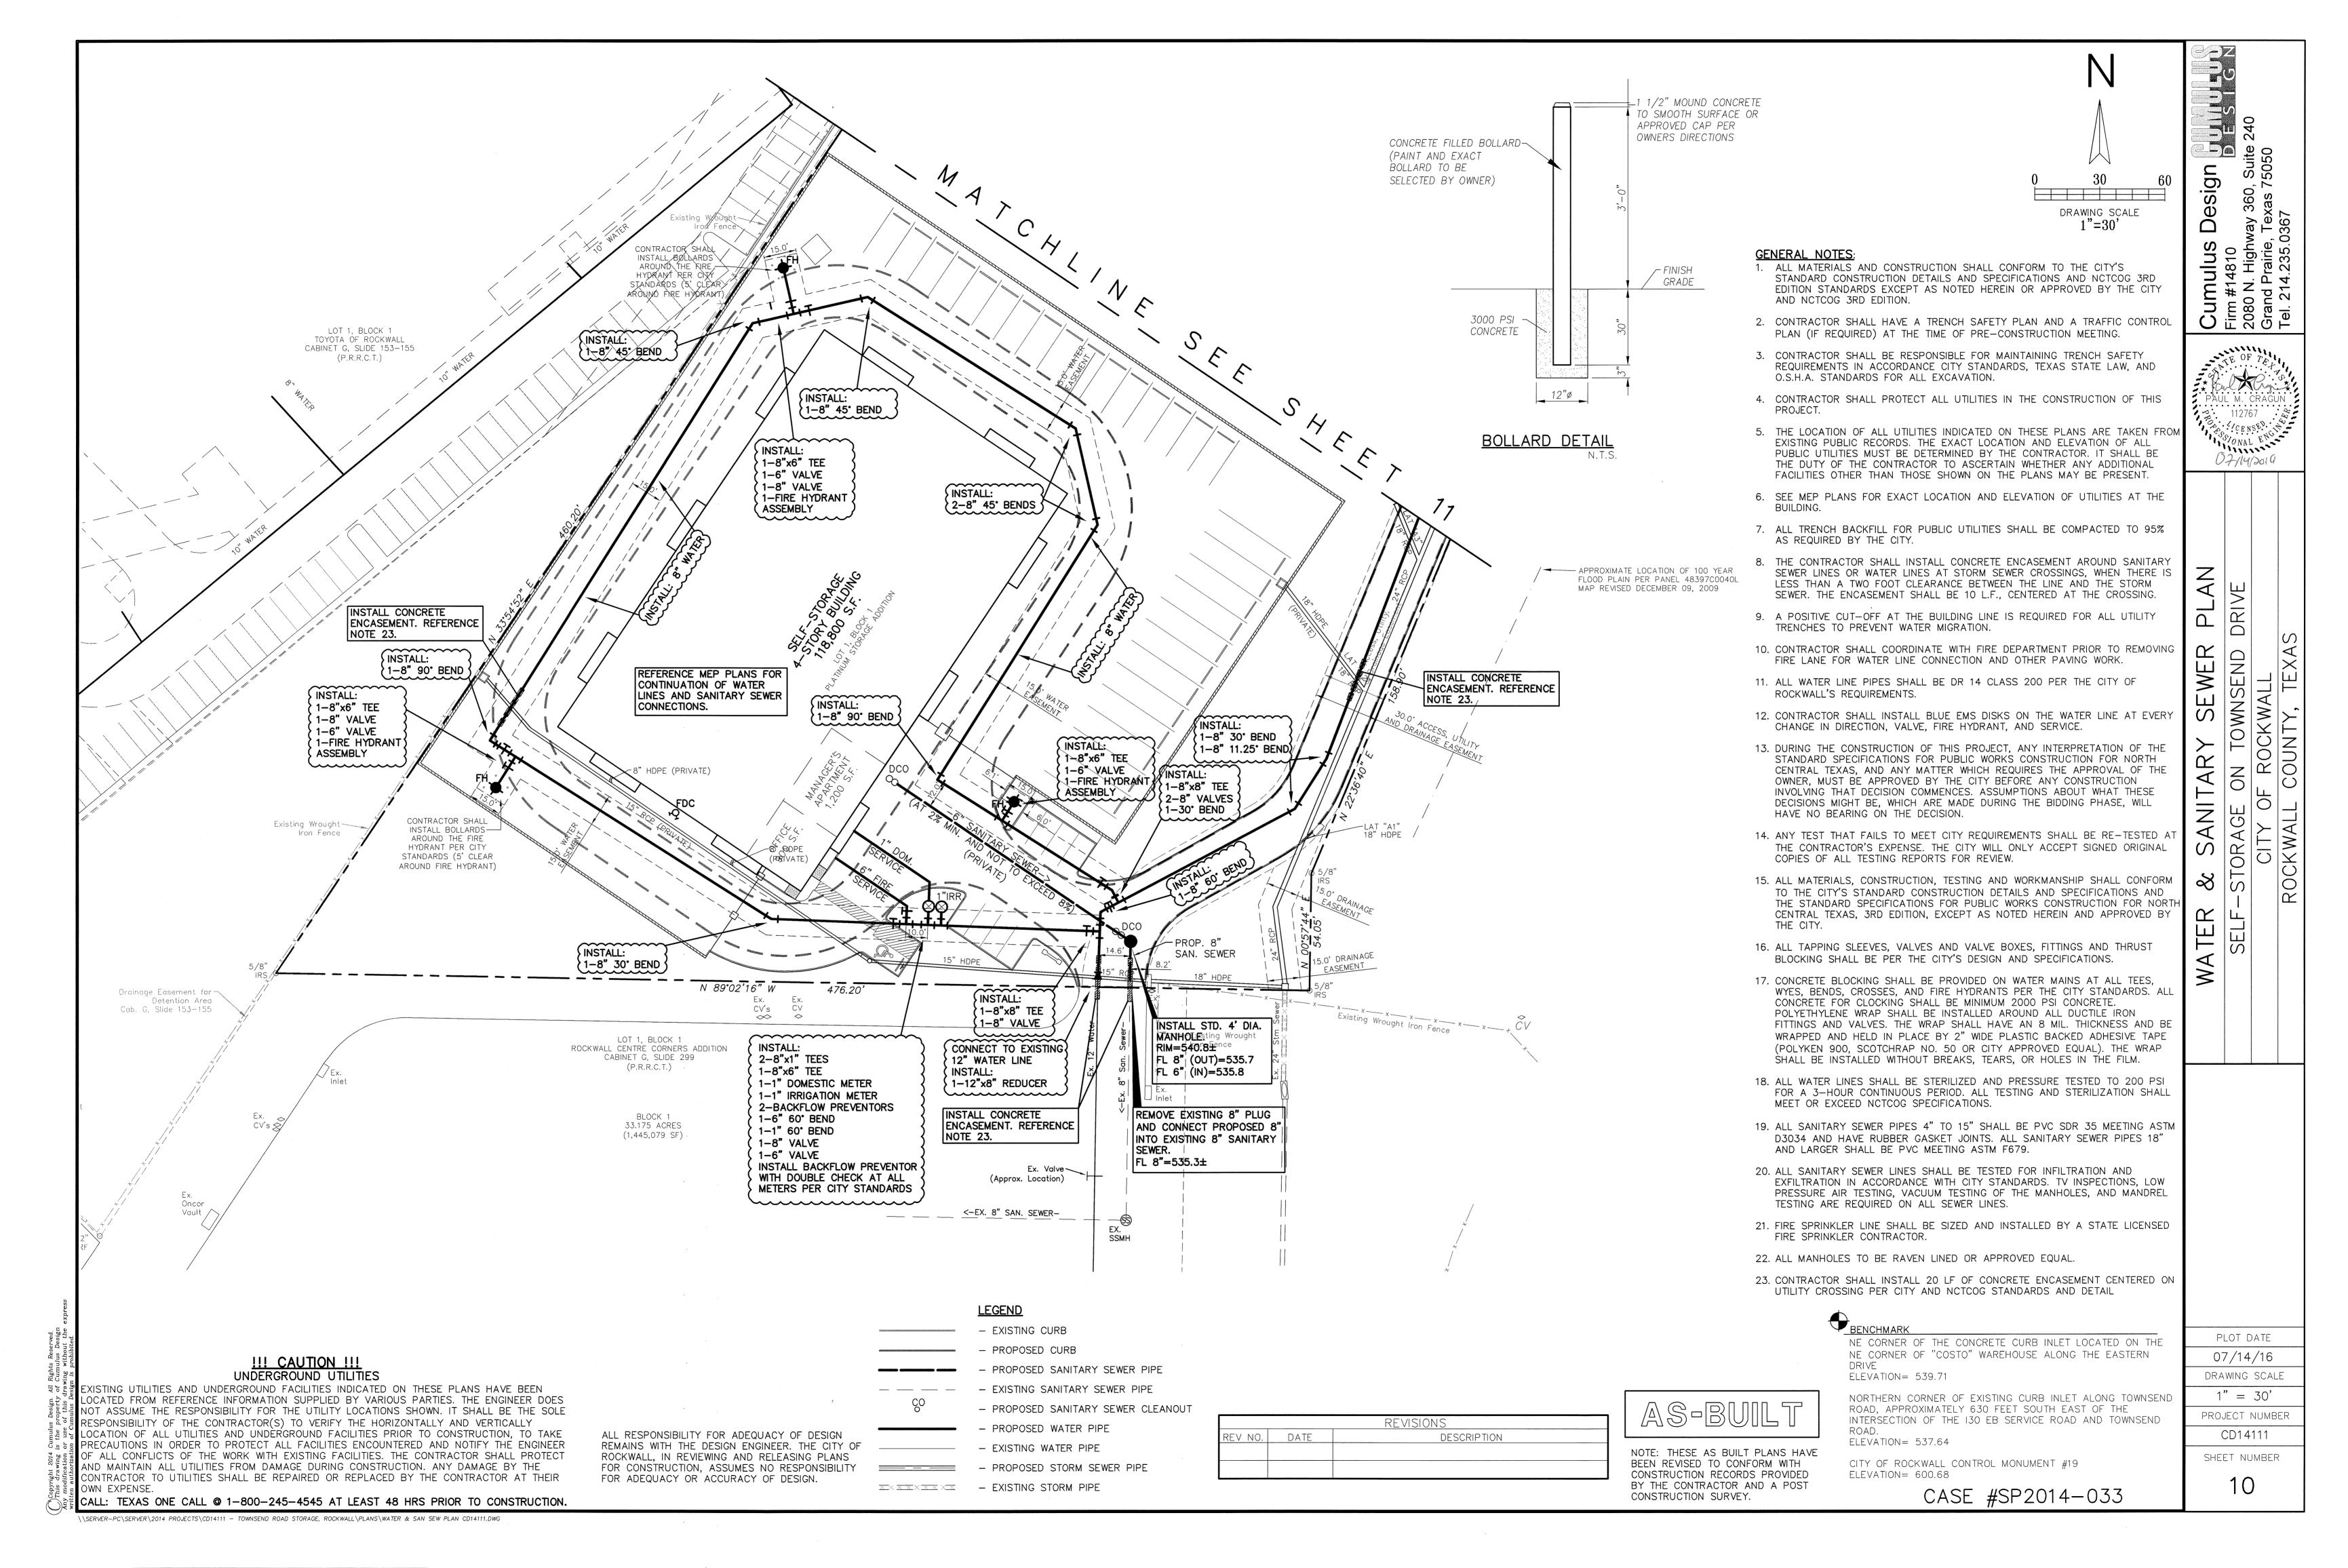

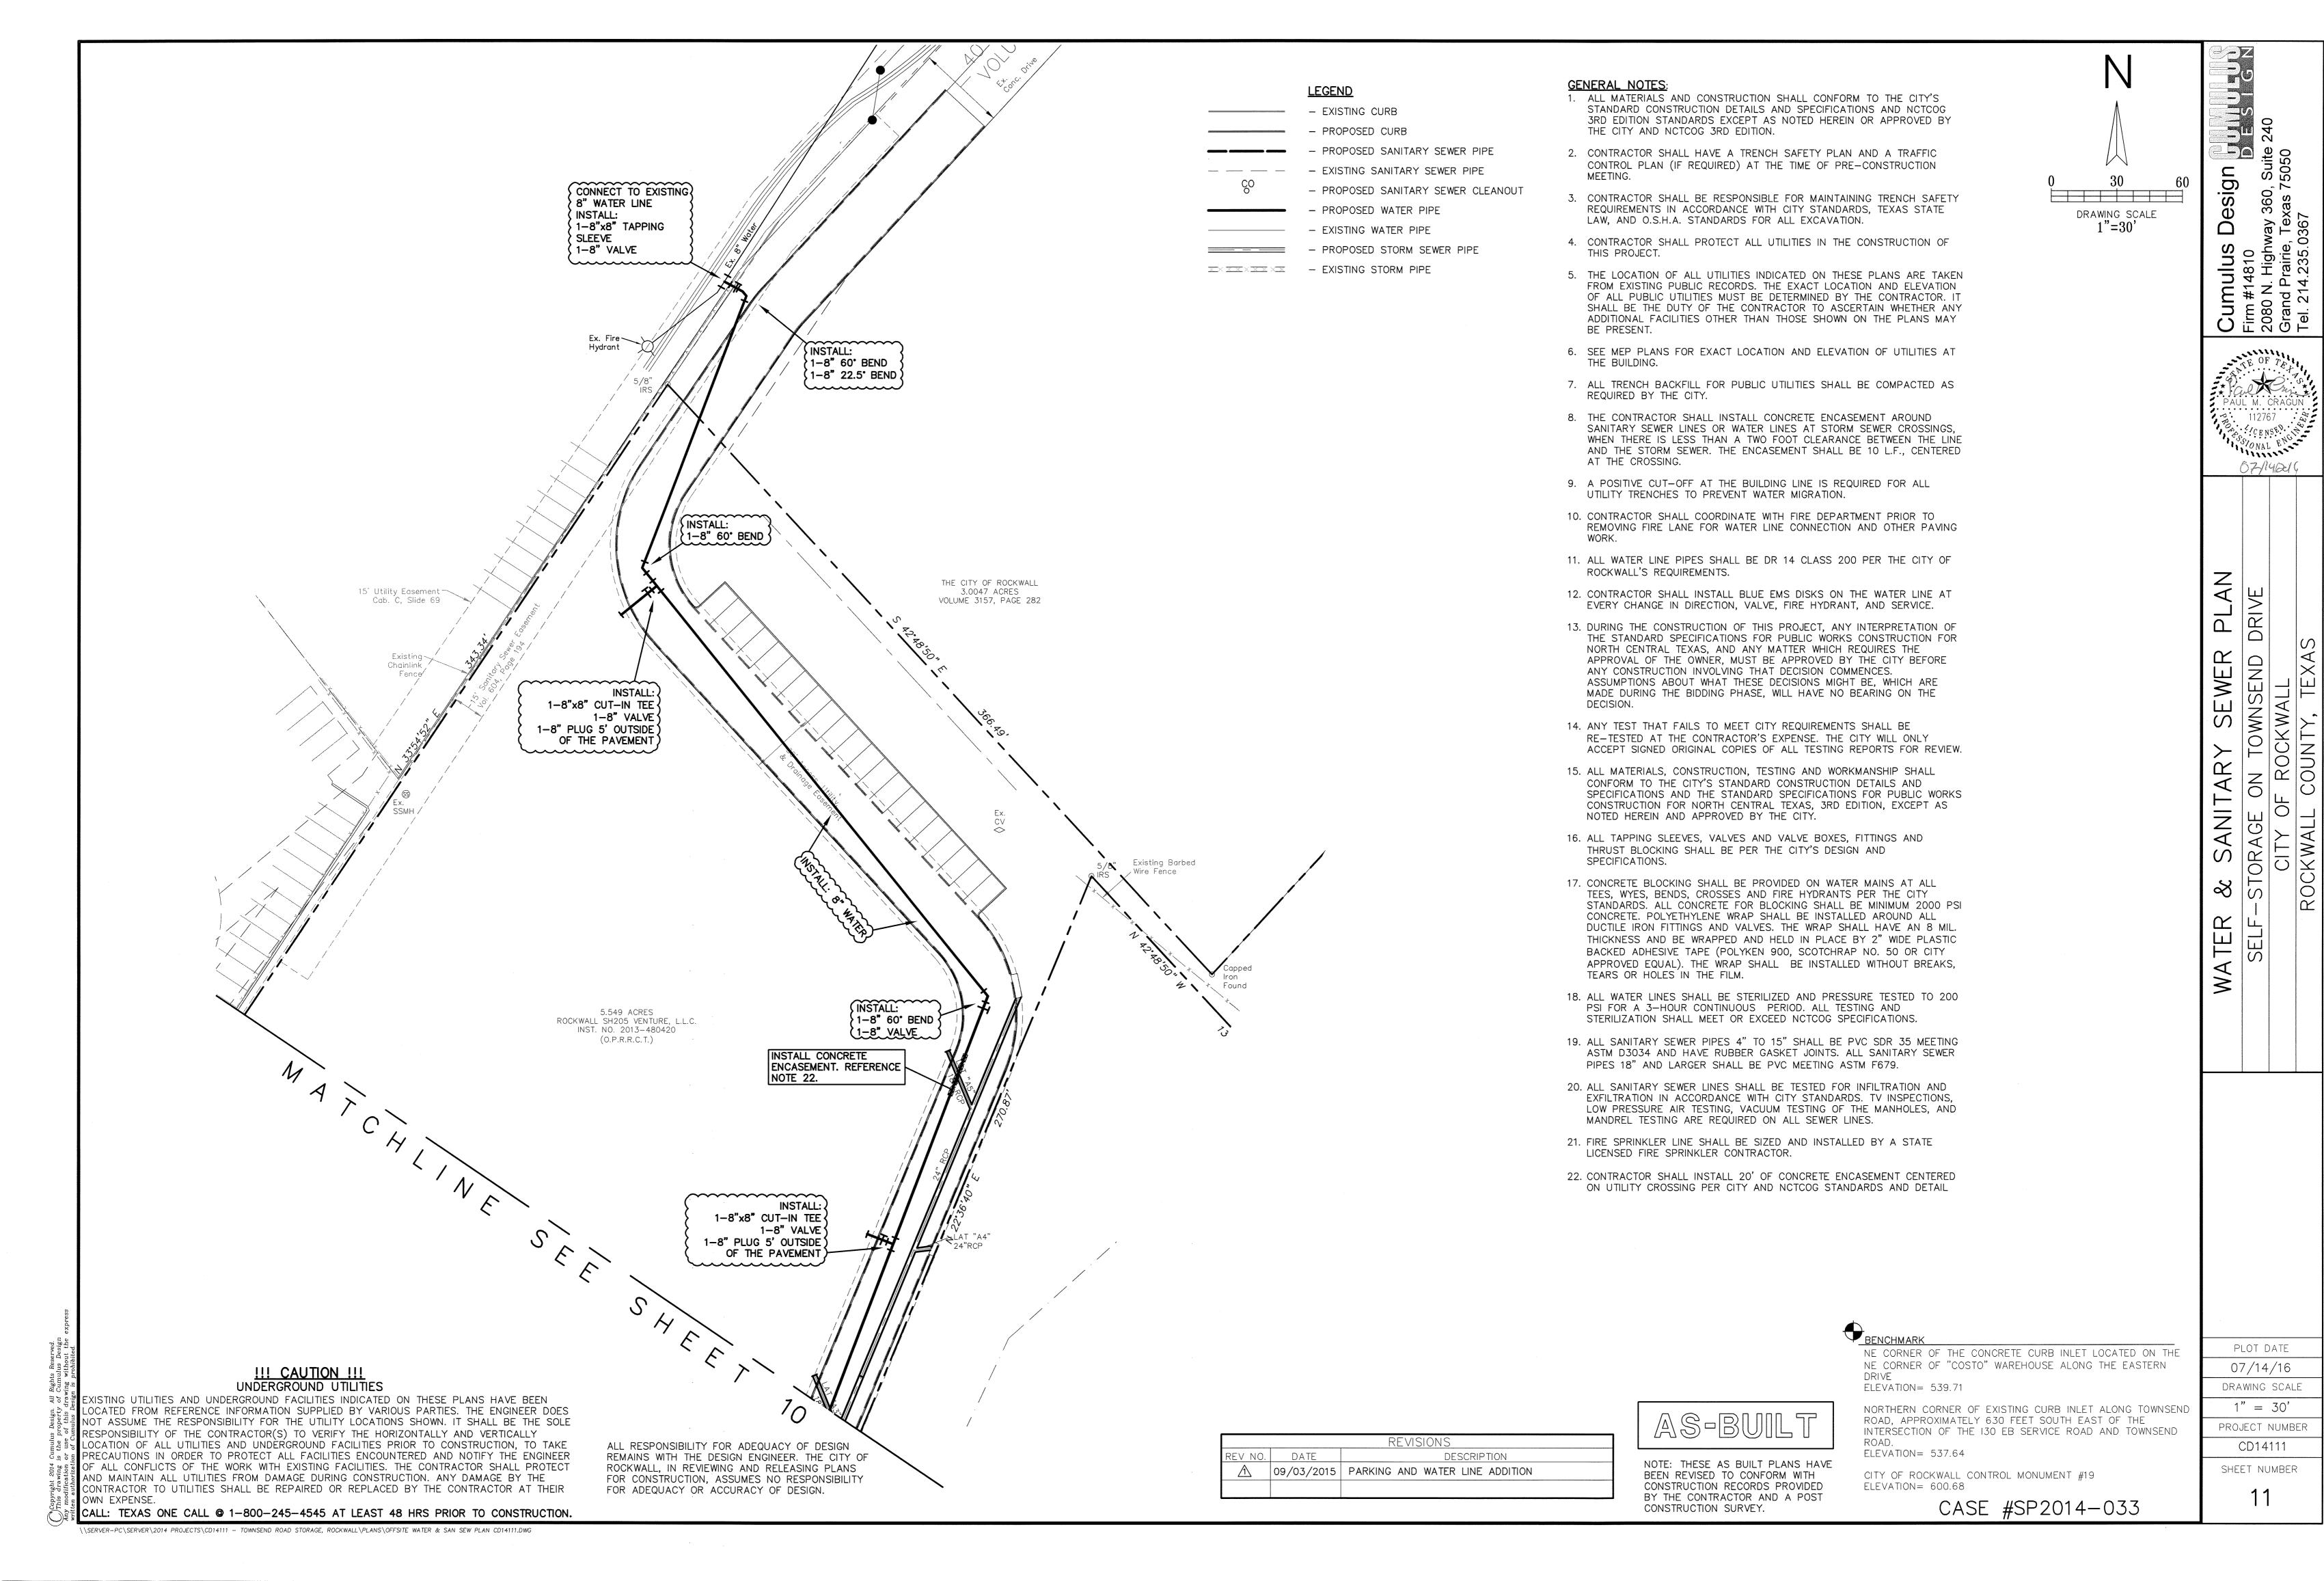

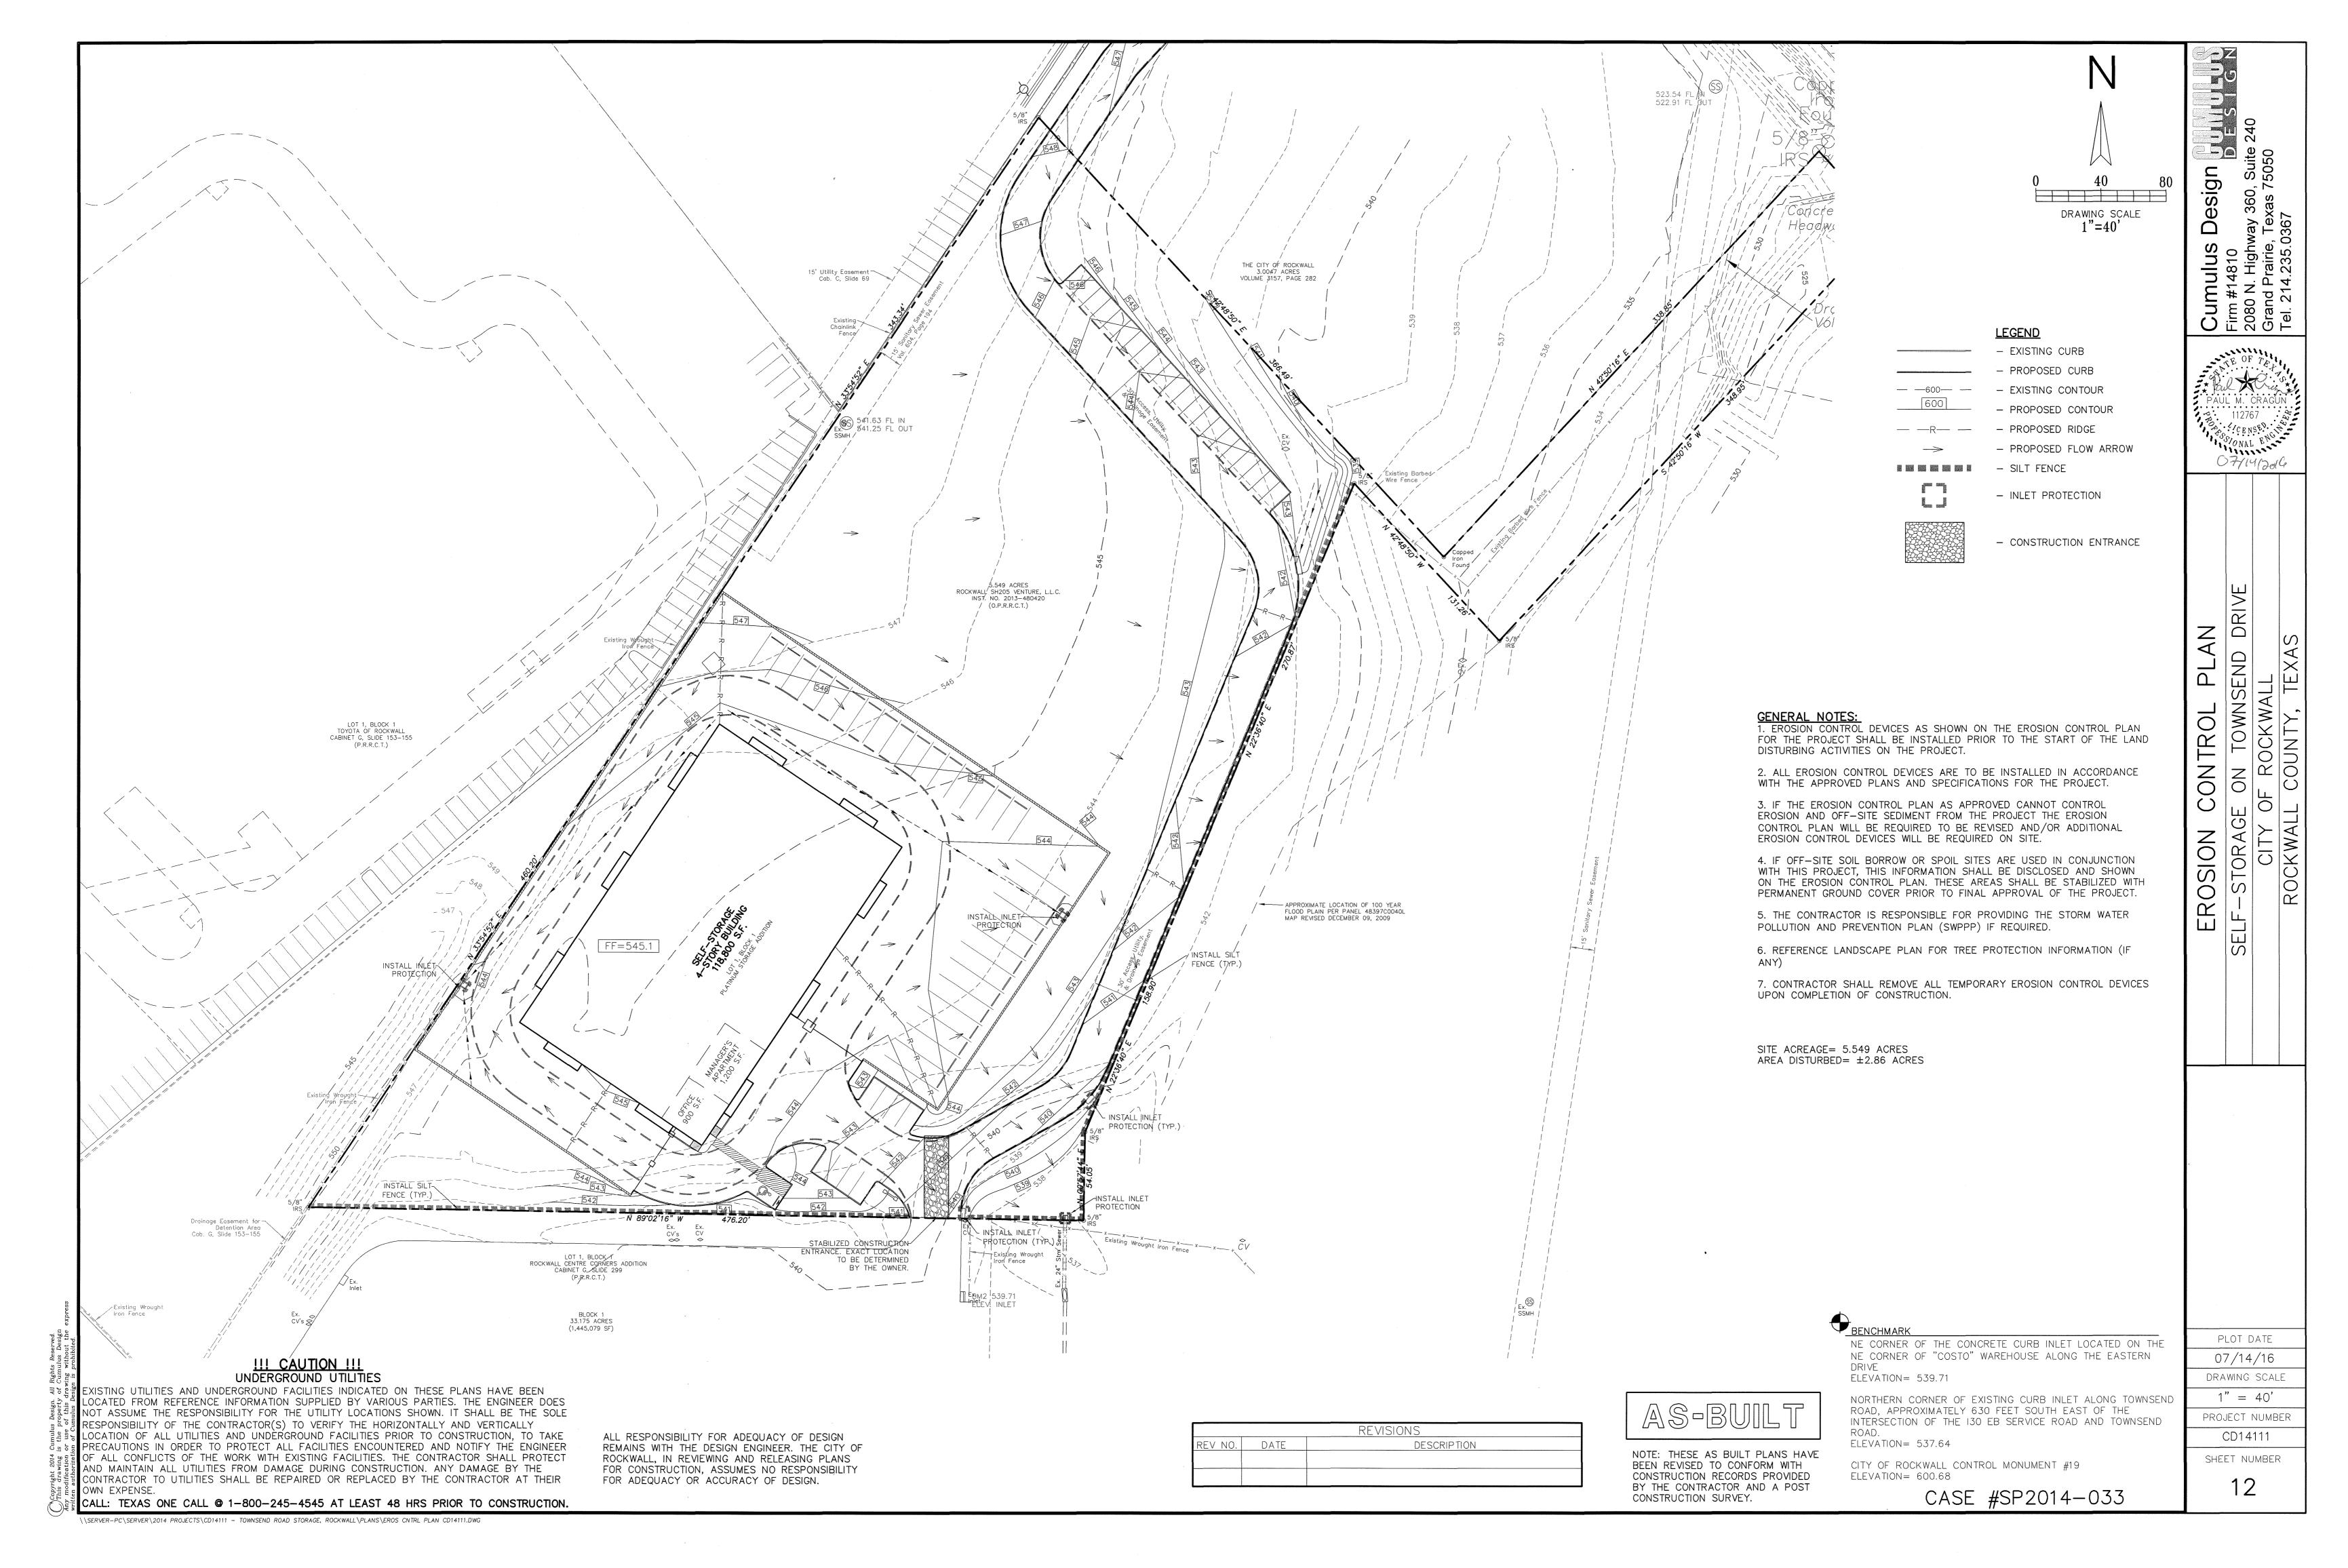

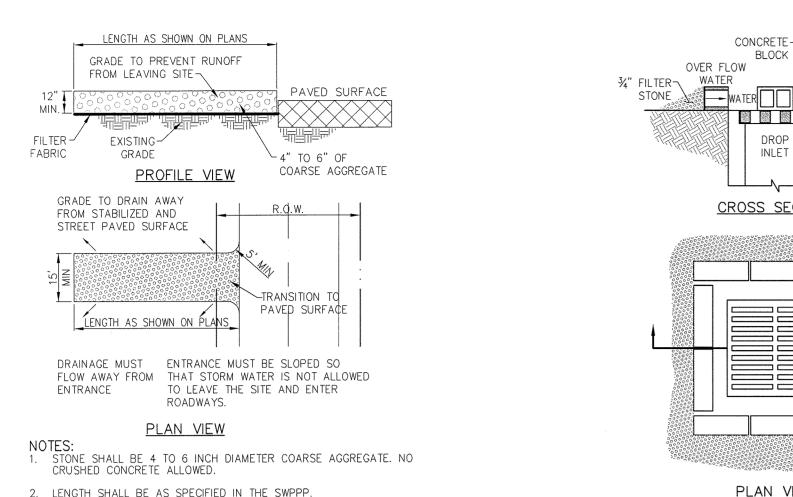


2. LENGTH SHALL BE AS SPECIFIED IN THE SWPPP.

OR WATERCOURSE USING APPROVED METHODS.

BE REMOVED IMMEDIATELY.

- 3. THE THICKNESS SHALL NOT BE LESS THAT 12 INCHES. 4. THE WIDTH SHALL BE NO LESS THAT THE FULL WIDTH OF ALL
- POINTS OF INGRESS OR EGRESS. 5. WHEN NECESSARY, VEHICLES SHALL BE CLEANED TO REMOVE SEDIMENT PRIOR TO ENTRANCE ONTO A PUBLIC ROADWAY. WHEN WASHING IS REQUIRED, IT SHALL BE DONE ON A AREA STABILIZED WITH CRUSHED STONE WITH DRAINAGE FLOWING AWAY FORM BOTH THE STREET AND THE STABILIZED ENTRANCE. ALL SEDIMENT SHALL BE PREVENTED FROM ENTERING ANY STORM DRAIN, DITCH
- 6. THE ENTRANCE SHALL MAINTAINED IN A CONDITION WHICH WILL PREVENT TRACKING OR FLOWING OF SEDIMENT ONTO PAVED SURFACES. THIS MAY REQUIRE PERIODIC TOP DRESSING WITH ADDITIONAL STONE A CONDITIONS DEMAND. ALL SEDIMENT SPILLED DROPPED, WASHED OR TRACKED ONTO PAVED SURFACES, MUST
- 7. THE ENTRANCE MUST BE PROPERLY GRADED OR INCORPORATE A DRAINAGE SWALE TO PREVENT RUNOFF FROM LEAVING THE
- 8. PREVENT SHORTCUTTING OF THE FULL LENGTH OF THE CONSTRUCTION ENTRANCE BY INSTALLING BARRIERS AS


9. INSPECTION SHALL BE AS SPECIFIED IN THE SWPPP. STABILIZED CONSTRUCTION ENTRANCE (IF REQUIRED)

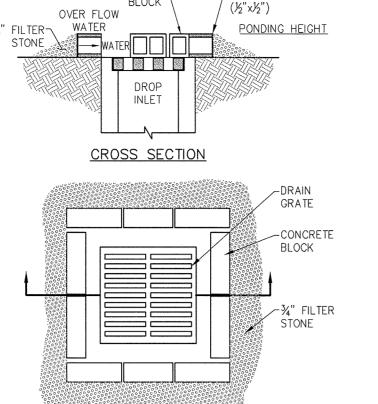

BLOCK

-WIRE SCREEN


DROP INLET PROTECTION

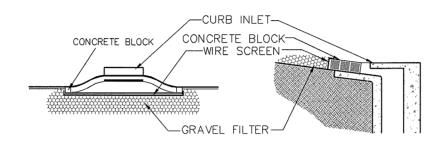


BLOCK AND GRAVEL PROTECTION CONCRETE BLOCKS ARE TO BE PLACED ON THEIR SIDES IN A SINGLE ROW AROUND THE PERIMETER OF THE INLET, WITH ENDS ABUTTING. OPENING IN THE BLOCKS SHOULD FACE OUTWARD, NOT UPWARD . WIRE MESH SHALL THEN BE PLACED OVER THE OUTSIDE FACE OF THE BLOCKS COVERING THE HOLES . FILTER STONE SHALL THEN BE PILED AGAINST THE WIRE MESH TO THE TOP OF THE BLOCKS WITH THE BASE OF THE STONE BEING A MINIMUM OF 18 INCHES FROMTHE BLOCKS. PERIODICALLY, WHEN THE STONE FILTER BECOMES CLOGGED, THE STONE MUST BE REMOVED AND CLEANED IN A PROPER MANNER OR REPLACED WITH NEW STONE AND PILED BACK AGAINST THE WIRE

- CONSTRUCTION NOTES INLET PROTECTION 1. THE CONTRACTOR SHALL PROVIDE ANY ADDITIONAL EROSION OR POLLUTION DEVICES AS REQUIRED DURING THE CONSTRUCTION PHASE IN ORDER TO COMPLETELY CONFORM TO THE UNITED STATES ENVIRONMENTAL PROTECTION AGENCY AND ALL OTHER AGENCIES HAVING JURISDICTION.
- 2. CONTRACTOR AND OWNER SHALL FILE N.O.I. PER EPA REQUIREMENTS. ONSITE CURB INLET PROTECTION SHALL BE CONSTRUCTED UPON
- 3. INSTALLATION OF APPLICABLE ON SITE STORM SEWER.


EROSION CONTROL DETAILS

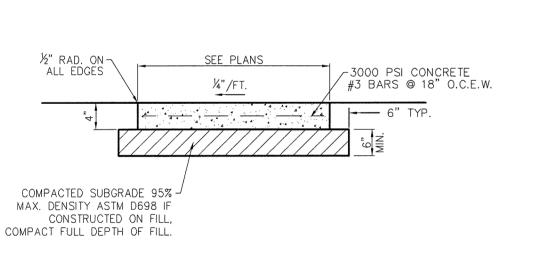


SIDEWALK CROSS-SECTION

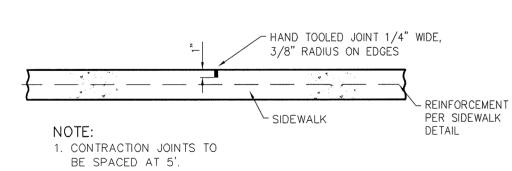

CONTRACTION JOINT

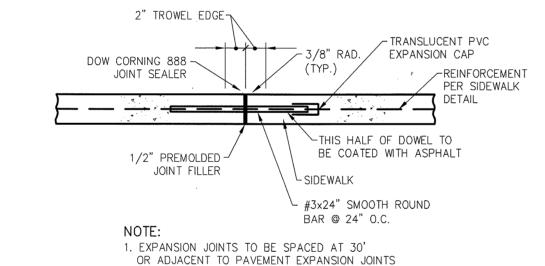

EXPANSION JOINT

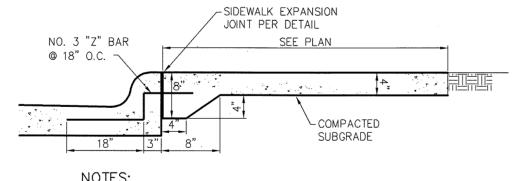


- 1. ALL HONEYCOMB IN BACK OF CURB TO BE TROWEL-PLASTERED BEFORE POURING SIDEWALK.
- 2. LUG MAY BE FORMED BY SHAPING SUBGRADE
- TO APPROXIMATE DIMENSIONS SHOWN. 3. SIDEWALK TO BE MIN. 3000 PSI (MIN. 5.5 SACK

MIX) CONCRETE UNLESS OTHERWISE SPECIFIED.


JOINT DETAIL FOR SIDEWALK ADJACENT TO CURB

SIDEWALK DETAILS

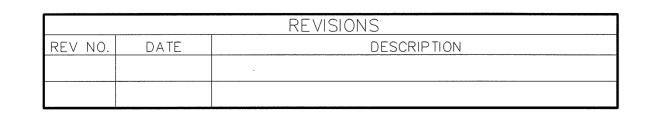

\\SERVER-PC\SERVER\2014 PROJECTS\CD14111 - TOWNSEND ROAD STORAGE, ROCKWALL\PLANS\DETAILS PRIVATE CD14111.DWG

ALL RESPONSIBILITY FOR ADEQUACY OF DESIGN REMAINS WITH THE DESIGN ENGINEER. THE CITY OF ROCKWALL, IN REVIEWING AND RELEASING PLANS FOR CONSTRUCTION, ASSUMES NO RESPONSIBILITY FOR ADEQUACY OR ACCURACY OF DESIGN.

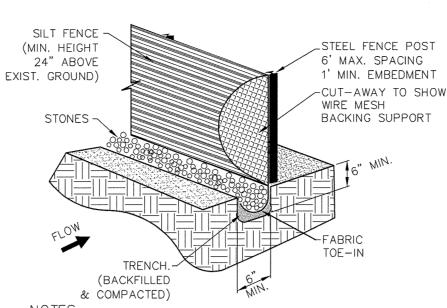

1. STEEL POSTS WHICH SUPPORT THE SILT FENCE SHALL BE INSTALLED ON A SLIGHT ANGLE TOWARD THE ANTICIPATED RUNOFF SOURCE. THE POST MUST BE EMBEDDED A MINIMUM OF ONE FOOT.

- 2. THE TOE OF THE SILT FENCE SHALL BE TRENCHED IN WITH A SPADE OR MECHANICAL TRENCHER, SO THAT THE DOWNSLOPE FACE OF THE TRENCH IS FLAT AND PERPENDICULAR TO THE LINE OF FLOW.WHERE FENCE CANNOT BE TRENCHED IN (E.G. PAVEMENT), WEIGHT FABRIC FLAP WITH WASHED GRAVEL ON THE UPHILL SIDE TO PREVENT FLOW UNDER FENCE.
- 3. THE TRENCH MUST BE A MINIMUM OF 6 INCHES DEEP AND 6 INCHES WIDE TO ALLOW FOR THE SILT FENCE FABRIC TO BE LAID IN THE GROUND AND BACKFILLED WITH COMPACTED MATERIAL.
- 4. SILT FENCE SHALL BE SECURELY FASTENED TO EACH STEEL SUPPORT POST OR TO WOVEN WIRE, WHICH IS IN TURN ATTACHED TO THE STEEL SUPPORT POST. THERE SHALL BE A 6 INCH DOUBLE OVERLAP, SECURELY FASTENED WHERE ENDS OF FABRIC MEET.
- 5. INSPECTION SHALL BE MADE WEEKLY OR AFTER EACH RAINFALL.REPAIR OR REPLACEMENT SHALL BE MADE PROMPTLY AS NEEDED.
- 6. SILT FENCE SHALL BE REMOVED WHEN THE SITE IS COMPLETELY STABILIZED SO AS NOT TO BLOCK OR IMPEDE STORM FLOW OR DRAINAGE.
- 7. ACCUMULATED SILT SHALL BE REMOVED WHEN IT REACHED A DEPTH OF 6 INCHES.THE SILT SHALL BE DISPOSED OF AT AN APPROVED SITE AND IN SUCH A MANNER AS TO NOT CONTRIBUTE TO ADDITIONAL SILTATION.

MOUNT W/ CORROSION RESISTANT

STOVE BOLT (DEFORM THREADS

2" GALVANIZED~

3000 PSI -

CONCRETE

(TYP.)

TYPICAL SIGNAGE MOUNTING DETAIL

-WHITE PAINT (TYP.)

CL OF PARKING SPACE

<u>ACCESSBILITY PARKING SYMBOL DETAIL</u>

ACCESSIBILITY DETAILS

DETAILS ON THIS SHEET ARE PRIVATE. ALL WORK WITHIN

(OR STATE, IF APPLICABLE) STANDARD DETAILS. THE

CONTRACTOR IS REQUIRED TO HAVE ON—SITE, AT ALL

TIMES, A COPY OF THE CITY'S CONSTRUCTION DETAILS.

||PUBLIC EASEMENTS OR RIGHT-OF-WAY SHALL BE PER CITY


-BLUE PAINT

AFTER INSTALLATION) -

TYPICAL ALUMINUM -

EXISTING GRADE -


SILT FENCE

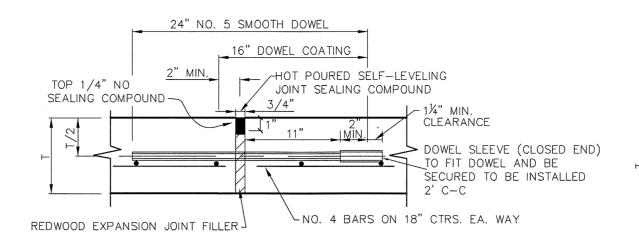

DOWELS AND REINFORCING BARS SHALL BE SUPPORTED BY AN APPROVED DEVICE

T=THICKNESS OF PAVEMENT

LOCATED AS INDICATED. N.T.S

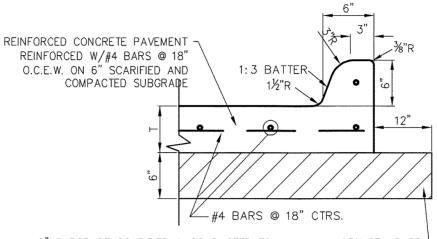

6" SUBGRADE SCARIFIED & COMPACTED TO A MINIMUM 95% STANDARD-PROCTOR DENSITY (ASTM D 698) WITHIN -1% TO +3% OF OPTIMUM MOISTURE. SUBGRADE BENEATH FIRELANE SHALL BE 8% LIME STABILIZED IN ACCORDANCE WITH TxDOT ITEM No 260 & 264.

T=THICKNESS OF PAVEMENT

MOUNT W/ CORROSION RESISTANT

STOVE BOLT (DEFORM THREADS

ALUMINUM SIGN (AS-

DIRECTED)

AFTER INSTALLATION) -

2" GALVANIZED STEEL POST TO EXTEND INTO CONCRETE -

FILLED BOLLARD (TYP.)

APPROVED CAP PER-

OWNERS DIRECTIONS

CONCRETE FILLED BOLLARD -

(COLOR AND SIZE OF BOLLARD TO BE

SELECTED BY OWNER)

3000 PSI (MIN)

CONCRETE

COLORS:

SPACES ONLY.

ARCHITECT DETAILS.

✓ GROUND

SIGNAGE MOUNTING DETAIL ADJACENT

TO PARKING SPACE

RESERVED

PARKING

VAN-ACCESSIBLE

LETTERS AND BORDER- GREEN SYMBOL ON BLUE BACKGROUND

1. SPACING BETWEEN LETTERS, COLORS, AND

PROCESSES SHALL CONFORM STANDARD HIGHWAY AND SIGN DESIGNS FOR TEXAS.

2. INSTALL WHERE INDICATED ON PLANS.

TYPICAL SIGNAGE

<u>DETAIL</u>

SIGNAGE DETAILS (IF ANY) IF ARCHITECT


PLANS CONTAIN SIGNAGE DETAILS, USE

3. VAN-ACCESSIBLE SIGNAGE ON VAN

REFERENCE ARCHITECT PLANS FOR

SIGN BACKGROUND-WHITE

CONCRETE PAVEMENT SECTION

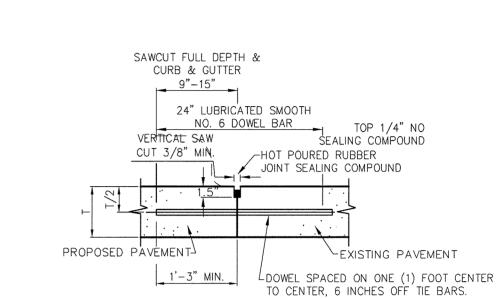

VERTICAL SAW CUT

3/8" WIDE MIN.

TOP 1/4" NO~

LNO. 4 BARS ON

MAXIMUM SPACING IS 15' CENTERS

18" CTRS. EA. WAY

<u>SAWED DUMMY (CONTROL) JOINT</u>

I SEALING COMPOUND

HOT POURED RUBBER SEALANT

esign

umulus m #14810

Firm # 2080 Grand

112767 E SSIONAL ENCE

07/M/2016

N.

AGE

PLOT DATE

07/14/16

DRAWING SCALE

1" = 30'

PROJECT NUMBER

CD14111

SHEET NUMBER

 $|\gg|$

CITY C ROCKWALL

RIVA

TAIL

DE


(SELF LEVELING COMPOUND)

DOWELS AND REINFORCING BARS SHALL BE SUPPORTED BY AN APPROVED DEVICE

<u>LONGITUDINAL BUTT JOINT</u>

- 1. NO. 5 SMOOTH DOWEL BAR MAY BE USED IN 5 INCH AND 6 INCH PAVEMENT THICKNESS.
- LONGITUDINAL BUT CONSTRUCTION MAY BE UTILIZED IN PLACE OF LONGITUDINAL HINGED (KEYWAY) JOINT AT CONTRACTORS OPTION.
 DOWEL BARS SHALL BE DRILLED INTO PAVEMENT HORIZONTALLY BY USE OF A MECHANICAL RIG.
- 4. DRILLED BY HAND IS NOT ACCEPTABLE, PUSHING DOWEL BARS INTO GREEN CONCRETE NOT ACCEPTABLE.

PAVEMENT DETAILS

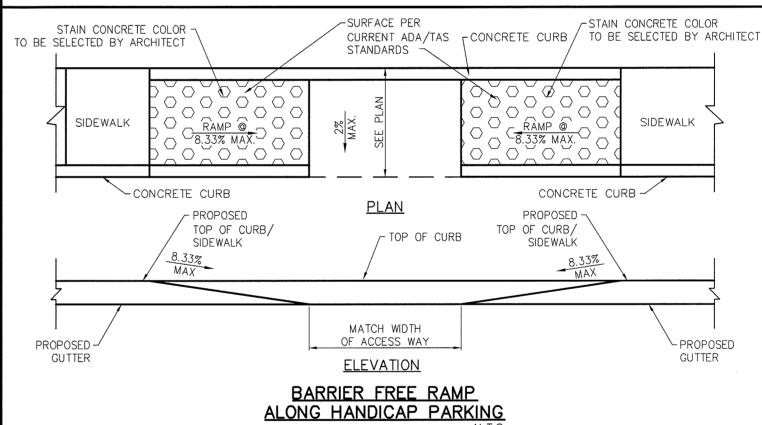


NOTE: THESE AS BUILT PLANS HAVE BEEN REVISED TO CONFORM WITH CONSTRUCTION RECORDS PROVIDED

BARRIER FREE RAMP

SITE BARRIER FREE RAMP DETAILS

CASE #SP2014-033

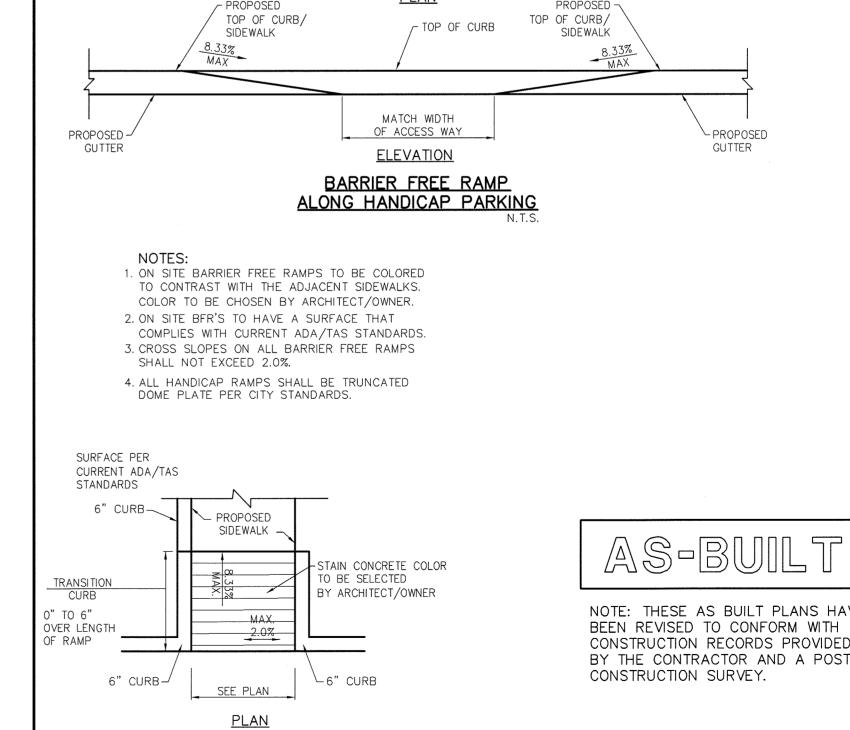


TRUE NORTH

PLANT MATERIAL LIST

		TREES	
<u>KEY</u>	QUANTITY	DESCRIPTION	<u>SIZE</u>
CE	2	ULMUS CRASSIFOLIA	3" CAL. MIN. 4' SPREAD
CE	2	CEDAR ELM	MIN. 10 FT.
CD	1 1	PISTACHIA CHINENSE	3" CAL. MIN. 4' SPREAD
CP 1		CHINESE PISTACHIO	MIN. 10 FT.
LC	37	CUPRESSOCYPARIS LEYLANDII	30 GAL., 5 FT. HT.,
	3/	LEYLAND CYPRESS	3 FT. SPREAD
		SHRUBS	
<u>KEY</u>	QUANTITY	DESCRIPTION	<u> ŞIZE</u>
11.1	45	RAPHIOLEPSIS INDICA ' PINK LADY'	5 GAL., MIN. 24" HT.,
IH	45	INDIAN HAWTHORN	24" O.C.
	15	ROSA 'RADTKO'	5 GAL., MIN. 24" HT.,
KOR	15	DOUBLE KNOCKOUT ROSE	36" O.C.
DDC		OPUNTIA ELLISIANA	3 GAL., MIN. 15" HT.,
PPC	6	SPINELESS PRICKLY PEAR	A.S.
CLV		YUCCA GLORIOSA	5 GAL., MIN. 15" HT.,
SLY	1	SOFTLEAF YUCCA	36" O.C.
\ A /T		AGAVE OVATIFOLIA	
WT	1	WHALE'S TONGUE	5 GAL., MIN. 15" HT.,
DV		HESPERALOE PARVIFOLIA	
RY	3	RED YUCCA	5 GAL., MIN. 15" HT.,
		GROUND COVER	
KEY	QUANTITY	DESCRIPTION	<u>SIZE</u>
	F00	EUONYMUS COLORATUS FORTUNEI	4" POT, FULL PLANT
EC	500	PURPLE WINTERCREEPER	10" O.C.
		BLOOMING COLOR	
<u>KEY</u>	QUANTITY	<u>DESCRIPTION</u>	SIZE
TC	4	MALVAISCUS ARBOREUS V. DRUMMONDII	1 GAL., FULL PLANT
TC	4	TURKS CAP	16" O.C.
		ORNAMENTAL GRASSES	
<u>KEY</u>	QUANTITY	DESCRIPTION	<u>SIZE</u>
ABM	FO	MUHLENBERGIA CAPILLARIS 'REGAL MIST'	1 GAL., FULL PLANT
	50	AUTUMN BLUSH MUHLY	15" O.C.
DMC	12	MISCANTHUS SINENSIS 'ADAGIO'	1 GAL., FULL PLANT
DMG	13	DF. MAIDEN GRASS	16" O.C.

LANDSCAPE ORDINANCE FOR CITY OF ROCKWALL

	<u>requirements</u>	<u>PROVIDED</u>
	MINIMUM SQUARE FOOTAGE REQUIREMENTS FOR LANDSCAPING SHALL BE PROVIDED AND MAINTAINED IN THE ZONING DISTRICTS SET FORTH AS FOLLOWS: COMMERCIAL = 15% @ 124,451 S.F. = 18,668 S.F. REQUIRED	24,637 S.F. (20% OF TOTAL AREA) OF THE LANDSCAPE AREA PROVIDED.
	ANY PARKING LOT WITH MORE THAN 2 ROWS SHALL HAVE A MINIMUM OF 5% OR 200 S.F., WHICHEVER IS AREATER, IN THE INTERIOR OF THE PARKING LOT IN LANDSCAPING. SUCH LANDSCAPING SHALL BE COUNTED TOWARD THE TOTAL LANDSCAPING. = 18,668 S.F. @ 5% = 933 S.F.	1,059 S.F (5.7% OF TOTAL LANDSCAPE AREA)
	PARKING AND MANELIVERING SPACE EXCEEDS 20,000 S.F., ONE TREE FOR EVERY IO PARKING SPACES. 59,425 S.F. @ 37 SPACES = 4 TREES	(4) TREES PROVIDED
,	NO PARKING SPACE SHALL BE FURTHER THAN 80 FEET FROM AT LEAST ONE TREE,	ALL PARKING SPACES ARE WITHIN 80 FT, OF AT LEAST ONE TREE,
7	TREES MUST BE PLANTED AT LEAST FIVE FEET FROM WATER, SEWER AND STORM SEWER LINES.	TREES ARE LOCATED AT LEAST FIVE FEET FROM WATER, SEWER AND STORM SEWER LINES.
	NO LESS THAN 50% OF THE TOTAL LANDSCAPE REQUIREMENT SHALL BE LOCATED IN FRONT OF THE BUILDINGS LANDSCAPE REQUIREMENTS = 18,6681 S.F. @ 50% = 9,334 S.F.	LANDSCAPE PROVIDED = 71% OR 13,244 S.F.
	ONE ROW OF LEYLAND CYPRESS TO BE INSTALLED ALONG EASTERN PROPERTY LINE IN ACCORDANCE WITH SUP #5-121	(15) LEYLAND CYPRESS PROVIDED
	IRRIGATION TO BE AN UNDERGROUND AUTOMATIC SYSTEM	ALITOMATIC SYSTEM PROVIDED

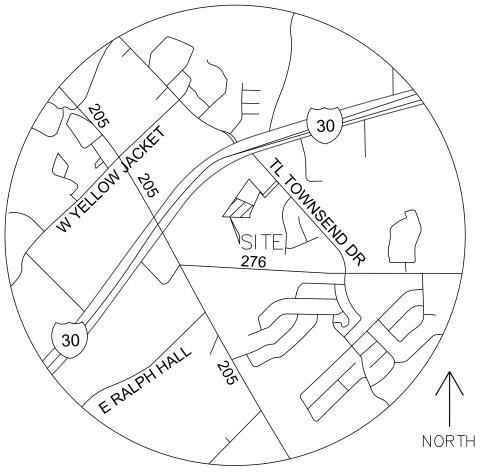

<u>VICINITY MAP</u>

<u>SUP2014-033</u>

SELF-STORAGE ON TOWNSEND DRIVE
CITY OF ROCKWALL
ROCKWALL COUNTY, TEXAS

Design Furn

J. CAMILLE LA FOY

LANDSCAPE ARCHITECTURE CONSULTING

101C NORTH GREENVILLE AVENUE, #242

214-502-4036

PLOT DATE

03/11/15

DRAWING SCALE

1" = 20'

PROJECT NUMBER
CD14111

SHEET NUMBER

G:\BACKUP 112814\CD-SELF STORAGE-ROCKWALL 14\LBASE 14111.DWG

