LEGEND

WATER VALVE IRRIGATION CONTROL VALVE FIRE HYDRANT

FIRE DEPARTMENT CONNECTION CLEAN OUT

MANHOLE GAS METER TRAFFIC SIGNAL CONTROL TRAFFIC SIGNAL POLE

TRAFFIC SIGN TELEPHONE BOX TV BOX FLAG POLE

LANDSCAPE AREA PROPERTY LINE O.H. POWER LINES TEL U/G TELEPHONE LINES

WATER U/G WATER LINE GAS LINE 

EXISTING CONTOURS EXISTING SPOT GRADES CONTROLLING MONUMENT 5/8-INCH IRON ROD WITH "POGUE ENG & DEV" CAP SET

PROPOSED CONTOURS TC XXX.XX PROPOSED SPOT GRADES PROPOSED EROSION CONTROL PROPOSED DRAINAGE DIVIDES

FRANCHISE UTILITY NOTES: 1. TXU ENERGY CONSTRUCTION SERVICES - (800) 711-9112 2. ATMOS ENERGY (GAS) - 903-457-2092 - DINAH WOOD

3. AT&T (PHONE) - 903-457-2092 - DWAYNE WELLS

CAUTIONIII UNDERGROUND UTILITIES ARE LOCATED IN THIS AREA. 48 HOURS PRIOR TO ANY CONSTRUCTION ACTIVITIES, CONTACT LINE LOCATES FOR FRANCHISE UTILITY INFO. CALL BEFORE YOU DIG: TEXAS EXCAVATION SAFETY SYSTEM (TESS) 1-800-344-8377 TEXAS ONE CALL SYSTEMS 1-800-245-4545 LONE STAR NOTIFICATION CENTER 1-800-669-8344 EXT. 5

**BENCH MARK LIST:** BENCHMARK #1
SQUARE CUT SET AT SOUTHWESTCORNER OF WATER VAULT LOCATEDED AT
THE SOUTHEAST CORNER OF THE INTERSECTION OF THE EAST
RIGHT-OF-WAY LINE OF SH 205 AND THE SOUTH RIGHT-OF-WAY LINE OF ELEVATION = 543.09

BENCHMARK #2 CITY OF ROCKWALL MONUMENT (R010) FOUND. ELEVATION = 524.788

OWNER:

MR. GREY STOGNER METROPLEX ACQUISITION FUND, L.P. 8214 WESTCHESTER, SUITE 850 DALLAS, TEXAS 75225 (214) 343-4477 PHONE (214) 340-2029 FAX

# CIVIL CONSTRUCTION PLANS

# TOM THUMB FUEL CENTER #2964

BLOCK A, LOT 3, STONE CREEK RETAIL ADDITION 3074 N. GOLIAD STREET W.T. DEWEESE SURVEY, ABSTRACT NO. 71


> ROCKWALL COUNTY CITY OF ROCKWALL, TEXAS

> > PLANS PREPARED BY:

1512 BRAY CENTRAL DRIVE, SUITE 100 McKINNEY, TEXAS 75069 (214) 544-8880 FAX (214) 544-8882 BRANDON E. COX, P.E.

PLANS PREPARED FOR:

MR. ROBERT PICARD STANTEC ARCHITECTURE, INC. 1137 N. McDOWELL BOULEVARD PETALUMA, CALIFORNIA 94954 (707) 765-1660 PHONE (707) 765-9908 FAX

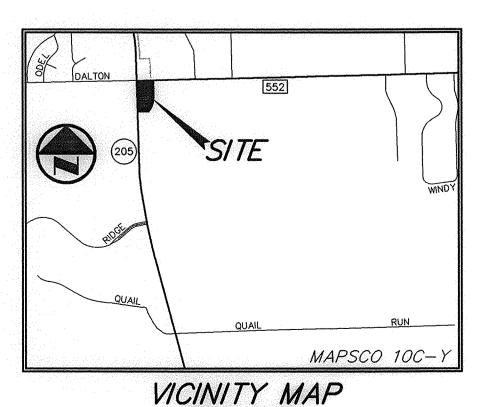

NOT TO SCALE

RECORD DRAWINGS:
IT WAS THE INTENT THAT THE IMPROVEMENTS SHOWN BE CONSTRUCTED ACCORDING TO THESE PLANS AS APPROVED BY THE CITY. THE LINES AND GRADES WERE SET ON THE GROUND FOR CONSTRUCTION ACCORDING TO SAID PLANS. THE CITY INSPECTED THE CONSTRUCTION. THE ENGINEER DID NOT VERIFY LINES OR GRADES AFTER CONSTRUCTION. WE ARE NOT AWARE OF ANY CHANGES OR REVISIONS TO THESE PLANS DURING CONSTRUCTION OTHER THAN THOSE SHOWN. RANDALL P. POGUE, P.E. DATE: <u>APRIL 30, 2010</u> TX LIC. NO. 84780

ED PROJECT GENERAL NOTES:

1. SIZE AND LOCATION OF ALL UNDERGROUND UTILITIES HAVE BEEN REPRODUCED FROM PLANS ON FILE WITH THE CITY. CONTRACTOR TO VERIFY SIZE AND LOCATION OF ALL UTILITIES PRIOR TO COMMENCEMENT OF ANY CONSTRUCTION ACTIVITY.

2. THE BEARING SYSTEM FOR THIS TRACT WAS BASED ON A BEARING OF NORTH 89 DEGREES, 09 MINUTES, 25 SECONDS EAST FOR THE SOUTH RIGHT-OF-WAY LINE OF F.M. 552 ACCORDING TO SPECIAL WARRANTY DEED TO BETSY COMMERCIAL, LTD. RECORDED IN INSTRUMENT NO. 2007-00375397 OF THE DEED RECORDS OF ROCKWALL COUNTY, TEXAS.

3. BASE BOUNDARY AND TOPOGRAPHY INFORMATION SHOWN IS BASED ON THE GROUND SURVEY AS PREPARED BY POGUE ENGINEERING & DEVELOPMENT COMPANY, INC. DATED

4. THE SUBJECT PROPERTY IS SHOWN ON THE NATIONAL FLOOD INSURANCE PROGRAM FLOOD INSURANCE RATE MAP FOR ROCKWALL COUNTY, TEXAS AND INCORPORATED AREAS COMMUNITY PANEL NUMBER 48397C0030L, DATED SEPTEMBER 26, 2008. ALL OF THE SUBJECT PROPERTY IS INDICATED TO BE IN ZONE 'X' ON SAID MAP. RELEVANT ZONES ARE DEFINED ON SAID MAP AS FOLLOWS:

ZONE 'X' - AREAS DETERMINED TO BE OUTSIDE THE 0.2% ANNUAL CHANCE

THIS FLOOD STATEMENT REGARDING FLOODING DOES NOT IMPLY THAT THE PROPERTY AND/OR STRUCTURES THEREON WILL BE FREE FROM FLOODING OR FLOOD DAMAGE. ON RARE OCCASIONS, GREATER FLOODS CAN AND WILL OCCUR AND FLOOD HEIGHTS MAY BE INCREASED BY MAN-MADE OR NATURAL CAUSES. THIS FLOOD STATEMENT SHALL NOT CREATE LIABILITY ON THE PART OF THE SURVEYOR AND/OR ENGINEER.

5. PRIOR TO ANY CONSTRUCTION ACTIVITY, THE CONTRACTOR SHALL BECOME FAMILIAR WITH THE PLANS AND SPECIFICATIONS INCLUDING ALL NOTES, THE STANDARD SPECIFICATIONS FOR PUBLIC WORKS CONSTRUCTION, 3rd ADDITION, AS ISSUED BY THE NORTH TEXAS CENTRAL TEXAS COUNCIL OF GOVERNMENTS, THE CITY STANDARDS FOR PUBLIC WORKS CONSTRUCTION AND ANY OTHER APPLICABLE STANDARDS AND SPECIFICATIONS RELEVANT TO THE PROPER COMPLETION OF THE WORK HEREIN SPECIFIED FAILURE ON THE PART OF THE CONTRACTOR TO BECOME FAMILIAR WITH SAID STANDARDS AND SPECIFICATIONS PERTAINING TO THIS WORK SHALL IN NO WAY RELIEVE THE CONTRACTOR OF RESPONSIBILITY OF PERFORMING THE WORK IN ACCORDANCE WITH ALL SUCH APPLICABLE STANDARDS AND SPECIFICATIONS.

6. REFER TO THE GEOTECHNICAL REPORT FOR SUBSURFACE SOIL CONDITIONS AND RECOMMENDATIONS PERTAINING TO THE SUBJECT SITE.

7. ALL DIMENSIONS ARE FROM BACK OF CURB TO BACK OF CURB, UNLESS OTHERWISE

8. REFER TO THE STANDARD DETAILS AND GENERAL NOTES PLAN(S) FOR PAVING, DRAINAGE, AND UTILITY STANDARD DETAILS AND GENERAL NOTES. 9. REFER TO THE ARCHITECTURAL AND STRUCTURAL PLANS TO VERIFY ALL BUILDING

10. REFER TO THE ARCHITECTURAL PLANS FOR DETAILED BUILDING ENTRANCE LAYOUTS,

RAMPS, DUMPSTER AREA, BUILDING OVERHANGS, BOLLARDS, LANDSCAPING AND

11. REFER TO THE ARCHITECTURAL AND MECHANICAL PLANS FOR THE EXACT LOCATIONS FOR ROOF DRAIN COLLECTION SYSTEM TIE IN LOCATIONS.

12. REFER TO THE ARCHITECTURAL AND ELECTRICAL PLANS FOR THE SITE LIGHTING LOCATIONS, REQUIREMENTS AND SPECIFICATIONS.

13. DUMPSTER SCREENING TO COMPLY WITH CITY REQUIREMENTS.

## INDEX OF DRAWINGS

COVER SHEET FINAL PLAT (4 SHEETS)

SA-1.3 ENLARGED SITE PLAN (BY OTHERS) SA-2.2 SITE DETAILS/FUEL PAD PLANS (BY OTHERS)

DRAINAGE AREA MAP

GRADING PLAN C3.01

EROSION CONTROL SITE PLAN (SWPPP) EROSION CONTROL DETAILS (SWPPP)

STORM SEWER PLAN


WATER & SANITARY SEWER PLAN

GENERAL NOTES SHEET


THE SEAL APPEARING ON THIS DOCUMENT WAS AUTHORIZED BY BRANDON E. COX, PE. 10/037 ON 08-05-09 . ALTERATION OF A SEALED DOCUMENT WITHOUT PROPER NOTIFICATION TO THE RESPONSIBLE ENGINEER IS AN OFFENSE UNDER THE TEXAS


04-30-10 RECORD DRAWINGS




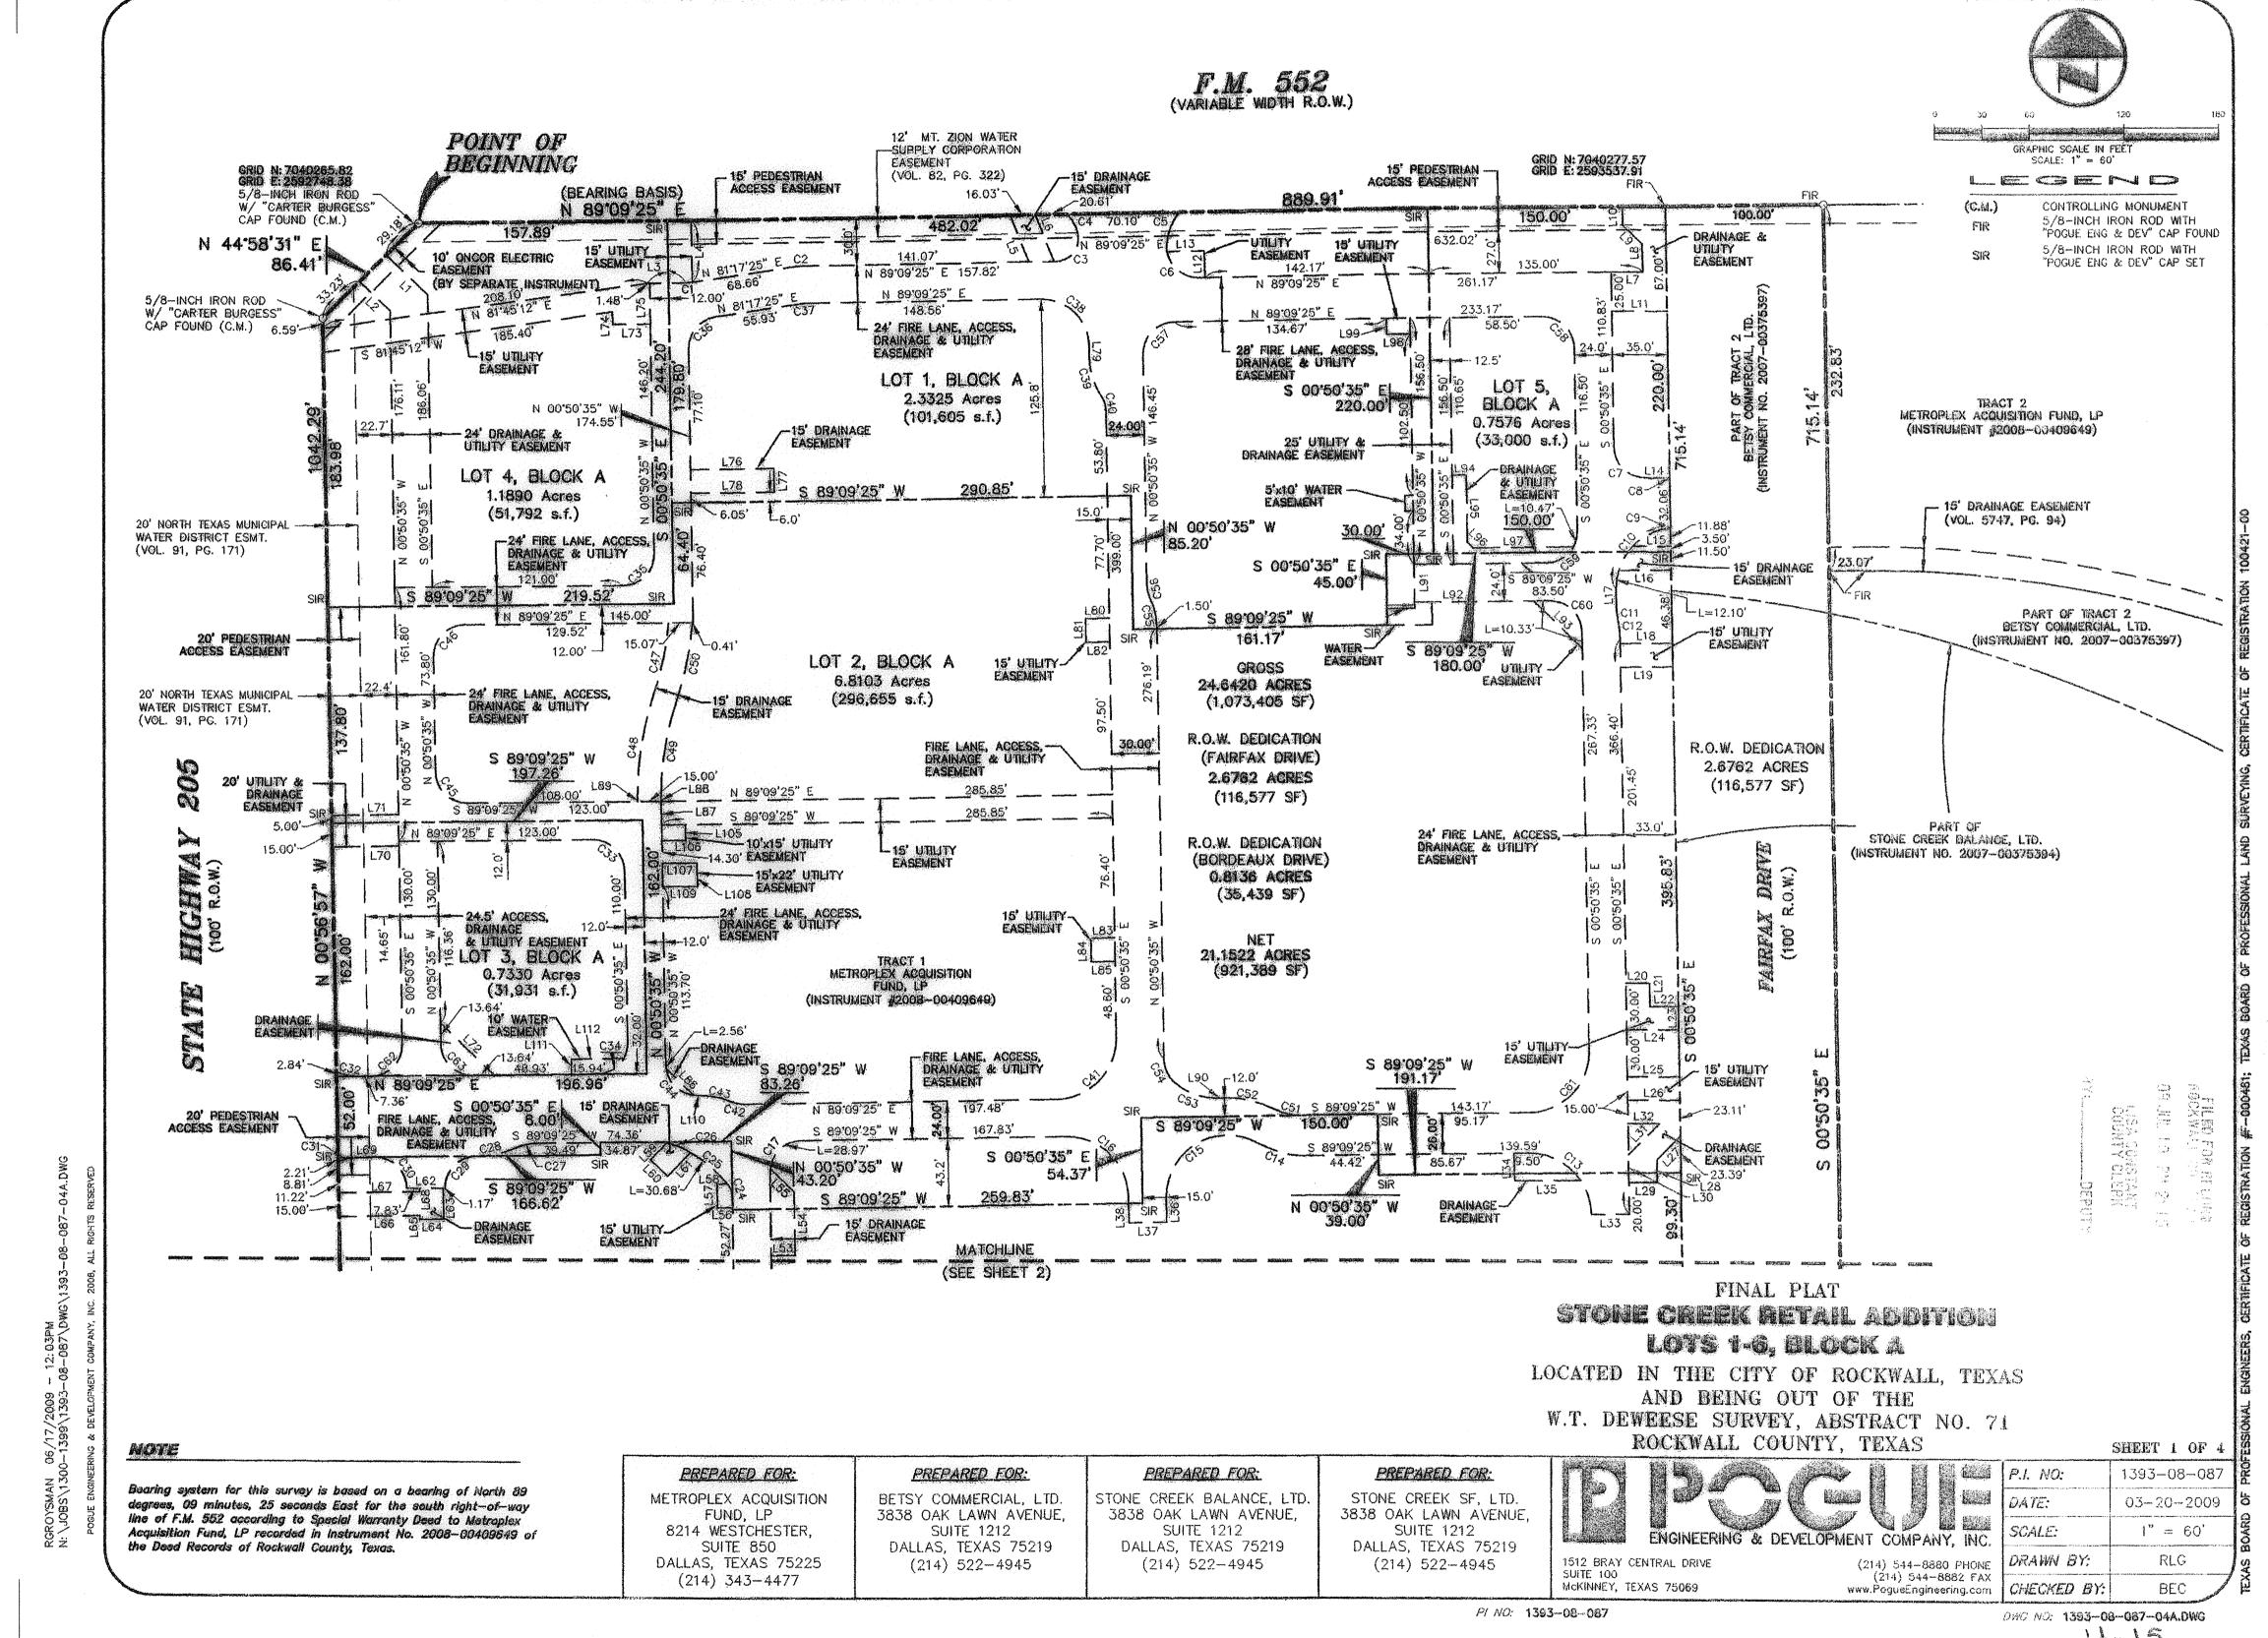


4-15

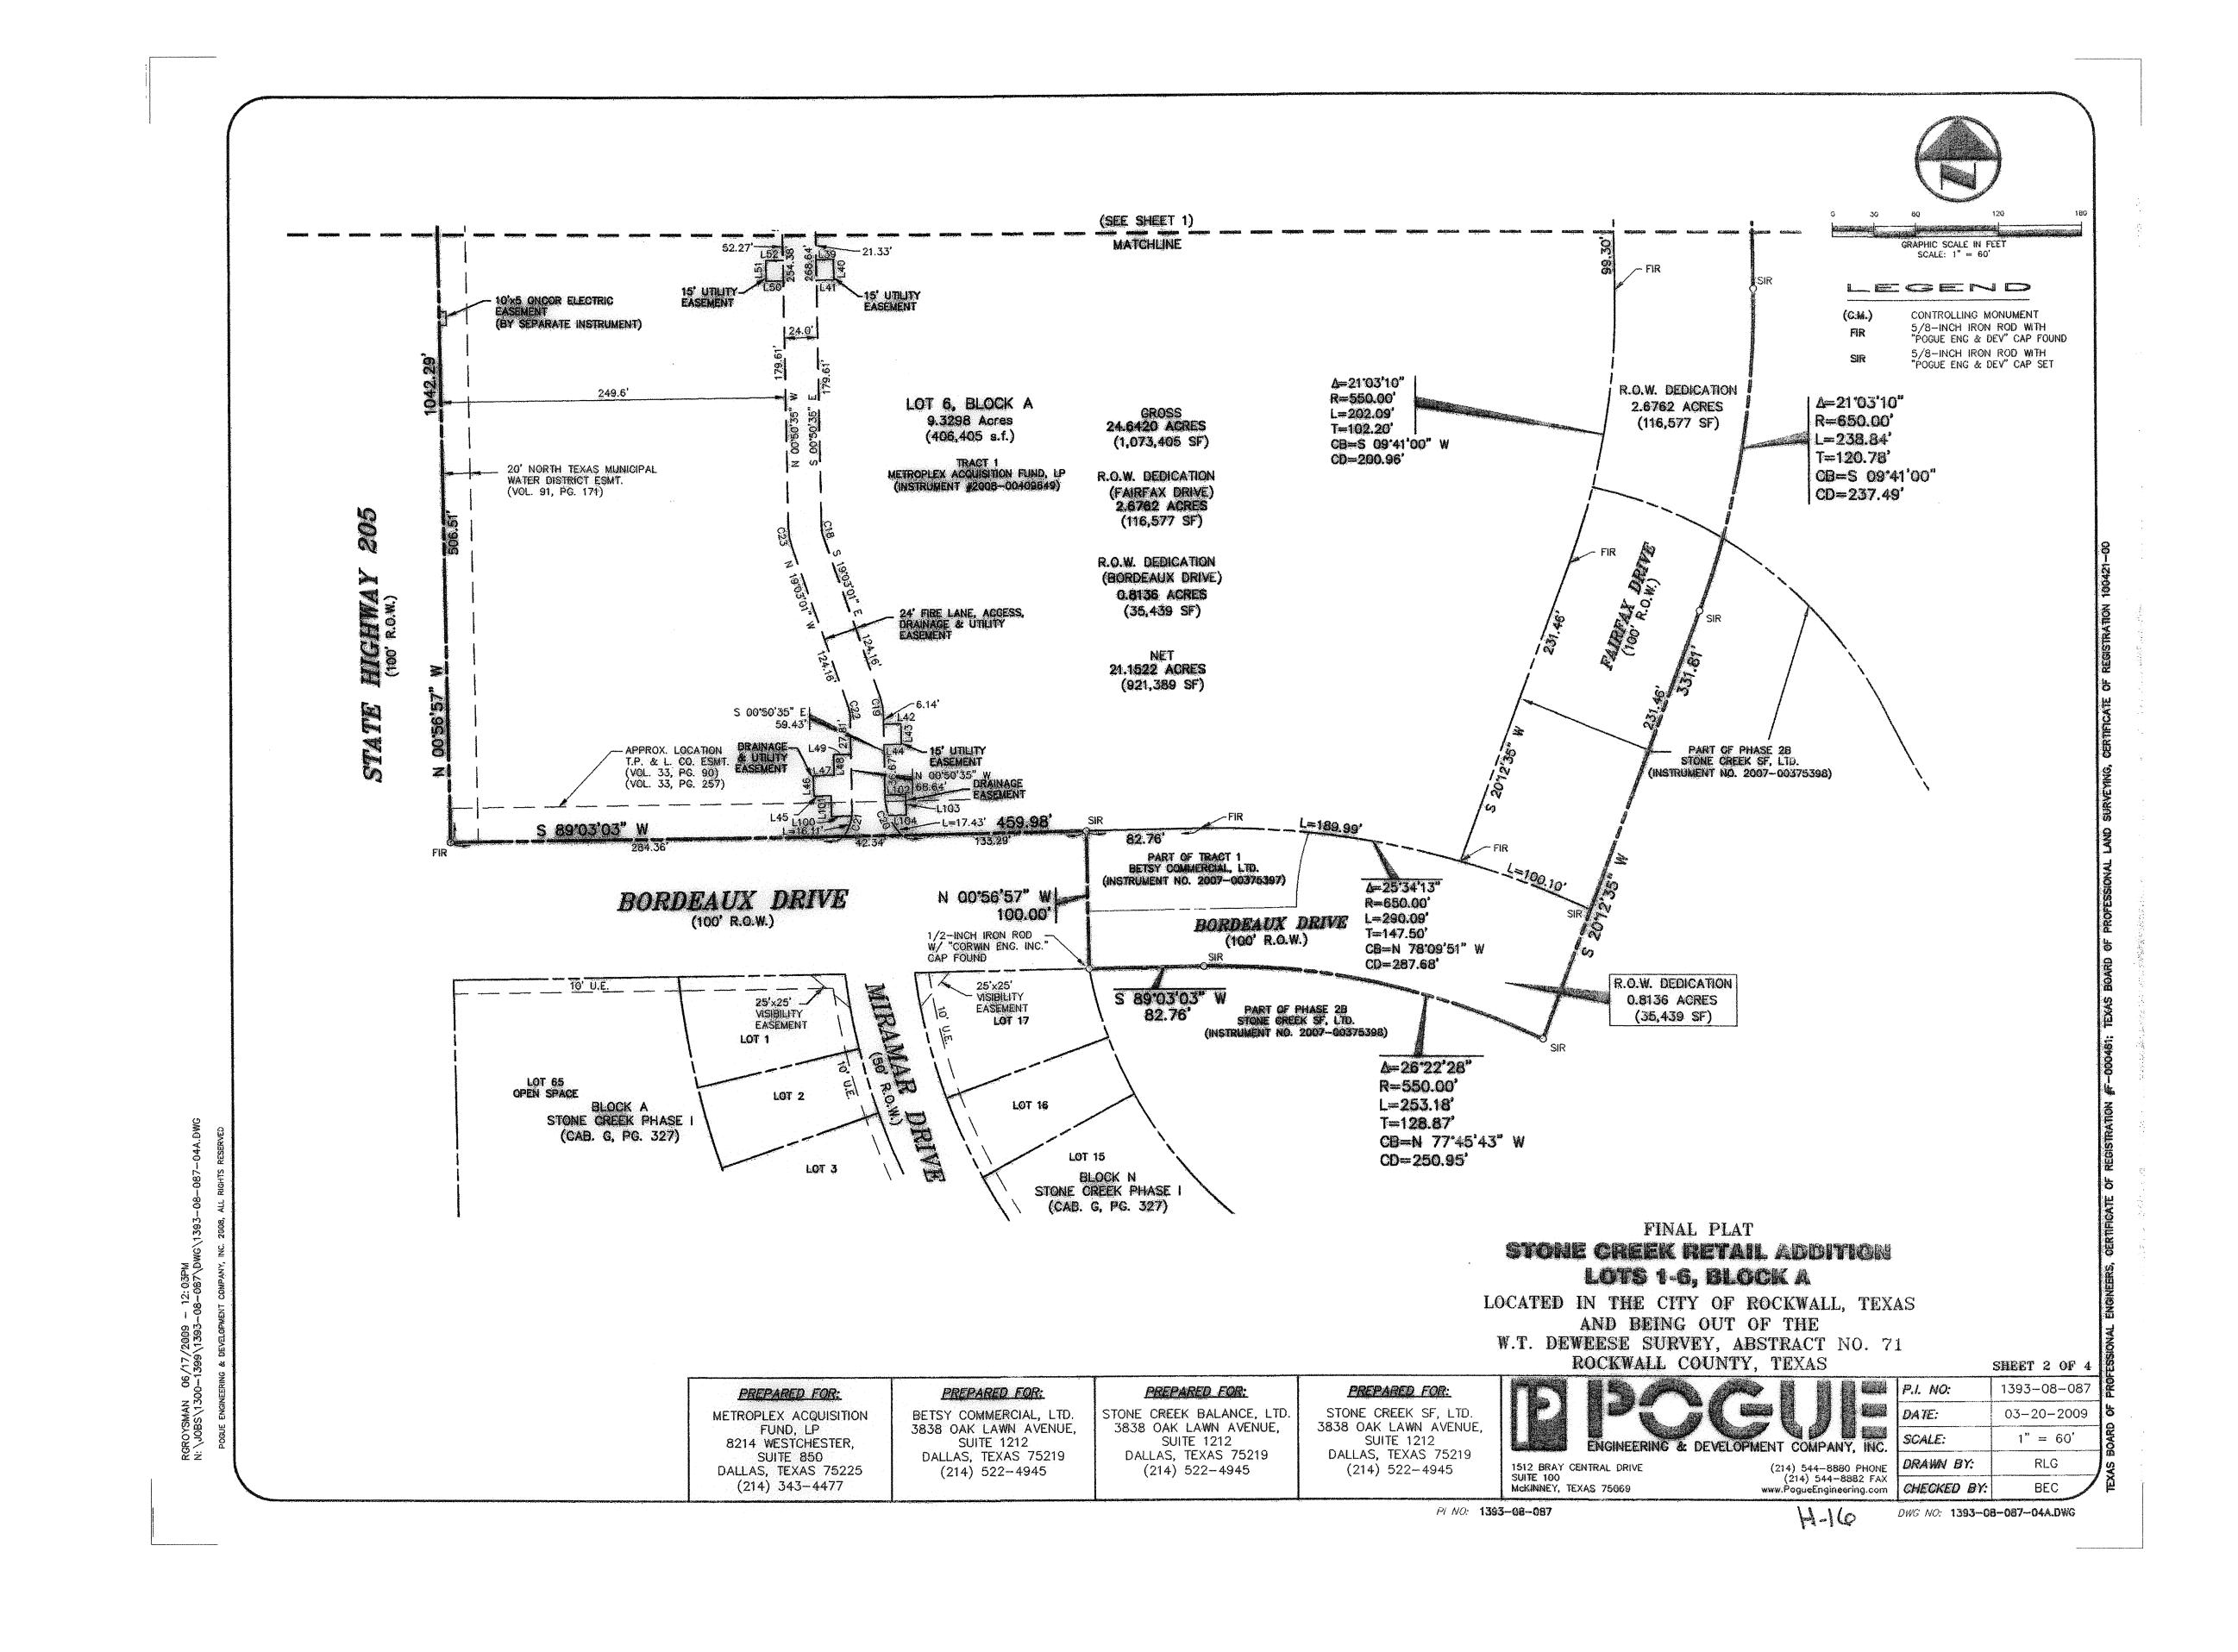

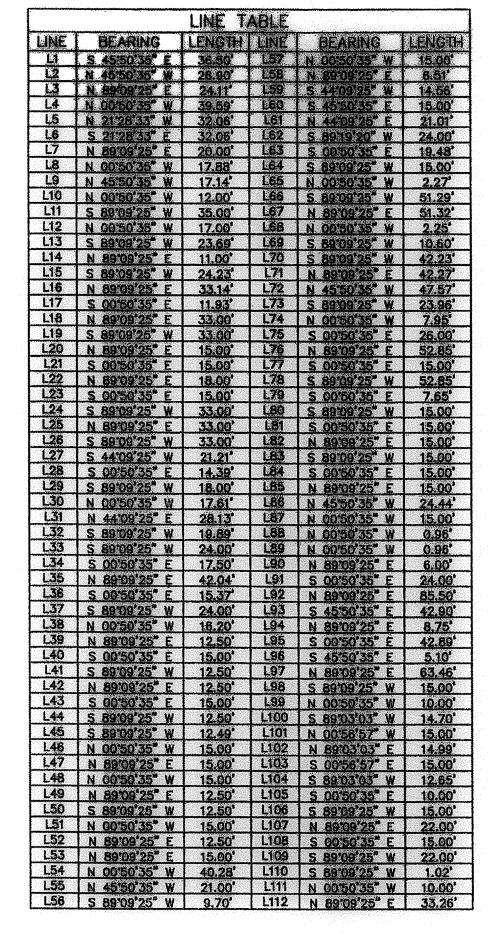

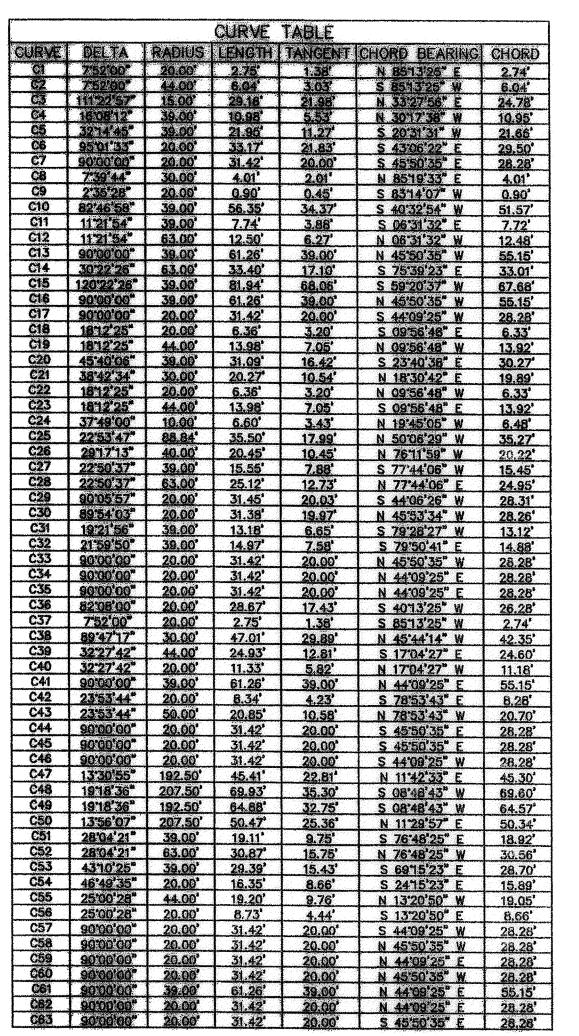

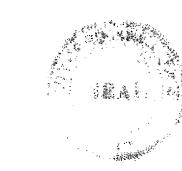

FINAL PLAT STONE CREEK RETAIL ADDITION Lots 1-6, block a

LOCATED IN THE CITY OF ROCKWALL, TEXAS AND BEING OUT OF THE W.T. DEWEESE SURVEY, ABSTRACT NO. 71

ROCKWALL COUNTY, TEXAS

DRAWN BY: (214) 544-8880 PHONE (214) 544-8882 FAX www.PogueEngineering.com CHECKED BY:

DWG NO: 1393-08-087-04A.DWG

PREPARED FOR: METROPLEX ACQUISITION FUND, LP 8214 WESTCHESTER, SUITE 850 DALLAS, TEXAS 75225

(214) 343-4477

PREPARED FOR: BETSY COMMERCIAL, LTD. 3838 OAK LAWN AVENUE, **SUITE 1212** DALLAS, TEXAS 75219 (214) 522-4945

PREPARED FOR: STONE CREEK BALANCE, LTD. 3838 OAK LAWN AVENUE, **SUITE 1212** DALLAS, TEXAS 75219 (214) 522-4945

PREPARED FOR: STONE CREEK SF, LTD. 3838 OAK LAWN AVENUE **SUITE 1212** DALLAS, TEXAS 75219 (214) 522-4945

1512 BRAY CENTRAL DRIVE SUITE 100 MCKINNEY, TEXAS 75069

PI NO: 1303-08-087

BEC

SHEET 3 OF 4

1393-08-087

03-20-2009

1" = 60'

RLG

WHEREAS, Metroplex Acquisition Fund, LP, Betsy Commercial, Ltd., Stone Creek Balance, Ltd. and Stone Creek SF, Ltd. are the owners of a 24.6420 acre tract of land situated in the W.T. Dewesse Survey, Abstract No. 71, City of Rockwall, Rockwall County, Texas; said tract being all of that certain tract of land described as Tract 1 in Special Warranty Deed to Metroplex Acquisition Fund, LP recorded in Instrument No. 2008—00409649 of the Deed Records of Rockwall County, Texas, part of those certain tracts of land described as Tract 1 and Tract 2 in Special Warranty Deeds to Betsy Commercial, Ltd. recorded in Instrument No. 2007—00375397 of the said Deed Records, part of that certain tract of land described in Special Warranty Deeds to Stone Creek Balance, Ltd. recorded in Instrument No. 2007—00375394 of the said Deed Records and part of that certain tract of land described as Phase 28 in Special Warranty Deed to Stone and part of that certain tract of land described as Phase 28 in Special Warranty Deed to Stone Creek SF, Ltd. recorded in Instrument No. 2007-00375398 of the said Deed Records; said 24.6420 acre tract being more particularly described as follows:

BEGINNING, at a 5/8-inch iron rod with "Carter Burgess" cap found for corner at the north end of a right-of-way corner clip at the intersection of the east right-of-way line of State Highway 205 (a 100-foot wide right-of-way) and the south right-of-way line of F.M. 552 (a variable width right-of-way);

THENCE, North 89 degrees, 09 minutes, 25 seconds East, along the said south line of F.M. 552, at a distance of 789.91 feet passing a 5/8—inch iron rod with "Pogue Eng & Dev" cap found at the northeast corner of said Tract 1, continuing along said south line of F.M. 552, in all a total distance of 889.91 feet to a 5/8—inch iron rod with "Pogue Eng & Dev" cap found for corner; said point also being the northwest corner of that certain tract of land described as Tract 2 in same deed to Metroplex Acquisition Fund, LP;

THENCE, South 00 degrees, 50 minutes, 35 seconds East, departing the said south line of F.M. 552 and along the west line of second referenced Tract 2, at a distance of 232.83 feet passing a 5/8-Inch iron rad with "Pague Eng & Dev" cap found at the southwest corner of second referenced Tract 2, continuing in all a total distance of 715.14 feet to a 5/8-inch iron rod with "Pogue Eng & Dev" cap set at the beginning of a tangent curve to the right;

THENCE, in a southwesterly direction, along said curve to the right, having a central angle of 21 degrees, 03 minutes, 10 seconds, a radius of 650.00 feet, a chard bearing and distance of South 09 degrees, 41 minutes, 00 seconds West, 237.49 feet, an arc distance of 238.84 feet to a 5/8-inch iron rod with "Pogue Eng & Dev" cap set at the end of said curve;

THENCE, South 20 degrees, 12 minutes, 35 seconds West, a distance of 331.81 feet to a 5/8—inch iron rod with "Pogue Eng & Dev" cap set for corner; said point being the beginning of a non-tangent curve to the left;

THENCE, in a northwesterly direction, along said curve to the left, having a central angle of 26 degrees, 22 minutes, 28 seconds, a radius of 550.00 feet, a chord bearing and distance of North 77 degrees, 45 minutes, 43 seconds West, 250.95 feet, an arc distance of 253.18 feet to a 5/8-inch iron rod with "Pogue Eng & Dev" cap set at the end of said curve;

THENCE, South 89 degrees, 03 minutes, 03 seconds West, a distance of 82.76 feet to a 1/2-inch iron rod with "Corwin Emg Inc." cap found for corner; said point being at the south end of the east terminus of Bordeaux Drive (a 100-foot wide right-of-way); said point also being the northeast corner of Lot 17, Block N, Stone Creek Phase I, an addition to the City of Rockwall, Texas according to the plat recorded in Cabinet G, Page 327 of the Plat Records of

THENCE, North 00 degrees, 56 minutes, 57 seconds West, along the said east terminus of Bordeaux Drive, a distance of 100.00 feet to a 5/8-inch iron rod with "Pague Eng & Dev" cap set for corner; said point also being at the north end of said east terminus of Bordeaux Drive;

THENCE, South 89 degrees, 03 minutes, 03 seconds West, departing the said east terminus of Bordeaux Drive and along the north right—of—way line of said Bordeaux Drive, a distance of 459.98 feet to a 5/8—inch iron rod with "Pogue Eng & Dev" cap found for corner at the intersection of the said east line of State Highway 205 and the said north line of Bordeaux Drive; said point also being the southwest corner of said Tract 1;

THENCE, North 00 degrees, 56 minutes, 57 seconds West, departing the sold north line of Bordeaux Drive and along the sold east line of State Highway 205 and the west line of Tract 1, a distance of 1042.29 feet to a 5/8—inch iron rod with "Carter Burgess" cap found for corner; said point also being the south end of said right-of-way corner clip:

THENCE, North 44 degrees, 58 minutes, 31 seconds East, departing the said east line of State Highway 205 and said west line of Tract 1 and along the said corner clip, a distance of 86.41 feet to the POINT OF BEGINNING;

CONTAINING, 1,073,405 square feet or 24.6420 acres of land, more or less.

SURVEYOR'S CERTIFICATE

NOW, THEREFORE KNOW ALL MEN BY THESE PRESENTS:

THAT I, Roman L. Greysman, do hereby certify that I prepared this plat from an actual and accurate survey of the land, and that the corner manuments shown thereon were properly placed under my personal supervision.

R. GROYSman 5/28/09



NOW, THEREFORE, KNOW ALL MEN BY THESE PRESENTS:

COUNTY OF ROCKWALL I the undersigned owner of the land shown on this plat, and designated herein as the STONE CREEK RETAIL ADDITION, LOTS 1—6, BLOCK A, subdivision to the City of Rockwall, Texas, and whose name is subscribed hereto, hereby dedicate to the use of the public forever all streets, alleys, parks, water courses, drains, easements and public places thereon shown on the purpose and consideration therein expressed. We further certify that all other parties who have a mortgage or lien interest in the STONE CREEK RETAIL ADDITION, LOTS 1—6, BLOCK A, have been notified and signed this plat.

I understand and do hereby reserve the easement strips shown on this plat for the purposes stated and for the mutual use and accommodation of all utilities desiring to use or using same.

1. No buildings shall be constructed or placed upon, over, or across the utility easements as

2. Any public utility shall have the right to remove and keep removed all or part of any buildings, fences, trees, shrubs, or other growths or improvements which in any way endanger or interfere with construction, maintenance or efficiency of their respective system on any of these easement strips; and any public utility shall at all times have the right of ingress or egress to, from and upon the said easement strips for purpose of construction, reconstruction, inspecting, patrolling, maintaining, and either adding to or removing all or part of their respective system without the percentily of at any time procuring the permission of appears. without the necessity of, at any time, procuring the permission of anyone.

3. The City of Rockwall will not be responsible for any claims of any nature resulting from or occasioned by the establishment of grade of streets in the subdivision.

4. The developer and subdivision engineer shall bear total responsibility for storm drain

5. The developer shall be responsible for the necessary facilities to provide drainage patterns and drainage controls such that properties within the drainage area are not adversely affected by storm drainage from the development.

6. No house dwelling unit, or other structure shall be constructed on any lot in this addition by the owner or any other person until the developer and/or owner has complied with all requirements of the Subdivision Regulations of the City of Rockwall regarding improvements with respect to the entire black on the street or streets on which property abuts, including the actual installation of streets with the required base and paving, curb and gutter, water and sewer, drainage structures, storm structures, storm sewers, and alleys, all according to the specifications of the City of Rockwall; or

Until an escrow deposit, sufficient to pay for the cost of such improvements, as determined by the city's engineer and/or city administrator, computed on a private commercial rate basis, has been made with the city secretary, accompanied by an agreement signed by the developer and/or owner, authorizing the city to make such improvements at prevailing private commercial rates, or have the same made by a contractor and pay for the same out of the escrow deposit, should the developer and/or owner fail or refuse to install the required improvements within the time stated in such written agreement, but in no case shall the City be obligated to make such improvements itself. Such deposit may be used by the owner and/or developer as progress payments as the work progresses in making such improvements by making certified requisitions to the city secretary, supported by evidence of work done; or

Until the developer and/or owner files a corporate surety bond with the city secretary in a sum equal to the cost of such improvements for the designated area, guaranteeing the installation thereof within the time stated in the bond, which time shall be fixed by the city council of the City of Rockwall.

I further acknowledge that the dedications and/or exaction's made herein are proportional to the impact of the Subdivision upon the public services required in order that the development will comport with the present and future growth needs of the City; Our successors and assigns hereby waive any claim, damage, or cause of action that We may have as a result of the dedication of exactions made herein.

METROPLEX ACQUISITION FUND, LP a Texas limited pertnership
By: SIX PINES REALTY, L.C.
a Texas limited liability company
its general partner

STATE OF TEXAS COUNTY OF DALLAS

Before me, the undersigned authority, on this day personally appeared Ronald G. Gentzier, known to me to be the person whose name is subscribed to the foregoing instrument, and acknowledged to me that he executed the same for the purpose and consideration therein

Notary Public in and for the State of Texas My Commission Expires: \_\_\_\_\_



STATE OF TEXAS Before me, the undersigned authority, on this day personally appeared RICHARD M. SKORBURG, known to me to be the person whose name is subscribed to the foregoing instrument, and acknowledged to me that he executed the same for the purpose and consideration therein stated. Given upon my hand and seal of office this 15 day of sique medonais Notary Public in and for the State of Texas My Commission Expires: 01-99 2011 Notary Public State of Texas My Commission Expires January 09, 2011 STONE CREEK BALANCE, LTD., a Texas limited partnership By: STONE CREEK BALANGE GP Corporation, a Texas corporation, its general partner By: Richard M. Skorburg, President STATE OF TEXAS COUNTY OF DALLAS Before me, the undersigned authority, on this day personally appeared RICHARD M. SKORBURG, known to me to be the person whose name is subscribed to the foregoing instrument, and acknowledged to me that he executed the same for the purpose and consideration therein stated. Given upon my hand and seal of office this /5 77 day of 1009. ANGLIE MCDONALD Rainelle McDonala Ministery Public, State of Texas My Commission Expires Notary Public in and for the State of Texas

My Commission Expires: 01-09-2011 Jenuary 69, 2011 STONE CREEK SF, LTD., a Texas limited partnership

By: STONE CREEK SF GP Corporation, a Texas corporation, its general partner By: Richard M. Skorburg, President STATE OF TEXAS COUNTY OF DALLAS Before me, the undersigned authority, on this day personally appeared RICHARD M. SKORBURG, known to me to be the person whose name is subscribed to the foregoing instrument, and acknowledged to me that he executed the same for the purpose and consideration therein stated. Given upon my hand and seal of office this 54 day of Aune Paialle McDonald RAMELLE MCDONALD
Notern Hubble, State of Texas

BETSY COMMERCIAL, LTD., a Texas limited partnership

By: BETSY COMMERCIAL GP Corporation, a Texas corporation, its general partner

<u>RECOMMENDED FOR FINAL APPROVAL</u> 04-14-09 **APPROVED** I hereby certify that the above and foregoing plat of an addition to the City of Rockwall, Texas, was approved by the City Council of the City of Rockwall on the day of April 2009. WITNESS OUR HANDS this 2nd day of \_ Mayori City of Rockwall Shuty Ushberry

SHAL

City Secketary City of Rockwall Chad Isl 7-10-09 City of Rockwall Engineer

FINAL PLAT

Notary Public in and for the State of Texas My Commission Expires: 01-09-2011

STONE CREEK RETAIL ADDITION LOTS 1-6, BLOCK A

LOCATED IN THE CITY OF ROCKWALL, TEXAS AND BEING OUT OF THE W.T. DEWEESE SURVEY, ABSTRACT NO. 71

ROCKWALL COUNTY, TEXAS 1512 BRAY CENTRAL DRIVE

(214) 544-8880 PHONE (214) 544-8882 FAX www.PogueEngineering.com

1393-08-087 03-20-2009 1" = 60'DRAWN BY: RLG CHECKED BY: BEC

SHEET 4 OF 4

PREPARED FOR: METROPLEX ACQUISITION FUND, LP 8214 WESTCHESTER. SUITE 850 DALLAS, TEXAS 75225

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PREPARED FOR: BETSY COMMERCIAL, LTD. 3838 OAK LAWN AVENUE, SUITE 1212 DALLAS, TEXAS 75219 (214) 522-4945

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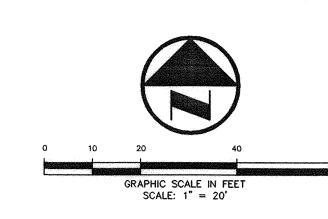
SUITE 100

My Commission Expires Jonatory 09, 2011

FRANCHISE UTILITY NOTES:

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2. ATMOS ENERGY (GAS) - 903-457-2092 - DINAH WOOD 3. AT&T (PHONE) - 903-457-2092 - DWAYNE WELLS



#### LEGEND

BOLLARD ELECTRIC METER POWER POLE LIGHT STANDARD WATER METER

WATER VALVE IRRIGATION CONTROL VALVE

FIRE HYDRANT FIRE DEPARTMENT CONNECTION CLEAN OUT

6

1512 BRA'SUITE 100 MCKINNEY

MH (O) MANHOLE GAS METER TRAFFIC SIGNAL CONTROL TRAFFIC SIGNAL POLE

TRAFFIC SIGN TELEPHONE BOX TV BOX

FLAG POLE LANDSCAPE AREA PROPERTY LINE

OHL OH. POWER LINES TEL U/G TELEPHONE LINES WATER U/G WATER LINE GAS LINE

EXISTING CONTOURS EXISTING SPOT GRADES XXX.XX ~ (XXX)~ PROPOSED CONTOURS (BY OTHERS)

PROPOSED SPOT GRADES (BY OTHERS) CONTROLLING MONUMENT

5/8-INCH IRON ROD WITH "POGUE ENG & DEV" CAP SET

PROPOSED CONTOURS PROPOSED SPOT GRADES PROPOSED EROSION CONTROL PROPOSED DRAINAGE DIVIDES

DRAINAGE AREA TABLE/CALCULATIONS hooPRE-DEV QooPRE-DEV REMARKS AREA # 8.30 1.28 TO 10' CURB INLET/LINE 'ST-2H' TO 10' CURB INLET/LINE 'ST-21' 14.91 8.30 TO 10' CURB INLET/LINE 'ST-2J' 0.90 9.80 8.56 8.30 TO DROP INLET/LINE 'ST-2K' Tc = 10 MIN. (DEVELOPED)
C = 0.90 COMMERCIAL
C = 0.50 RESIDENTIAL 4.06 8.30 1.34 TO 5' CURB INLET/LINE 'ST-4A' 1.15 8.30 TO 10' CURB INLET/LINE 'ST-4B' 6.88 8.30 TO LINE 'ST-4' C = 0.90 TXDOT RIGHT-OF-WAY Tc = 20 MIN. (PRE-DEVELOPED) C = 0.35 PRE-DEVELOPED 0.27 TO 3' X 3' TXDOT INLET/LINE 'ST-4C' 2.38 8.30 | 1100 = 8.30 (IN/HR) PRE-DEVELOPED | 1100 = 9.80 (IN/HR) DEVELOPED | A = AREA (ACRES) 0.29 TXDOT R.O.W./EX. 30" CULVERT 9.80 2.56 8.30 0.84 8.30 0.46 PROPOSED ROOF DRAINS/LINE 'ST-4' 0.90 9.80 1.41

\*REFER TO OVERALL DEVELOPMENT PLANS FOR LOTS 1-6 OF THE STONE CREEK RETAIL ADDITION, BY POGUE ENGINEERING & DEVELOPMENT COMPANY, INC., DATED 05-21-09 FOR FURTHER DETAILS.

RECORD DRAWINGS:
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DATE: <u>APRIL 30, 2010</u>

RANDALL P. POGUE, P.E.

TX LIC. NO. 84780

THE SEAL APPEARING ON THIS DOCUMENT WAS AUTHORIZED BY BRANDON E. COX, P.E. 101037 ON 08-05-09 . ALTERATION OF A SEALED DOCUMENT WITHOUT PROPER NOTIFICATION TO THE RESPONSIBLE ENGINEER IS AN OFFENSE UNDER THE TEXAS ENGINEERING PRACTICE ACT.

BRANDON E. COX

PI NO: 1393-09-024

DWG NO: 1393-09-024-07A.DWG

CAUTIONIII

CALL BEFORE YOU DIG:

TEXAS ONE CALL SYSTEMS 1-800-245-4545

1-800-669-8344 EXT. 5

LONE STAR NOTIFICATION CENTER

1-800-344-8377

UNDERGROUND UTILITIES ARE LOCATED IN

CONSTRUCTION ACTIVITIES, CONTACT LINE

TEXAS EXCAVATION SAFETY SYSTEM (TESS)

THIS AREA. 48 HOURS PRIOR TO ANY

LOCATES FOR FRANCHISE UTILITY INFO.

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CITY OF ROCKWALL MONUMENT (R010) FOUND.
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SQUARE CUT SET AT SOUTHWESTCORNER OF WATER VAULT LOCATEDED AT
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ISSUE:

DWG. FILE:

CHECKED BY:

08-05-09

1393-09-024-07A


PROJECT No.: 1393-09-024

SHEET TITLE

DRAINAGE

AREA MAP

SHEET No.

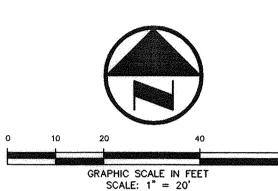

### LEGEND

ELECTRIC METER POWER POLE LIGHT STANDARD WATER METER WATER VALVE IRRIGATION CONTROL VALVE FIRE HYDRANT FIRE DEPARTMENT CONNECTION

BOLLARD

CLEAN OUT MH (O) MANHOLE GAS METER

TRAFFIC SIGNAL CONTROL TRAFFIC SIGNAL POLE TRAFFIC SIGN TELEPHONE BOX TV BOX

FLAG POLE LANDSCAPE AREA PROPERTY LINE

-OHL --- O.H. POWER LINES U/G TELEPHONE LINES WATER U/G WATER LINE GAS U/G GAS LINE

---×------×--- FENCE EXISTING CONTOURS XXX.XX EXISTING SPOT GRADES -XXX PROPOSED CONTOURS (BY OTHERS) PROPOSED SPOT GRADES (BY OTHERS)

CONTROLLING MONUMENT 5/8-INCH IRON ROD WITH "POGUE ENG & DEV" CAP SET

PROPOSED CONTOURS PROPOSED SPOT GRADES PROPOSED EROSION CONTROL

PROPOSED DRAINAGE DIVIDES

## PAVEMENT LEGEND

NEW PAVEMENT UNDER THIS CONTRACT (REFER TO SHEET SA-1.3 & SA-2.2 FOR DETAILS)

ADA ROUTE MAXIMUM SLOPE FOR ALL ADA PATHS 5%; MAX. CROSS FALL IS 2%; FOR THE FIRST FIVE FOOT FROM THE DOOR A 2% SLOPE (MAX.) MUST BE

 $\triangle$ 

ALL FILL IS TO BE COMPACTED TO A MINIMUM OF 95% USING A SHEEPSFOOT ROLLER.

CAUTIONIII UNDERGROUND UTILITIES ARE LOCATED IN THIS AREA. 48 HOURS PRIOR TO ANY CONSTRUCTION ACTIVITIES, CONTACT LINE LOCATES FOR FRANCHISE UTILITY INFO. CALL BEFORE YOU DIG: TEXAS EXCAVATION SAFETY SYSTEM (TESS) 1-800-344-8377

TEXAS ONE CALL SYSTEMS

1-800-669-8344 EXT. 5

LONE STAR NOTIFICATION CENTER

1-800-245-4545

BENCH MARK LIST:

CITY OF ROCKWALL MONUMENT (RO10) FOUND. ELEVATION = 524.788

SQUARE CUT SET AT SOUTHWESTCORNER OF WATER VAULT LOCATEDED AT THE SOUTHEAST CORNER OF THE INTERSECTION OF THE EAST RIGHT-OF-WAY LINE OF SH 205 AND THE SOUTH RIGHT-OF-WAY LINE OF FM 552. ELEVATION = 543.09

FRANCHISE UTILITY NOTES:

1. TXU ENERGY CONSTRUCTION SERVICES - (800) 711-9112 2. ATMOS ENERGY (GAS) - 903-457-2092 - DINAH WOOD 3. AT&T (PHONE) - 903-457-2092 - DWAYNE WELLS

RECORD DRAWINGS:
IT WAS THE INTENT THAT THE IMPROVEMENTS SHOWN BE CONSTRUCTED ACCORDING TO THESE PLANS AS APPROVED BY THE CITY. THE LINES AND GRADES WERE SET ON THE GROUND FOR CONSTRUCTION ACCORDING TO SAID PLANS. THE CITY INSPECTED THE CONSTRUCTION. THE ENGINEER DID NOT VERIFY LINES OR GRADES AFTER CONSTRUCTION. WE ARE NOT AWARE OF ANY CHANGES OR REVISIONS TO THESE PLANS DURING CONSTRUCTION OTHER THAN THOSE SHOWN.

RANDALL P. POGUE, P.E. TX LIC. NO. 84780

DATE: APRIL 30, 2010

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PI NO: 1393-09-024

DWG NO: 1393-09-024-07A.DWG

DRAWN BY: CHECKED BY: SHEET TITLE

08-05-09

1393-09-024-07/

PROJECT No.: 1393-09-024

DWG. FILE:

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1512 BRA SUITE 100

Randalls

M

GRADING PLAN

SHEET No.

FRANCHISE UTILITY NOTES:


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3. AT&T (PHONE) - 903-457-2092 - DWAYNE WELLS

MAPSCO 10C-

VICINITY MAP
NOT TO SCALE



#### LEGEND

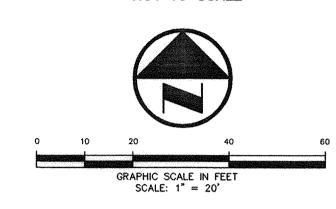BOLLARD ELECTRIC METER POWER POLE LIGHT STANDARD WATER METER WATER VALVE IRRIGATION CONTROL VALVE FIRE HYDRANT FIRE DEPARTMENT CONNECTION CLEAN OUT MH (O) MANHOLE GAS METER TRAFFIC SIGNAL CONTROL TRAFFIC SIGNAL POLE TRAFFIC SIGN

TELEPHONE BOX TV BOX FLAG POLE LANDSCAPE AREA

PROPERTY LINE OHL POWER LINES U/G TELEPHONE LINES WATER U/G WATER LINE

GAS LINE \_\_\_\_ × \_\_\_\_ × \_\_\_ FENCE EXISTING CONTOURS EXISTING SPOT GRADES

-- (XXX) PROPOSED CONTOURS (BY OTHERS) PROPOSED SPOT GRADES (BY OTHERS) CONTROLLING MONUMENT

5/8-INCH IRON ROD WITH "POGUE ENG & DEV" CAP SET

PROPOSED CONTOURS

TC XXX.XX PROPOSED SPOT GRADES PROPOSED EROSION CONTROL PROPOSED DRAINAGE DIVIDES

**EROSIONS CONTROL GENERAL NOTES:** 1. REFER TO SHEET C4.02 FOR THE EROSION CONTROL DETAILS AND POLLUTION PREVENTION PLAN NOTES/SPECIFICATIONS/REQUIREMENTS. 2. THE CONTRACTOR SHALL BE RESPONSIBLE FOR MAINTAINING ALL MEASURES OF THIS EROSION CONTROL PLAN (SWPPP) AND COMPLYING WITH ALL FEDERAL, STATE AND LOCAL REQUIREMENTS REGARDING THE SWPPP. 3. THE CONTRACTOR SHALL BE RESPONSIBLE FOR INSTALLING AND MAINTAINING THESE MEASURES INCLUDING WATERING, MOWING AND GENERAL MAINTENANCE UNLESS OTHERWISE

CONSTRUCTION ACTIVITIES: THE CONSTRUCTION ACTIVITY INCLUDED IN THIS PLAN WILL INCLUDE THE FOLLOWING CONSTRUCTION PHASES: A. CLEARING AND GRUBBING

RELIEVED OF THESE DUTIES BY THE OWNER.

B. STOCK PILING

C. ROUGH GRADING D. UTILITY INSTALLATION/EXCAVATION OF

TRENCHES

E. FINAL OR FINISH GRADING F. PAVEMENT INSTALLATION

G. BUILDING CONSTRUCTION H. PREPARATION OF SEEDING AND PLANTING

THE SEAL APPEARING ON THIS DOCUMENT WAS AUTHORIZED BY BRANDON E. COX, PE. 101037 ON 08-05-09 . ALTERATION OF A SEALED DOCUMENT WITHOUT PROPER NOTIFICATION TO THE RESPONSIBLE ENGINEER IS AN OFFENSE UNDER THE TEXAS ENGINEERING PRACTICE ACT.

**RECORD DRAWINGS:** 

TX LIC. NO. 84780

DATE: <u>APRIL 30, 2010</u>

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ELEVATION = 543.09 CITY OF ROCKWALL MONUMENT (RO10) FOUND. ELEVATION = 524.788

SQUARE CUT SET AT SOUTHWESTCORNER OF WATER VAULT LOCATEDED AT THE SOUTHEAST CORNER OF THE INTERSECTION OF THE EAST RIGHT-OF-WAY LINE OF SH 205 AND THE SOUTH RIGHT-OF-WAY LINE OF

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CONSTRUCTION ACTIVITIES, CONTACT LINE

TEXAS EXCAVATION SAFETY SYSTEM (TESS)

THIS AREA. 48 HOURS PRIOR TO ANY

LOCATES FOR FRANCHISE UTILITY INFO.

CONSTRUCTION OTHER THAN THOSE SHOWN. RANDALL P. POGUE, P.E.

PI NO: 1393-09-024

DWG NO: 1393-09-024-07A.DWG

**EROSION** CONTROL SITE PLAN (SWPPP)

SHEET No.

SHEET TITLE

PROJECT No.: 1393-09-024

DWG. FILE:

RAWN BY:


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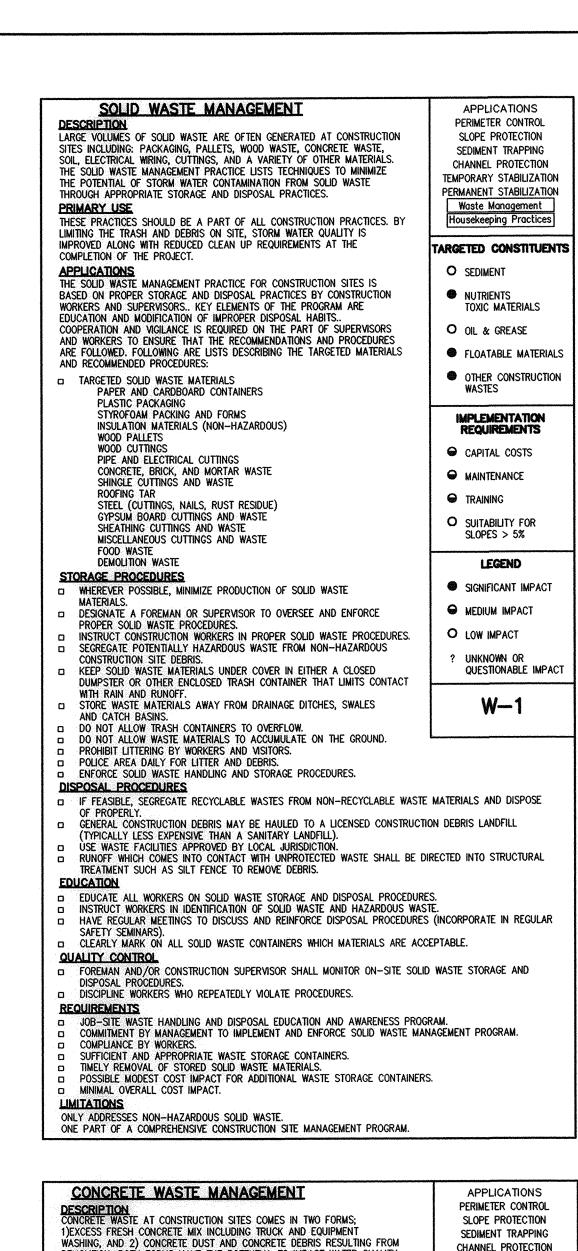
08-05-09


1393-09-024-07A

1512 BRA SUITE 100

Randalls



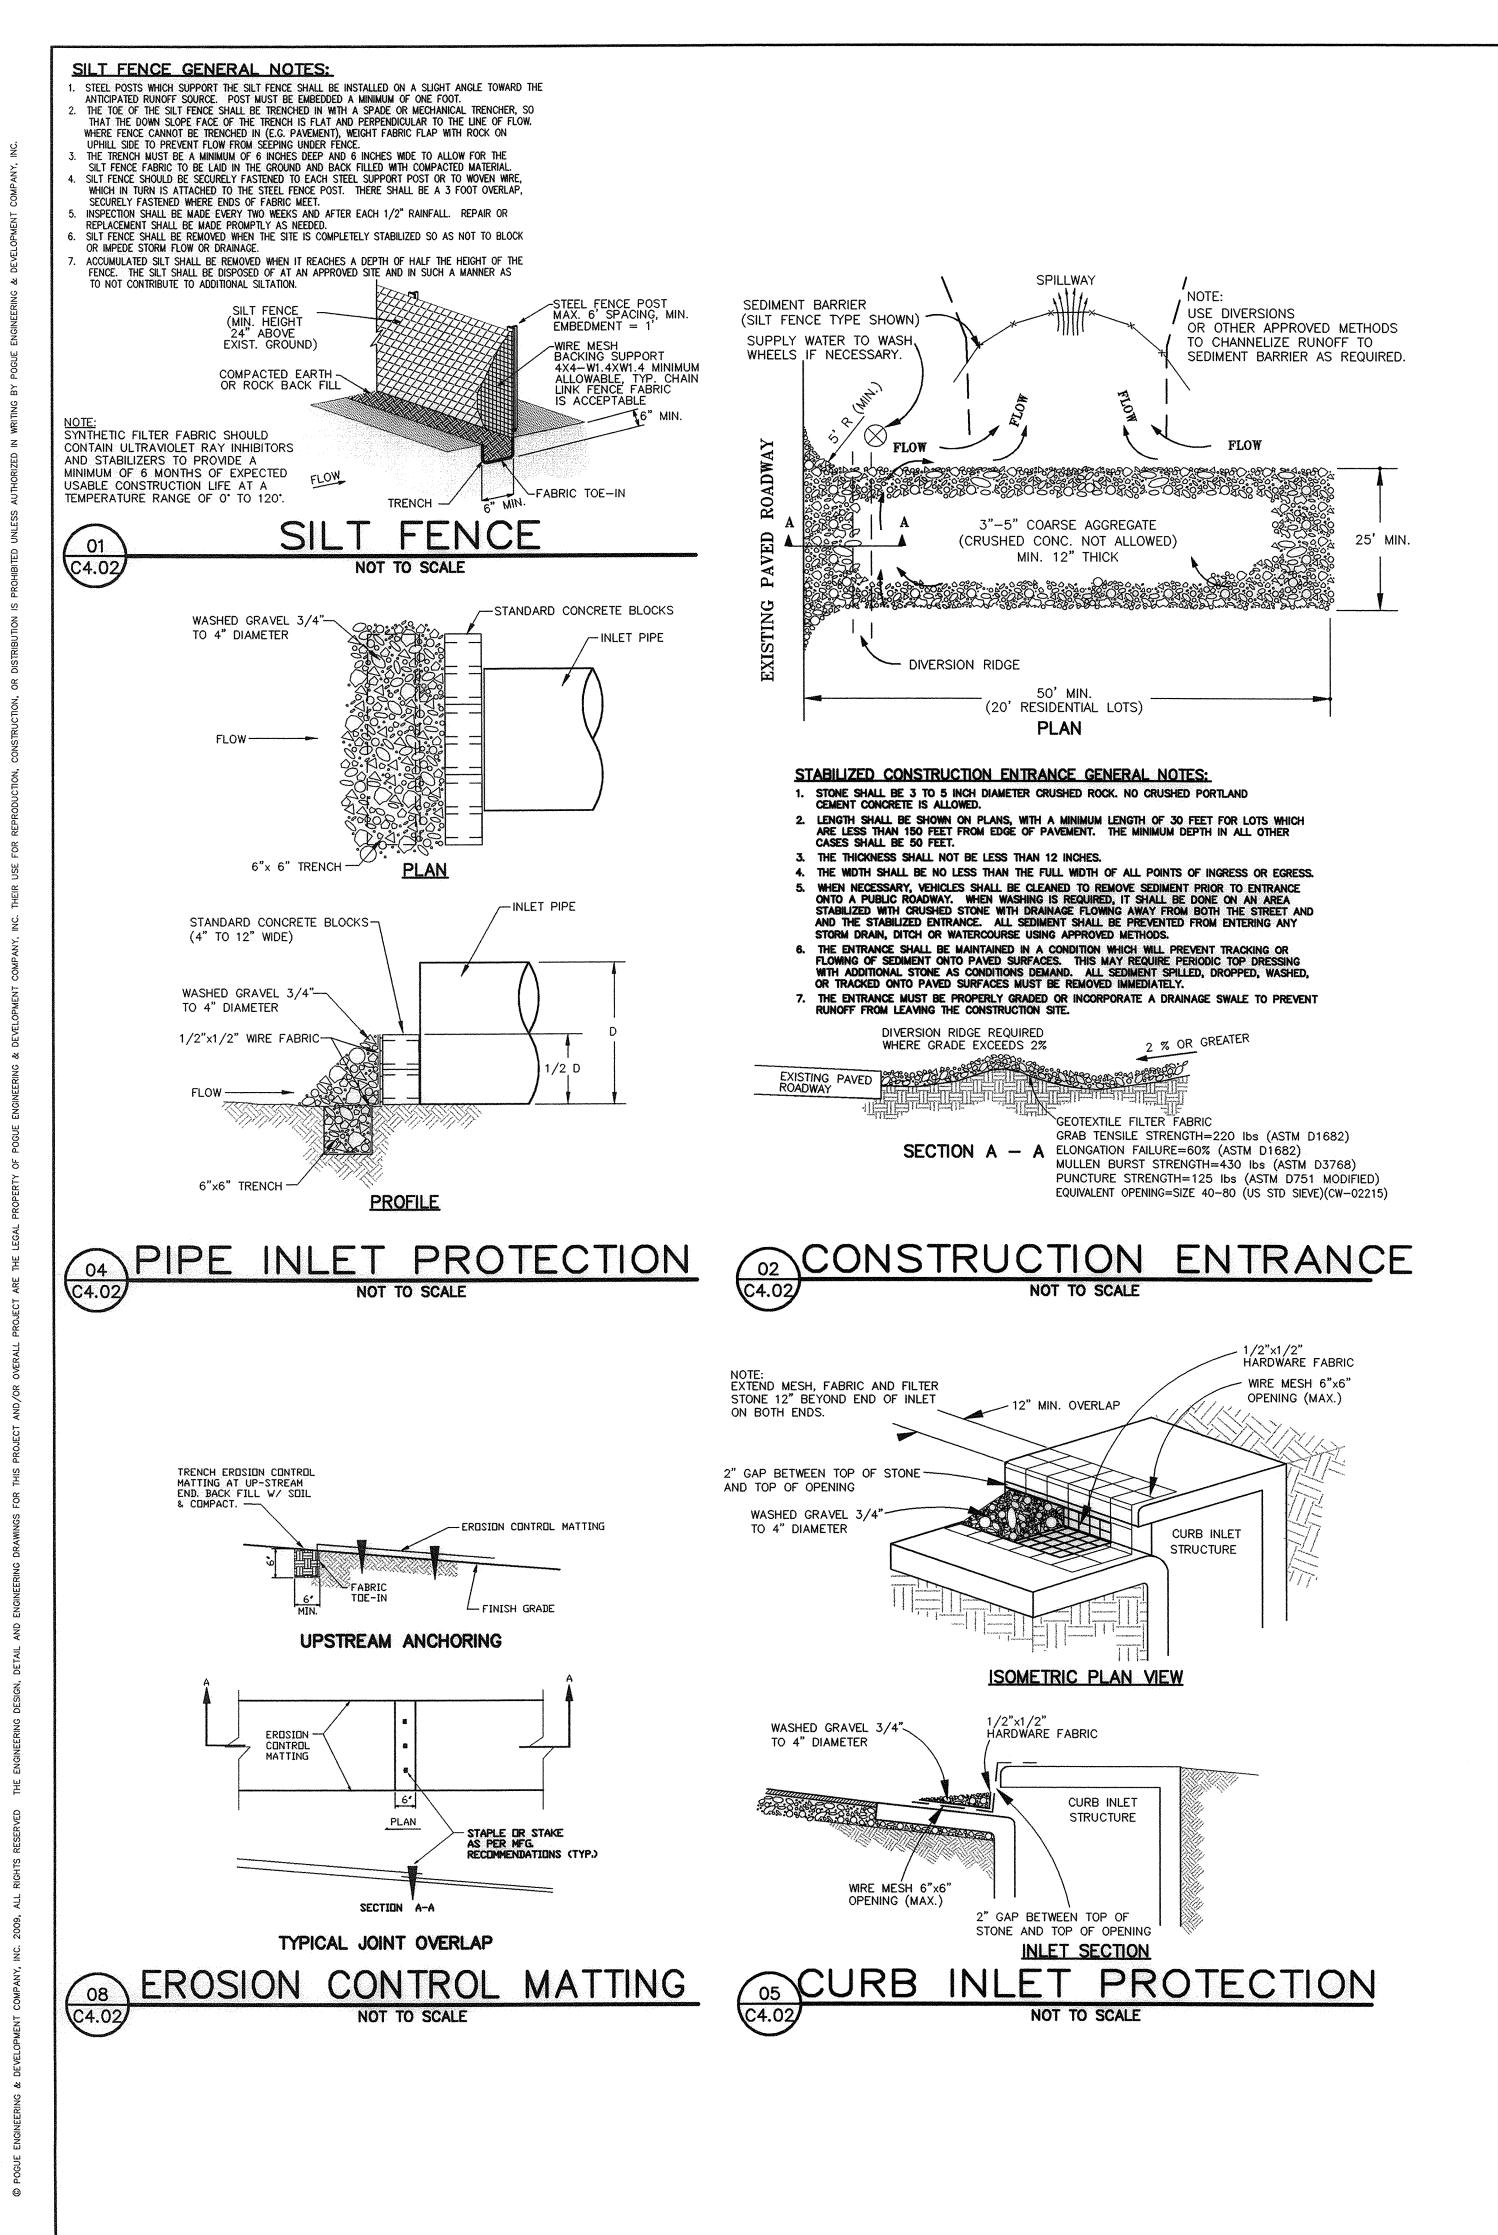

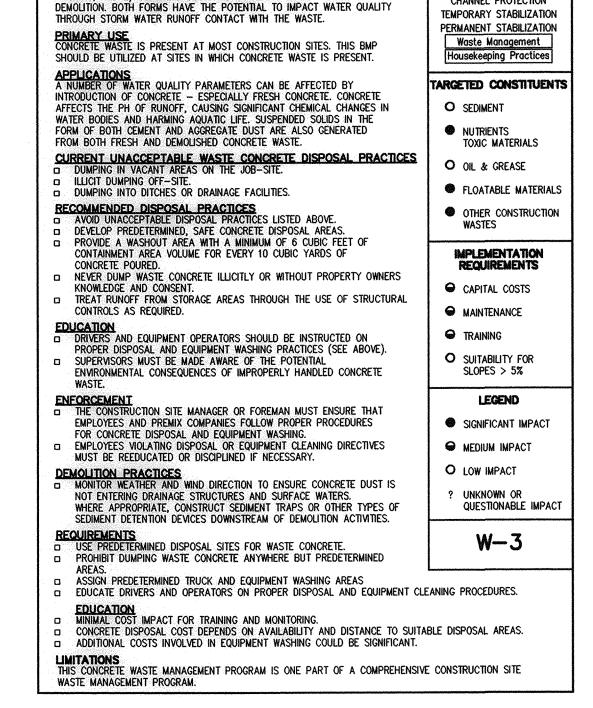

RANDALL P. POGUE, P.E. TX LIC. NO. 84780

POLLUTION CONTROL GENERAL NOTES:

1. THIS PLAN HAS BEEN PREPARED TO PROVIDE MEANS TO PREVENT OR MINIMIZE POLLUTION OF STORM WATER.

2. THIS PROJECT CONSISTS OF THE DEVELOPMENT OF 1 LOT ON A 0.73 ACRE TRACT FOR A COMMERCIAL USE.

3. THE CONSTRUCTION ACTIVITY INCLUDED IN THIS PLAN WILL INCLUDE: A. CLEARING AND GRUBBING STOCK PILING ROUGH GRADING UTILITY INSTALLATION/EXCAVATION OF TRENCHES

FINAL OR FINISH GRADING PAVEMENT INSTALLATION BUILDING CONSTRUCTION H. PREPARATION OF SEEDING OR PLANTING

4. BEST MANAGEMENT PRACTICES (STRUCTURAL PRACTICES) USED ON THIS PROJECT COULD INCLUDE: SILT FENCING, CONSTRUCTION ENTRANCE, INLET PROTECTION, OUTLET PROTECTION, SUBSURFACE DRAINS, CHECK DAMS, DRAINAGE SWALES, SEDIMENT TRAPS, EARTH DIKE, PIPE SLOPE DRAINS, EROSION CONTROL MATTING, DETENTION/RETENTION PONDS AND SEDIMENT BASINS.

5. THE TOTAL ESTIMATED SITE AREA IS 0.73 ACRES THE TOTAL ESTIMATED SITE AREA TO BE DISTURBED IS 0.73 ACRES THE TOTAL ESTIMATED SITE AREA NOT TO BE DISTURBED IS 0.00 ACRES

6. THE ESTIMATED RUNOFF COEFFICIENT PRIOR TO DEVELOPMENT OF THE PROJECT IS 0.35

7. THE ESTIMATED RUNOFF COEFFICIENT UPON COMPLETION OF THE PROJECT IS 0.90

8. THE SLOPES EXPECTED ON THE SITE UPON COMPLETION OF FINAL GRADING WILL RANGE BETWEEN 1% TO 30%

9. THE STORM WATER EXITING THE SITE IS COLLECTED IN AN EXISTING DRAINAGE SYSTEM MAINTAINED BY THE CITY OF ROCKWALL, TEXAS.

10. THE NAME OF THE RECEIVING WATER BODY IS LAKE RAY HUBBARD, LOCATED APPROXIMATELY 4,800 FEET FROM THE SUBJECT PROPERTY.

11. THE SOILS PRESENT AT THE SITE ARE GENERALLY EXPANSIVE CLAYS.

12. THE CONTRACTOR SHALL PROVIDE EROSION PROTECTION AROUND THE WORK AREA PERIMETER AND AT ALL INLET MOUTHS DURING CONSTRUCTION.

13. THE CONTRACTOR WILL REMOVE ALL EXCESS SOIL FROM CONSTRUCTION VEHICLES PRIOR TO EXITING THE SITE.

14. ALL DISTURBED AREAS WHICH WILL NOT BE RE-DISTURBED FOR A MINIMUM

OF 14 DAYS MUST BE STABILIZED BY THE CONTRACTOR TO CONTROL EROSION.

15. THE CONTRACTOR SHALL UNDERTAKE PROPER METHODS TO REDUCE DUST GENERATION FROM THE SITE.

16. THE CONTRACTOR MUST COMPLY WITH FEDERAL, STATE AND LOCAL REGULATIONS REGARDING SEDIMENT AND EROSION CONTROL.

17. A COPY OF THE STORM WATER POLLUTION PREVENTION PLAN ALONG WITH THE EPA (NPDES) PERMIT MUST BE POSTED AT THE CONSTRUCTION SITE THROUGHOUT THE CONSTRUCTION OF THE PROJECT. IF THE PERMIT HAS NOT BEEN ISSUED, A COPY OF NOTICE OF INTENT (NOI) SHALL BE POSTED

18. CONTRACTOR SHALL BE RESPONSIBLE FOR SUBMITTAL OF THE EPA'S REQUIREMENT OF A NOTICE OF INTENT (NOI) AND THE NOTICE OF TERMINATION (NOT) AND ANY ADDITIONAL REQUIREMENT PER THE EPA GUIDELINES FOR STORM WATER POLLUTION

19. ALL EROSION CONTROL DEVICES ARE TO BE INSTALLED IN ACCORDANCE WITH THE APPROVED PLANS AND SPECIFICATIONS FOR THIS PROJECT. CHANGES ARE TO BE APPROVED BEFORE CONSTRUCTION BY THE DESIGN ENGINEER AND THE CITY.

20. IF OFF-SITE SOIL BORROW OR SPOIL SITES ARE USED IN CONJUNCTION WITH THIS PROJECT. THE CONTRACTOR SHALL NOTIFY THE CITY INSPECTOR AND BE RESPONSIBLE FOR EROSION CONTROL REQUIREMENTS AS PER FEDERAL. STATE AND LOCAL REQUIREMENTS.

21. INSPECTIONS SHALL BE MADE WEEKLY AND AFTER RAIN STORM EVENTS TO INSURE THAT THE DEVICES ARE FUNCTIONING PROPERLY. WHEN SEDIMENT OR MUD HAS CLOGGED THE VOID SPACES BETWEEN STONES OR MUD IS BEING TRACKED ONTO A PUBLIC ROADWAY THE AGGREGATE PAD MUST BE WASHED DOWN OR REPLACED. RUNOFF FROM THE WASH DOWN OPERATION SHALL NOT BE ALLOWED TO DRAIN DIRECTLY OFF-SITE WITHOUT FIRST FLOWING THROUGH ANOTHER BEST MANAGEMENT PRACTICE (BMP) TO CONTROL OFF-SITE SEDIMENTATION. PERIODIC RE-GRADING OR THE ADDITION OF NEW STONE MAY BE REQUIRED TO MAINTAIN EFFICIENCY OF THE INSTALLATION.

22. MAINTENANCE AND INSPECTIONS PROCEDURES: CONTROL MEASURES SHALL B INSPECTED AT LEAST ONCE A WEEK OR WITHIN 24 HOURS OF ANY STORM EVENT OF 0.5 INCHES OR GREATER. IF REPAIR IS NECESSARY IT SHALL BE DONE AT THE EARLIEST PRACTICAL DATE BUT IN NO CASE GREATER THAN 48 HOURS.

23. FINAL STABILIZATION IS DEFINED AS A UNIFORM PERENNIAL VEGETATIVE COVER AT A MINIMUM OF 70% RESTORATION OF THE NATIVE OR NATURAL PREEXISTING BACKGROUND

24. SEDIMENTATION PONDS/TRAPS MUST BE CLEANED OUT WHEN SEDIMENTATION ACCUMULATES

TO A POINT OF 50% FULL (BY VOLUME).

25. CONTRACTOR SHALL SEED ALL DISTURBED AREAS IMMEDIATELY UPON COMPLETION OF

26. NO PUBLIC ACCEPTANCE UNTIL (FINAL STABILIZATION) VEGETATION IS ESTABLISHED ON ALL DISTURBED AREAS.

SEQUENCE OF EROSION CONTROL BEST MANAGEMENT PRACTICES:

1. INSTALL DOWN SLOPE AND SIDE SLOPE PERIMETER CONTROLS PRIOR TO THE LAND DISTURBING ACTIVITIES.

2. DO NOT DISTURB AN AREA UNTIL IT IS NECESSARY FOR CONSTRUCTION TO PROCEED. 3. COVER AND STABILIZE DISTURBED AREAS AS SOON AS POSSIBLE (WITHIN A MAXIMUM

4. TIME ACTIVITIES TO LIMIT IMPACT FROM SEASONAL CLIMATE CHANGES OR WEATHER EVENTS.

5. DELAY CONSTRUCTION OF INFILTRATION MEASURES UNTIL THE END OF THE CONSTRUCTION

PROJECT, WHEN UPSTREAM DRAINAGE AREAS HAVE BEEN STABILIZED.

6. DO NOT REMOVE TEMPORARY PERIMETER CONTROLS UNTIL AFTER ALL UPSTREAM AREAS

ALLOWABLE NON-STORM WATER DISCHARGES

OF 14 DAYS).

ARE FINAL STABILIZED.

DISCHARGES FROM FIRE FIGHTING ACTIVITIES.

FIRE HYDRANT FLUSHINGS. \*

WATER USED TO WASH VEHICLES OR CONTROL DUST.

POTABLE WATER SOURCES (INCLUDING WATERLINE FLUSHINGS CONTAINING LESS THAN 1000 GALLONS). \*

■ UNCONTAMINATED GROUND WATER (INCLUDING DEWATERING GROUNDWATER INFILTRATION).
■ FOUNDATION OR FOOTING DRAINS WHERE FLOWS ARE NOT CONTAMINATED WITH PROCESS MATERIALS SUCH AS SOLVENTS.

SPRINGS, RIPARIAN HABITATS, WETLANDS AND UNCONTAMINATED GROUNDWATER. IRRIGATION WATER. EXTERIOR BUILDING WASH DOWN WITHOUT DETERGENTS.

PAVEMENT WASH WATERS WHERE SPILLS OR LEAKS OF TOXIC OR HAZARDOUS MATERIALS

HAVE NOT OCCURRED (UNLESS ALL SPILL MATERIAL HAS BEEN REMOVED) AND WHERE DETERGENTS ARE NOT USED.

\* HEAVILY CHLORINATED WATER (3.5 MG/L OR GREATER FREE CHLORINE) RESULTING FROM WATER LINE STERILIZATION SHALL BE DIRECTED UNDER PERMIT TO THE SANITARY SEWER UNLESS OTHERWISE NOTED. THE CONTRACTOR SHALL APPLY TO THE ENGINEERING DEPARTMENT FOR A SANITARY SEWER DISCHARGE PERMIT AFTER THE MANDATORY CHLORINE RETENTION TIME (USUALLY 24 HOURS). THE HEAVILY CHLORINATED WATER MAY BE DISCHARGED TO THE SANITARY SEWER, BEGINNING TWO WORKING DAYS AFTER PERMIT APPLICATION.

#### SPILLS AND RELEASES: (OF REPORTABLE QUANTITIES) THE FOLLOWING STEPS SHALL BE TAKEN

1. NOTIFY THE NATIONAL RESPONSE CENTER (800) 424-8802 OR (202) 426-2675 AS SOON AS YOU HAVE KNOWLEDGE OF THE SPILL.

2. THE SWPPP MUST BE MODIFIED WITHIN 14 DAYS TO PROVIDE A DESCRIPTION OF THE RELEASE, THE CIRCUMSTANCES LEADING TO THE RELEASE AND THE DATE OF THE RELEASE.

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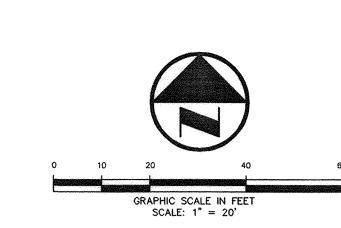
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08-05-09 ROJECT No.: 1393-09-024 393-09-024-07A HECKED BY

**EROSION** CONTROL **DETAILS** (SWPPP)

SHEET No.

PI NO: 1393-09-024



#### LEGEND

POWER POLE LIGHT STANDARD WATER METER WATER VALVE IRRIGATION CONTROL VALVE FIRE HYDRANT FIRE DEPARTMENT CONNECTION CLEAN OUT MH (O) MANHOLE GAS METER TRAFFIC SIGNAL CONTROL TRAFFIC SIGNAL POLE

BOLLARD

ELECTRIC METER

TRAFFIC SIGN TELEPHONE BOX TV BOX

FLAG POLE LANDSCAPE AREA PROPERTY LINE O.H. POWER LINES

TEL U/G TELEPHONE LINES WATER U/G WATER LINE GAS LINE 

XXX.XX EXISTING SPOT GRADES  $-\langle XX \rangle$ PROPOSED CONTOURS (BY OTHERS)

PROPOSED SPOT GRADES (BY OTHERS) CONTROLLING MONUMENT 5/8-INCH IRON ROD WITH

"POGUE ENG & DEV" CAP SET PROPOSED CONTOURS PROPOSED SPOT GRADES

PROPOSED EROSION CONTROL PROPOSED DRAINAGE DIVIDES

FOR ALL STORM SEWER DETAILS, SEE CITY OF ROCKWALL/STANDARDS & NCTCOG 3rd ADDITION.

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RANDALL P. POGUE, P.E. TX LIC. NO. 84780

PI NO: 1393-09-024

DWG NO: 1393-09-024-07A.DWG

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UNDERGROUND UTILITIES ARE LOCATED IN

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FM 552. ELEVATION = 543.09

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BENCHMARK #1
SQUARE CUT SET AT SOUTHWESTCORNER OF WATER VAULT LOCATEDED AT
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SHEET TITLE

08-05-09

1393-09-024-07A

PROJECT No.: 1393-09-024

DWG. FILE: DRAWN BY: CHECKED BY:

STORM SEWER PLAN


**Mana** ≻

1512 BRA SUITE 100 MCKINNEY

Randalls

SHEET No.

(CAB. H, SLIDES 15-18)

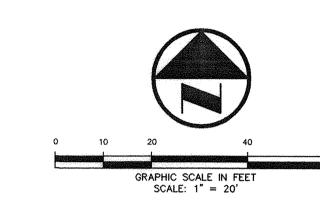

#### LEGEND

ELECTRIC METER POWER POLE LIGHT STANDARD WATER METER WATER VALVE IRRIGATION CONTROL VALVE FIRE HYDRANT FIRE DEPARTMENT CONNECTION CLEAN OUT MH O MANHOLE GM⊗ GAS METER TRAFFIC SIGNAL CONTROL TRAFFIC SIGNAL POLE TRAFFIC SIGN TELEPHONE BOX TV BOX FLAG POLE

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EXISTING CONTOURS EXISTING SPOT GRADES XXX) PROPOSED CONTOURS (BY OTHERS)

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LANDSCAPE AREA

"POGUE ENG & DEV" CAP SET PROPOSED CONTOURS

PROPOSED SPOT GRADES PROPOSED EROSION CONTROL PROPOSED DRAINAGE DIVIDES

PROVIDE CONDUIT AND POWER TO SITE LIGHTING AS REQUIRED. COORDINATE WITH

MEP/ARCH AND LOCAL FRANCHISE UTILITY

COMPANY AS REQUIRED.

PROVIDE CONDUIT AND POWER TO SIGN AS REQUIRED. COORDINATE WITH MEP/ARCH AND LOCAL FRANCHISE UTILITY COMPANY AS REQUIRED.

PROPOSED TELEPHONE SERVICE LINE. COORDINATE WITH LOCAL FRANCHISE UTILITY COMPANY FOR SERVICE AS REQUIRED.

PROPOSED GAS SERVICE LINE. COORDINATE WITH LOCAL FRANCHISE UTILITY COMPANY FOR SERVICE AS REQUIRED.

FOR ALL WATER & SANITARY SEWER

ROCKWALL/STANDARDS & NCTCOG

DETAILS, SEE CITY OF

3rd ADDITION.

PROPOSED ELECTRIC
SERVICE LINE.
COORDINATE WITH LOCAL RANCHISE UTILITY COMPANY FOR SERVICE AS REQUIRED.



PROVIDE CONDUIT AS REQUIRED FOR PHONE, ELECTRICAL, GAS, IRRIGATION & LIGHTING. COORDINATE WITH LANDSCAPE, MEP & FRANCHISE UTILITY COMPANIES FOR LOCATIONS NUMBER & SIZES OF CONDUITS AND SERVICES.

THE SERVICE WOULD REQUIRE THAT THE DEVELOPER PROVIDE THE STANDARD 2-4" PVC CONDUITS WITH PULL STRINGS FROM THE TELEPHONE EQUIPMENT TO THE RIGHT-OF-WAY OR UTILITY EASEMENT UNDER AREAS OF THE PAVEMENT. PVC CONDUITS NEED TO BE EXPOSED OR TURNED UP AT THE RIGHT-OF-WAY OR UTILITY EASEMENT. ALL 90° BENDS IN THE CONDUITS SHOULD BE LONG RADIUS. A BACKBOARD IN THE BUILDING SHALL CONSIST OF STANDARD 4'x8'x3/4"
SHEET OF PLYWOOD MOUNTED AT THE TERMINATION POINT.
ALSO, AN ELECTRICAL OUTLET AND #6 SOLID INSULATED GROUND WIRE FROM THE GROUND BAR OF THE POWER PANEL TO PLYWOOD BACKBOARD WITH A 6' COIL OF WIRE LEFT AT THE BACKBOARD WILL BE REQUIRED AT THE BUILDING.

BRANDON E. COX

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**RECORD DRAWINGS:** IT WAS THE INTENT THAT THE IMPROVEMENTS SHOWN BE CONSTRUCTED ACCORDING TO

TX LIC. NO. 84780

(CAB. H, SLIDES 15-18)

PROPOSED FIRE HYDRANT

(BY OTHERS)

THESE PLANS AS APPROVED BY THE CITY. THE LINES AND GRADES WERE SET ON THE GROUND FOR CONSTRUCTION ACCORDING TO SAID PLANS. THE CITY INSPECTED THE CONSTRUCTION. THE ENGINEER DID NOT VERIFY LINES OR GRADES AFTER CONSTRUCTION. WE ARE NOT AWARE OF ANY CHANGES OR REVISIONS TO THESE PLANS DURING CONSTRUCTION OTHER THAN THOSE SHOWN. RANDALL P. POGUE, P.E. DATE: <u>APRIL 30, 2010</u>  $\triangle$ 

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, 101037

PI NO: 1393-09-024

08-05-09 1393-09-024-07A

PROJECT No.: 1393-09-024 DWG. FILE: DRAWN BY: CHECKED BY:

3

<u>^</u>

SHEET TITLE WATER & SANITARY SEWER PLAN

SHEET No.

DWG NO: 1393-09-024-07A.DWG

2. UNLESS OTHERWISE NOTED, ALL CONCRETE SHALL BE TYPE IA. CLASS 'A'. 3000 PSI STRENGTH AT 28 DAYS. CONCRETE FOR INLET AND DRAINAGE STRUCTURES SHALL BE TYPE I, CLASS 'F', 4200 PSI STRENGTH AT 28 DAYS. FIRE LANES AND APPROACHES SHALL BE TYPE 1A, CLASS 'C', 3600 PSI STRENGTH AT 28 DAYS. 6 SACK MINIMUM FOR MACHINE PLACED AND 6-1/2 SACK MINIMUM FOR HAND PLACED. NO SAND UNDER PAVEMENT.

3. THE HORIZONTAL AND VERTICAL LOCATIONS OF EXISTING SUBSURFACE UTILITIES HAVE BEEN DETERMINED FROM DATA RECORDED BY OTHERS. THE CONTRACTOR SHALL VERIFY THAT ALL NECESSARY CROSSING CLEARANCES BETWEEN EXISTING AND PROPOSED UTILITIES EXIST PRIOR TO CONSTRUCTION OF ANY SUCH CROSSING. IT IS THE RESPONSIBILITY OF THE CONTRACTOR TO VERIFY SIZE AND LOCATION OF ALL UTILITIES PRIOR TO CONSTRUCTION. IT WILL BE THE RESPONSIBILITY OF THE CONTRACTOR TO PROTECT ALL PUBLIC UTILITIES IN THE CONSTRUCTION OF THIS PROJECT.

4. IT WILL BE THE RESPONSIBILITY OF THE CONTRACTOR TO PROTECT ALL MANHOLES, CLEAN OUTS, VALVE BOXES, FIRE HYDRANTS, ETC. THEY MUST BE ADJUSTED TO THE PROPER LINE AND GRADE BY THE CONTRACTOR PRIOR TO AND AFTER THE PLACING OF PERMANENT PAVING AND GRADING. UTILITIES MUST BE MAINTAINED TO PROPER LINE AND GRADE THROUGHOUT THE CONSTRUCTION OF THIS PROJECT.

5. CONTRACTOR SHALL MAINTAIN ONE SET OF "RECORD DRAWINGS" ON SITE WHICH WILL BE SUBMITTED TO THE OWNER OR ENGINEER UPON COMPLETION OF THE PROJECT. RECORD DRAWINGS SHALL INDICATE THE LOCATION OF ALL SUBTERRANEAN UTILITY IMPROVEMENTS AND/OR RELOCATIONS. THEY SHALL ALSO INCLUDE DIMENSIONAL TIES TO ALL MANHOLES, CULVERTS, INLETS, JUNCTION BOXES, FIRE HYDRANTS, ETC.

6. CONTRACTOR SHALL BE RESPONSIBLE FOR MAINTAINING AND BEING IN COMPLIANCE WITH ALL FEDERAL (O.S.H.A. STANDARDS AND REGULATIONS), STATE AND LOCAL REGULATIONS REGARDING TRENCH SAFETY.

7. BARRICADING AND PROJECT SIGNS SHALL CONFORM TO "STATE DEPARTMENT OF HIGHWAYS AND PUBLIC TRANSPORTATION BARRICADING AND CONSTRUCTION STANDARDS" ON TXDOT ROADWAYS AND "TEXAS MANUAL ON UNIFORM TRAFFIC CONTROL DEVICES, PART VI" FOR PRIVATE WORK. BARRICADES AND PROJECT SIGNS SHALL ALSO MEET CITY CODE.

8. UNLESS OTHERWISE NOTED, THE STORM DRAIN LINES MAY BE OF THE

A. CLASS III, RCP C-76 (CIRCULAR) INSTALLED IN ACCORDANCE WITH THE MANUFACTURER'S SPECIFICATIONS.

9. STORM SEWER JOINT MATERIALS MAY BE OF THE FOLLOWING: A. RAM-NECK

CON-SEAL CEMENT GROUT

INSTALLED IN ACCORDANCE WITH THE MANUFACTURER'S SPECIFICATIONS.

10. STORM SEWER CONNECTIONS FOR NEW INTERCEPTING MAINS SHALL BE FACTORY WYES FOR 48" AND SMALLER PIPE.

11. ALL HEADWALLS SHALL BE POURED IN PLACE.

12. GRADING OF ALL HANDICAPPED SPACES AND ROUTES SHALL CONFORM TO STATE, LOCAL AND FEDERAL REGULATIONS. THE MAXIMUM CROSS FALL SHALL BE 2% (1' IN 50') AND THE MAXIMUM SLOPE FOR INGRESS/EGRESS ALONG THE ROUTE SHALL BE 5% (1' IN 20'). AND A 2% MAXIMUM SLOPE IN ANY DIRECTION MUST BE MAINTAINED WITHIN THE FIRST 5' FROM ANY ENTRY OR EXIT OF A BUILDING OR LANDING AREA.

13. FINAL PAVING, CURB AND SIDEWALK ELEVATIONS SHALL BE PLACED AT THE PROPOSED GRADE ELEVATIONS WITHIN PLUS OR MINUS 0.05 FEET.

14. ANY CONCRETE, ROCK, DEBRIS OR MATERIAL DEEMED UNSUITABLE FOR SUB-GRADE BY THE ENGINEER SHALL BE DISPOSED OF OFF SITE AND OUT OF THE CITY LIMITS AT THE CONTRACTOR'S EXPENSE.

15. TRENCH BACK FILL MATERIAL SHALL CONFORM TO THE REQUIREMENTS OF NCTCOG ITEM 6.2.10 AND SHALL BE MECHANICALLY COMPACTED IN ACCORDANCE WITH NCTCOG ITEM 6.2.9 TO A MINIMUM OF 95 PERCENT STANDARD PROCTOR DENSITY UNLESS OTHERWISE SHOWN ON THESE PLANS OR STATED IN THE CITY STANDARD SPECIFICATIONS OR IN THE GEOTECHNICAL REPORT. SEE CITY OF ROCKWALL STANDARDS OF DESIGN & CONSTRUCTION DATED AUGUST 2003, FOR ADDENDUMS.

16. EMBEDMENT FOR PIPES SHALL CONFORM TO THE REQUIREMENTS OF NCTCOG ITEM 6.2.9 UNLESS OTHERWISE SHOWN ON THESE PLANS OR NOTED IN THE STANDARD CITY SPECIFICATIONS. CRUSHED STONE BEDDING OR APPROVED EQUAL SHALL BE PROVIDED BY THE CONTRACTOR WHEN ROCK IS ENCOUNTERED IN TRENCHES. THERE SHALL BE NO ADDITIONAL PAY ITEM OF THE CRUSHED STONE BEDDING. IF ROCK IS ENCOUNTERED, ROCK SPOIL SHALL NOT BE USED IN THE UPPER 1.5 FEET OF THE TRENCH. THE UPPER 1.5 FEET OF TRENCH SHALL BE BACK FILLED WITH QUALITY TOPSOIL. SEE CITY OF ROCKWALL STANDARDS OF DESIGN & CONSTRUCTION DATED AUGUST 2003, FOR ADDENDUMS.

17. IF REQUIRED BY CONSTRUCTION, POWER POLES TO BE BRACED AND/OR RELOCATED AT THE CONTRACTOR'S EXPENSE.

18. REFER TO THE GEOTECHNICAL REPORT FOR REQUIREMENTS REGARDING FILL COMPACTION AND RELATED MOISTURE CONTENT.

19. DRAINAGE SHALL BE MAINTAINED AWAY FROM ALL FOUNDATIONS, BOTH DURING AND AFTER CONSTRUCTION.

20. TREES SHALL REMAIN AND BE PROTECTED UNLESS SPECIFIED OTHERWISE ON THE LANDSCAPE PLAN OR APPROVED BY THE OWNER AND THE CITY.

21. REFER TO THE ARCHITECTURAL AND M.E.P. PLANS FOR COORDINATION OF ALL UTILITY CONNECTIONS (ROOF DRAIN COLLECTION, WATER, SEWER, ETC.).

22. REFER TO THE PAVING AND DRAINAGE PLANS FOR ADDITIONAL INFORMATION RELATED TO SAID CONSTRUCTION.

23. PRIOR TO THE COMMENCEMENT OF ANY CONSTRUCTION ACTIVITIES, THE CONTRACTOR SHALL SUBMIT BOND AND THREE WAY CONTRACTS TO THE CITY AND OWNER AS REQUIRED.

24. ALL FILL SHALL BE COMPACTED WITH A SHEEPS FOOT ROLLER.

WATER AND SANITARY SEWER GENERAL NOTES:

1. ALL WORK UNLESS OTHERWISE NOTED, SHALL CONFORM TO THE STANDARD SPECIFICATIONS FOR PUBLIC WORKS CONSTRUCTION, AS ISSUED BY THE NORTH CENTRAL TEXAS COUNCIL OF GOVERNMENTS, AND THE CITY OF ROCKWALL STANDARD CONSTRUCTION SPECIFICATIONS. COPIES OF NCTCOG SPECIFICATIONS 3rd VERSION CAN BE OBTAINED BY CONTACTING NCTCOG @ (817) 640-3300

2. UNLESS OTHERWISE NOTED, ALL CONCRETE SHALL BE TYPE IA. CLASS 'A'. 3000 PSI STRENGTH AT 28 DAYS. CONCRETE FOR INLET AND DRAINAGE STRUCTURES SHALL BE TYPE I, CLASS 'F', 4200 PSI STRENGTH AT 28 DAYS.

3. THE HORIZONTAL AND VERTICAL LOCATIONS OF EXISTING SUBSURFACE UTILITIES HAVE BEEN DETERMINED FROM DATA RECORDED BY OTHERS. THE CONTRACTOR SHALL VERIFY THAT ALL NECESSARY CROSSING CLEARANCES BETWEEN EXISTING AND PROPOSED UTILITIES EXIST PRIOR TO CONSTRUCTION OF ANY SUCH CROSSING. IT IS THE RESPONSIBILITY OF THE CONTRACTOR TO VERIFY SIZE AND LOCATION OF ALL UTILITIES PRIOR TO CONSTRUCTION. IT WILL BE THE RESPONSIBILITY OF THE CONTRACTOR TO PROTECT ALL PUBLIC UTILITIES IN THE CONSTRUCTION OF THIS PROJECT.

4. IT WILL BE THE RESPONSIBILITY OF THE CONTRACTOR TO PROTECT ALL MANHOLES, CLEAN OUTS, VALVE BOXES, FIRE HYDRANTS, ETC. THEY MUST BE ADJUSTED TO THE PROPER LINE AND GRADE BY THE CONTRACTOR PRIOR TO AND AFTER THE PLACING OF PERMANENT PAVING AND GRADING. UTILITIES MUST BE MAINTAINED TO PROPER LINE AND GRADE THROUGHOUT THE CONSTRUCTION OF THIS PROJECT.

5. CONTRACTOR SHALL MAINTAIN ONE SET OF "RECORD DRAWINGS" ON SITE WHICH WILL BE SUBMITTED TO THE OWNER OR ENGINEER UPON COMPLETION OF THE PROJECT. RECORD DRAWINGS SHALL INDICATE THE LOCATION OF ALL SUBTERRANEAN UTILITY IMPROVEMENTS AND/OR RELOCATIONS. THEY SHALL ALSO INCLUDE DIMENSIONAL TIES TO ALL MANHOLES, CULVERTS, INLETS, JUNCTION BOXES, FIRE HYDRANTS, ETC.

6. CONTRACTOR SHALL BE RESPONSIBLE FOR MAINTAINING AND BEING IN COMPLIANCE WITH ALL FEDERAL (O.S.H.A. STANDARDS AND REGULATIONS). STATE AND LOCAL REGULATIONS REGARDING TRENCH SAFETY.

7. BARRICADING AND PROJECT SIGNS SHALL CONFORM TO "STATE DEPARTMENT OF HIGHWAYS AND PUBLIC TRANSPORTATION BARRICADING AND CONSTRUCTION STANDARDS" ON TXDOT ROADWAYS AND "TEXAS MANUAL ON UNIFORM TRAFFIC CONTROL DEVICES. PART VI" FOR PRIVATE WORK. BARRICADES AND PROJECT SIGNS SHALL ALSO MEET CITY CODE.

8. ALL WATER MAINS 12" IN DIAMETER OR LESS SHALL BE PVC C-900, DR 14, CLASS 200.

9. ALL WATER MAINS UNLESS OTHERWISE NOTED SHALL HAVE A MINIMUM COVER OF 48 INCHES (4" THRU 8"); 60 INCHES (10" THRU 12"); 72 INCHES (14 INCHES AND LARGER) TO THE TOP OF PIPE BELOW FINISHED GRADES.

10. ALL WATER SERVICES TO BE INSTALLED IN ACCORDANCE TO CITY REQUIREMENTS.

11. ALL SANITARY SEWER PIPE TO BE PVC SDR-35, UNLESS OTHERWISE NOTED.

12. CONTRACTOR TO TEST WATER AND SANITARY SEWER LINES IN ACCORDANCE WITH THE STANDARD CITY SPECIFICATIONS.

13. ALL METER BOXES TO BE LOCATED IN NON-TRAFFIC AREAS.

14. FIRE SPRINKLER LINE TO BE SIZED AND INSTALLED BY A STATE LICENSED FIRE SPRINKLER CONTRACTOR.

15. FIRE HYDRANTS SHALL BE PLACED 3 FEET FROM THE BACK OF CURB LOCATED AS SHOWN ON THE PLANS. THE FIRE HYDRANT SHALL BE CITY APPROVED AND PAINTED TO BE COLOR CODED PER CITY REQUIREMENTS. FIRE HYDRANTS TO HAVE 5 FOOT CLEARANCE AROUND. (INCLUDES PARKING SPACES)

16. ALL UTILITIES INSTALLED OUTSIDE OF AN EASEMENT SHALL BE INSTALLED BY A LICENSED PLUMBER AND INSPECTED BY THE CITY CODE ENFORCEMENT.

17. ALL DUCTILE IRON FITTINGS SHALL BE OF THE MECHANICAL JOINT TYPE OR SLIP JOINT AND SHALL BE CLASS D. OR CLASS 250 ON SIZES 12 INCHES AND SMALLER IN ACCORDANCE WITH A.W.W.A. SPECIFICATIONS C-110-64 AND C-111-64.

18. CONCRETE BLOCKING SHALL BE PROVIDED ON WATER MAINS AT ALL TEES. BENDS AND FIRE HYDRANTS PER STANDARD CITY SPECIFICATIONS. PAYMENT FOR CONCRETE BLOCKING SHALL BE SUBSIDIARY TO PIPE INSTALLATION AND SHALL BE INCLUDED IN THE BID PRICE THEREOF.

19. ANY CONCRETE, ROCK, DEBRIS OR MATERIAL DEEMED UNSUITABLE FOR SUB-GRADE BY THE ENGINEER SHALL BE DISPOSED OF OFF SITE AT THE CONTRACTOR'S EXPENSE.

20. TRENCH BACK FILL MATERIAL SHALL CONFORM TO THE REQUIREMENTS OF NCTCOG ITEM 6.2.10 AND SHALL BE MECHANICALLY COMPACTED IN ACCORDANCE WITH NCTCOG ITEM 6.2.9 TO A MINIMUM OF 95 PERCENT STANDARD PROCTOR DENSITY UNLESS OTHERWISE SHOWN ON THESE PLANS OR STATED IN THE CITY STANDARD SPECIFICATIONS OR IN THE GEOTECHNICAL REPORT.

21. EMBEDMENT FOR PIPES SHALL CONFORM TO THE REQUIREMENTS OF VERSION 3 NCTCOG ITEM 6.2.9 UNLESS OTHERWISE SHOWN ON THESE PLANS OR NOTED IN THE STANDARD CITY SPECIFICATIONS. CRUSHED STONE BEDDING OR APPROVED EQUAL SHALL BE PROVIDED BY THE CONTRACTOR WHEN ROCK IS ENCOUNTERED IN TRENCHES. THERE SHALL BE NO ADDITIONAL PAY ITEM OF THE CRUSHED STONE BEDDING. IF ROCK IS ENCOUNTERED. ROCK SPOIL SHALL NOT BE USED IN THE UPPER 1.5 FEET OF THE TRENCH. THE UPPER 1.5 FEET OF TRENCH SHALL BE BACK FILLED WITH QUALITY TOPSOIL.

22. CLASS "B" EMBEDMENT SHALL BE USED FOR RCP PIPE.

23. CLASS "B-3" EMBEDMENT SHALL BE USED FOR PVC PIPE FOR WATER.

24. ROCK EMBEDMENT SHALL BE USED FOR PVC SEWER PIPE.

25. NOT USED

26. NOT USED

27. IF REQUIRED BY CONSTRUCTION, POWER POLES TO BE BRACED AND/OR RELOCATED AT THE CONTRACTOR'S EXPENSE.

WATER AND SANITARY SEWER GENERAL NOTES CONT .:

28. REFER TO THE GEOTECHNICAL REPORT FOR REQUIREMENTS REGARDING FILL COMPACTION AND RELATED MOISTURE CONTENT.

29. TREES SHALL REMAIN AND BE PROTECTED UNLESS SPECIFIED OTHERWISE ON THE LANDSCAPE PLAN OR APPROVED BY THE OWNER AND THE CITY.

30. REFER TO THE ARCHITECTURAL AND M.E.P. PLANS FOR COORDINATION OF ALL UTILITY CONNECTIONS (ROOF DRAIN COLLECTION, WATER, SEWER, ETC.).

31. CONTRACTOR TO VERIFY ALL EXISTING UTILITIES FLOW LINES PRIOR TO BEGINNING CONSTRUCTION.

32. CONTRACTOR SHALL TIE A 1" WIDE PIECE OF RED PLASTIC FLAGGING TO THE END OF SEWER SERVICE AND SHALL LEAVE A MINIMUM OF 36" OF FLAGGING EXPOSED AFTER BACK FILL. AFTER CURB AND PAVING IS COMPLETE. CONTRACTOR SHALL MARK THE LOCATION OF THE SEWER SERVICE ON THE CURB OR PAVING WITH A RED LETTER 'S' IN ACCORDANCE WITH STANDARD CITY SPECIFICATIONS.

33. THE CONTRACTOR TO INSTALL THE WATER SERVICES TO A POINT 2 FEET FROM BACK OF THE CURB LINE AT A DEPTH OF 12 INCHES. THE METER BOX SHALL BE FURNISHED AND INSTALLED BY THE CONTRACTOR AFTER THE PAVING HAS BEEN COMPLETED AND THE FINE GRADING BEHIND THE CURB AND PAVING AREAS. EACH SERVICE LOCATION SHALL BE MARKED ON THE CURB OR PAVING WITH A BLUE LETTER "W" IN ACCORDANCE WITH STANDARD CITY SPECIFICATIONS AND TIED TO PROPERTY CORNERS ON THE "RECORD DRAWINGS"

34. VALVE BOXES SHALL BE FURNISHED AND SET ON EACH GATE VALVE. AFTER FINAL GRADING AND ALIGNMENT HAS BEEN COMPLETED, THE CONTRACTOR SHALL POUR A CONCRETE PAD BLOCK (24"X24"X6") AROUND ALL VALVES AS TO PROVIDE THE FINISHED GRADE OF THE PAD TO BE EQUAL TO THE FINISHED GRADES ADJACENT TO THE VALVES.

35. WHEN WATER AND SANITARY SEWER MAINS ARE INSTALLED, THEY SHALL BE INSTALLED NO CLOSER THAN NINE (9) FEET TO EACH OTHER IN ALL DIRECTIONS AS MEASURED FROM THE OUTSIDE OF THE PIPES. PARALLEL LINES SHALL BE INSTALLED IN SEPARATE TRENCHES. WHERE THE NINE FOOT SEPARATION DISTANCE CANNOT BE ACHIEVED OR MAINTAINED. THE FOLLOWING GUIDELINES SHALL APPLY:

A. WHERE A SANITARY SEWER PARALLELS A WATER LINE, THE SEWER SHALL BE CONSTRUCTED OF CAST IRON, DUCTILE IRON OR PVC PIPE MEETING ASTM SPECIFICATIONS WITH A PRESSURE RATING FOR BOTH THE PIPE AND JOINTS OF 150 PSI. THE VERTICAL SEPARATION SHALL BE A MINIMUM OF 2 FEET BETWEEN OUTSIDE DIAMETERS AND THE HORI-ZONTAL SEPARATION SHALL BE A MINIMUM OF FOUR FEET BETWEEN OUTSIDE DIAMETERS. THE SEWER SHALL BE LOCATED BELOW THE WATER. B. WHERE A SANITARY SEWER CROSSES A WATERLINE AND THE SEWER IS CONSTRUCTED OF CAST IRON, DUCTILE IRON OR PVC WITH A MINIMUM PRESSURE RATING OF 150 PSI, AN ABSOLUTE MINIMUM DISTANCE OF SIX INCHES BETWEEN OUTSIDE DIAMETERS SHALL BE MAINTAINED. IN ADDITION, THE SEWER SHALL BE LOCATED BELOW THE WATERLINE WHERE POSSIBLE AND ONE LENGTH OF SEWER PIPE MUST BE CENTERED ON THE WATERLINE. C. WHERE A SANITARY SEWER CROSSES UNDER A WATERLINE AND THE SEWER IS CONSTRUCTED OF ABS TRUSS PIPE, SIMILAR SEMI-RIGID PLASTIC COMPOSITE PIPE. CLAY PIPE OR CONCRETE PIPE WITH GASKETED JOINTS, A MINIMUM OF TWO FOOT SEPARATION DISTANCE SHALL BE MAINTAINED. IN ADDITION. THE SEWER SHALL BE LOCATED BELOW THE WATERLINE WHERE POSSIBLE AND ONE LENGTH OF THE SEWER PIPE MUST BE CENTERED ON THE WATERLINE.

D. WHERE A SEWER CROSSES OVER A WATERLINE ALL PORTIONS OF THE SEWER WITHIN NINE FEET OF THE WATERLINE SHALL BE CONSTRUCTED OF CAST IRON, DUCTILE IRON OR PVC PIPE WITH A PRESSURE RATING OF AT LEAST 150 PSI USING APPROPRIATE ADAPTERS. IN LIEU OF THIS PROCEDURE THE NEW CONVEYANCE MAY BE ENCASED IN A JOINT OF 150 PSI PRESSURE CLASS PIPE AT LEAST 18 FEET LONG AND TWO NOMINAL SIZES LARGER THAN THE NEW CONVEYANCE. THE SPACE AROUND THE CARRIER PIPE SHALL BE SUPPORTED AT FIVE FEET INTERVALS WITH SPACERS OR BE FILLED TO THE SPRING LINE WITH WASHED SAND. THE ENCASEMENT PIPE SHOULD BE CENTERED ON THE CROSSING AND BOTH ENDS SEALED WITH CEMENT GROUT OR MANUFACTURED SEAL.

E. THE SEWER NEED NOT BE DISTURBED WHERE A NEW WATERLINE IS TO BE INSTALLED PARALLEL TO AN EXISTING SEWER THAT SHOWS NO EVIDENCE OF LEAKAGE AND THE WATERLINE IS INSTALLED ABOVE THE SEWER A MIN-IMUM OF TWO FEET VERTICALLY AND FOUR FEET HORIZONTALLY. SHOULD EXCAVATION FOR THE WATERLINE PRODUCE EVIDENCE THAT THE SEWER IS LEAKING. THE SEWER MUST BE REPAIRED OR REPLACED AS DESCRIBED IN SUBPARAGRAPHS (A) OR (D) OF THIS PARAGRAPH.

F. THE SEWER NEED NOT BE DISTURBED WHERE A NEW WATERLINE IS TO CROSS OVER (BY TWO FEET OR MORE) EXISTING SEWER SHOWING NO EVIDENCE OF LEAKAGE. SHOULD EXCAVATION FOR THE WATERLINE PRODUCE EVIDENCE THAT THE SEWER IS LEAKING. THEN THE SEWER MUST BE REPAIRED OR REPLACED AS DESCRIBED IN SUBSECTIONS (C) OF (D) OF THIS PARAGRAPH.

36. REFER TO THE WATER AND SEWER PLANS FOR ADDITIONAL INFORMATION RELATED TO SAID CONSTRUCTION.

37. PRIOR TO THE COMMENCEMENT OF ANY CONSTRUCTION ACTIVITIES. THE CONTRACTOR SHALL SUBMIT BOND AND THREE WAY CONTRACTS TO THE CITY AND OWNER AS REQUIRED.

38. CONTRACTOR SHALL INSTALL BLUE EMS DISKS (WATER LINE) AT EVERY CHANGE IN DIRECTION, VALVES, & SERVICES, CONTRACTOR SHALL INSTALL GREEN EMS DISKS (SEWER) AT EVERY CHANGE IN DIRECTION, MANHOLE, CLEANOUT, AND SERVICES.

39. INSTALL BLUE EMS DISK ON THE WATER LINES AT EVERY CHANGE IN DIRECTION, VALVE, & SERVICE.

40. INSTALL GREEN EMS DISK ON THE SANITARY SERVICE LINES AT EVERY MANHOLE, CLEANOUT. & SERVICE.

NO SAND OR GRANULAR MATERIAL ALLOWED FOR USE IN BACKFILL ABOVE ROCK EMBEDMENT

ALL FILL SHALL BE COMPACTED WITH SHEEPS FOOT ROLLER.

RECORD DRAWINGS: T WAS THE INTENT THAT THE IMPROVEMENTS SHOWN BE CONSTRUCTED ACCORDING TO THESE PLANS AS APPROVED BY THE CITY. THE LINES AND GRADES WERE SET ON THE GROUND FOR CONSTRUCTION ACCORDING TO SAID PLANS. THE CITY INSPECTED THE CONSTRUCTION. THE ENGINEER DID NOT VERIFY LINES OR GRADES AFTER CONSTRUCTION. WE ARE NOT AWARE OF ANY CHANGES OR REVISIONS TO THESE PLANS DURING CONSTRUCTION OTHER THAN THOSE SHOWN.

DATE: <u>APRIL 30, 2010</u>

RANDALL P. POGUE, P.E. TX LIC. NO. 84780

LANDSCAPING GENERAL NOTES:

1. ALL MATERIALS FOR TURF GRASS PROVIDED SHALL BE IN ACCORDANCE WITH THE STANDARD SPECIFICATIONS FOR PUBLIC WORKS CONSTRUCTION, LATEST EDITION, AS ISSUED BY THE NORTH CENTRAL TEXAS COUNCIL OF GOVERNMENTS. AND THE CITY SPECIFICATIONS AND AS NOTED IN THE PLANS AND CONTRACT DOCUMENTS.

BERMUDA GRASS SEED. TURF GRASS SEED SHALL BE "CYNODON DACTYLON" (COMMON BERMUDA GRASS). THE SEED SHALL BE HARVESTED WITHIN ONE YEAR PRIOR TO PLANTING, FREE OF JOHNSON GRASS, FIELD BIND WEED, DODDER SEED, AND FREE OF OTHER WEED SEED TO THE LIMITS ALLOWABLE UNDER THE FEDERAL SEED ACT AND APPLICABLE SEED LAWS. THE SEED SHALL NOT BE A MIXTURE. THE SEED SHALL BE HULLED, EXTRA FANCY GRADE, TREATED WITH FUNGICIDE AND HAVE A GERMINATION AND PURITY THAT SHALL PRODUCE, AFTER ALLOWANCE FOR FEDERAL SEED ACT TOLERANCES, A PURE LIVE SEED CONTENT OF NOT LESS THAN 85%, USING THE FORMULA: PURITY PERCENT TIME (GERMINATION PERCENT TIMES PLUS HARD OR SOUND SEED FIVE PERCENT). SEED SHALL BE LABELED IN ACCORDANCE

WITH U.S. DEPARTMENT OF AGRICULTURE RULES AND REGULATIONS. A. CERTIFICATE SUBMITTAL. PRIOR TO PLANTING, PROVIDE THE OWNER AND ENGINEER WITH THE STATE OF TEXAS CERTIFICATE STATING ANALYSIS OF PURITY AND GERMINATION OF SEED.

3. RYE GRASS SEED. TURF GRASS SEED SHALL BE "LOLIUM MULTIFLORUM" (ITALIAN OR ANNUAL RYE GRASS). THE SEED SHALL BE HARVESTED WITHIN ONE YEAR PRIOR TO PLANTING AND SHALL BE FREE OF PERENNIAL RYE GRASS SEED. OTHER GRASS SEED AND WEED SEED TO THE LIMITS ALLOWABLE UNDER THE FEDERAL SEED ACT AND APPLICABLE SEED LAWS. SEED SHALL BE AT LEASE 95% PURE AND SHALL HAVE A 90% MINIMUM GERMINATION RATE.


A. CERTIFICATE SUBMITTAL. PRIOR TO PLANTING, PROVIDE THE OWNER AND ENGINEER WITH THE STATE OF TEXAS CERTIFICATE STATING ANALYSIS OF PURITY AND GERMINATION OF SEED.

4. TIMES OF HYDROMULCHING SHALL BE AS FOLLOWS:

A. SEPTEMBER 1 TO APRIL 1 - RYE GRASS SEED SHALL BE APPLIED. B. APRIL 2 TO AUGUST 31 - BERMUDA GRASS SEED SHALL BE APPLIED.

5. 75% - 80% OF ALL DISTURBED AREAS SHALL HAVE MINIMUM 1" (HEIGHT) OF GRASS ESTABLISHED PRIOR TO CITY ACCEPTANCE.

6. WHERE SOIL IS DISTURBED. SIDES AND BOTTOM OF DISTURBED AREAS TO BE EITHER SODDED OR STABILIZED WITH ANCHORED SEEDED CURLEX PRIOR TO PAVEMENT.

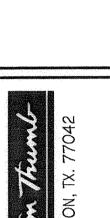

Randalls

08-05-09 ISSUE: PROJECT No.: 1393-09-024 DWG. FILE: 1393-09-024-07/ DRAWN BY: CHECKED BY:

> SHEET TITLE **GENERAL** NOTES SHEET

> > SHEET No.

DWG NO: 1393-09-024-07A.DWG

BRANDON E. COX

ENGINEERING PRACTICE ACT.

THE SEAL APPEARING ON THIS DOCUMENT WAS

AUTHORIZED BY BRANDON E. COX. P.E. 101037 ON

08-05-09 ALTERATION OF A SEALED DOCUMENT

WITHOUT PROPER NOTIFICATION TO THE RESPONSIBLE

ENGINEER IS AN OFFENSE UNDER THE TEXAS