

NORTH TEXAS MUNICIPAL WATER DISTRICT


CONSTRUCTION PLANS FOR ROCKWALL - HEATH TRANSFER SEWER

RHCF 01-1

SECTION 2 STA 484+37.93 TO STA 755+16.76

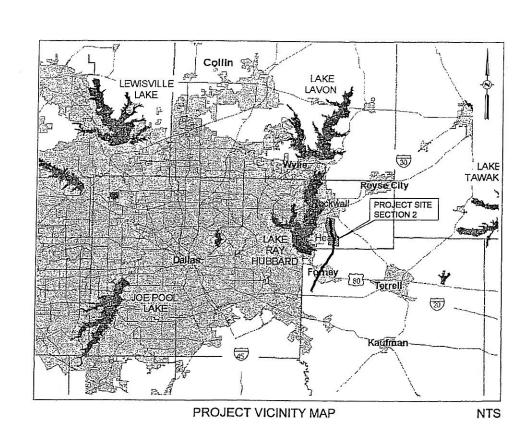

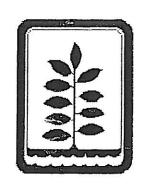

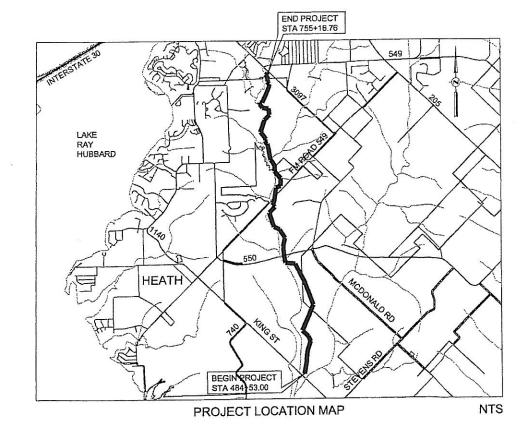

DECEMBER 8, 2003

KELLOGG BROWN & ROOT, INC.



1. L. GUINION 37124
37124
12/8/03

Engineered by KBR Technical Services, Inc.

DRAWING INDEX

DRAWING NO.	TITLE
1 2	TITLE SHEET DRAWING INDEX AND GENERAL NOTES
3 4 5 6 7 8 9 10	PLAN AND PROFILE, STA 483+00 TO STA 494+00 PLAN AND PROFILE, STA 494+00 TO STA 505+00 PLAN AND PROFILE, STA 505+00 TO STA 516+00 PLAN AND PROFILE, STA 516+00 TO STA 527+00 PLAN AND PROFILE, STA 527+00 TO STA 538+00 PLAN AND PROFILE, STA 528+00 TO STA 548+00 PLAN AND PROFILE, STA 549+00 TO STA 560+00 PLAN AND PROFILE, STA 549+00 TO STA 550+00 PLAN AND PROFILE, STA 540+00 TO STA 571+00
11 12 13 14 15 16 17 18 19 20	PLAN AND PROFILE, STA 571+00 TO STA 582+00 PLAN AND PROFILE, STA 582+00 TO STA 593+00 PLAN AND PROFILE, STA 583+00 TO STA 604+00 PLAN AND PROFILE, STA 604+00 TO STA 615+00 PLAN AND PROFILE, STA 604+00 TO STA 626+00 PLAN AND PROFILE, STA 660+00 TO STA 637+00 PLAN AND PROFILE, STA 637+00 TO STA 637+00 PLAN AND PROFILE, STA 637+00 TO STA 648+00 PLAN AND PROFILE, STA 659+00 TO STA 659+00 PLAN AND PROFILE, STA 650+00 TO STA 670+00 PLAN AND PROFILE, STA 650+00 TO STA 670+00 PLAN AND PROFILE, STA 670+00 TO STA 681+00
21 22 23 24 25 26 27 28 29 30 31 32 33 34 35 36	PLAN AND PROFILE, STA 681+00 TO STA 692+00 PLAN AND PROFILE, STA 692+00 TO STA 703+00 PLAN AND PROFILE, STA 703+00 TO STA 714+00 PLAN AND PROFILE, STA 703+00 TO STA 714+00 PLAN AND PROFILE, STA 714+00 TO STA 725+00 PLAN AND PROFILE, STA 735+00 TO STA 735+00 PLAN AND PROFILE, STA 736+00 TO STA 735+00 PLAN AND PROFILE, STA 736+00 TO STA 735+00 PLAN AND PROFILE, STA 736+00 TO STA 735+00 PLAN AND PROFILE, STA 745+00 TO END INTERCONNECTION / 20* PLAN & PROFILE, 0+00 TO END METERING MANHOLE DETAILS (SHT 1 OF 2) METERING MANHOLE DETAILS (SHT 2 OF 2) EMBEDMENT & ENCASEMENT DETAILS MANHOLE DETAILS FLOW SPLITTER BOX SPLITTER BOX SPLITTER BOX GRATING AND METER VAULT FENCE DETAILS INTERCONNECTION / ELECTRICAL

DRAWING LEGEND

-	
SYMBOL	LINE DESCRIPTION
	PROPERTY LINE EXISTING EASEMENT LINE PROPOSED EASEMENT LINE CENTERLINE PROPOSED SANITARY SEWER LINE EXISTING FENCE
•PP	EXISTING POWER POLE
•ც•	EXISTING LIGHT POLE
△ 3030	SURVEY CONTROL POINT
●2114 IR	IRON ROD

CADD DWG FILE NO :

GENERAL PROJECT NOTES

- COORDINATION WITH ADJACENT CONTRACTORS WILL BE REQUIRED WHERE APPLICABLE AT THE INTERFACES OF CONTRACTS.
- 2. THE CONTRACTOR'S ACTIVITIES ALONG THE PIPELINE ROUTE SHALL BE LIMITED TO THE CONSTRUCTION LIMITS SHOWN ON THE DRAWINGS OR MADE AVAILABLE TO CONTRACTOR BY OWNER. NOTHING CONTAINED IN THE SPECIFICATIONS AND NOTHING MARKED ON THE DRAWINGS SHALL BE INTERPRETED AS GIVING THE CONTRACTOR EXCLUSIVE OCCUPANCY WITHIN THE TERRITORY SHOWN. ALL DAMAGES RESULTING FROM CONTRACTOR'S USE OF PROPERTY SHALL BE PAID FOR BY THE CONTRACTOR.
- 3. IT SHALL BE THE RESPONSIBILITY OF THE CONTRACTOR TO PROVIDE FOR ADDITIONAL AREAS THAT HE MAY REQUIRE FOR HIS OPERATION INCLUDING ACCESS ROADS TO WORK AREAS OR TO LINK UP WITH ANY ROAD WITHIN THE LIMITS OF OPERATIONS, AND CONTRACTOR SHALL BEAR ALL COSTS, LIABILITIES AND RESPONSIBILITIES IN CONNECTION THEREWITH.
- 4. CONTRACTOR SHALL NOTIFY THE APPROPRIATE GOVERNMENTAL OR PRIVATE AGENCY BEFORE CONSTRUCTION BEGINS FOR CROSSING OR INTERFERING IN ANY WAY WITH DITCHES, RAILROAD TRACKS, ROADS, PIPELINE OR UTILITY LINES, UTILITY RIGHTS-OF-WAY OR EASEMENTS, OR ANY OTHER EXISTING FACILITIES AND OBTAIN ALL REQUIRED PERMITS, AND MEET ALL REQUIREMENTS THEREWITH INCLUDING OBTAINMENT OF ALL REQUIRED BONDS, INSURANCE AND OTHER REQUIREMENTS FOR CROSSING OR UTILIZATION OF RIGHTS-OF-WAY.
- 5. EXISTING UNDERGROUND PIPELINE AND UTILITIES
- A. UNDERGROUND PIPELINES AND UTILITIES EXIST ON THIS PROJECT, THESE PIPELINES MAY CONTAIN HAZARDOUS, FLAMMABLE OR CORROSIVE PRODUCTS UNDER SIGNIFICANT PRESSURE. THE CONTRACTOR SHALL USE EXTREME CAUTION WHEN PERFORMING ANY ACTIVITIES IN THE VICINITY OF ANY PIPELINE.
- B. THE LOCATION, SIZE AND OWNERSHIP OF KNOW UNDERGROUND UTILITIES SHOWN IN THE PLANS IS APPROXIMATE AND BASED ON THE INFORMATION AVAILABLE TO THE ENGINEER DURING DESIGN OF THE PROJECT. CONTRACTOR SHALL VERIFY THE LOCATIONS OF ALL EXISTING UTILITIES INCLUDING THOSE NOT SHOWN ON THE DRAWINGS SUFFICIENTLY IN ADVANCE OF THE CONSTRUCTION SO THAT IF IT IS NECESSARY TO CHANGE OR MOVE THE UTILITY, THE PROGRESS OF THE WORK WILL NOT BE DELAYED.
- C. THE CONTRACTOR SHALL PROVIDE ALL NECESSARY AND PROPER SUPPORT TO PIPELINES OR UTILITIES AT CROSSINGS AND PROVIDE ALL NECESSARY MATERIALS, SUPPLIES, SUPERVISION AND EXERCISE PROPER SAFETY PRECAUTIONS WHILE EXCAVATING IN AREAS ADJACENT TO AND AROUND PIPELINE/UTILITY CROSSINGS.
- CONTRACTOR SHALL ADEQUATELY PROTECT EXISTING BUILDINGS, STRUCTURES AND OTHER PERMANENT FACILITIES WITHIN AND ADJACENT TO THE TEMPORARY CONSTRUCTION EASEMENT.
- CONTRACTOR SHALL DETERMINE EXISTING GRADES AND DIMENSIONS OF ROADS, DITCHES, CULVERTS, DRIVEWAYS, ETC. BEFORE THEIR REMOVAL FOR USE IN THEIR SUBSEQUENT RESTORATION.
- 8. FENCING, ROADS, DRIVEWAYS, CULVERTS, DITCHES OR OTHER FACILITIES OR IMPROVEMENTS REMOVED OR DAMAGED DURING CONSTRUCTION SHALL BE REPAIRED OR REPLACED IN THEIR ORIGINAL LOCATION AND LEFT IN A CONDITION AS GOOD OR BETTER THAN THAT IN WHICH THEY WERE FOUND UNLESS OTHERWISE NOTED ON DRAWINGS OR DIRECTED BY THE ENGINEER
- CONTRACTOR SHALL PROVIDE ALL TRENCH SAFETY AND EXCAVATION SUPPORT SYSTEMS AS REQUIRED BY TEXAS STATE LAW AND THE CONTRACT DOCUMENTS.
- 10. NO EXCESS EXCAVATED MATERIAL SHALL BE DEPOSITED IN LOW AREAS OR ALONG NATURAL DRAINAGE WAY WITHOUT WRITTEN PERMISSION FROM THE OWNER'S REPRESENTATIVE. SHOULD THE CONTRACTOR PLACE EXCESS MATERIAL IN AREAS WITHOUT WRITTEN PERMISSION, HE WILL BE RESPONSIBLE FOR ALL DAMAGE RESULTING FROM SUCH FILL AND HE SHALL REMOVE THE MATERIAL AT HIS OWN COST IF THE DISTRICT SO DIRECTS.
- CONTRACTOR SHALL PROVIDE ALL WARNING LIGHTS, BARRICADES AND OTHER ITEMS REQUIRED FOR THE PROTECTION OF PERSONNEL AND THE PUBLIC.
- 12. UNRESTRICTED INGRESS AND EGRESS OF OWNERS AND LEASEES OF PROPERTY ADJACENT TO THE CONSTRUCTION RIGHTS-OF-WAY SHALL BE MAINTAINED BY CONTRACTOR AT ALL TIMES DURING THE DURATION OF THE WORK. CONTRACTOR SHALL OBTAIN ANY REQUIRED PERMITS.
- ALL TOPSOIL SHALL BE STOCKPILED AND REPLACED TO A MINIMUM DEPTH OF 6 INCHES. THE REPLACED TOPSOIL SHALL BE DISC HARROWED AND SMOOTHED.
- 14. STATIONING SHOWN IS MEASURED HORIZONTALLY ALONG THE CENTERLINE OF THE PIPELINE.
- PIPELINE ELEVATIONS GIVEN ARE PIPE INVERT ELEVATIONS UNLESS OTHERWISE NOTED.
- 16. SURFACE WATER CONTROL
- A. CONTRACTOR SHALL PROVIDE STORM WATER POLLUTION PREVENTION PLANS (SWPPP) AND ALL APPURTENANCES WHICH COMPLY WITH THE LATEST E.P.A. SWPPP REGULATIONS.
- B. UNLESS OTHERWISE SHOWN ON THE PLANS, THE CONTRACTOR SHALL RESTORE GROUND TO ORIGINAL GRADE AND PREVENT PONDING OF STORM WATER RUNOFF ON ALL GROUND DISTURBED BY CONSTRUCTION ACTIVITIES.
- C. CONTRACTOR SHALL BE RESPONSIBLE FOR PROVIDING ADEQUATE MEASURES FOR PREVENTING STORM WATER RUNOFF FROM ENTERING THE TRENCH DURING CONSTRUCTION.

- 16. SURFACE WATER CONTROL (CONTINUED)
- D. CONTRACTOR SHALL MAINTAIN DRAINAGE FOR ALL STORM DRAINAGE CULVERTS REMOVED OR IN AREAS OTHERWISE AFFECTED BY CONSTRUCTION OPERATIONS.
- E. CONTRACTOR SHALL MAINTAIN DRAINAGE WITHIN ALL COUNTY AND CITY RIGHTS-OF-WAYS AFFECTED BY CONSTRUCTION AND RESTORE THE RIGHTS-OF-WAYS BACK TO CONDITIONS EQUAL TO OR EXCEEDING THAT WHICH EXISTED PRIOR TO START OF CONSTRUCTION.

17. PROTECTION OF TREES

- A. ALTHOUGH 50 FEET OF PERMANENT EASEMENT AND 30 ADDITIONAL FEET OF TEMPORARY CONSTRUCTION EASEMENT ARE INDICATED, THE CONTRACTOR WILL NOT BE ALLOWED TO CLEAR THE ENTIRE 30 FOOT TEMPORARY CONSTRUCTION EASEMENT OF ALL EXISTING TREES OVER 4 INCHES CALIPER. THE CONTRACTOR AND OWNER'S REPRESENTATIVE WILL DETERMINE THE ONLY TREES THAT MAY BE REMOVED WITHIN THE CONST EASEMENTS PRIOR TO EXCAVATION OR CLEARING ACROSS ANY TRACTS. CONTRACTOR WILL BE HELD LIABLE FOR DAMAGE TO ANY TREES THAT HAVE NOT BEEN DESIGNATED FOR APPROVAL.
- B. CONTRACTOR MAY TRIM TREES AS NECESSARY UNDER OWNER SUPERVISION.
- C. ALL CUT LIMBS OVER 1 INCH CALIPER SHALL BE PAINTED WITH TREE WOUND PAINT IMMEDIATELY AFTER CONSTRUCTION ACTIVITIES HAVE BEEN COMPLETED IN THIS AREA.
- D. ALL TREES OVER 4 INCHES CALIPER THAT ARE REMOVED OR SEVERELY DAMAGED BY CONSTRUCTION OPERATIONS WITHOUT PERMISSION SHALL BE REPLACED WITH EQUIVALENT TYPE AND DIAMETER OF TREES AT THE SOLE EXPENSE OF THE CONTRACTOR OR THE CONTRACTOR SHALL PAY THE FAIR MARKET VALUE TO THE OWNER.
- E. THE CONTRACTOR SHALL TAKE SPECIAL CARE IN AVOIDING DAMAGE TO PLANT MATERIAL OR TREES WITHIN THE SITE OR PROPERTY ADJACENT TO THE WORK. ANY AND ALL PLANT MATERIAL OR TREES DAMAGED AS A RESULT OF THE CONTRACTOR'S WORK SHALL BE CORRECTED IN ACCORDANCE WITH TEXAS A&M FORMULA FOR SHADE TREE EVALUATION.
- 18. FINISHED GROUND SHALL NOT CONTAIN ANY MORE ROCKS OR DEBRIS THAN THE SURROUNDING UNDISTURBED GROUND.
- ANY FENCES DAMAGED OR REMOVED BY CONSTRUCTION ACTIVITIES NOT NOTED ON PLANS SHALL BE REPLACED WITH A FENCE OF EQUAL OR SUPERIOR QUALITY AT CONTRACTOR'S EXPENSE.
- 20. ANY CONCRETE PAVEMENT OR SIDEWALK, NOT SHOWN TO BE REMOVED IN THE PLANS, REMOVED BY THE CONTRACTOR SHALL BE REPLACED BY THE CONTRACTOR AT HIS SOLE EXPENSE.
- 21. CONTRACTOR SHALL CONSTRUCT TEMPORARY ASPHALT RAMPS TO PROTECT CURBS AT THE CONCRETE PAVEMENT USED BY CONSTRUCTION TRAFFIC, AND SHALL REMOVE ASPHALT AT END OF PROJECT.

22. TRAFFIC CONTROL

- A THE CONTRACTOR SHALL PROVIDE BARRICADES, FLAGMEN
 AND OTHER TRAFFIC CONTROL DEVICES AS REQUIRED BY
 THE RESPECTIVE CITYS TRAFFIC CONTROL DEPARTMENT
 FOR ANY CITY STREET LANE CLOSURES AND AS REQUIRED
 BY THE TEXAS DEPARTMENT OF TRANSPORTATION FOR
 WORK WITHIN TXDOT RIGHT-OF-WAY.
- B. ALL BARRICADES, WARNING SIGNS, LIGHTS, DEVICES, ECT., FOR THE GUIDANCE AND PROTECTION OF TRAFFIC AND PEDESTRIANS MUST CONFORM TO THE INSTALLATION SHOWN IN THE TEXAS MANUAL ON UNIFORM TRAFFIC CONTROL DEVICES, LATEST EDITION, PUBLISHED BY THE STATE DEPARTMENT OF HIGHWAY AND PUBLIC TRANSPORTATION.
- 23. CONTRACTOR SHALL VERIFY ALL DIMENSIONS AND CONDITIONS IN THE FIELD BEFORE COMMENCING WORK. ANY DISCREPANCIES BETWEEN SITE CONDITIONS AND THAT SHOWN ON THE DRAWINGS SHALL BE REPORTED TO THE ENGINEER IN A TIMELY MANNER.
- 24. CONTRACTOR SHALL BE RESPONSIBLE FOR PROVIDING REQUIRED SECURITY TO PROTECT MATERIALS, EQUIPMENT, AND WORK COMPLETED OR IN PROGRESS.
- 25. THE CONTRACTOR IS TO DETERMINE THE EXACT LOCATION OF BORE PITS IN THE FIELD. PROPOSED PIT LOCATIONS ARE SUBJECT TO REGULATORY AGENCY REQUIREMENTS AND/OR THE MINIMUM CONSTRAINTS DEPICTED BY THE TRAFFIC CONTROL PLANS. A SUBMITTAL SHOWING PIT LOCATIONS SHALL BE SUBMITTED TO AND APPROVED BY THE ENGINEER PRIOR TO COMMENCING WORK.
- 26. WORK PITS FOR TUNNELING OPERATION SHALL BE BORDERED BY A SUBSTANTIAL SECURITY FENCE OR PROTECTED FROM THE PUBLIC BY OTHER SUITABLE MEANS WHEN NOT IN USE.

- 27. THE CONTRACTOR SHALL CONDUCT HIS OPERATIONS IN A MANNER SUCH THAT TRUCKS AND OTHER VEHICLES DO NOT CREATE A DIRT NUISANCE OR SAFETY HAZARD IN ANY STREETS OR ROADWAYS, PUBLIC OR PRIVATE. THE CONTRACTOR SHALL CLEAN AND SWEEP DIRT FROM ALL STREETS AND ROADWAYS ON A DAILY BASIS.
- CONTRACTOR SHALL COMPLY WITH OSHA REGULATIONS AND STATE OF TEXAS LAW CONCERNING EXCAVATION, TRENCHING AND SHORING.
- 29. NO TRENCHES SHALL BE LEFT OPEN WHILE CONTRACTOR IS NOT WORKING. CONTRACTOR SHALL CONTAIN ALL WORK WITHIN THE EASEMENTS PROVIDED FOR THIS PROJECT AS SHOWN ON THE PLANS.
- 30. THE CONTRACTOR MAY EMPLOY TWO OR MORE CONSTRUCTION CREWS ON THE PROJECT SIMULTANEOUSLY IN ORDER TO EXPEDITE COMPLETION.
- 31. THE CONTRACTOR SHALL CONTINUOUSLY RESTORE THE CONSTRUCTION AREA TO ORIGINAL GRADE AND SECTION. AT NO TIME SHALL THERE BE MORE THAN 2000 L.F. ALONG THE EASEMENT THAT HAS NOT BEEN BESTORED.
- 32. CONTRACTOR SHALL NOT PLACE FILL OR WASTE MATERIAL ON ANY PRIVATE PROPERTY WITHOUT PRIOR WRITTEN AGREEMENT WITH THE PROPERTY OWNER.
- 33. BEFORE COMPLETION OF THIS PROPOSED WORK, ALL ROADWAYS, SLOPES, DITCHES AND BERMS SHALL BE RESTORED TO THEIR ORIGINAL CONDITION
- 34. ELEVATION OF THE TOPS OF MANHOLES WILL BE 0.50 FEET ABOVE THE EXISTING GROUND SURFACE UNLESS IDENTIFIED ON THE PLANS AS BEING LOCATED BELOW EXISTING GROUND SURFACE.
- 35. THE R.O.W. WIDTHS IN SOME LIMITED AREAS MAY NOT BE SUFFICIENT FOR THE CONTRACTOR'S PLANNED WORK. THE CONTRACTOR MAY ACQUIRE ADDITIONAL TEMPORARY CONSTRUCTION R.O.W. AT HIS EXPENSE OR MODIFY HIS CONSTRUCTION PROCEEDURES AS REQUIRED TO STAY WITHIN THE R.O.W. PROVIDED.
- 36. THE CONTRACTOR SHALL PROVIDE TO THE OWNER A VIDEO TAPE DOCUMENTING THE ON THE GROUND PRECONSTRUCTION CONDITION OF THE PROPOSED PIPE LINE CONSTRUCTION AREAS, INCLUDING BOTH THE PERMANENT AND TEMPORARY CONSTRUCTION EASEMENTS AND ROADWAY OROSSINGS, PRIOR TO THE START OF CONSTRUCTION.
- 37. WHEN THE PROPOSED SEWER LINE CONSTRUCTION CROSSES UNDER AN EXISTING PIPE LINE, THE CONTRACTOR SHALL CONTINUE THE TYPE "H" EMBEDMENT OF THE NEW SEWER PIPE UPWARD AND AROUND THE EXISTING PIPE ALSO TO A LEVEL ONE FOOT ABOVE THE TOP OF THE EXISTING PIPE LINE.

PIPELINE MARKER



1. PIPELINE MARKERS SHALL BE LOCATED ON BOTH SIDES OF ALL ROADS AND RAILROADS AT THE R.O.W, LINES OVER THE CENTER OF THE PIPELINE. SEE

GROUNDWATER CONTROL

- IF CONTRACTOR ENCOUNTERS GROUNDWATER ON THE PROJECT, HE SHALL PROVIDE ADEQUATE MEASURES FOR DEWATERING THE TRENCH. ALL COST FOR PUMPS AND/OR OTHER RELATED APPURTENANCES SHALL BE INCLUDED IN THE APPROPRIATE ITEM OF THE BID SCHEDULE.
- 2. PLACEMENT OF DEWATERING SYSTEM (HEADERS, WELLS, ETC.)
 WHERE APPLICABLE SHALL BE SUCH THAT PEDESTRIAN AND VEHICULAR
 TRAFFIC ARE NOT ADVERSELY IMPACTED.
- WATER DISCHARGED FROM THE DEWATERING SYSTEM SHALL NOT BE ALLOWED TO CREATE A WATER NUISANCE ON THE PROPERTY OR ADJACENT PROPERTY.

GEOTECHNICAL BORINGS

 A GEOTECHNICAL INVESTIGATION REPORT SHOWING THE LOCATION AND LOGS OF BORINGS TAKEN AT THE RAILROAD CROSSING, HWY 80 CROSSING, FM 740 CROSSING, KING ROAD CROSSING, FM 550 CROSSING AND FM 549 CROSSING IS ATTACHED TO THE BACK OF THE SPECIFICATIONS.





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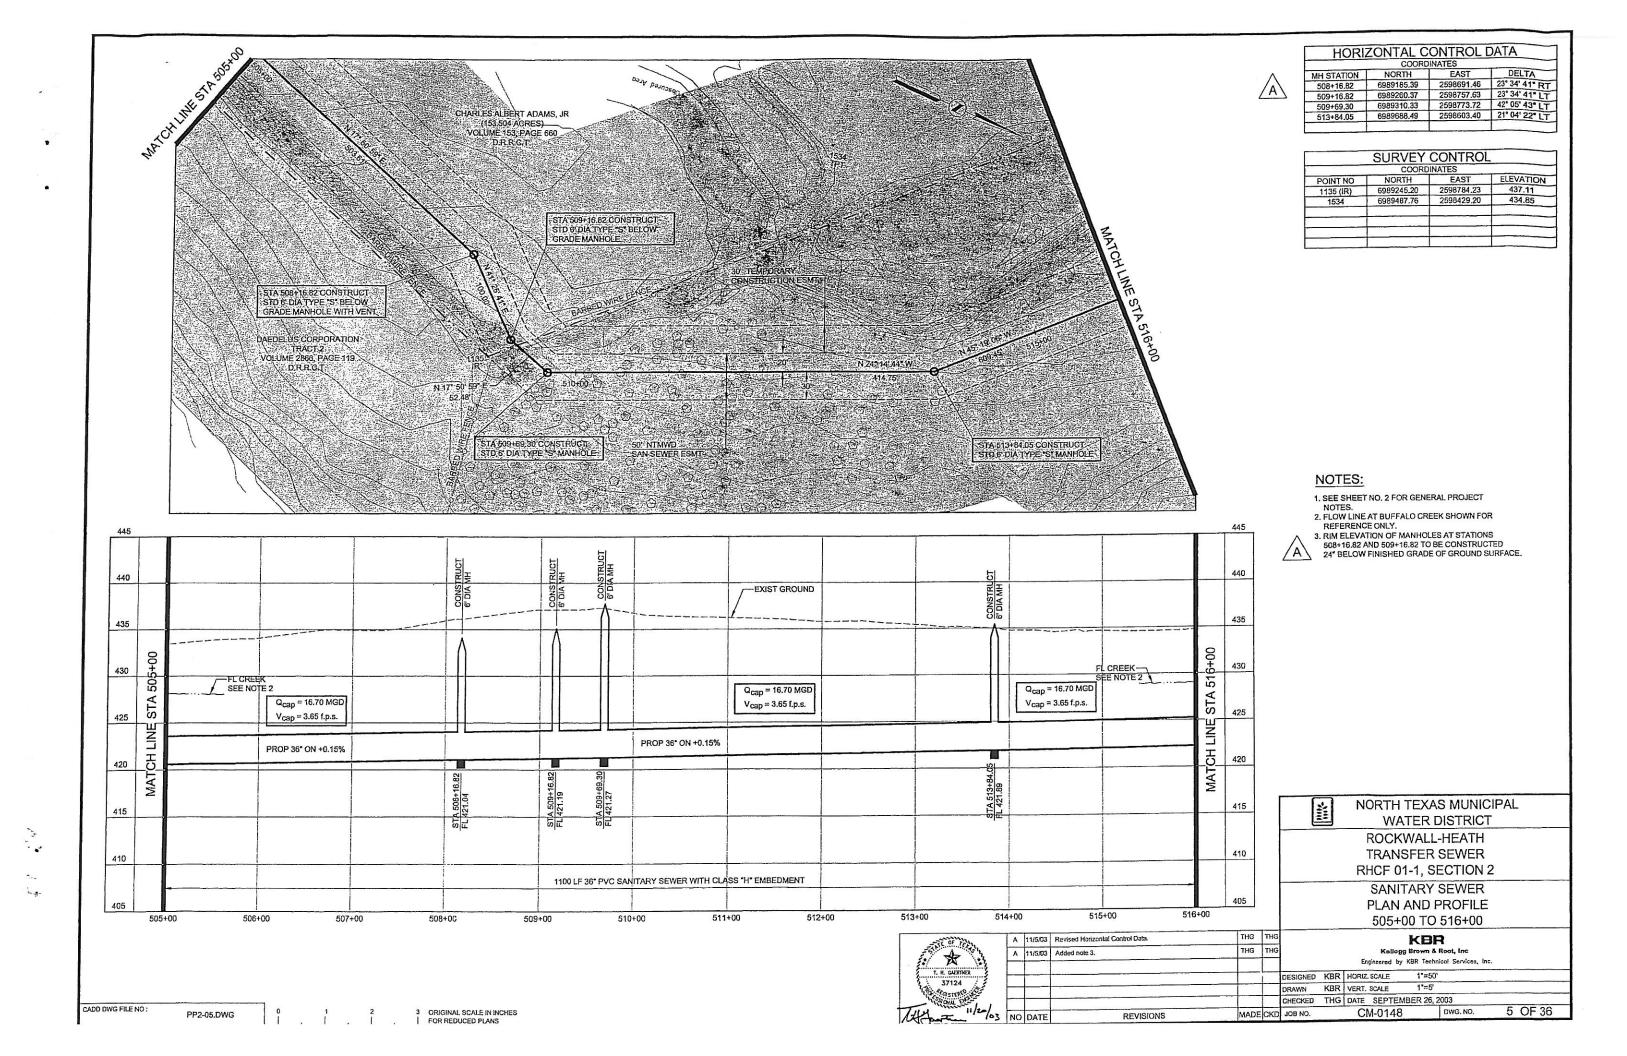
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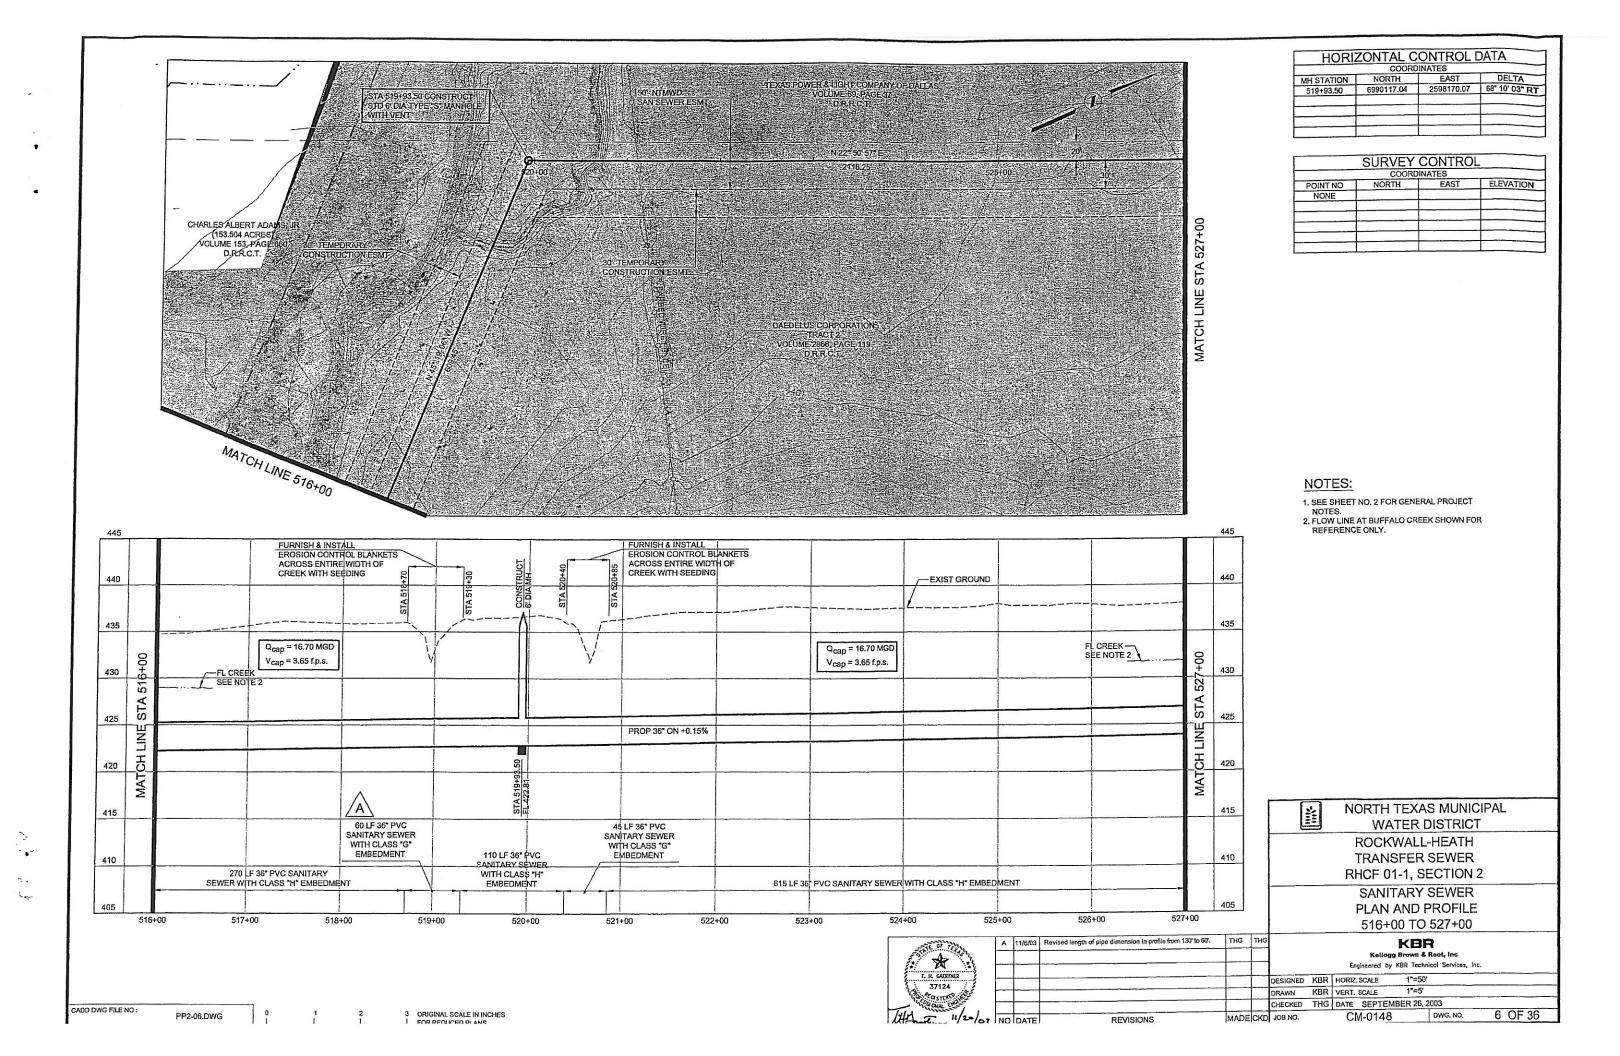
SANITARY SEWER
PLAN AND PROFILE
DRAWING INDEX AND GENERAL NOTES


						טוע	WING INDEX / IND CENTER IN THE				
TO OF THE	Α	11/4/03	Added notes 36 and 37	THG	THG		KBR				
T. H. CARRINGS	A	11/4/03	Revised notes 25 and 26	THG	THG						
	Α	11/4/03	Added sheet 35 to Drawing Index	THG	THG		Engineered by KBR Technical Services, Inc.				
37124	A	11/11/03	Added note on Pipeline Marker.	THG	THG	DESIGNED K	BR HORIZ, SCALE NO SCALE				
19 Fastrace						DRAWN K	BR VERT, SCALE NO SCALE				
HARONE BALL						CHECKED TI	HG DATE SEPTEMBER 26, 2003				
HH 1/20/03	NO	DATE	REVISIONS	MADE	CKD	JOB NO.	CM-0148 DWG. NO. 2 OF 36				







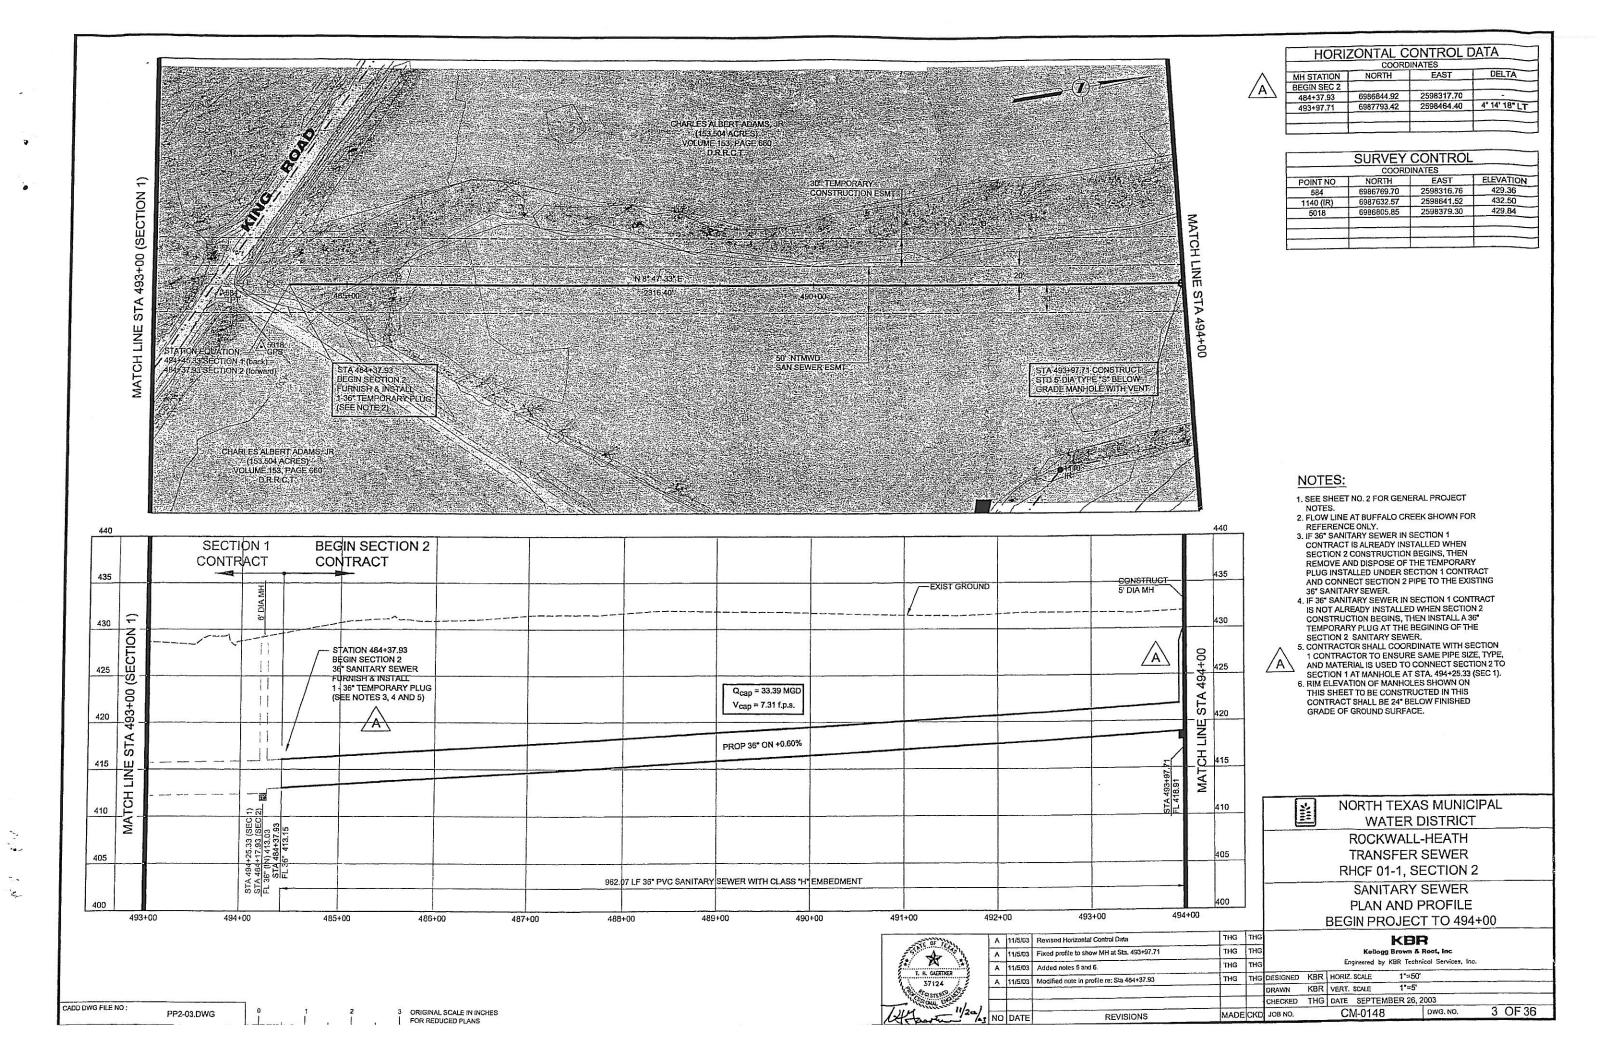


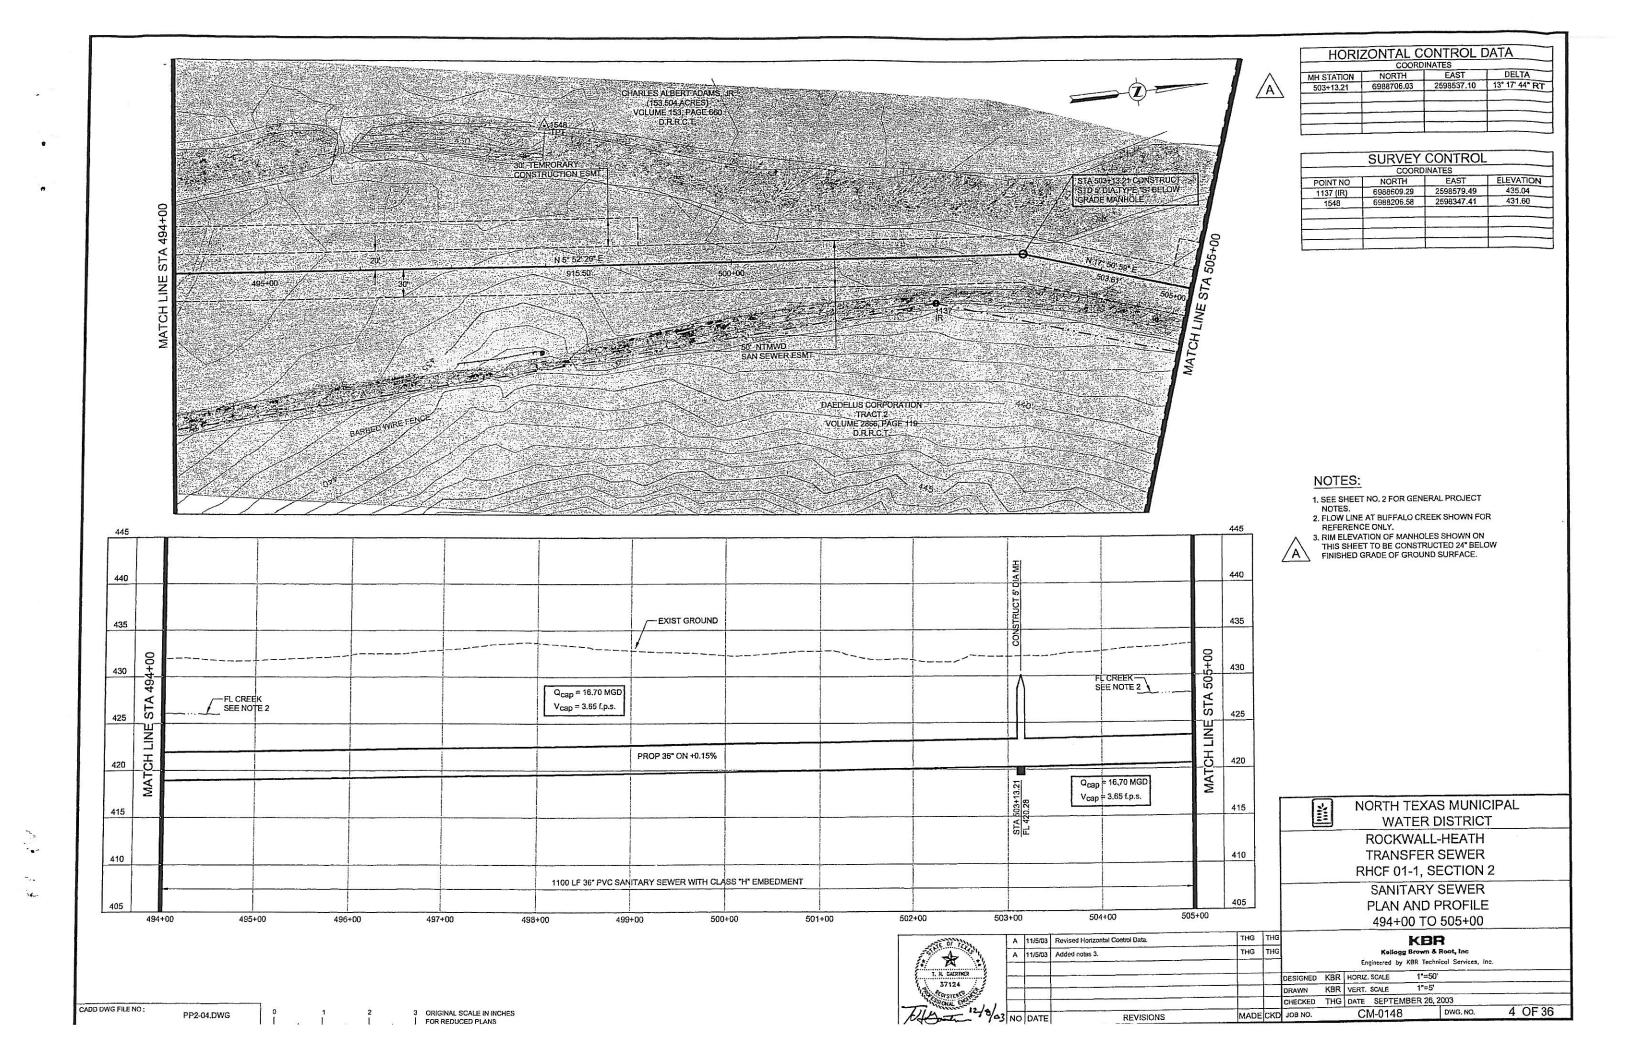


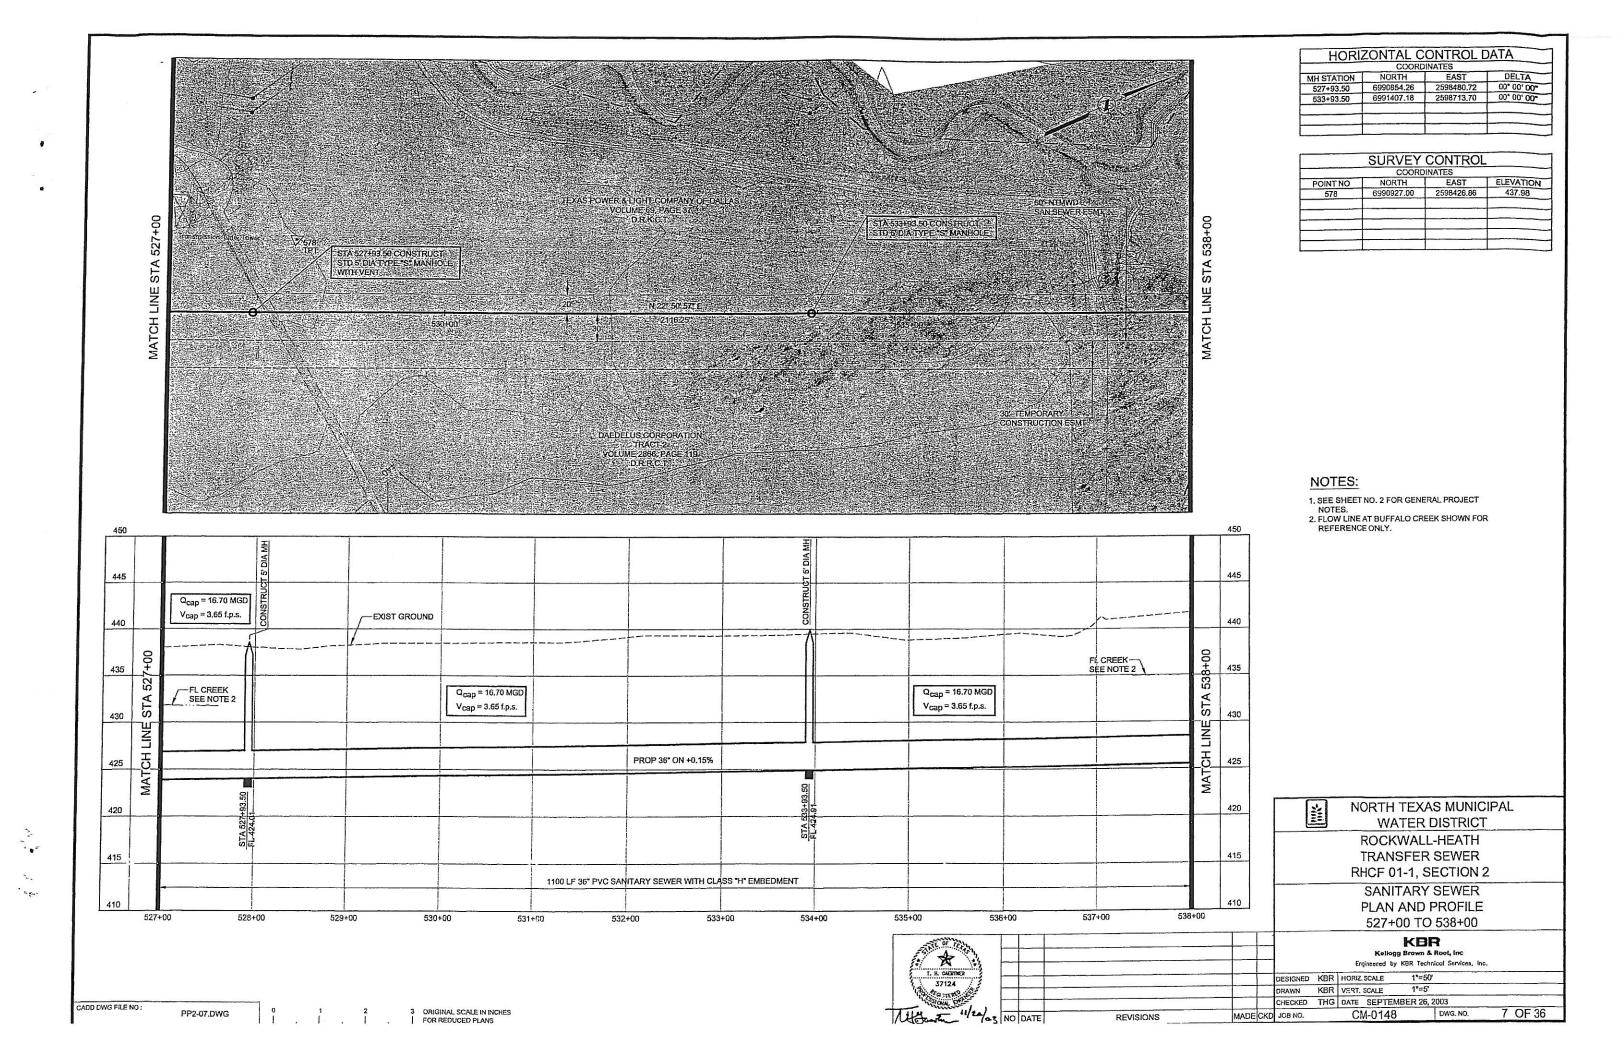


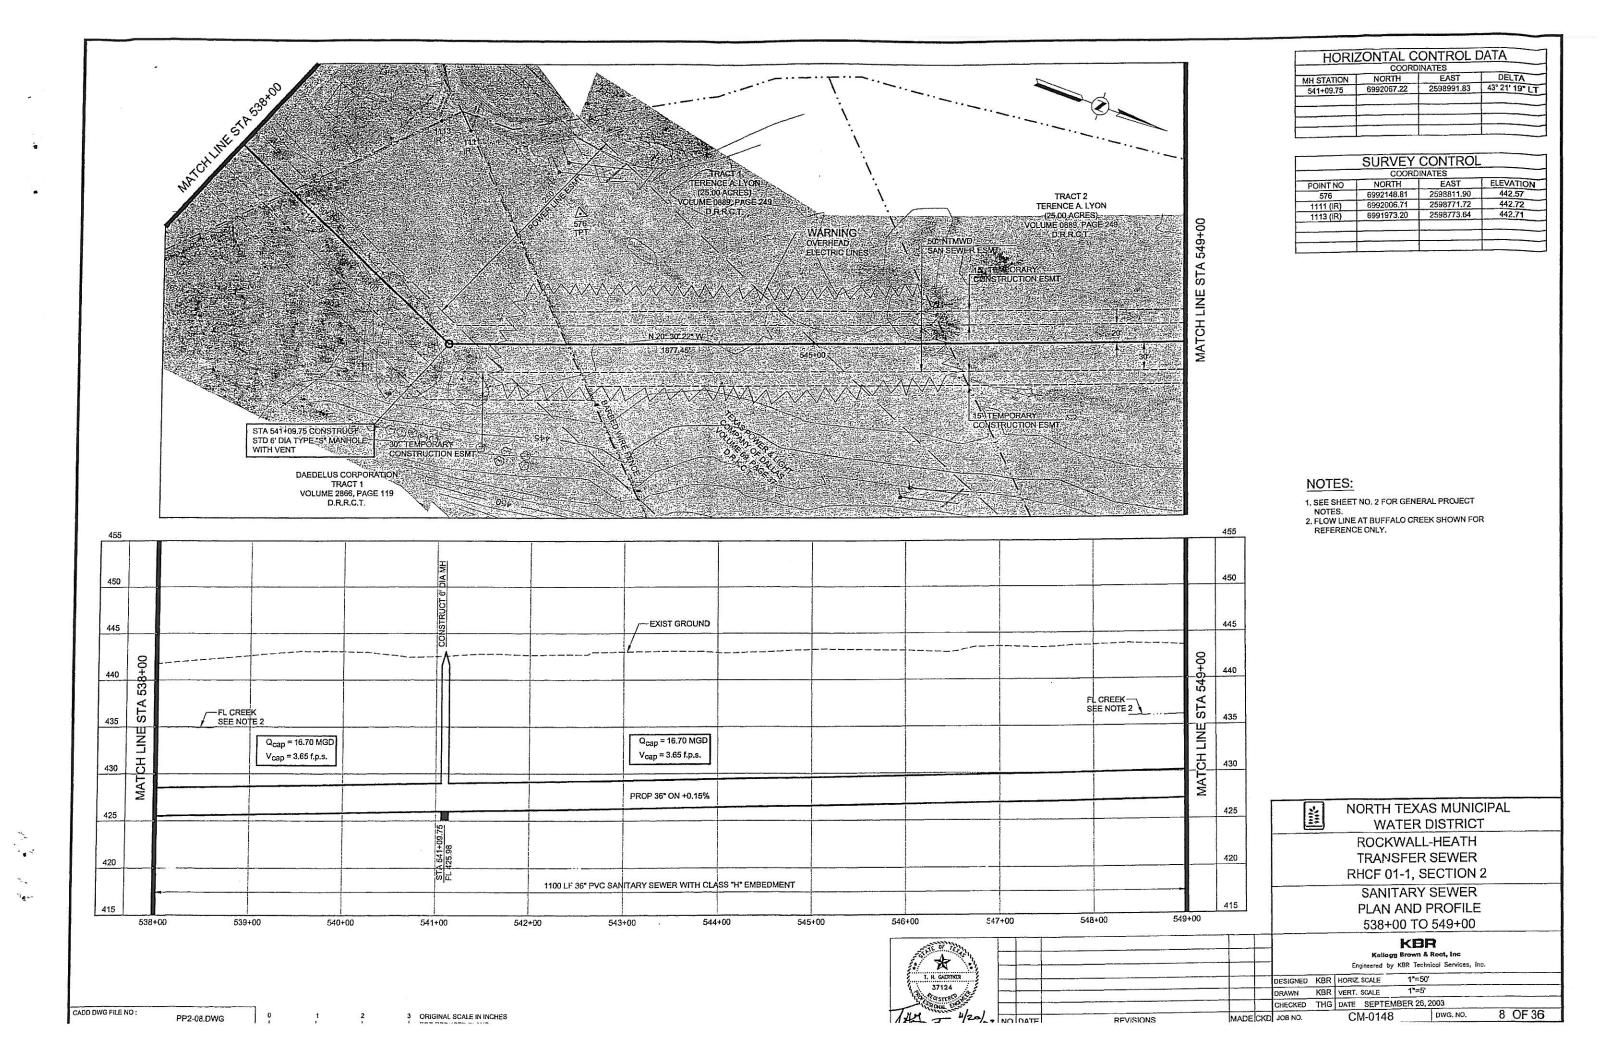


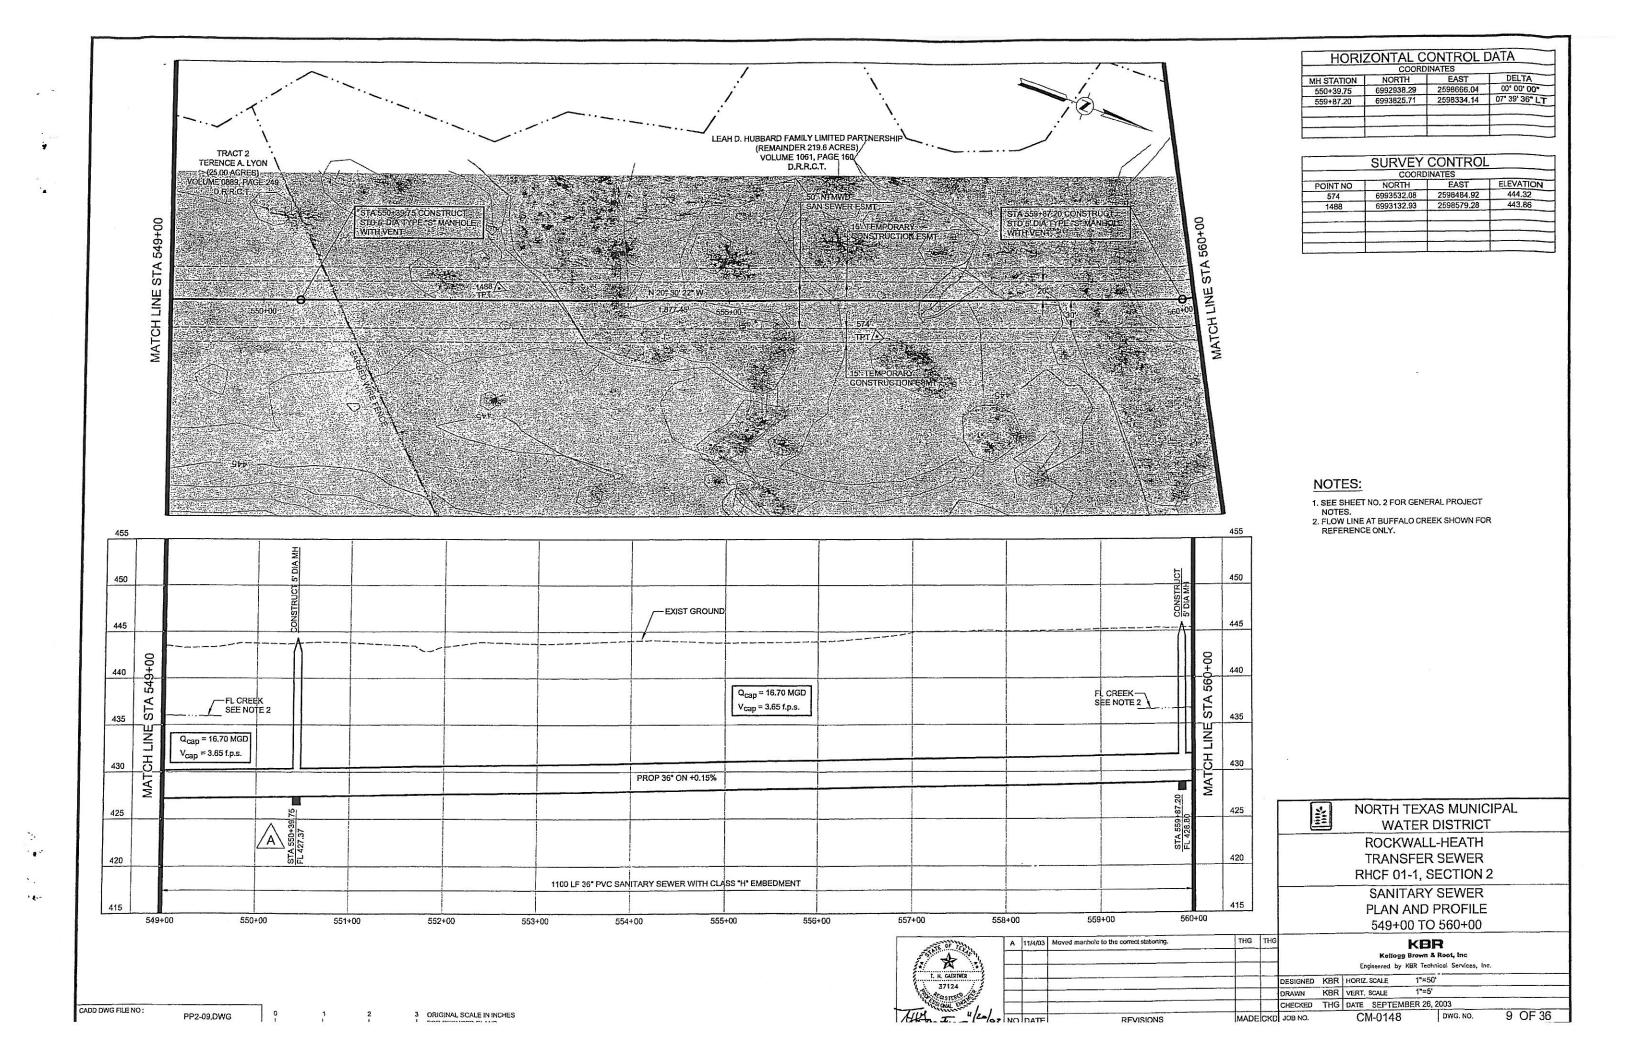


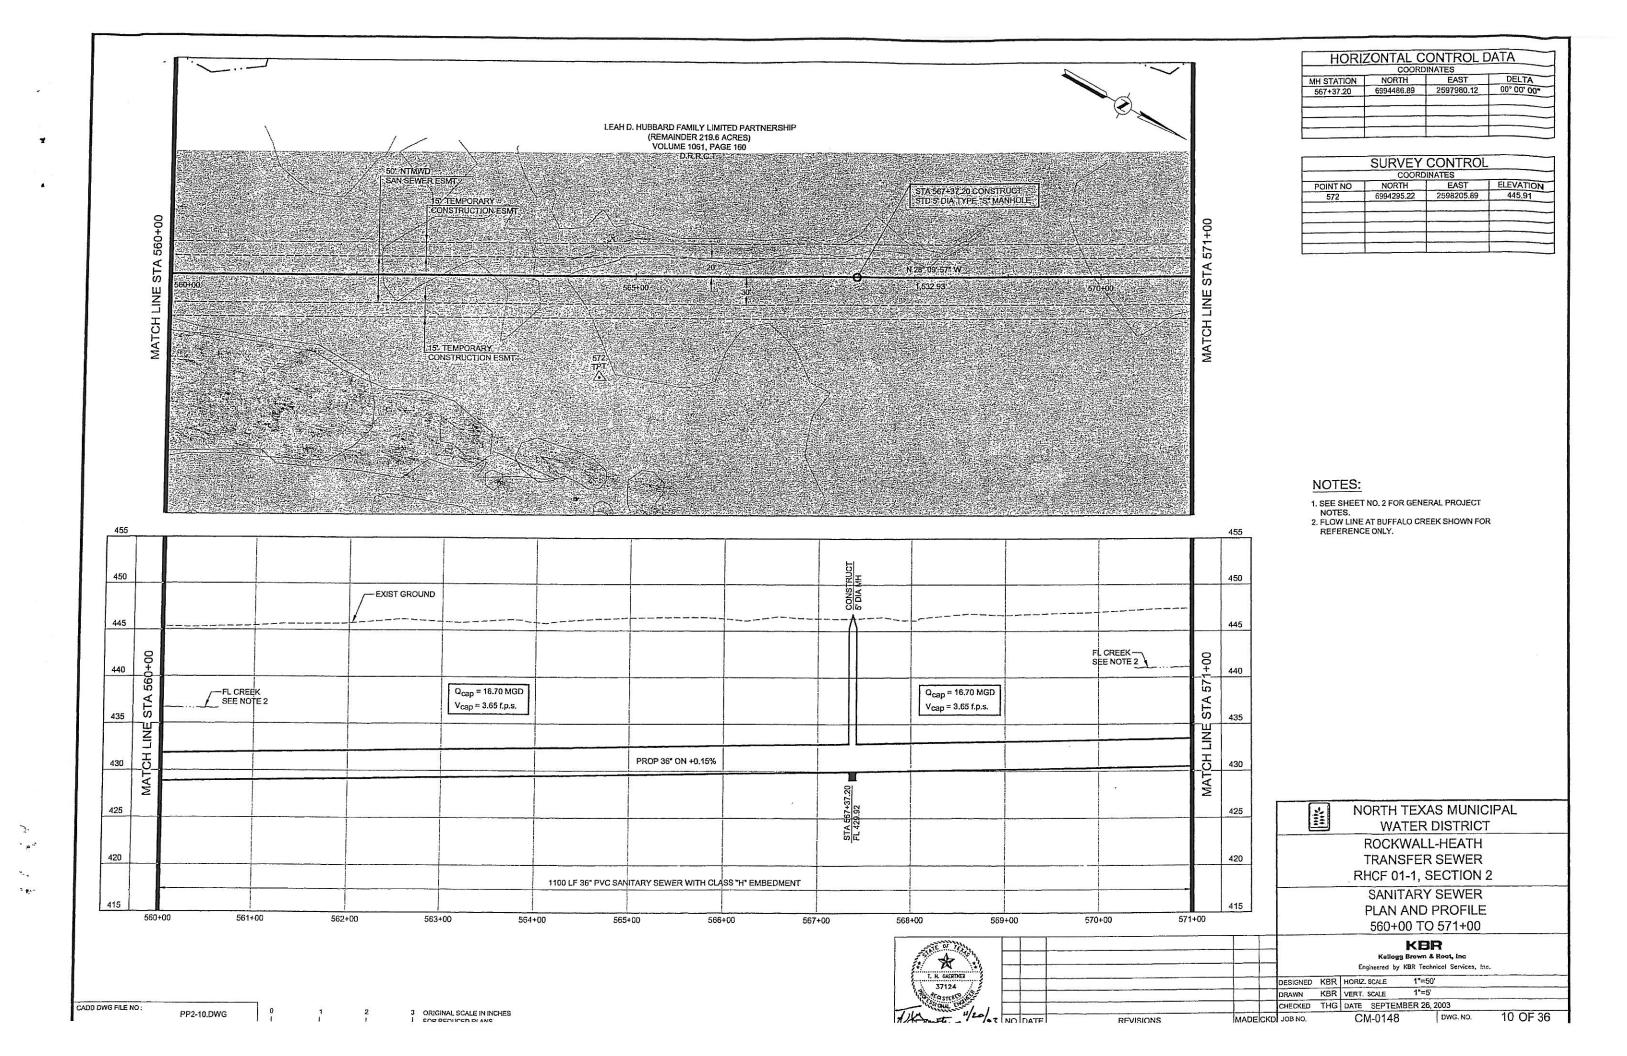


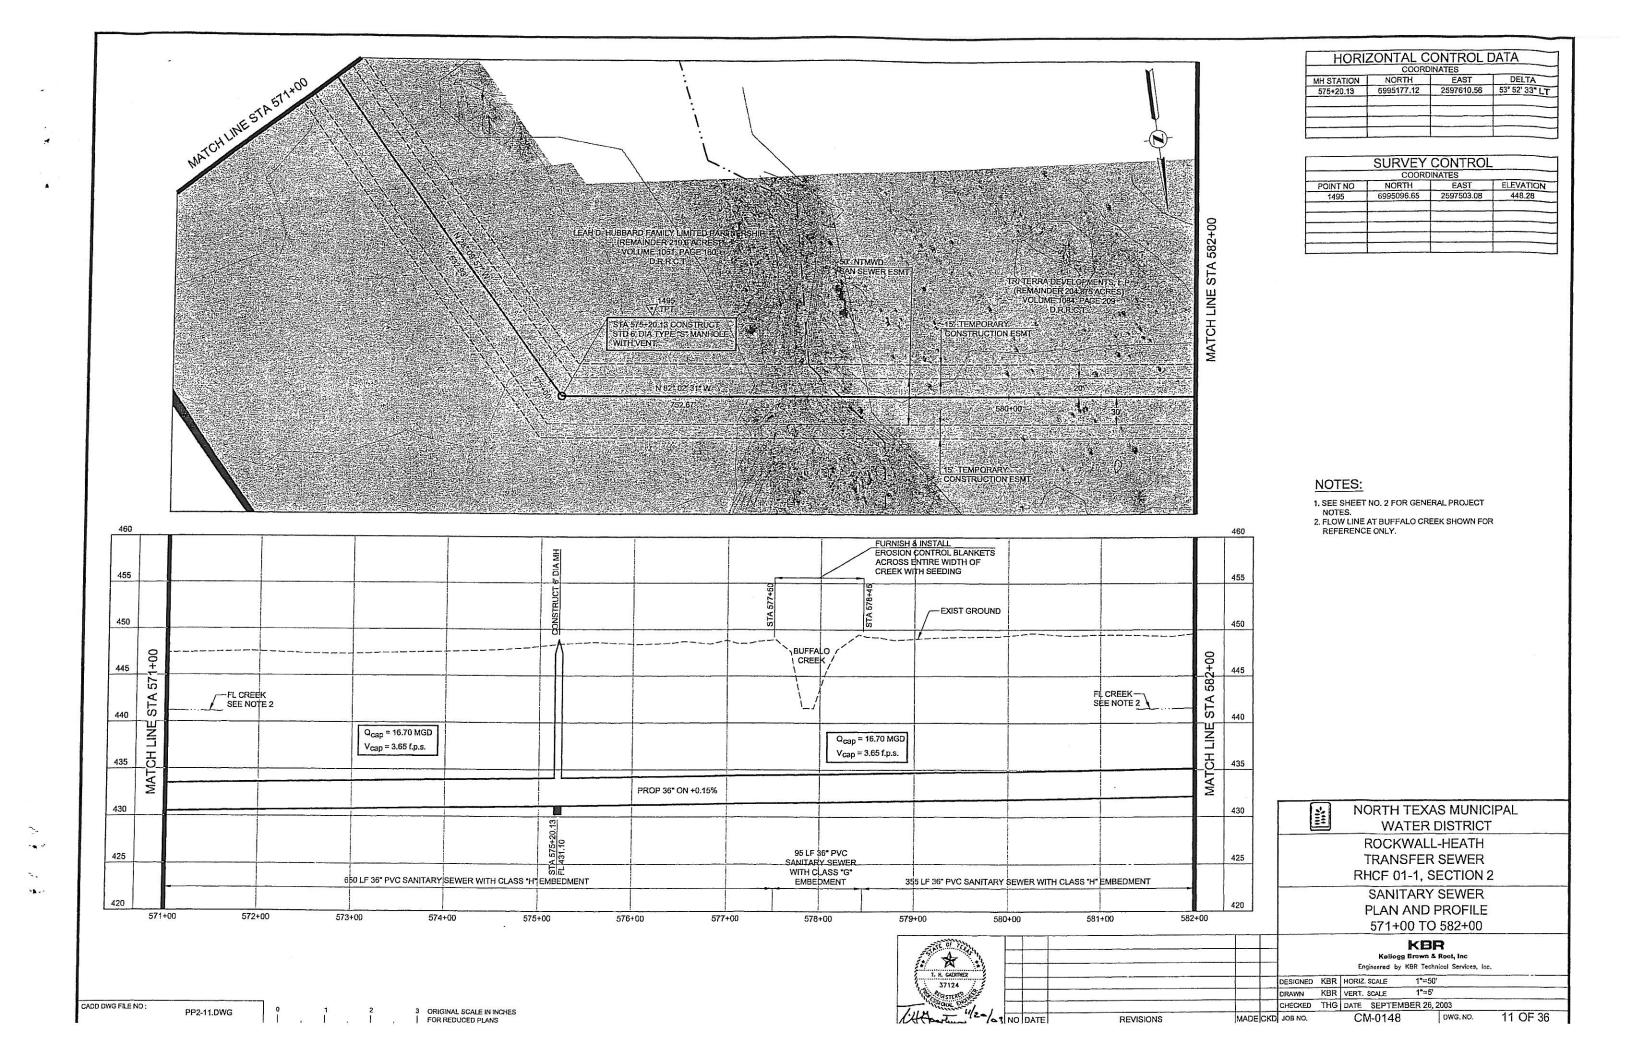


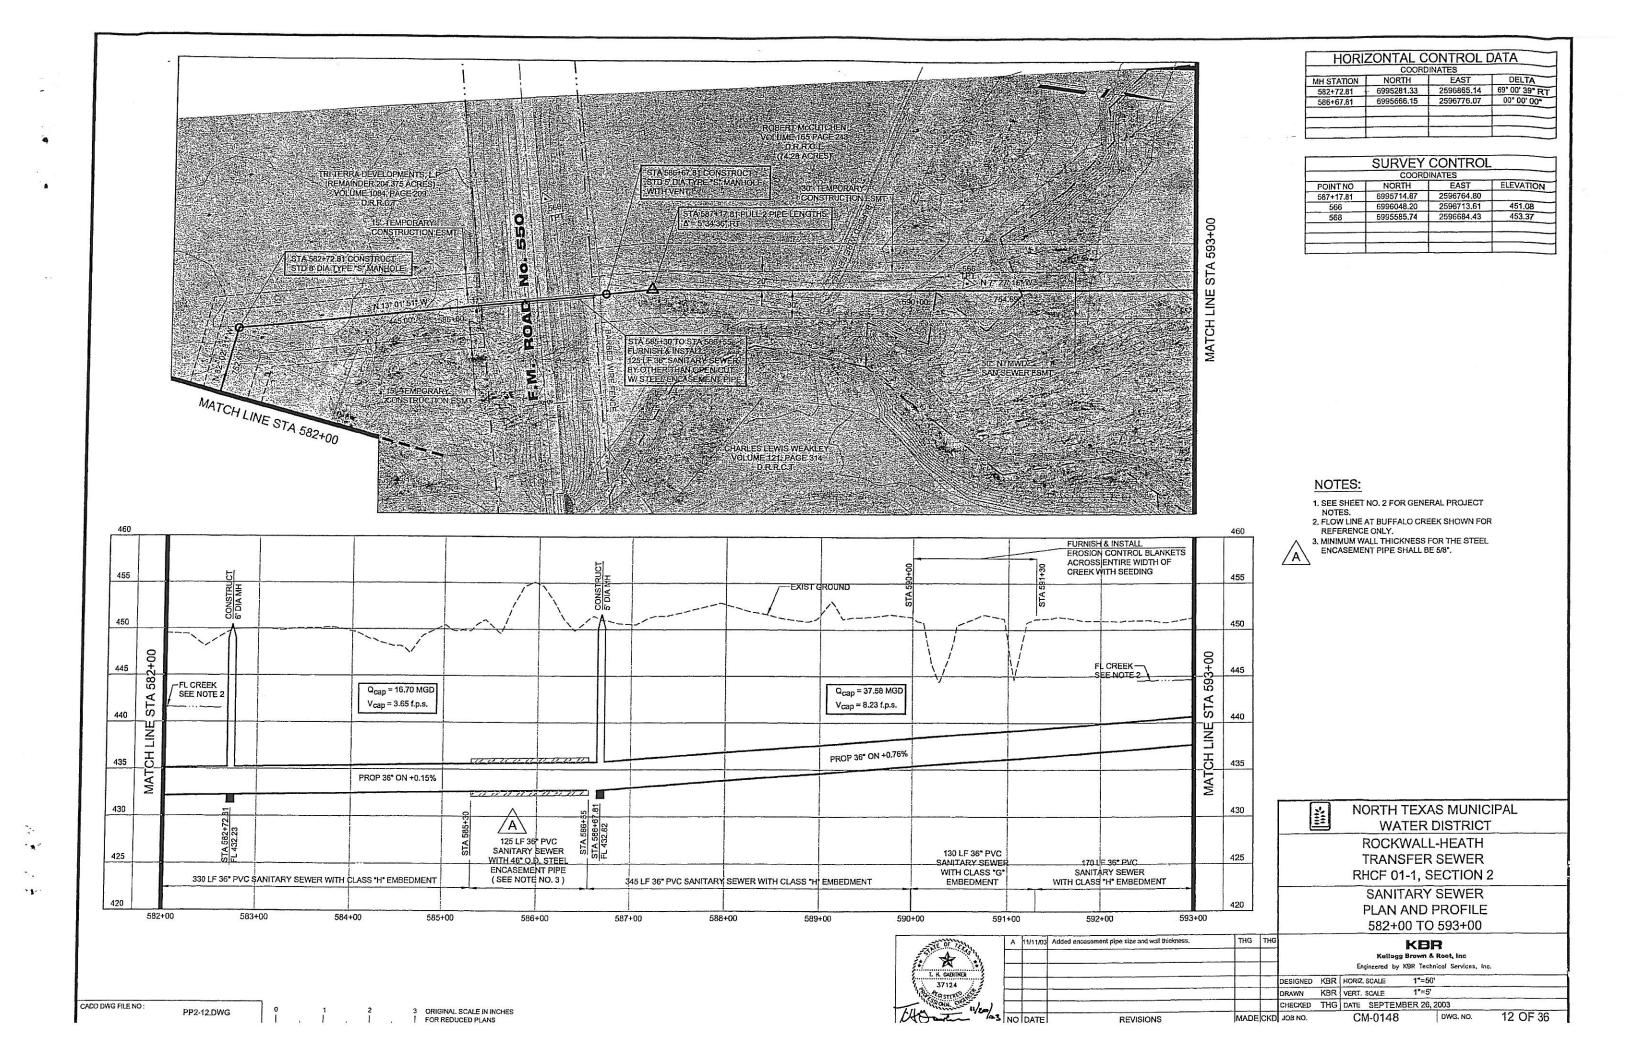


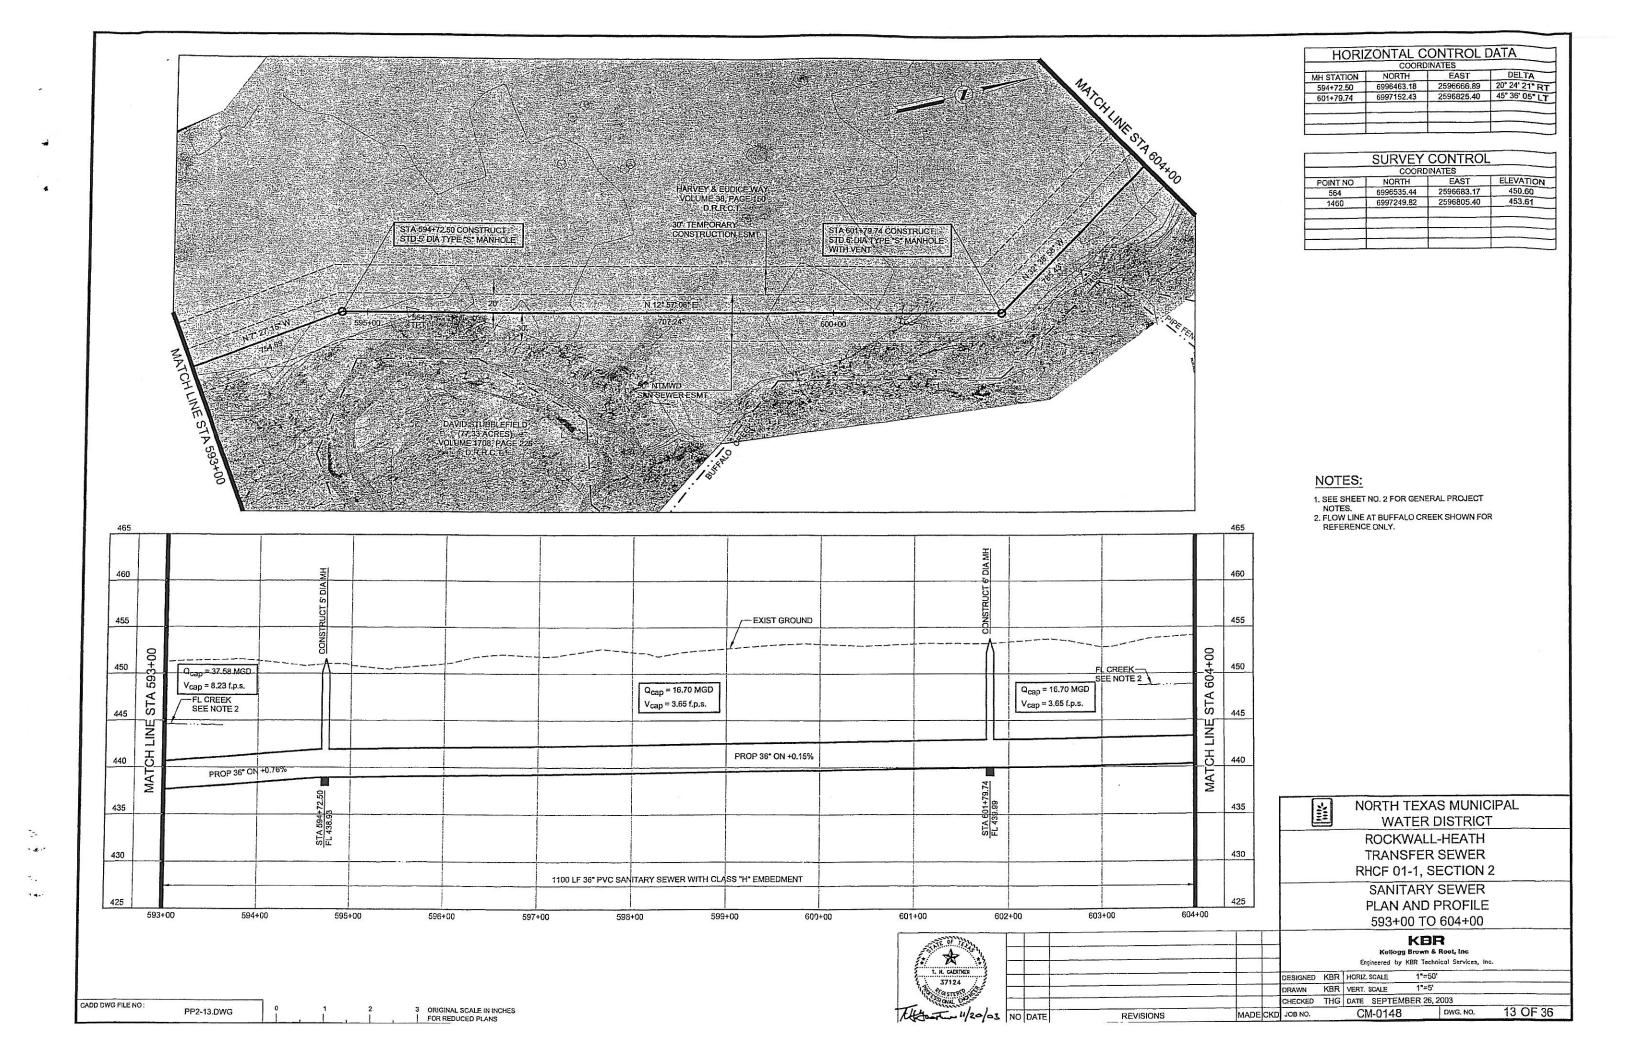


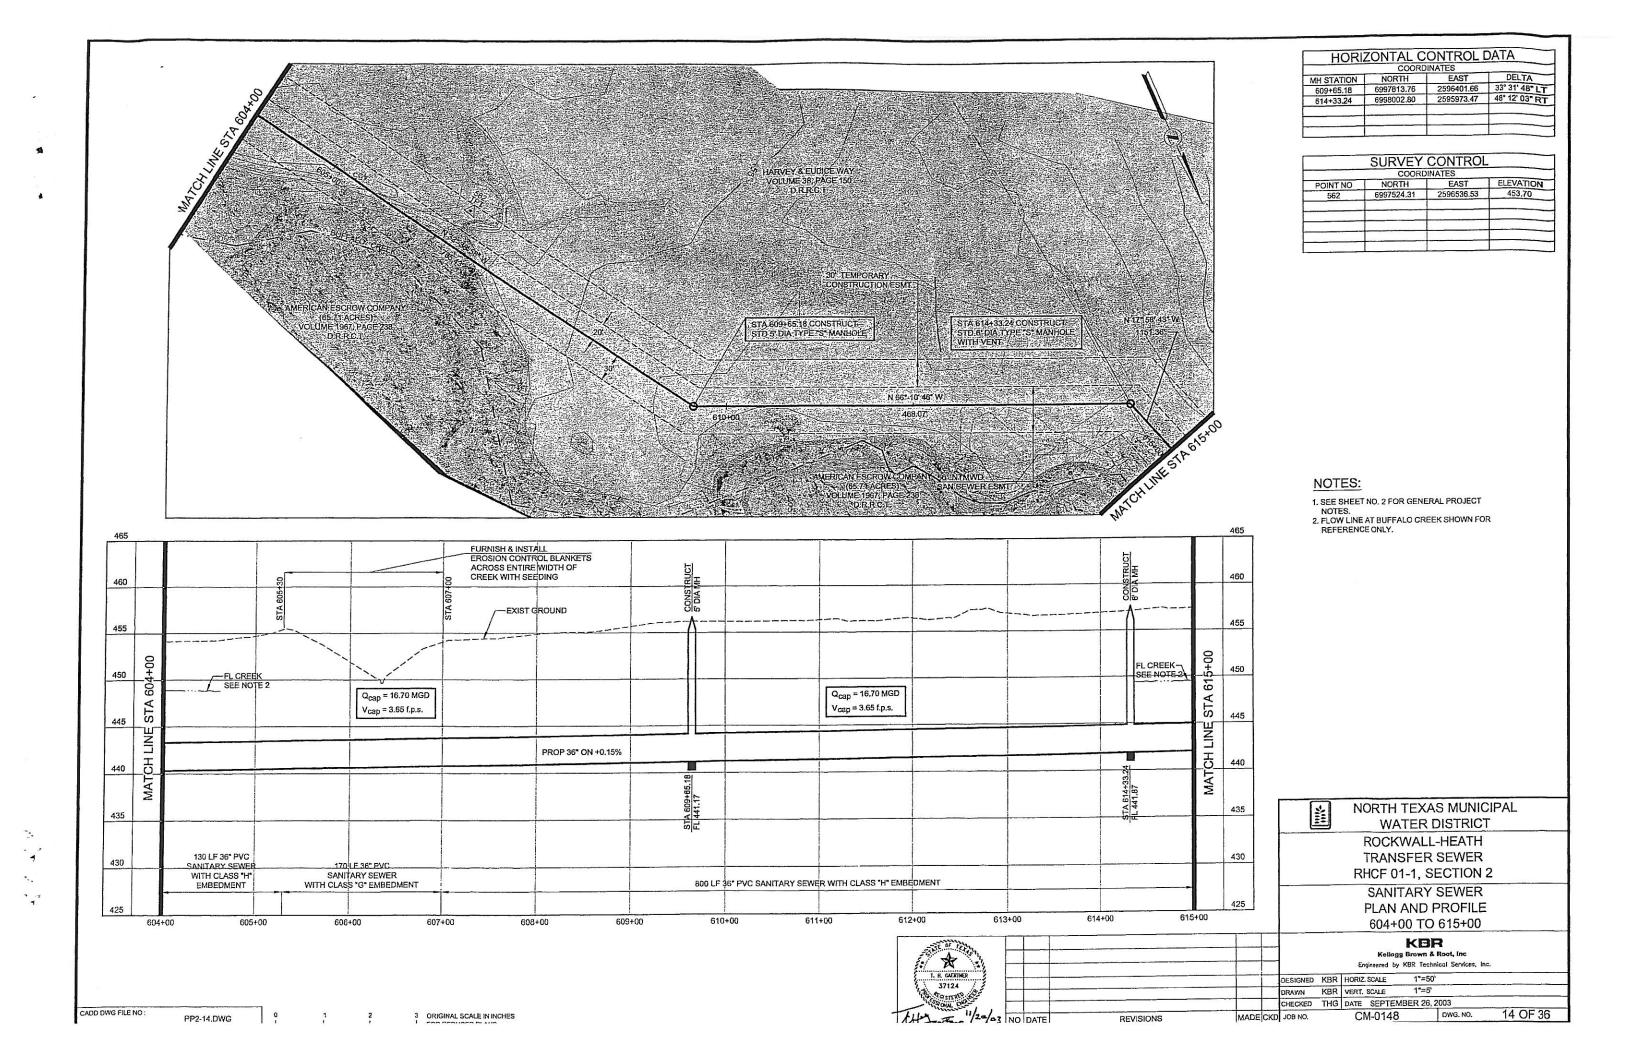


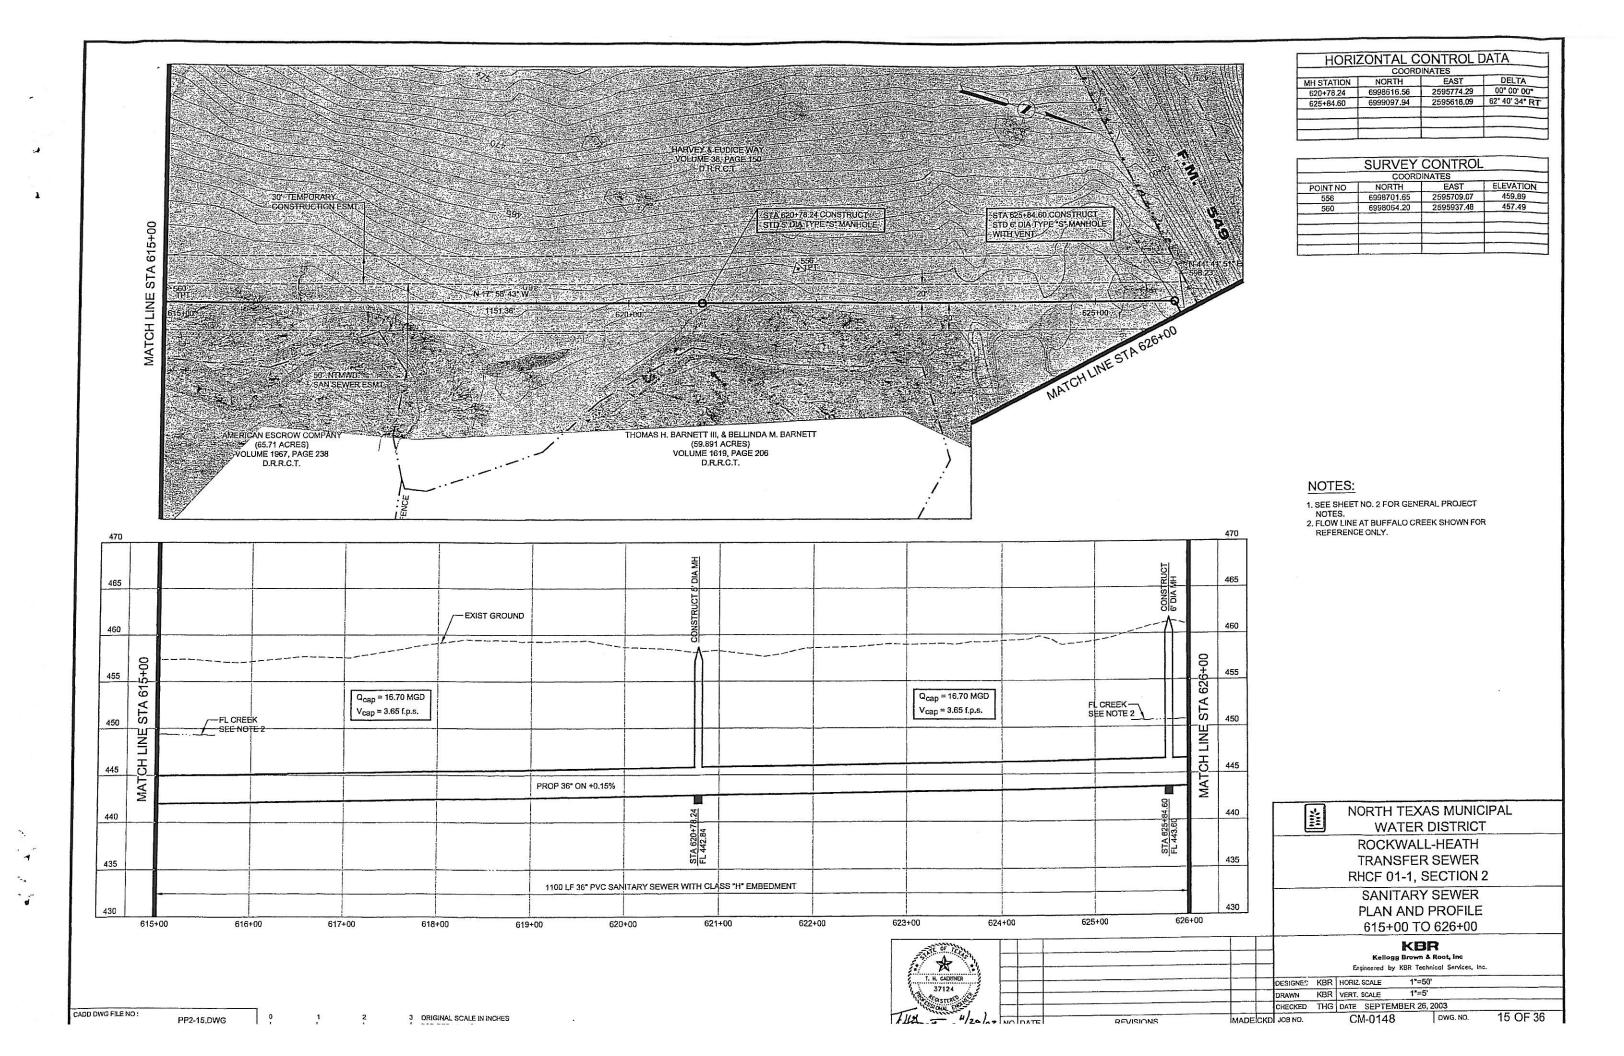


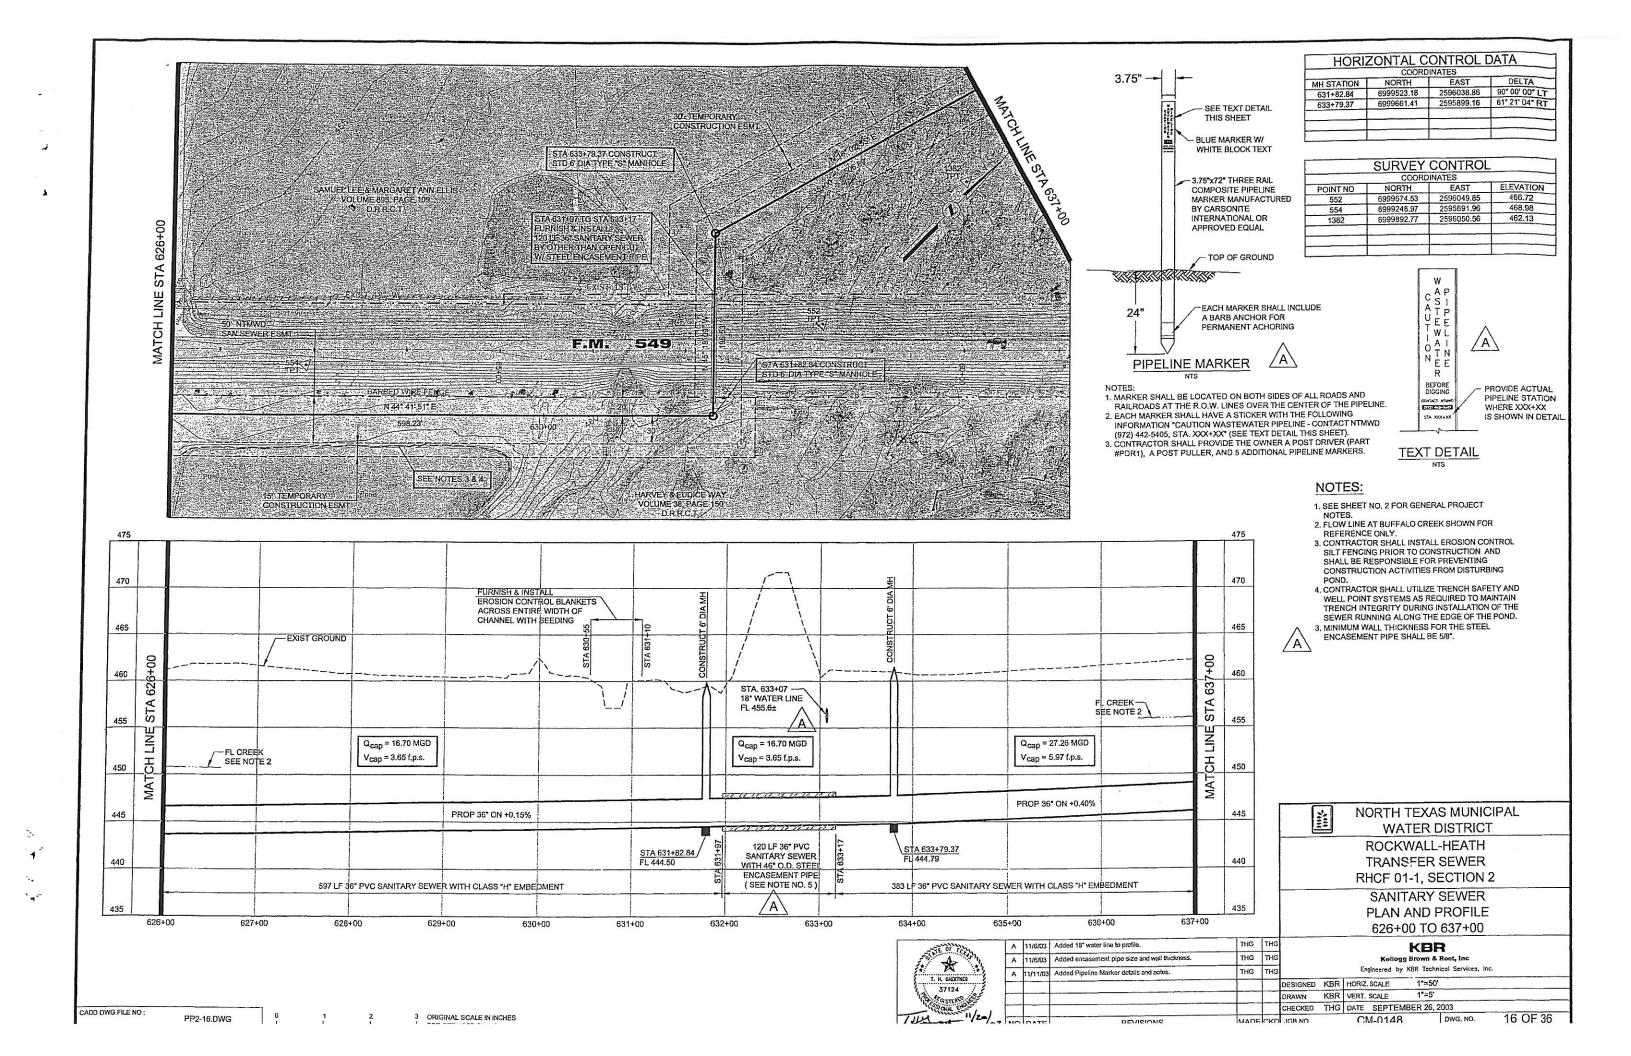


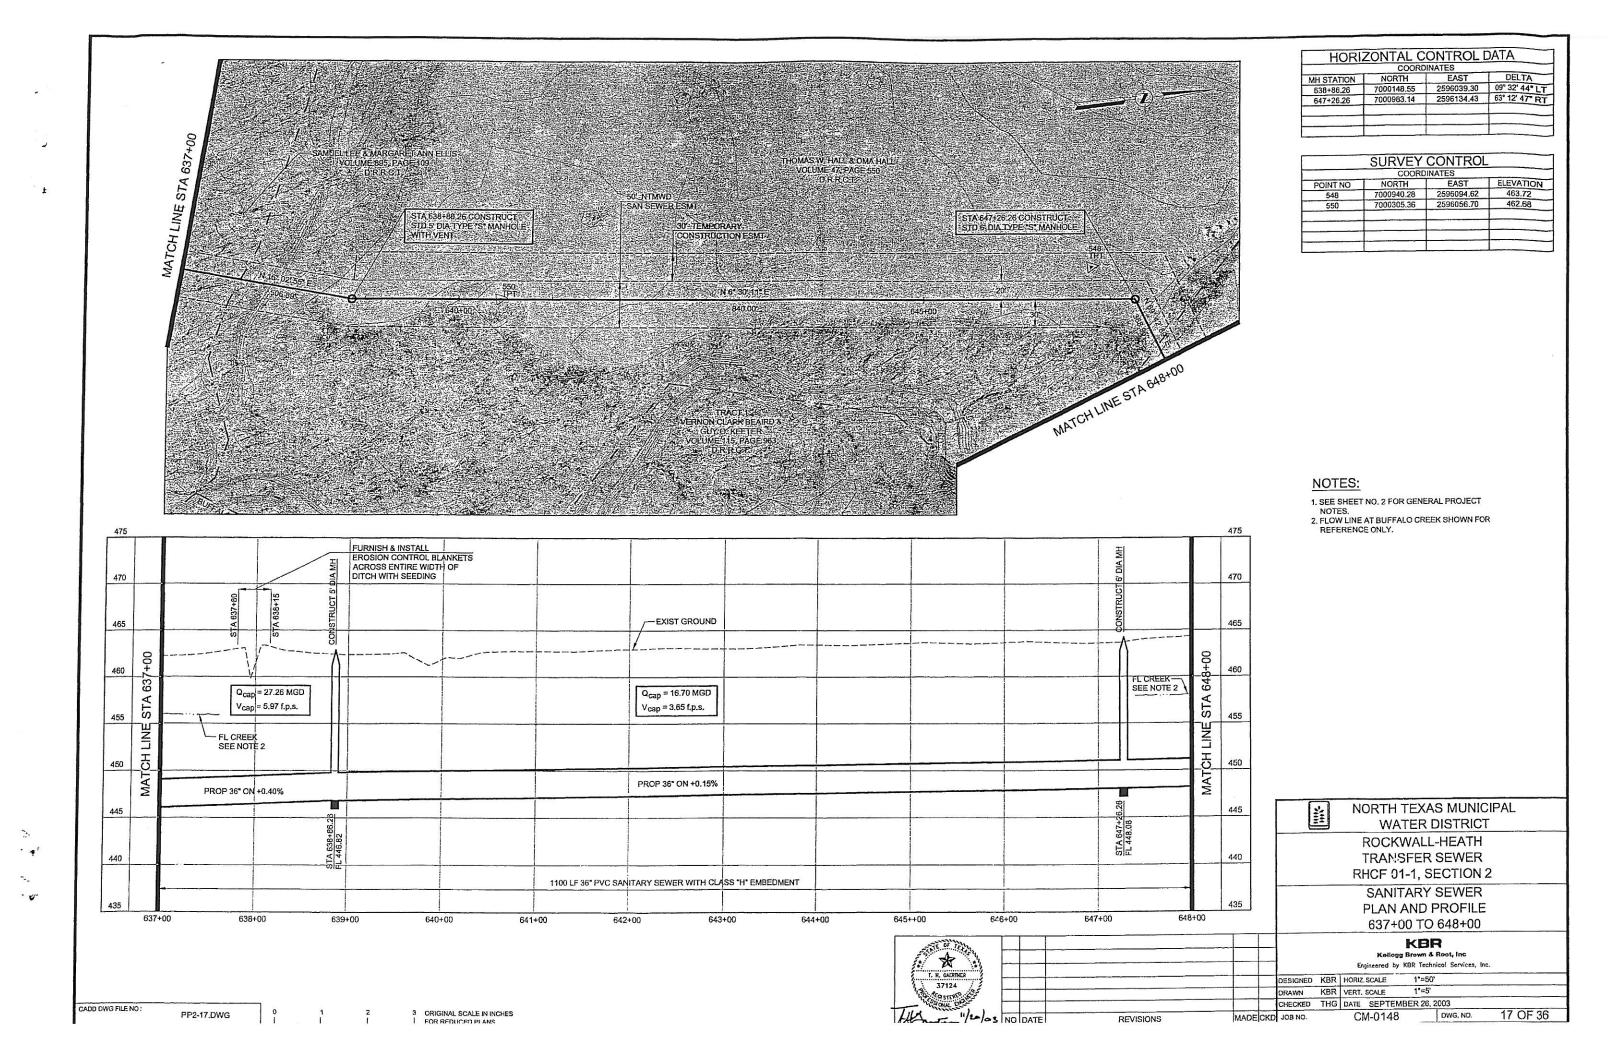


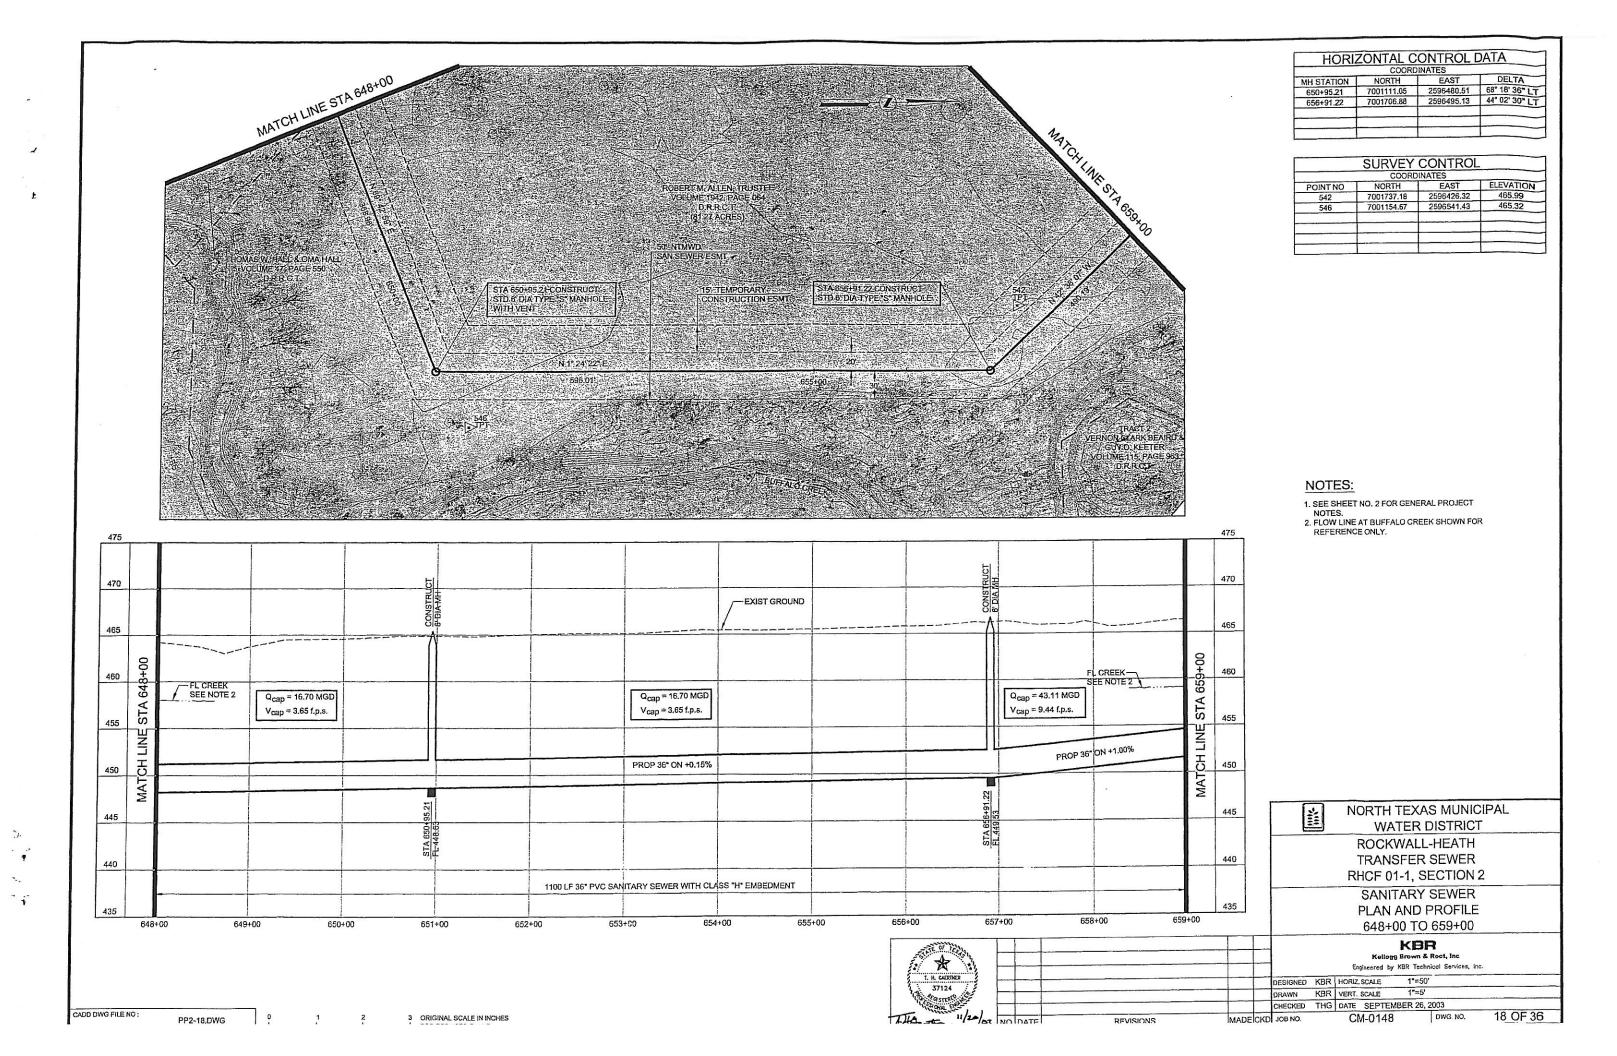


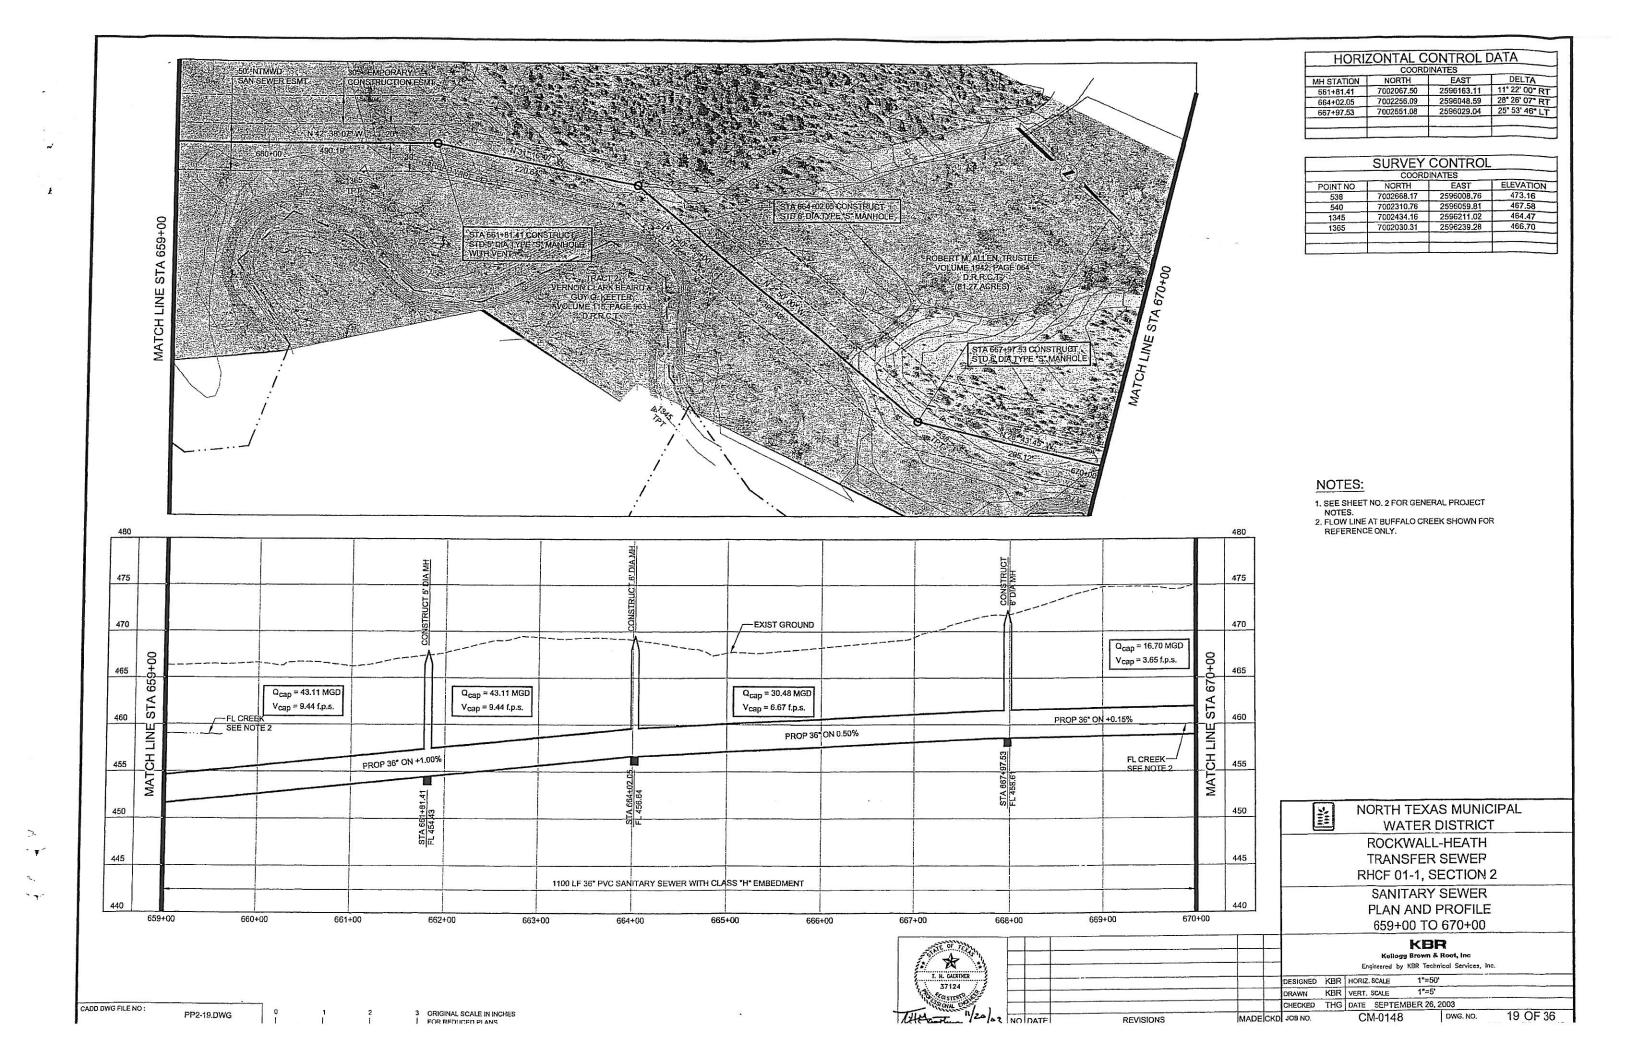

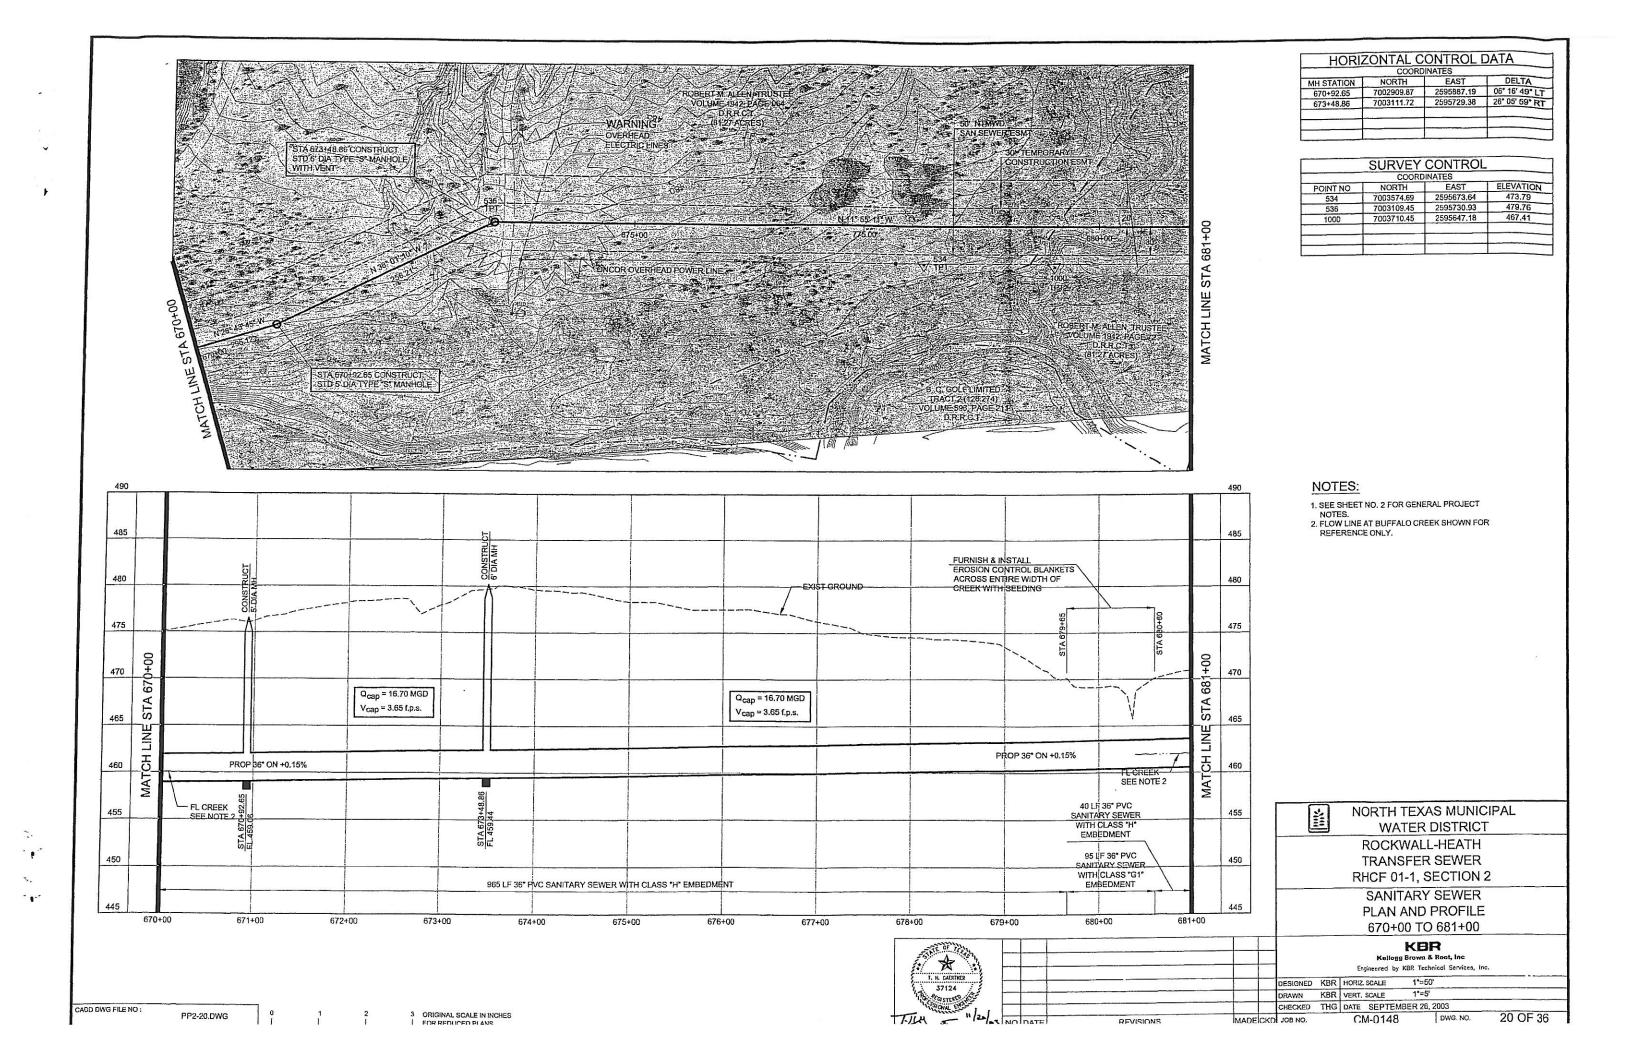

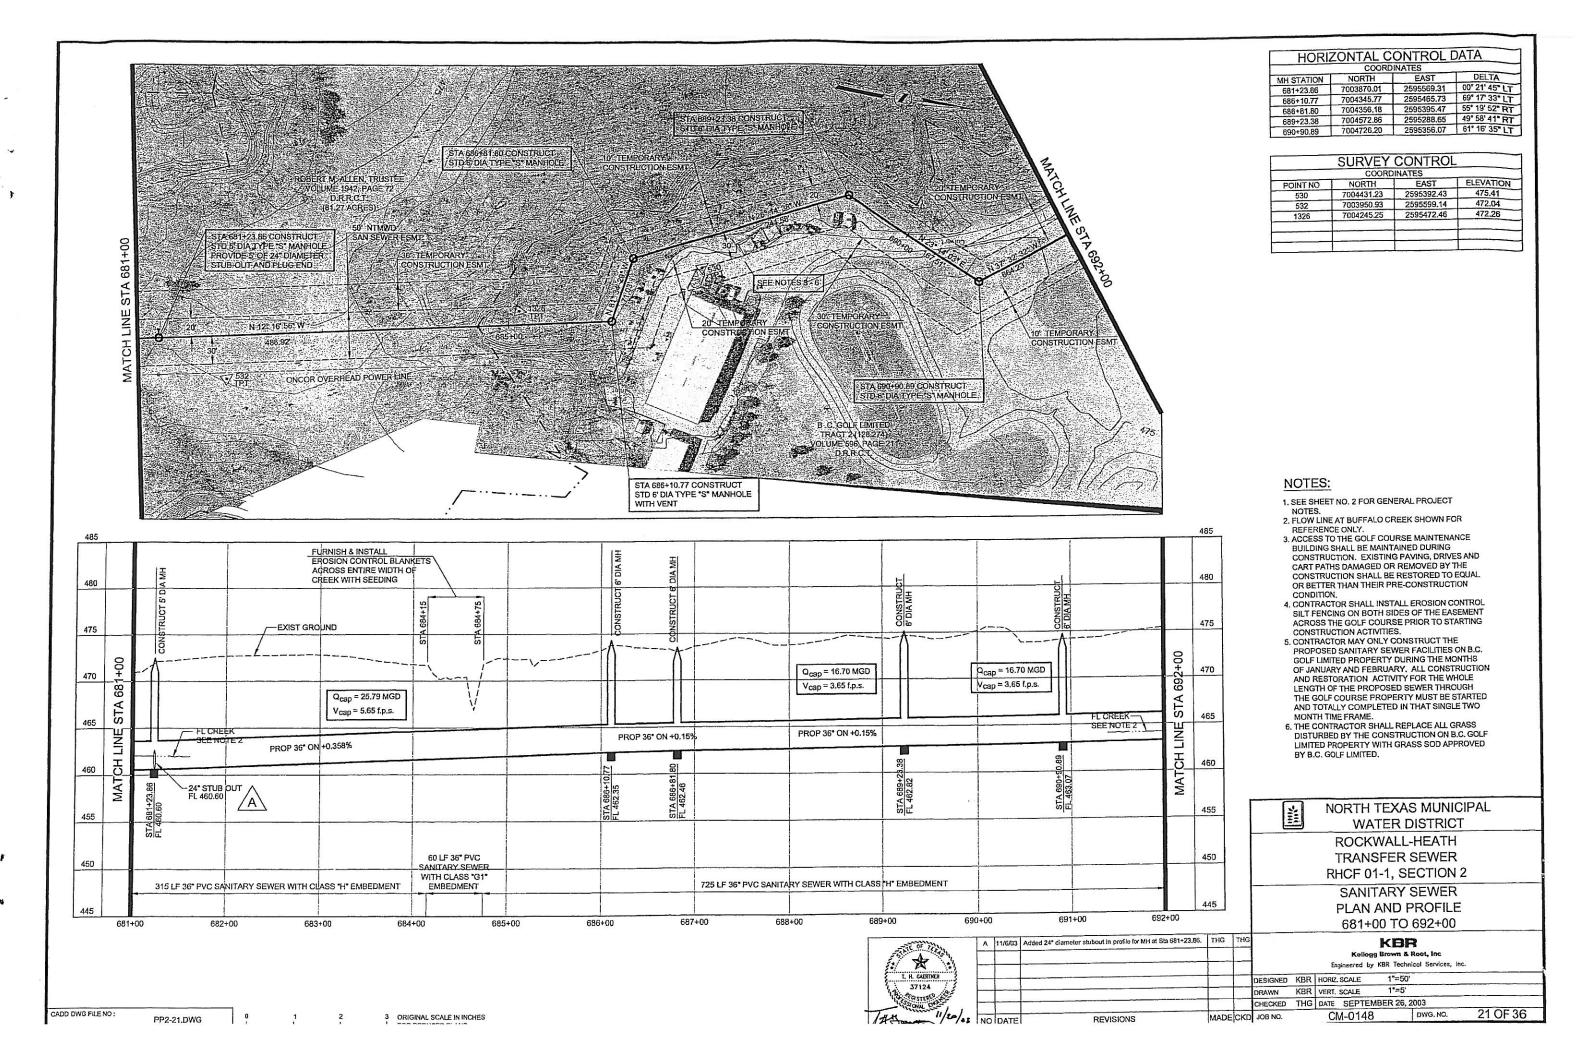


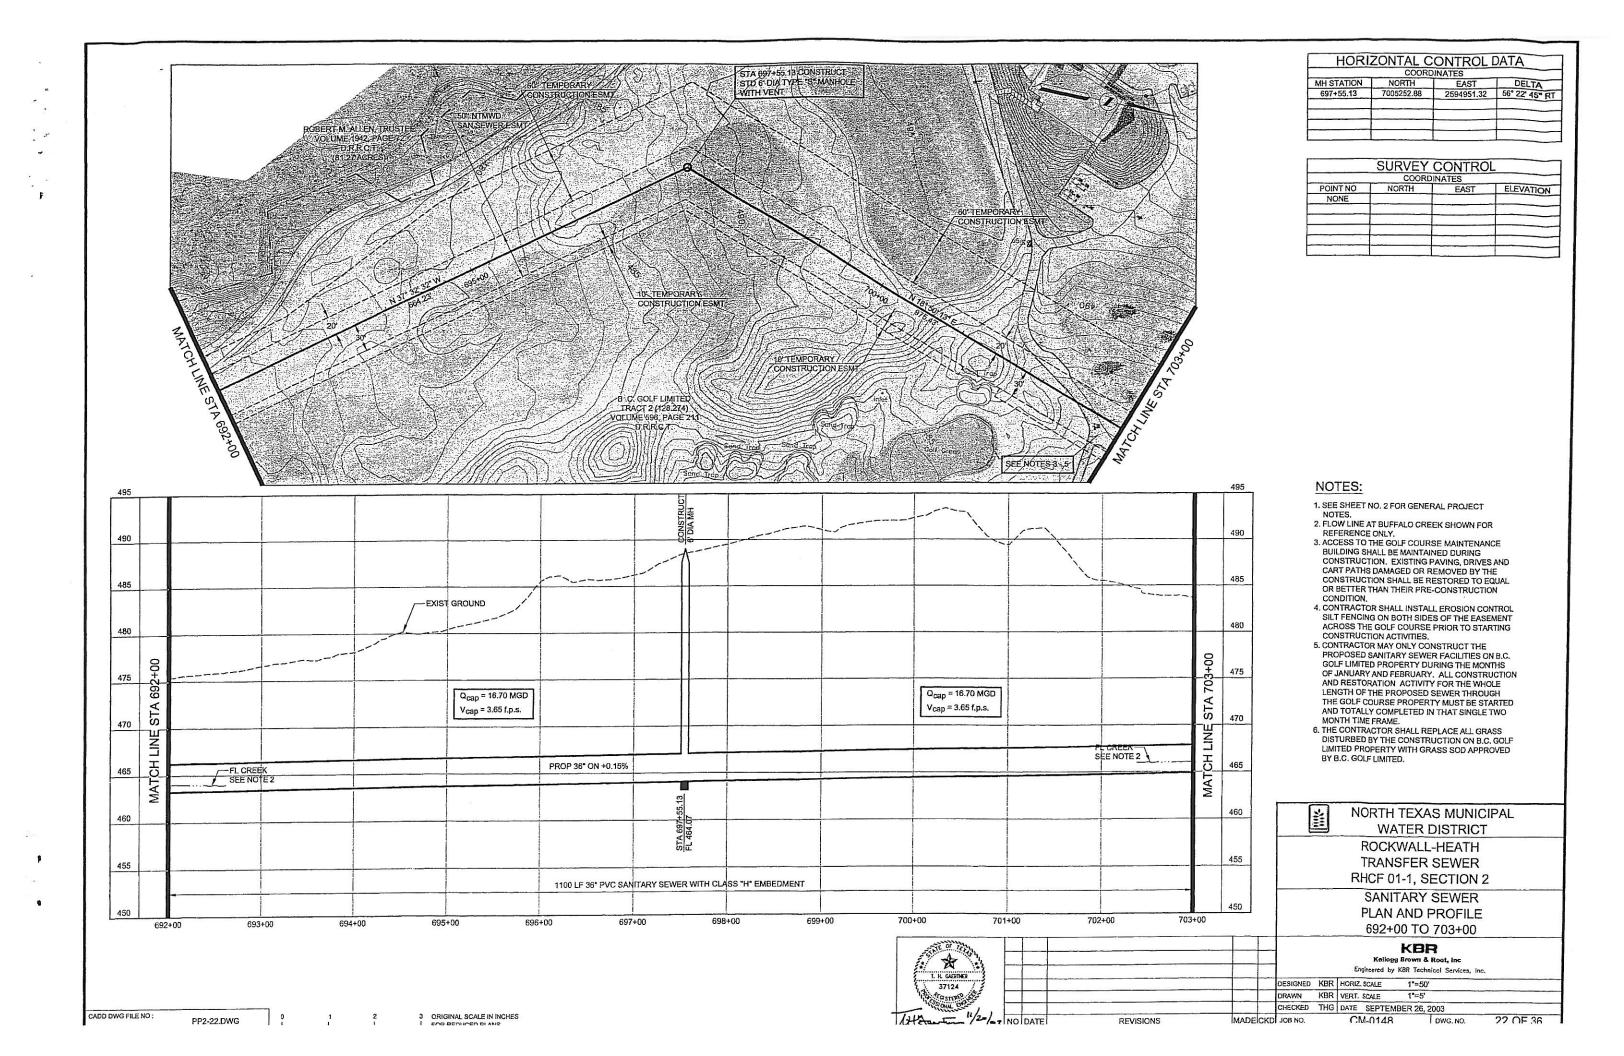

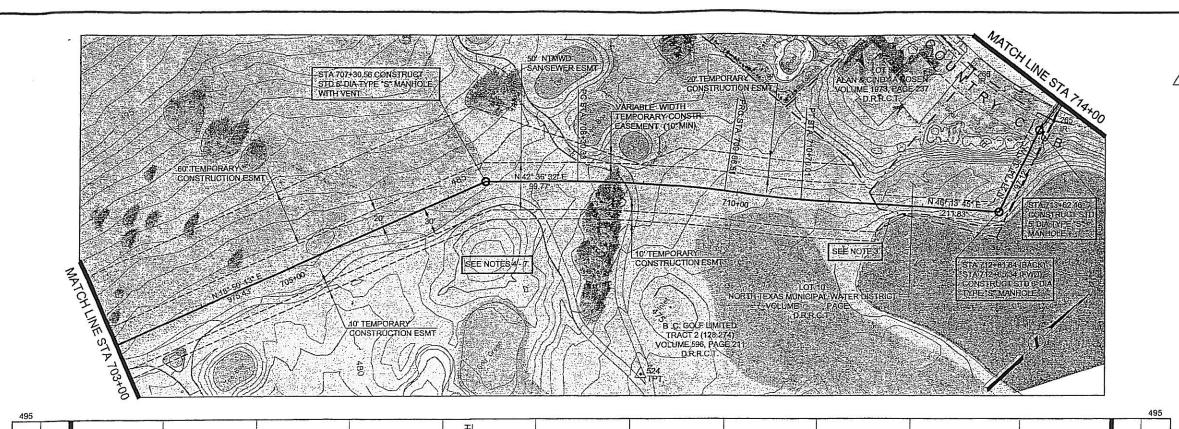

Q_{cap} = 16.70 MGD

V_{Cap} = 3.65 f.p.s.

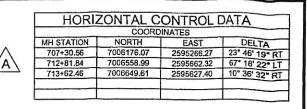

	COORD	INATES	
POINT NO	NORTH	EAST	ELEVATION
524	7006159.52	2595532.00	475.82
265 (IR)	7006668.07	2595631.21	482.88
266 (IR)	7006642,12	2595532.33	484.60
200 (111)	7000012.12	2030002.00	704.00

NOTES:

490

485

480

475

470

465

460

455

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THE THE

THG THG

MADEICKD JOB NO.

THG

714+00

STA

LINE

CH

MAT

Q_{cap} = 16.36 MGD

 $V_{cap} = 3.58 \text{ f.p.s.}$

PROP 36

ON +0.144%

REVISIONS

- 1. SEE SHEET NO. 2 FOR GENERAL PROJECT
- 2. FLOW LINE AT BUFFALO CREEK SHOWN FOR REFERENCE ONLY.
- 3. CONTRACTOR SHALL INSTALL EROSION CONTROL SILT FENCING PRIOR TO CONSTRUCTION AND SHALL BE RESPONSIBLE FOR PREVENTING CONSTRUCTION ACTIVITIES FROM DISTURBING POND.
- 4. CART PATHS DAMAGED OR REMOVED BY THE CONSTRUCTION SHALL BE RESTORED TO EQUAL OR BETTER THAN THEIR PRE-CONSTRUCTION CONDITION.
- 5. CONTRACTOR SHALL INSTALL EROSION CONTROL SILT FENCING ON BOTH SIDES OF THE EASEMENT ACROSS THE GOLF COURSE PRIOR TO STARTING CONSTRUCTION ACTIVITIES.
- CONTRACTOR MAY ONLY CONSTRUCT THE PROPOSED SANITARY SEWER FACILITIES ON B.C. GOLF LIMITED PROPERTY DURING THE MONTHS OF JANUARY AND FEBRUARY. ALL CONSTRUCTION AND RESTORATION ACTIVITY FOR THE WHOLE LENGTH OF THE PROPOSED SEWER THROUGH THE GOLF COURSE PROPERTY MUST BE STARTED AND TOTALLY COMPLETED IN THAT SINGLE TWO MONTH TIME FRAME.
- 7. THE CONTRACTOR SHALL REPLACE ALL GRASS DISTURBED BY THE CONSTRUCTION ON B.C. GOLF LIMITED PROPERTY WITH GRASS SOD APPROVED BY B.C. GOLF LIMITED.



NORTH TEXAS MUNICIPAL WATER DISTRICT

ROCKWALL-HEATH TRANSFER SEWER RHCF 01-1, SECTION 2

SANITARY SEWER PLAN AND PROFILE 703+00 TO 714+00

KBR

Kellogg Brown & Root Inc Engineered by KBR Technical Services, Inc.

DWG. NO

23 OF 36

THE THE DESIGNED KBR HORIZ. SCALE 1"=50" DRAWN KBR VERT. SCALE 1"=5" CHECKED THG DATE SEPTEMBER 26, 2003

CM-0148

SEE NOTE 2 FL CREEK-465 SEE NOTE 2 MAT 460 455 252.5 LF 36" PVC SANITARY SEWER VITH 46" O.D. STEEL ENCASEMENT PIPE (SEE NOTE NO. 3 SHEET 24) 450 /A\ 1084 LF 36" PVC SANITARY SEWER WITH CLASS "H" EMBEDMENT 445 708+00 709+00 710+00 711+00 712+00 713+00 714+00 706+00 707+00 703+00 704+00 705+00 A 11/10/03 Corrected pipe length. A 11/10/03 Added manhole at 713+62.46 to Horizontal Control Data. * A 11/10/03 Corrected Horizontal Control Data A h1/10/03 Added encasement pipe size and wall thickness 37124 11/20/03 NO DATE CADD DWG FILE NO

PROP 36* ON +0.15%

3 ORIGINAL SCALE IN INCHES

Q_{cap} = 16.70 MGD

V_{cap} = 3.65 f.p.s.

EXIST GROUND

490


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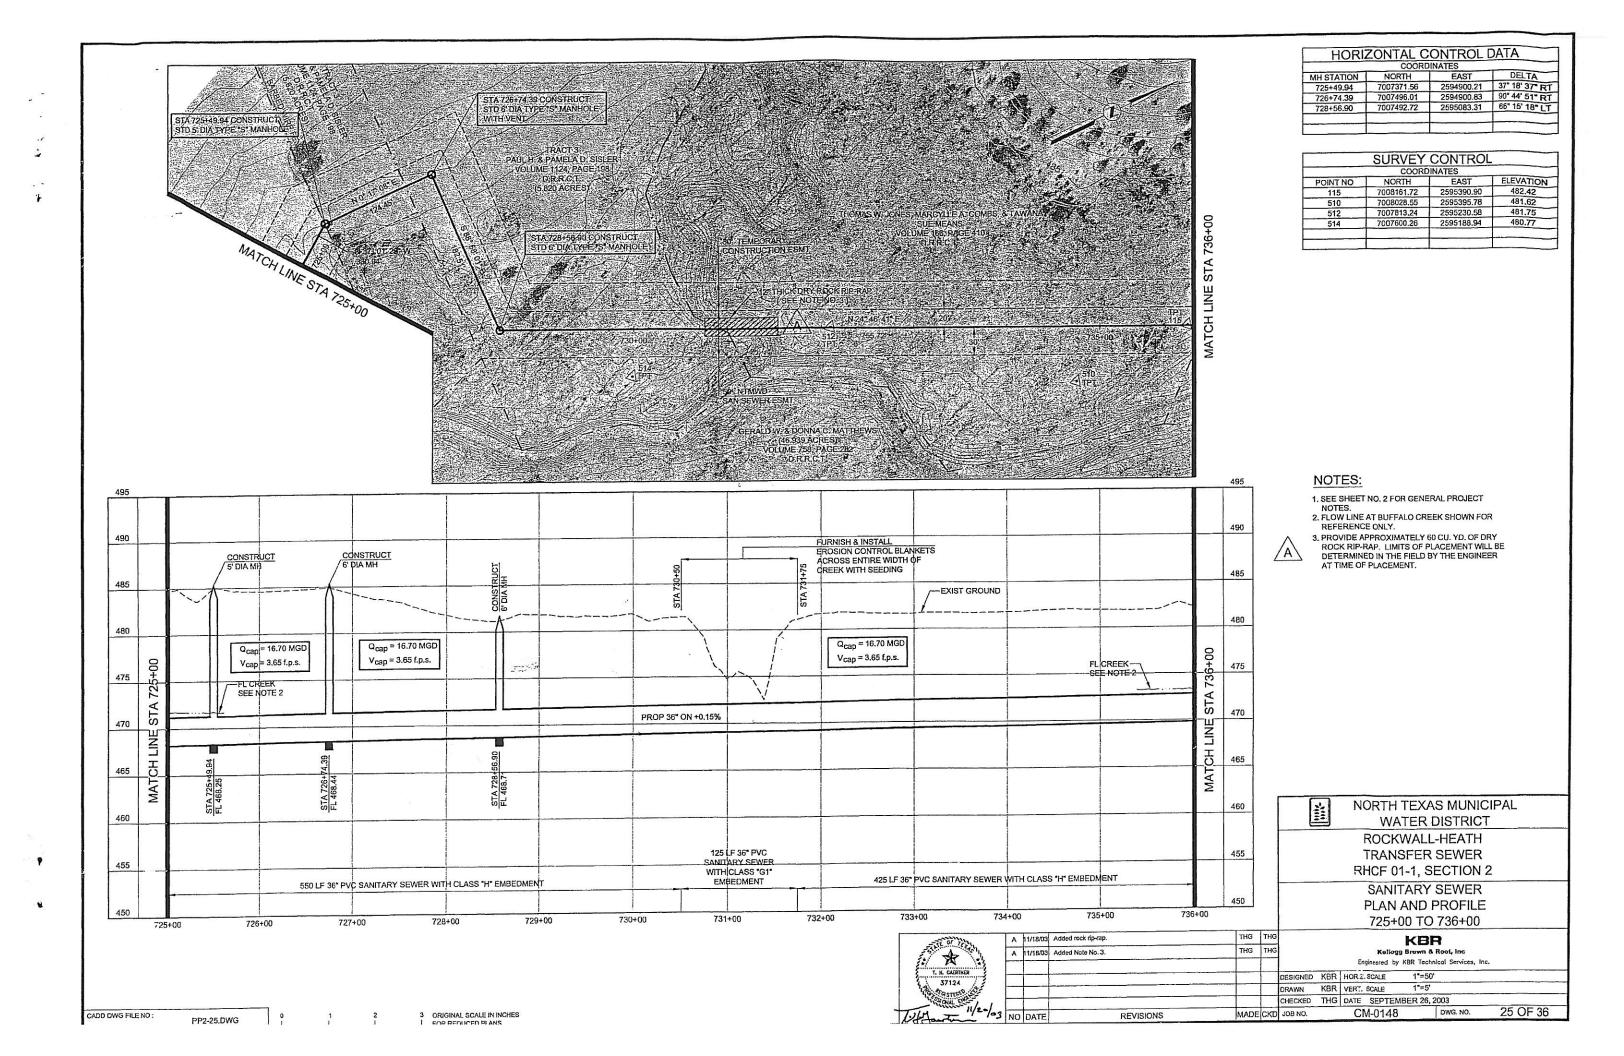
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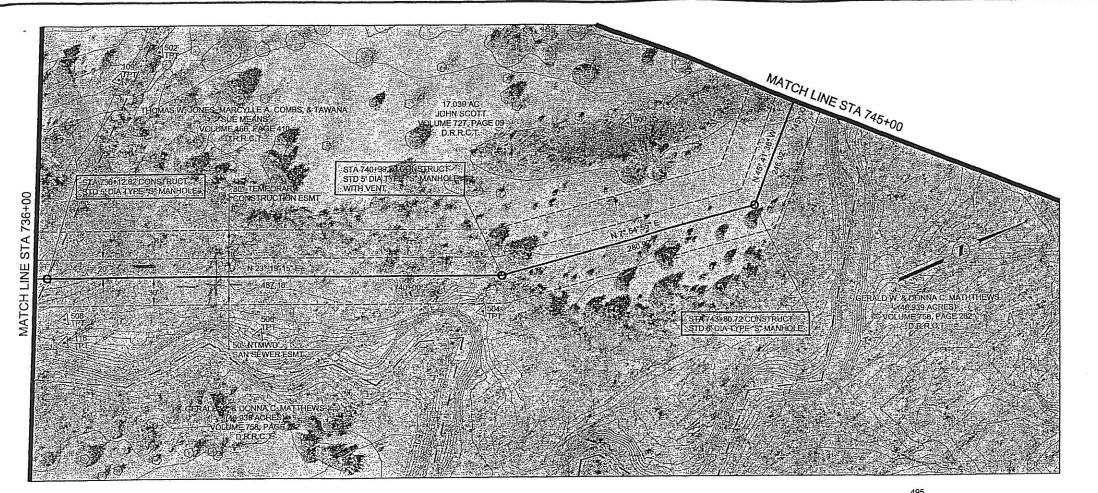
475

470

S





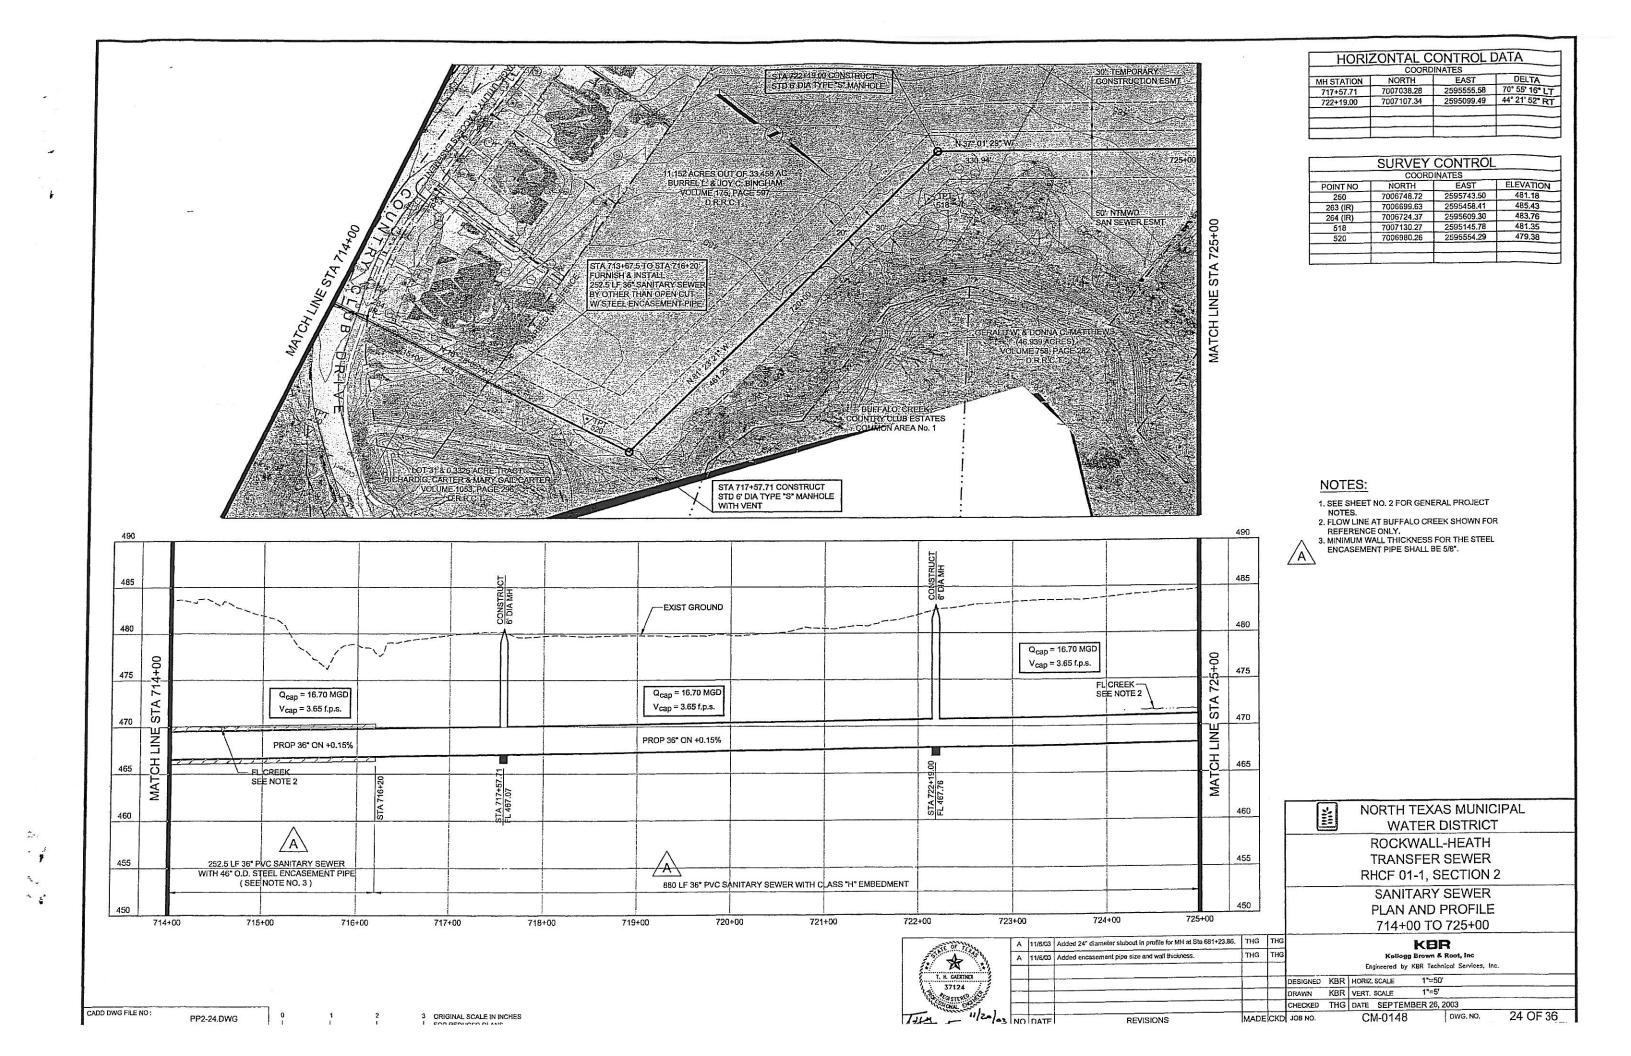

	COORD	INATES	
MH STATION	NORTH	EAST	DELTA
736+12.62	7008178.87	2595400.04	01° 27' 26" L
740+99.80	7008626.25	2595592.90	15° 24' 20" LT
743+80.72	7008904.49	2595631.59	53° 36' 31° L

	SURVEY	CONTROL						
COORDINATES								
POINT NO	NORTH	EAST	ELEVATION					
109	7008333,59	2595237.28	486.39					
118	7008169.16	2595470.66	478.59					
500	7008813.74	2595496,72	483.46					
502	7008385.11	2595227.84	485.92					
504	7008592.10	2595619.60	482.01					
506	7008363.03	2595547.91	479.50					
508	7008179.12	2595447.56	481.48					

NOTES:

- SEE SHEET NO. 2 FOR GENERAL PROJECT NOTES.
 FLOW LINE AT BUFFALO CREEK SHOWN FOR REFERENCE ONLY.

90		A MH			DIA MH			T 6' DIA MH			490
35		TRUCT & D	EXIST GROUND		ONSTRUCT 6			CONSTRUCT			485
30	STA 736+00	FL CREEK SEE NOTE 2	Q _{cap} = 40.9 MGD V _{cap} = 8.95 f.p.s.		98		_{cap} = 24.76 MGD _{cap} = 5.42 f.p.s. PROP 36* ON	1+0.33%		STA 745+00	480
5	MATCH LINE	34-12.62 55 55	PROP 36* ON +0.90%		STA 740+89.80 FL 474.23	Jan'a	N-XVX-X	STA 743+80.73 FL 475.16	FL CREEK—SEE NOTE 2	MATCH LINE	470
0		STA 7884-12 FL 469-85							4		460
				900 LF 36" PVC SAN TA	ARY SEWER WITH CLASS "H"	EMBEDMENT 742+00	743+00		4+00 74	5+00	455


1 2 3 ORIGINAL SCALE IN INCHES
. | FOR REDUCED PLANS


CADD DWG FILE NO:

NORTH TEXAS MUNICIPAL WATER DISTRICT ROCKWALL-HEATH TRANSFER SEWER RHCF 01-1, SECTION 2 SANITARY SEWER

PLAN AND PROFILE 736+00 TO 745+00

KBR Kellogg Brown & Root, Inc Engineered by KBR Technical Services, Inc. DESIGNED KBR HORIZ, SCALE 1"=50" DRAWN KBR VERT. SCALE 1"=5" CHECKED THG DATE SEPTEMBER 26, 2003 CM-0148 DWG, NO. 26 OF 36 MADE CKD JOB NO. REVISIONS

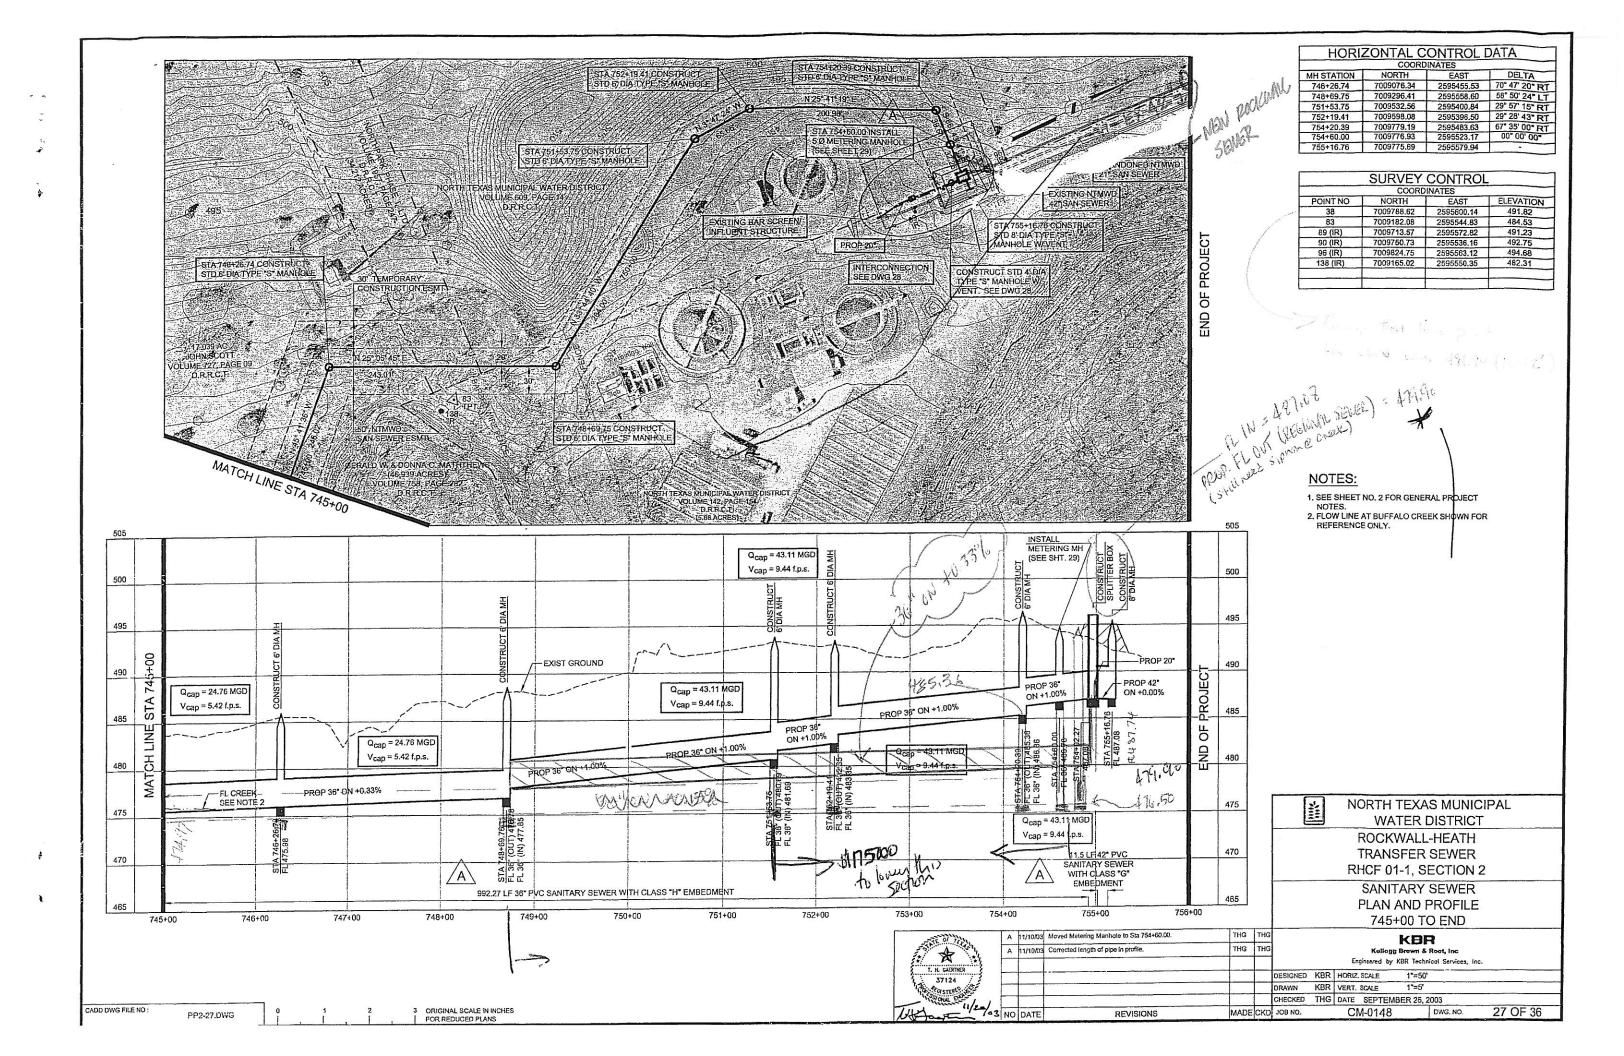

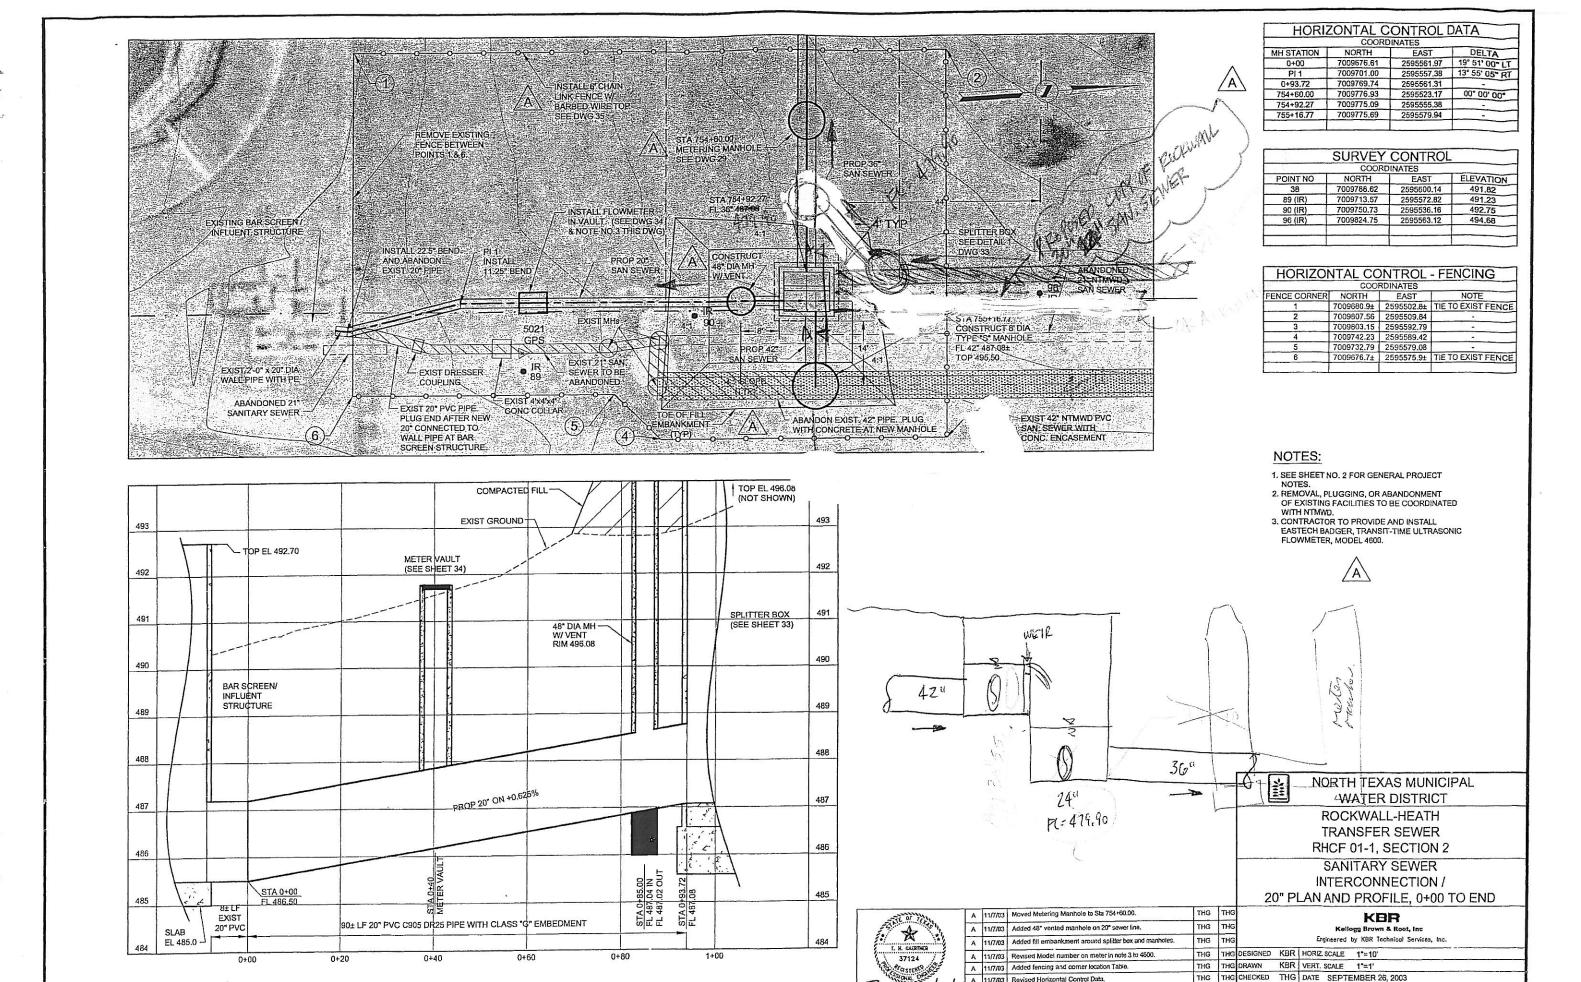

CADD DWG FILE NO :

PP2-28 DWG

ORIGINAL SCALE IN INCHES

A 11/7/03 Revised Horizontal Control Data.


REVISIONS


MADE CKD JOB NO.

CM-0148

28 OF 36

NO DATE

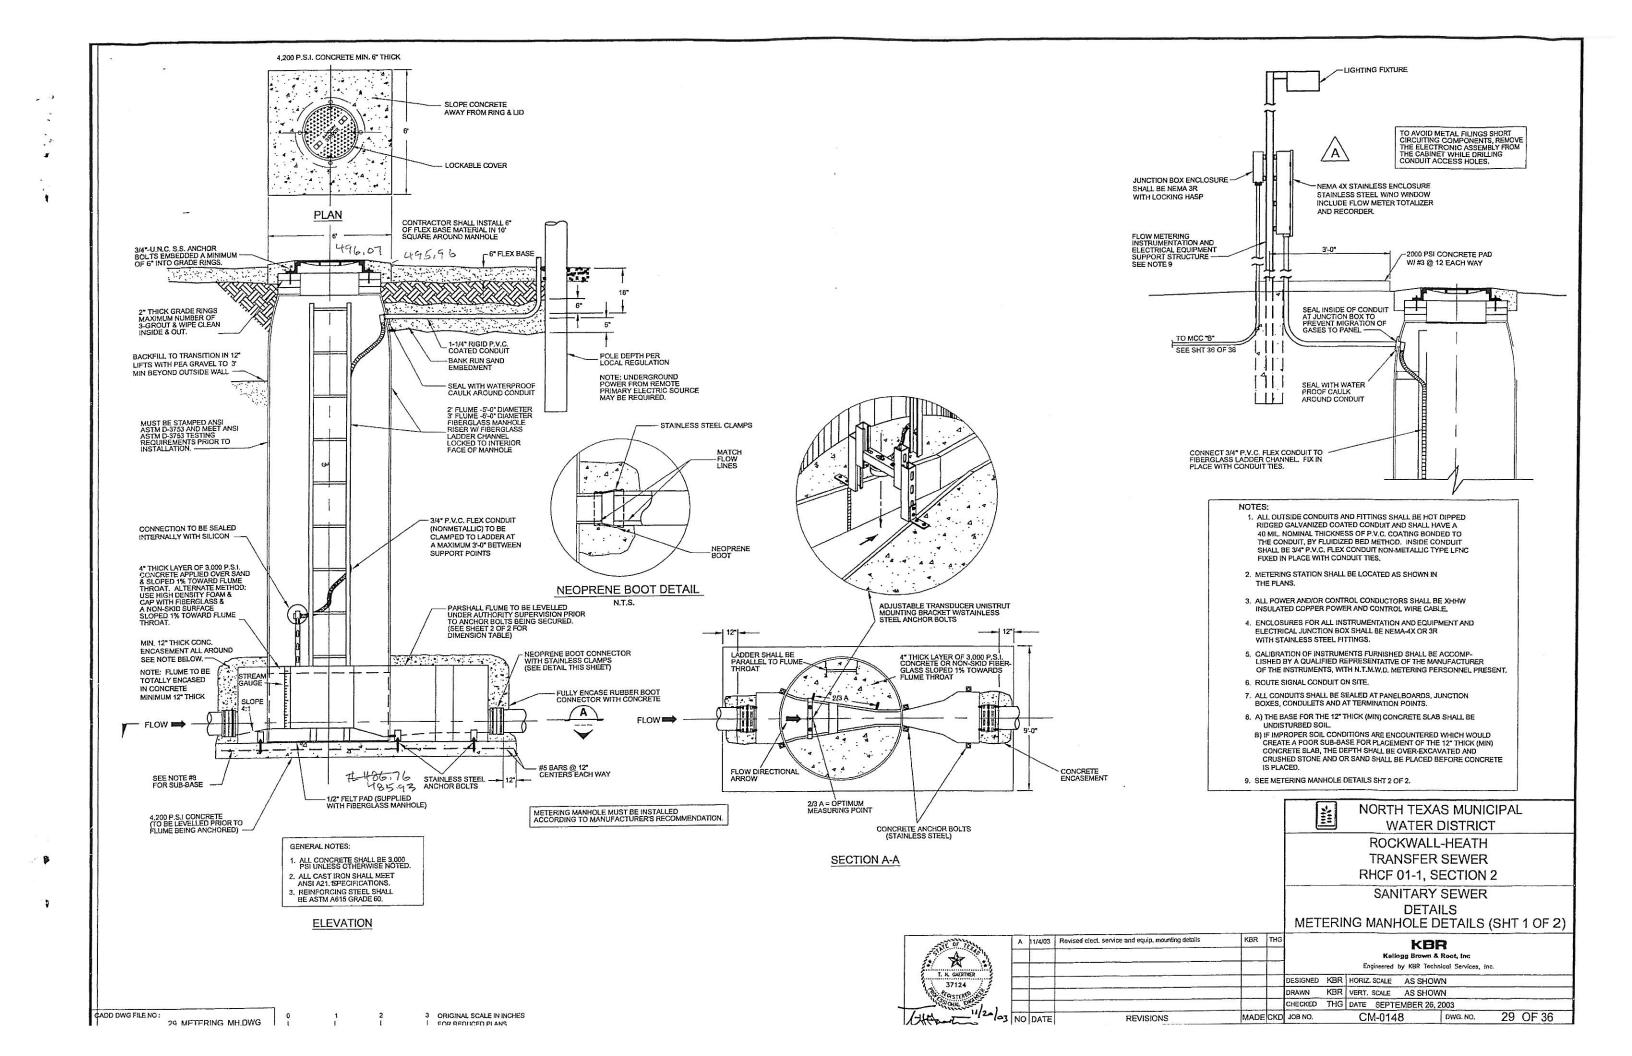


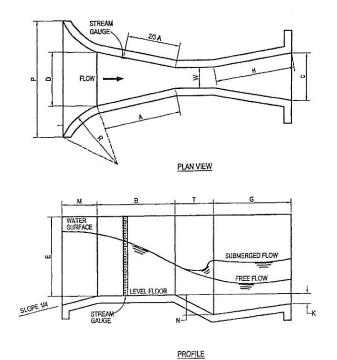


PARSHALL FLUME TABLE OF DIMENSIONS

	w	T	A	T	2/3 A		В		С		D	1	Ē		Т		G		н		K	м		N		P		₹		Х		Y
FT.	IN.	FI	IN.	FT.	IN.	FT.	IN.	FT.	INL	FT.	IN.	FT.	IN.	FT.	IN.	FT.	IN.	FT.	IN.	FT.	IN.	FT. IN.	FT.	IN.	FT.	IN.	FT.	IN.	FT.	IN.	FT.	11
	1	1	2 9/32	\top	9 17/32	1	2		3 19/32		6 19/32		9		3		8		9 3/4"		3/4			1 1/8						5/16		1
_	2	1	4 5/16	+	10 7/8	1	4		5 5/16		8 13/32		9		4 1/2		10		9 7/8"		7/8			1 11/16			_			5/8		
-	3	1	6 3/8	1	1/4	1	6		7		103/16	2			6	1		2	1		1			2 1/4						1		1
	6	2	7/16	1	4 5/16	2		1	3 1/2	1	3 5/8	2		1		2		2	3		3	1		4 1/2	2	11 1/2	1	4		2		
	9	2	10 5/8	1	11 1/8	2	10	1	3	1	10 5/8	2	6	1		1	6	2	9		3	1		4 1/2	3	6 1/2	1	4		2		
1	t	4	6	3		4	4 7/8	2		2	9 1/4	3		2		3		3	3		3	1 3		9	4	10 3/4	1	8		2		
1	6	4	9	3	2	4	7 7/8	2	6	3	4 3/B	3		2		3		3	3		3	1 3		9	5	6	1	8		2		
2	T	5		3	4	4	10 7/8	3		3	11 1/2	3		2		3		3	3		3	1 3		9	5	1	1	8		2		
3	+	5	6	3	6	5	4 3/4	4		5	1 7/8	3		2		3					3	1 3		9	7	3 1/2	1	8		2		
4	+	6		14		5	10 5/8	5		6	4 1/4	3		2		3					3	1 6		9	8	10 3/4	2			2		

**FLUME SIZE REQUIRED FOR THIS PROJECT AT STATION 750+00

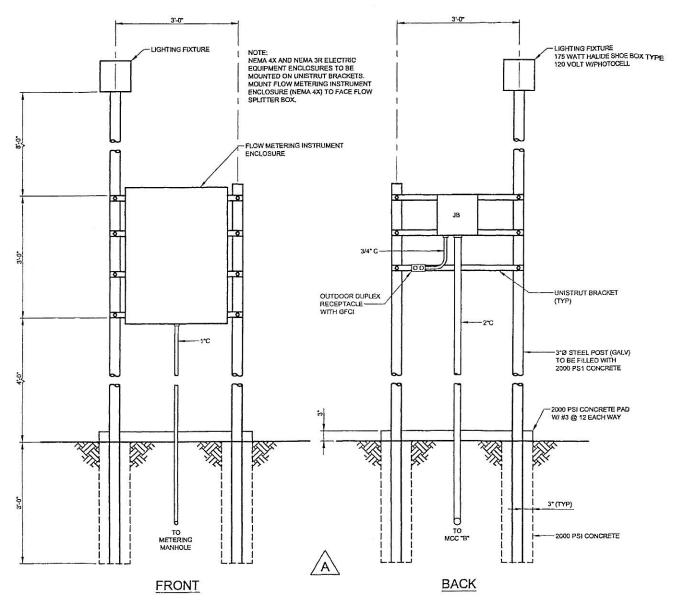


FLOW METERING INSTRUMENTATION AND ELECTRICAL EQUIPMENT SUPPORT STRUCTURE

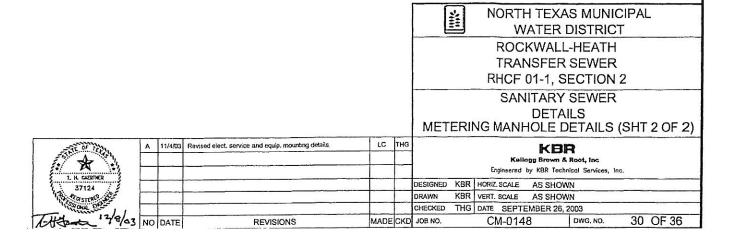


CADD DWG FILE NO:

30 MFTFRING MH.DWG

3 ORIGINAL SCALE IN INCHES I FOR REDUCED PLANS

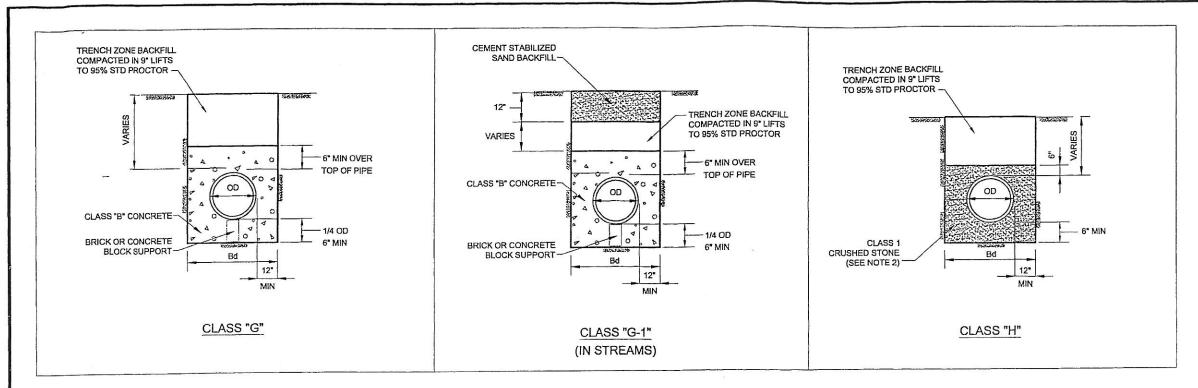

PIPE EMBEDMENT DETAILS NOT TO SCALE

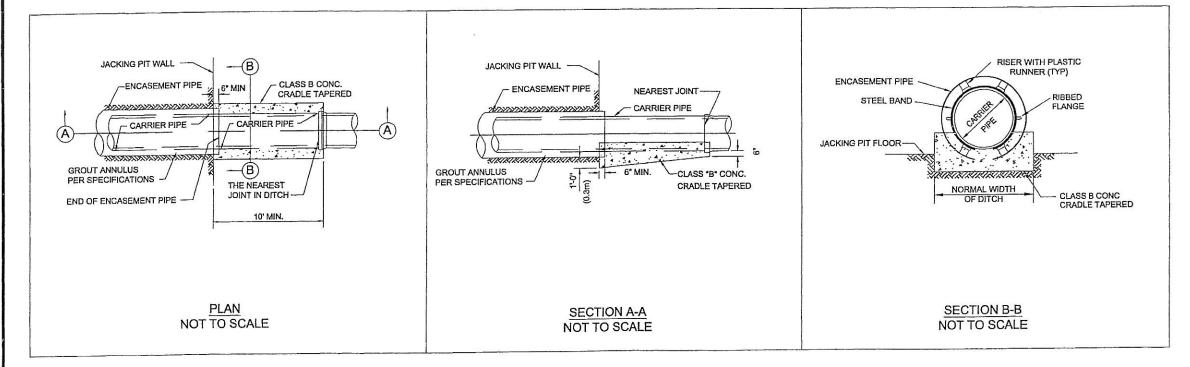

ENCASED ROAD AND RAILROAD BORE DETAILS

ENCASEMENT NOTES

EMBEDMENT NOTES:

1. Bd IS TRENCH WIDTH

2. CLASS 1 CRUSHED STONE EMBEDMENT GRADATIONS RETAINED ON 1 1/2-INCH SIEVE 0%

90 - 100% 95 - 100%

RETAINED ON 1 INCH SIEVE 0 - 5%

RETAINED ON NO. 4 SIEVE

RETAINED ON NO. 8 SIEVE

RETAINED ON 1/2 INCH SIEVE 40 - 75%

3. TRENCH ZONE BACKFILL SHALL BE NATIVE SOIL MATERIAL PRODUCED BY THE TRENCH EXCAVATION.

- 1. CONTRACTOR SHALL PROVIDE ADEQUATE SUPPORT FOR CARRIER PIPE TO ENSURE MIN. 1.5* CLEARANCE BETWEEN PIPE BELL AND ENCASEMENT PIPE.
- 2. CONTRACTOR SHALL FURNISH & INSTALL A MINIMUM OF 3 CASING SPACERS PER JOINT OF PIPE. CASING SPACERS SHALL BE INSTALLED ACCORDING TO MANUFACTURERS RECOMMENDATIONS. CASING SPACERS SHALL BE MODEL A12G-2, MANUFACTURED BY P.S.I. OR APPROVED EQUAL.

NORTH TEXAS MUNICIPAL WATER DISTRICT


ROCKWALL-HEATH TRANSFER SEWER RHCF 01-1, SECTION 2


SANITARY SEWER **DETAILS** EMBEDMENT & ENCASEMENT DETAILS

				L.,	INDEDIVERT & ENGAGENMENT DETAILS	
*					KBR Kellogg Brown & Root, Inc Engineered by KBR Technical Services, Inc.	
T. H. GAERTHER		5.00		DESIGNED	D KBR HORIZ SCALE AS SHOWN	
To france				DRAWN	KBR VERT. SCALE AS SHOWN	
is one pro-				CHECKED	THG DATE SEPTEMBER 26, 2003	-
	NO DATE	REVISIONS	MADE CK	D JOB NO.	CM-0148 DWG, NO. 31 OF 36	

CADD DWG FILE NO: 31 EMBEDRENCASE DWG


3 ORIGINAL SCALE IN INCHES

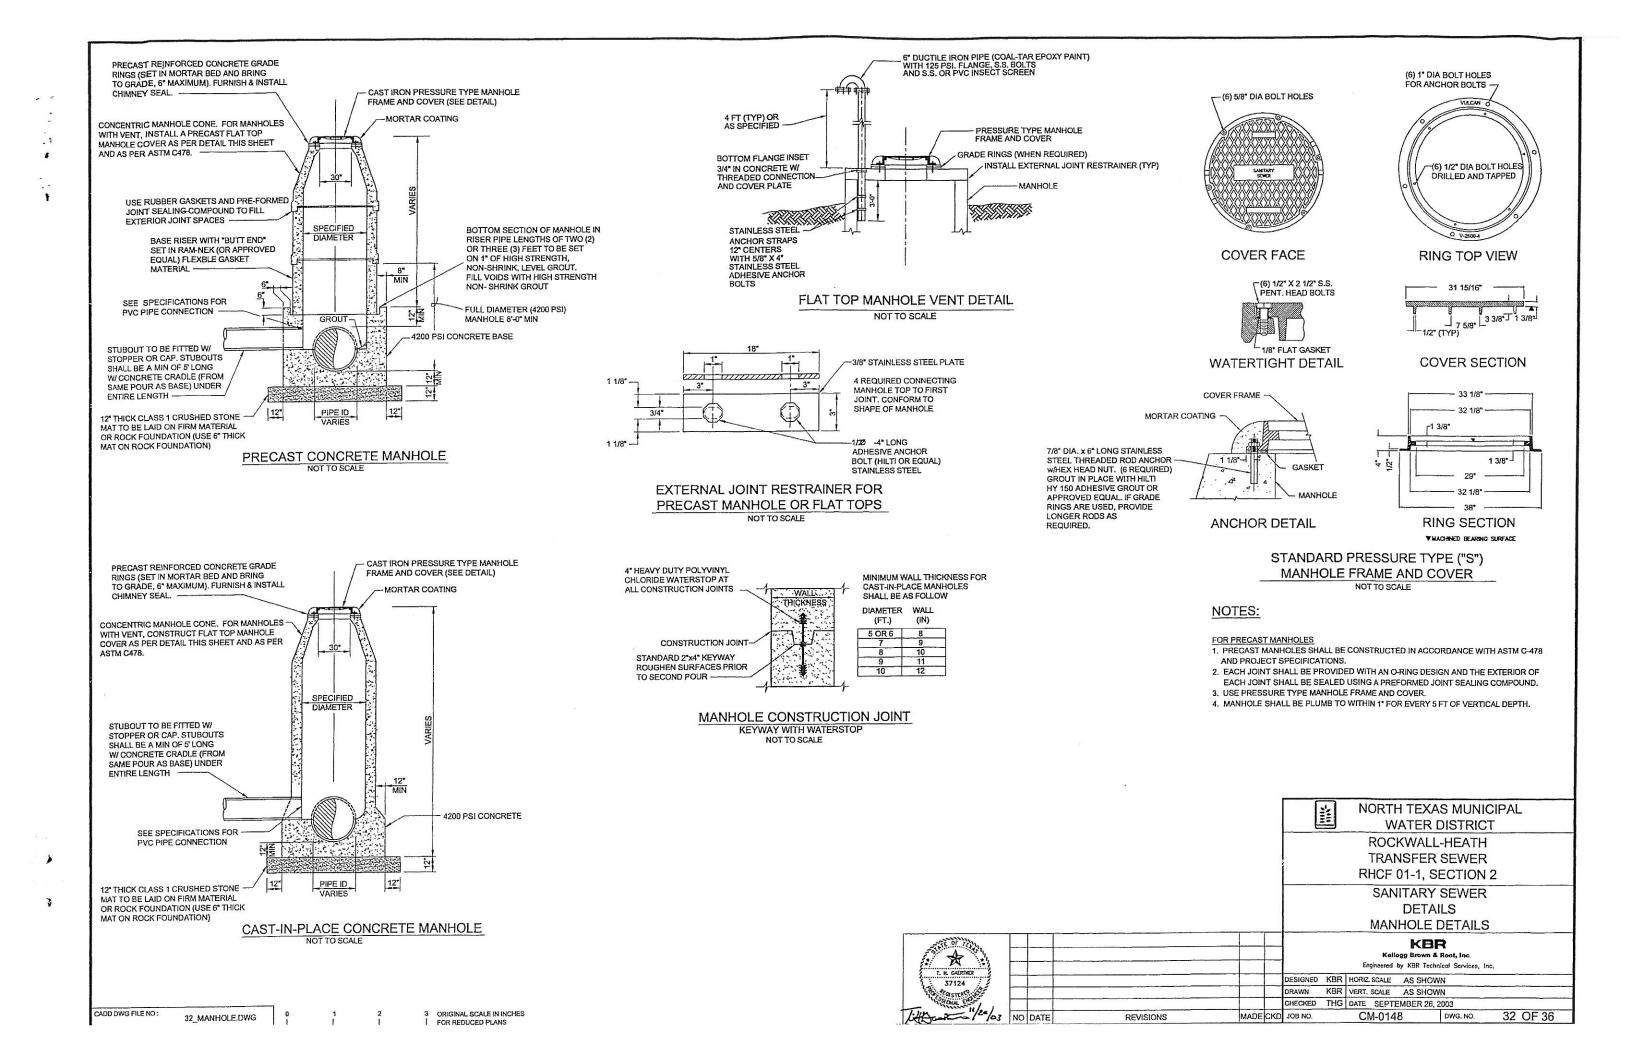


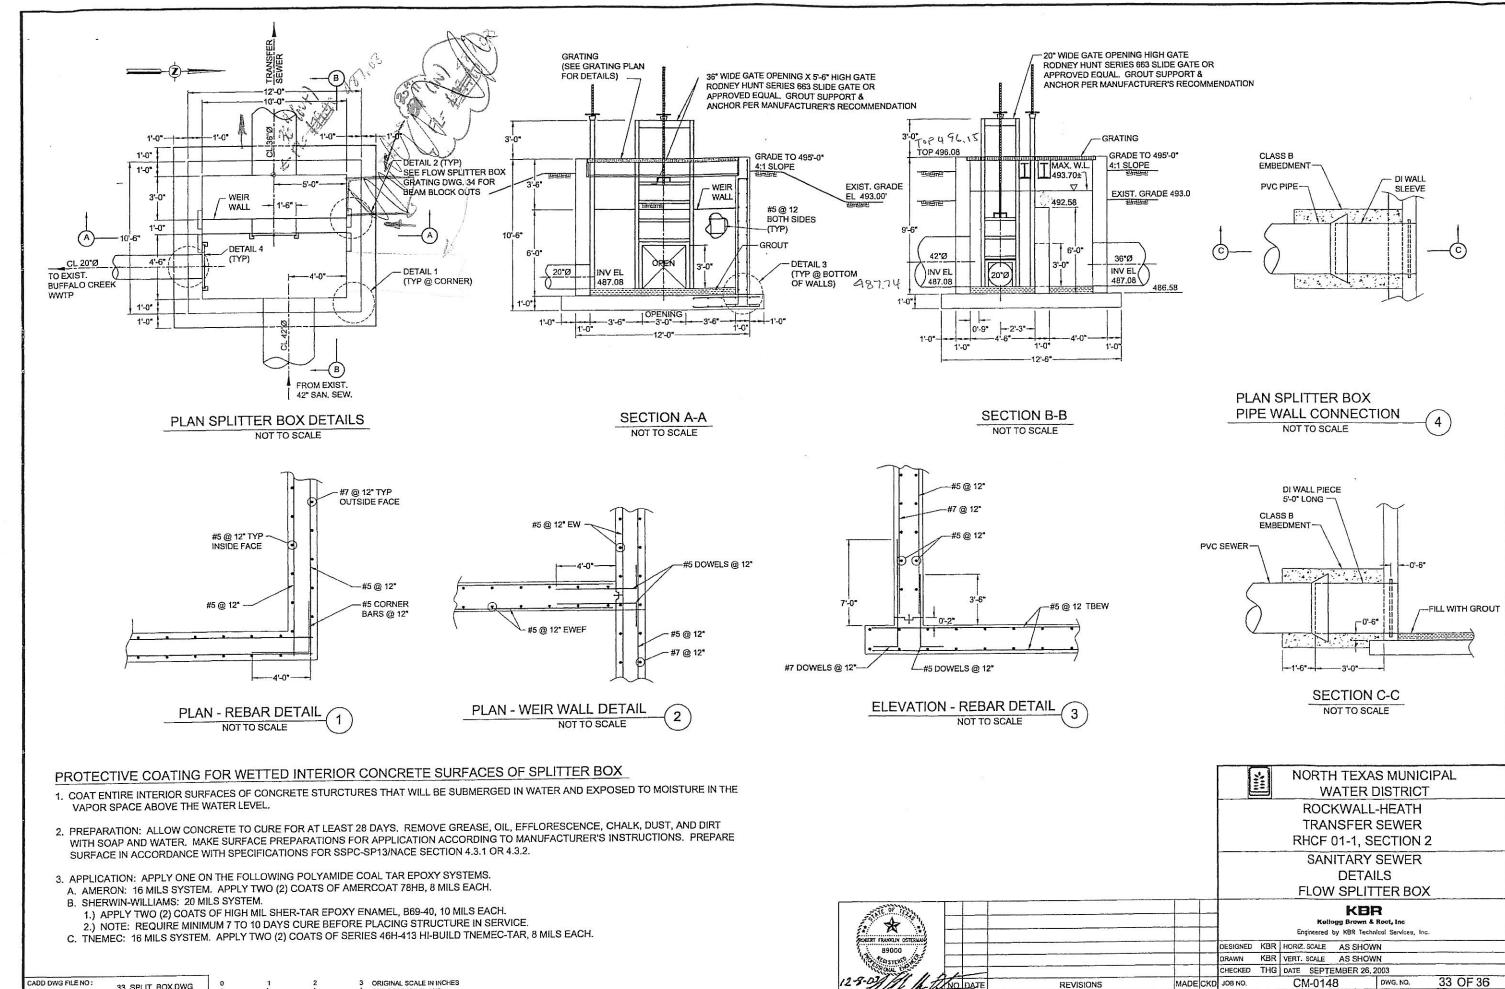


REVISIONS

CADD DWG FILE NO: ORIGINAL SCALE IN INCHES 33 SPLIT BOX.DWG

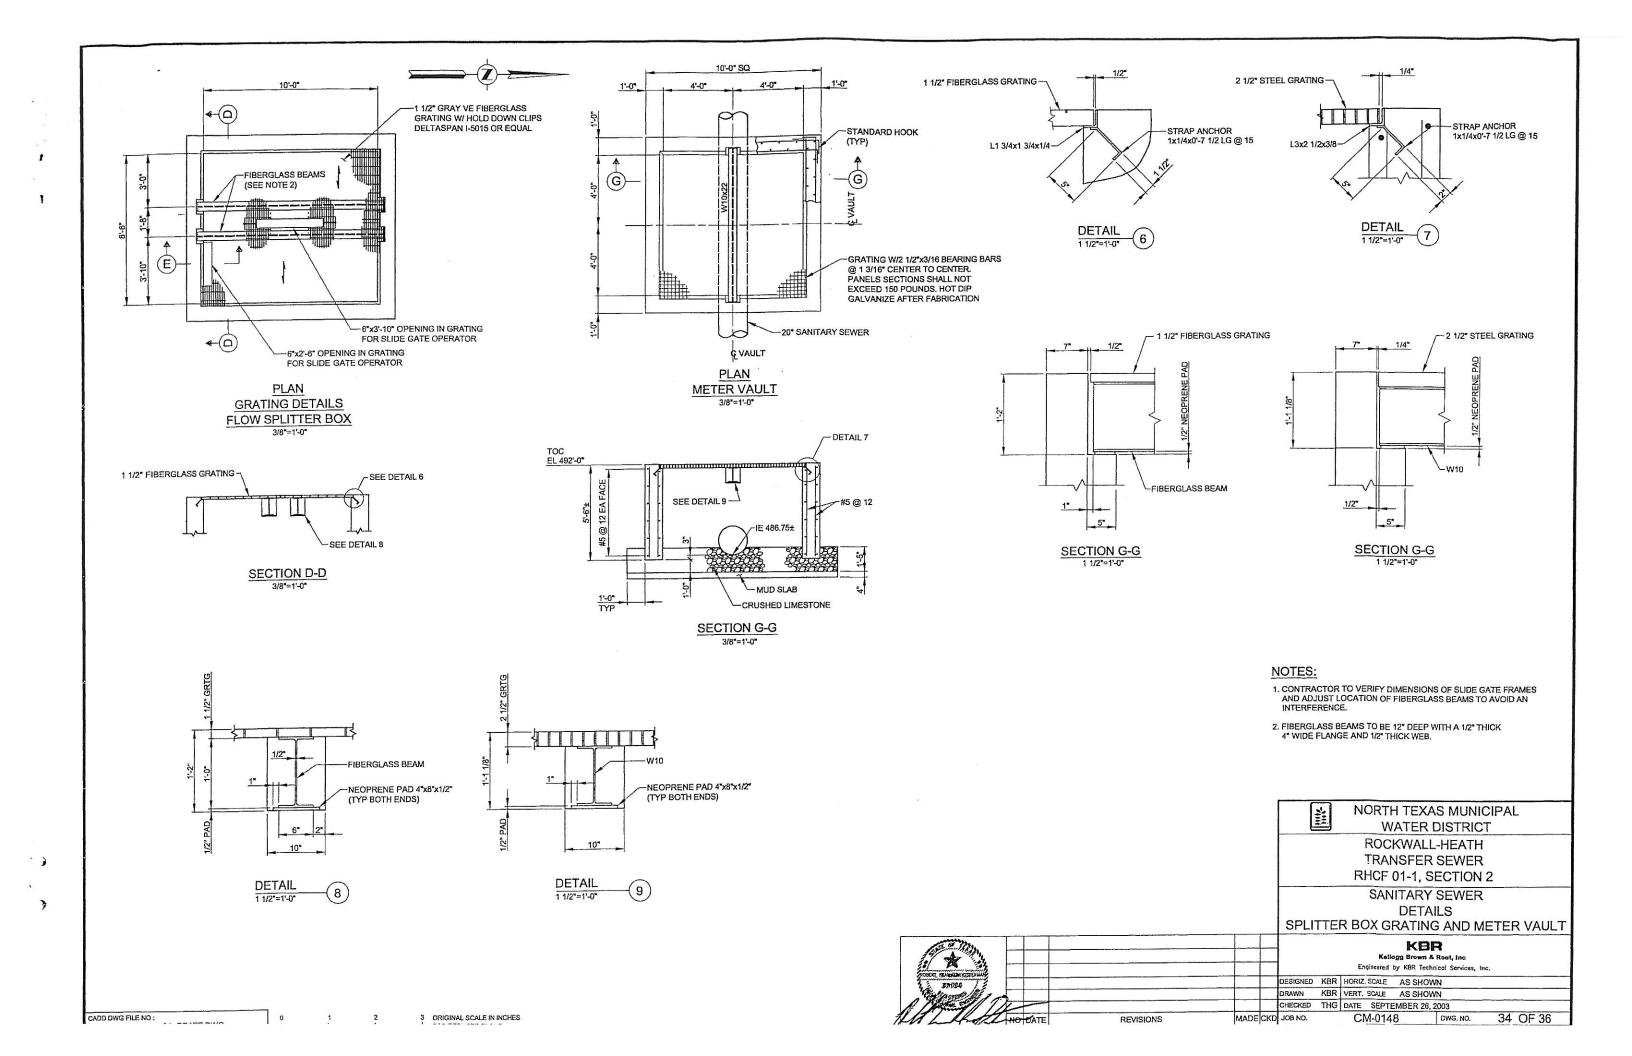

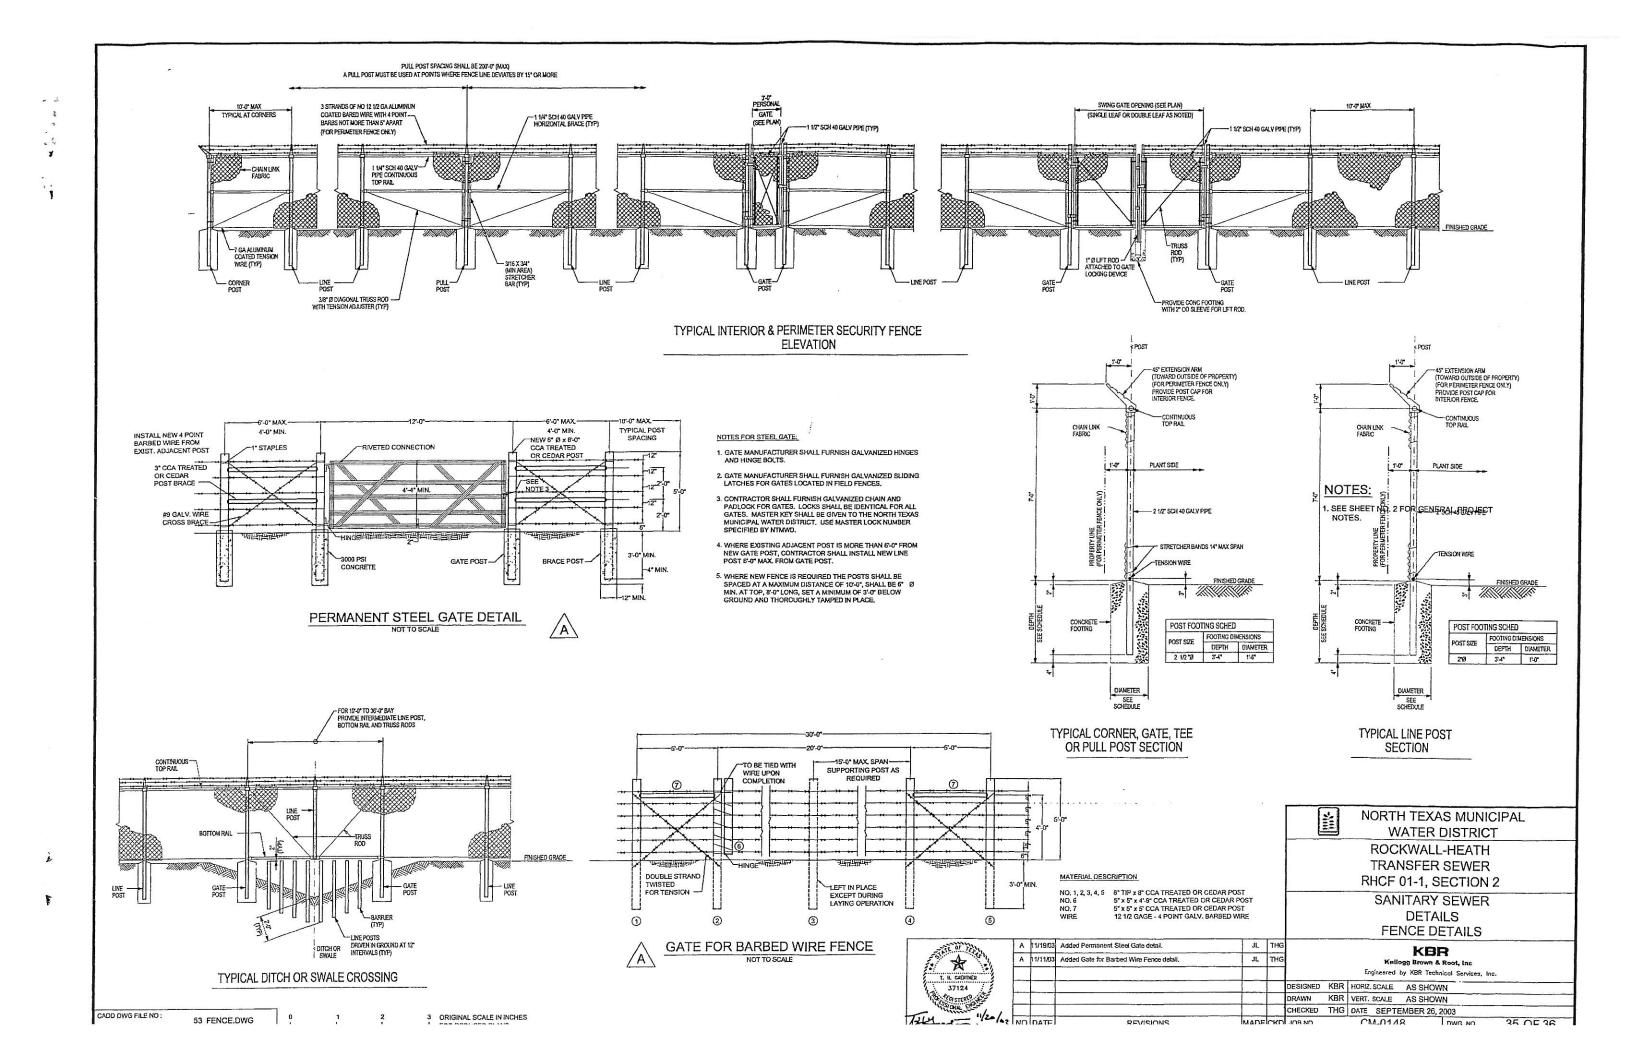

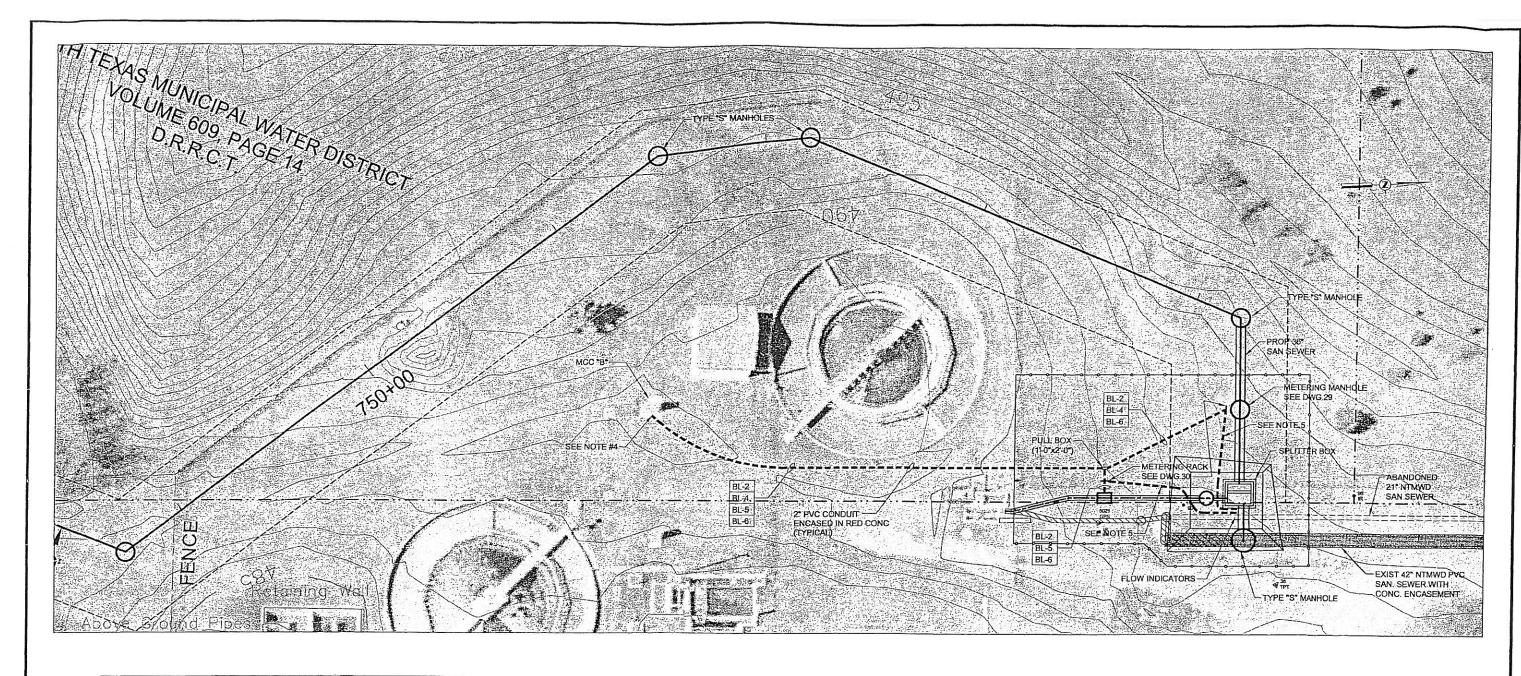

LOC	ATION:	"BL" VOLTAGE: 120/240 MCC"B" AMPS: 100 IE: MCC PHASE: 1 ING: 10KA MLO/MCB: MCB (100A)		
CKT	BRKR	LOAD SERVED	WIRE/CONDUIT	TAG
1	20/1	PORTABLE DEWATERING PUMP RECPT.	2#12, #12G., 3/4*C.	BL-1
2	20/1	METERING STATION LIGHTS	2#12, #12G., 2" DUCT	BL-2
3	20/1	FLOOD LIGHTS	2#12, #12G., 3/4"C.	BL-3
4	20/1	PHARSHALL FLUME FLOW METER	2#12, #12G., 2* DUCT	BL-4
5	20/1	ULTRA SONIC FLOW METER	2#12, #12G., 2* DUCT	BL-5
6	20/1	METERING STATION RECEPTACLES	2#12, #12G., 2* DUCT	BL-6
7	20/1	SPARE		
8	20/1	SPARE		
9	20/1	SPARE		
10	20/1	SPARE		
11	20/1	SPARE		
12	20/1	SPARE		
13	20/1	SPARE		
14	20/1	SPARE		
15	20/1	SPARE		

NOTES:

1. SEE SHEET	NO. 2 FOR GENERAL PROJECT
110770	

1. SEE SHEET NO. 2 FOR GENERAL PROJECT NOTES.
2. REMOVAL, PLUGGING, OR ABANDONMENT OF EXISTING FACILITIES TO BE COORDINATED WITH NTMWD.
3. CONTRACTOR TO PROVIDE AND INSTALL EASTECH BADGER, TRANSIT-TIME ULTRASONIC FLOWMETER, MODEL 4600.
4. CONTRACTOR TO VERIFY ANY EXSITING MCC STUB-OUTS. IF NONE ARE AVAILABLE COORDINATE WITH THE CLIENT FOR MCC ENTRY.
5. 1* PVC CONDUIT WIT TWISTED PAIR #16 AWG

5. 1" PVC CONDUIT W/1 TWISTED PAIR #16 AWG SHIELDED CABLE FROM METERING RACK TO FLOW INDICATORS AT THE SPLITTER BOX.

NORTH TEXAS MUNICIPAL WATER DISTRICT

DWG. NO.

36 OF 36

ROCKWALL-HEATH TRANSFER SEWER RHCF 01-1, SECTION 2

SANITARY SEWER INTERCONNECTION / ELECTRICAL

KBR * Kollogg Brown & Root, Inc. Engineered by KBR Technical Services, Inc. T. H. GAERTHER DESIGNED KBR HORIZ. SCALE 1"=40" 37124 DRAWN KBR VERT. SCALE CHECKED THG DATE SEPTEMBER 26, 2003 12/8/03 NO DATE REVISIONS CM-0148

CADD DWG FILE NO:

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