
ROCKWALL URBAN + INDUSTRIAL CENTER

ALPHA DRIVE CITY OF ROCKWALL, TEXAS

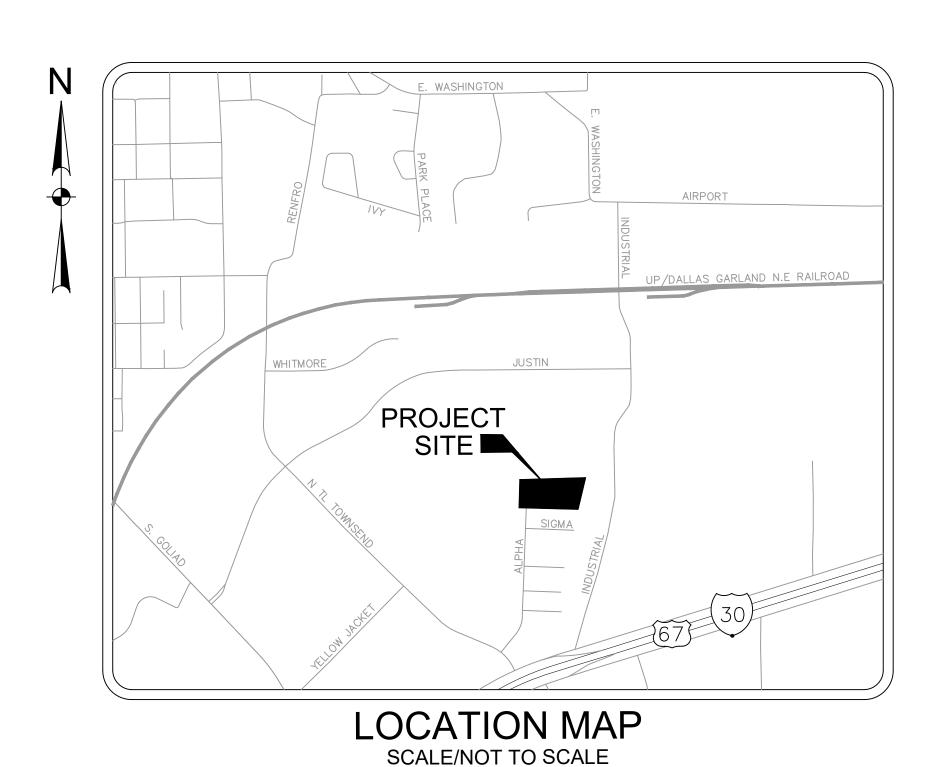

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C1.01	PAVING & DIMENSIONAL CONTROL PLAN
C1.02	PAVING DETAILS
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C2.01	GRADING PLAN
C3.01	EXISTING DRAINAGE AREA MAP
C3.02	PROPOSED DRAINAGE AREA MAP
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OWNER/DEVELOPER

LONG BOW INTERESTS 13150 COIT ROAD DALLAS, TX. 75240 CONTACT: REID CALDWELL EMAIL: reid@longbowinterests.com TEL: (214) 457-8198

ENGINEER

HALFF ASSOCIATES, INC. 1201 NORTH BOWSER ROAD RICHARDSON, TX. 75081 CONTACT: DYLAN HEDRICK EMAIL: dhedrick@halff.com TEL: (214) 217-6426 TBPE FIRM# F-312



(214) 346-6200

AVO: 35989.002 DATE: MARCH 2020


RECORD DRAWING


NOVEMBER 24, 2020

THESE RECORD DRAWINGS HAVE BEEN PREPARED BASED ON FIELD OBSERVATIONS AND INFORMATION PROVIDED BY THE CONTRACTOR. ELEVATIONS HAVE NOT BEEN FIELD VERIFIED. THE ORIGINAL SEALED CONSTRUCTION DRAWINGS ARE ON FILE AT THE OFFICES OF HALFF ASSOCIATES, INC. TBPE FIRM F-312.

ENGINEER OF RECORD DYLAN B. HEDRICK HALFF ASSOCIATES, INC. TBPE FIRM F-312 DATE: NOVEMBER 24, 2020


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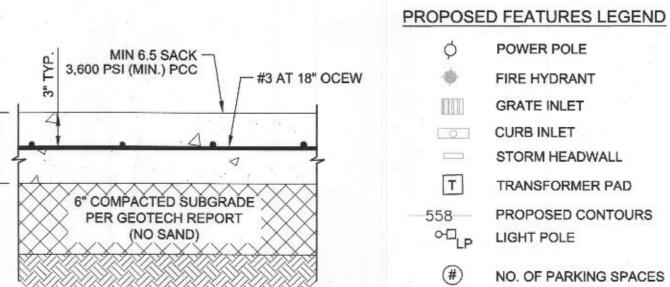


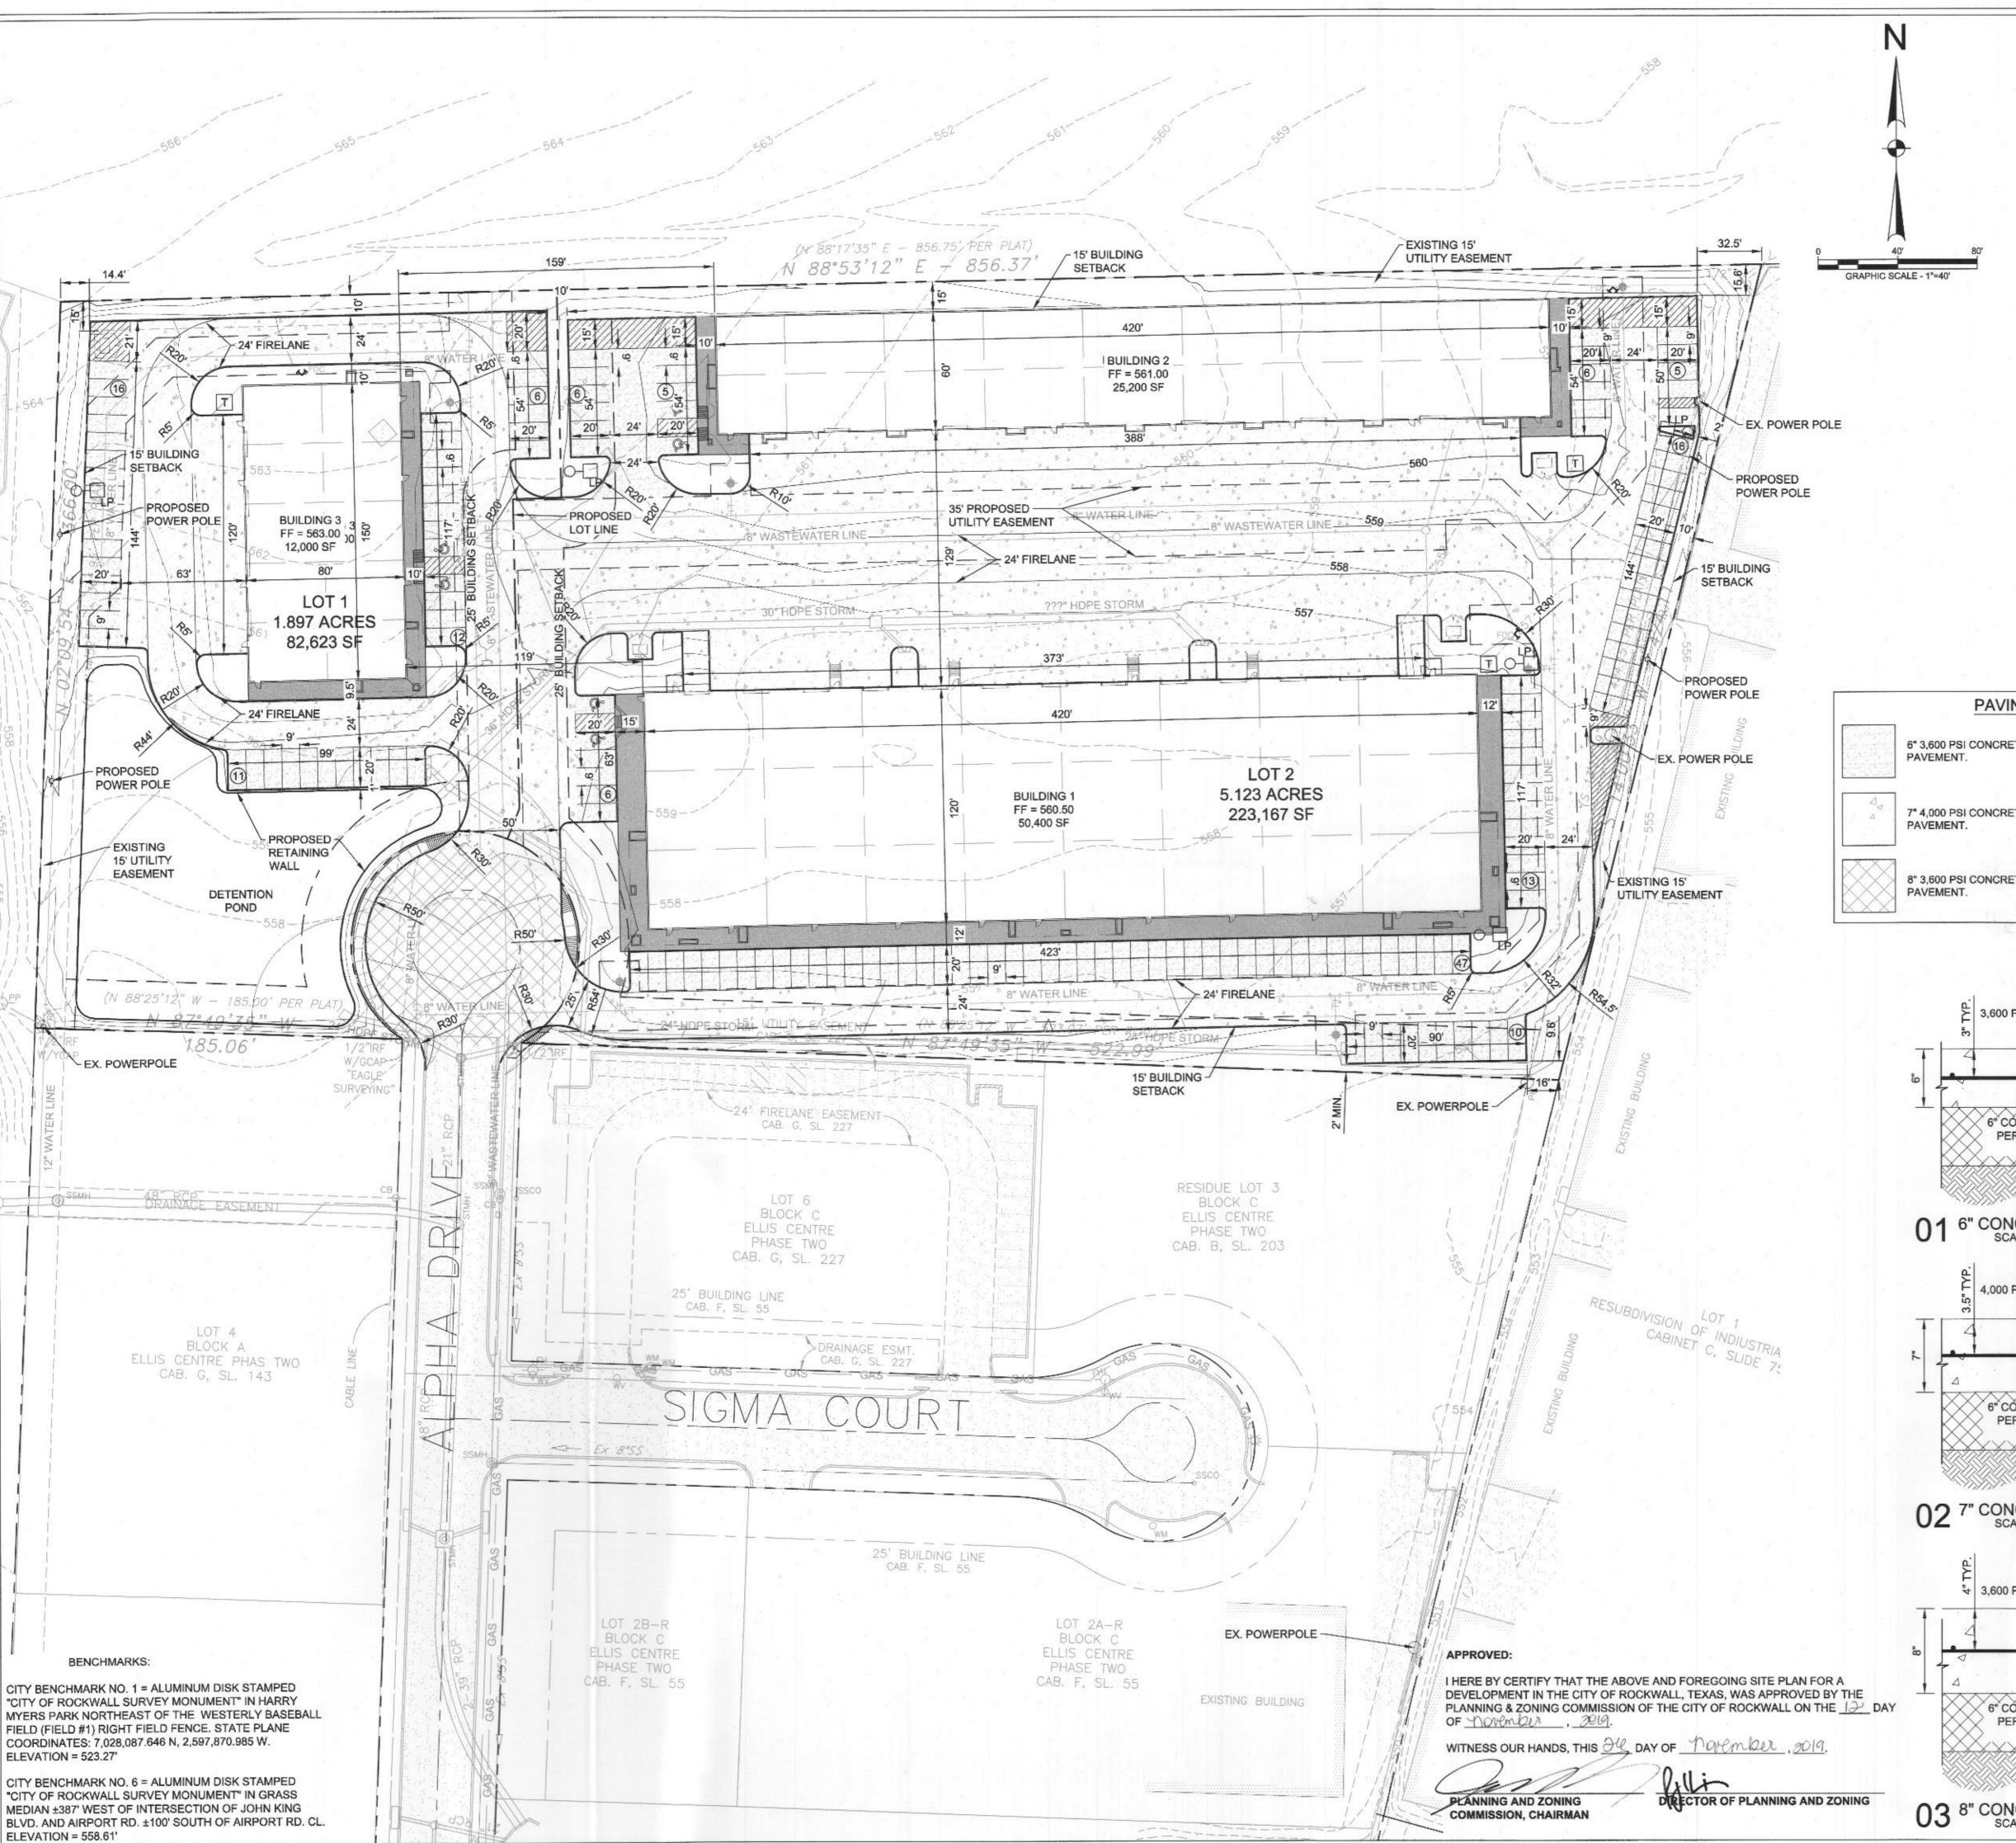

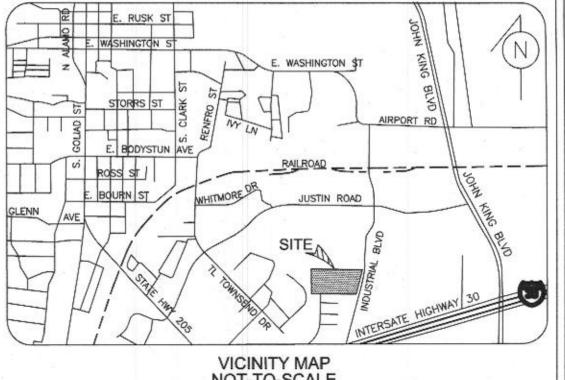
NOT-TO-SCALE

SHEE	T DATA	۸:	
CURRENT ZONING		LIGHT IN	DUSTRIAL
PROPOSED LAND USE:		LIGHT IN	DUSTRIAL
TOTAL SITE AREA:		7.02	ACRES
BUILDING:			. E.,
BUILDING 1		50,400	SF
BUILDING 2		25,200	SF
BUILDING 3		12,000	SF
PARKING:			
REQUIRED: 1 SPACE/1,000 SF (75%)	1 SPACE/30	00 SF (25%)	
TOTAL REQUIRED:		139	SPACES
PROVIDED:		159	SPACES
ACCESSIBLE SPACES PROVIDED:		6*	SPACES




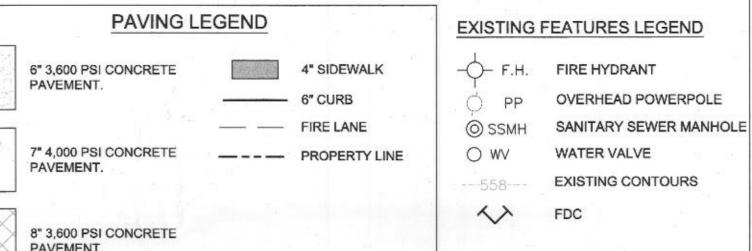

01 6" CONCRETE PAVEMENT SECTION SCALE: N.T.S.

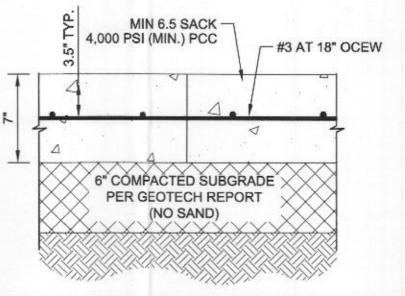

02 7" CONCRETE PAVEMENT SECTION SCALE: N.T.S.

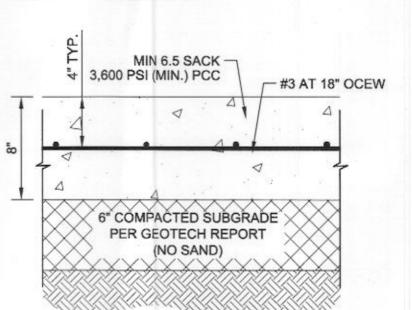

03 8" CONCRETE PAVEMENT SECTION


 ALL DIMENSIONS ARE TO FACE OF CURB UNLESS OTHERWISE

OWNER/ DEVELOPER ROCKWALL URBAN INDUSTRIAL, LP 13150 COIT ROAD DALLAS, TX. 75240 CONTACT: REID CALDWELL EMAIL: reid@longbowinterests.com

TEL: (214) 457-8198 **ENGINEER** HALFF ASSOCIATES, INC. 1201 NORTH BOWSER ROAD RICHARDSON, TX. 75081 CONTACT: DYLAN HEDRICK EMAIL: dhedrick@halff.com TEL: (214) 217-6426

TBPE FIRM# F-312 ALL RESPONSIBILITY FOR ADEQUACY OF DESIGN REMAIN WITH THE DESIGN ENGINEER. THE CITY OF ROCKWALL, IN REVIEWING AND RELEASING PLANS FOR CONSTRUCTION, ASSUMES NO RESPONSIBILITY FOR ADEQUACY OF DESIGN.

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PRELIMINARY FOR INTERIM REVIEW ONLY

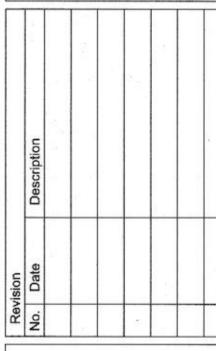
THESE DOCUMENTS ARE FOR INTERIM REVIEW AND ARE NOT INTENDED FOR REGULATORY APPROVAL, PERMIT, BIDDING OR CONSTRUCTION PURPOSES. THEY WERE PREPARED BY, OR UNDER THE SUPERVISION OF: THE SUPERVISION OF: DYLAN B. HEDRICK 11/15/2019 TBPE FIRM # F-312


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ssued:	NOVEMBER 2019
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hecked By:	DBH
cale:	AS SHOWN
heet Title	

DETAILED

Sheet Number

SITE PLAN 1 OF 1

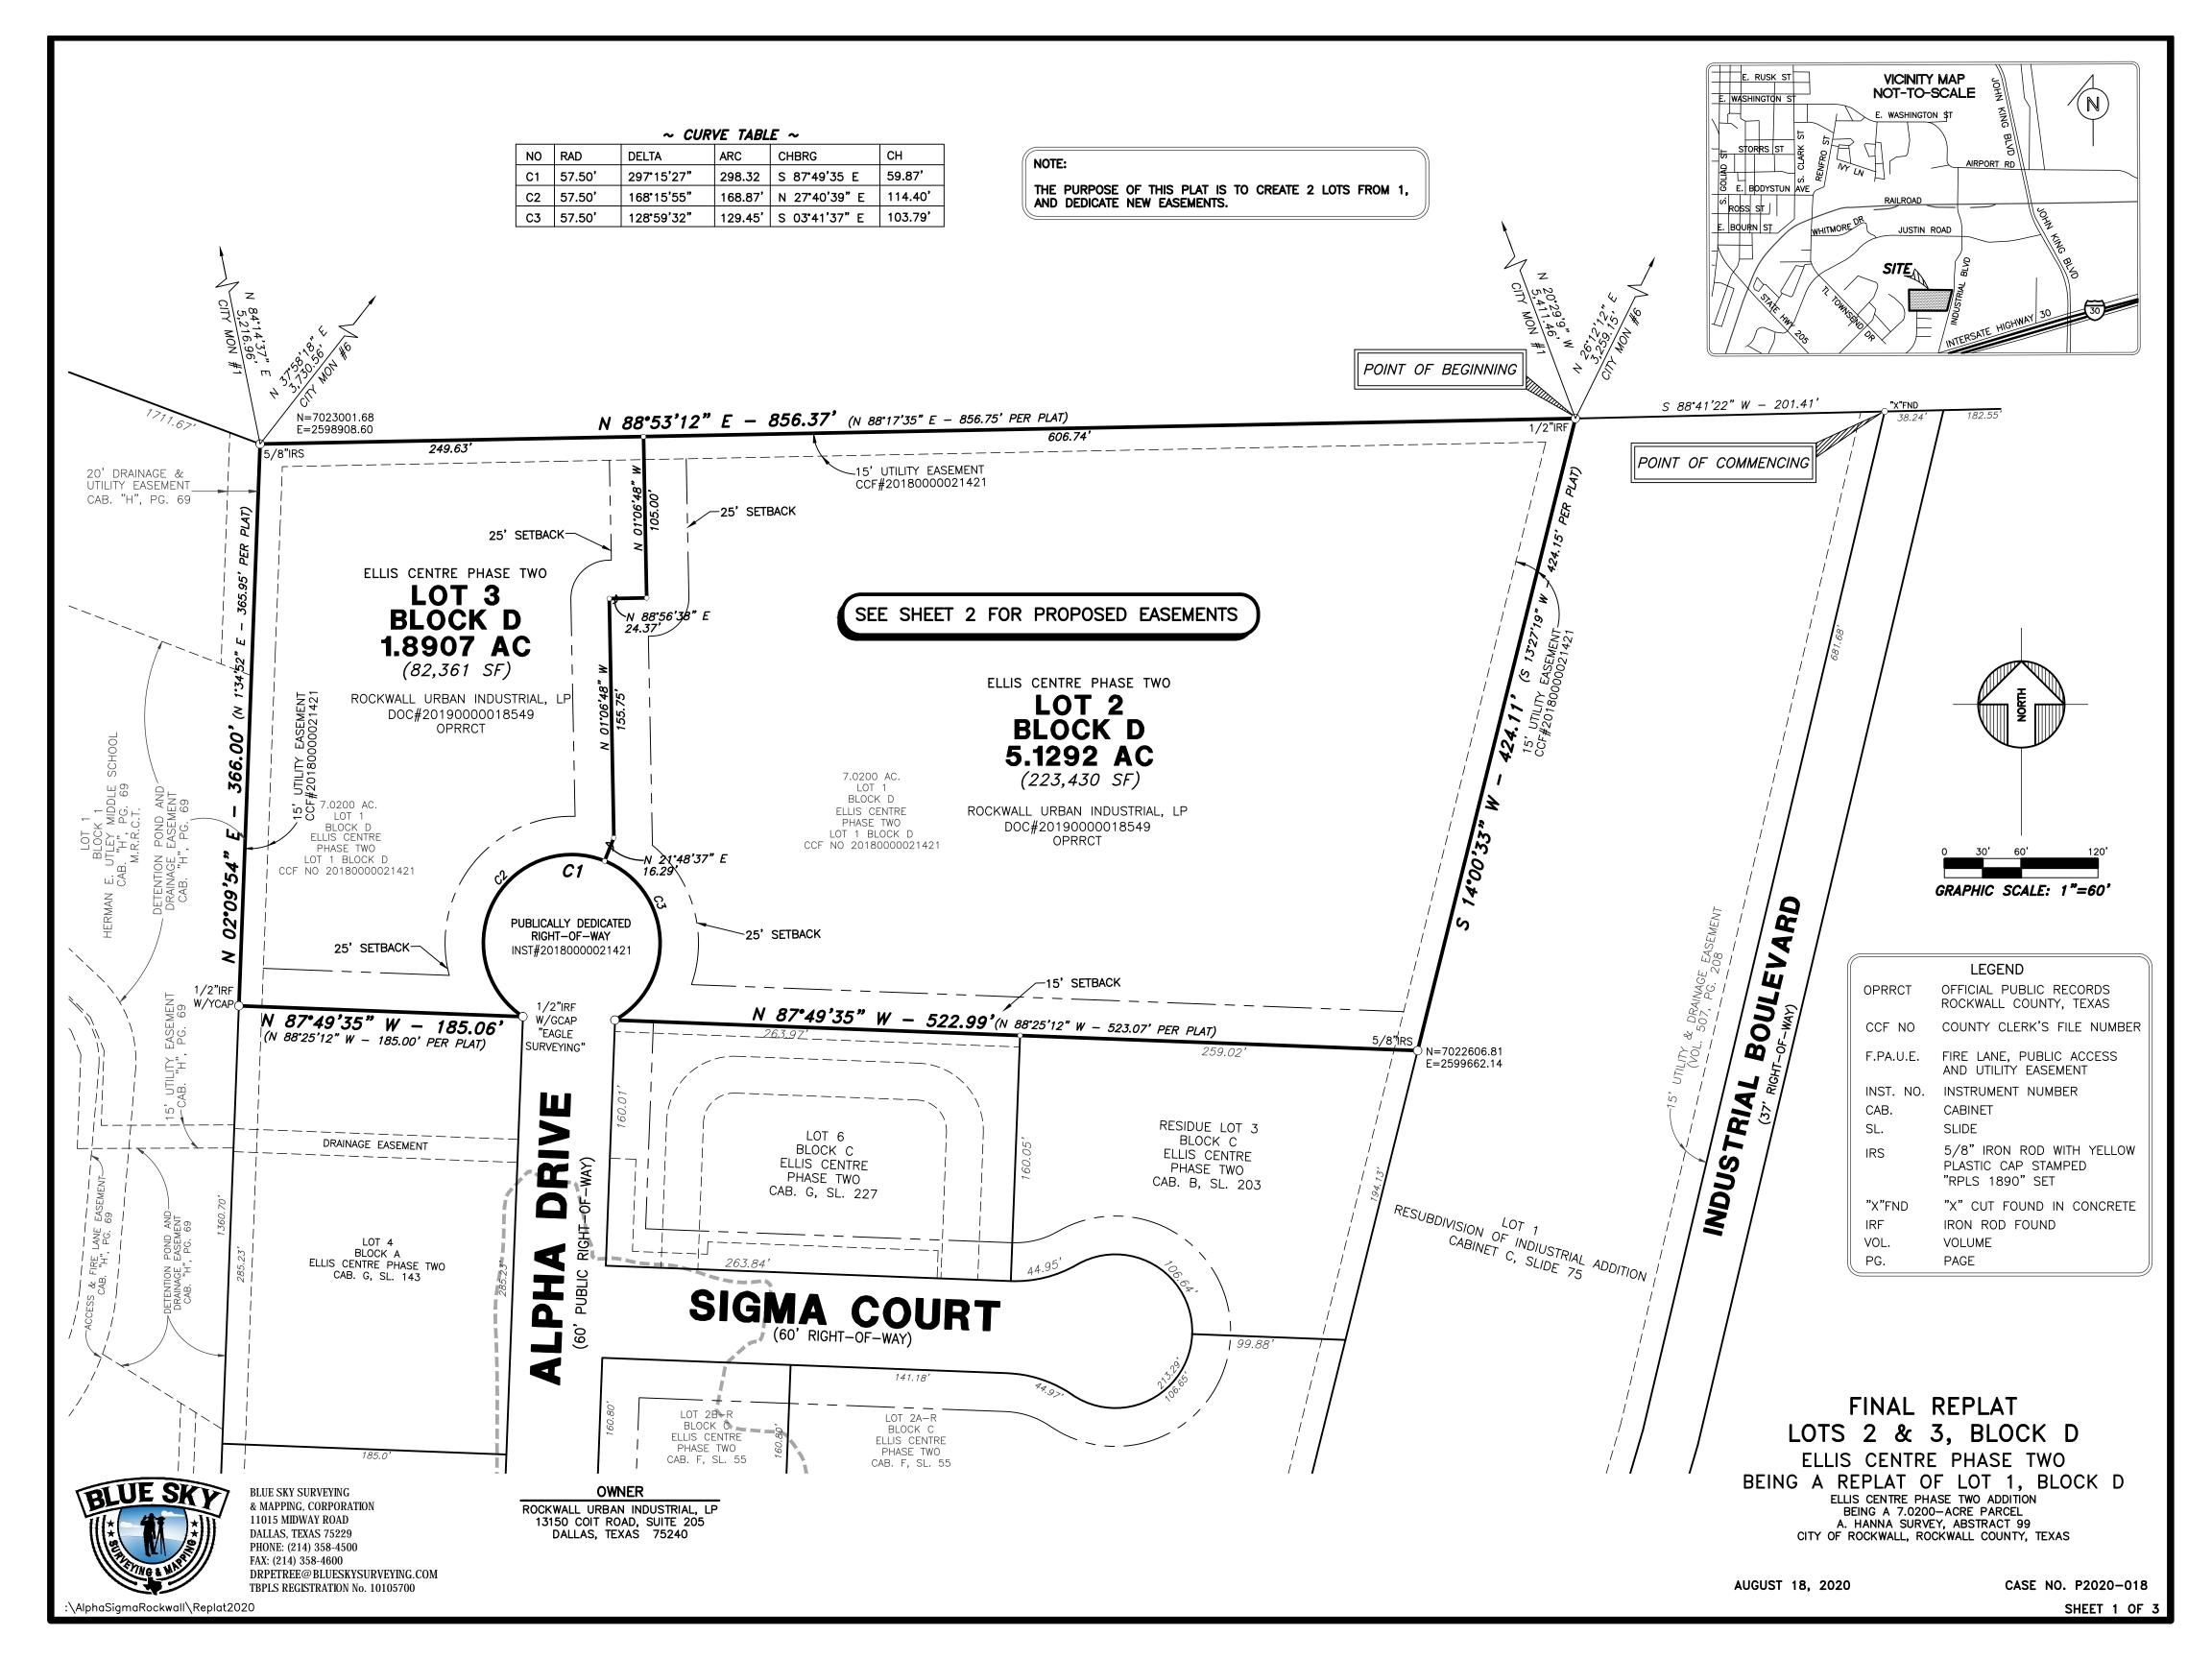

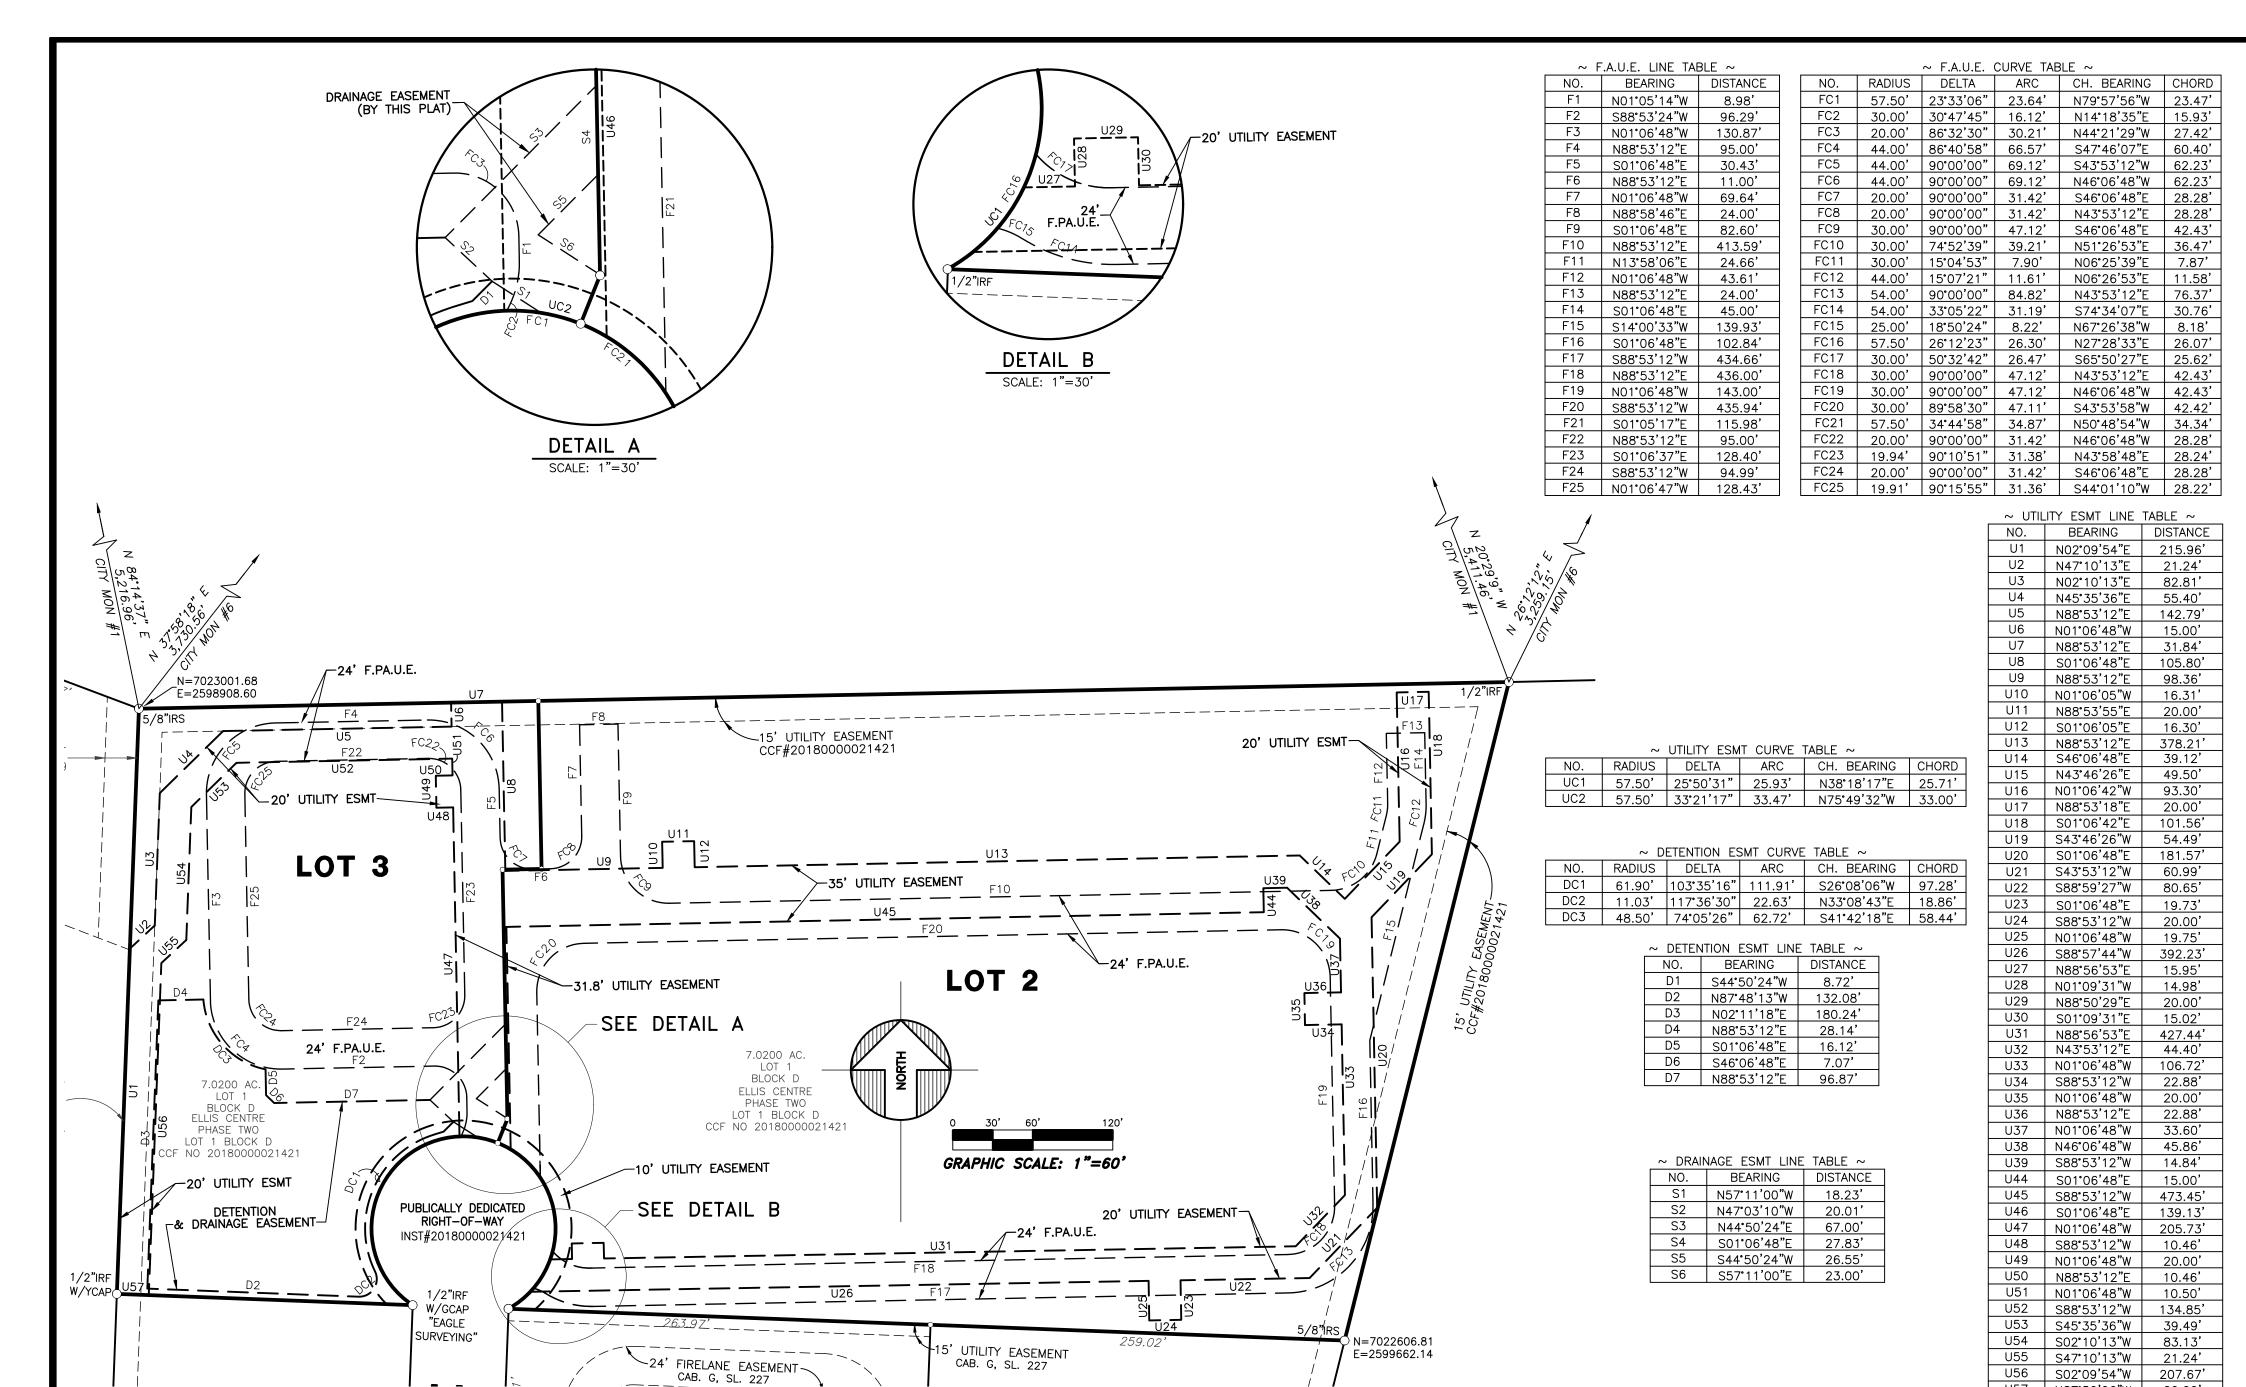

FINAL REPLAT LOTS 2 & 3, BLOCK D

ELLIS CENTRE PHASE TWO
BEING A REPLAT OF LOT 1, BLOCK D

ELLIS CENTRE PHASE TWO ADDITION
BEING A 7.0200—ACRE PARCEL
A. HANNA SURVEY, ABSTRACT 99
CITY OF ROCKWALL, ROCKWALL COUNTY, TEXAS

AUGUST 18, 2020

CASE NO. P2020-018

U57 N87°50'06"W 20.00'

BLUE SKY SURVEYING

11015 MIDWAY ROAD

DALLAS, TEXAS 75229

PHONE: (214) 358-4500 FAX: (214) 358-4600

DRPETREE@BLUESKYSURVEYING.COM

TBPLS REGISTRATION No. 10105700

& MAPPING, CORPORATION

OWNER

ROCKWALL URBAN INDUSTRIAL, LP

13150 COIT ROAD, SUITE 205

DALLAS, TEXAS 75240

OWNER'S CERTIFICATE

STATE OF TEXAS COUNTY OF ROCKWALL

WHEREAS, ROCKWALL URBAN INDUSTRIAL, LP IS THE OWNER OF ALL THAT CERTAIN LOT, TRACT OR PARCEL OF LAND SITUATED IN THE CITY OF ROCKWALL, ROCKWALL COUNTY, TEXAS AND BEING KNOWN AS ALL OF LOT 1, IN BLOCK D, OF ELLIS CENTRE, PHASE TWO, LOT 1, BLOCK D, AN ADDITION TO THE CITY OF ROCKWALL, ROCKWALL COUNTY, TEXAS, ACCORDING TO THE PLAT THEREOF RECORDED IN DOCUMENT NUMBER 20180000021421 OF THE OFFICIAL PUBLIC RECORDS OF ROCKWALL COUNTY, TEXAS, AND BEING THE SAME PROPERTY DESCRIBED IN DEED TO ROCKWALL URBAN INDUSTRIAL, LP UNDER DOCUMENT NUMBER 20190000018549, OFFICIAL PUBLIC RECORDS, ROCKWALL COUNTY, TEXAS, AND BEING MORE PARTICULARLY DESCRIBED BY METES AND BOUNDS AS FOLLOWS:

COMMENCING AT AN "X" FOUND IN CONCRETE FOR CORNER IN THE NORTHWEST RIGHT-OF-WAY LINE OF INDUSTRIAL BOULEVARD (37' RIGHT-OF-WAY), SAID POINT BEING THE NORTHEAST CORNER OF LOT 1 OF RESUBDIVISION OF INDUSTRIAL ADDITION, AN ADDITION TO THE CITY OF ROCKWALL, ROCKWALL COUNTY, TEXAS, ACCORDING TO THE PLAT THEREOF RECORDED IN CABINET C, SLIDE 75 OF THE PLAT RECORDS OF ROCKWALL COUNTY, TEXAS;

THENCE SOUTH 88° 41' 22" WEST LEAVING THE NORTHWEST RIGHT-OF-WAY LINE OF INDUSTRIAL BOULEVARD AND ALONG THE NORTH LINE OF SAID LOT 1 OF RESUBDIVISION OF INDUSTRIAL ADDITION FOR A DISTANCE OF 201.41 FEET TO A 1/2" IRON ROD FOUND FOR THE POINT OF BEGINNING, SAID POINT BEING THE NORTHEAST CORNER OF SAID LOT 1 IN BLOCK D OF ELLIS CENTRE, PHASE TWO, SAID POINT ALSO BEING THE NORTHWEST CORNER OF SAID LOT 1 OF RESUBDIVISION OF INDUSTRIAL ADDITION;

THENCE SOUTH 14° 00' 33" WEST (SOUTH 13° 27' 19" WEST PER PLAT) ALONG THE EAST LINE OF SAID LOT 1 IN BLOCK D OF ELLIS CENTRE, PHASE TWO AND THE WEST LINE OF SAID LOT 1 OF RESUBDIVISION OF INDUSTRIAL ADDITION FOR A DISTANCE OF 424.11 FEET (424.15 FEET PER PLAT) TO A 5/8" IRON ROD SET FOR THE SOUTHEAST CORNER OF SAID LOT 1 IN BLOCK D OF ELLIS CENTRE, PHASE TWO;

THENCE NORTH 87° 49' 35" WEST (NORTH 88° 25' 12" WEST PER PLAT) LEAVING THE WEST LINE OF SAID LOT 1 OF RESUBDIVISION OF INDUSTRIAL ADDITION AND ALONG THE SOUTH LINE OF SAID LOT 1 IN BLOCK D OF ELLIS CENTRE, PHASE TWO, AND PASSING AT A DISTANCE OF 259.02 FEET THE NORTHEAST CORNER OF LOT 6 IN BLOCK C OF ELLIS CENTRE, PHASE TWO, AN ADDITION TO THE CITY OF ROCKWALL, ROCKWALL COUNTY, TEXAS ACCORDING TO THE PLAT THEREOF RECORDED IN CABINET "G", SLIDE 227 OF THE PLAT RECORDS OF ROCKWALL COUNTY, TEXAS; AND CONTINUING ALONG THE SOUTH LINE OF SAID LOT 1 IN BLOCK D OF ELLIS CENTRE, PHASE TWO AND THE NORTH LINE OF SAID LOT 6 IN BLOCK C OF ELLIS CENTRE, PHASE TWO, FOR A DISTANCE OF 522.99 FEET (523.07 FEET PER PLAT) TO A 1/2" IRON ROD FOUND FOR THE NORTHWEST CORNER OF SAID LOT 6 IN BLOCK C OF ELLIS CENTRE, PHASE TWO, SAID POINT BEING IN THE EAST RIGHT—OF—WAY LINE OF ALPHA DRIVE (60' RIGHT—OF—WAY), SAID POINT BEING THE BEGINNING OF A CURVE TO THE LEFT HAVING A RADIUS OF 57.50 FEET WITH A CENTRAL ANGLE OF 297° 15' 27" AND A CHORD BEARING SOUTH 87° 49' 35" EAST AT A DISTANCE OF 59.87 FEET;

THENCE NORTHWESTERLY AND FOLLOWING ALONG SAID CURVE TO THE LEFT AND THE RIGHT-OF-WAY LINE OF SAID ALPHA DRIVE FOR AN ARC DISTANCE OF 298.32 FEET TO A 1/2" IRON ROD WITH GCAP MARKED "EAGLE SURVEYING" FOUND FOR CORNER, SAID POINT BEING IN THE WEST RIGHT-OF-WAY LINE OF SAID ALPHA DRIVE AND ALSO BEING THE NORTHEAST CORNER OF LOT 4 IN BLOCK A OF ELLIS CENTRE, PHASE TWO, AN ADDITION TO THE CITY OF ROCKWALL, ROCKWALL COUNTY, TEXAS ACCORDING TO THE PLAT THEREOF RECORDED IN CABINET "G", SLIDE 143 OF THE MAP RECORDS OF ROCKWALL COUNTY, TEXAS;

THENCE NORTH 87° 49' 35" WEST (NORTH 88° 25' 12" WEST PER PLAT) AND LEAVING THE WEST LINE OF SAID ALPHA DRIVE AND FOLLOWING ALONG THE SOUTH LINE OF SAID LOT 1 IN BLOCK D OF ELLIS CENTRE, PHASE TWO AND THE NORTH LINE OF SAID LOT 4 IN BLOCK A OF ELLIS CENTRE, PHASE TWO, FOR A DISTANCE OF 185.06 FEET (185.00 FEET) TO A 1/2" IRON ROD WITH YELLOW CAP FOUND FOR CORNER IN THE EAST LINE OF LOT 1 IN BLOCK 1 OF HERMAN E. UTLEY MIDDLE SCHOOL, AN ADDITION TO THE CITY OF ROCKWALL, ROCKWALL COUNTY, TEXAS ACCORDING THE PLAT THEREOF RECORDED IN CABINET "H", PAGE 69 OF THE MAP RECORDS OF ROCKWALL COUNTY, TEXAS, SAID POINT BEING THE SOUTHWEST CORNER OF SAID LOT 1 IN BLOCK D OF ELLIS CENTRE, PHASE TWO AND THE NORTHWEST CORNER OF SAID LOT 4 IN BLOCK A OF ELLIS CENTRE, PHASE TWO;

THENCE NORTH 02° 09' 54" EAST (NORTH 1° 34' 52" EAST PER PLAT) AND DEPARTING THE NORTH LINE OF SAID LOT 4 IN BLOCK A OF ELLIS CENTRE, PHASE TWO, AND FOLLOWING ALONG THE WEST LINE OF SAID LOT 1 IN BLOCK D OF ELLIS CENTRE, PHASE TWO AND THE EAST LINE OF SAID LOT 1 IN BLOCK 1 OF HERMAN E. UTLEY MIDDLE SCHOOL FOR A DISTANCE OF 366.00 FEET (365.95 FEET PER PLAT) TO A 5/8" IRON ROD SET FOR CORNER, SAID POINT BEING THE NORTHWEST CORNER OF SAID LOT 1 IN BLOCK D OF ELLIS CENTRE, PHASE TWO AND THE NORTHEAST CORNER OF LOT 1 IN BLOCK 1 OF HERMAN E. UTLEY MIDDLE SCHOOL ADDITION;

THENCE NORTH 88° 53' 12" EAST (NORTH 88° 17' 35" EAST PER PLAT) ALONG THE NORTH LINE OF SAID LOT 1 IN BLOCK D OF ELLIS CENTRE, PHASE TWO FOR A DISTANCE OF 856.37 FEET (856.75 FEET PER PLAT) TO THE POINT OF BEGINNING AND CONTAINING 7.0200 ACRES OF LAND, MORE OR LESS.

BASIS OF BEARINGS = STATE PLANE COORDINATE (4202 TEXAS NORTH CENTRAL ZONE) REFERENCE FRAME NORTH AMERICAN DATUM (NAD) 83(2011)

NOW, THEREFORE, KNOW ALL MEN BY THESE PRESENTS:

STATE OF TEXAS
COUNTY OF ROCKWALL

WE, THE UNDERSIGNED OWNERS OF THE LAND SHOWN ON THIS PLAT, AND DESIGNATED HEREIN AS LOTS 2 & 3, BLOCK D, ELLIS CENTRE PHASE TWO ADDITION, A SUBDIVISION TO THE CITY OF ROCKWALL, TEXAS, AND WHOSE NAME IS SUBSCRIBED HERETO, HEREBY DEDICATE TO THE USE OF THE PUBLIC FOREVER ALL STREETS, ALLEYS, PARKS, WATER COURSES, DRAINS, EASEMENTS AND PUBLIC PLACES THEREON SHOWN ON THE PURPOSE AND CONSIDERATION THEREIN EXPRESSED. WE FURTHER CERTIFY THAT ALL OTHER PARTIES WHO HAVE A MORTGAGE OR LIEN INTEREST IN ELLIS CENTRE PHASE TWO ADDITION HAVE BEEN NOTIFIED AND SIGNED THIS PLAT.

WE UNDERSTAND AND DO HEREBY RESERVE THE EASEMENT STRIPS SHOWN ON THIS PLAT FOR THE PURPOSES STATED AND FOR THE MUTUAL USE AND ACCOMMODATION OF ALL UTILITIES DESIRING TO USE OR USING SAME. WE ALSO UNDERSTAND THE FOLLOWING:

(1) NO BUILDINGS SHALL BE CONSTRUCTED OR PLACED UPON, OVER, OR ACROSS THE UTILITY EASEMENTS AS DESCRIBED HERFIN.

(2) ANY PUBLIC UTILITY SHALL HAVE THE RIGHT TO REMOVE AND KEEP REMOVED ALL OR PART OF ANY BUILDINGS, FENCES, TREES, SHRUBS, OR OTHER GROWTHS OR IMPROVEMENTS WHICH IN ANY WAY ENDANGER OR INTERFERE WITH CONSTRUCTION, MAINTENANCE OR EFFICIENCY OF THEIR RESPECTIVE SYSTEM ON ANY OF THESE EASEMENT STRIPS; AND ANY PUBLIC UTILITY SHALL AT ALL TIMES HAVE THE RIGHT OF INGRESS OR EGRESS TO, FROM AND UPON THE SAID EASEMENT STRIPS FOR PURPOSE OF CONSTRUCTION, RECONSTRUCTION, INSPECTING, PATROLLING, MAINTAINING, AND EITHER ADDING TO OR REMOVING ALL OR PART OF THEIR RESPECTIVE SYSTEM WITHOUT THE NECESSITY OF, AT ANY TIME, PROCURING THE PERMISSION OF ANYONE.

- (3) THE CITY OF ROCKWALL WILL NOT BE RESPONSIBLE FOR ANY CLAIMS OF ANY NATURE RESULTING FROM OR OCCASIONED BY THE ESTABLISHMENT OF GRADE OF STREETS IN THE SUBDIVISION.
- (4) THE DEVELOPER AND SUBDIVISION ENGINEER SHALL BEAR TOTAL RESPONSIBILITY FOR STORM DRAIN IMPROVEMENTS.

(5) THE DEVELOPER SHALL BE RESPONSIBLE FOR THE NECESSARY FACILITIES TO PROVIDE DRAINAGE PATTERNS AND DRAINAGE CONTROLS SUCH THAT PROPERTIES WITHIN THE DRAINAGE AREA ARE NOT ADVERSELY AFFECTED BY STORM DRAINAGE FROM THE DEVELOPMENT.

(6) NO HOUSE DWELLING UNIT, OR OTHER STRUCTURE SHALL BE CONSTRUCTED ON ANY LOT IN THIS ADDITION BY THE OWNER OR ANY OTHER PERSON UNTIL THE DEVELOPER AND/OR OWNER HAS COMPLIED WITH ALL REQUIREMENTS OF THE SUBDIVISION REGULATIONS OF THE CITY OF ROCKWALL REGARDING IMPROVEMENTS WITH RESPECT TO THE ENTIRE BLOCK ON THE STREET OR STREETS ON WHICH PROPERTY ABUTS, INCLUDING THE ACTUAL INSTALLATION OF STREETS WITH THE REQUIRED BASE AND PAVING, CURB AND GUTTER, WATER AND SEWER, DRAINAGE STRUCTURES, STORM STRUCTURES, STORM SEWERS, AND ALLEYS, ALL ACCORDING TO THE SPECIFICATIONS OF THE CITY OF ROCKWALL; OR

(7) THE PROPERTY OWNER SHALL BE RESPONSIBLE FOR ALL MAINTENANCE, REPAIRS, AND RECONSTRUCTION OF DRAINAGE AND DETENTION EASEMENTS ON SITE.

UNTIL AN ESCROW DEPOSIT, SUFFICIENT TO PAY FOR THE COST OF SUCH IMPROVEMENTS, AS DETERMINED BY THE CITY'S ENGINEER AND/OR CITY ADMINISTRATOR, COMPUTED ON A PRIVATE COMMERCIAL RATE BASIS, HAS BEEN MADE WITH THE CITY SECRETARY, ACCOMPANIED BY AN AGREEMENT SIGNED BY THE DEVELOPER AND/OR OWNER, AUTHORIZING THE CITY TO MAKE SUCH IMPROVEMENTS AT PREVAILING PRIVATE COMMERCIAL RATES, OR HAVE THE SAME MADE BY A CONTRACTOR AND PAY FOR THE SAME OUT OF THE ESCROW DEPOSIT, SHOULD THE DEVELOPER AND/OR OWNER FAIL OR REFUSE TO INSTALL THE REQUIRED IMPROVEMENTS WITHIN THE TIME STATED IN SUCH WRITTEN AGREEMENT, BUT IN NO CASE SHALL THE CITY BE OBLIGATED TO MAKE SUCH IMPROVEMENTS ITSELF. SUCH DEPOSIT MAY BE USED BY THE OWNER AND/OR DEVELOPER AS PROGRESS PAYMENTS AS THE WORK PROGRESSES IN MAKING SUCH IMPROVEMENTS BY MAKING CERTIFIED REQUISITIONS TO THE CITY SECRETARY, SUPPORTED BY EVIDENCE OF WORK DONE; OR

UNTIL THE DEVELOPER AND/OR OWNER FILES A CORPORATE SURETY BOND WITH THE CITY SECRETARY IN A SUM EQUAL TO THE COST OF SUCH IMPROVEMENTS FOR THE DESIGNATED AREA, GUARANTEEING THE INSTALLATION THEREOF WITHIN THE TIME STATED IN THE BOND, WHICH TIME SHALL BE FIXED BY THE CITY COUNCIL OF THE CITY OF ROCKWALL.

WE FURTHER ACKNOWLEDGE THAT THE DEDICATIONS AND/OR EXACTION'S MADE HEREIN ARE PROPORTIONAL TO THE IMPACT OF THE SUBDIVISION UPON THE PUBLIC SERVICES REQUIRED IN ORDER THAT THE DEVELOPMENT WILL COMPORT WITH THE PRESENT AND FUTURE GROWTH NEEDS OF THE CITY; WE, OUR SUCCESSORS AND ASSIGNS HEREBY WAIVE ANY CLAIM, DAMAGE, OR CAUSE OF ACTION THAT WE MAY HAVE AS A RESULT OF THE DEDICATION OF EXACTIONS MADE HEREIN.

NOTE: IT SHALL BE THE POLICY OF THE CITY OF ROCKWALL TO WITHHOLD ISSUING BUILDING PERMITS UNTIL ALL STREETS, WATER, SEWER AND STORM DRAINAGE SYSTEMS HAVE BEEN ACCEPTED BY THE CITY. THE APPROVAL OF A PLAT BY THE CITY DOES NOT CONSTITUTE ANY REPRESENTATION, ASSURANCE OR GUARANTEE THAT ANY BUILDING WITHIN SUCH PLAT SHALL BE APPROVED, AUTHORIZED OR PERMIT THEREFORE ISSUED, NOR SHALL SUCH APPROVAL CONSTITUTE ANY REPRESENTATION, ASSURANCE OR GUARANTEE BY THE CITY OF THE ADEQUACY AND AVAILABILITY FOR WATER FOR PERSONAL USE AND FIRE PROTECTION WITHIN SUCH PLAT. AS REQUIRED UNDER ORDINANCE 83-54.

THIS PLAT APPROVED SUBJECT TO ALL PLATTING ORDINANCES, RULES, REGULATIONS, AND RESOLUTIONS OF THE CITY OF ROCKWALL.

WITNESS, MY HAND AT DALLAS, TEXAS, THIS THE _____ DAY OF _____, 2020.

ELLIS CENTRE PHASE TWO ADDITION

Y: _____ (NAME / TITLE)

STATE OF TEXAS

BEFORE ME, THE UNDERSIGNED AUTHORITY, ON THIS DAY PERSONALLY APPEARED ______, KNOWN TO ME TO BE THE PERSON WHOSE NAME IS SUBSCRIBED TO THE FOREGOING INSTRUMENT, AND ACKNOWLEDGED TO ME THAT HE EXECUTED THE SAME FOR THE PURPOSE AND CONSIDERATION THEREIN STATED.

GIVEN UPON MY HAND AND SEAL OF OFFICE THIS ____ DAY OF _____, 2020.

NOTARY PUBLIC IN AND FOR THE STATE OF TEXAS MY COMMISSION EXPIRES:

SURVEYOR'S CERTIFICATE

NOW, THEREFORE KNOW ALL MEN BY THESE PRESENTS:
THAT I, DAVID PETREE, DO HEREBY CERTIFY THAT I PREPARED THIS PLAT FROM AN ACTUAL AND ACCURATE SURVEY OF THE LAND, AND THAT THE CORNER MONUMENTS SHOWN THEREON WERE PROPERLY PLACED UNDER MY PERSONAL SUPERVISION.

DAVID PETREE REGISTERED PROFESSIONAL LAND SURVEYOR NO. 1890

PLANNING AND ZONING COMMISSION	
PLANNING & ZONING	
APPROVED	
I HEREBY CERTIFY THAT THE ABOVE AND FOREGOING PLAT OF AN ADDITION TO THE CI OF ROCKWALL, TEXAS, WAS APPROVED BY THE CITY COUNCIL OF THE CITY OF ROCKW, ON THE DAY OF, 2020.	
THIS APPROVAL SHALL BE INVALID UNLESS THE APPROVED PLAT FOR SUCH ADDITION RECORDED IN THE OFFICE OF THE COUNTY CLERK OF ROCKWALL, COUNTY, TEXAS, WIT ONE HUNDRED EIGHTY (180) DAYS FROM SAID DATE OF FINAL APPROVAL.	
WITNESS OUR HANDS, THIS DAY OF, 2020.	
MAYOR, CITY OF ROCKWALL	
	
CITY SECRETARY CITY ENGINEER	

FINAL REPLAT LOTS 2 & 3, BLOCK D

ELLIS CENTRE PHASE TWO
BEING A REPLAT OF LOT 1, BLOCK D

ELLIS CENTRE PHASE TWO ADDITION
BEING A 7.0200-ACRE PARCEL
A. HANNA SURVEY, ABSTRACT 99

CITY OF ROCKWALL, ROCKWALL COUNTY, TEXAS

BLUE SKY

BLUE SKY SURVEYING
& MAPPING, CORPORATION
11015 MIDWAY ROAD
DALLAS, TEXAS 75229
PHONE: (214) 358-4500
FAX: (214) 358-4600
DRPETREE@BLUESKYSURVEYING.COM
TBPLS REGISTRATION No. 10105700

OWNER
URBAN INDUST

ROCKWALL URBAN INDUSTRIAL, LP 13150 COIT ROAD, SUITE 205 DALLAS, TEXAS 75240 TE:

THE PURPOSE OF THIS PLAT IS TO ABANDON EXISTING AND DEDICATE NEW EASEMENTS.

STORM DRAIN NOTES:

- 1. ALL MATERIALS AND WORKMANSHIP FOR STORM DRAIN CONSTRUCTION SHALL CONFORM TO THE STANDARD SPECIFICATIONS FOR PUBLIC WORKS CONSTRUCTION FOR NORTH CENTRAL TEXAS, 5TH EDITION, AND THE CITY OF ROCKWALL REQUIREMENTS.
- 2. DURING THE CONSTRUCTION OF THESE IMPROVEMENTS, ANY INTERPRETATION OF THE STANDARD SPECIFICATIONS FOR PUBLIC WORKS CONSTRUCTION FOR NORTH CENTRAL TEXAS, AND ANY MATTER WHICH REQUIRES THE APPROVAL OF THE OWNER, MUST BE APPROVED BY THE APPROPRIATE CITY OFFICIAL BEFORE ANY CONSTRUCTION INVOLVING THAT DECISION COMMENCES. ASSUMPTIONS ABOUT WHAT THESE DECISIONS MIGHT BE WHICH ARE MADE DURING THE BIDDING PHASE WILL HAVE NO BEARING ON THE DECISION.
- 3. THE CONTRACTOR SHALL PROTECT EXISTING PROPERTY MONUMENTATION AND PRIMARY CONTROL. ANY SUCH POINTS WHICH THE CONTRACTOR BELIEVES WILL BE DESTROYED SHALL HAVE OFFSET POINTS ESTABLISHED BY THE CONTRACTOR PRIOR TO CONSTRUCTION. ANY MONUMENTATION DESTROYED BY THE CONTRACTOR SHALL BE REESTABLISHED AT HIS EXPENSE.
- 4. THE CONTRACTOR SHALL ABIDE BY ALL APPLICABLE FEDERAL, STATE, AND LOCAL LAWS GOVERNING EXCAVATION. THE CONTRACTOR SHALL PROVIDE DETAILED PLANS AND SPECIFICATIONS FOR TRENCH SAFETY SYSTEMS THAT COMPLY WITH APPLICABLE LAWS GOVERNING EXCAVATION. THESE PLANS SHALL BE SEALED BY AN ENGINEER EXPERIENCED IN THE DESIGN OF TRENCH SAFETY SYSTEMS AND LICENSED BY THE STATE OF TEXAS. SUBMIT PLAN TO THE OWNER PRIOR TO COMMENCING WORK. THE CONTRACTOR SHALL BE SOLE RESPONSIBLE FOR ALL ASPECTS OF WORK RELATED TO EXCAVATION.
- 5. ALL STORM SEWER PIPE TO BE CLASS III REINFORCED CONCRETE PIPE UNLESS NOTED OTHERWISE ON THE CONSTRUCTION DOCUMENTS.
- 6. ALL RCP WYES AND BENDS SHALL BE PREFABRICATED BY THE PIPE MANUFACTURER.
- 7. CONSTRUCT CONCRETE COLLAR AT ALL PIPE SIZE CHANGE LOCATIONS AS PER CITY OF ROCKWALL STANDARD DETAILS.
- 8. ADJUST PROPOSED WATER MAIN AS REQUIRED AT ALL STORM DRAIN AND WATER MAIN CROSSING LOCATIONS.

PAVING NOTES

- 1. EXISTING UTILITIES SHOWN ARE TAKEN FROM AVAILABLE RECORDS PROVIDED BY THE UTILITY OWNER AND FIELD LOCATIONS OF SURFACE APPURTENANCES. LOCATIONS SHOWN ARE GENERALLY SCHEMATIC IN NATURE AND MAY NOT ACCURATELY REFLECT THE SIZE AND LOCATION OF EACH PARTICULAR UTILITY. SOME UTILITY LINES MAY NOT BE SHOWN. CONTRACTOR SHALL ASSUME RESPONSIBILITY FOR ACTUAL FIELD LOCATION AND PROTECTION OF EXISTING FACILITIES WHETHER SHOWN OR NOT. CONTRACTOR SHALL ALSO ASSUME RESPONSIBILITY FOR REPAIRS TO EXISTING FACILITIES, WHETHER SHOWN OR NOT, DAMAGED BY CONTRACTOR'S ACTIVITIES. DIFFERENCES IN HORIZONTAL OR VERTICAL LOCATION OF EXISTING UTILITIES SHALL NOT BE A BASIS FOR ADDITIONAL EXPENSE.
- 2. PAVEMENT REMOVAL AND REPAIR SHALL CONFORM TO CITY OF ROCKWALL REQUIREMENTS FOR DRIVEWAY. ALL SAWCUTS SHALL BE FULL DEPTH CUTS SQUARE. CONTRACTOR SHALL MAKE EFFORTS TO PROTECT CONCRETE AND/OR ASPHALT EDGES. ANY LARGE SPALLED OR BROKEN EDGES SHALL BE REMOVED BY SAWCUTTING PAVEMENT PRIOR TO REPLACEMENT.
- 3. CONTRACTOR SHALL MAINTAIN POSITIVE DRAINAGE AT ALL TIME DURING CONSTRUCTION. PONDING OF WATER IN STREETS, DRIVES, TRUCK COURTS, TRENCHES, ETC. WILL NOT BE ALLOWED.
- 4. CONTRACTOR SHALL LOCATE AND ADJUST EXISTING UTILITY MANHOLE LIDS, CLEANOUTS, WATER VALVES AND OTHER SURFACE APPURTENANCES TO FINAL GRADE AS REQUIRED FOR NEW CONSTRUCTION. CONTRACTOR SHALL COORDINATE UTILITY ADJUSTMENTS WITH OTHER DISCIPLINES AND THE APPROPRIATE UTILITY AGENCIES AND PROVIDE FOR ALL FEES FOR PERMITS, CONNECTIONS, INSPECTIONS, ETC.
- 5. CONTRACTOR'S WORK SHALL INCLUDE PAVEMENT REMOVAL AND LEGAL DISPOSAL REQUIRED FOR NEW WALK, DRIVE, CURB, GUTTER AND OTHER PAVING FEATURES. CONTRACTOR SHALL BE RESPONSIBLE FOR ALL COORDINATION, INSPECTION AND TESTING REQUIRED BY THE OWNER AND THE CITY OF ROCKWALL.
- 6. CONCRETE PAVING JOINTS SHALL BE CONSTRUCTED AS NOTED BELOW. EXPANSION JOINTS SHALL BE PLACED AT CHANGES IN DIRECTION OF PAVING, AT DRIVEWAYS AND/OR AS SHOWN ON THE DRAWINGS.
- 7. PAVING SECTIONS SHOULD BE SAWCUT AT AN APPROXIMATE SPACING IN FEET OF 2.5 TO 3 TIMES THE PAVEMENT THICKNESS EXPRESSED IN INCHES, NOT TO EXCEED A MAXIMUM SPACING OF 20 FEET. THE ACTUAL JOINT PATTERN SHOULD BE CAREFULLY DESIGNED TO AVOID IRREGULAR
- 8. SITE GRADING AND PAVEMENT SUBGRADE SHALL BE PREPARED IN ACCORDANCE WITH THE GEOTECHNICAL REPORT NO. 23160, PREPARED BY REED ENGINEERING, LTD DATED OCTOBER 2019. ALL PAVEMENT SUBGRADE ON COMMERCE DRIVE SHALL CONFORM TO ALL CITY OF ROCKWALL REQUIREMENTS.

PAVING NOTES, CONTINUED:

- 9. ALL DIMENSIONS ARE TO FACE OF CURB OR FACE OF BUILDING AND ARE PERPENDICULAR TO PROPERTY LINE. THESE DIMENSIONS ARE PROVIDED TO TIE THE ARCHITECT'S SITE PLAN TO THE PROPERTY LINES.
- 10. CONTRACTOR SHALL PROVIDE TRAFFIC CONTROL PLAN, AT LEAST 48 HOURS PRIOR TO ANY WORK IN A CITY STREET. TRAFFIC CONTROL MEASURES SHALL CONFORM TO PART VI OF THE TEXAS MANUAL ON UNIFORM TRAFFIC CONTROL MEASURES SHALL BE INSTALLED FOR ANY WORK ACTIVITY THAT TAKES PLACE ON OR ADJACENT TO ANY CITY STREET OR ROADWAY. THE CITY ENGINEER REQUIRES THE TRAFFIC CONTROL PLAN TO BE DESIGNED AND SEALED BY AN ENGINEER LICENSED IN THE STATE OF TEXAS. CHECK WITH THE CITY OF ROCKWALL PRIOR TO CONSTRUCTION.
- 11. THE CONTRACTOR SHALL PROTECT EXISTING PROPERTY MONUMENTATION AND PRIMARY CONTROL. ANY SUCH POINTS WHICH THE CONTRACTOR BELIEVES WILL BE DESTROYED SHALL HAVE OFFSET POINTS ESTABLISHED BY THE CONTRACTOR PRIOR TO CONSTRUCTION. ANY MONUMENTATION DESTROYED BY THE CONTRACTOR SHALL BE REESTABLISHED AT HIS EXPENSE.
- 12. IT SHALL BE THE RESPONSIBILITY OF THE CONTRACTOR TO: PREVENT ANY DAMAGE TO PRIVATE PROPERTY AND PROPERTY
- OWNER'S POLES, FENCES, SHRUBS, ETC. PROVIDE ACCESS TO ALL DRIVES DURING CONSTRUCTION.
- PROTECT ALL UNDERGROUND UTILITIES TO REMAIN IN SERVICE.
- NOTIFY ALL UTILITY COMPANIES AND VERIFY LOCATION OF ALL UTILITIES PRIOR TO START OF CONSTRUCTION.
- 13. ANY DAMAGES THAT MAY OCCUR TO REAL PROPERTY OR EXISTING IMPROVEMENTS SHALL BE RESTORED BY THE CONTRACTOR TO AT LEASE THE SAME CONDITION THAT THE REAL PROPERTY OR EXISTING IMPROVEMENTS WERE IN PRIOR TO THE DAMAGES. THIS RESTORATION SHALL BE SUBJECT TO THE OWNER'S APPROVAL; MOREOVER, THIS RESTORATION SHALL NOT BE A BASIS FOR ADDITIONAL COMPENSATION TO THE CONTRACTOR. RESTORATION SHALL INCLUDE, BUT NOT BE LIMITED TO, REGRASSING, REVEGETATION, REPLACING FENCES, REPLACING TREES, ETC.
- 14. THE EXISTING SPOT ELEVATIONS AND PLANIMETRIC DATA SHOWN TAKEN FROM SURVEY PREPARED BY HALFF ASSOCIATES, INC. SURFACE APPURTENANCES OF UNDERGROUND UTILITIES SHOWN ARE ALSO TAKEN FROM SAME SURVEY.
- 15. FOR PAVEMENT STRENGTH AND THICKNESS USE THE FOLLOWING: 5" 3000 PSI (5.5 SACK) IN PARKING AREAS WITH #3 GRADE 60 BARS AT 24" ON CENTER EACH WAY. 7" 4000 PSI (6.5 SACK MIX) IN TRUCK COURTS, FIRE LANES, DRIVE AISLES AND DUMPSTERS WITH #4 GRADE 60 BARS AT 18" ON CENTER EACH WAY.
- 16. ALL SIDEWALKS SHALL MAINTAIN 2% CROSS SLOPE MAXIMUM.
- 17. SLOPES ALONG SIDEWALKS IN THE DIRECTION OF TRAVEL SHALL NOT EXCEED 5%.
- 18. SLOPES WITHIN DESIGNATED HANDICAP AREAS SHALL NOT EXCEED 2% IN ANY DIRECTION.
- 19. FOR PAVING DETAILS, SEE CITY OF ROCKWALL STANDARD DETAILS.
- 20. SEE ARCHITECT AND STRUCTURAL PLANS FOR RETAINING WALL DETAILS AND SPECIFICATIONS WITHIN CITY OF ROCKWALL
- 21. CONTACT ENGINEERING DIVISION AT LEAST 48 HOURS PRIOR TO WORK REQUIRING THE REMOVAL OR RELOCATION OF TRAFFIC SIGNS, TRAFFIC CONTROL EQUIPMENT OR OTHER TRAFFIC CONTROL APPURTENANCES WITHIN CITY OF ROCKWALL.
- 22. ACCESSIBLE PEDESTRIAN ROUTES ON PUBLIC RIGHTS-OF-WAY AND PRIVATE PROPERTY SHALL COMPLY WITH AMERICANS WITH DISABILITIES ACT ACCESSIBILITY GUIDELINES (ADAAG) AND TEXAS ACCESSIBILITY STANDARDS (TAS). DESIGN AND CONSTRUCTION OF ALL CURB RAMPS ON PUBLIC RIGHTS-OF-WAY SHALL BE IN ACCORDANCE WITH TEXAS DEPARTMENT OF TRANSPORTATION STANDARD DETAIL PED-05, SHEETS 1 THROUGH 4. DESIGN AND CONSTRUCTION OF ALL SIDEWALKS SHALL BE IN ACCORDANCE WITH CITY OF ROCKWALL STANDARD DETAILS WITH PASSING AREAS HAVING A MINIMUM 5-FOOT BY 5-FOOT SIZE AT INTERVALS NOT EXCEEDING 200 FEET. CURB RAMPS THAT ARE PART OF ACCESSIBLE ROUTES ON PRIVATE PROPERTY MAY BE CONSTRUCTED IN ACCORDANCE WITH TXDOT STADARD DETAIL PED-05, SHEETS 1 THROUGH 4, OR MAY BE CONSTRUCTED IN ACCORDANCE WITH A DESIGN SUBMITTED AND APPROVED BY THE TEXAS DEPATMENT OF LICENSING AND REGULATION.
- 23. THE CONTRACTOR SHALL PARTICIPATE WITH THE CITY OF ROCKWALL IN A PUBLIC WORKS PRE-CONSTRUCTION MEETING AND A BUILDING INSPECTION PRE-CONSTRUCTION MEETING PRIOR TO MOBILIZATION AND


CONSTRUCTION

GRADING NOTES:

- 1. CONTRACTOR IS RESPONSIBLE FOR, AND MUST OBTAIN PRIOR TO CONSTRUCTION, ALL NECESSARY CONSTRUCTION PERMITS REQUIRED BY THE CITY OF ROCKWALL.
- 2. ALL SITE WORK DETAILS SHALL BE DONE IN ACCORDANCE WITH THE STANDARD DETAILS OF THE CITY OF ROCKWALL AND CONFORM TO THE REQUIREMENTS OF THE PLANS AND CONTRACT DOCUMENTS.
- 3. EXISTING UTILITY LOCATIONS SHOWN ARE TAKEN FROM AVAILABLE RECORDS PROVIDED BY THE UTILITY OWNER AND FIELD LOCATIONS OF SURFACE APPURTENANCES. LOCATIONS SHOWN ARE GENERALLY SCHEMATIC IN NATURE AND MAY NOT ACCURATELY REFLECT THE SIZE AND LOCATION OF EACH PARTICULAR UTILITY. SOME UTILITY LINES MAY NOT BE SHOWN. CONTRACTOR SHALL ASSUME RESPONSIBILITY FOR ACTUAL FIELD LOCATION AND PROTECTION OF EXISTING FACILITIES WHETHER SHOWN OR NOT. CONTRACTOR SHALL ALSO ASSUME RESPONSIBILITY FOR REPAIRS TO EXISTING FACILITIES, WHETHER SHOWN OR NOT, DAMAGED BY CONTRACTOR'S ACTIVITIES. DIFFERENCES IN HORIZONTAL OR VERTICAL LOCATION OF EXISTING UTILITIES SHALL NOT BE A BASIS FOR ADDITIONAL EXPENSE.
- 4. THE CONTRACTOR SHALL PROTECT EXISTING PROPERTY MONUMENTATION AND PRIMARY CONTROL. ANY SUCH POINTS WHICH THE CONTRACTOR BELIEVES WILL BE DESTROYED SHALL HAVE OFFSET POINTS ESTABLISHED BY THE CONTRACTOR PRIOR TO CONSTRUCTION. ANY MONUMENTATION DESTROYED BY THE CONTRACTOR SHALL BE REESTABLISHED AT HIS EXPENSE.
- 5. IT SHALL BE THE RESPONSIBILITY OF THE CONTRACTOR TO: A. PREVENT ANY DAMAGE TO PRIVATE PROPERTY AND PROPERTY
- OWNER'S POLES, FENCES, SHRUBS, ETC. B. PROVIDE ACCESS TO ALL DRIVES DURING CONSTRUCTION.
- C. PROTECT ALL UNDERGROUND UTILITIES TO REMAIN IN SERVICE.
- D. NOTIFY ALL UTILITY COMPANIES AND VERIFY LOCATION OF ALL UTILITIES PRIOR TO START OF CONSTRUCTION WITHIN CITY OF ROCKWALL.
- 7. CONTRACTOR SHALL PROVIDE TRAFFIC CONTROL PLAN, AT LEAST 48 HOURS PRIOR TO ANY WORK IN CITY STREET. TRAFFIC CONTROL MEASURES SHALL CONFORM TO PART VI OF THE TEXAS MANUAL ON UNIFORM TRAFFIC CONTROL DEVICES. TRAFFIC CONTROL MEASURES SHALL BE INSTALLED FOR ANY WORK ACTIVITY THAT TAKES PLACE ON OR ADJACENT TO ANY CITY STREET OR ROADWAY. THE CITY ENGINEER MAY REQUIRE THE TRAFFIC CONTROL PLAN TO BE DESIGNED AND SEALED BY AN ENGINEER LICENSED IN THE STATE OF TEXAS.
- 8. THE CONTRACTOR SHALL ABIDE BY ALL APPLICABLE FEDERAL, STATE, AND LOCAL LAWS GOVERNING EXCAVATION. THE CONTRACTOR SHALL PROVIDE DETAILED PLANS AND SPECIFICATIONS FOR TRENCH SAFETY SYSTEMS THAT COMPLY WITH APPLICABLE LAWS GOVERNING EXCAVATION. THESE PLANS SHALL BE SEALED BY AN ENGINEER EXPERIENCED IN THE DESIGN OF TRENCH SAFETY SYSTEMS AND LICENSED BY THE STATE OF TEXAS. SUBMIT PLAN TO THE OWNER PRIOR TO COMMENCING WORK. THE CONTRACTOR SHALL BE SOLELY RESPONSIBLE FOR ALL ASPECTS OF WORK RELATED TO EXCAVATION.
- 9. CONTRACTOR SHALL MAINTAIN DRAINAGE AT ALL TIMES DURING CONSTRUCTION. PONDING OF WATER IN STREETS, DRIVES, TRUCK COURTS, TRENCHES, ETC., WILL NOT BE ALLOWED.
- 10. PAVEMENT REMOVAL AND REPAIR FOR DRIVEWAYS SHALL CONFORM TO THE CITY OF ROCKWALL REQUIREMENTS. ALL SAWCUTS SHALL BE FULL DEPTH CUTS. CONTRACTOR SHALL MAKE EFFORTS TO PROTECT CONCRETE AND/OR ASPHALT EDGES. ANY LARGE SPALLED OR BROKEN EDGES SHALL BE REMOVED BY SAWCUTTING PAVEMENT PRIOR TO REPLACEMENT.
- 11. ANY DAMAGES THAT MAY OCCUR TO REAL PROPERTY OR EXISTING IMPROVEMENTS SHALL BE RESTORED BY THE CONTRACTOR TO AT LEASE THE SAME CONDITION THAT THE REAL PROPERTY OR EXISTING IMPROVEMENTS WERE IN PRIOR TO THE DAMAGES. THIS RESTORATION SHALL BE SUBJECT TO THE OWNER'S APPROVAL; MOREOVER, THIS RESTORATION SHALL NOT BE A BASIS FOR ADDITIONAL COMPENSATION TO THE CONTRACTOR. RESTORATION SHALL INCLUDE, BUT NOT BE LIMITED TO, REGRASSING, REVEGETATION, REPLACING FENCES, REPLACING TREES, ETC.
- 12. CONTRACTOR SHALL MAINTAIN EXISTING SANITARY SEWER AND WATER SERVICE AT ALL TIMES DURING CONSTRUCTION.
- 13. CONTRACTOR IS RESPONSIBLE FOR COORDINATION WITH UTILITY COMPANIES AND ADJUSTMENT OF EXISTING SANITARY SEWER CLEANOUTS, WATER METERS AND ANY OTHER APPURTENANCES TO NEW GRADE AS REQUIRED.
- 14. ONSITE PLANAMETRIC, TOPOGRAPHIC AND BOUNDARY DATA TAKEN FROM SURVEY BY HALFF ASSOCIATES, INC.
- 15. THE CONTRACTOR SHALL ADMINISTER SPRINKLERS FOR DUST CONTROL. EARTHWORK OR BASE CONSTRUCTION AS REQUIRED OR AS DIRECTED BY THE ENGINEER IN ACCORDANCE WITH TXDOT SPECIFICATIONS ITEM 204.
- 16. CONTRACTOR'S WORK SHALL INCLUDE PAVEMENT REMOVAL AND DISPOSAL REQUIRED FOR NEW WALK, DRIVE, CURB, GUTTER AND OTHER GRADING FEATURES. CONTRACTOR SHALL BE RESPONSIBLE FOR ALL COORDINATION, INSPECTION AND TESTING REQUIRED BY THE OWNER AND/OR THE CITY OF ROCKWALL.
- 17. ALL SIDEWALKS SHALL MAINTAIN 2% CROSS SLOPE MAXIMUM.
- 18. SLOPES ALONG SIDEWALK IN THE DIRECTION OF TRAVEL SHALL NOT EXCEED 5%.
- 19. SLOPES WITHIN DESIGNATED HANDICAP AREAS SHALL NOT EXCEED 2% IN ANY DIRECTION.
- 20. 4:1 IS THE MAXIMUM ALLOWABLE SLOPE WITHIN THE EARTHEN AREAS. (1.0% MIN SLOPE ALLOWED IN AREA)
- 21. SITE GRADING AND PAVEMENT SUBGRADE SHALL BE PREPARED IN ACCORDANCE WITH THE GEOTECHNICAL REPORT NO. 22076, PREPARED BY REED ENGINEERING GROUP, DATED DECEMBER 2017.
- 22. ALL SPOT ELEVATIONS ARE TOP OF PAVEMENT UNLESS OTHERWISE
- 23. SLOPE WITHIN ROW SHALL MAINTAIN 1/4" PER FOOT

- 1. ALL MANHOLES SHALL BE ROWEN LINED OR APPROVED EQUAL INCLUDING EXISTING MANHOLES BEING USED.
- 2. CONTRACTOR TO INSTALL BLUE EMS DISKS ON THE WATERLINE EVERY 250', EVERY VALVE, CHANGE IN DIRECTION, FIRE HYDRANTS AND SERVICE
- 3. CONTRACTOR TO INSTALL GREEN EMS DISKS ON THE PUBLIC SEWER LINE AT EVERY MANHOLE, CLEANOUT, SERVICE CONNECTION, AND CHANGE IN
- 4. ALL WATER LINES 12" OR LESS TO BE DR14 (PC305) AND LARGER THAN 12"
- 5. ALL DISTURBED AREAS TO HAVE 75-80% 1" IN HEIGHT GRASS (NOT WINTER RYE OR WEEDS) COVERS PRIOR TO CITY ACCEPTANCE AND CERTIFICATE
- 6. ALL PUBLIC ROW WILL BE SODDED PRIOR TO CITY ACCEPTANCE AND CERTIFICATE OF OCCUPANCY.
- 7. ALL GENERAL FILL TO BE COMPACTED TO 95% STANDARD PROCTOR DENSITY WITH A SHEEPSFOOT ROLLER IN NO MORE THAN 8" LIFTS. MECHANICAL TAMPING IS ALLOWED FOR TRENCH BACKFILL.
- 8. NO PAVING OPERATIONS, INCLUDING SLAB, ARE ALLOWED UNTIL THE DETENTION POND IS FULLY INSTALLED WITH EROSION PROTECTION ON SIDES AND BOTTOM, SOD OR ANCHORED SEEDED ****
- 9. ALL WALLS TO BE ROCK OR STONE.
- 10. NO WALLS OFFSITE OR IN UTILITY EASEMENT.
- 11. ALL WALLS 3' OR TALLER TO BE ENGINEERED (SIGNED/SEALED) DESIGN AND REVIEWED BY CITY.



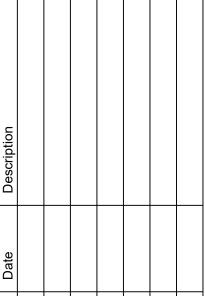

RECORD DRAWING

NOVEMBER 24, 2020

THESE RECORD DRAWINGS HAVE BEEN PREPARED BASED ON FIELD OBSERVATIONS AND INFORMATION PROVIDED BY THE CONTRACTOR. ELEVATIONS HAVE NOT BEEN FIELD VERIFIED. THE ORIGINAL SEALED CONSTRUCTION DRAWINGS ARE ON FILE AT THE OFFICES OF HALFF ASSOCIATES.


ENGINEER OF RECORD DYLAN B. HEDRICK HALFF ASSOCIATES, INC. TBPE FIRM F-312 DATE: NOVEMBER 24, 2020

INC. TBPE FIRM F-312.

Project No.: 38050 Issued: **NOVEMBER 2020** Drawn By: REP Checked By: DBH Scale: AS SHOWN Sheet Title


GENERAL NOTES


C0.01 Sheet Number

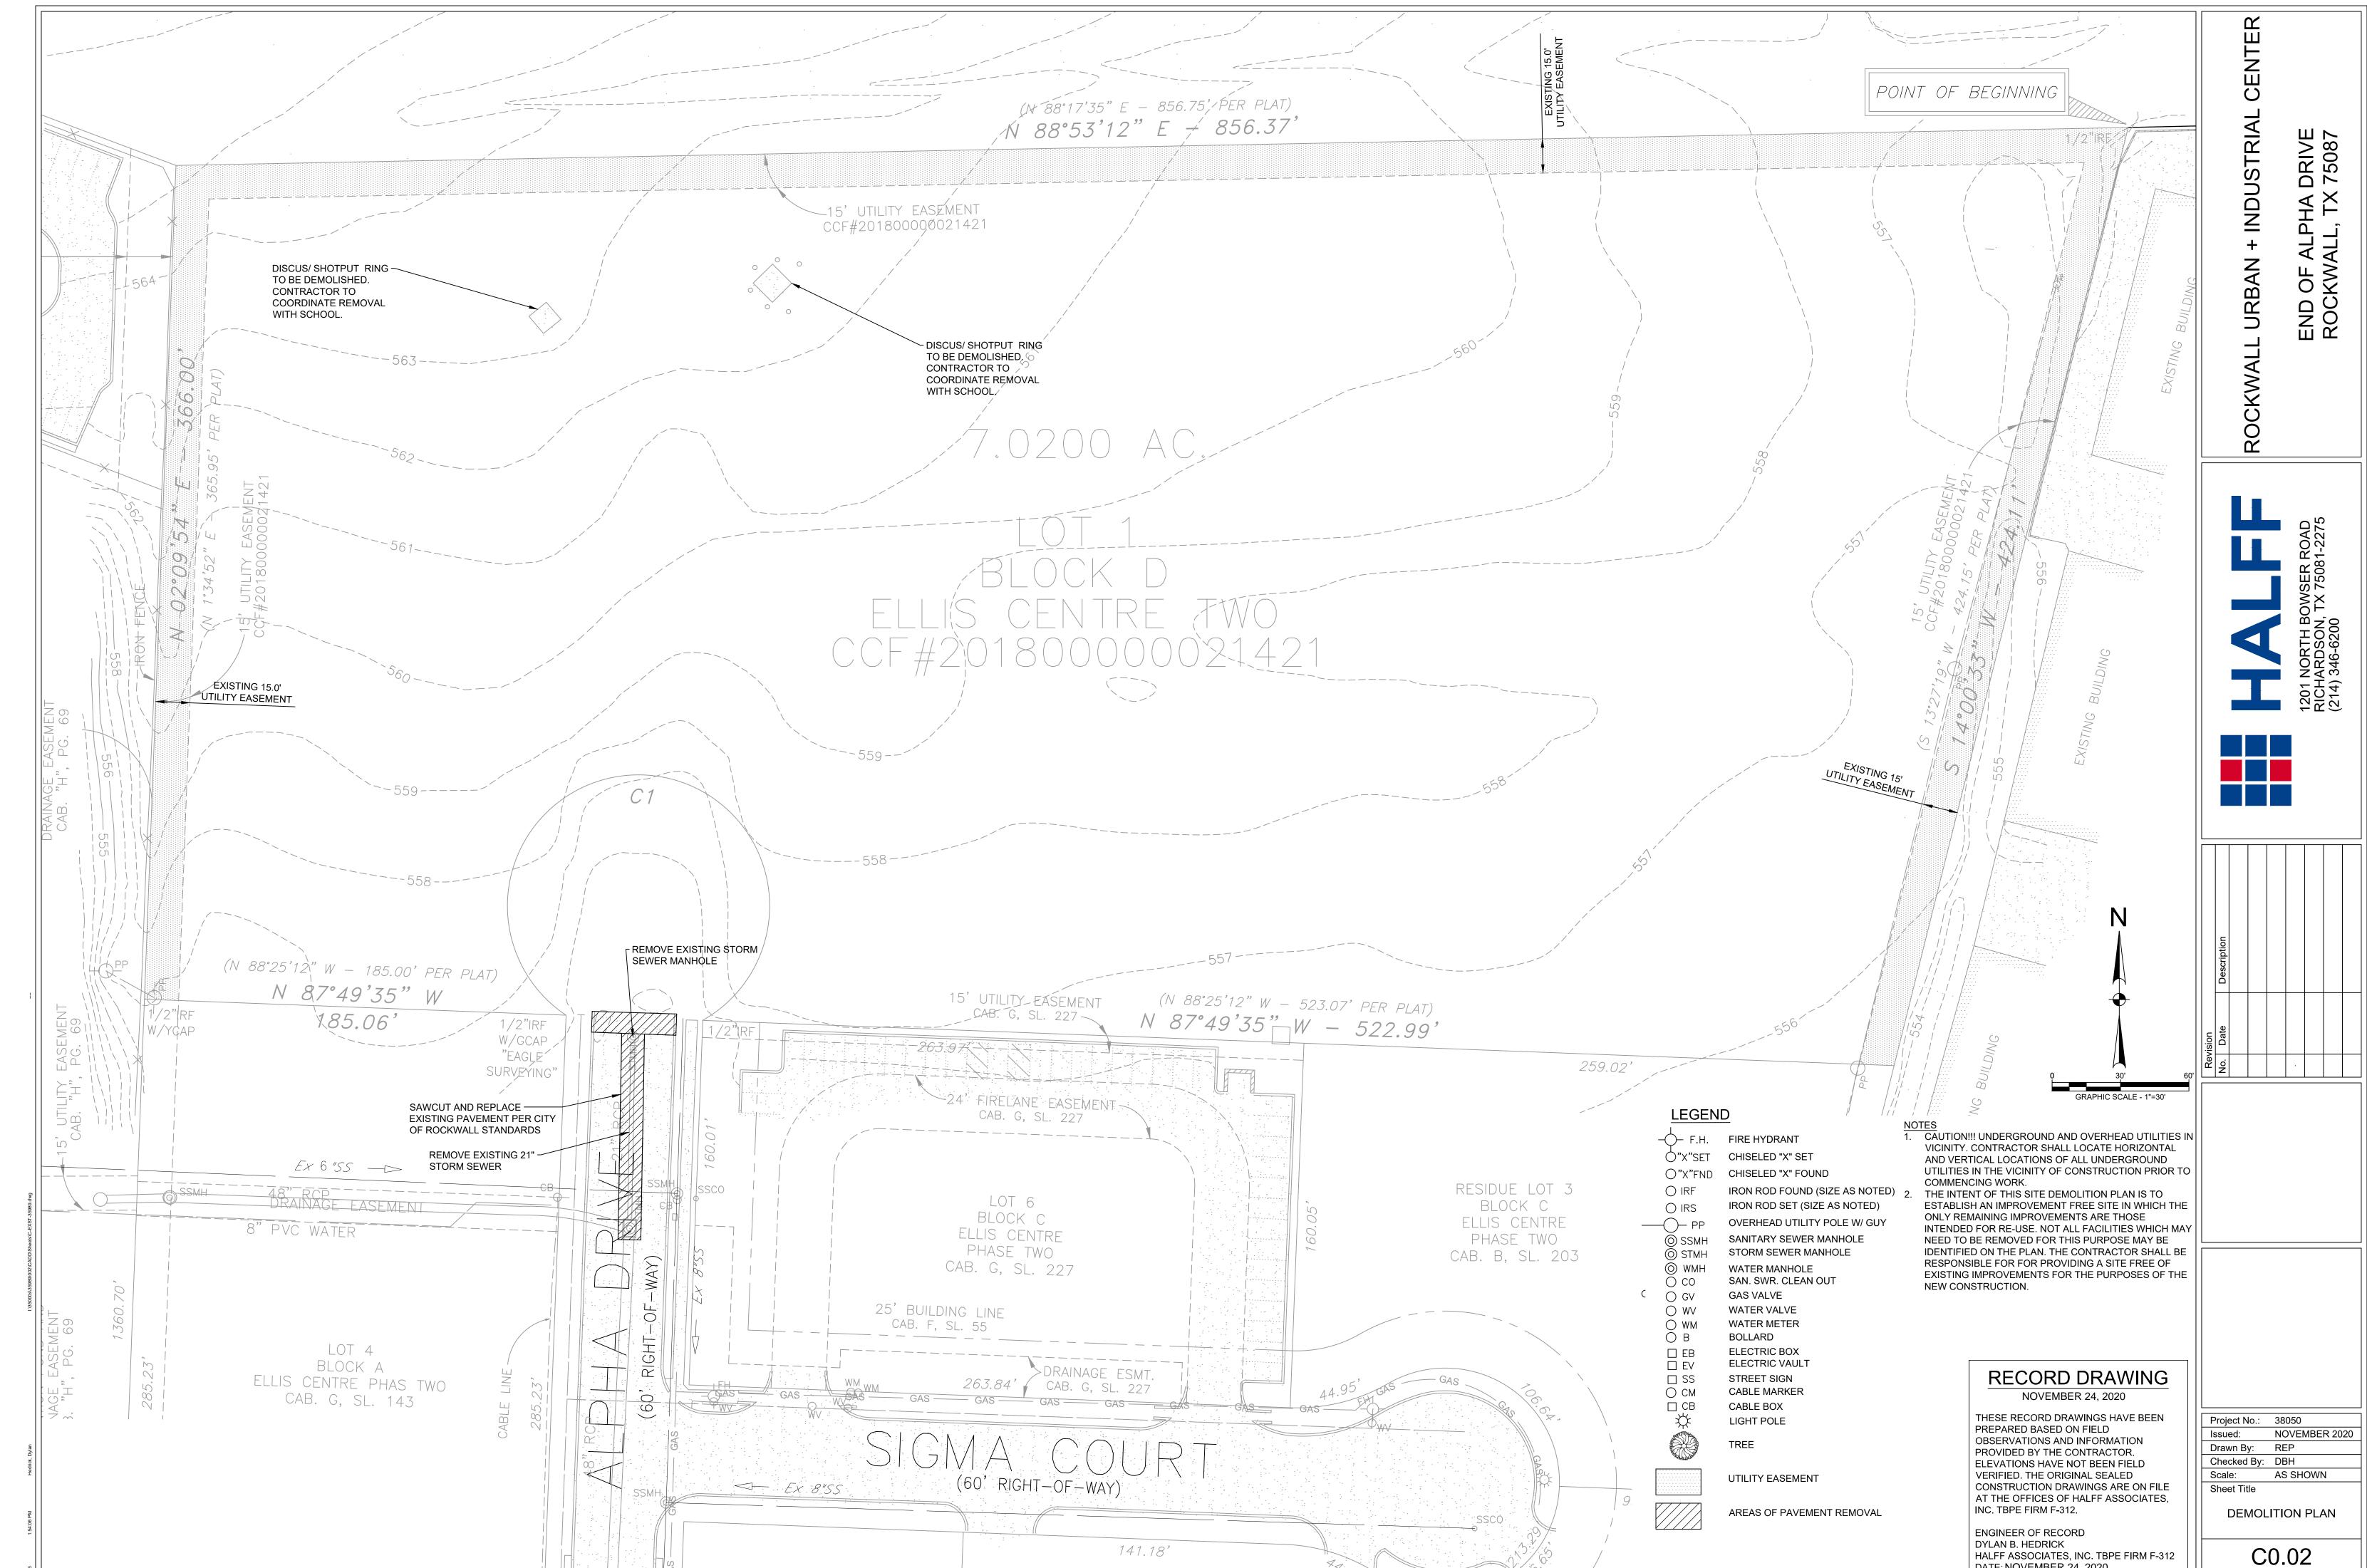

DATE: NOVEMBER 24, 2020


Sheet Number

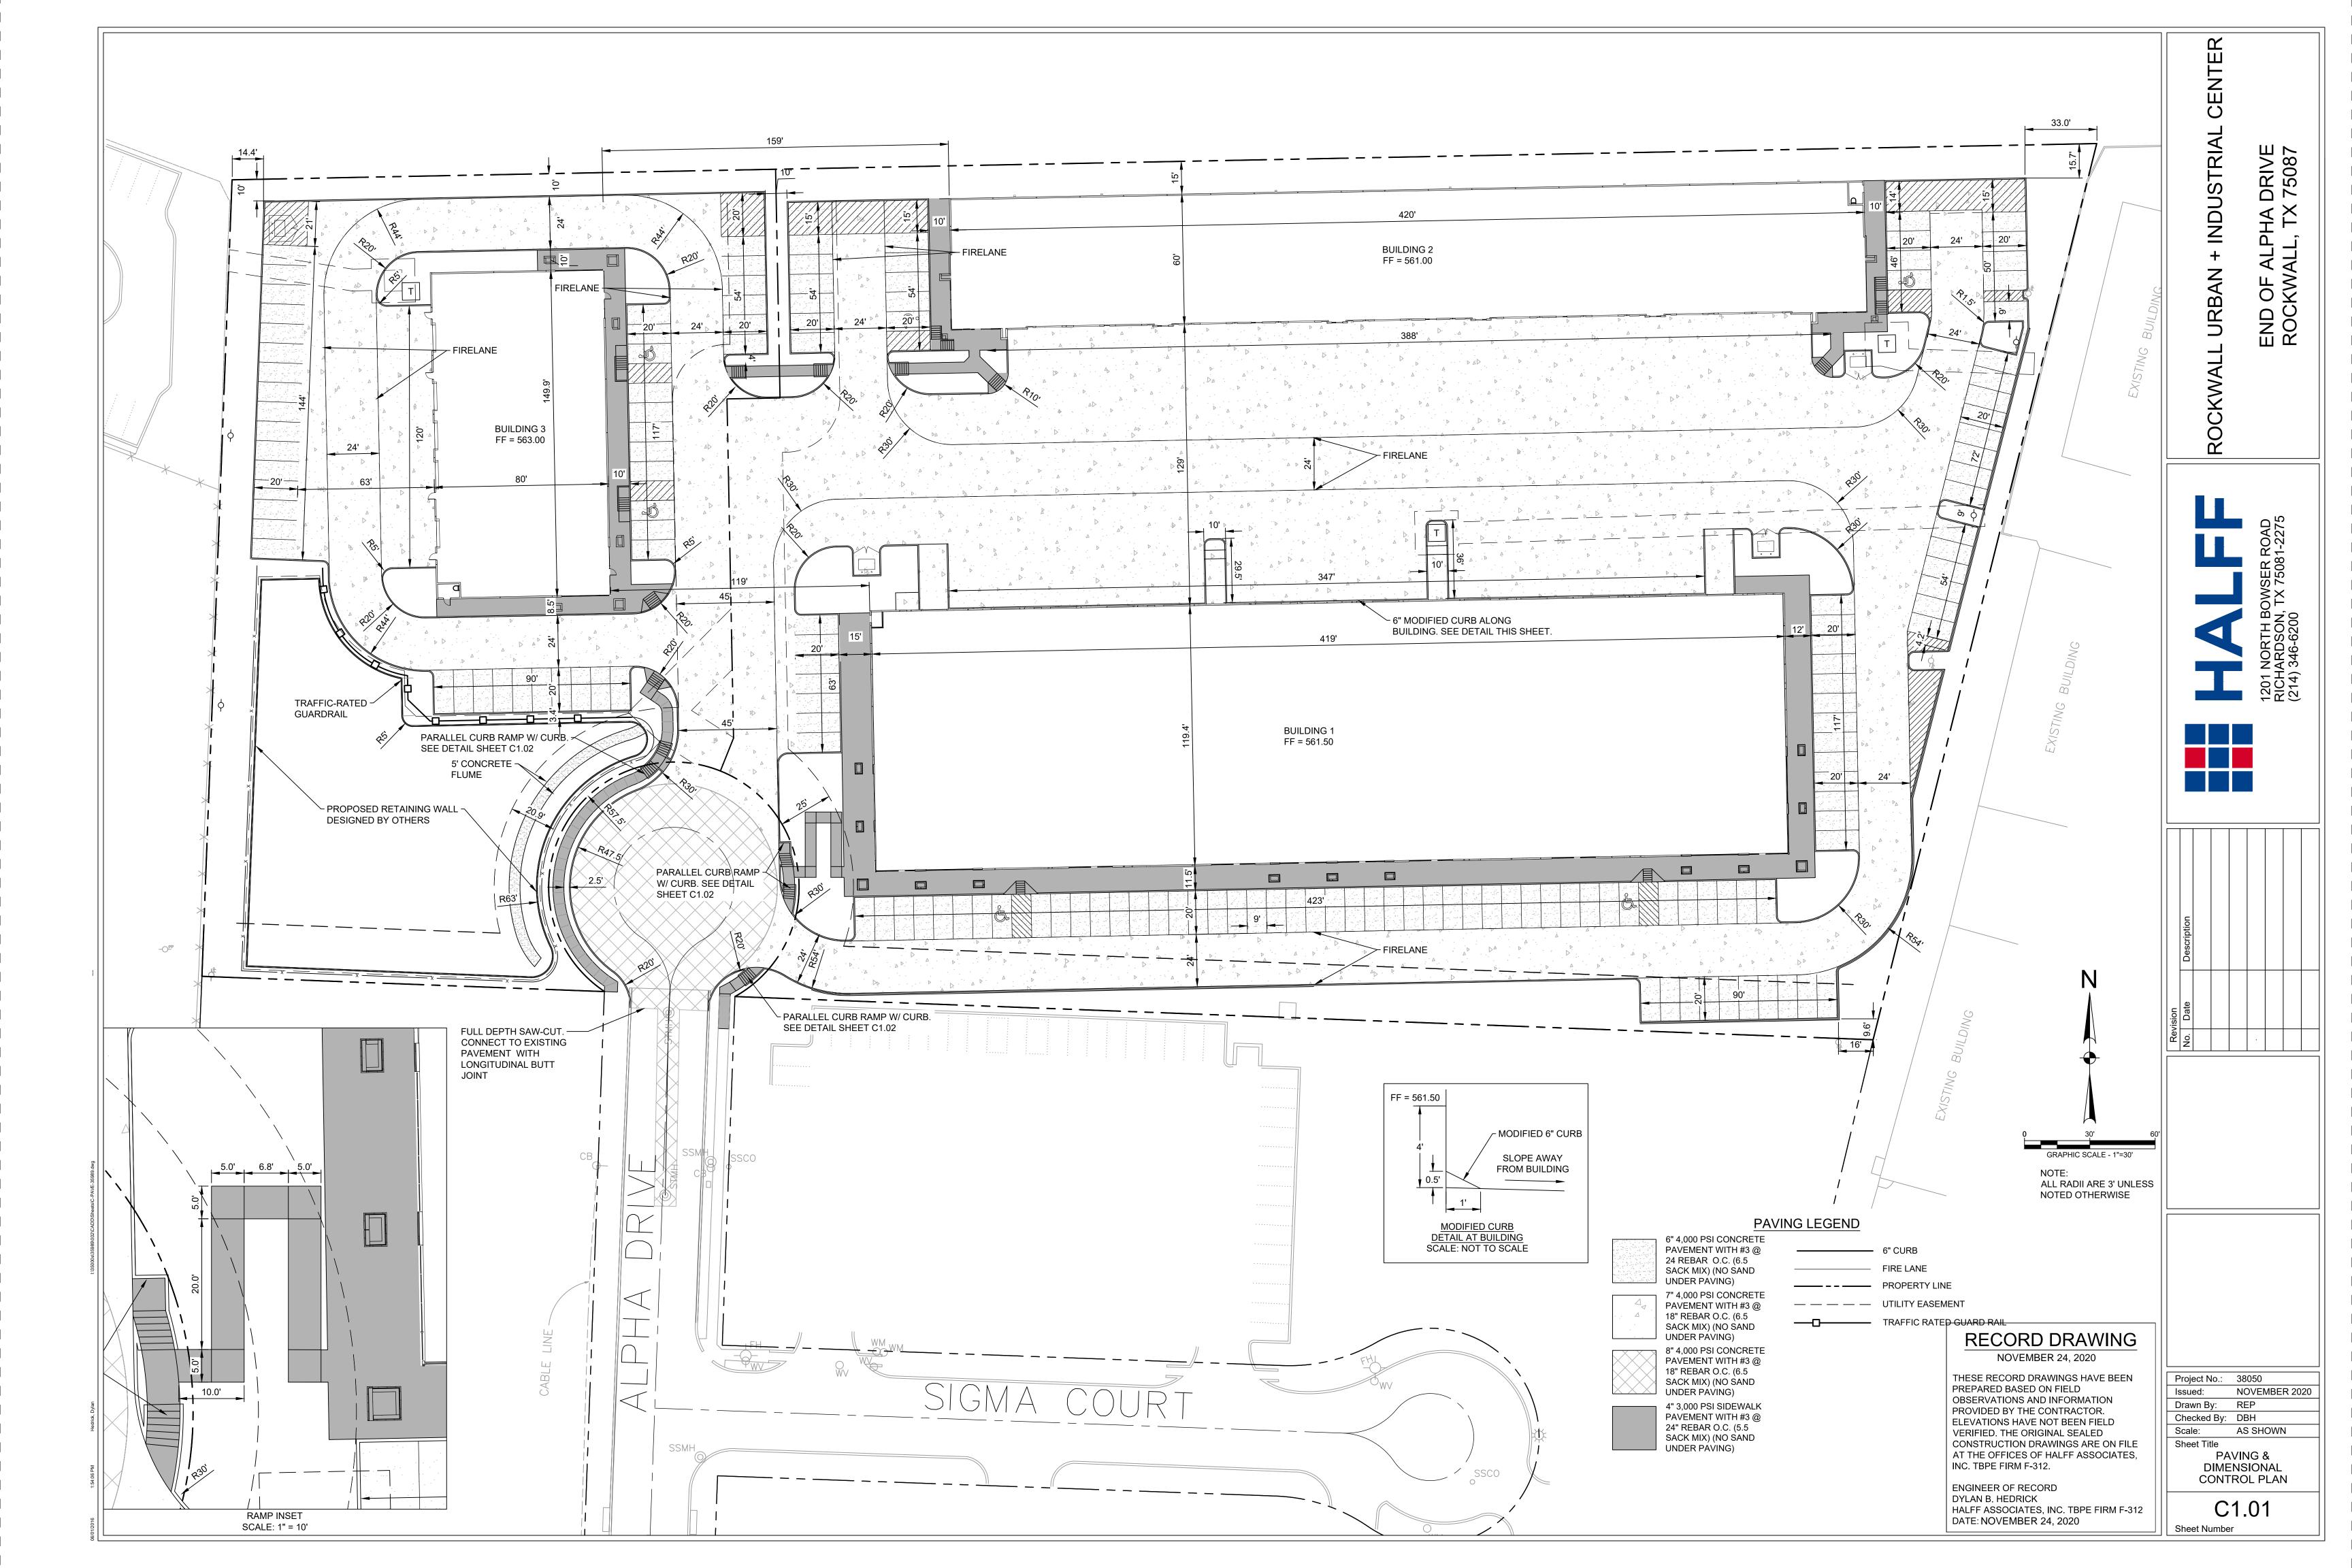

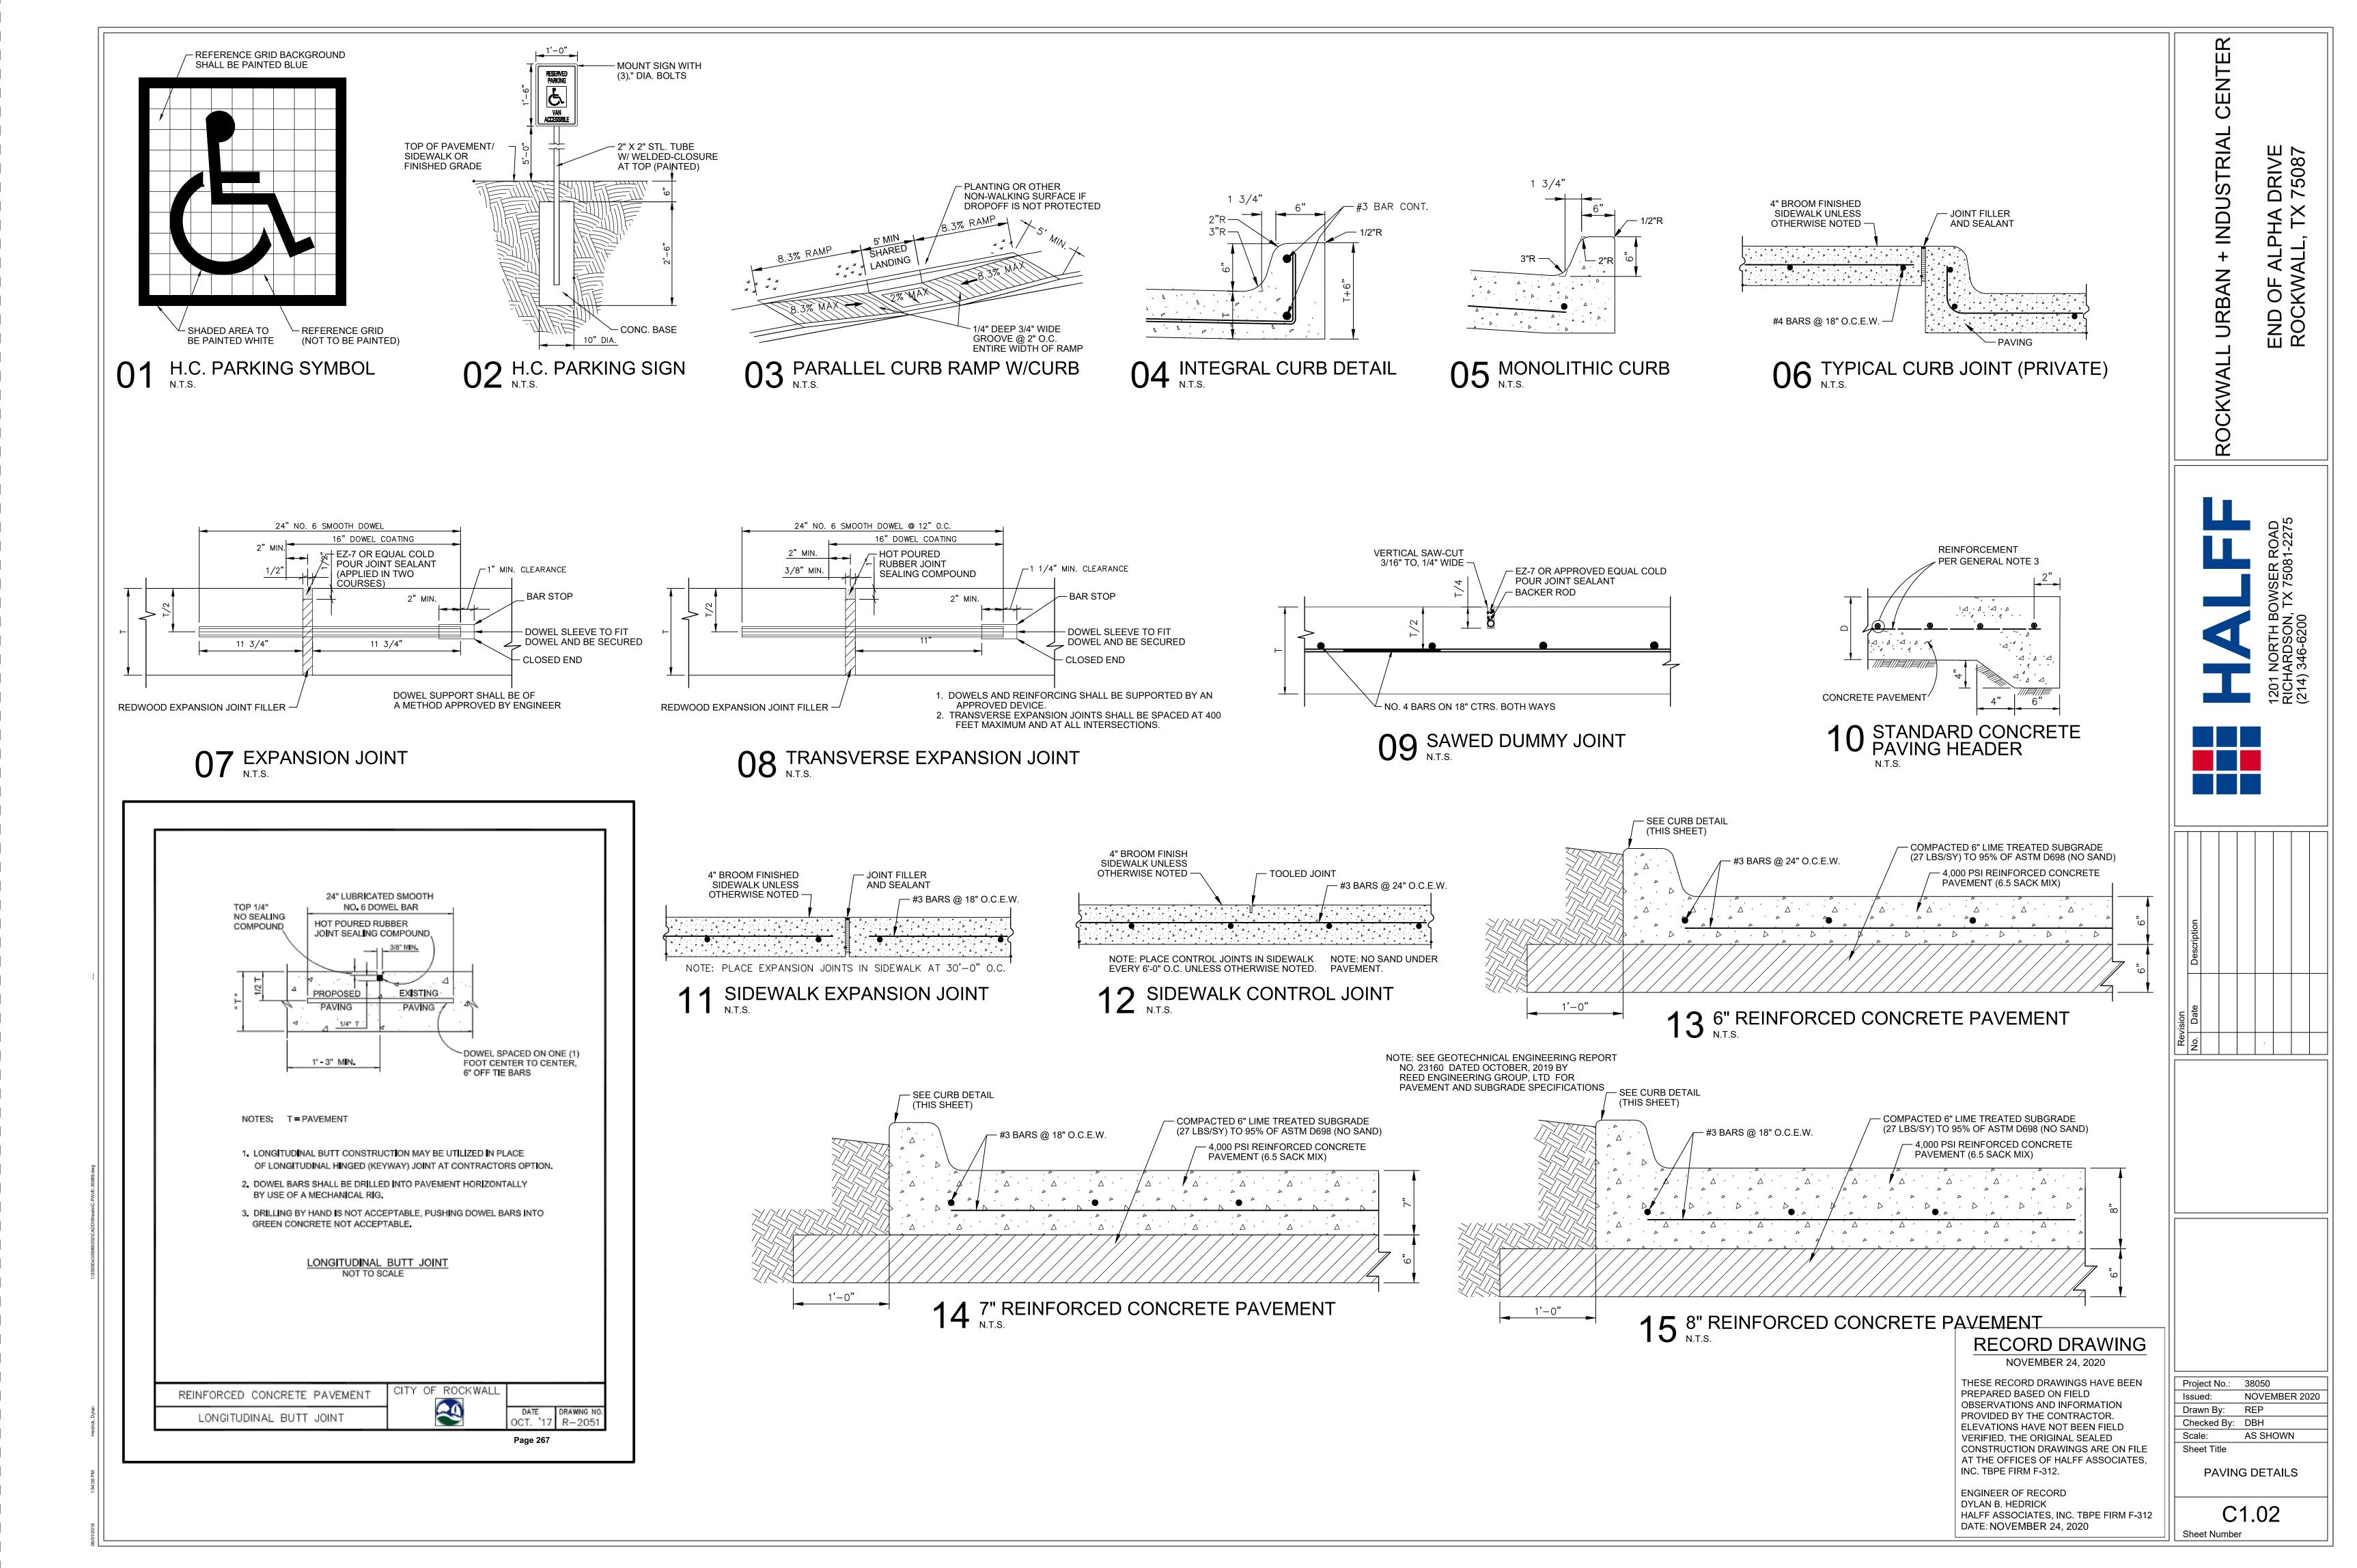





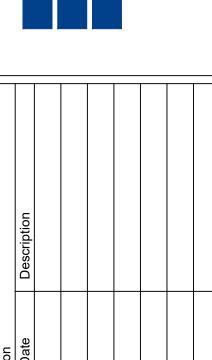

RECORD DRAWING

NOVEMBER 24, 2020

THESE RECORD DRAWINGS HAVE BEEN

OBSERVATIONS AND INFORMATION

ELEVATIONS HAVE NOT BEEN FIELD

CONSTRUCTION DRAWINGS ARE ON FILE

AT THE OFFICES OF HALFF ASSOCIATES,

HALFF ASSOCIATES, INC. TBPE FIRM F-312

PROVIDED BY THE CONTRACTOR.


VERIFIED. THE ORIGINAL SEALED

PREPARED BASED ON FIELD

INC. TBPE FIRM F-312.

ENGINEER OF RECORD DYLAN B. HEDRICK

DATE: NOVEMBER 24, 2020

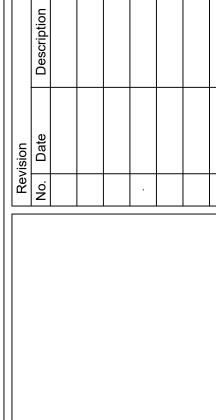




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Project No.: 38050
Issued: NOVEMBER 2020
Drawn By: REP
Checked By: DBH
Scale: AS SHOWN
Sheet Title


PAVING DETAILS

C1.03
Sheet Number

17 CONCRETE PILOT CHANNEL DETAIL

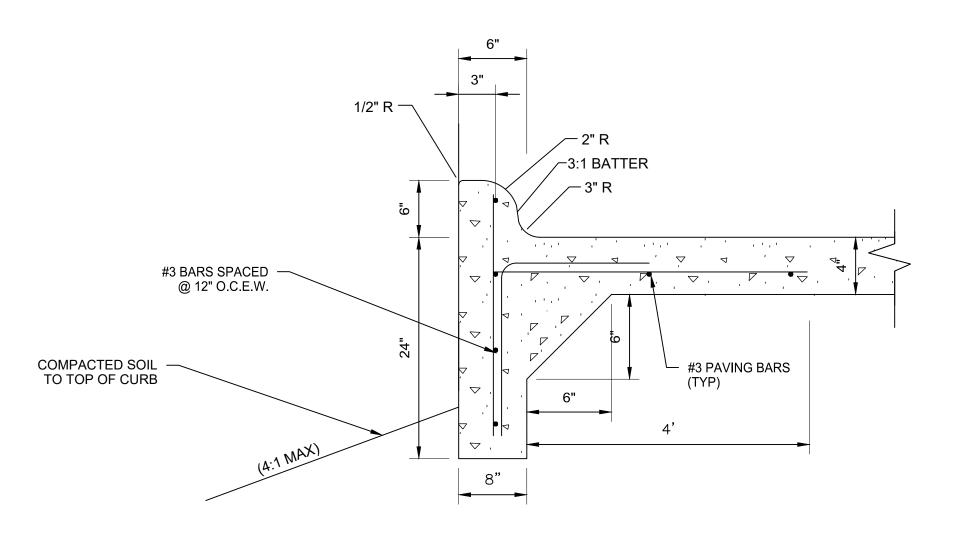

18 6" INTEGRAL CURB W/ TOE DOWN

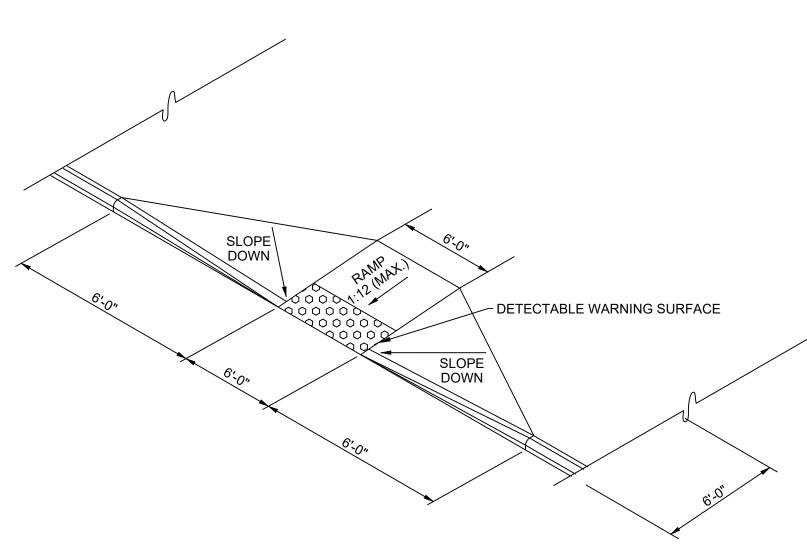

∠ FL OF BOX CULVERT

- 5'x2' BOX CULVERT

└- #6 x 24" SMOOTH DOWEL BAR AT 24" C/C EPOXIED


INTO BOX CULVERT

19 CURB RAMP


#3 @ 18" O.C.E.W.

16 CONCRETE PILOT CHANNEL TO CULVERT CONNECTION DETAIL N.T.S.


CONCRETE PILOT CHANNEL

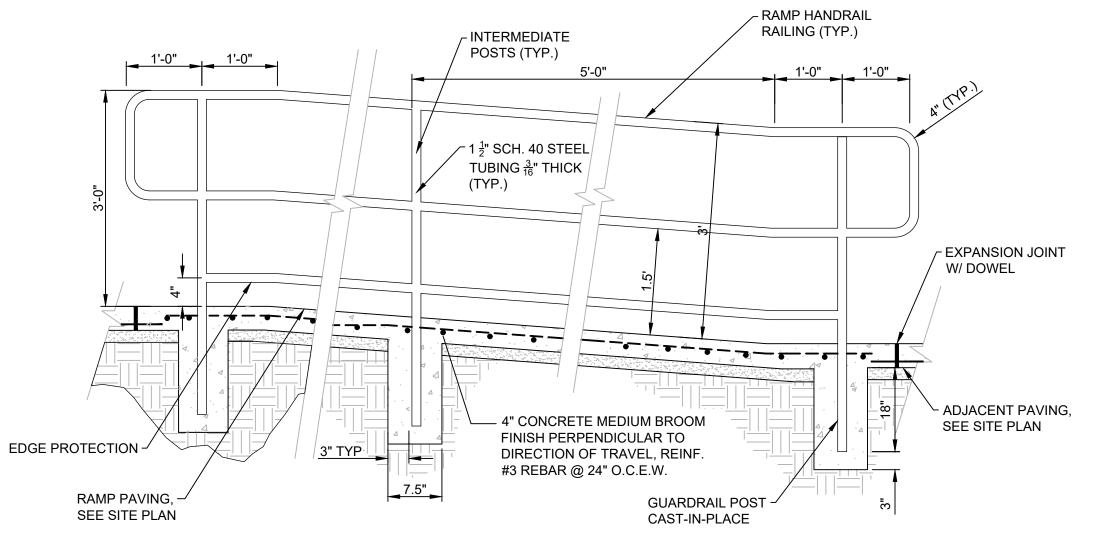

20 SWITCHBACK RAMP AND HANDRAIL DETAIL

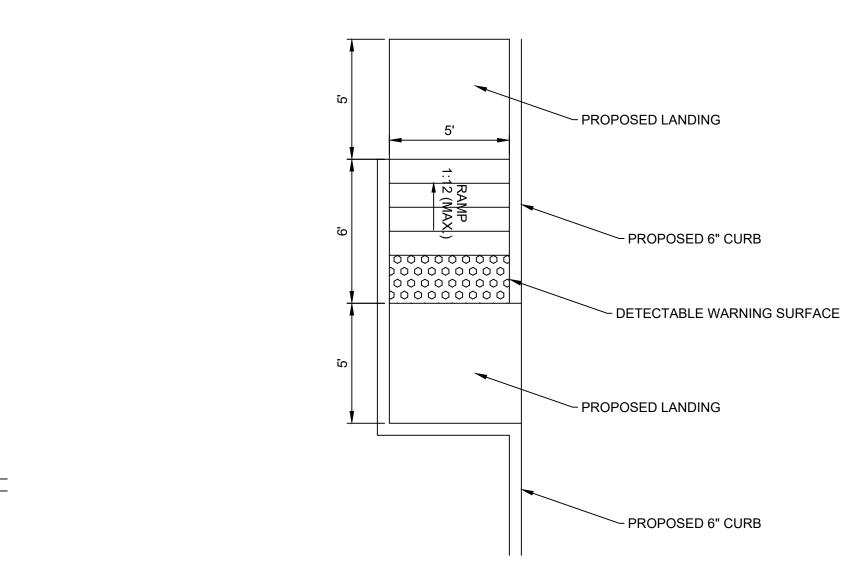


22 CURB RAMP AT BUILDING 3

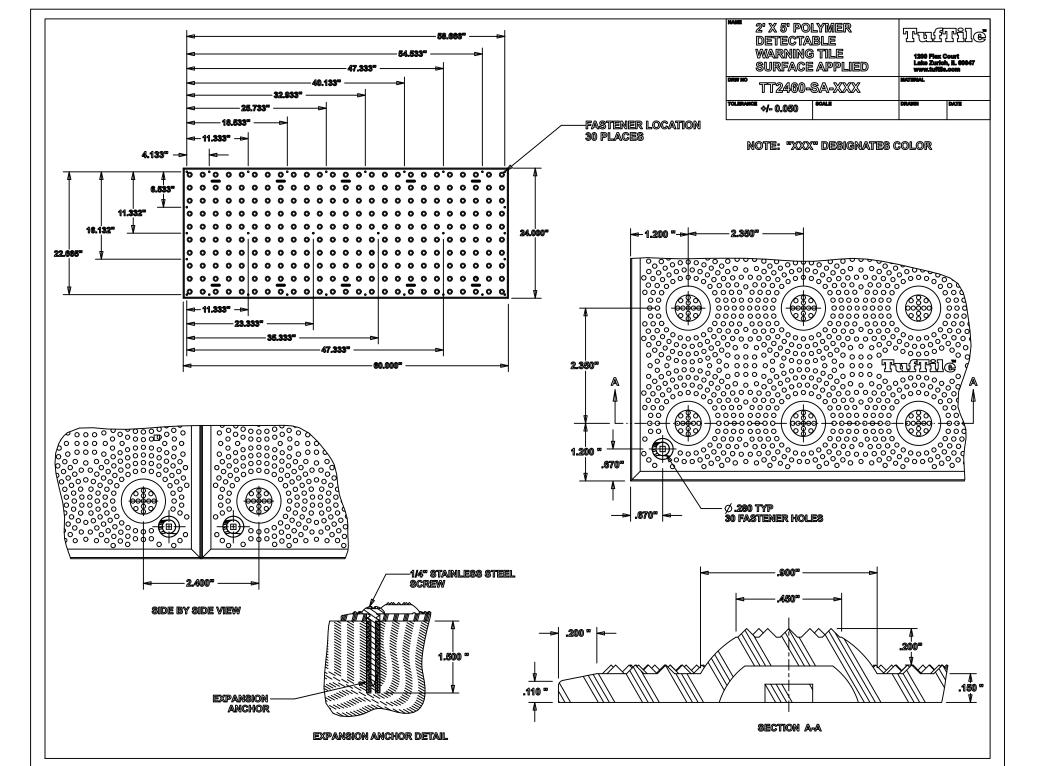



23 DETECTIBLE WARNING SURFACE DETAIL


N.T.S. (SURFACE MAY TUFTILE OR APPROVED EQUAL)

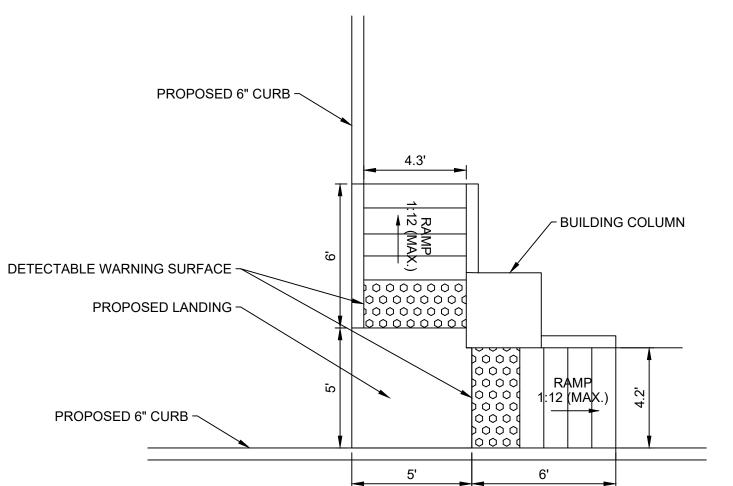



21 CURB RAMP AT BUILDING 2

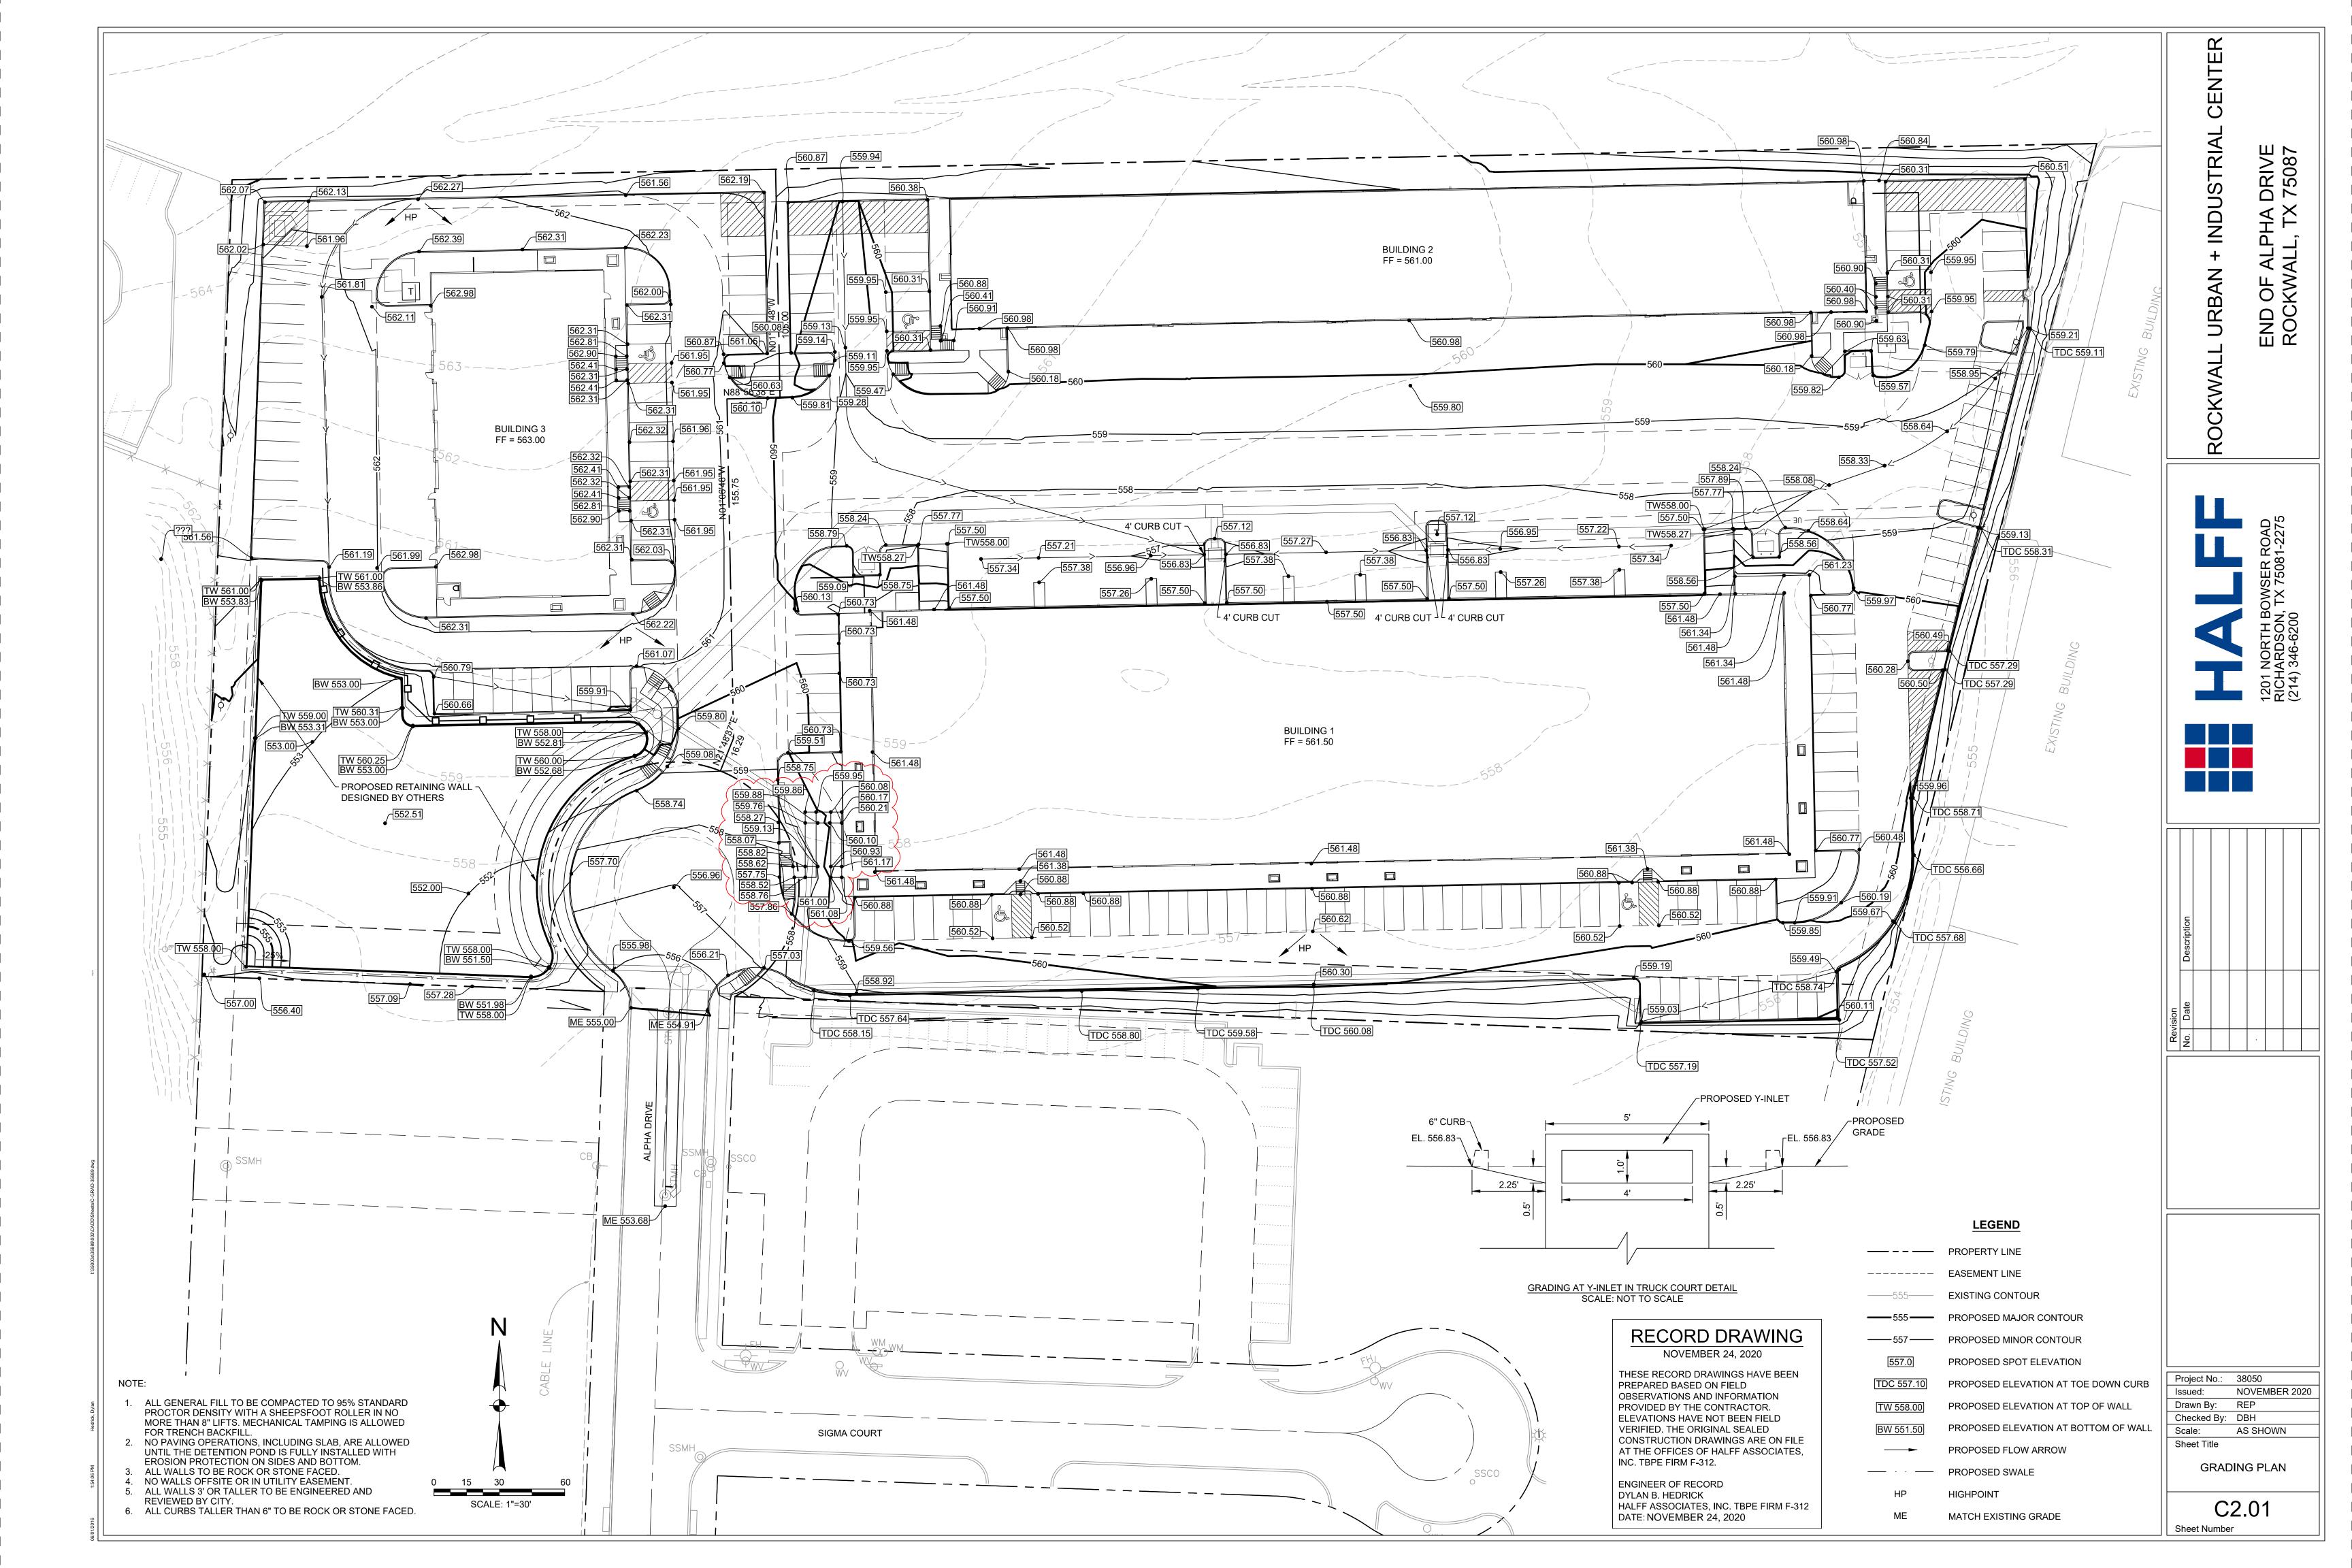


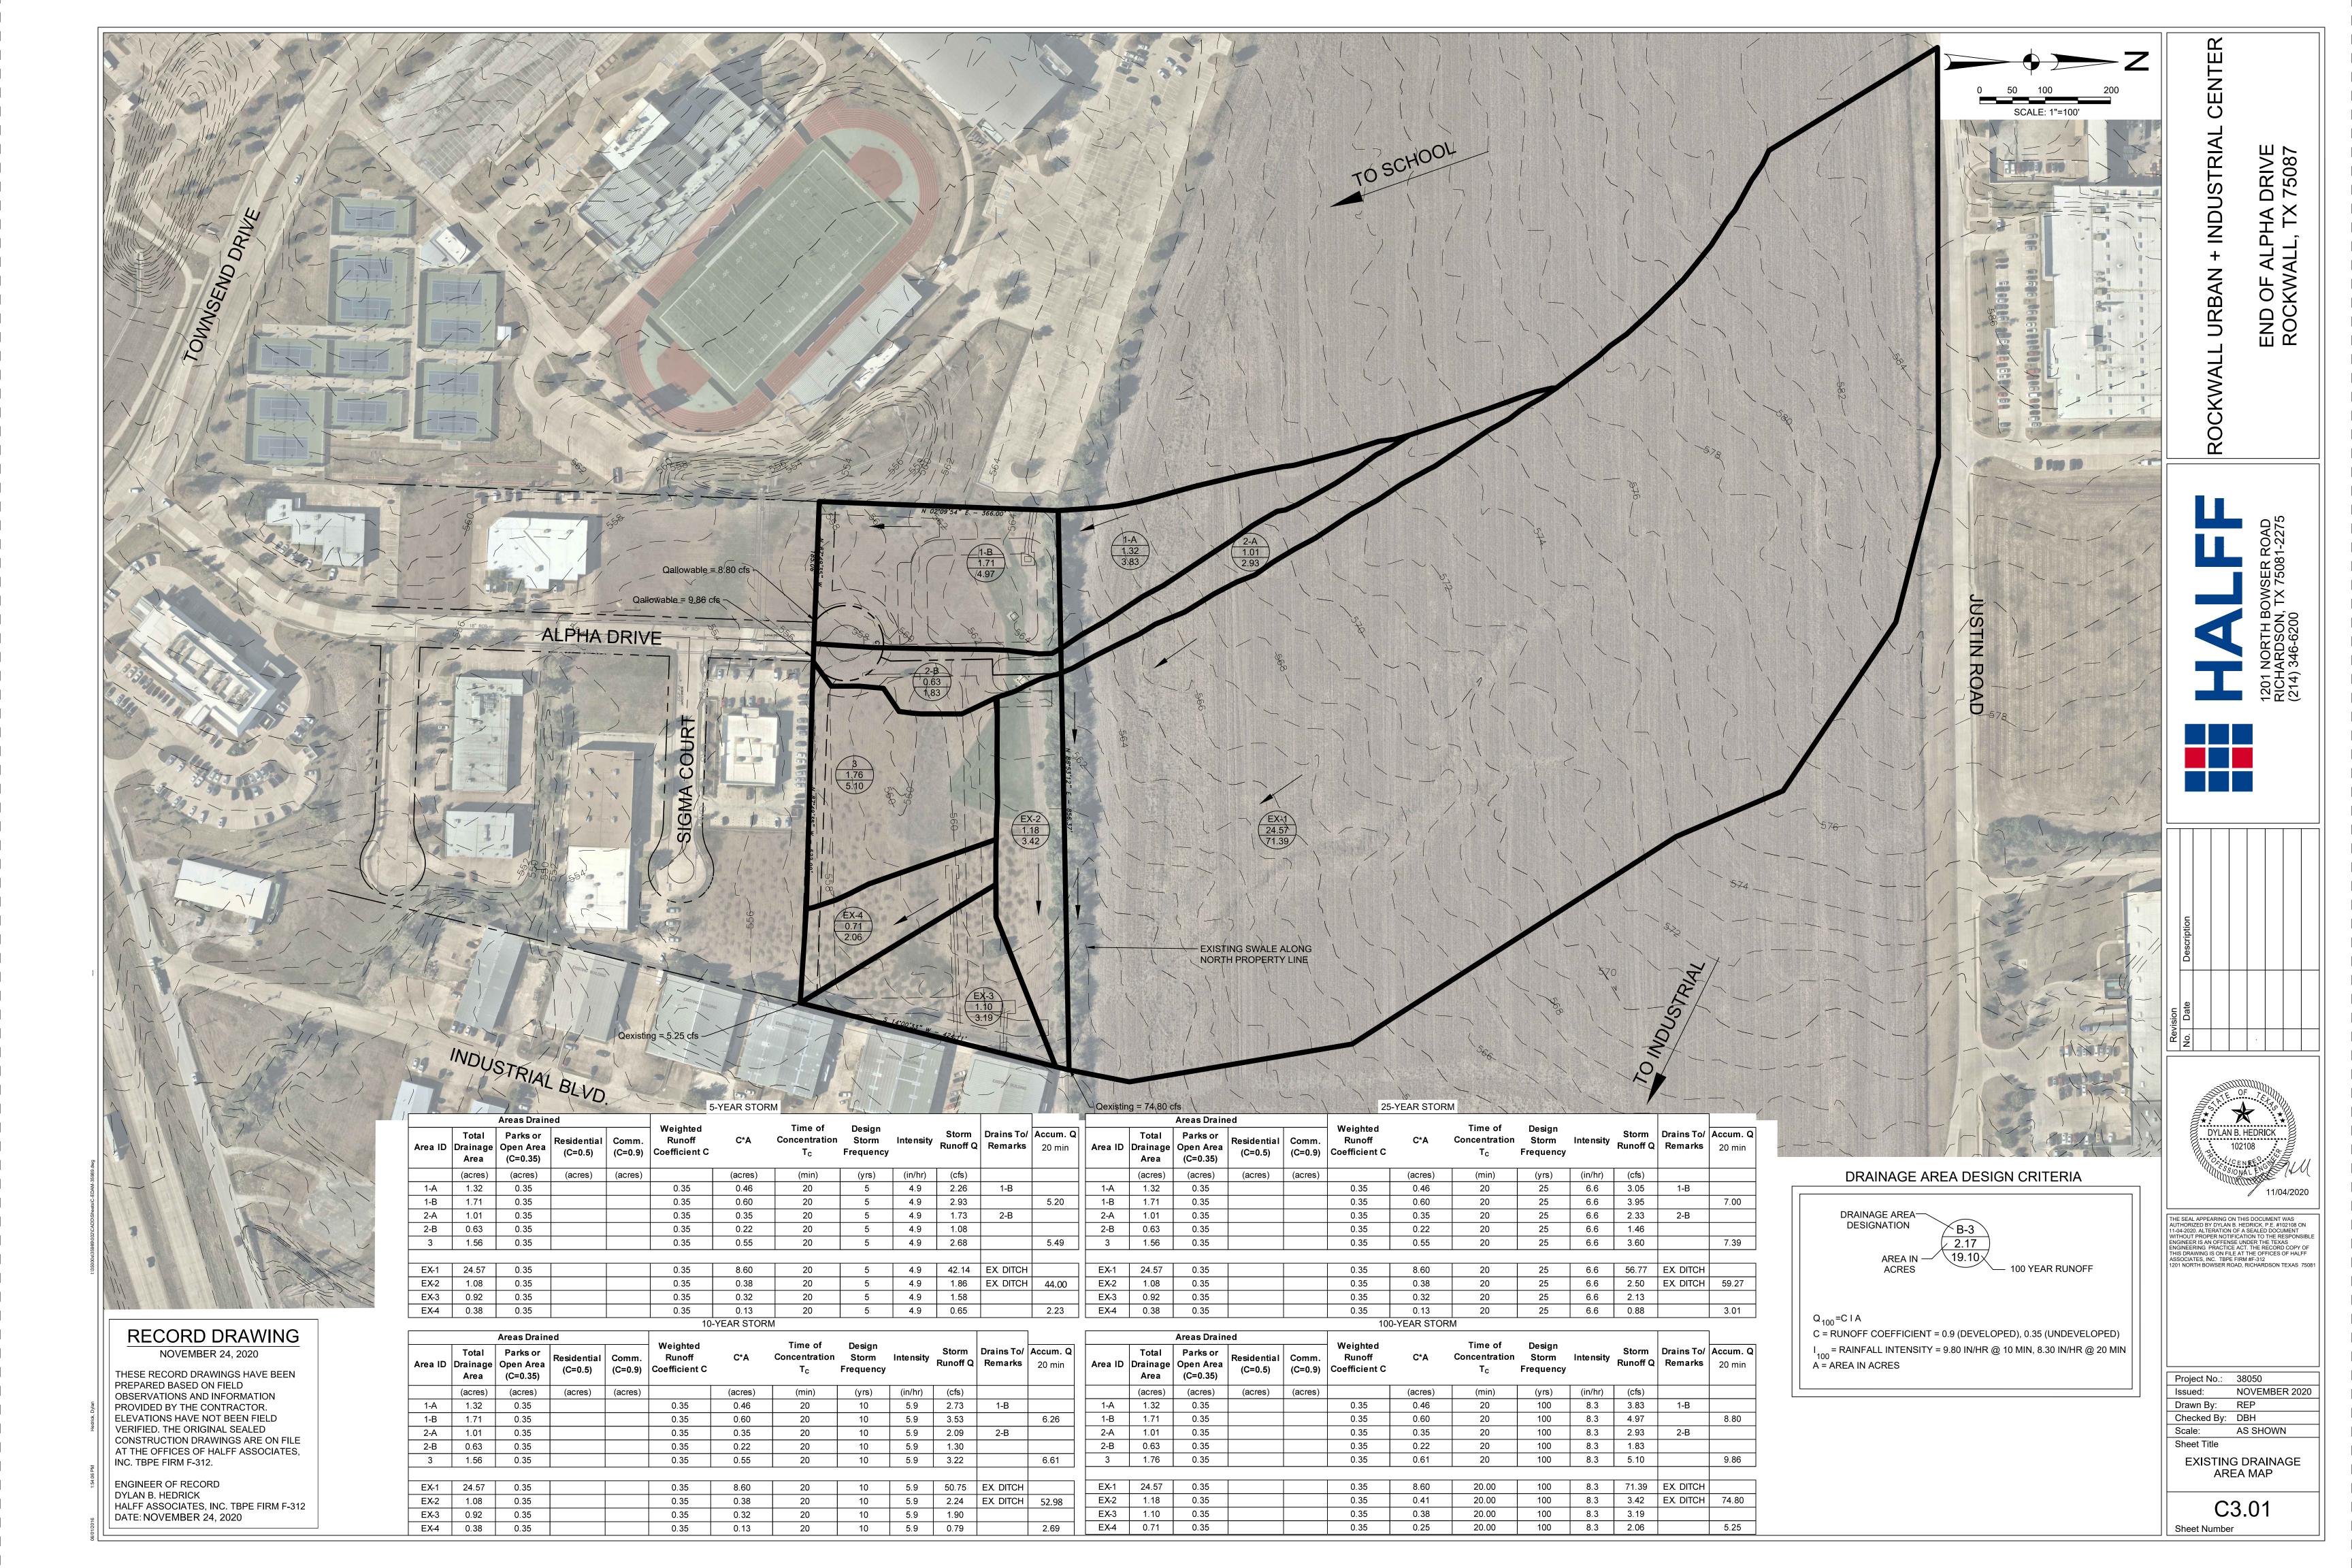

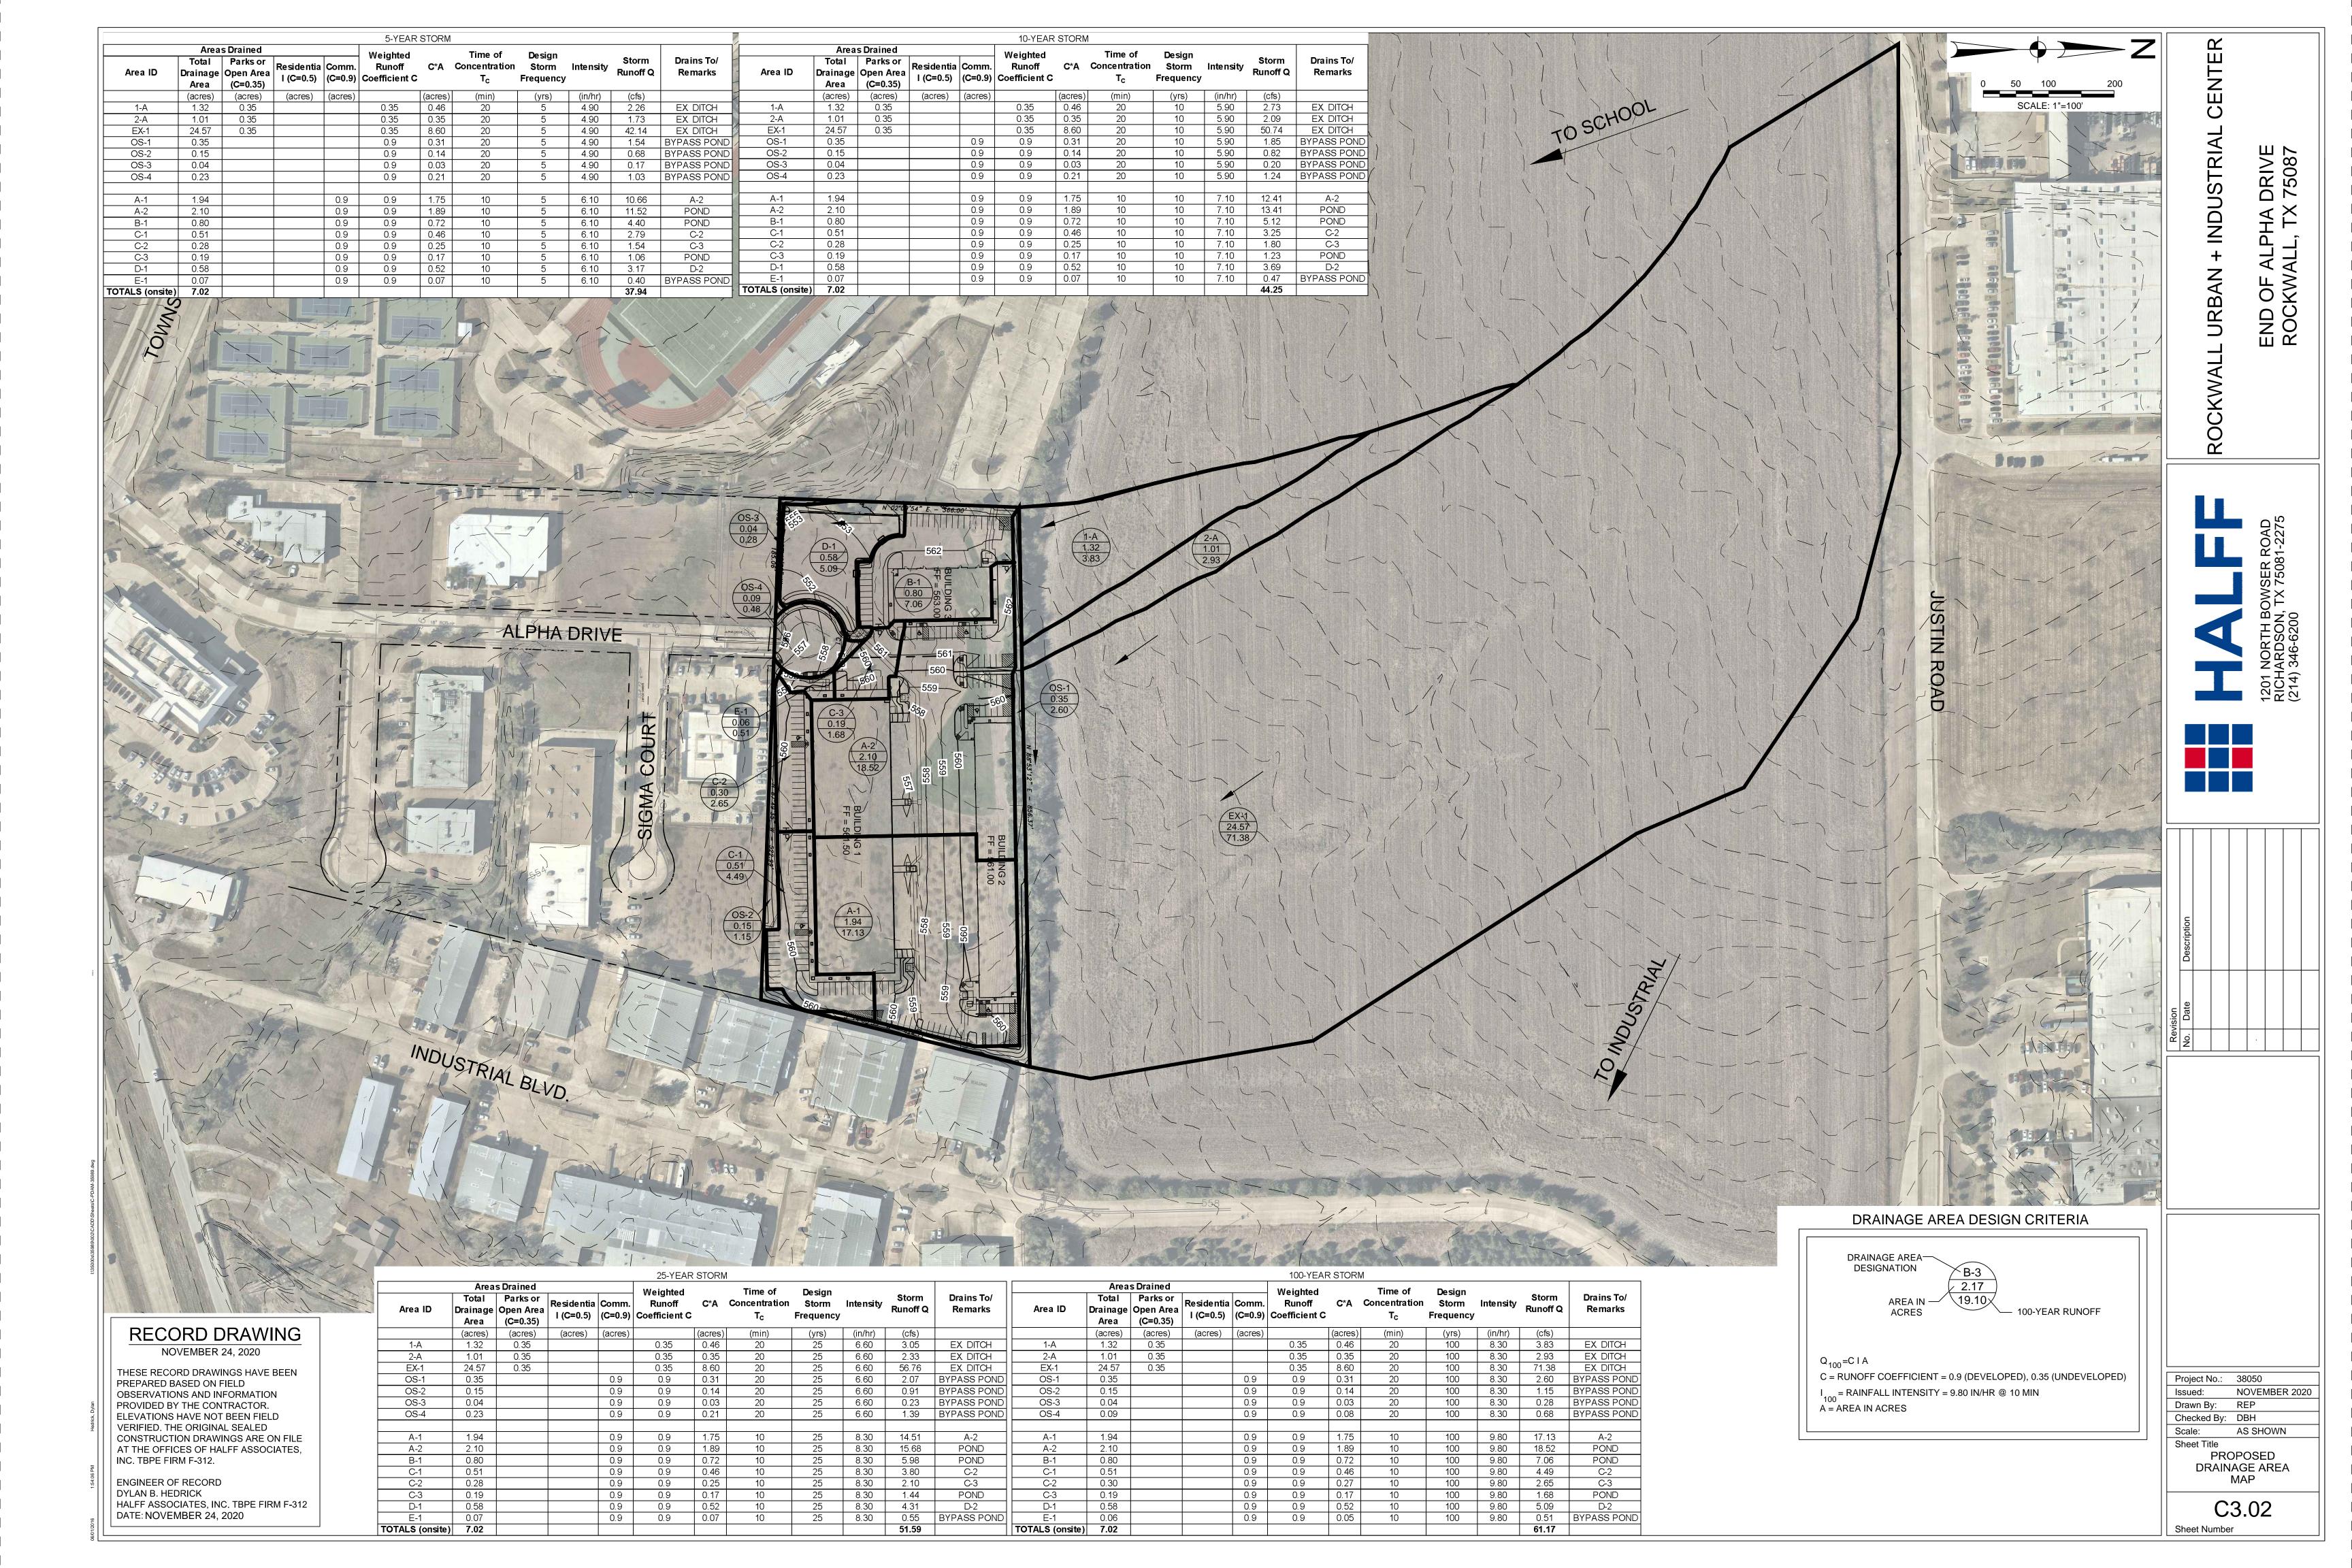

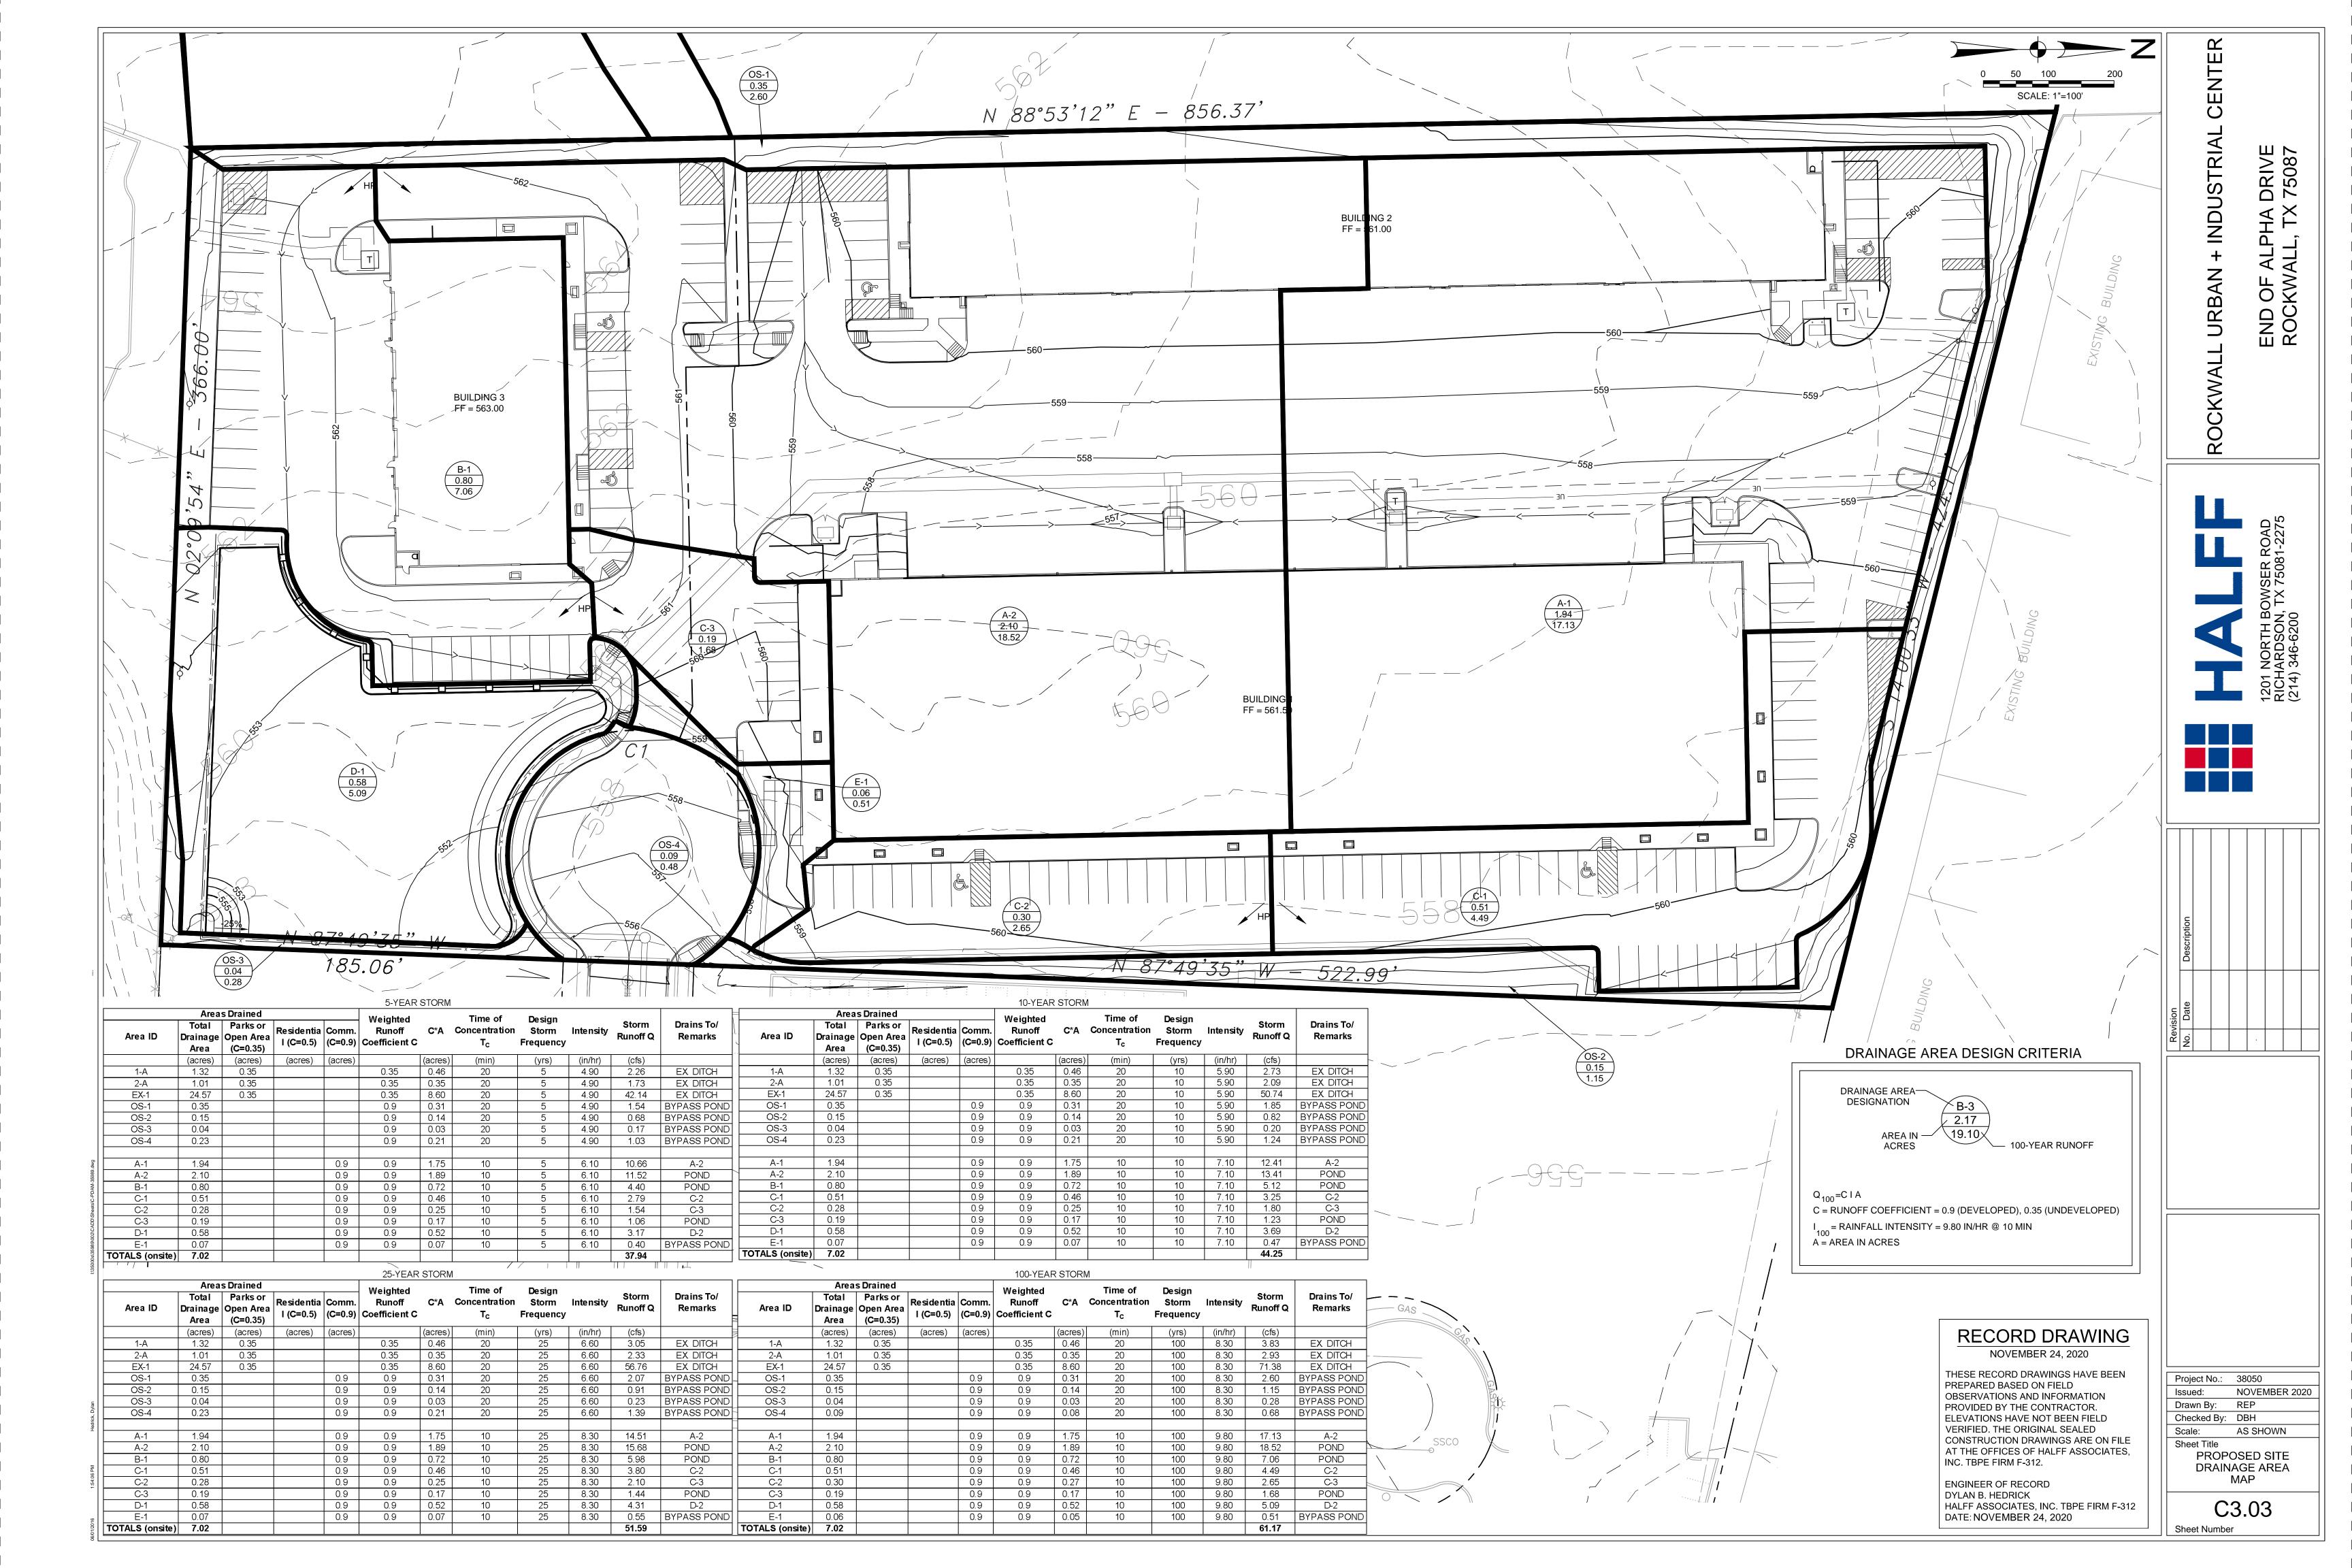


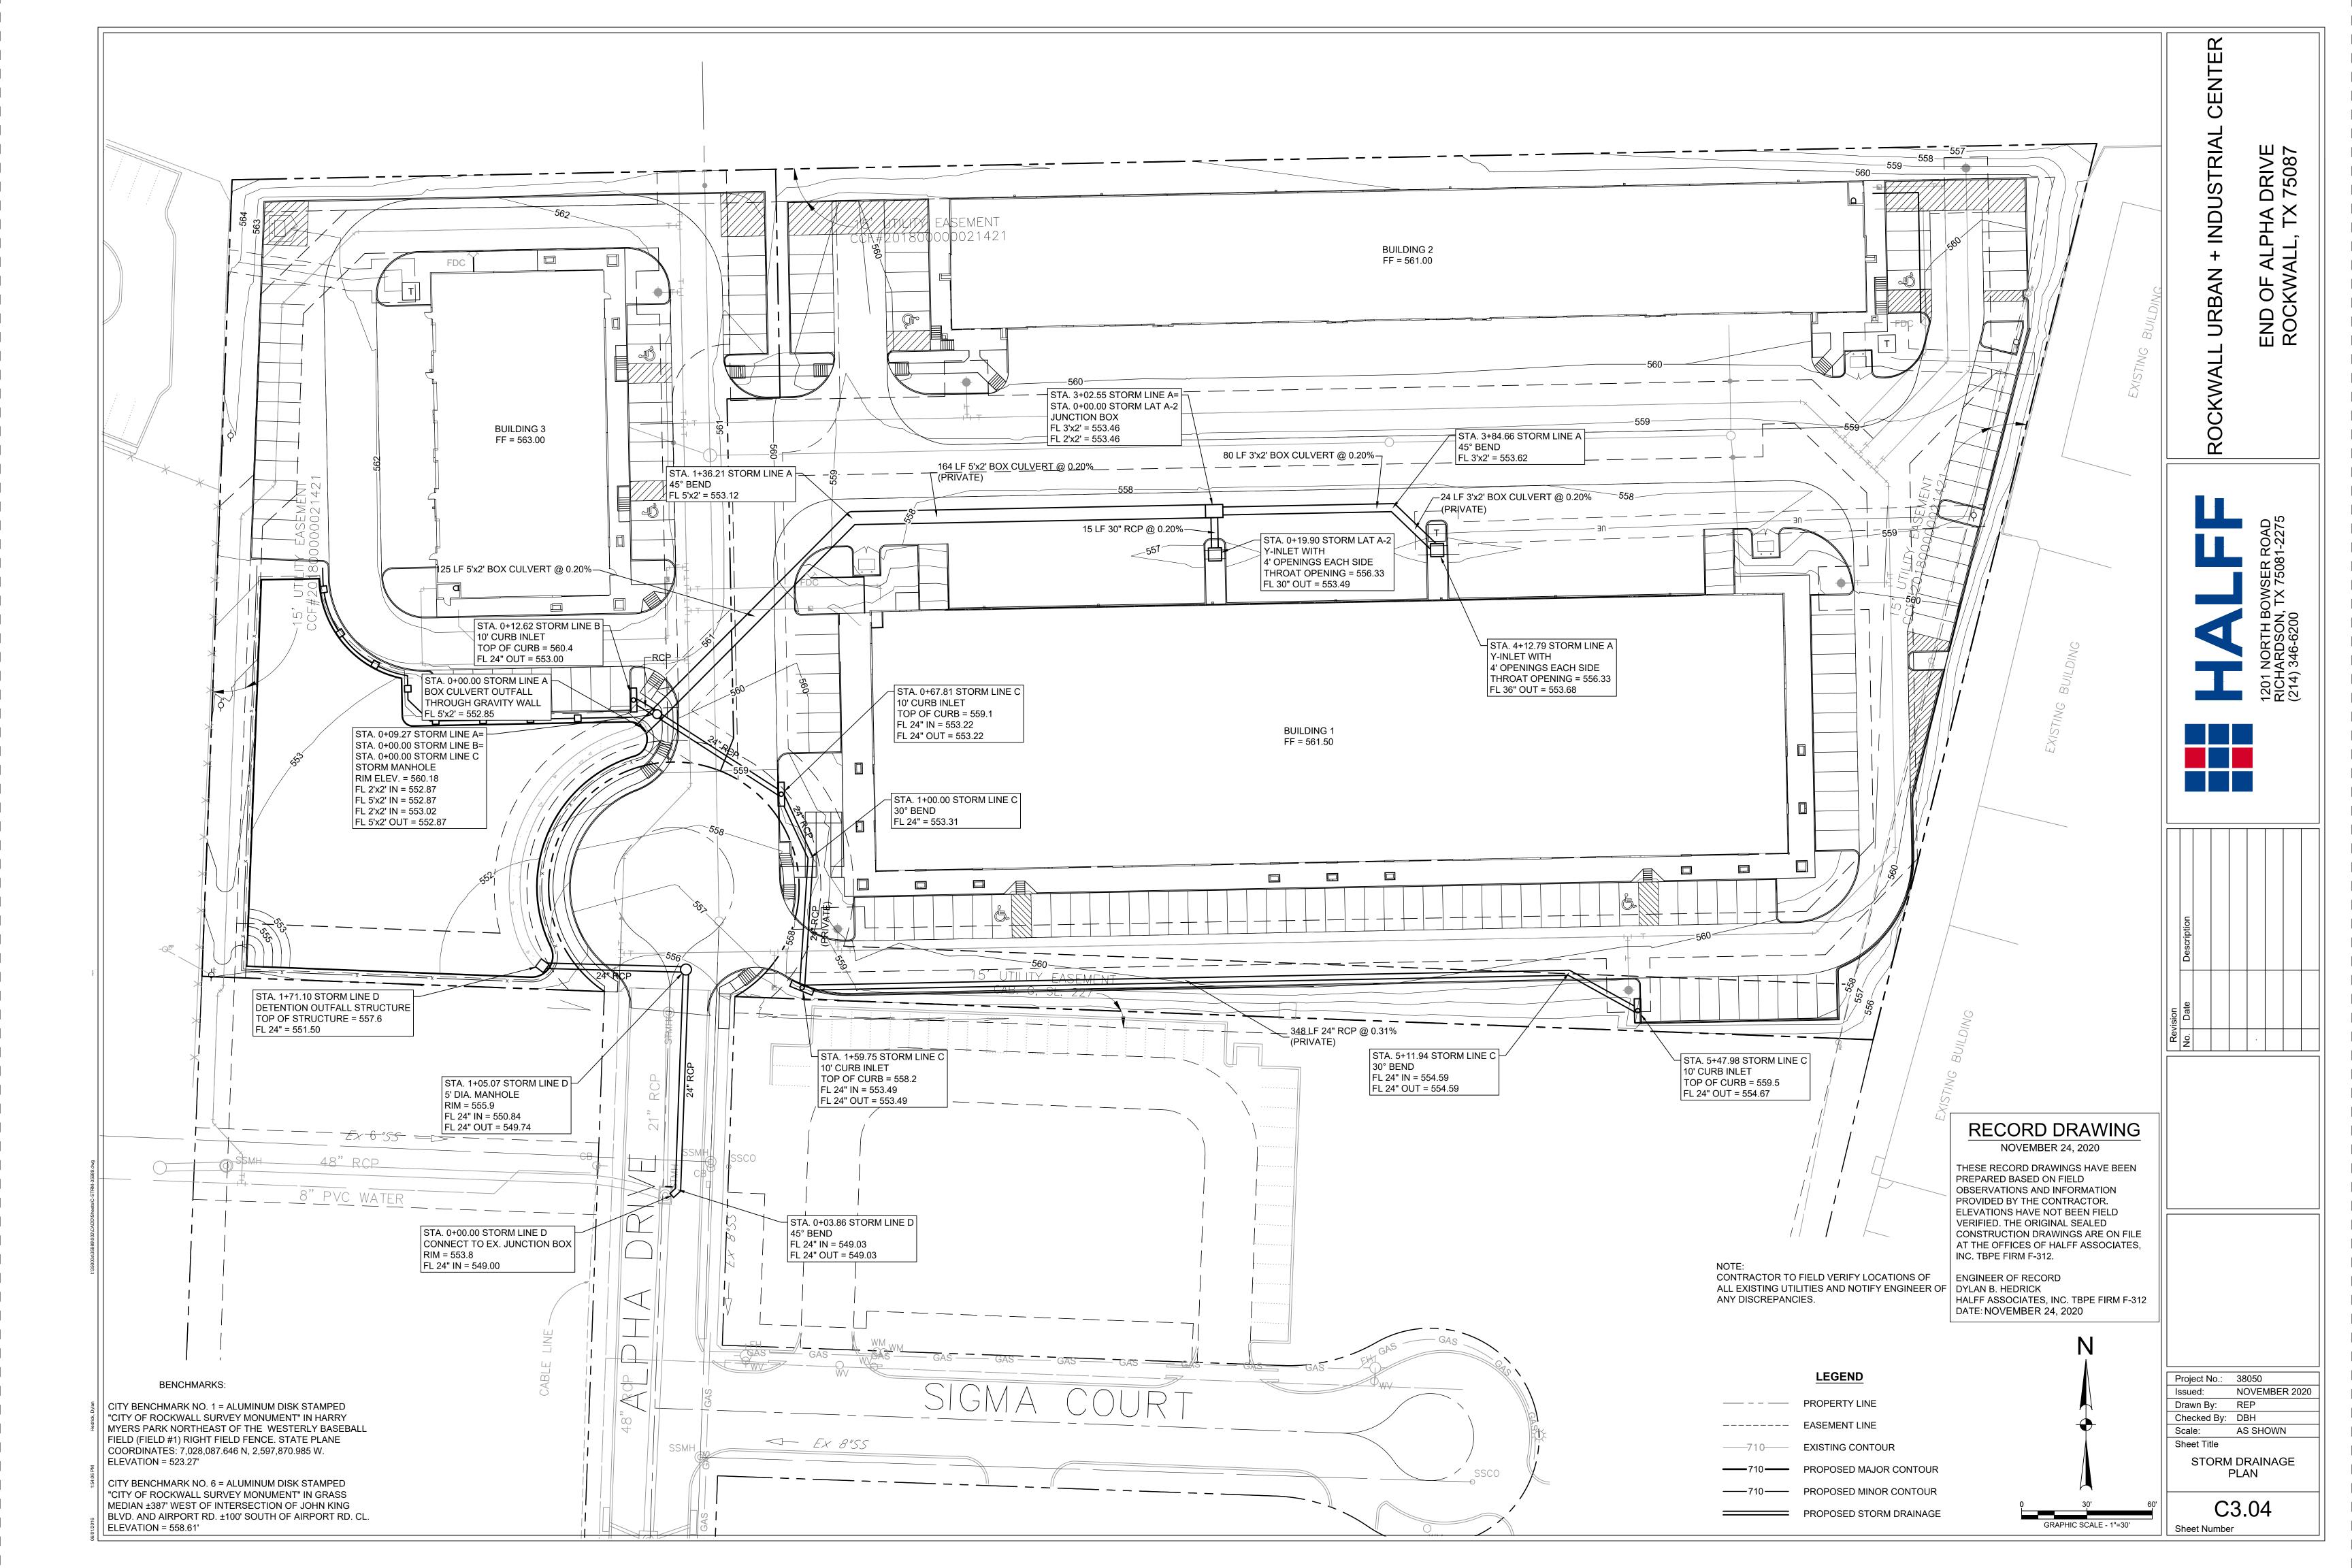

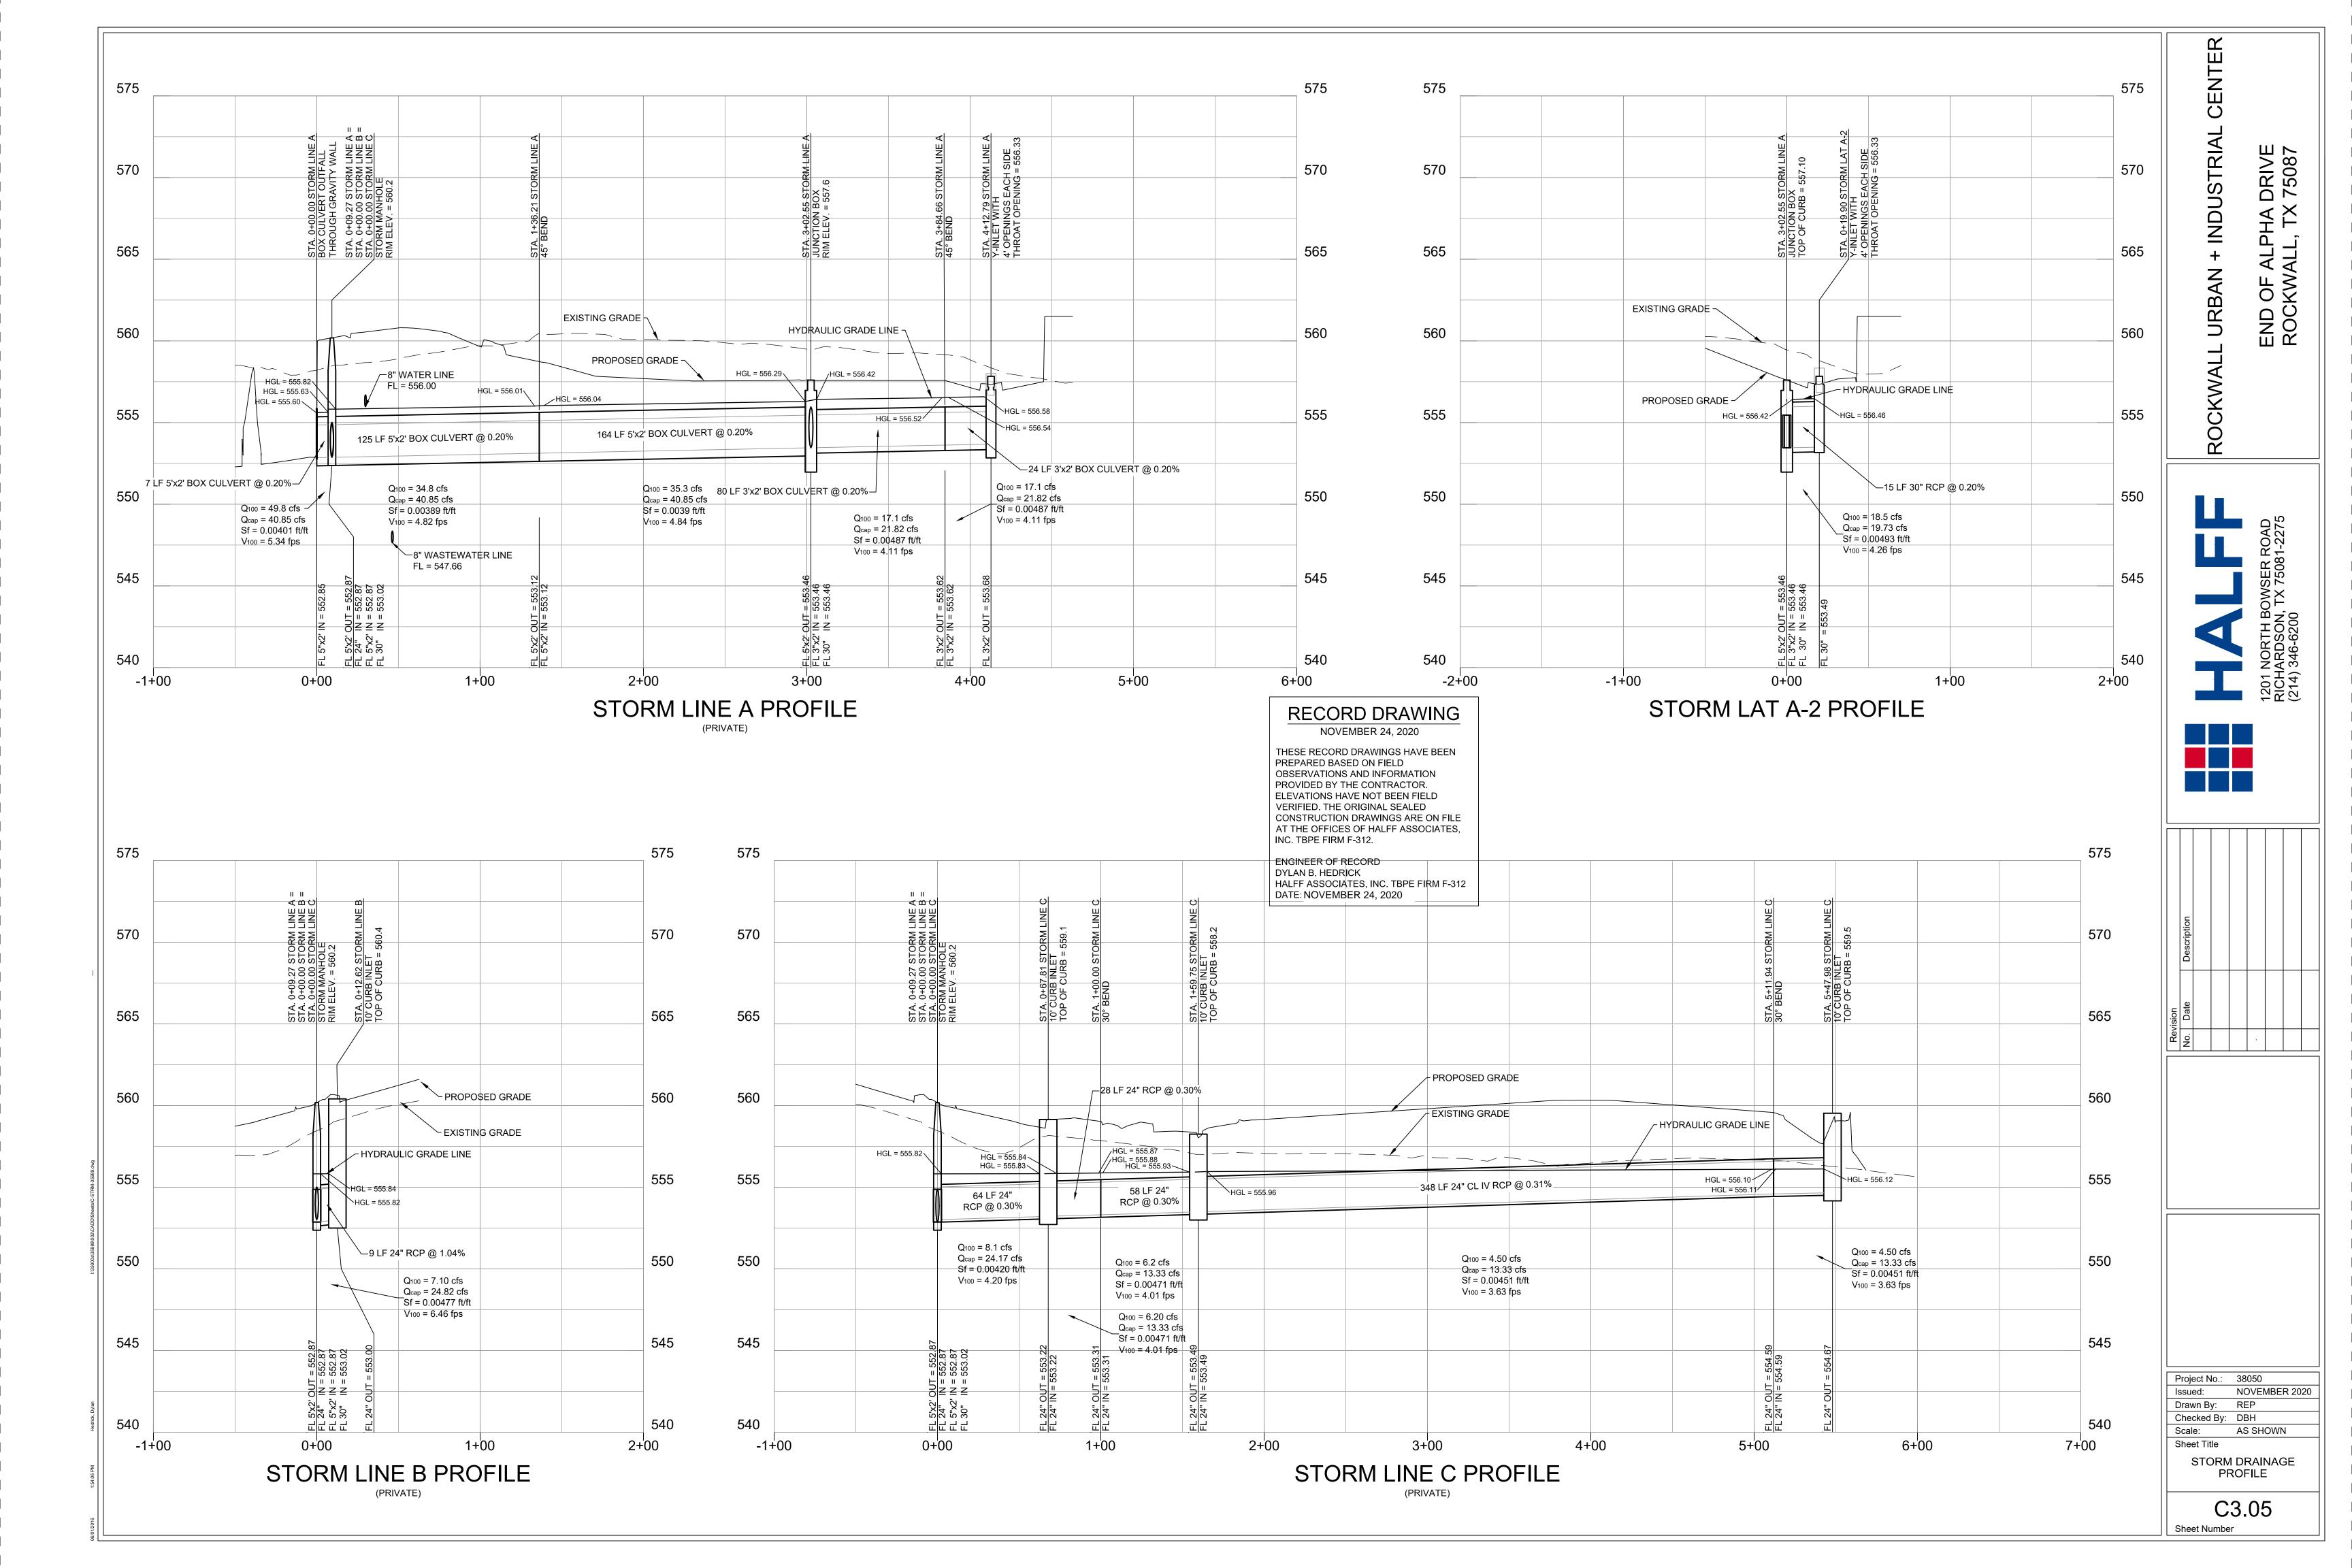

ROCKWALL URBAN + INDUSTRIAL CENTER END OF ALPHA DRIVE ROCKWALL, TX 75087

1201 NORTH BOWSER ROAD RICHARDSON, TX 75081-2275 (214) 346-6200

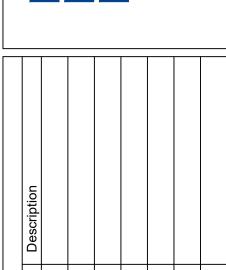

RECORD DRAWING NOVEMBER 24, 2020


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ENGINEER OF RECORD
DYLAN B. HEDRICK
HALFF ASSOCIATES, INC. TBPE FIRM F-312
DATE: NOVEMBER 24, 2020

Project No.:	38050
Issued:	NOVEMBER 2020
Drawn By:	REP
Checked By:	DBH
Scale:	AS SHOWN
Sheet Title	_

C3.06
Sheet Number

STORM DRAINAGE PROFILE

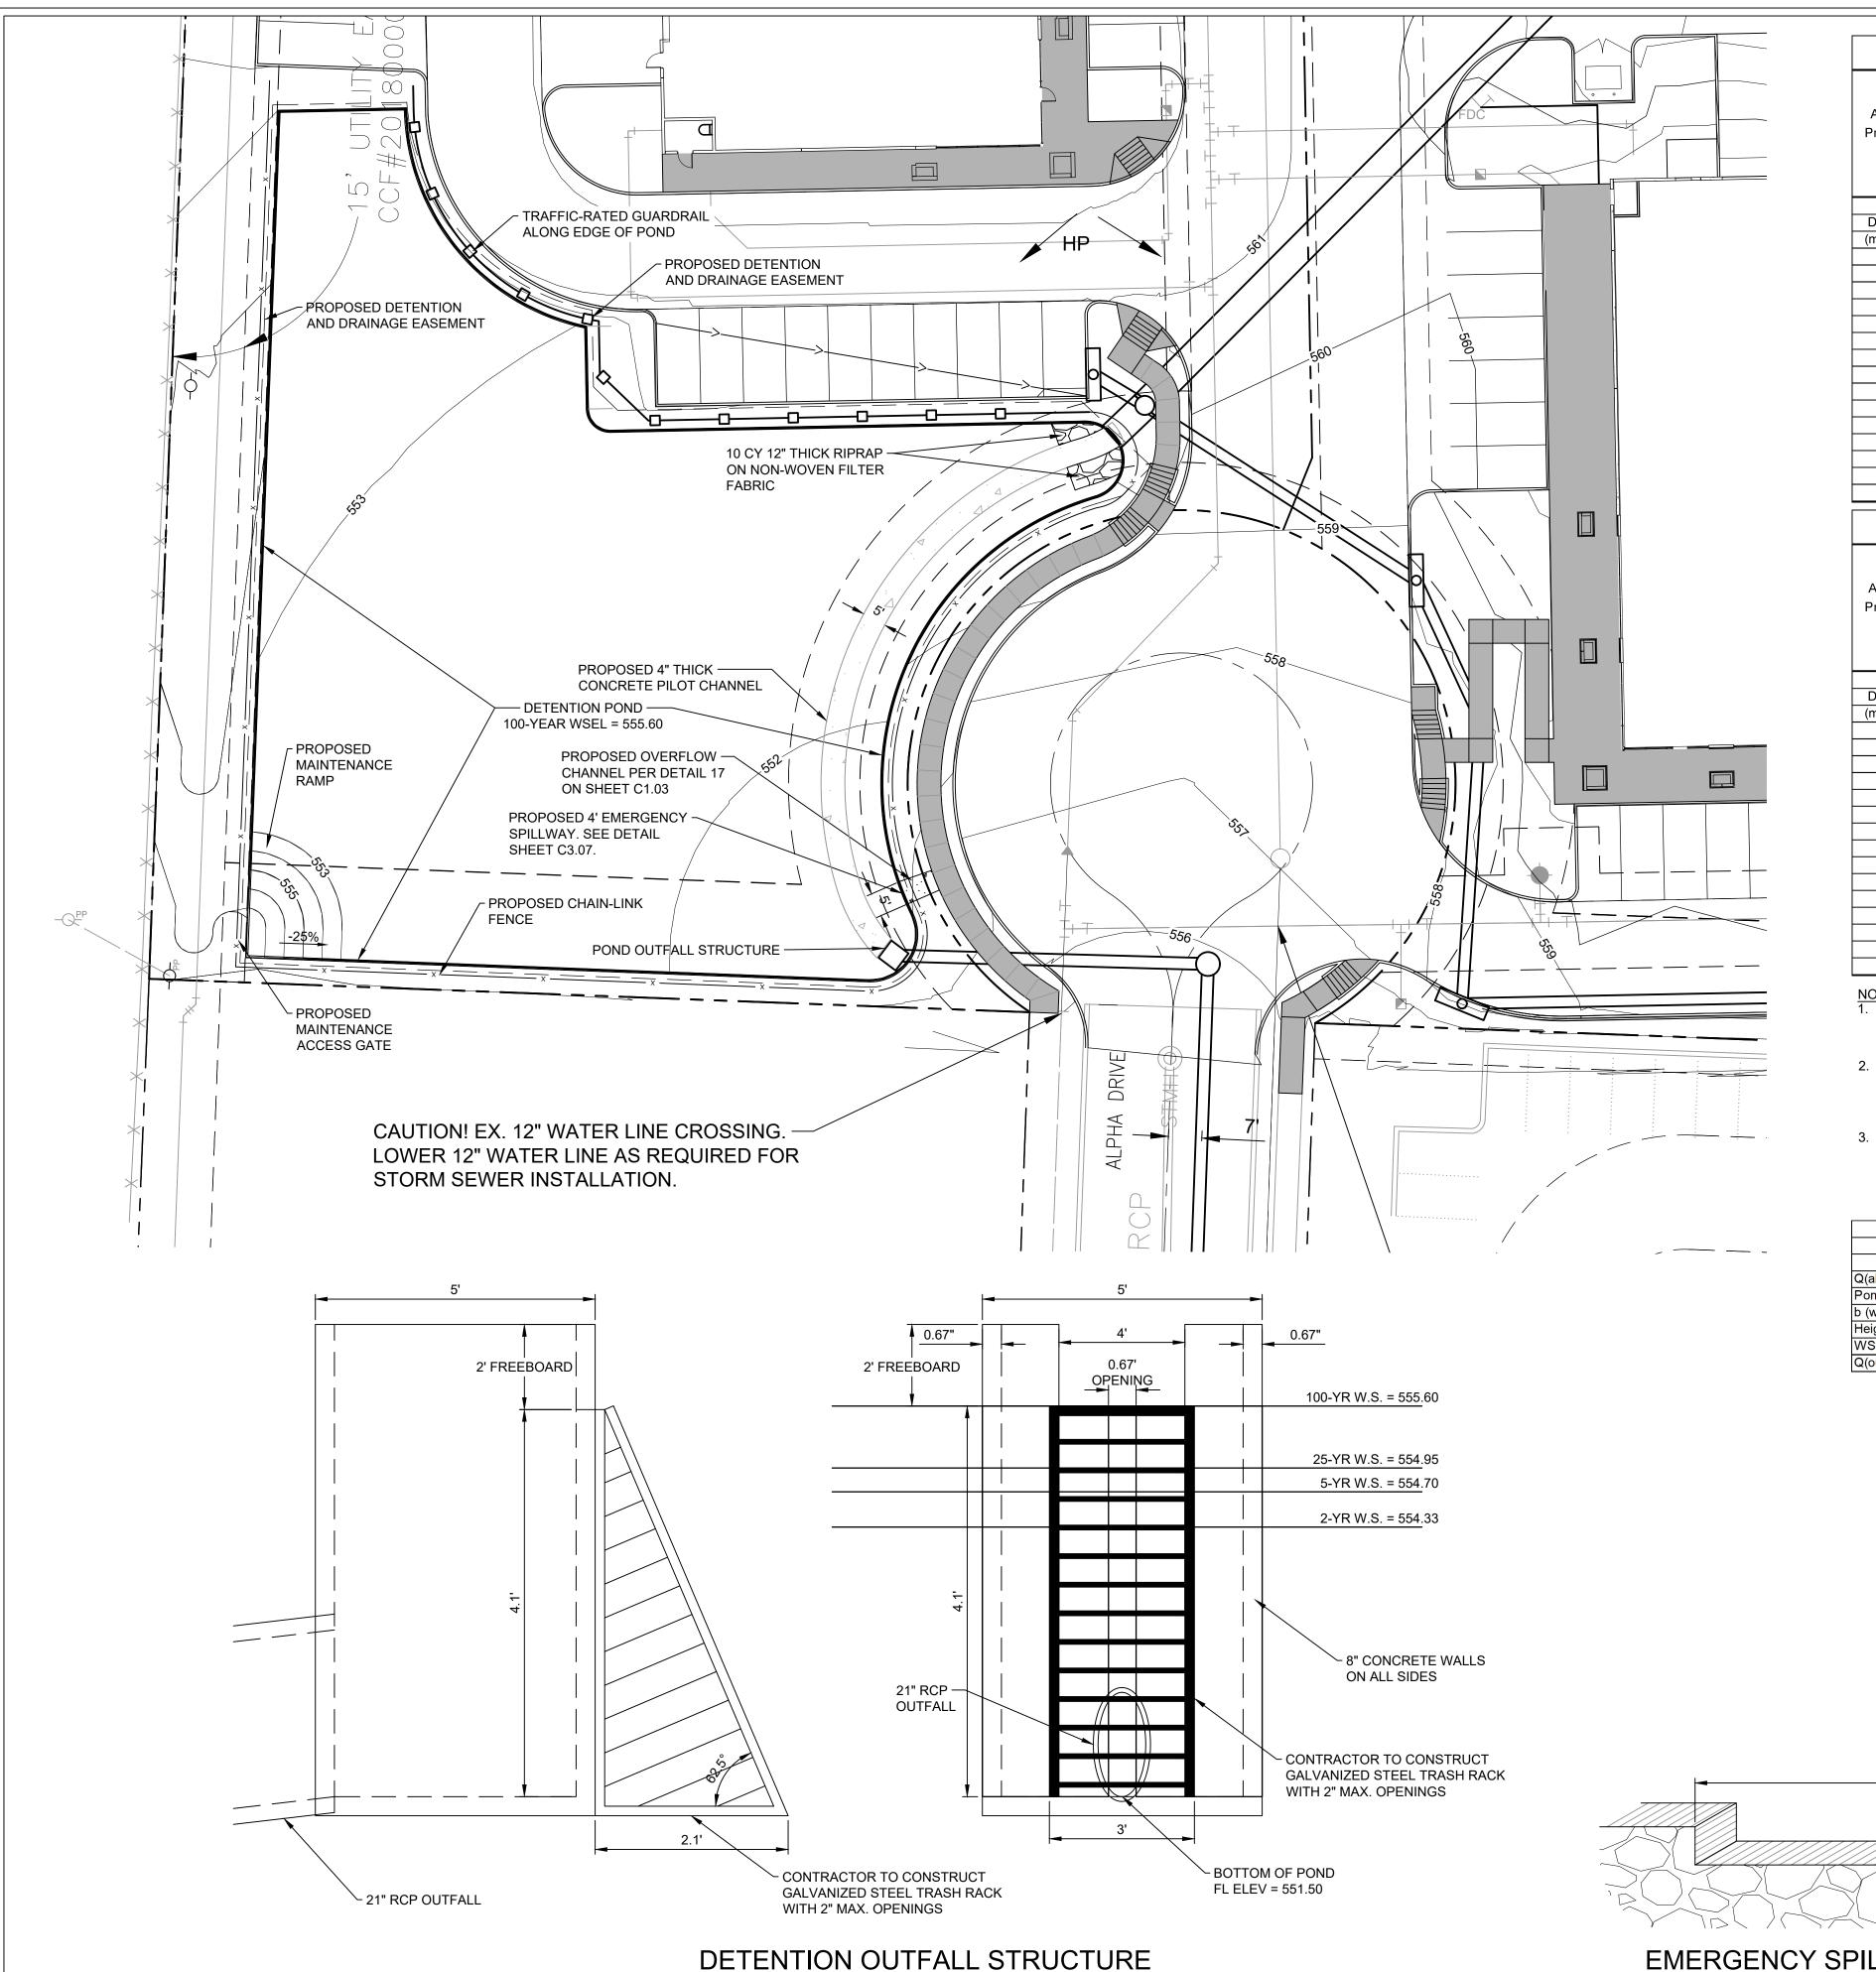

SCALE: NOT TO SCALE

BENCHMARKS:

ELEVATION = 523.27'

ELEVATION = 558.61'

CITY BENCHMARK NO. 1 = ALUMINUM DISK STAMPED

"CITY OF ROCKWALL SURVEY MONUMENT" IN HARRY

FIELD (FIELD #1) RIGHT FIELD FENCE. STATE PLANE

CITY BENCHMARK NO. 6 = ALUMINUM DISK STAMPED

"CITY OF ROCKWALL SURVEY MONUMENT" IN GRASS

MEDIAN ±387' WEST OF INTERSECTION OF JOHN KING

BLVD. AND AIRPORT RD. ±100' SOUTH OF AIRPORT RD. CL.

COORDINATES: 7,028,087.646 N, 2,597,870.985 W.

MYERS PARK NORTHEAST OF THE WESTERLY BASEBALL

l	DETENTION	I (MODIFIE	DETENTIC D RATIONA		D - HYDRO	35) 5-YF	₹		DETENTION	(MODIFIE	DETENTIONA D RATIONA		- HYDRO	35) 10-YF	₹				
	inage Area : Outflow Rat		6.40 10.68	acres cfs	(does not i	• •	•	Allowable	inage Area : Outflow Rate	e - Q ₁₀ =	6.40 12.86	acres cfs	•	does not include bypass areas) does not inlcude bypass runoff)					
Proposed F	Runoff Coeffic	cient C =	0.9					Proposed F	Runoff Coeffic	cient C =	0.9								
Time	of Concentra	10.00	minutes				Time	Time of Concentration - $T_c = 10.00$ minutes											
F	requency F	actor - K =	1					F	requency F	actor - K =	1								
			Inflow	Inflow	Outflow	Outflow	Storage				Inflow	Inflow	Outflow	Outflow	Storage				
Duration	Intensity	Depth	Discharge	Volume	Duration	Volume	Volume	Duration	Intensity	Depth	Discharge	Volume	Duration	Volume	Volume				
(minutes)	(inches/hr)	(inches)	Q=KCiA	Cu. Ft.	(minutes)	Cu. Ft.	Cu. Ft.	(minutes)	(inches/hr)	(inches)	Q=KCiA	Cu. Ft.	(minutes)	Cu. Ft.	Cu. Ft.				
10	6.10	1.02	35.1	21,090	20	6,411	14,679	10	7.10	1.18	40.9	24,547	20	7,719	16,828				
15	5.50	1.38	31.7	28,523	25	8,013	20,510	15	6.50	1.63	37.5	33,709	25	9,649	24,061				
20	4.90	1.63	28.2	33,882	30	9,616	24,266	20	5.90	1.97	34.0	40,797	30	11,578	29,218				
30	4.10	2.05	23.6	42,526	40	12,821	29,704	30	4.80	2.40	27.7	49,786	40	15,438	34,348				
40	3.40	2.27	19.6	47,020	50	16,027	30,993	40	4.00	2.67	23.0	55,318	50	19,297	36,020				
50	2.80	2.33	16.1	48,403	60	19,232	29,171	50	3.50	2.92	20.2	60,504	60	23,157	37,347				
60	2.60	2.60	15.0	53,935	70	22,437	31,498	60	3.00	3.00	17.3	62,233	70	27,016	35,216				
70	2.40	2.80	13.8	58,084	80	25,643	32,441	70	2.80	3.27	16.1	67,764	80	30,876	36,888				
80	2.30	3.07	13.3	63,615	90	28,848	34,767	80	2.60	3.47	15.0	71,913	90	34,735	37,178				
90	2.10	3.15	12.1	65,344	100	32,053	33,291	90	2.50	3.75	14.4	77,791	100	38,595	39,196				
100	1.90	3.17	10.9	65,690	110	35,259	30,431	100	2.40	4.00	13.8	82,977	110	42,454	40,522				
110	1.80	3.30	10.4	68,456	120	38,464	29,992	110	2.30	4.22	13.3	87,471	120	46,314	41,157				
				Required S	Storage Vol.	34,767	cubic feet					Required S	Storage Vol.	41,157	cubic feet				
				'		0.80	acre-feet							0.94	acre-feet				
	DETENTION	(MODIFIEI	DETENTIONA D RATIONA) - HYDRO (35) 25-YI	R	D	ETENTION	(MODIFIED	DETENTIONAL		- HYDRO 3	5) 100-Y	R				
Dra	inage Area :	=	6.40	acres	(does not i	nclude byp	ass areas)	Dra	inage Area :	=	6.40	acres	(does not i	nclude bypa	ass areas)				
	Outflow Rate		14.39	cfs	(does not i	nlcude byp	ass runoff)	Allowable (Outflow Rate	e - Q ₁₀₀ =	18.66	cfs		nlcude bypa					
	Runoff Coeffic		0.9		,	,,	,		Runoff Coeffic		0.9		•	,,	,				
•	of Concentra			minutes					of Concentra			minutes							
	Frequency F	•		midtee					Frequency F			minutes							
			Inflow	Inflow	Outflow	Outflow	Storage				Inflow	Inflow	Outflow	Outflow	Storage				
Duration	Intensity	Depth	Discharge	Volume	Duration	Volume	Volume	Duration	Intensity	Depth	Discharge	Volume	Duration	Volume	Volume				
(minutes)	(inches/hr)	(inches)	Q=KCiA	Cu. Ft.	(minutes)	Cu. Ft.	Cu. Ft.	(minutes)	(inches/hr)	(inches)	Q=KCiA	Cu. Ft.	(minutes)	Cu. Ft.	Cu. Ft.				
10	8.30	1.38	47.8	28,696	20	8,635	20,061	10	9.80	1.63	56.5	33,882	20	11,199	22,683				
15	7.50	1.88	43.2	38,895	25	10,793	28,102	15	9.00	2.25	51.9	46,674	25	13,999	32,676				
20	0.00	2 20	20.0	45.007	00	40.050	00.005		0.00	0.77	47.0	F7 000		40.700	40.504				

NOTES:
1. ONSITE DRAINAGE AREAS OS-1, OS-2, OS-3, OS-4 AND E-1 ARE NOT INCLUDED IN THE DETENTION POND CALCULATIONS AS THEY BYPASS THE POND. THE TOTAL

6.60 2.20 38.0 45,637 30 12,952 32,685

5.50 2.75 31.7 57,046 40 17,270 39,777

2.50 4.58 14.4 95,077 120 51,809 43,269

3.07 | 26.5 | 63,615 | 50 | 21,587 | 42,029 3.33 23.0 69,147 60 25,904 43,243

3.50 20.2 72,605 70 30,222 42,383

 3.85
 19.0
 79,865
 80
 34,539
 45,326

 4.13
 17.9
 85,743
 90
 38,857
 46,886

4.35 16.7 90,237 100 43,174 47,063

4.50 15.6 93,349 110 47,491 45,858

Required Storage Vol. 47,063 cubic feet

1.08 acre-feet

ELEV

552.00

553.00

554.00

555.00

555.60

556.00

557.00

558.00

AREA BYPASSING THE POND IS 0.85 ACRES (5.22 CFS). EXISTING DRAINAGE AREAS EX-2, EX-3, AND EX-4 FLOW OFF-SITE WITH A COMBINED AREA OF 2.99 ACRES AT 8.67 CFS RUNOFF. PROPOSED DRAINAGE AREAS OS-1, OS-2, OS-3, OS-4 AND E-1 FLOW OFF-SITE WITH A COMBINED AREA OF 1.19 ACRES AT 5.22 CFS RUNOFF.

NO PAVING OPERATIONS, INCLUDING SLAB, ARE ALLOWED UNTIL DETENTION POND IS FULLY INSTALLED WITH EROSION PROTECTION ON THE SIDES AND BOTTOM

Weir Sizing													
WSEL BASED ON SET WIDTH "b"													
	5-YR	10-YR	25-YR	100-YR									
Q(allowable)	10.68	12.86	14.39	18.66									
Pond FL	551.5	551.5	551.5	551.5									
b (width)	0.67	0.67	0.67	0.67									
Height	2.83	3.20	3.45	4.10									
WSEL	554.33	554.70	554.95	555.60									
Q(out, actual)	10.68	12.86	14.39	18.66									

Elevation Vs. Di	scharge Table
Water Surface	Weir Discharge
Elevation	(cfs)
557.60	46.92
557.00	28.65
556.00	21.19
555.60	18.66
555.00	14.72
554.95	14.39
554.70	12.86
554.33	10.68
554.00	8.88
553.00	4.13
552.00	0.79
551.50	0.00



4.93

5.25

5.67

DETENTION POND STAGE STORAGE TABLE

INC. VOL.

(cu. yd.)

8.54

245.07

662.65

720.17

433.98

289.99

727.04

729.27

3.40

(ft)

0.5

1

0.6

0.4

1

100

(sq. ft.)

1985

16121

19519


19553

19571

19586

19620

19654

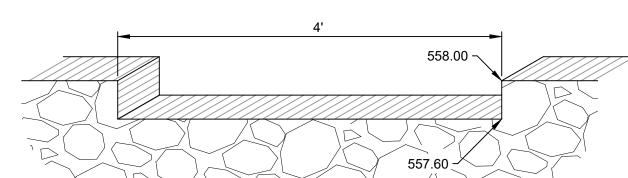

EMERGENCY SPILLWAY DETAIL SCALE: NOT TO SCALE

LEGEND

	PROPERTY LINE
	EASEMENT LINE
710	EXISTING CONTOUR
710——	PROPOSED MAJOR CONTOUR

-----710 PROPOSED MINOR CONTOUR

PROPOSED STORM DRAINAGE

RECORD DRAWING NOVEMBER 24, 2020

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ENGINEER OF RECORD DYLAN B. HEDRICK HALFF ASSOCIATES, INC. TBPE FIRM F-312 DATE: NOVEMBER 24, 2020

Project No.: 38050 **NOVEMBER 2020** Issued: Drawn By: REP Checked By: DBH Scale: AS SHOWN Sheet Title **DETENTION POND**

PLAN

C3.07 Sheet Number

ROCKWALL 20 8.30 2.77 47.8 57,392 30 16,798 40,594 6.60 3.30 38.0 68,456 40 22,398 46,058
 23.0
 96,806
 80
 44,796
 52,010

 21.3
 102,338
 90
 50,395
 51,943

 20.2
 108,907
 100
 55,995
 52,912

19.6 117,550 110 61,594 55,956

AVG END

TOTAL VOL.

(cu. yd.)

8.54

253.61

916.26

1636.43

2070.41

2360.40

3087.44

3816.71

Required Storage Vol. 55,956 cubic feet

TOTAL VOL.

(ac. ft.)

0.01

0.16

0.57

1.01


1.28 1.46

1.91

2.37

110 3.20 5.87 18.4 121,699 120 67,194 54,506

 $\overline{\mathbf{O}}$

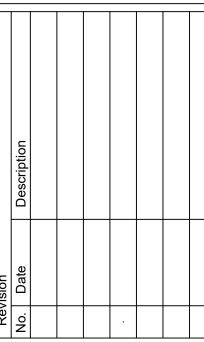

		AVO 35989			1				1	1				1												1	T								
	RUNOFF CO	LLECTION POINT	(Inlet or Manh	ole)				MENTAL NAGE	Incoming CA		Time at			Storm	Slope of		Selected Storm Sewer Size	RISE	Velocity In Sewer	Standard			Flow Time in Sewer			Hydra	ulic Grade	l							
	DRAINAGE A	REA	UPSTREAM STATION	DOWNSTREAM STATION	Distar Betwe Collect Poin	en Draina ion Area	Runo	ff Incrementa f. "CA"	(from wye or manhole, I link to DS lateral DS Accum CA)	Accum- ulated	Upstream Station (minutes)	Design Stor Frequenc (yrs.)	"I"	Water Runoff "Q" (c.f.s.)	Hydraulic Gradient "S" (ft./ft.)	# BARRELS	SPAN for RCB (feet) DIA for pipe (inches)	FOR	Between Collection Points "V" (ft/sec)	DS Junction	Minor Loss Coeff. Kj	Velocity Head (V2/2g) (feet)	Distance V x 60 (minutes)	DS Hyd. Grade	Friction Losses	Hyd. Grade After Friction Loss	Junction Losses	Minor Losses	Hyd. Grade After Hyd. Jump	Inlet Top Elevation	Starting Hydraulic Grade at DS End	PIPE SOFFIT ELEV	PF IF (-#) THEN PIPE IS IN PF		EPTH TO ONDING
											10	100	TABLE						12																
LINE A			1																																
	INLET	A-1	4+12.79	3+84.66	28.1	3 1.94	0.90	1.75		1.75	10.00	100	9.80	17.1	0.0012	1	3	2	2.85		1.25	0.13	0.16	556.54	0.03	556.58	0.00	0.16	556.73	556.83		555.68	1.06 F	ULL	0.10
	BEND 45 [^]		3+84.60	3+03.05	81.6	1		0.00		1.75	10.16	100	9.77	17.1	0.0012	1	3	2	2.85		0.15	0.13	0.48	556.42	0.10	556.52	0.00	0.02	556.54			555.62	0.92 F		
	WYE 90^	LAT A-2	3+03.0		166.8	86		0.00	1.89	3.64	10.64	100	9.70	35.3	0.0015	1	5	2	3.53	0.45		0.19	0.79	556.04	0.25	556.29	0.14	0.00	556.42			555.46	0.97 F		
	BEND 45 [^]		1+36.19		126.9)2		0.00		3.64	11.43	100	9.57	34.8	0.0015	1	5	2	3.48		0.15	0.19	0.61	555.82	0.18		0.00	0.03	556.04			555.12	0.91 F		
	MH 90^	MH B-1, C-1	0+09.27	0+00.00	9.27	<u>'</u>		0.00	1.62	5.26	12.04	100	9.47	49.8	0.0030	1	5	2	4.98	1.00		0.39	0.03	555.60	0.03	555.63	0.20	0.00	555.82		555.60	554.87	0.96 F	ULL	
LAT A-2		+ +																							+		+								
	INLET	A-2	0+20.00	0+00.00	20.0	0 2.10	0.90	1.89		1.89	10.00	100	9.80	18.5	0.0020	1	30		3.77		1.25	0.22	0.09	556.42	0.04	556.46	0.00	0.28	556.74	559.39	556.42	556.02	0.72 F	ULL	2.65
LINE B																											1								
	INLET	B-1	0+15.00	0+00.00	15.0	0.80	0.90	0.72		0.72	10.00	100	9.80	7.1	0.0010	1	24		2.25		1.25	0.08	0.11	555.82	0.01	555.84	0.00	0.10	555.94	559.16	555.82	2.03	553.90 F	ULL	3.22
LINE C																																			
	INLET	C-1	5+47.98	5+11.94	36.0	4 0.51	0.90	0.46		0.46	10.00	100	9.80	4.5	0.0004	1	24		1.43		1.25	0.03	0.42	556.11	0.01	556.12	0.00	0.04	556.16	559.03		556.30	-0.14 P	ARTIAL	2.87
	BEND 45^		5+11.94	1+59.75	352.1	9		0.00		0.46	10.42	100	9.73	4.5	0.0004	1	24		1.42		0.15	0.03	4.14	555.96	0.14	556.10	0.00	0.00	556.11			556.20	-0.10 P	ARTIAL	
	INLINE INLE	T C-2	1+59.7	1+00.00	59.7	5 0.30	0.90	0.27		0.73	14.56	100	9.07	6.6	0.0009	1	24		2.10		0.50	0.07	0.47	555.88	0.05		0.00	0.03	555.96	557.76		555.14	0.82 F	ULL	1.80
	BEND 30 [^]		1+00.00	0+67.81	32.1	9		0.00		0.73	15.03	100	9.00	6.6	0.0008	1	24		2.09		0.10	0.07	0.26	555.84	0.03	555.87	0.00	0.01	555.88			554.97	0.91 F	ULL	
	INLINE INLE	T C-3	0+67.8	0+00.00	67.8	1 0.19	0.90	0.17		0.90	15.29	100	8.96	8.1	0.0001	1	36		1.14		0.50	0.02	0.99	555.82	0.01	555.83	0.00	0.01	555.84	558.62	555.82				2.78
LINE D																																			
	INLET	D-1	1+62.04	0+99.88	62.1	6 0.58	0.90	0.52	1.38	1.90	10.00	100	9.80	18.7	0.0068	1	24		5.94		1.25	0.55	0.17	553.83	0.42	554.25	0.00	0.69	554.94	555.70		551.44	3.50 F		0.76
	MH 90 [^]		0+99.88		96.0	2		0.00		1.90	10.17	100	9.77	18.6	0.0068	1	24		5.92		0.50	0.55	0.27	552.91	0.65	553.56	0.00	0.27	553.83	555.90					2.07
	BEND 45^		0+03.86	0+00.00	3.86	;		0.00		1.90	10.44	100	9.73	18.5	0.0067	1	24		5.90		0.15	0.54	0.01	552.80	0.03	552.83	0.00	0.08	552.91		552.80				

		ROCKW	VALL INLET	DESIGN	CALCULA	ATIONS TABL	.E																															
	LOCATIO	N				AREA	A RUNOFF											GUTTER F	LOW											INLETS CAP	PACITY					INLE	T BY-PA	ASS
			DESI	GN		TIME OF				UPSTREAM	IOUTIEN	1			LONG			DEPRESS	SION	PONE WIDTH/S			OF GUTTER LOW	MAX ALLOWABLE FLOW BASED ON		PRESSED ER SECTION	I	ON BEYONE PRESSION	CON	/EYANCE	RATIO OF DEPRESSIO	I EQUIVALENT		_ENGTH	INLET			
ALIGNMEN	STATIO	ON OFF	I		AREA ID	CONCENTR TION To	A INTENSIT	Y AREA A	RUNOFF Q	BYPASS C*A	FLOW Q _A	THOROUGH FARE TYPE	ON- GRADE/SAG	MANNING'S n	SLOPE	CROWN TYPE	SLOPE S _X	DEPTH W	-	LLOW) - ALLOW	(ACTUAL) T _{ACTUAL}	(ALLOW) Y _{ALLOW}	(ACTUAL) Y _{ACTUAL}	MAX ALLOWABLE PONDING WIDTH QALLOW GUTTER	AREA A _W	WETED PERIMITER P _W	AREA A _W	WETED PERIMITEI P _W	DEPRESSIC SECTION K		FLOW TO TOTAL FLOV	CROSS	REQUIRED	1	CAPACITY Q _C	, FLOW Q _{BYPASS}	C*A	TO INLET REMARKS
			(yr)		(min)	(in/hr)	(acres) (cfs)	(cfs)	(cfs)				(ft/ft)		(ft/ft)	(ft)	(ft)	(ft)	(ft)	(ft)	(ft)	(cfs)	(ft²)	(ft)	(ft ²)	(ft)	(cfs)	(cfs)		(ft/ft)	(ft)	(ft)	(cfs)	(cfs)		
(1) (2)	(3)	(4	4) (5)	(6)	(7)	(8)	(9)	(10)	(11)	(12)	(13)	(14)	(15)	(16)	(17)	(18)	(19)	(20)	21)	(22)	(23)	(24)	(25)	(26)	(27)	(28)	(29)	(30)	(31)	(32)	(33)	(34)	(35)	(36)	(37)	(38)	(39)	(40) (41)
A-1 LINE A	4+12.7	79 C	0 10	0.90	B-1	10	9.80	1.94	17.13		17.13		SAG	0.0175	0.0035		0.0350	0.5	2	29	18.52	1.015	0.6482	1.66	1.73	2.18	4.78	16.52	125.45	177.29	0.414	0.139	10.67	20	28.33			
A-2 LAT A-1	0+20.0	00 0	0 10	0.90	C-1	10	9.80	2.10	18.52		18.52		SAG	0.0175	0.0055		0.0350	0.5	2	29	17.52	1.015	0.6132	2.62	1.66	2.18	4.22	15.52	117.10	150.12	0.438	0.145	13.17	20	26.06			
B-1 LINE B	0+15.0	00 0	0 10	0.90	C-2	10	9.80	0.80	7.06		7.06		SAG	0.0175	0.0400		0.0050	0.5	2	50	28.39	0.25	0.1420	3.17	0.77	2.17	1.74	26.39	33.04	24.15	0.578	0.149	53.82	10	1.67			
C-1 LINE C	5+43.5	57 0	0 10	0.90	C-3	10	9.80	0.51	4.49		4.49		SAG	0.0175	0.0300		0.0064	0.5	2	75	21.67	0.48	0.1387	10.59	0.76	2.17	1.24	19.67	32.37	16.63	0.661	0.172	34.20	10	1.62			
C-2 LINE C	1+59.7	75 C	0 10	0.90	D-1	10	9.80	0.30	2.65		2.65		ON-GRADE	0.0175	0.0350		0.0350	0.5	2	30	5.98	1.05	0.2092	18.22	0.85	2.18	0.28	3.98	38.40	3.98	0.906	0.262	8.38	10	4.05			
C-3 LINE C	0+67.8	81 0	0 10	0.90	E-1	10	9.80	0.19	1.68		1.68		ON-GRADE	0.0175	0.0500		0.0030	0.5	2	18	21.85	0.054	0.0656	0.11	0.63	2.17	0.59	19.85	23.15	4.82	0.828	0.210	8.77	10	2.29			

RECORD DRAWING NOVEMBER 24, 2020

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ENGINEER OF RECORD DYLAN B. HEDRICK HALFF ASSOCIATES, INC. TBPE FIRM F-312 DATE: NOVEMBER 24, 2020 ROCKWALL URBAN + INDUSTRIAL CENTER END OF ALPHA DRIVE ROCKWALL, TX 75087

1201 NORTH BOWSER ROAD RICHARDSON, TX 75081-2275 (214) 346-6200


	Description				
Revision	No. Date				
Rev	Š.				

Project No.: 38050
Issued: NOVEMBER 2020
Drawn By: REP
Checked By: DBH
Scale: AS SHOWN
Sheet Title


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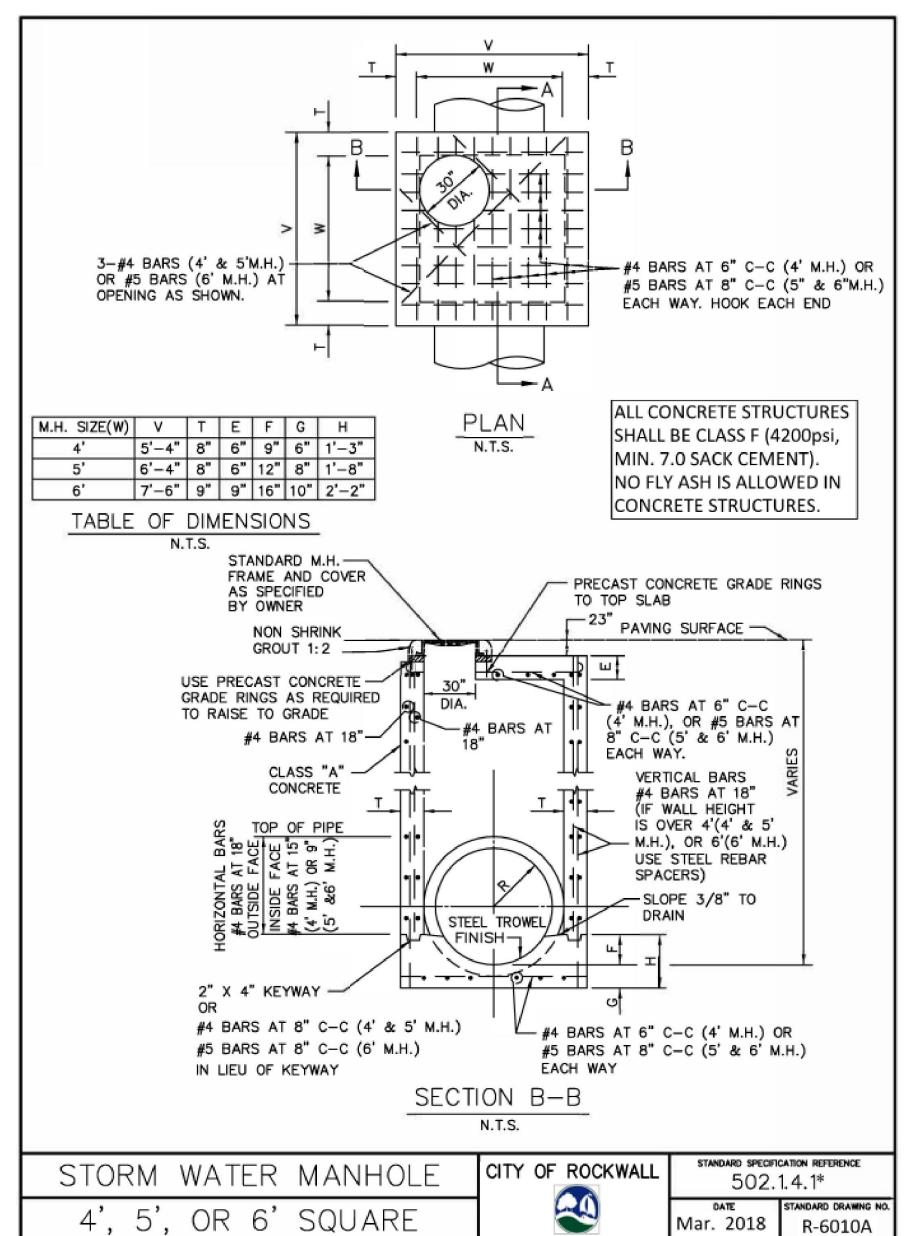
C3.08


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Sheet Number

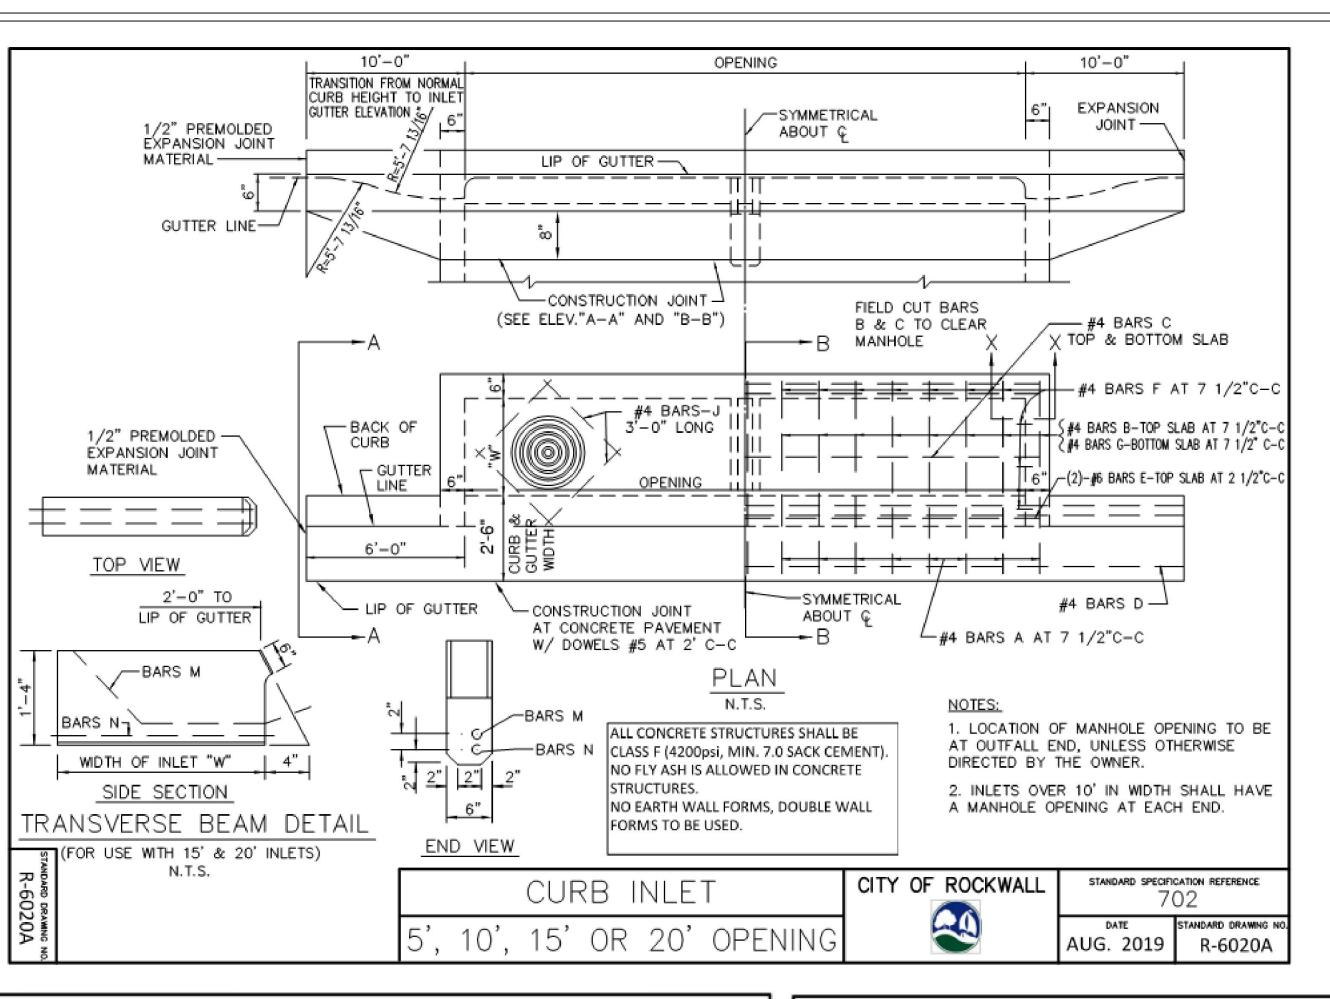


R-6010A



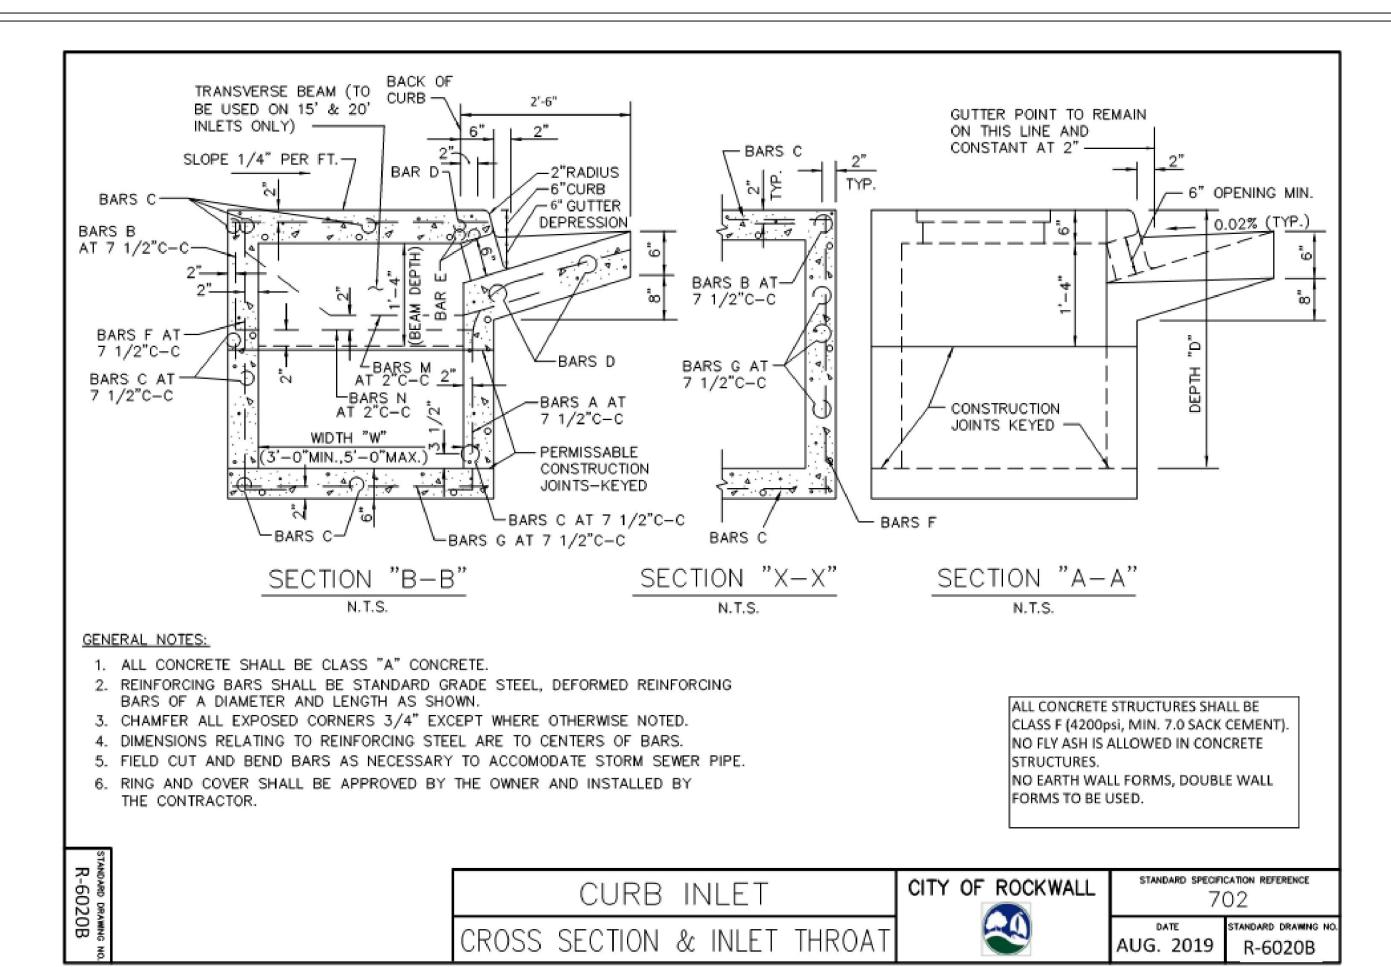

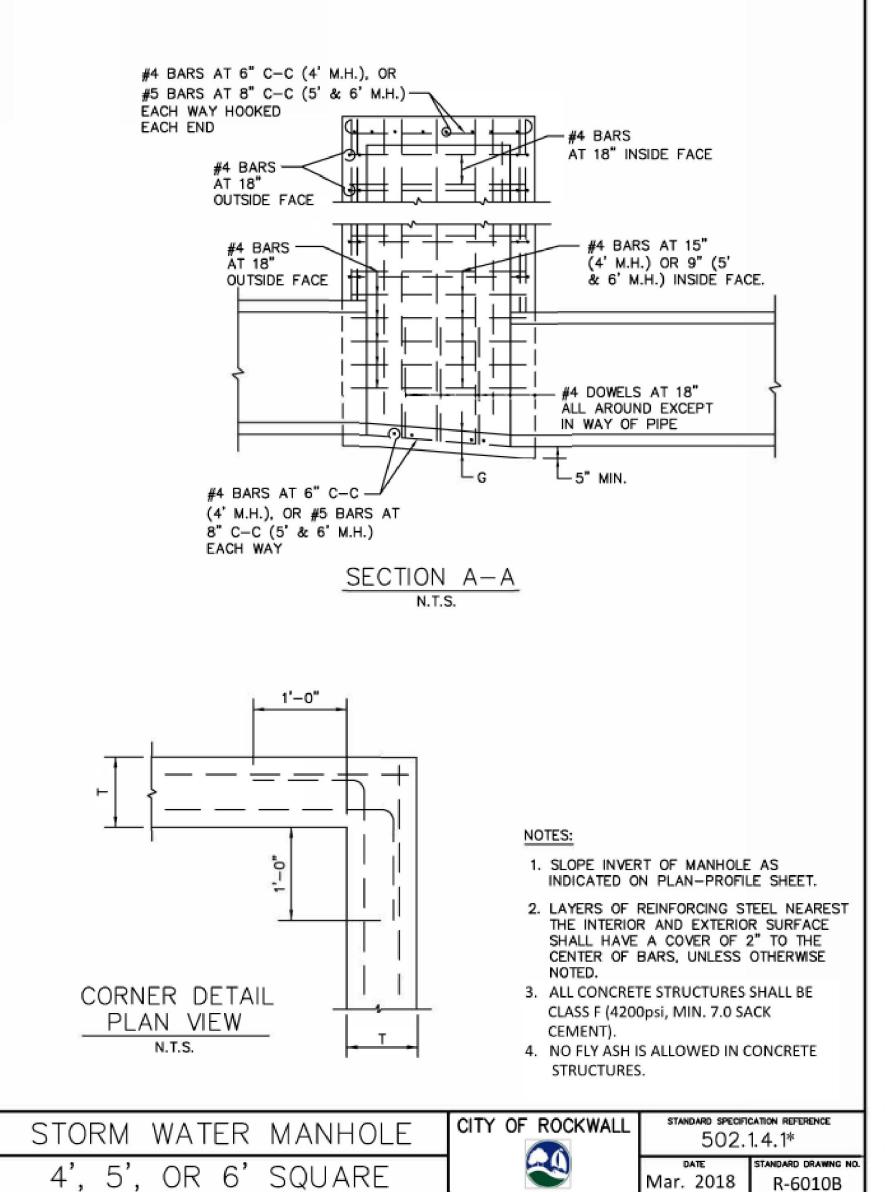

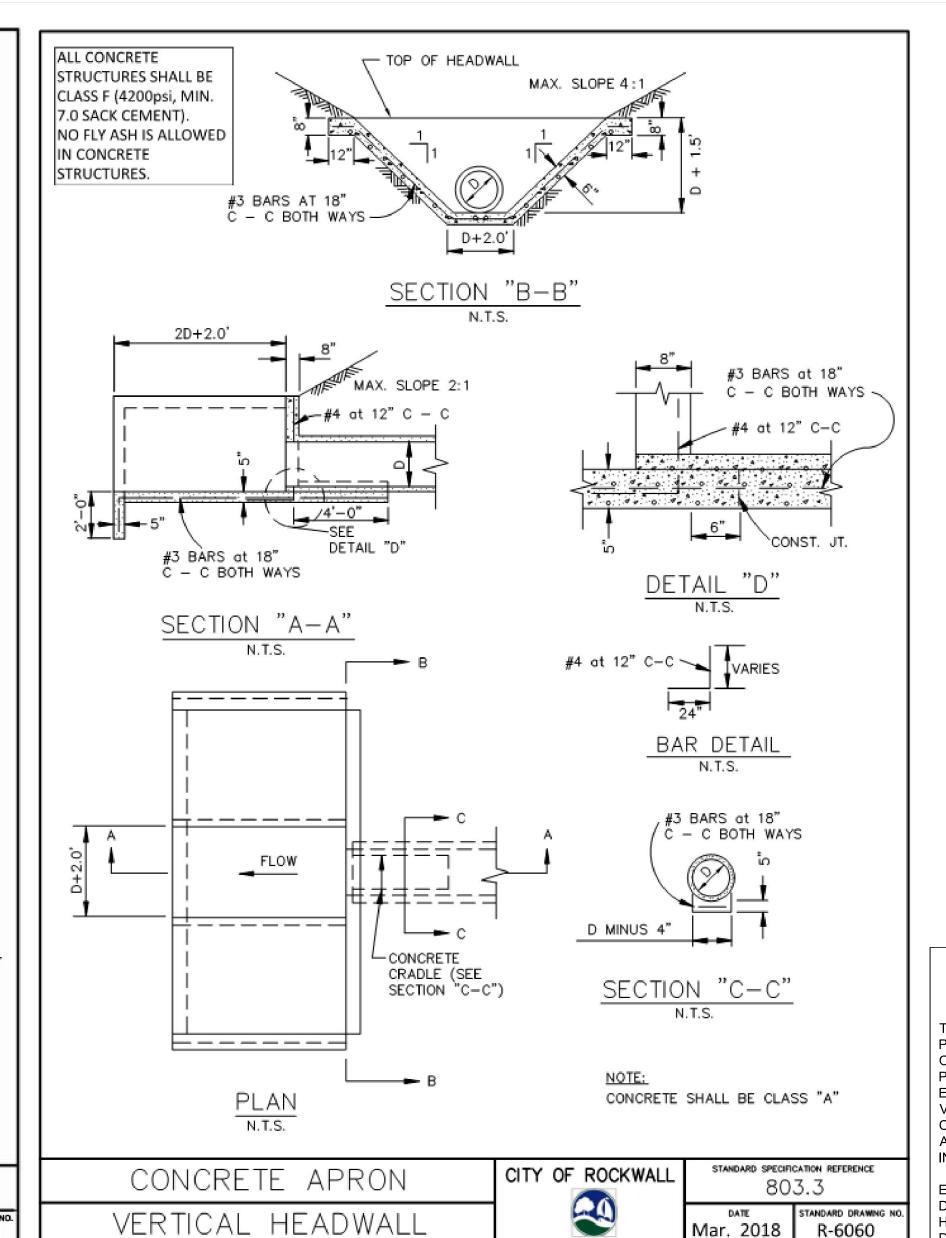

RECORD DRAWING NOVEMBER 24, 2020

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ENGINEER OF RECORD DYLAN B. HEDRICK HALFF ASSOCIATES, INC. TBPE FIRM F-312 DATE: NOVEMBER 24, 2020

Mar. 2018


R-6060

INDUSTRIAL DRIVI 7508 PHA L, TX URBAN A N N N END ROCKWALL

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Z H


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Project No.: 38050 **NOVEMBER 2020** Drawn By: REP Checked By: DBH AS SHOWN Scale: Sheet Title STORM DRAIN


DETAILS C3.09

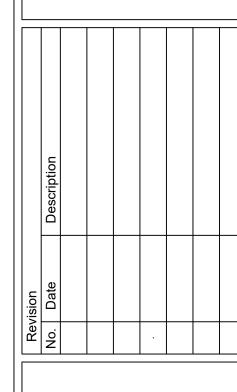Sheet Number



ROCKWALL URBAN + INDUSTRIAL CENTER END OF ALPHA DRIVE ROCKWALL, TX 75087

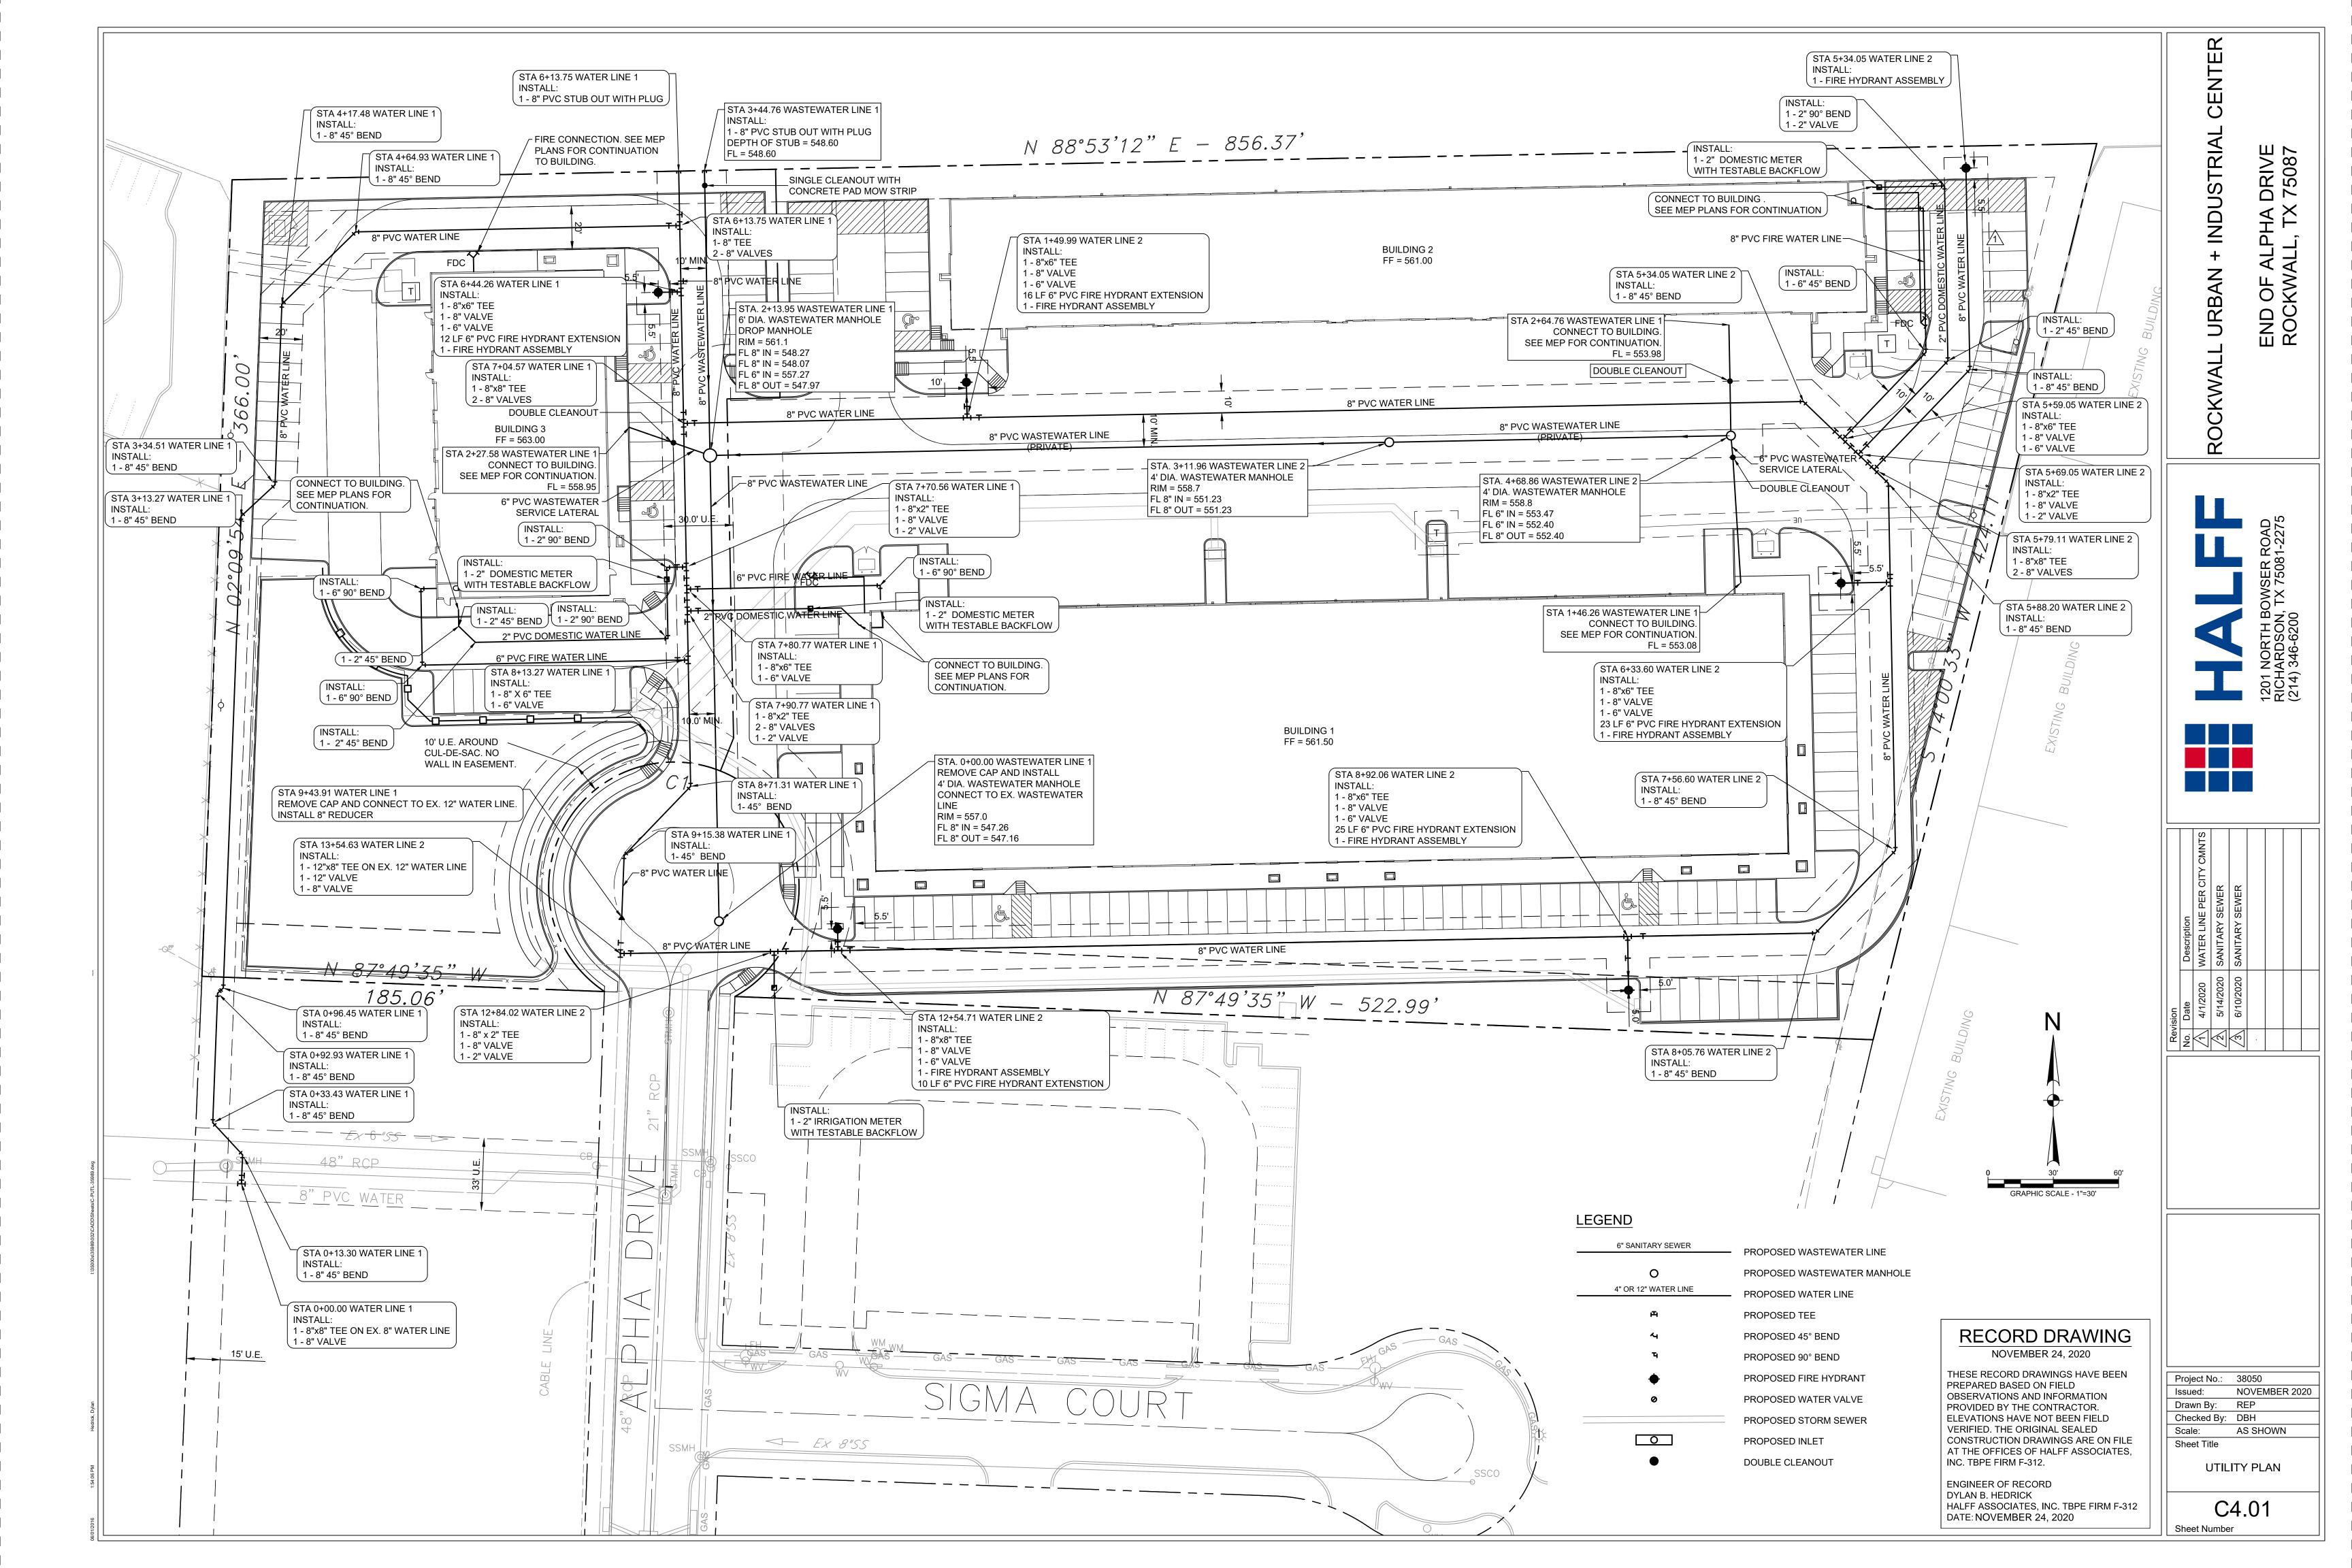

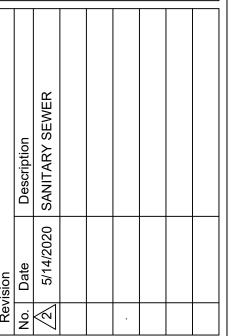


RECORD DRAWING NOVEMBER 24, 2020

THESE RECORD DRAWINGS HAVE BEEN PREPARED BASED ON FIELD OBSERVATIONS AND INFORMATION PROVIDED BY THE CONTRACTOR. ELEVATIONS HAVE NOT BEEN FIELD VERIFIED. THE ORIGINAL SEALED CONSTRUCTION DRAWINGS ARE ON FILE AT THE OFFICES OF HALFF ASSOCIATES, INC. TBPE FIRM F-312.

ENGINEER OF RECORD DYLAN B. HEDRICK HALFF ASSOCIATES, INC. TBPE FIRM F-312 DATE: NOVEMBER 24, 2020


		Project No.:	38050
		Issued:	NOVEMBER 2020
		Drawn By:	REP
		Checked By:	DBH
		Scale:	AS SHOWN
		Sheet Title	
		WASTEWATER PROFILE	

C4.02
Sheet Number

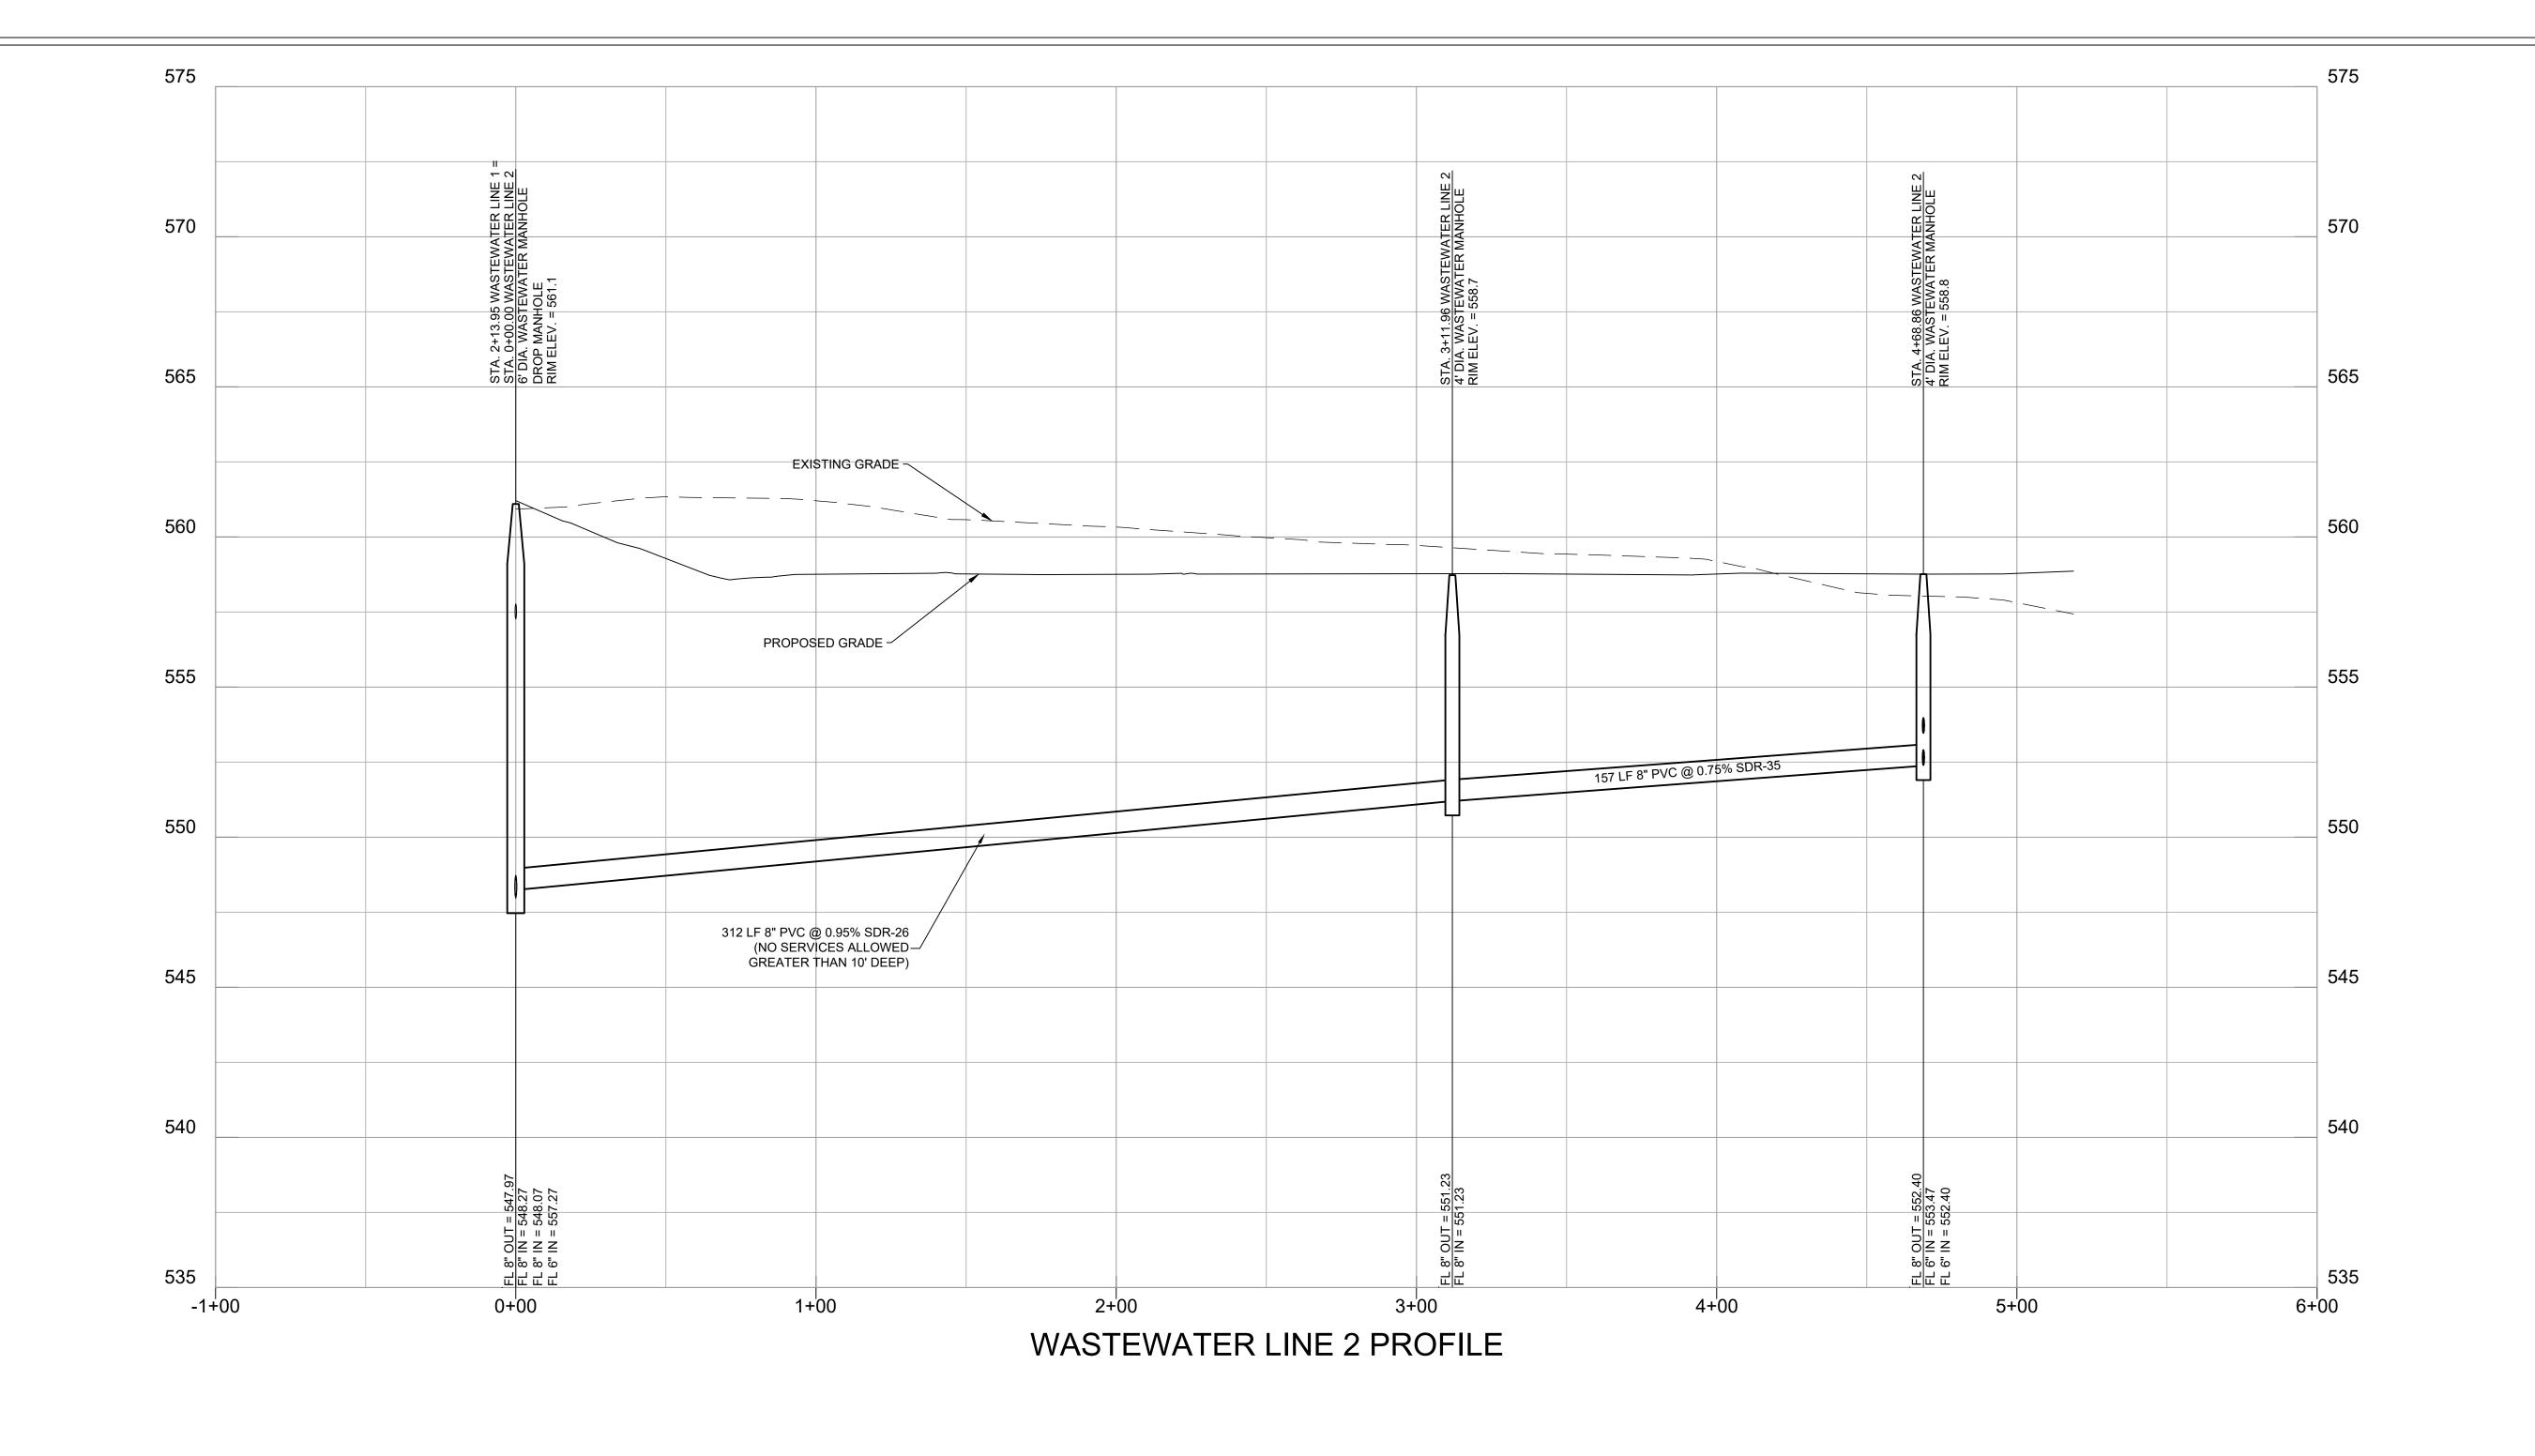

ROCKWALL URBAN + INDUSTRIAL CENTER END OF ALPHA DRIVE ROCKWALL, TX 75087

1201 NORTH BOWSER ROAD RICHARDSON, TX 75081-2275 (214) 346-6200

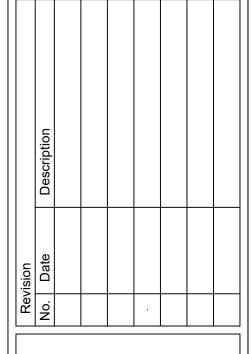


RECORD DRAWING NOVEMBER 24, 2020


THESE RECORD DRAWINGS HAVE BEEN PREPARED BASED ON FIELD OBSERVATIONS AND INFORMATION PROVIDED BY THE CONTRACTOR. ELEVATIONS HAVE NOT BEEN FIELD VERIFIED. THE ORIGINAL SEALED CONSTRUCTION DRAWINGS ARE ON FILE AT THE OFFICES OF HALFF ASSOCIATES, INC. TBPE FIRM F-312.


ENGINEER OF RECORD DYLAN B. HEDRICK HALFF ASSOCIATES, INC. TBPE FIRM F-312 DATE: NOVEMBER 24, 2020 Project No.: 38050
Issued: NOVEMBER 2020
Drawn By: REP
Checked By: DBH
Scale: AS SHOWN
Sheet Title


wastewater profile C4.03

C4.03
Sheet Number

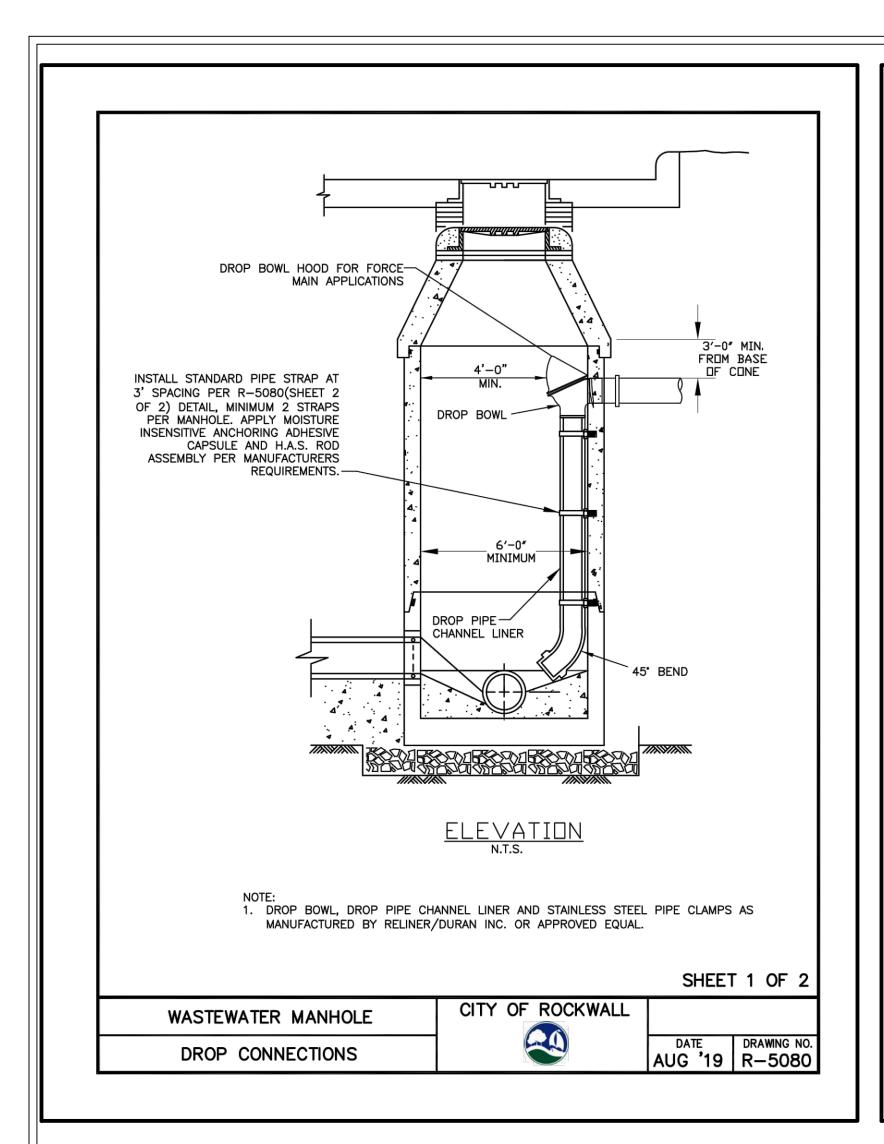

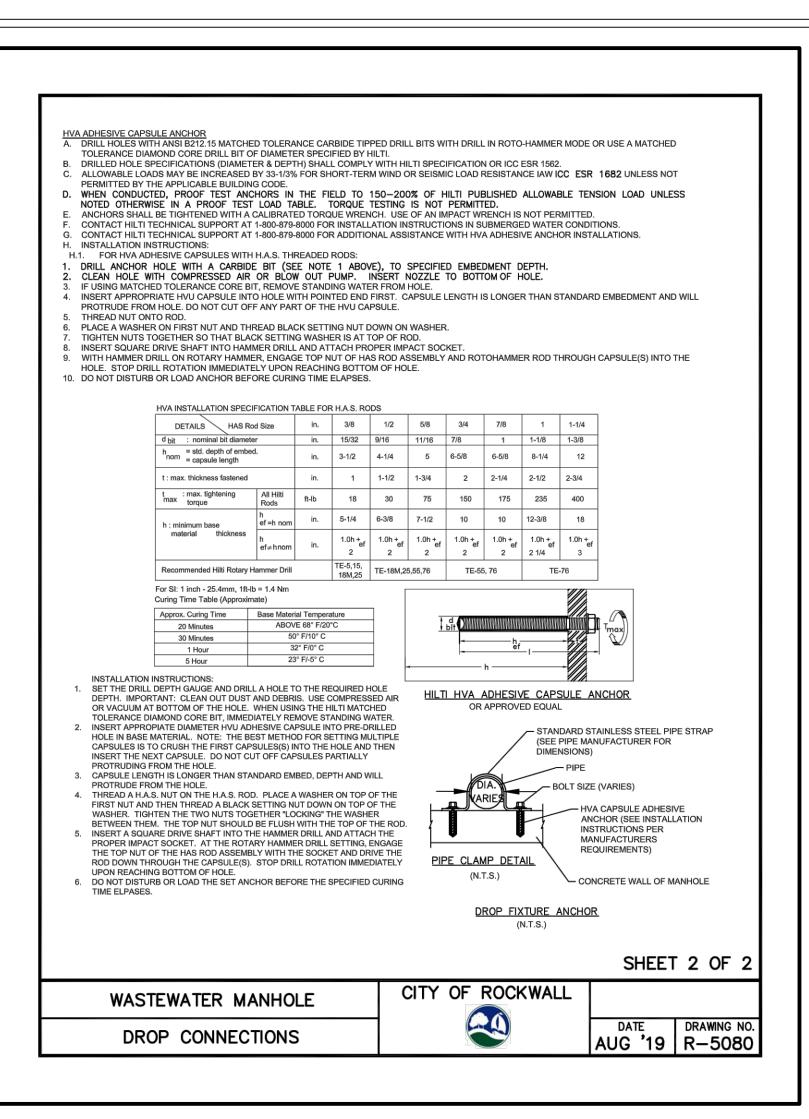

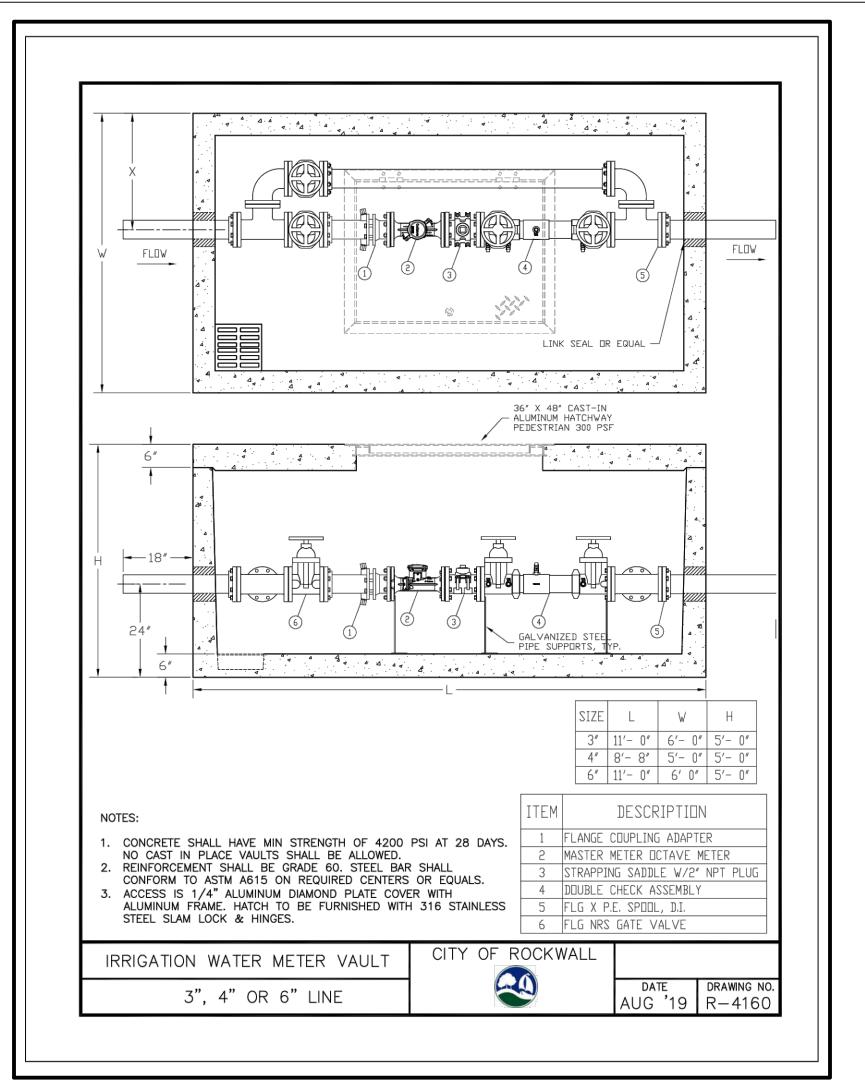

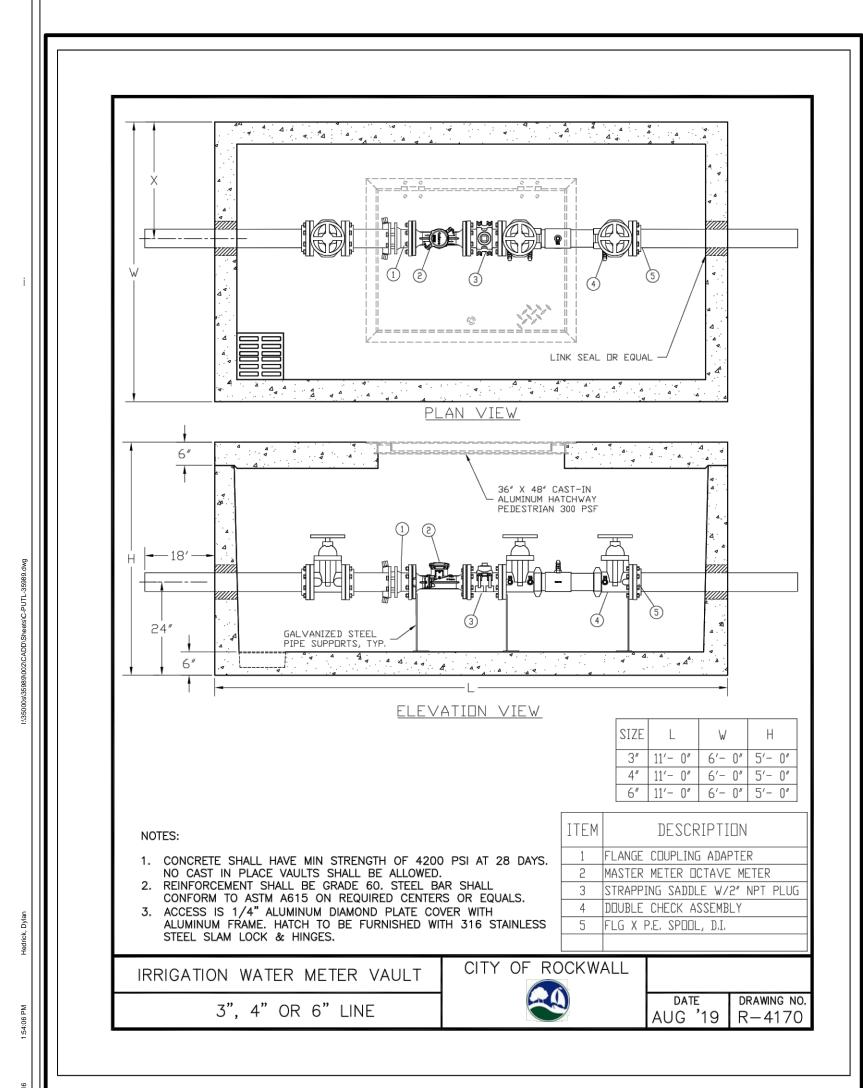

RECORD DRAWING NOVEMBER 24, 2020


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ENGINEER OF RECORD
DYLAN B. HEDRICK
HALFF ASSOCIATES, INC. TBPE FIRM F-312
DATE: NOVEMBER 24, 2020

ROCKWALL URBAN + INDUSTRIAL
END OF ALPHA DRIVE
ROCKWALL, TX 75087

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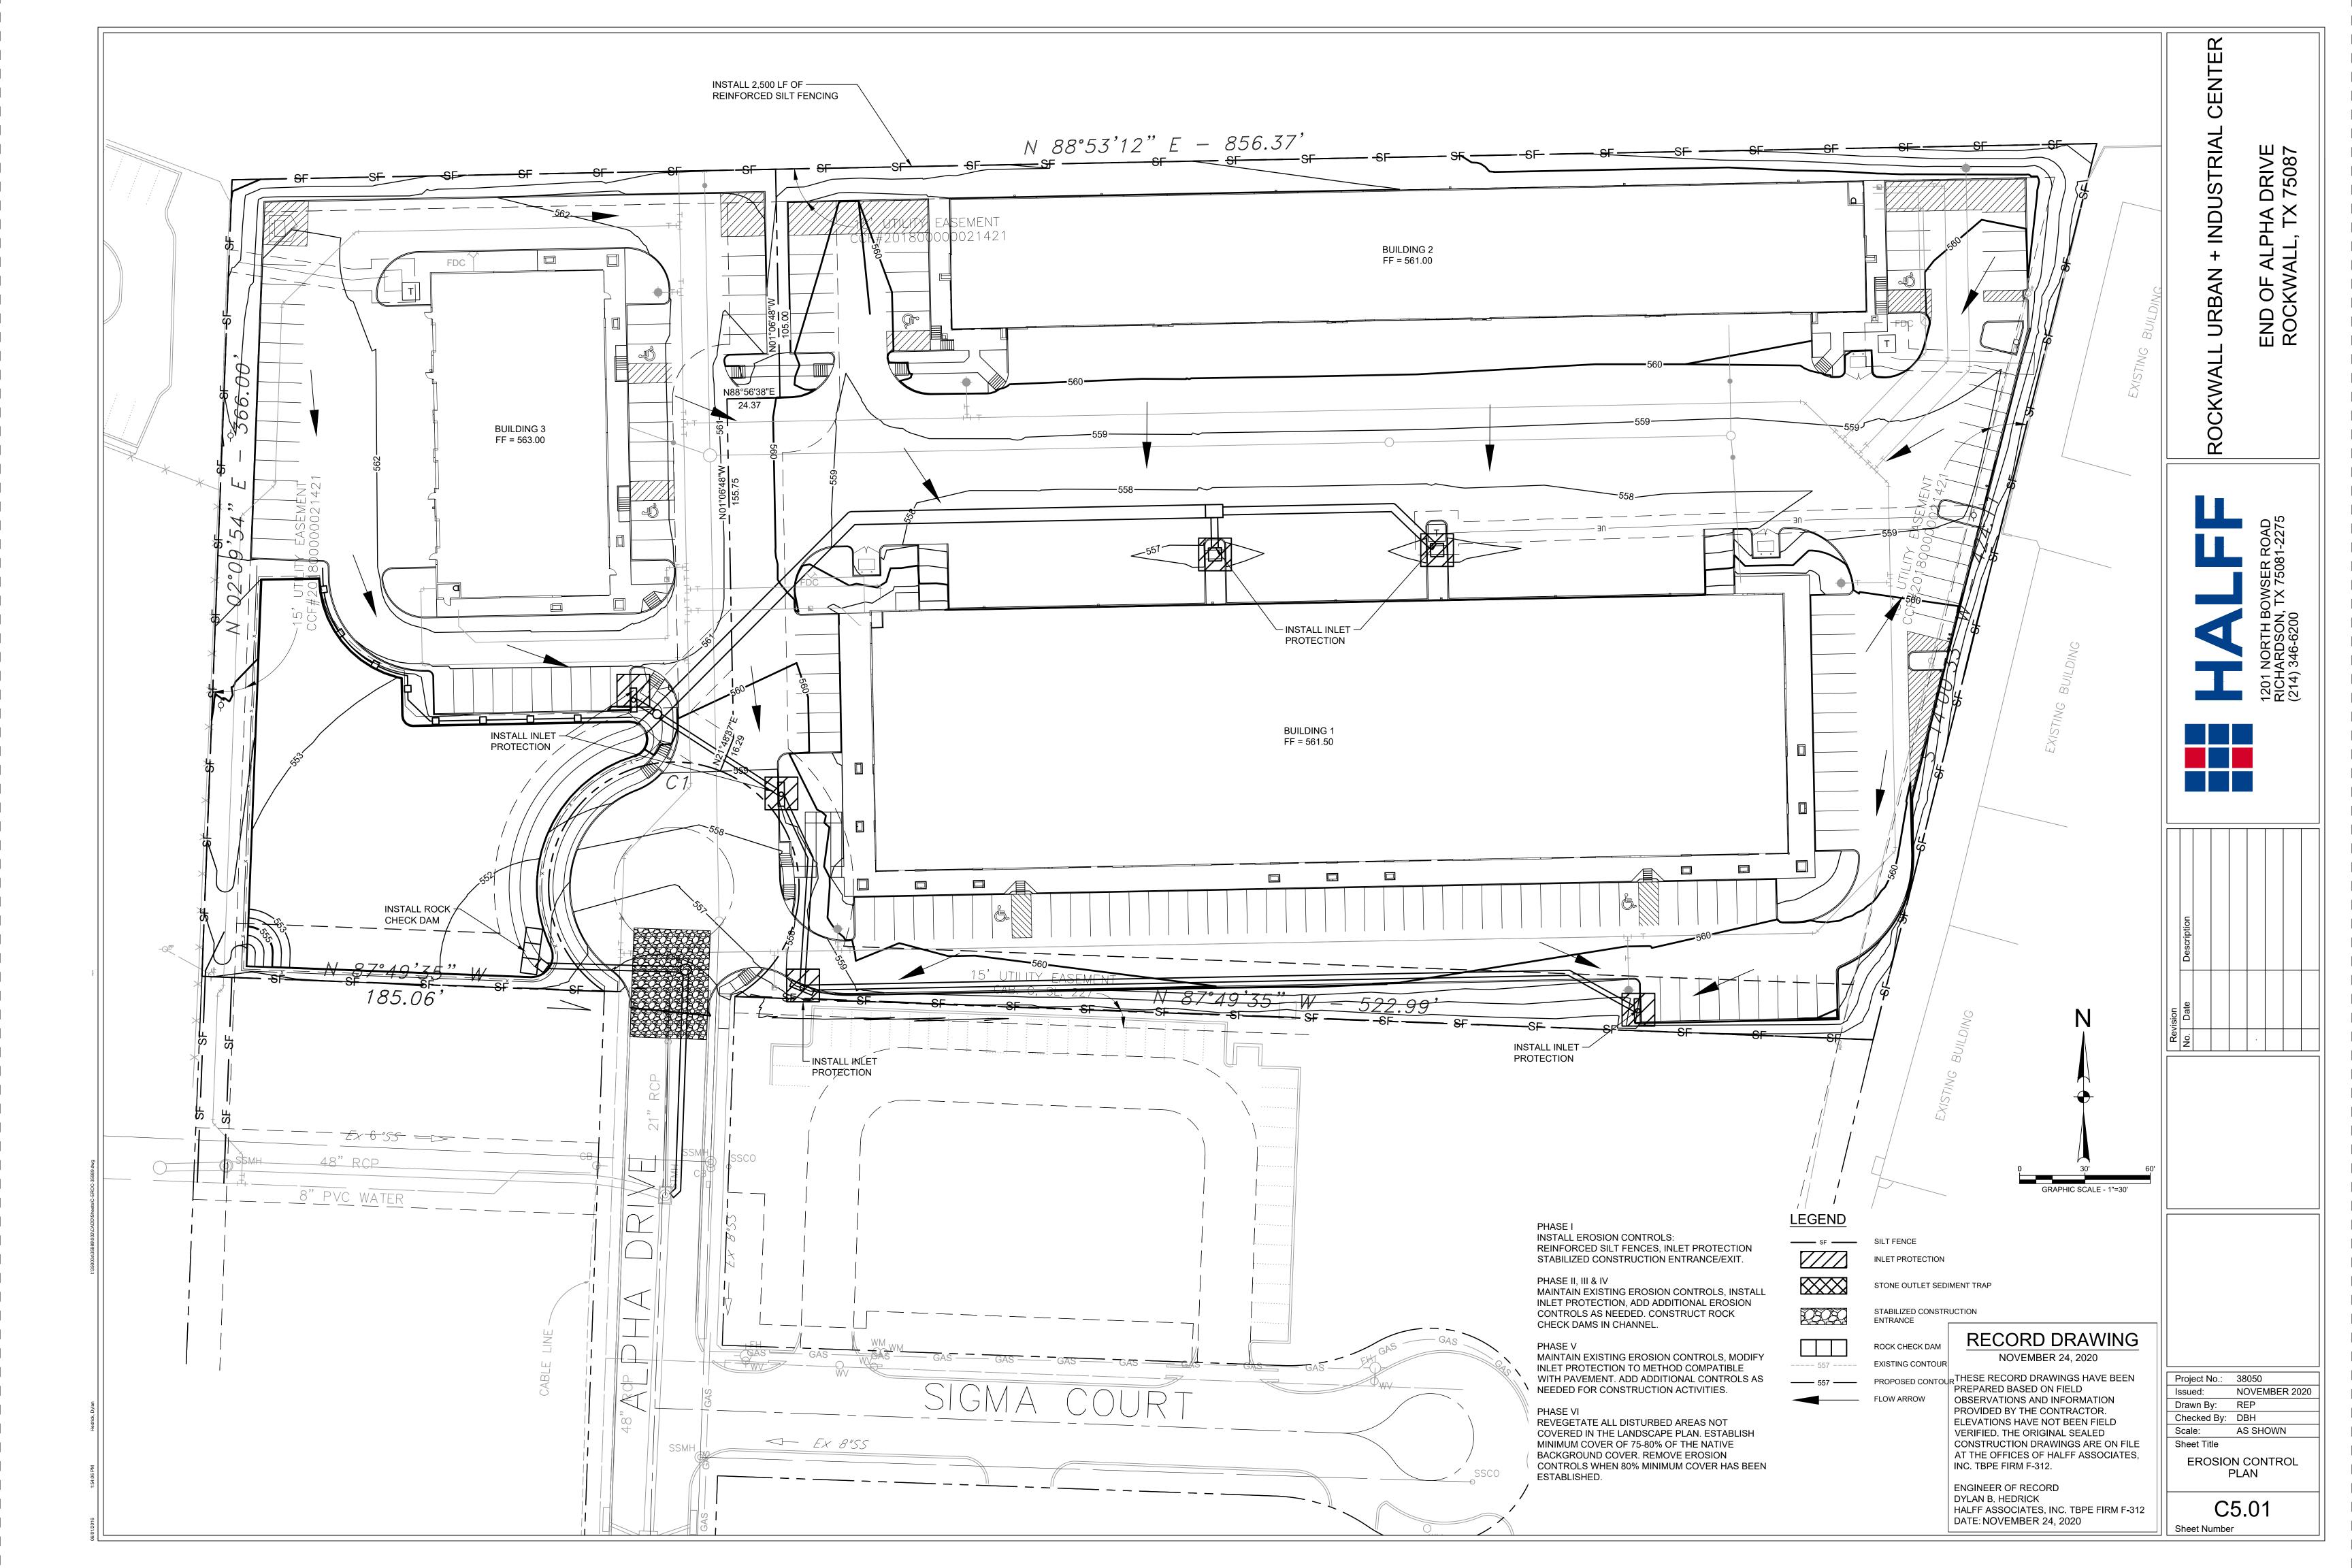




Project No.:	38050
Issued:	NOVEMBER 2020
Drawn By:	REP
Checked By:	DBH
Scale:	AS SHOWN
Sheet Title	

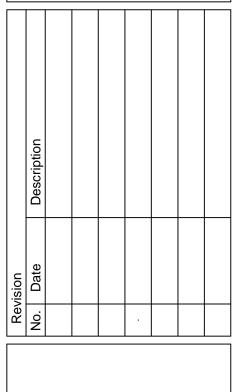UTILITY DETAILS

C4.04
Sheet Number




STANDARD SWPP NOTES


- 1. CONSTRUCTION ACTIVITY IN THE CITY OF ROCKWALL SHALL COMPLY WITH THE REQUIREMENTS OF THE TPDES GENERAL PERMIT TXR150000 AND ALL APPLICABLE CITY OF ROCKWALL ORDINANCES.
- 2. NO CONSTRUCTION RELATED ACTIVITIES MAY BEGIN ON THE PROJECT SITE UNTIL A STORM WATER POLLUTION PREVENTION PLAN (SWPPP) HAS BEEN ACCEPTED BY THE CITY, AND THE CITY AND/OR CONTRACTOR SITE NOTICES ARE POSTED ON SITE. SWPPP DOCUMENTATION AND RECORDS SHALL
- 3. IF FIVE (5) ACRES OR GREATER WILL BE DISTURBED, A NOI MUST BE SUBMITTED TO TCEQ AND THE CITY PRIOR TO THE START OF CONSTRUCTION RELATED ACTIVITIES.
- 4. REVISIONS TO THE SWPPP SHALL BE DATED AND INITIALED BY THE PERMITTEE OR HIS REPRESENTATIVE.

BE MAINTAINED ON SITE THROUGHOUT CONSTRUCTION.

- 5. AREAS TO REMAIN UNDISTURBED AND/OR TO BE PROTECTED DURING CONSTRUCTION (INCLUDING ALL WATERBODIES, WETLAND AREAS, EROSION CLEAR ZONES, DRIP LINE OF TREES TO REMAIN AFTER CONSTRUCTION, NATURAL AREAS, ETC.) SHALL BE CLEARLY DELINEATED PRIOR TO THE START OF CONSTRUCTION.
- 6. SEDIMENT AND EROSION CONTROL DEVICES SHALL BE INSTALLED AND FUNCTIONING PRIOR TO ANY EARTH DISTURBING ACTIVITIES. THEY SHALL REMAIN IN PLACE UNTIL THE COMPLETION OF ALL CONSTRUCTION ACTIVITIES AND/OR UNTIL ALL DISTURBED AREAS HAVE BEEN PERMANENTLY
- 7. REFER TO THE CITY OF ROCKWALL DESIGN CRITERIA MANUAL AND THE ISWM CONSTRUCTION
- CONTROLS MANUAL FOR SELECTION AND DESIGN OF STORMWATER CONTROLS. 8. CONSTRUCTION WASTE, DEBRIS AND SOIL BLOWN, TRACKED OR WASHED FROM THE SITE DURING CONSTRUCTION ACTIVITY SHALL BE CLEANED UP DAILY.
- EROSION CONTROL PLANS ARE CONSIDERED MINIMUM REQUIREMENTS. ADDITIONAL CONTROL DEVICES MAY BE REQUIRED DURING CONSTRUCTION IN ORDER TO CONTROL EROSION AND
- 10. WETLANDS AND STREAMS SHALL BE PROTECTED AT ALL TIMES DURING CONSTRUCTION WITH EROSION AND SEDIMENT CONTROLS AS WELL AS NATURAL BUFFERS. ALL APPLICABLE PERMITS MUST BE OBTAINED PRIOR TO CONSTRUCTION IN FLOODPLAIN, WETLANDS AND/OR STREAMS. ANY WORK IN A FLOODPLAIN AND/OR STREAM SHALL COMPLY WITH ALL APPLICABLE FEDERAL, STATE AND LOCAL REGULATIONS AND PERMITS.
- 11. IF SOIL DISTURBANCE IS OCCURRING WITHIN A CITY OF ROCKWALL EASEMENT, AN EASEMENT USE
- AGREEMENT MUST BE OBTAINED PRIOR TO CONSTRUCTION. 12. A STABILIZED CONSTRUCTION ENTRANCE SHALL BE INSTALLED AND MAINTAINED ON THE PROJECT
- 13. STORM WATER INLET PROTECTION SHALL BE PROVIDED FOR ALL INLETS (UPSTREAM AND DOWNSTREAM) WITHIN 50 FT. OF THE CONSTRUCTION ENTRANCE (ON BOTH SIDES OF THE PUBLIC ROADWAY).
- 14. TO SECURE THE PROJECT SITE, LOCATE LIMITS OF CONSTRUCTION, PROTECT AREAS THAT ARE TO REMAIN UNDISTURBED, AND PREVENT MIGRATION OF CONSTRUCTION DEBRIS
- 15. CARE SHALL BE TAKEN WHEN INSTALLING STORMWATER CONTROLS TO NOT OBSCURE ONCOMING TRAFFIC AT INTERSECTIONS, ADJACENT DRIVEWAYS AND THE PROJECT CONSTRUCTION
- ENTRANCE. A QUALIFIED REPRESENTATIVE OF EACH OPERATOR SHALL INSPECT THE CONSTRUCTION ACTIVITY EITHER ONCE EVERY 14 CALENDAR DAYS AND WITHIN 24 HOURS OF A STORM EVENT OF 1/2-INCH OR GREATER OR WEEKLY AT A SPECIFIED DAY AND TIME REGARDLESS OF PRECIPITATION. A WRITTEN SWPPP INSPECTION REPORT SHALL BE COMPLETED FOR EACH INSPECTION.
- 17. AT A MINIMUM, SEDIMENT SHALL BE REMOVED FROM CONTROLS WHEN THEIR CAPACITY IS REDUCED BY 50% UNLESS MORE FREQUENT CLEANING IS SPECIFIED IN THE SWPPP.
- 18. IF ANY CONTROL IS FOUND TO BE INEFFECTIVE, INSTALLED INCORRECTLY, OR DAMAGED, IT SHALL BE MODIFIED OR REPLACED WITHIN 7 DAYS OF INSPECTION OR AS REQUIRED BY THE CITY.
- 19. ALL EXISTING AND NEW STORM WATER STRUCTURES, AFFECTED BY THIS PROJECT, SHALL BE INSPECTED AND MAINTAINED ON THE SAME SCHEDULE AS THE STORMWATER CONTROLS. SEDIMENT DISCHARGED INTO THE MUNICIPAL SEPARATE STORM SEWER SYSTEM (STREETS, GUTTERS, STORM DRAINS, FLUMES, CHANNELS, ETC.) FROM THE CONSTRUCTION ACTIVITY SHALL BE NOTED IN THE SWPPP INSPECTIONS AND SHALL BE REMOVED WITHIN 7 DAYS OF INSPECTION OR AS REQUIRED BY THE CITY.
- 20. DURING DRY AND WINDY PERIODS, DISTURBED SOIL SHALL BE SPRINKLED WITH WATER UNTIL DAMPENED AND REPEATED AS NEEDED TO PREVENT DUST GENERATION.
- 21. STABILIZATION MEASURES SHALL BE INITIATED AS SOON AS PRACTICABLE IN PORTIONS OF THE SITE WHERE CONSTRUCTION ACTIVITIES HAVE TEMPORARILY OR PERMANENTLY CEASED, BUT IN NO CASE MORE THAN FOURTEEN (14) DAYS AFTER WORK HAS CEASED
- 22. THE CONTRACTOR SHALL DESIGNATE AN AREA TO BE USED FOR CONCRETE WASH WATER. A PIT LARGE ENOUGH TO CONTAIN THE WASH WATER WITHOUT OVERFLOWING SHALL BE EXCAVATED. IF CONCRETE PLACEMENT WILL OCCUR OVER A PERIOD OF TIME GREATER THAN A WEEK, A SIGN DESIGNATING THE AREA AS THE CONCRETE WASHOUT AREA SHALL BE POSTED IN A LOCATION
- 23. SLURRY FROM CONCRETE SAWCUTTING SHALL BE VACUUMED OR RECOVERED BY OTHER MEANS FOR PROPER DISPOSAL. IF A CURB INLET IS NEAR THE PAVEMENT TO BE CUT, THE INLET SHALL BE BLOCKED WITH SANDBAGS DURING SAWCUTTING TO PREVENT SLURRY FROM ENTERING THE STORM DRAIN.
- 24. TEMPORARY CONSTRUCTION CROSSINGS IN OR ACROSS ANY WATER BODY OR WETLAND SHALL NOT BE INSTALLED WITHOUT THE PRIOR APPROVAL OF THE APPROPRIATE RESOURCE AGENCIES
- 25. DISPOSAL OF ALL RECOVERED SEDIMENTS, CONSTRUCTION DEBRIS, OR OTHER POLLUTANTS SHALL BE IN ACCORDANCE WITH ALL APPLICABLE CITY, STATE AND FEDERAL REGULATIONS. NO SEDIMENTS, CONSTRUCTION DEBRIS, OR OTHER POLLUTANTS SHALL BE DISPOSED OR FLUSHED INTO THE STORM WATER SYSTEM.
- 26. STORE ALL TRASH AND WASTE MATERIALS IN COVERED BINS OR OTHER ENCLOSURES UNTIL PROPER DISPOSAL AT OFF-SITE FACILITIES. TRASH AND WASTE SHALL BE REMOVED FROM THE SITE AT REGULAR INTERVALS TO PREVENT OVERFLOW OF THE CONTAINERS.
- 27. TEMPORARY STOCKPILING OF USEABLE OR WASTE MATERIALS SHALL HAVE APPROPRIATE EROSION AND SEDIMENT CONTROL MEASURES INSTALLED. TEMPORARY STOCKPILES SHALL BE PLACED AWAY FROM STORM WATER INLET STRUCTURES, ADJACENT PROPERTY AND PUBLIC ROADWAYS.
- 28. APPLICATION OF LIME OR OTHER CHEMICAL STABILIZERS SHALL BE LIMITED TO THE AMOUNT THAT CAN BE MIXED AND COMPACTED BY THE END OF EACH WORKING DAY. STABILIZER SHALL BE APPLIED AT RATES THAT RESULT IN NO RUNOFF FROM THE SITE. STABILIZATION SHALL BE DELAYED IF RAIN IS FORECAST FOR THE WORKING DAY. NO TRAFFIC OTHER THAN WATER TRUCKS AND MIXING EQUIPMENT SHALL PASS OVER THE SPREAD STABILIZER UNTIL AFTER MIXING IS COMPLETED.
- 29. HAZARDOUS MATERIALS SHALL BE STORED IN CLOSED CONTAINERS, AND THE CONTAINERS SHALL BE PLACED IN A SHELTER THAT PREVENTS CONTACT WITH RAINFALL AND RUNOFF. THE AMOUNT OF HAZARDOUS MATERIALS STORED ON- SITE SHALL BE MINIMIZED AND LIMITED TO THE MATERIALS NECESSARY FOR THE CURRENT PHASE OF CONSTRUCTION. HAZARDOUS MATERIAL STORAGE SHALL BE IN ACCORDANCE WITH ALL FEDERAL, STATE AND LOCAL LAWS AND
- 30. SPILLS AND RELEASES OF ANYTHING OTHER THAN STORM WATER SHALL BE IMMEDIATELY REPORTED TO THE CITY OF ROCKWALL. IN ADDITION, SPILLS AND RELEASES OF HAZARDOUS MATERIALS GREATER THAN THE REGULATED REPORTABLE QUANTITY SHALL BE REPORTED TO STATE AND FEDERAL AUTHORITIES WITHIN 24 HOURS.
- 31. SUPER-CHLORINATED WATER FROM WATER LINE DISINFECTION SHALL NOT BE ALLOWED TO ENTER THE STORM DRAINAGE SYSTEM.
- 32. PORTABLE TOILET FACILITIES SHALL NOT BE LOCATED WITHIN 25 FT. OF ANY STORM WATER STRUCTURE AND/OR WITHIN 50 FT. OF ANY WATERCOURSE, WETLAND AREA, STREAM, FLOODPLAIN,
- 33. DISCHARGE FROM DEWATERING ACTIVITIES SHALL BE RELEASED THROUGH AN ON-SITE SEDIMENT TRAP OR BASIN, THROUGH AN UNDISTURBED AREA THROUGH A NON-EROSIVE OUTLET, OR INTO A DIRT BAG (120Z. NON-WOVEN FABRIC) OR APPROVED EQUIVALENT LOCATED IN AN UNDISTURBED
- 34. SMALL SITES CONSTRUCTED AS PART OF A LARGER COMMON PLAN OF DEVELOPMENT REQUIRE EROSION CONTROL FEATURES FOR INFRASTRUCTURE AS WELL AS FOR INDIVIDUAL SITE CONSTRUCTION. INDIVIDUAL SMALL CONSTRUCTION SITES SHALL FOLLOW THESE PLANS DURING CONSTRUCTION OR PROVIDE AN INDIVIDUAL PLAN. 35. THE SITE SHALL BE CONSIDERED PERMANENTLY STABILIZED WHEN ALL SURFACE DISTURBING
- ACTIVITIES ARE COMPLETE AND A UNIFORM (E.G., EVENLY DISTURBED, WITHOUT LARGE BARE AREAS) PERENNIAL VEGETATIVE COVER WITH A DENSITY OF 80% HAS BEEN ESTABLISHED ON ALL UNPAVED AREAS AND AREAS NOT COVERED BY PERMANENT STRUCTURES.
- 36. ALL TEMPORARY CONTROL DEVICES SHALL BE REMOVED ONCE CONSTRUCTION IS COMPLETE AND
- THE SITE IS PERMANENTLY STABILIZED. 37. CONTRACTOR SHALL SOD ALL DISTURBED AREAS IN CITY RIGHT-OF-WAY.

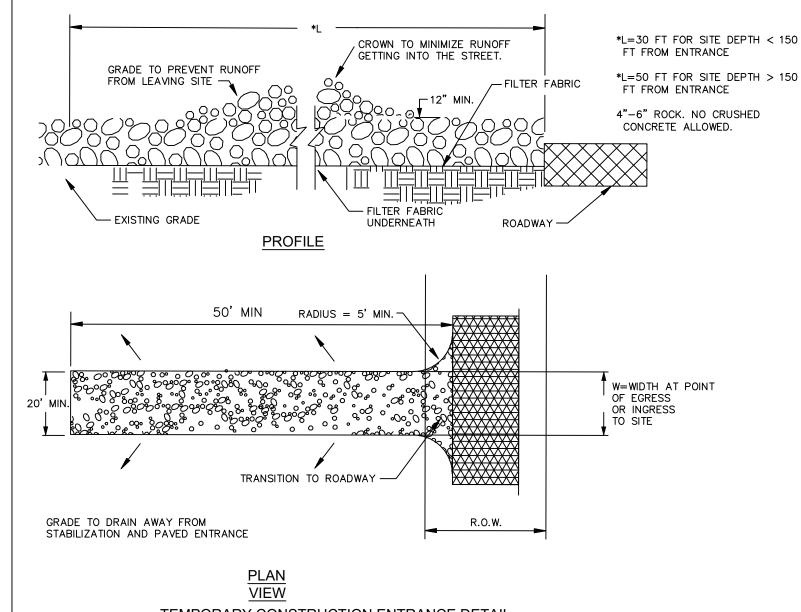


TEMPORARY CONSTRUCTION ENTRANCE DETAIL

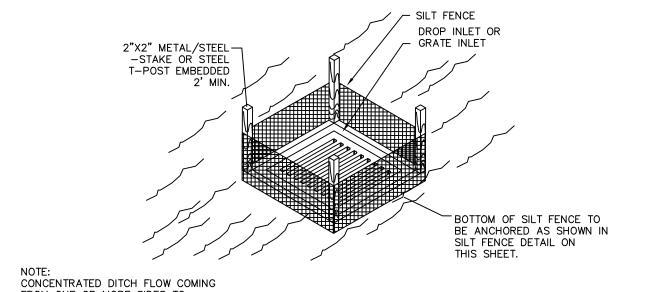


FROM ONE OR MORE SIDES TO THE DROP INLET MAY REQUIRE A STONE CHECK STRUCTURE TO BE CONSTRUCTED

SILT FENCE DROP INLET/ TRENCH DRAIN PROTECTION

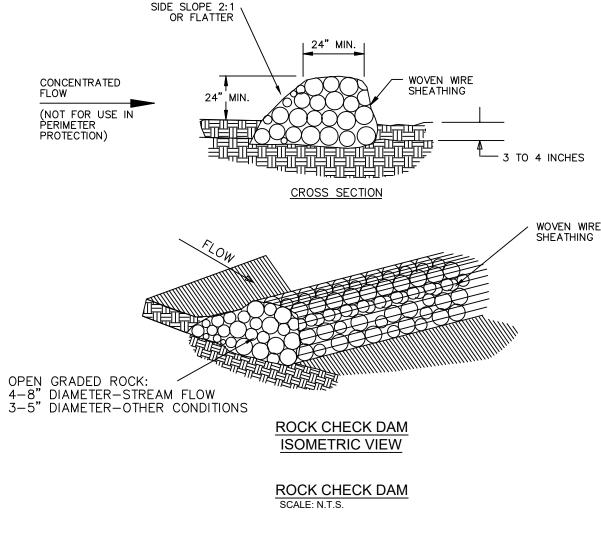


ROCK CHECK DAM GENERAL NOTES

- 1. WOVEN WIRE SHEATHING SHALL HAVE MAXIMUM OPENING OF ONE (1) INCH AND A MINIMUM WIRE SIZE OF 20 GAUGE AND SHALL BE SECURED WITH SHOAT RINGS.
- 2. THE ROCK BERM SHALL BE INSPECTED WEEKLY OR AFTER EACH RAIN AND SHALL BE REPLACED WHEN THE STRUCTURE CEASES TO FUNCTION PROPERLY.
- 3. WHEN SILT REACHES A DEPTH EQUAL TO ONE-THIRD OF THE HEIGHT OF THE BERM OR ONE FOOT. WHICHEVER IS LESS. THE SILT SHALL BE REMOVED AND DISPOSED OF IN AN APPROVED MANNER
- 4. WHEN THE SITE IS COMPLETELY STABILIZED, THE BERM AND ACCUMULATED SILT SHALL BE REMOVED AND

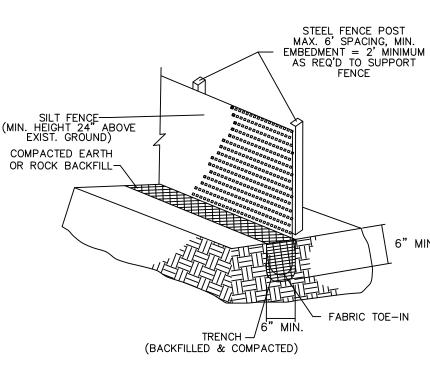


SILT FENCE GENERAL NOTES 1. STEEL POSTS WHICH SUPPORT THE SILT FENCE SHALL BE INSTALLED WITH A SLIGHT ANGLE TOWARD THE

- 2. THE TOE OF THE SILT FENCE SHALL BE TRENCHED IN WITH A SPADE OR MECHANICAL TRENCHER, SO THAT THE DOWNSLOPE FACE OF THE TRENCH IS FLAT AND PERPENDICULAR TO THE LINE OF FLOW. WHERE FENCE CANNOT BE TRENCHED IN (e.g. PAVEMENT), WEIGHT FABRIC FLAP WITH WASHED GRAVEL ON UPHILL SIDE TO
- 3. THE TRENCH MUST BE A MINIMUM OF 6 INCHES DEEP AND 6 INCHES WIDE TO ALLOW FOR THE SILT FENCE
- 6. SILT FENCE SHALL BE REMOVED WHEN THE SITE IS COMPLETELY STABILIZED SO AS NOT TO BLOCK OR
- . ACCUMULATED SILT SHALL BE REMOVED WHEN IT REACHES A DEPTH OF 6 INCHES. THE SILT SHALL BE DISPOSED OF IN AN APPROVED SITE AND IN SUCH A MANNER AS TO NOT CONTRIBUTE TO ADDITIONAL

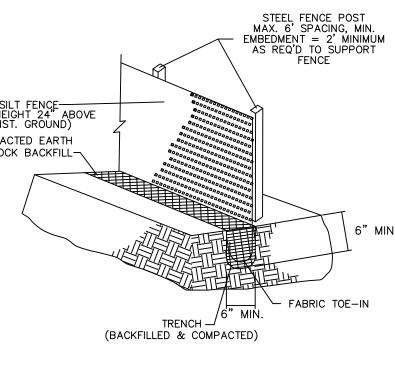



- ANTICIPATED RUNOFF SOURCE. POST MUST BE EMBEDDED A MINIMUM OF ONE FOOT.
- FABRIC TO BE LAID IN THE GROUND AND BACKFILLED WITH COMPACTED MATERIAL
- 4. SILT FENCE SHOULD BE SECURELY FASTENED TO EACH STEEL SUPPORT POST OR TO WOVEN WIRE, WHICH IS IN TURN ATTACHED TO THE STEEL FENCE POST. THERE SHALL BE A 6" DOUBLE OVERLAP, SECURELY
- 5. INSPECTION SHALL BE MADE WEEKLY OR AFTER EACH RAINFALL. REPAIR OR REPLACEMENT SHALL BE MADE
- IMPEDE STORM FLOW OR DRAINAGE.

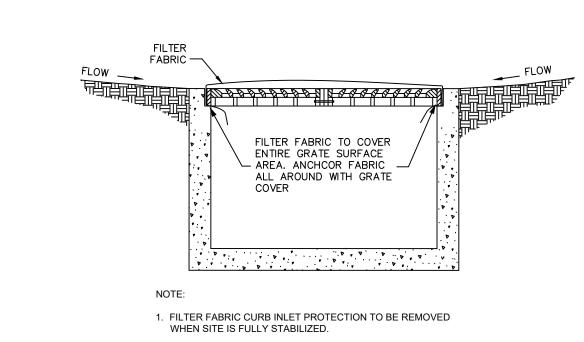

- 2. FILTER FABRIC TO BE CLEARED AFTER EACH RAIN EVENT AT

FILTER FABRIC GRATE INLET PROTECTION

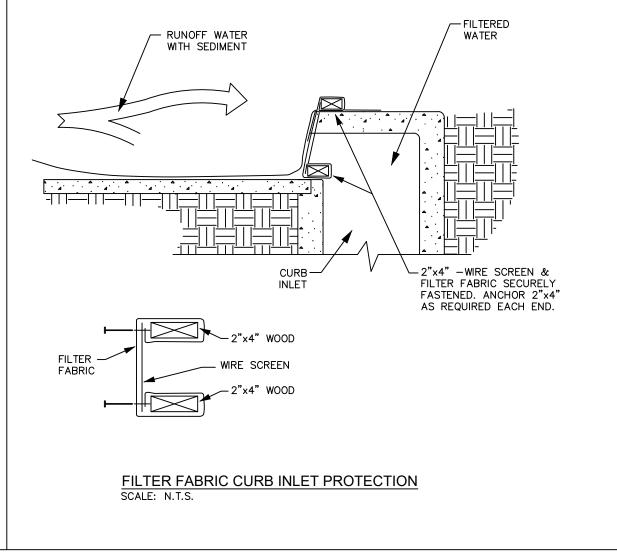

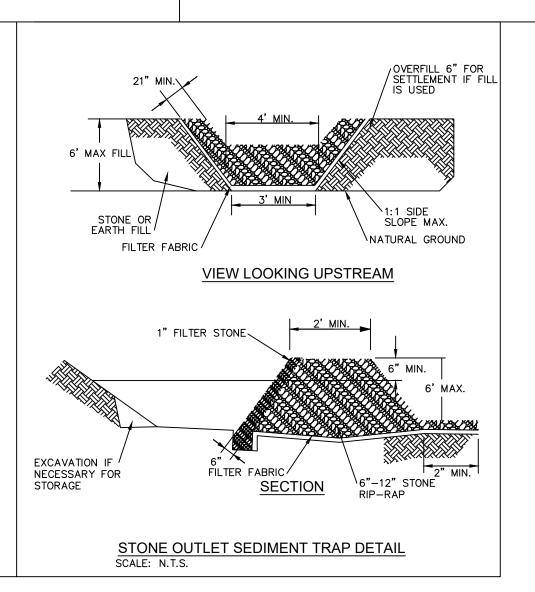

RECORD DRAWING NOVEMBER 24, 2020

THESE RECORD DRAWINGS HAVE BEEN PREPARED BASED ON FIELD **OBSERVATIONS AND INFORMATION** PROVIDED BY THE CONTRACTOR. ELEVATIONS HAVE NOT BEEN FIELD VERIFIED. THE ORIGINAL SEALED CONSTRUCTION DRAWINGS ARE ON FILE AT THE OFFICES OF HALFF ASSOCIATES, INC. TBPE FIRM F-312.

ENGINEER OF RECORD DYLAN B. HEDRICK HALFF ASSOCIATES, INC. TBPE FIRM F-312 DATE: NOVEMBER 24, 2020

Project No.: 38050 **NOVEMBER 2020** Issued: Drawn By: REP Checked By: DBH Scale: AS SHOWN Sheet Title

EROSION CONTROL

DETAILS

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C5.02 Sheet Number