



PLANNING AND ZONING CASE CHECKLIST

City of Rockwall
Planning and Zoning Department
385 S. Goliad Street
Rockwall, Texas 75087

P&Z CASE # SP2020-007 P&Z DATE 04/14/20 CC DATE 05/04/20 APPROVED/DENIED
ARCHITECTURAL REVIEW BOARD DATE _____ HPAB DATE _____ PARK BOARD DATE _____

ZONING APPLICATION

- ☐ SPECIFIC USE PERMIT
- ☐ ZONING CHANGE
- ☐ PD CONCEPT PLAN
- ☐ PD DEVELOPMENT PLAN

SITE PLAN APPLICATION

- ☐ SITE PLAN
- ☐ LANDSCAPE PLAN
- ☐ TREESCAPE PLAN
- ☐ PHOTOMETRIC PLAN
- ☐ BUILDING ELEVATIONS
- ☐ MATERIAL SAMPLES
- ☐ COLOR RENDERING

PLATTING APPLICATION

- ☐ MASTER PLAT
- ☐ PRELIMINARY PLAT
- ☐ FINAL PLAT
- ☐ REPLAT
- ☐ ADMINISTRATIVE/MINOR PLAT
- ☐ VACATION PLAT
- ☐ LANDSCAPE PLAN
- ☐ TREESCAPE PLAN

- ☐ COPY OF ORDINANCE (ORD.# _____)
- ☒ APPLICATIONS
- ☒ RECEIPT
- ☒ LOCATION MAP
- ☐ HOA MAP
- ☐ PON MAP
- ☐ FLU MAP
- ☐ NEWSPAPER PUBLIC NOTICE
- ☐ 500-FT. BUFFER PUBLIC NOTICE
- ☐ PROJECT REVIEW
- ☐ STAFF REPORT
- ☐ CORRESPONDENCE
- ☐ COPY-ALL PLANS REQUIRED
- ☐ COPY-MARK-UPS
- ☐ CITY COUNCIL MINUTES-LASERFICHE
- ☐ MINUTES-LASERFICHE
- ☐ PLAT FILED DATE _____
 - ☐ CABINET # _____
 - ☐ SLIDE # _____

NOTES: _____

ZONING MAP UPDATED _____



DEVELOPMENT APPLICATION

City of Rockwall
Planning and Zoning Department
385 S. Goliad Street
Rockwall, Texas 75087

STAFF USE ONLY

PLANNING & ZONING CASE NO. SP2020-007

NOTE: THE APPLICATION IS NOT CONSIDERED ACCEPTED BY THE CITY UNTIL THE PLANNING DIRECTOR AND CITY ENGINEER HAVE SIGNED BELOW.

DIRECTOR OF PLANNING: _____

CITY ENGINEER: _____

Please check the appropriate box below to indicate the type of development request [SELECT ONLY ONE BOX]:

Platting Application Fees:

- ☐ Master Plat (\$100.00 + \$15.00 Acre) ¹
- ☐ Preliminary Plat (\$200.00 + \$15.00 Acre) ¹
- ☐ Final Plat (\$300.00 + \$20.00 Acre) ¹
- ☐ Replat (\$300.00 + \$20.00 Acre) ¹
- ☐ Amending or Minor Plat (\$150.00)
- ☐ Plat Reinstatement Request (\$100.00)

Site Plan Application Fees:

- ☐ Site Plan (\$250.00 + \$20.00 Acre) ¹
- ☒ Amended Site Plan/Elevations/Landscaping Plan (\$100.00)

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- ☐ Specific Use Permit (\$200.00 + \$15.00 Acre) ¹
- ☐ PD Development Plans (\$200.00 + \$15.00 Acre) ¹

Other Application Fees:

- ☐ Tree Removal (\$75.00)
- ☐ Variance Request (\$100.00)

Notes:

¹: In determining the fee, please use the exact acreage when multiplying by the per acre amount. For requests on less than one acre, round up to one (1) acre.

PROPERTY INFORMATION [PLEASE PRINT]

Address 1480 Justin Rd.

Subdivision SPR Packaging Addition

Lot

2

Block

A

General Location 1/2 mile north of Highway 30 at the intersection of Justin Rd. and Industrial Blvd.

ZONING, SITE PLAN AND PLATTING INFORMATION [PLEASE PRINT]

Current Zoning LI

Current Use Warehouse, Manufacturing, Office

Proposed Zoning LI

Proposed Use Warehouse, Manufacturing, Office

Acreage 10.1893

Lots [Current]

Lots [Proposed]

☐ **SITE PLANS AND PLATS:** By checking this box you acknowledge that due to the passage of HB3167 the City no longer has flexibility with regard to its approval process, and failure to address any of staff's comments by the date provided on the Development Calendar will result in the denial of your case.

OWNER/APPLICANT/AGENT INFORMATION [PLEASE PRINT/CHECK THE PRIMARY CONTACT/ORIGINAL SIGNATURES ARE REQUIRED]

☐ Owner Alvaplast US Development LLC (SPR Packaging)

☒ Applicant Pross Design Group

Contact Person Carolina Molina

Contact Person David A. Morales

Address 1480 Justin Rd.

Address 5310 Harvest Hill Rd.

Suite 180

City, State & Zip Rockwall, TX 75087

City, State & Zip Dallas, TX 75230

Phone 469-745-9231

Phone 972-759-1400

E-Mail cmolina@sprpackaging.com

E-Mail dmorales@pdgarch.net

NOTARY VERIFICATION [REQUIRED]

Before me, the undersigned authority, on this day personally appeared Carolina Molina [Owner] the undersigned, who stated the information on this application to be true and certified the following:

"I hereby certify that I am the owner for the purpose of this application; all information submitted herein is true and correct; and the application fee of \$ 100 =, to cover the cost of this application, has been paid to the City of Rockwall on this the 20 day of March, 20 20. By signing this application, I agree that the City of Rockwall (i.e. "City") is authorized and permitted to provide information contained within this application to the public. The City is also authorized and permitted to reproduce any copyrighted information submitted in conjunction with this application, if such reproduction is associated or in response to a request for public information."


Given under my hand and seal of office on this the 20 day of March, 20 20.

Owner's Signature

Carolina Molina

Notary Public in and for the State of Texas

Jaime Garcia

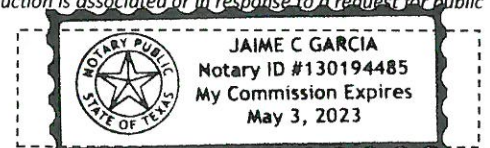

My Commission Expires



DEVELOPMENT REVIEW COMMITTEE (DRC)

CITY OF ROCKWALL, PLANNING & ZONING DEPARTMENT

Phone: (972) 771-7745

Email: Planning@Rockwall.com

External Review:

- Wayne Carter, Charter Communications
- Jim Friske, Charter Communications
- Dinah Wood, Atmos
- Randy Voight, Oncor
- Phillip Dickerson, Oncor
- Brian Duncan, AT&T
- Javier Fernandez, RISD
- Brenda Callaway, TXDOT
- Stephen Geiger, Farmer's Electric
- Frank Spataro, Farmer's Electric

Internal Review:

- Amy Williams, Engineering
- John Shannon, Building Inspections
- Ariana Hargrove, Fire
- Andy Hesser, Parks
- Andy Villarreal, Police

From: Planning & Zoning Department

Date: 3/23/2020

To assist the Planning Department in evaluating the attached request, we are sending it to you for your review and comments. Please return any comments and/or plan mark-ups to us within five (5) days. Internal staff will also be required to have all comments input into CRW no later than Friday, 03/26/2020. Planning staff will assemble all comments received in time for our regularly scheduled DRC meeting on 3/26/2020 at 2:00 p.m. The Planning and Zoning Commission work session will be held on 4/14/2020 at 6:00 p.m. You are welcome to attend both meetings. If you have any questions, please contact us at (972) 771-7745.

Project Number: SP2020-007

Project Name: 1480 Justin Rd.

Project Type: SITE PLAN

Applicant Name: DAVID MORALES

Owner Name: CAROLINA MOLINA

Project Description:



DEVELOPMENT APPLICATION

City of Rockwall
Planning and Zoning Department
385 S. Goliad Street
Rockwall, Texas 75087

STAFF USE ONLY

PLANNING & ZONING

CASE NO.

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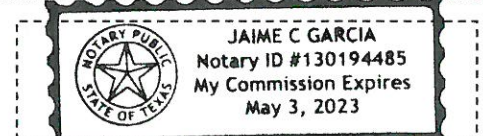
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Owner's Signature

Carolina Molina

Notary Public in and for the State of Texas

Jaime Garcia


My Commission Expires



City of Rockwall

Planning & Zoning Department
385 S. Goliad Street
Rockwall, Texas 75032
(P): (972) 771-7745
(W): www.rockwall.com

The City of Rockwall GIS maps are continually under development and therefore subject to change without notice. While we endeavor to provide timely and accurate information, we make no guarantees. The City of Rockwall makes no warranty, express or implied, including warranties of merchantability and fitness for a particular purpose. Use of the information is the sole responsibility of the user.

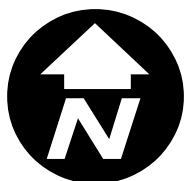



Date: March 20, 2020
Project: SPR Office and Ink Room
Project No.: 1854 – 1914
Case No: SP2019-030

RE: REVISION NARRATIVE – AMENDED SITE PLAN SUBMITTAL

The following changes have been made to the previous approved site plan.

ARCHITECTURAL:

A1.0 Site Plan

- The compactor enclosure has been moved further east and adjoined to the Ink Room addition exterior wall. The building wall will be protected by a traffic rated guardrail.
- Doors and stairs along the existing south wall have been relocated as needed to accommodate the new location of the compactor enclosure.
- At the existing west drive, the drive lane has been straightened with the Owner's removal of the existing 30" unprotected Bois d'Arc tree. Parking has been reconfigured to add three additional spaces to the site.
- Parking data is updated to reflect the additional parking spaces and the actual number of parking spaces added with the office and ink room additions.

A1.1 Demolition / Existing Site Plan

- Demolition is depicted for the above site changes.

A3.1 Ink Room Exterior Elevations

- Elevations are revised to show the new location of the compactor enclosure and the correct depiction of the entry stairs to the future locker room portion.

Variance Request Letter

- The parking variance request is revised to reflect the additional parking spaces added with these changes.

LANDSCAPE:

L1.01 Tree Preservation Plan

- Revised to show the removal of tree 1654 along the west drive.

L2.01 Landscape Plan

- Revised landscaping and tree location along the new parking configuration and affected drive areas.

L3.01 Irrigation Plan

- Revised irrigation design along the new parking configuration and affected drive areas.

The following sheets are included in the submission but are unchanged:

- A3.0 Office Addition Exterior Elevations
- L2.02 Landscape Specifications and Details
- L3.02 Irrigation Specifications and Details
- MEP1.1 Site Photometric Plans
- MEP1.2 Light Fixture Cut Sheets
- MEP1.3 Light Fixture Cut Sheets
- MEP1.1 Lighting Wall Elevations

Additional submittal items included:

- Application and Fee
- Owner supplied letter regarding parking needs

Sincerely,

A handwritten signature in black ink, appearing to read 'D. Morales', written in a cursive style.

David A. Morales
Project Architect

Attachments:

A1.0, A1.1, A3.0, A3.1, L1.01, L2.01, L2.02, L3.01, L3.02, MEP1., MEP1.2, MEP1.3, MEP1.4
Variance Request Letter, Owner Parking Letter, Application and Fee



SPR OFFICE ADDITION SITE PLAN SUBMITTAL
REQUESTED VARIANCES

On behalf of SPR Packaging, the following is a list of variances to the City of Rockwall Development Codes that we wish to submit to your office for the Site Plan Submittal.

SPR Packaging, located at 1480 Justin Rd., proposes a two-phase expansion which will include a two-story 22,564 SF Office addition and a 7,046 SF Ink Storage Room and future Employee Locker Room addition. In connection with this project, we request the following variances:

A. Off-Street Parking Requirements:

Article VI, section 2.3 indicates that when a building is expanded, the provisions for parking and loading shall be provided for the portion of land use and/or building that has been added. By this calculation, the proposed additions would require 82 spaces. Due to site constraints, only a total of 54 new parking spaces can be provided with this addition. The Owner feels that the total parking provided on-site after the completion of the two additions (154 spaces) is adequate for their actual needs. The Owner wishes to be granted a variance to reduce the required parking amount.

B. Construction Materials:

In order to achieve the desired architectural aesthetic, the Owner wishes to be granted a variance to eliminate requirements for stone and masonry on the building facades and the 10% maximum of secondary materials based on Article V, Section 4.01.A.2 Exception.

C. Building Articulation:

In order to achieve the desired architectural aesthetic, the Owner wishes to be granted a variance to the requirements for Horizontal and Vertical Articulation of Facades.

D. Dumpster Enclosure:

To accommodate the new office addition, the existing dumpster enclosure must be relocated. The only possible location is directly to the east of the existing location on the side that fronts Justin Rd. Based on the fact that the existing dumpster enclosure faced Justin Rd., we request a variance to locate the dumpster as proposed facing Justin Rd.

SPR Office Addition
Requested Variances
03/19/20
Page 2

Although the Owner has requested these variances, it is their intent to provide a unique and aesthetically pleasing architectural design constructed of high-quality materials. Additionally, as a compensatory measure for the requested site-related variances, additional landscaping and trees will be added to the landscaping fronting Justin Rd.

Sincerely,

A handwritten signature in black ink, appearing to read 'D. Morales', with a stylized, flowing script.

David A. Morales
Project Architect

DAM/cs

Attachments: Owner Letter Re: Parking

September 5, 2019

Ryan Miller
Director of Planning and Zoning
City of Rockwall
385 S. Goliad Street
Rockwall, TX 75087

Mr. Miller,


Please accept this letter as an indication of the sincere interest in ensuring that, the addition of the Headquarter Office, is not to exceed the number of 125 people working per shift at the same time. The office addition is forethought will relocate the administrative office to the new addition and the production office to the actual main area. The intention is to improve the available workspace for the office and production employees as well.


This number covers the entire staff that will use the parking space for 24 hours, seven days a week. Considering that the currently designed parking spaces are more than the minimum requirement for that number of people; we assume it will not be any inconvenience in the future. Therefore, we would appreciate your approval on this subject. Thank you for your time and consideration.

Sincerely,

Ignacio Echávarri
President SPR Packaging

SPR
PACKAGING  **armando alvarez**
GROUP COMPANY

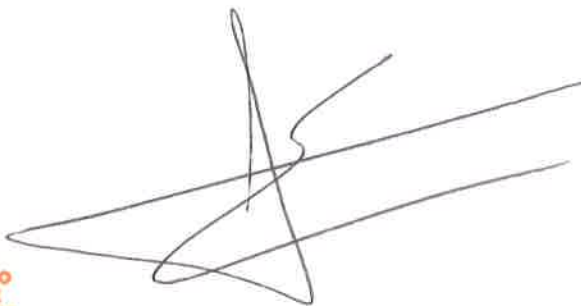

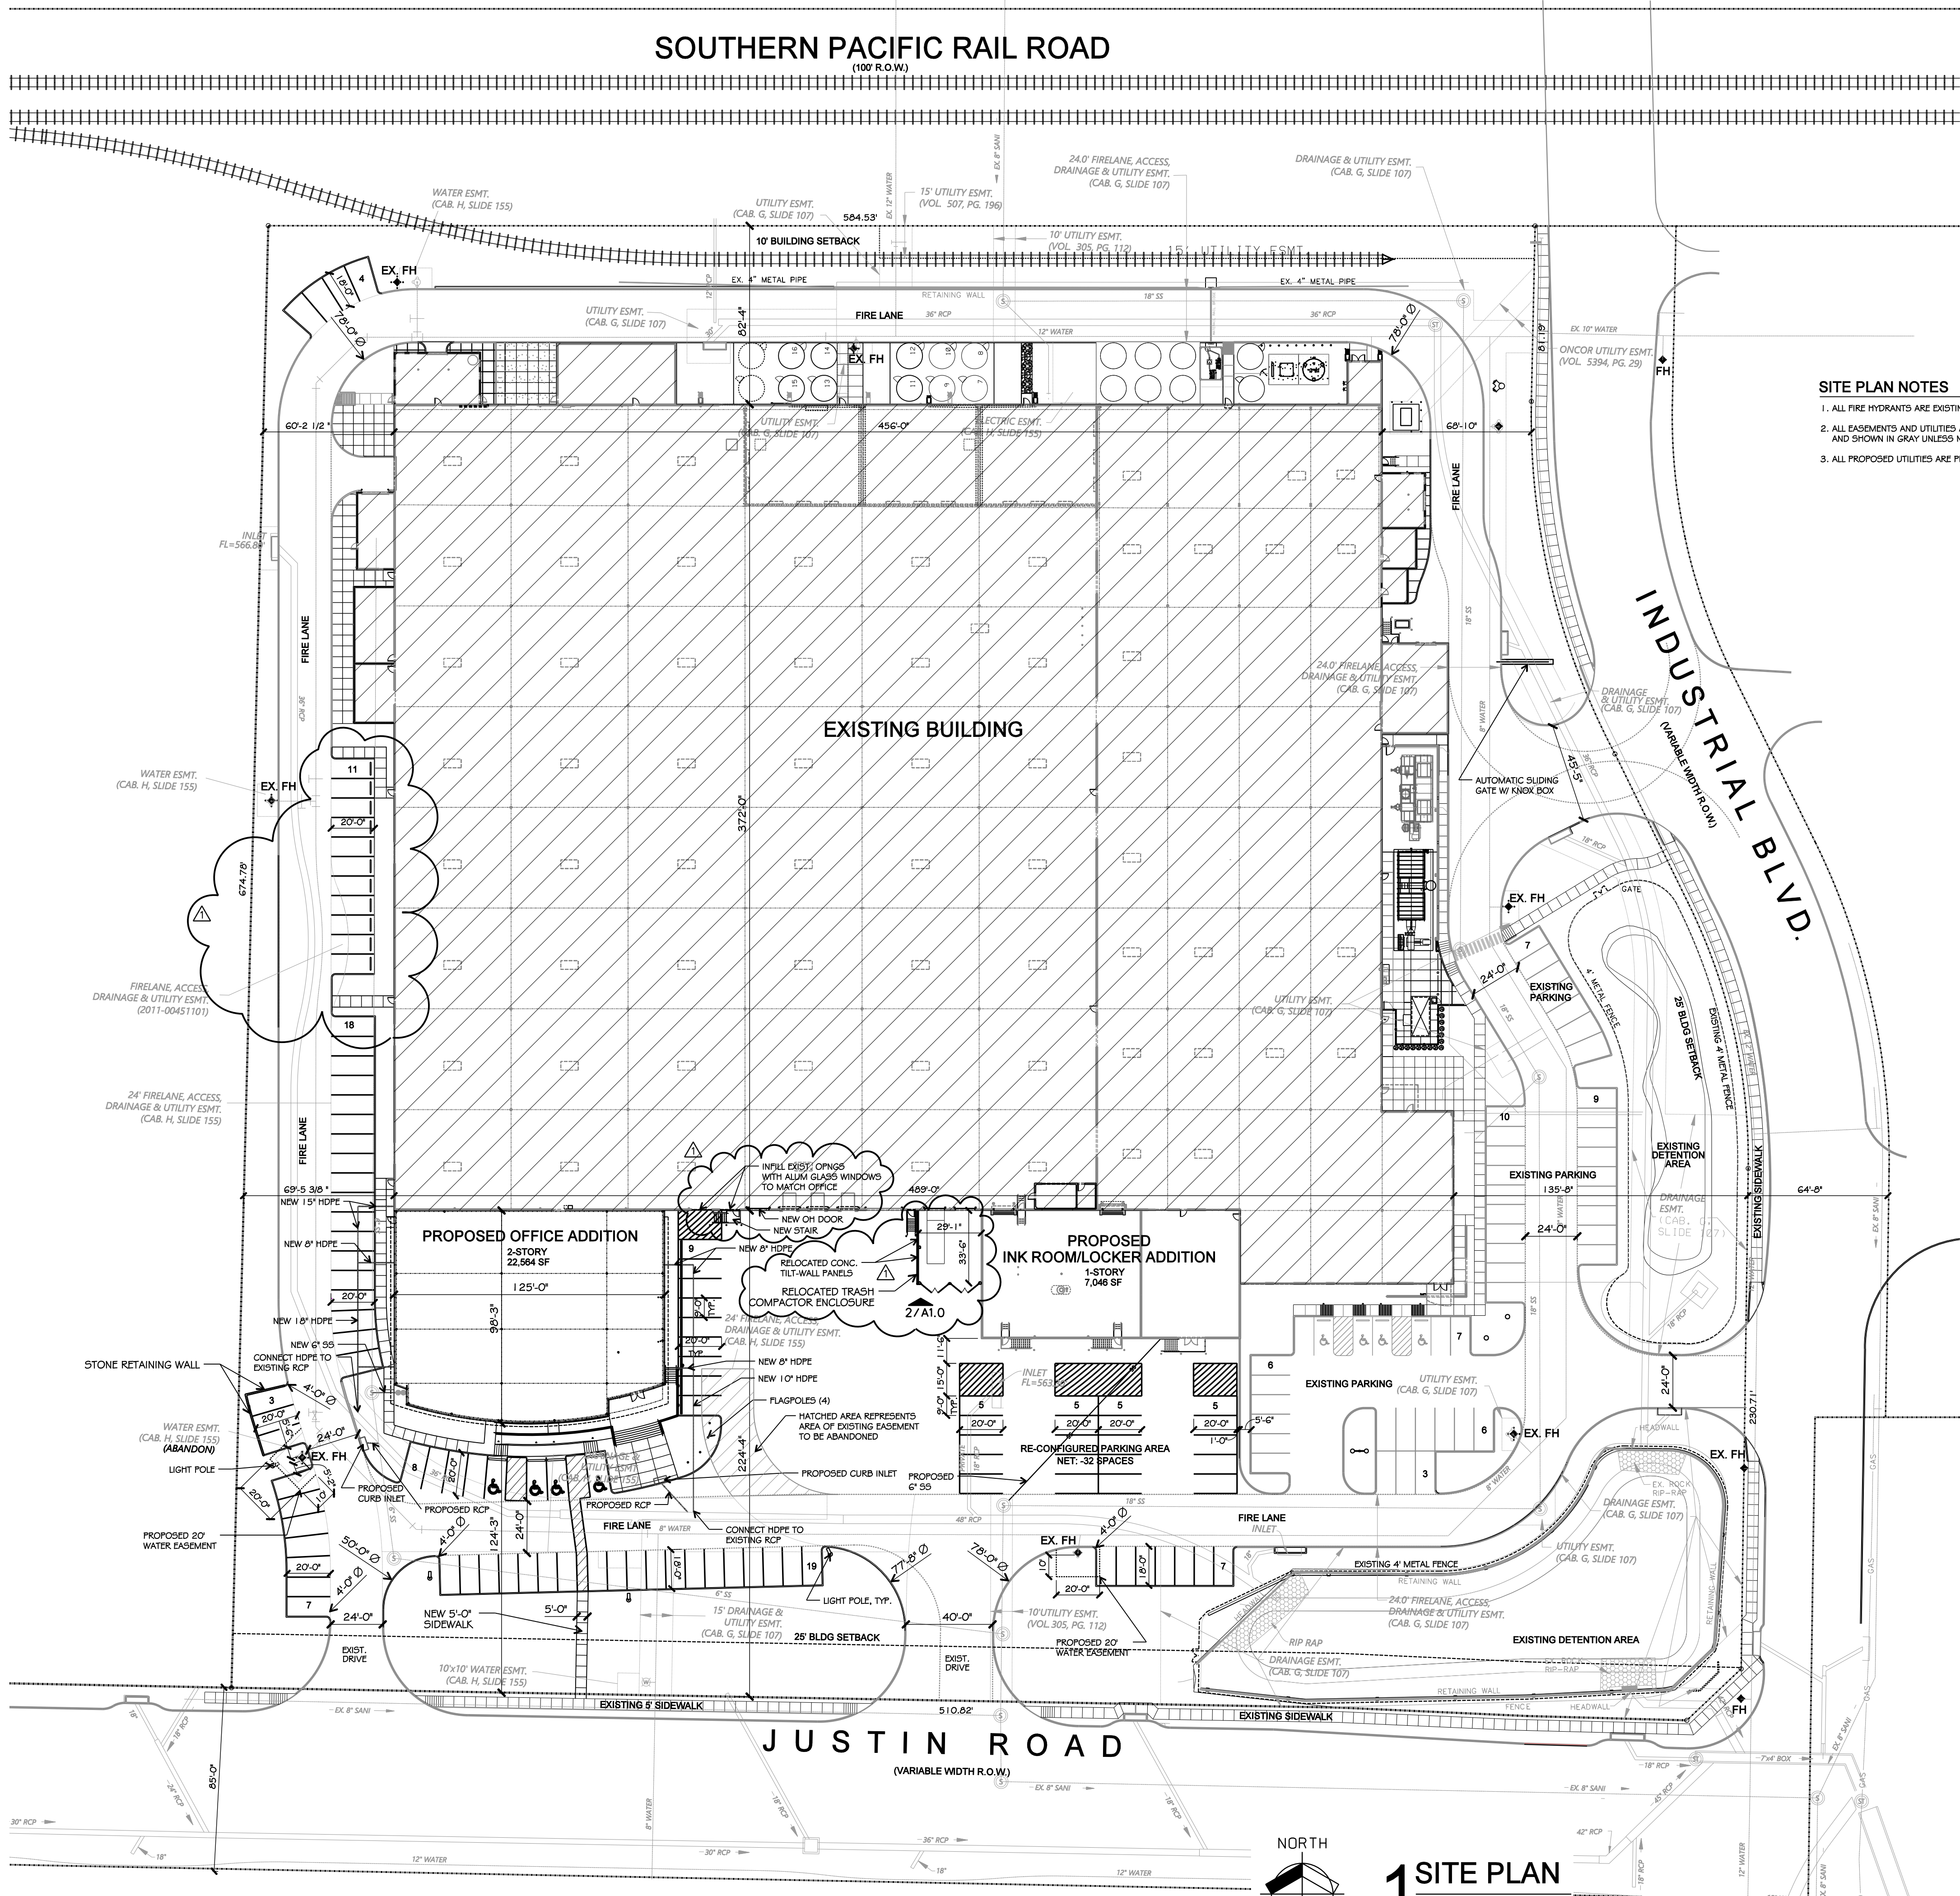

- SITE PLAN NOTES**
1. ALL FIRE HYDRANTS ARE EXISTING TO REMAIN.
 2. ALL EASEMENTS AND UTILITIES ARE EXISTING AND SHOWN IN GRAY UNLESS NOTED OTHERWISE.
 3. ALL PROPOSED UTILITIES ARE PRIVATE.

PROJECT DATA


| | |
|----------------------------------|---------------------------|
| ZONING: | LIGHT INDUSTRIAL |
| PROPOSED LAND USE: | WAREHOUSE, MANUF., OFFICE |
| SITE AREA: | 10.18 AC |
| | 443,480.8 SF |
| BUILDING AREA: | |
| EXISTING BUILDING: | 188,516 SF |
| OFFICE ADDITION: | |
| FIRST FLOOR: | 11,828 SF |
| SECOND FLOOR: | 10,936 SF |
| TOTAL: | 22,564 SF |
| INK ROOM / LOCKER ROOM ADDITION: | 7,046 SF |

PARKING DATA SUMMARY


| PROPOSED USE | AREA | FACTOR | REQ. SPACES |
|--------------------------|------------|----------|-------------|
| EXISTING BUILDING | | | |
| OFFICE | 26,038 SF | EXISTING | - |
| MANUFACTURING | 18,805 SF | EXISTING | - |
| WAREHOUSE | 143,673 SF | EXISTING | - |
| PROPOSED ADDITION | | | |
| OFFICE (2-STORIES) | 22,564 SF | 1:300 | 75 |
| INK ROOM (WAREHOUSE) | 7,046 SF | 1:1000 | 7 |

| | | | |
|--|--|--|----|
| TOTALS | | | |
| - REQUIRED FOR ADDITIONS | | | 82 |
| - PROVIDED WITH ADDITIONS | | | 54 |
| TOTAL PARKING VARIANCE REQUESTED | | | 28 |
| ACCESSIBLE PARKING REQUIREMENTS | | | |
| - REQUIRED FOR OFFICE ADDITION | | | *4 |
| - PROVIDED FOR OFFICE ADDITION | | | 4 |

*BASED ON NEW PLUS EXISTING PARKING THAT WILL BE ASSOCIATED WITH THE PARKING LOT SERVING THIS ADDITION

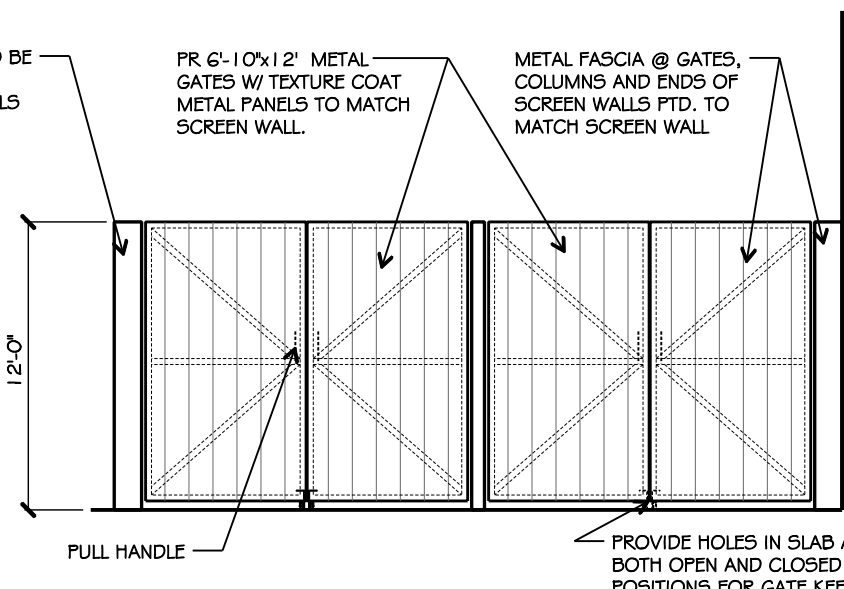

LOCATION MAP

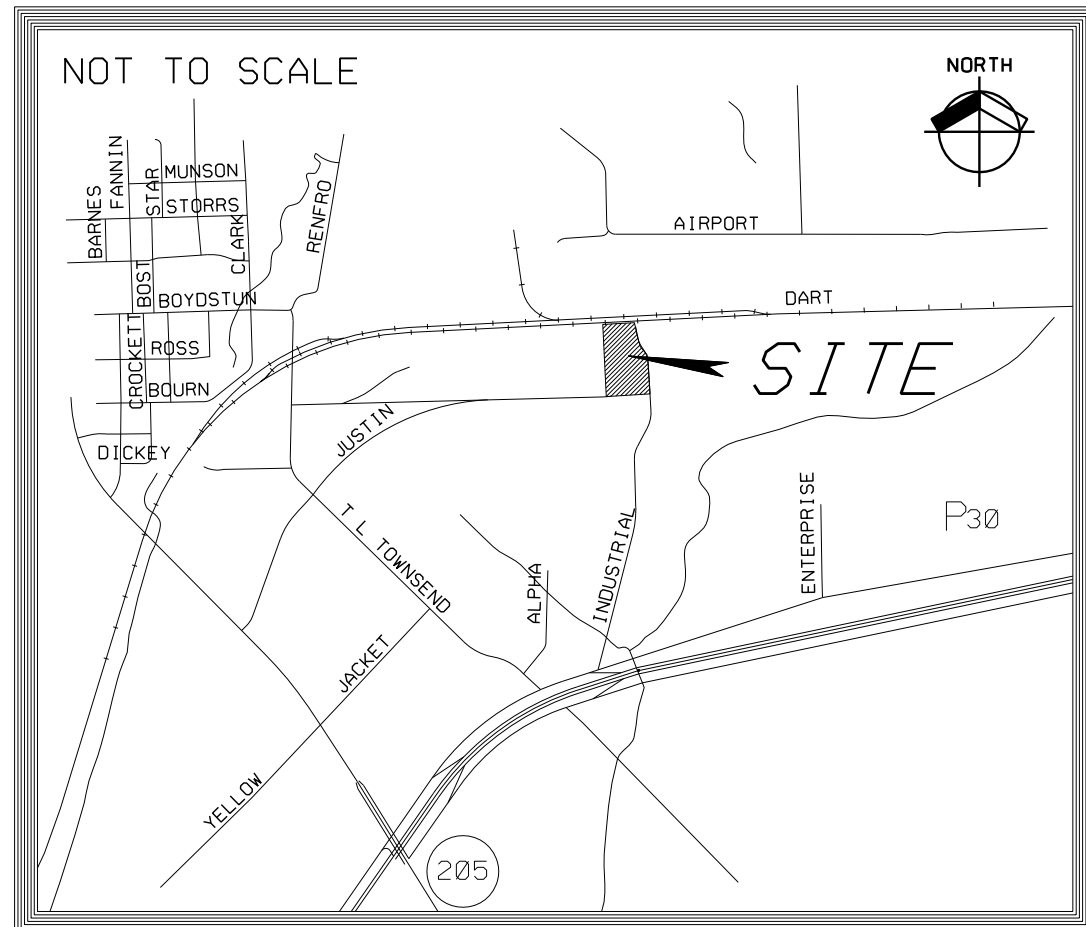


OWNER:
ALVAPLAST US. INC. / SPR PACKAGING
CONTACT: CAROLINA MOLINA
1480 JUSTIN ROAD
ROCKWALL, TX 75087
469-402-1232

ARCHITECT:
PROSS DESIGN GROUP, INC.
CONTACT: BOBBY PROSS
5310 HARVEST HILL ROAD, SUITE 180
DALLAS, TX 75230
972-759-1400

CASE NO: SP2019-030

Drawn:
DANIEL PROSS
ROBERT PROSS
COTE
09/08/19

| # | DATE | DESCRIPTION |
|---|------------|-----------------------------|
| 1 | 03/20/2020 | AMENDED SITE PLAN SUBMITTAL |


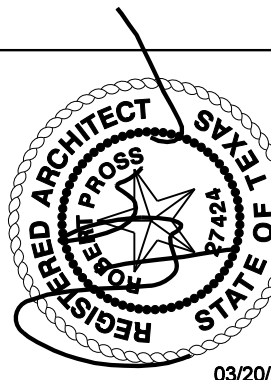


03/20/2020

pross design group, incorporated
5310 HARVEST HILL ROAD, SUITE 180, DALLAS, TEXAS 75230

SPR PACKAGING
OFFICE ADDITION
1480 JUSTIN RD., ROCKWALL, TEXAS

job no
1854
sheet
A1.0

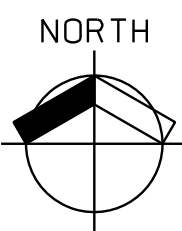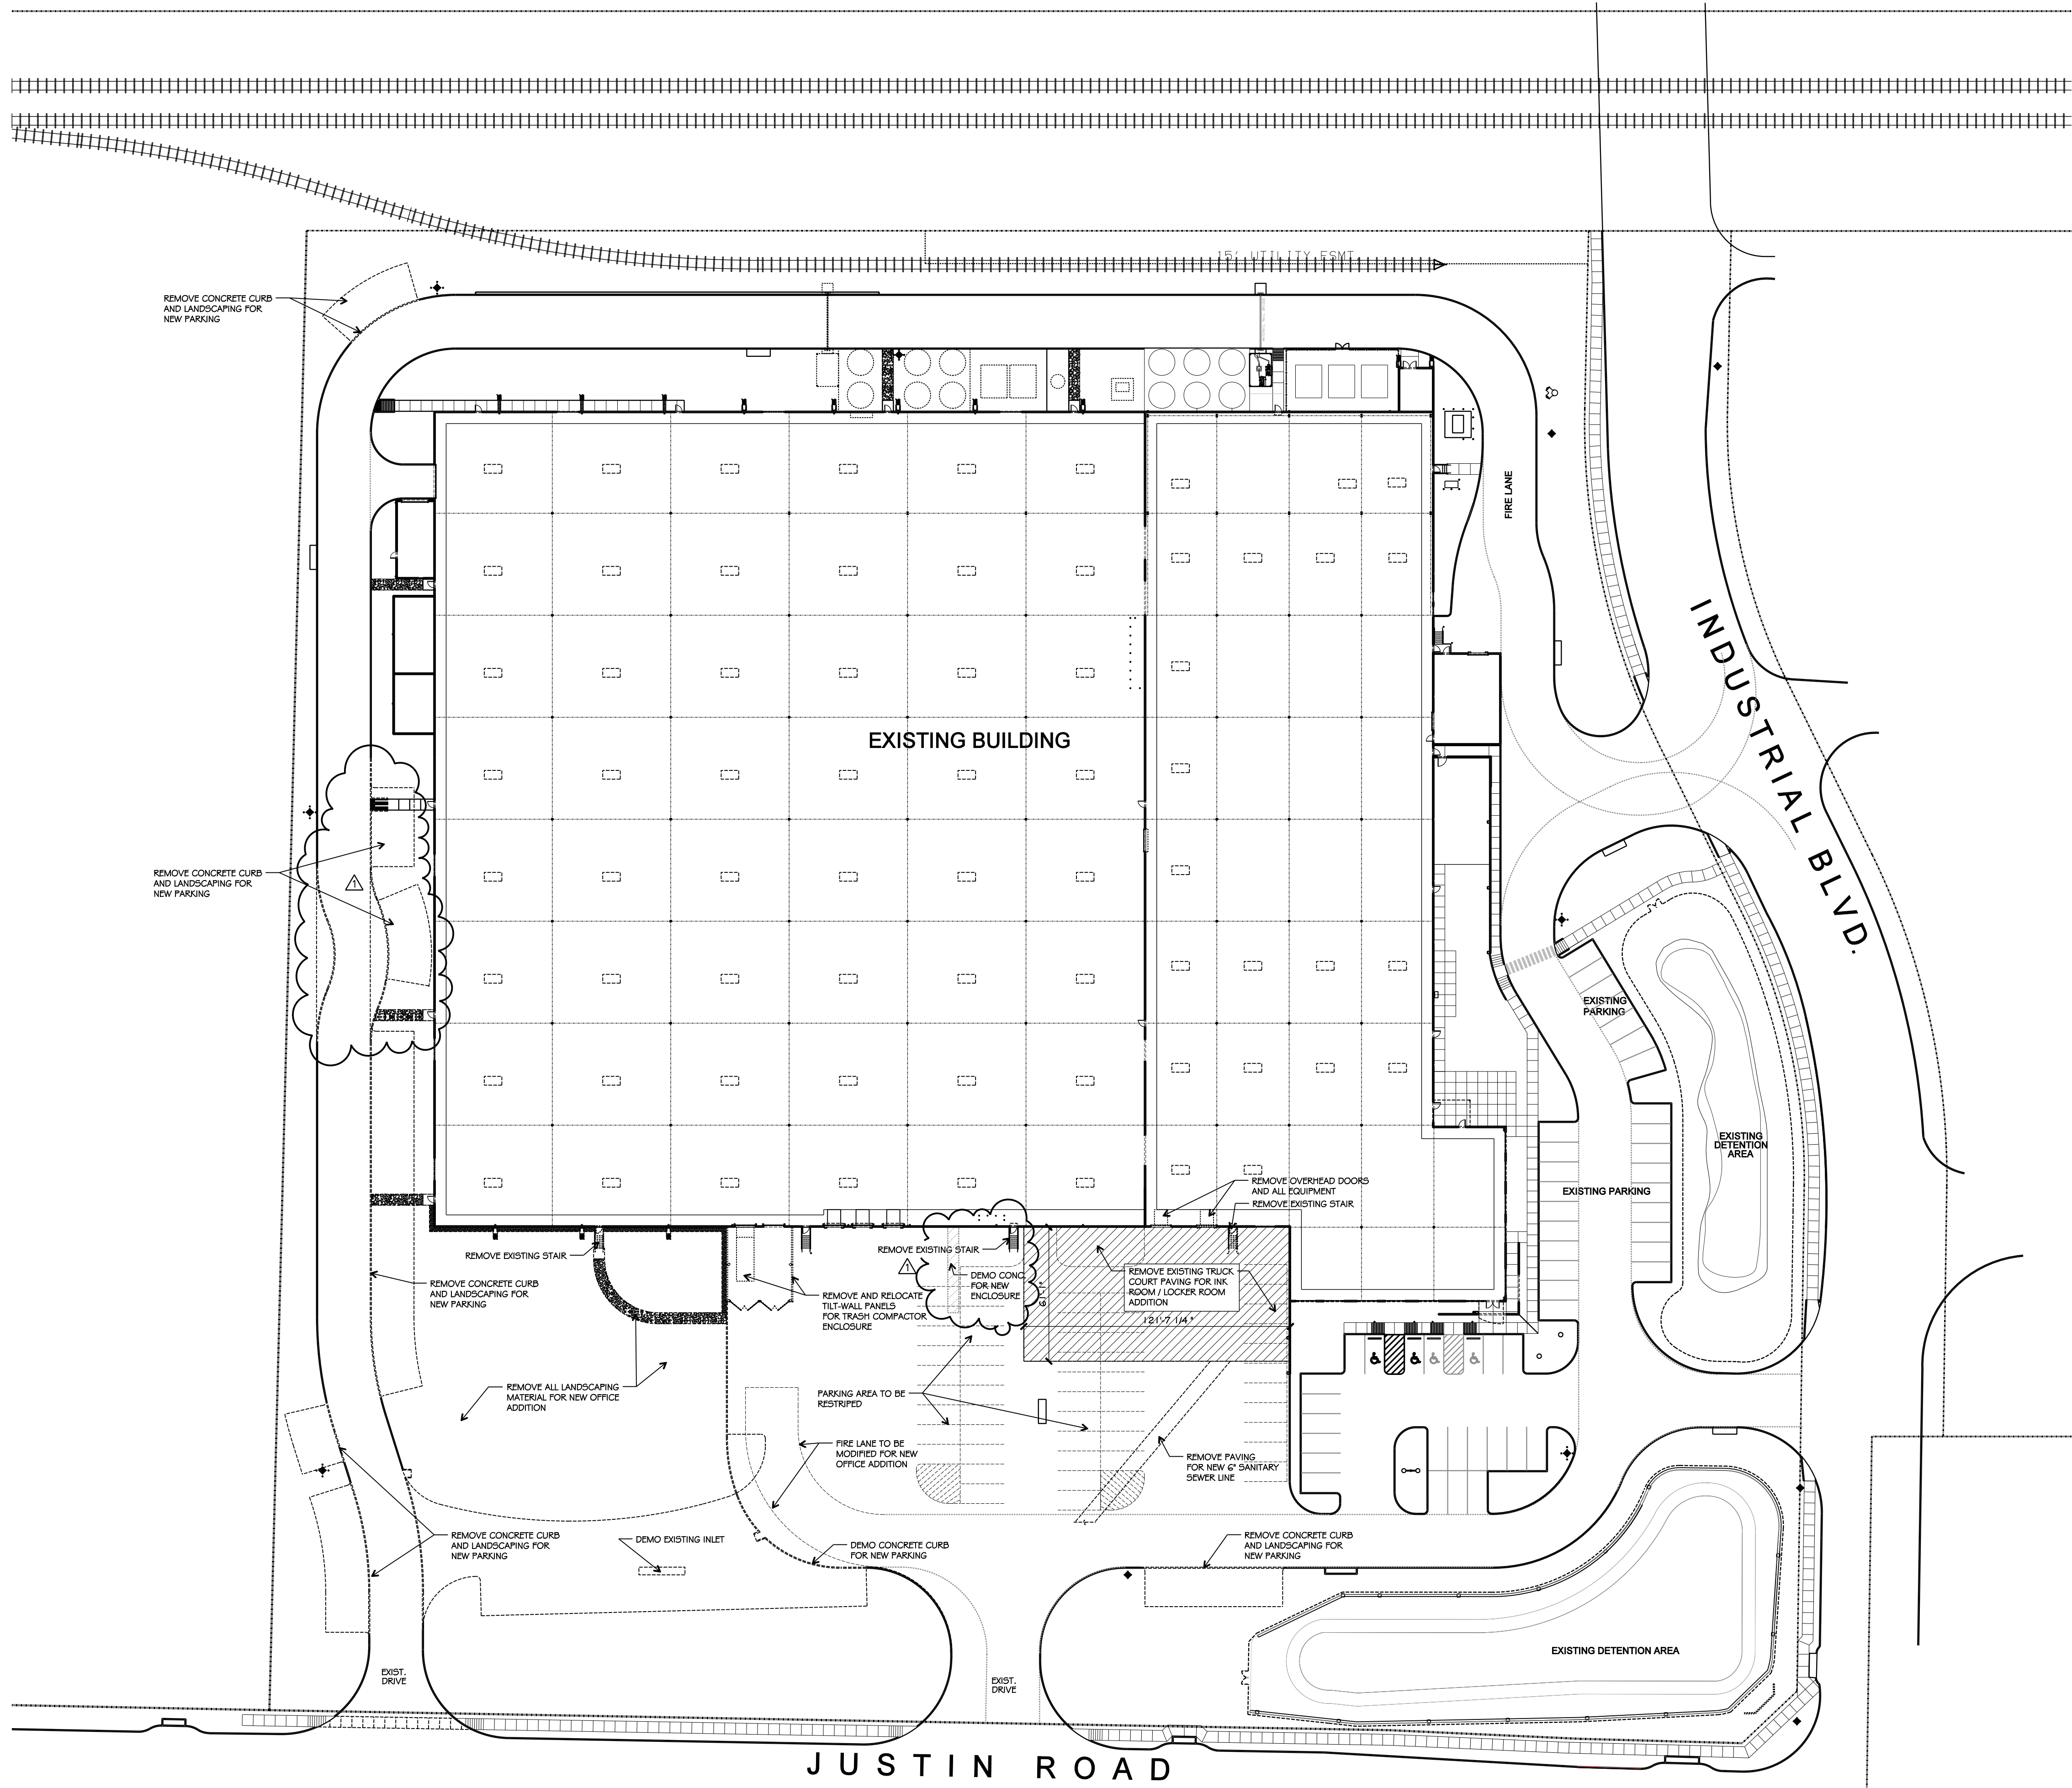

DEMOLITION /
1 EXISTING SITE PLAN
SCALE: 1"=40'-0"


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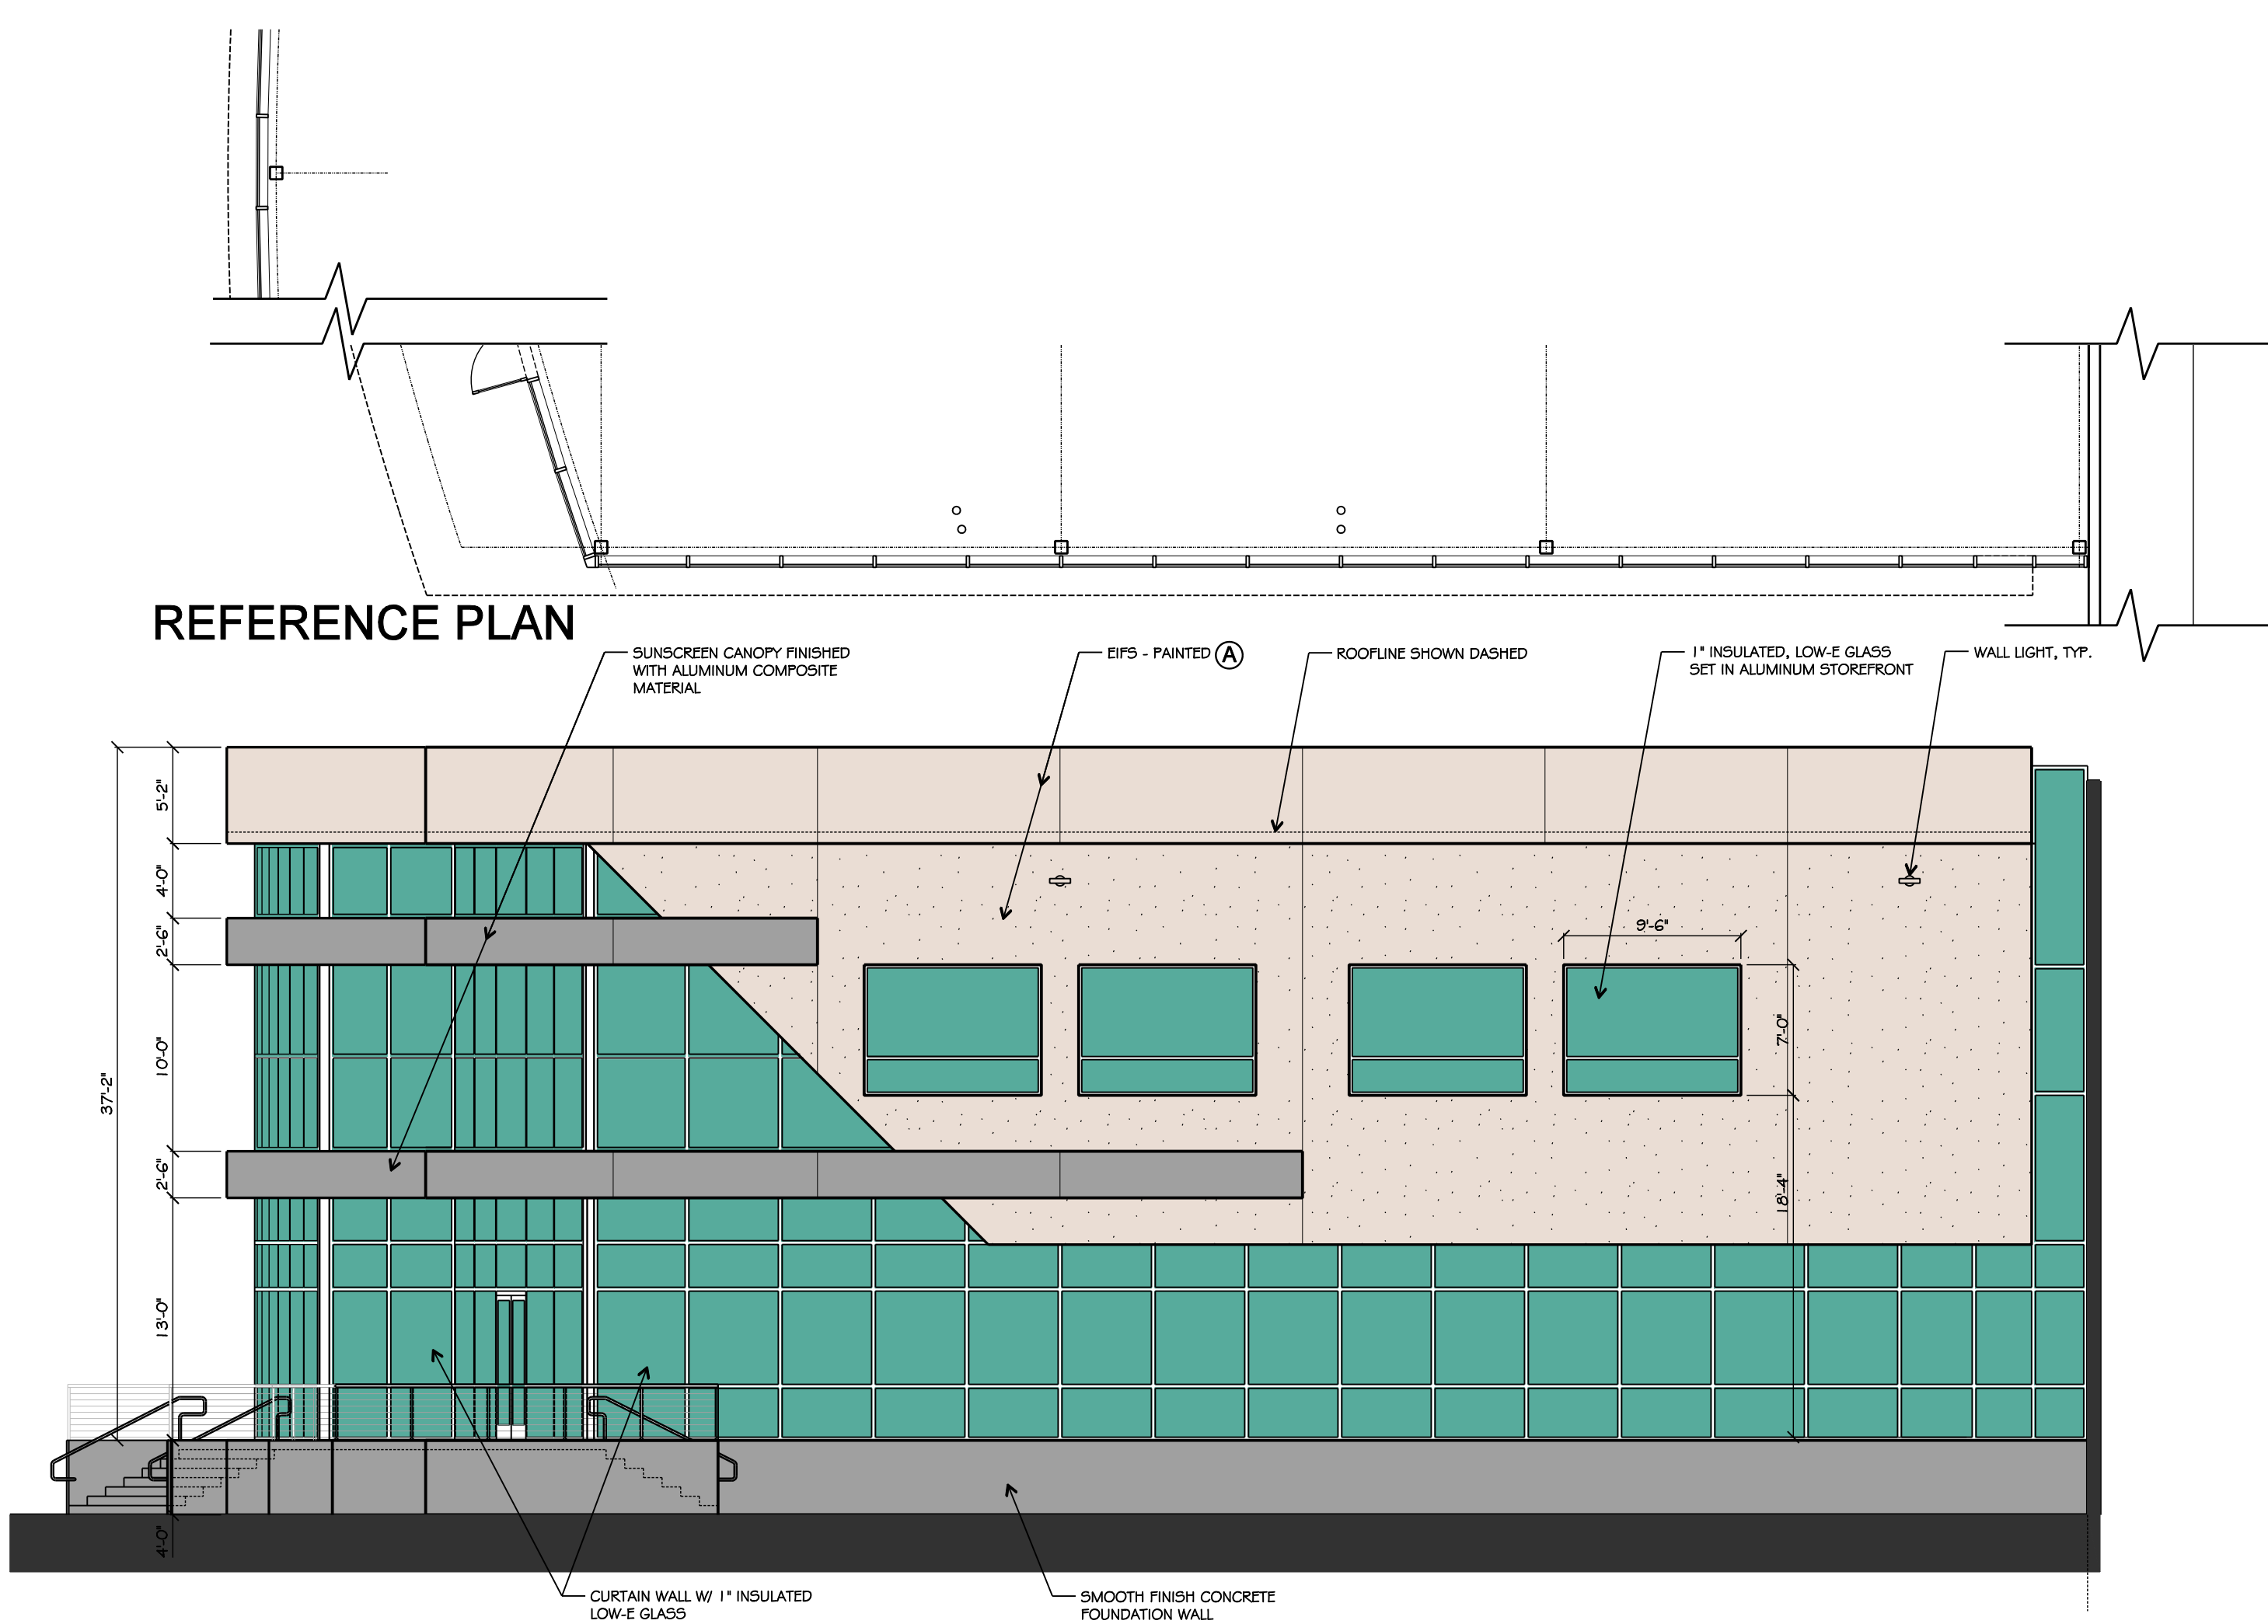
pross
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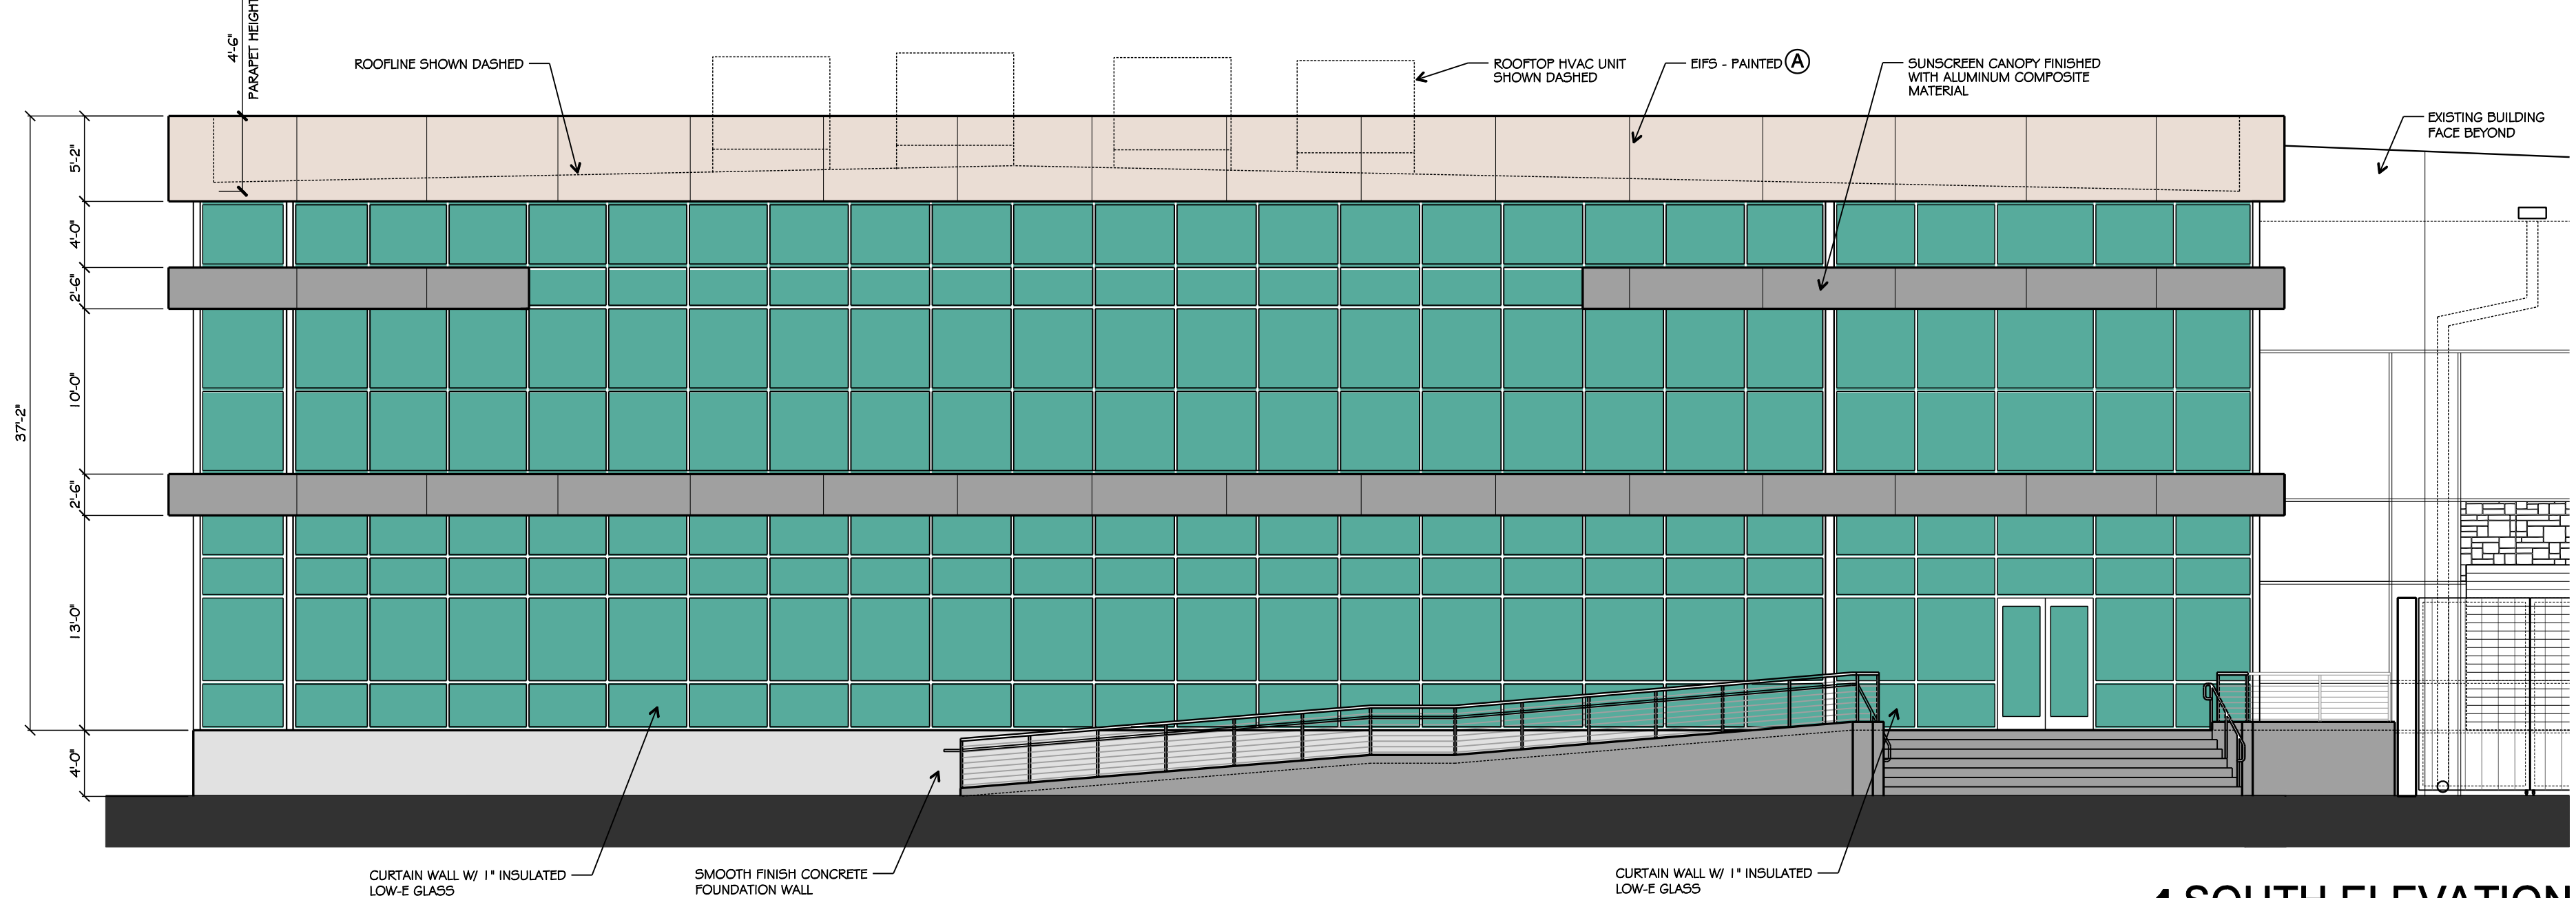
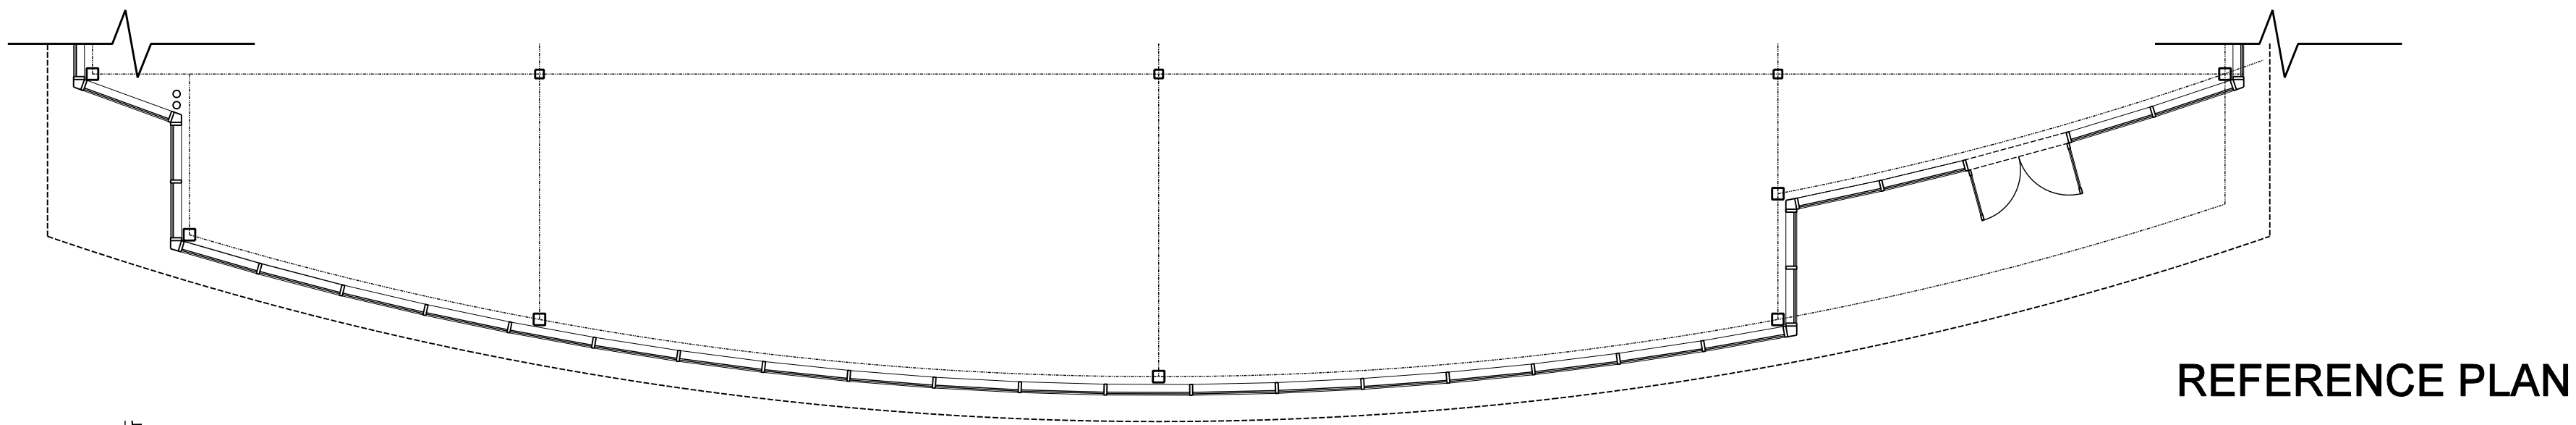
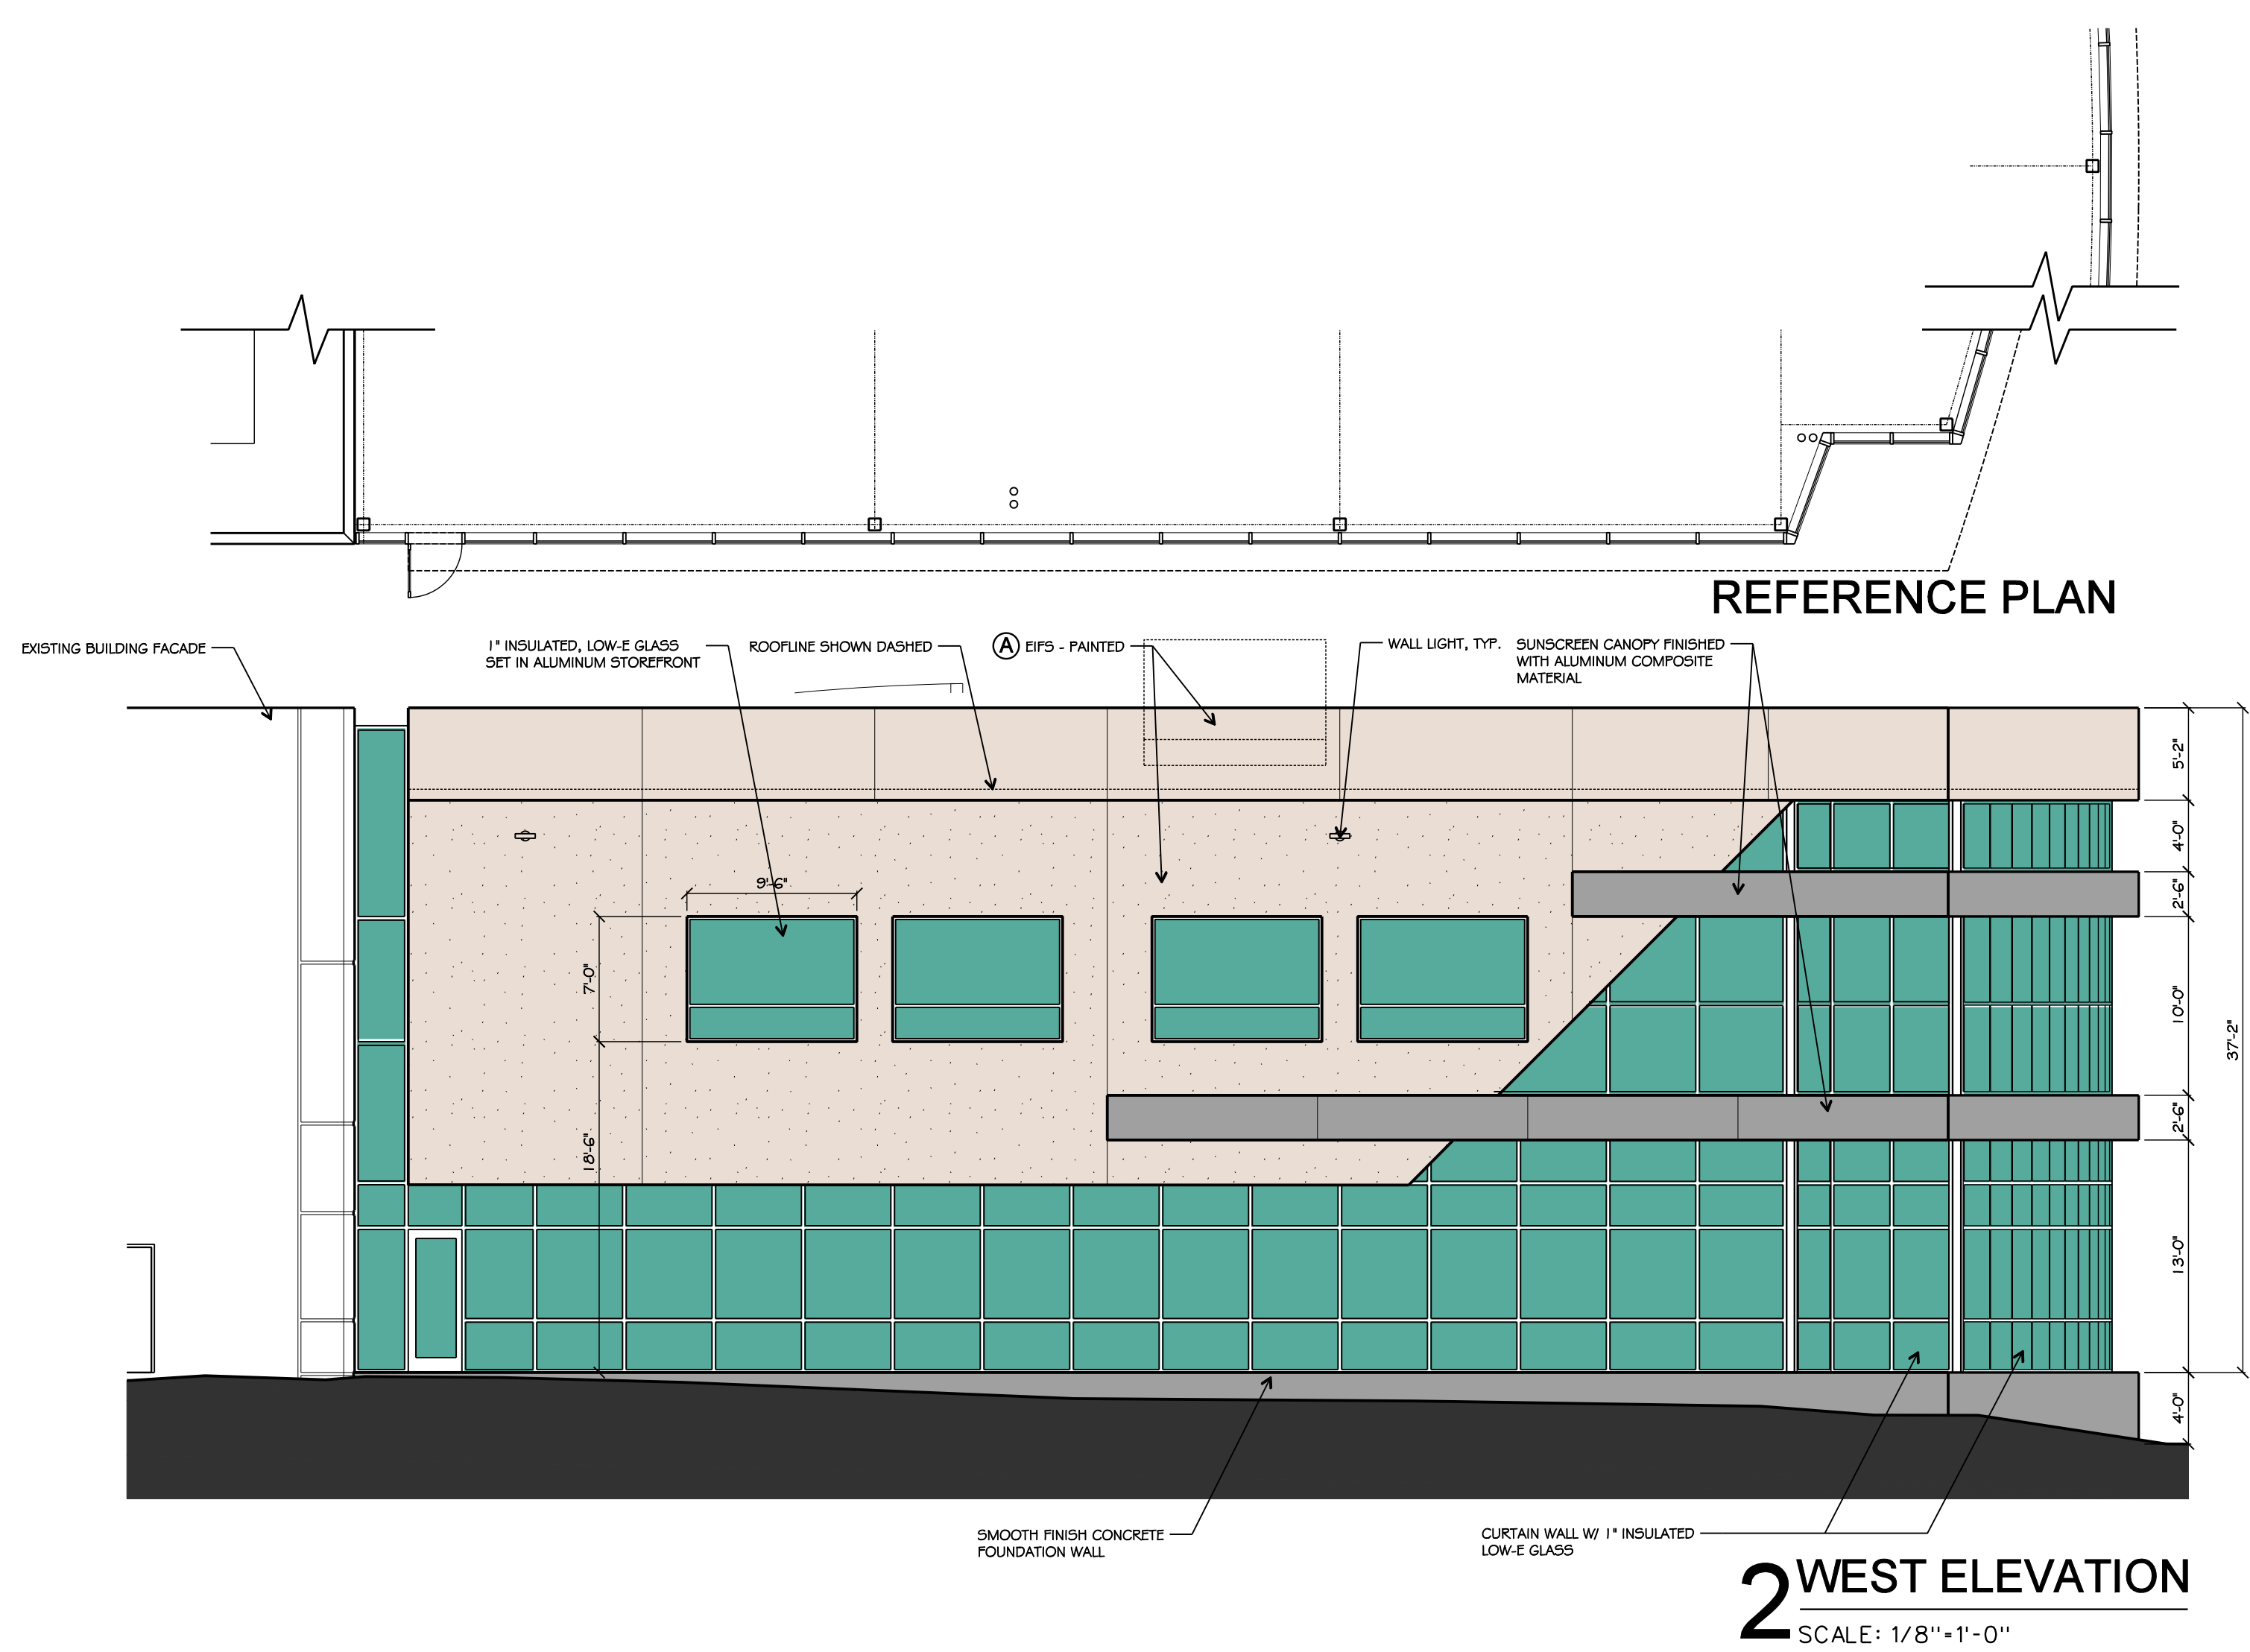
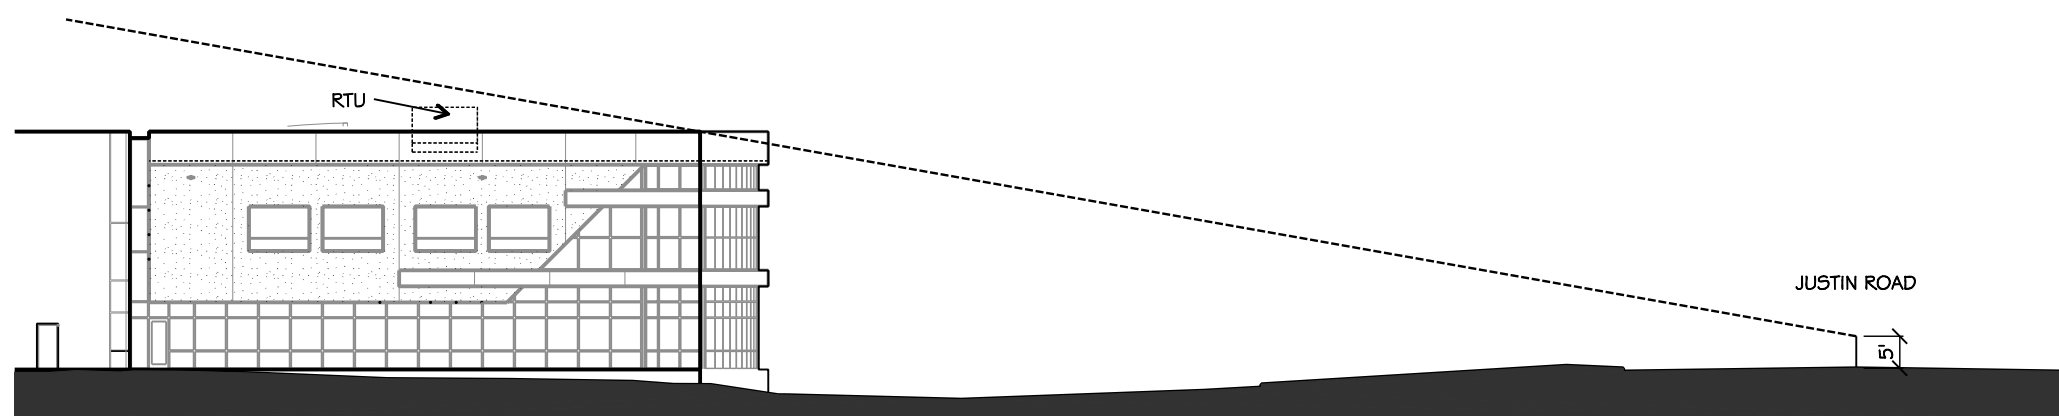
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| 1 | 03/20/2020 | AMENDED SITE PLAN SUBMITTAL |
| 2 | | |
| 3 | | |
| 4 | | |
| 5 | | |

drawn by:
BOBBY PROSS
checked by:
BOBBY PROSS
date:
09/08/19

job no
1854
sheet
A1.1



| PAINT SCHEDULE | | | | | | |
|---|-------------|------|-------------|------|-------------|------|
| A BASE PAINT COLOR - SW9085 TOUCH OF SAND | | | | | | |
| FACADE MATERIAL CALCULATIONS | | | | | | |
| | SOUTH | % | EAST | % | WEST | % |
| 1. CURTAIN WALL | 3,534.3 FT² | 75.6 | 1,642.3 FT² | 50.3 | 1,642.3 FT² | 50.3 |
| 2. ALUMINUM COMPOSITE METAL PANELS | 460.7 FT² | 10.3 | 223.3 FT² | 6.1 | 223.3 FT² | 6.1 |
| 3. EIFS | 661.3 FT² | 14.1 | 1,596.4 FT² | 43.6 | 1,596.4 FT² | 43.6 |
| 4. TOTAL FACADE AREA | 4,676.3 FT² | 100 | 3,664 FT² | 100 | 3,664 FT² | 100 |

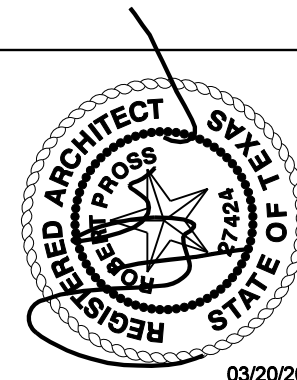

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DATE
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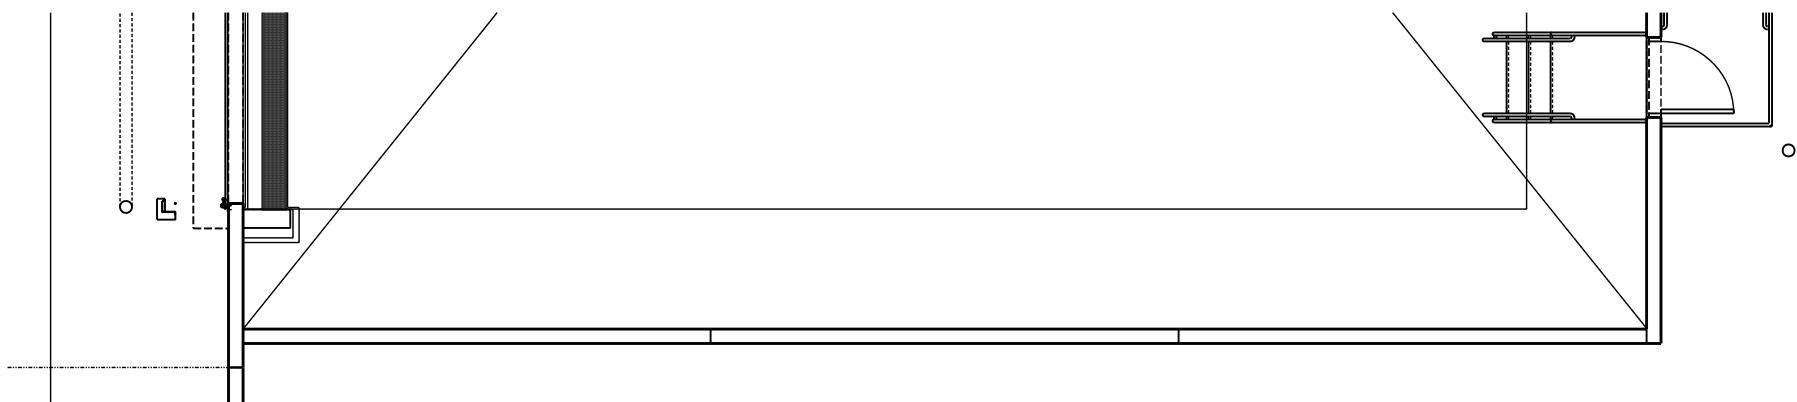
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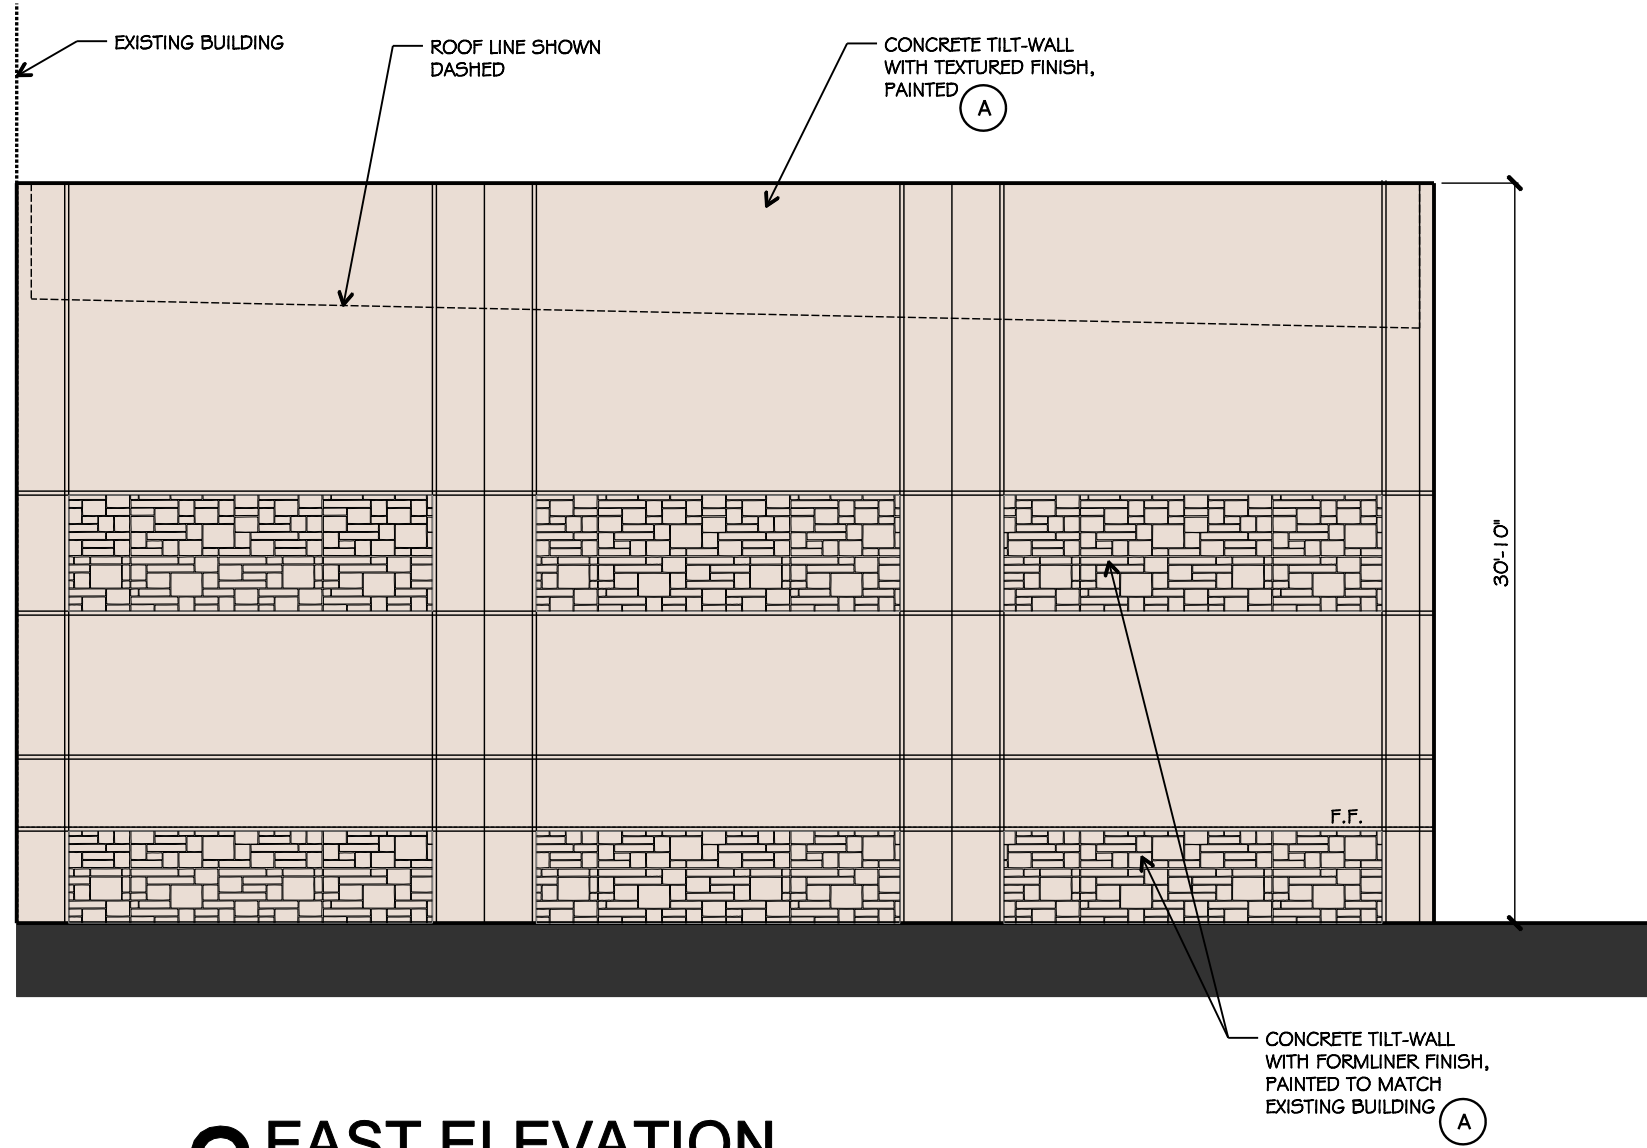
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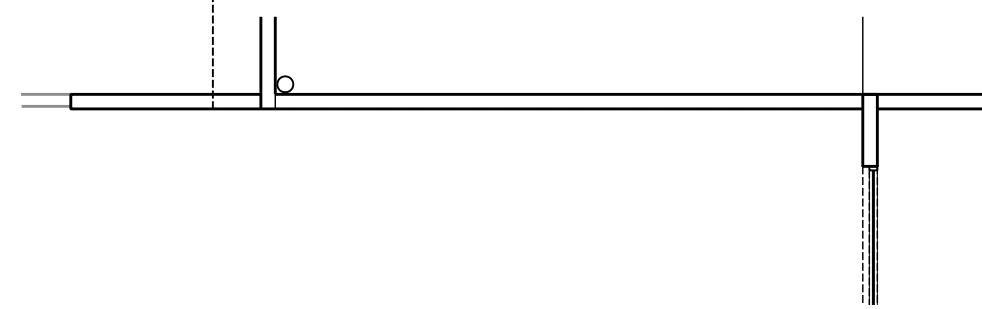
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1854
sheet
A3.0




REFERENCE PLAN



3 EAST ELEVATION
SCALE: 1/8"=1'-0"





REFERENCE PLAN

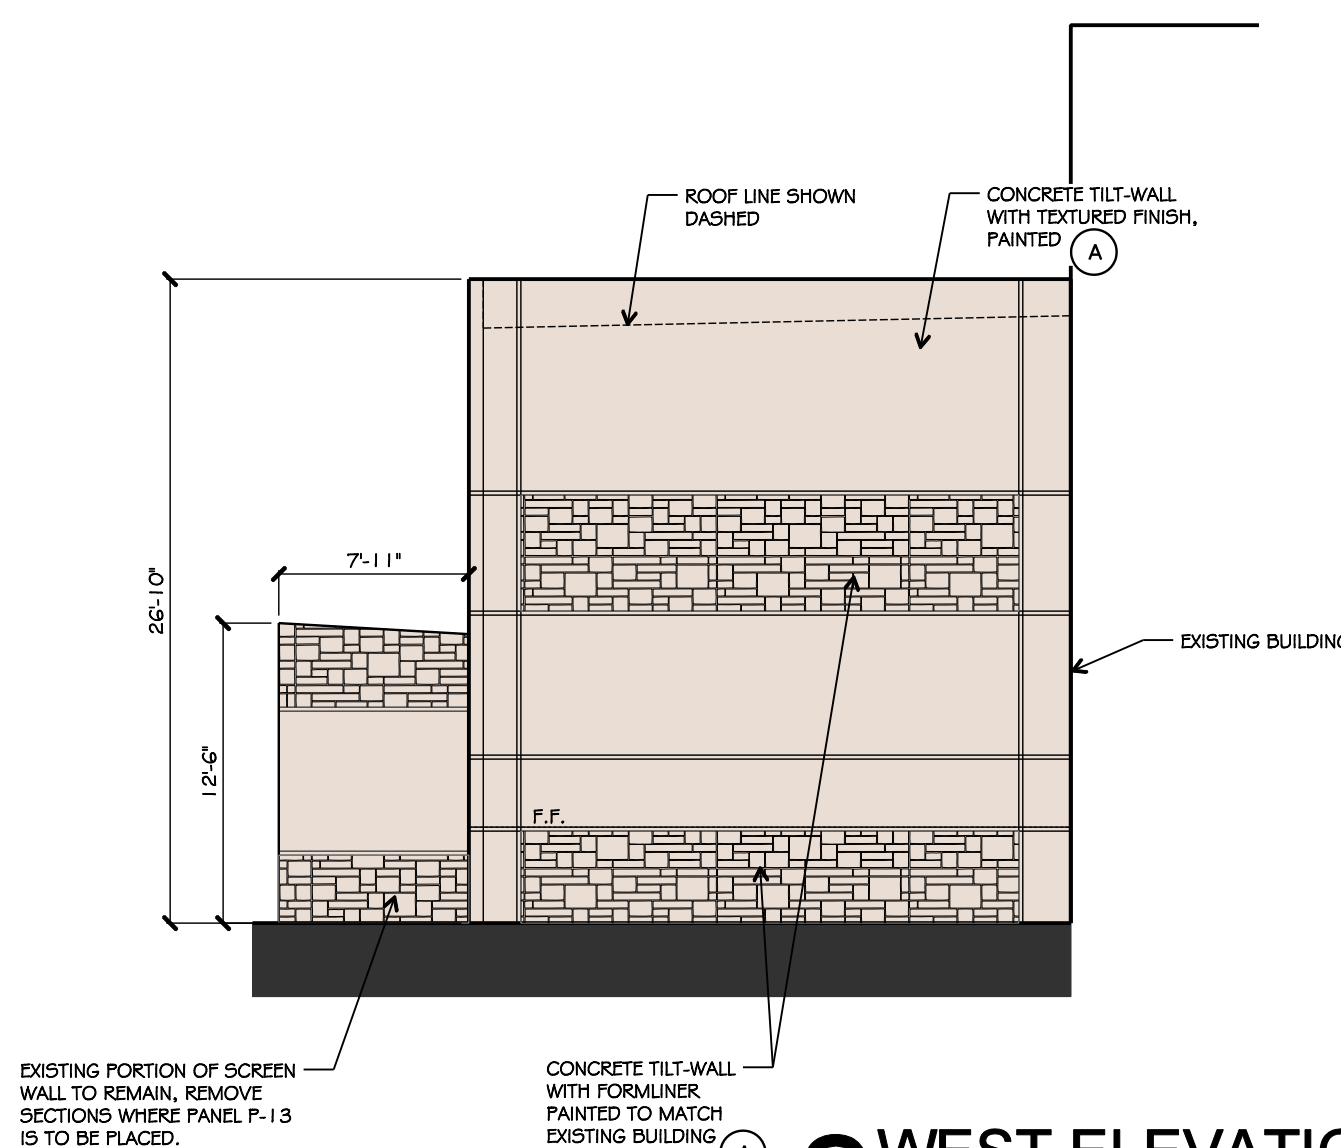

2 WEST ELEVATION
SCALE: 1/8"=1'-0"

| PAINT SCHEDULE | | | | | | |
|--------------------------------------|---|------|---------|------|-----------|------|
| A | BASE PAINT COLOR - SW9085 TOUCH OF SAND | | | | | |
| FACADE MATERIAL CALCULATIONS | | | | | | |
| | SOUTH | % | EAST | % | WEST | % |
| 1. PAINTED CONCRETE TILT-WALL | 2,442 FT² | 75.1 | 541 FT² | 70.2 | 1,421 FT² | 78.1 |
| 2. CONCRETE TILT-WALL WITH FORMLINER | 812 FT² | 24.9 | 229 FT² | 29.8 | 400 FT² | 21.9 |
| 3. TOTAL FACADE AREA | 3,254 FT² | 100 | 770 FT² | 100 | 1,821 FT² | 100 |

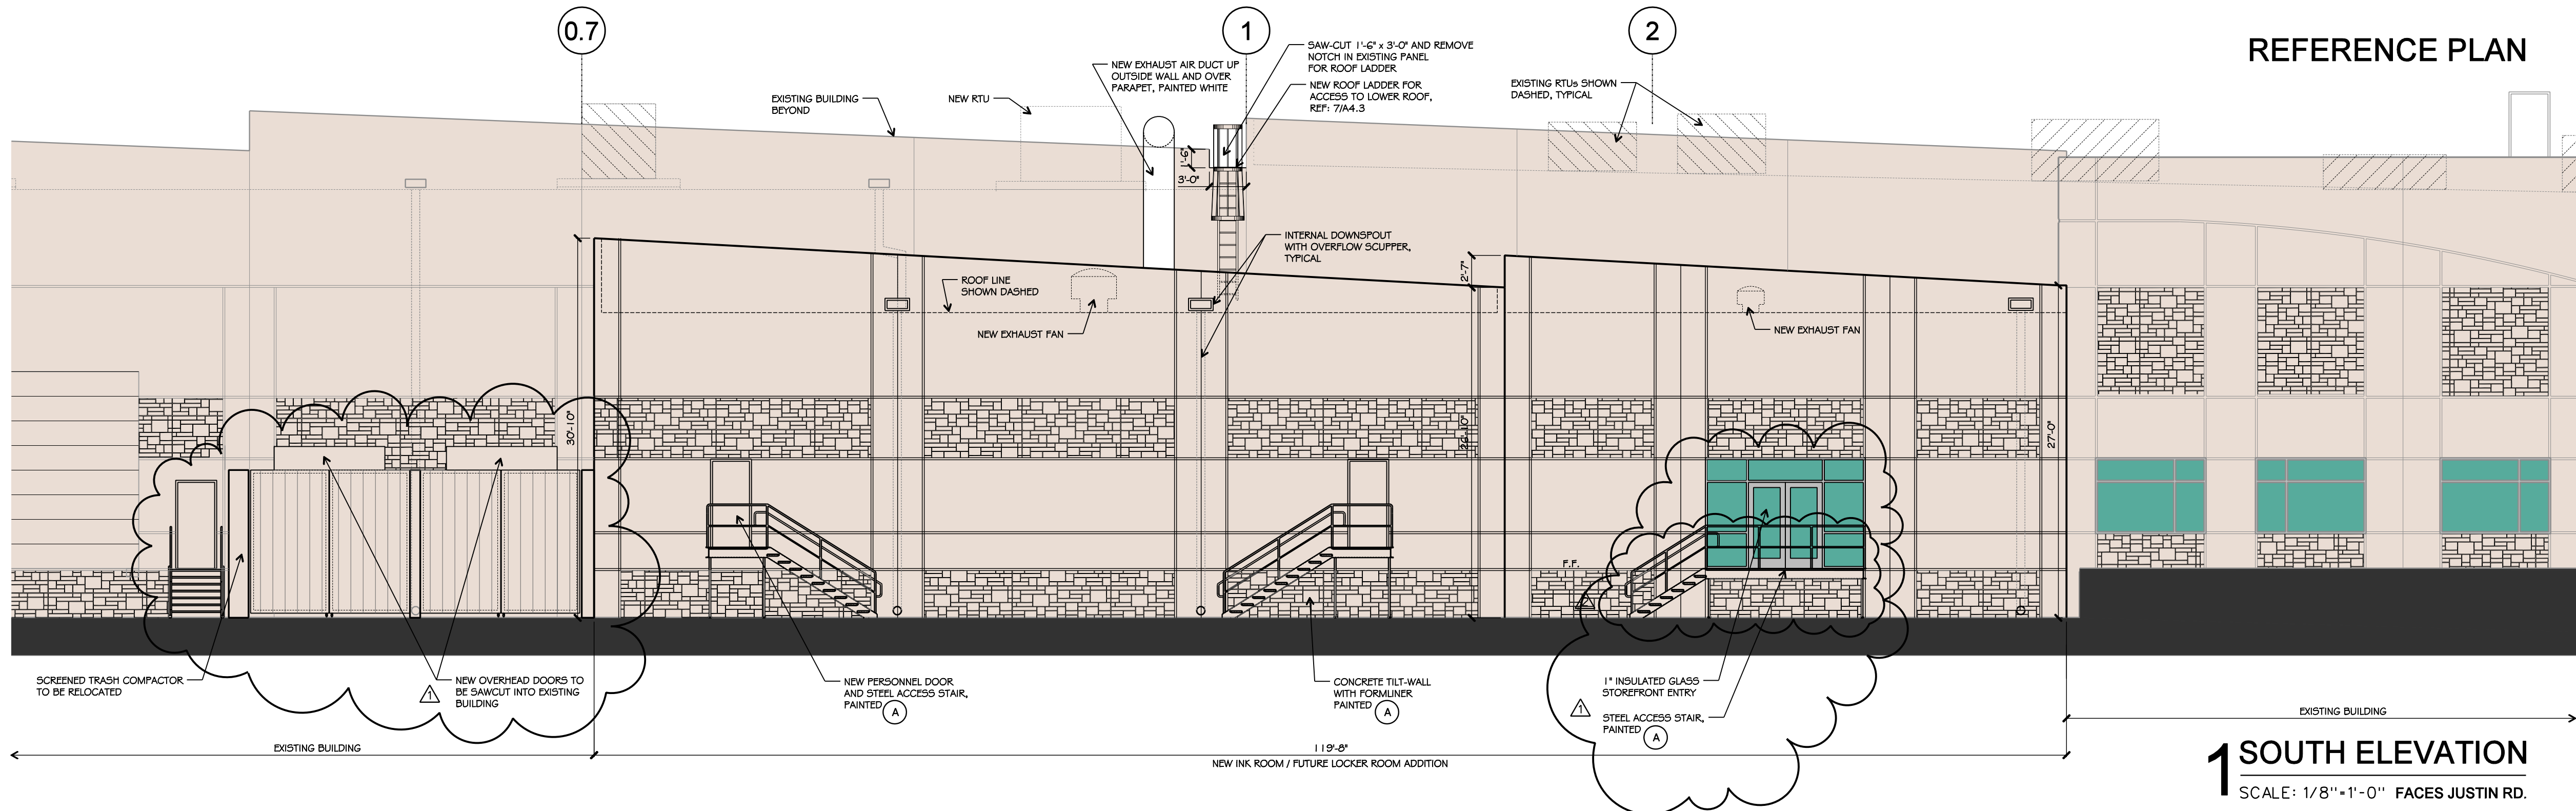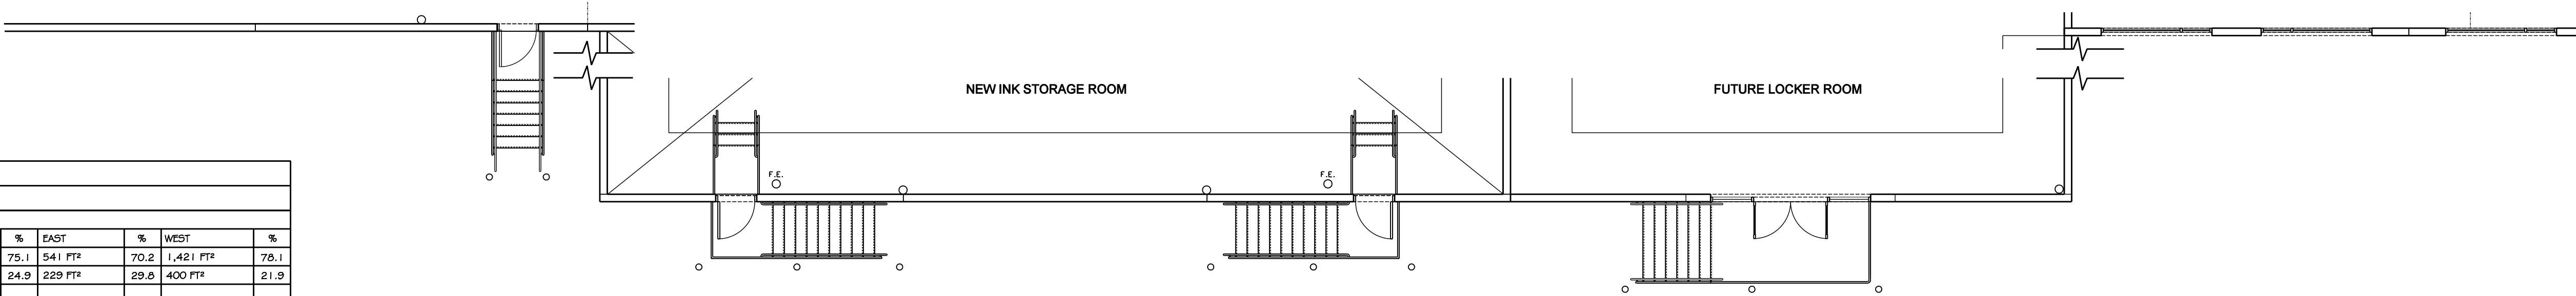

1 SOUTH ELEVATION
SCALE: 1/8"=1'-0" FACES JUSTIN RD.

OWNER:
ALVAPLAST US, INC. / SPR PACKAGING
CONTACT: CAROLINA MOLINA
1480 JUSTIN ROAD
ROCKWALL, TX 75087
469-402-1232

ARCHITECT:
PROSS DESIGN GROUP, INC.
CONTACT: BOBBY PROSS
5310 HARVEST HILL RD., SUITE 180
DALLAS, TX 75230
972-759-1400

CASE NO: SP2019-030

drawn by:
BOBBY PROSS
checked by:
ROBERT PROSS
date:
09/08/19


| # | DATE | DESCRIPTION |
|---|------------|-----------------------------|
| 1 | 03/20/2020 | AMENDED SITE PLAN SUBMITTAL |



pross design group, incorporated
5310 HARVEST HILL ROAD, SUITE 180, DALLAS, TEXAS 75230
972-759-1400

SPR PACKAGING
OFFICE ADDITION
1480 JUSTIN RD., ROCKWALL, TEXAS

job no
1854
sheet
A3.1

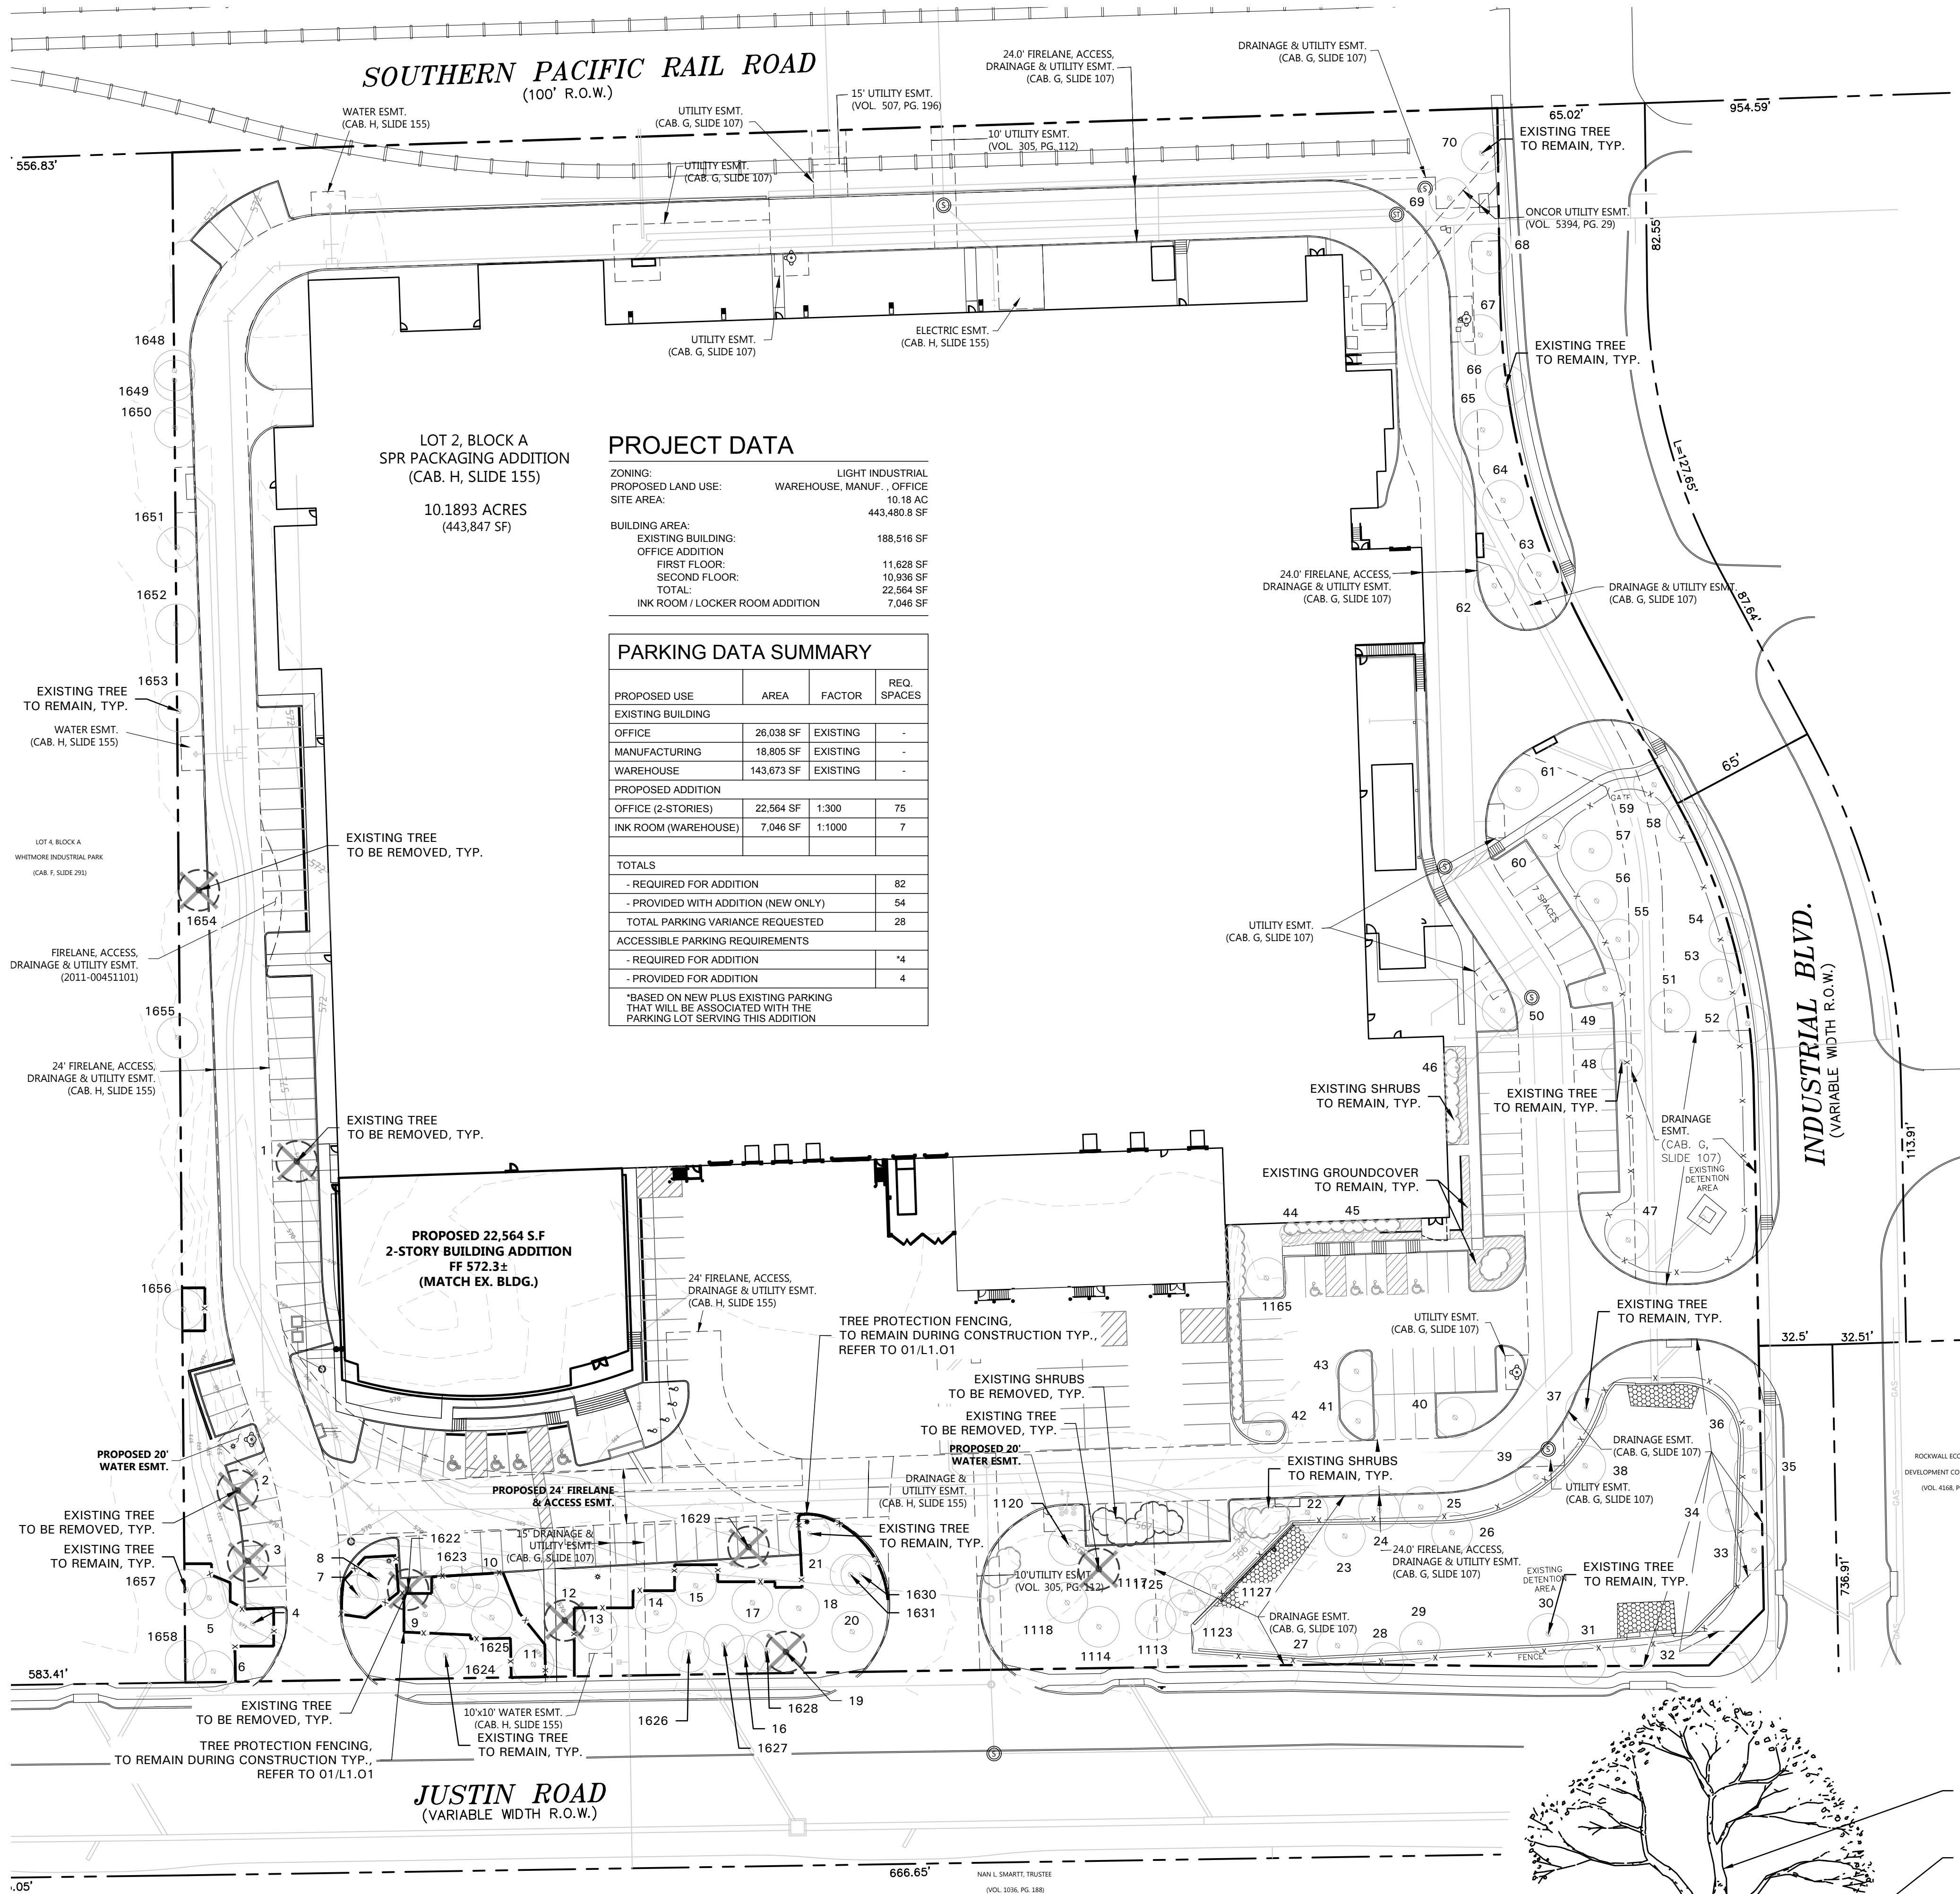

| PROJECT DATA | | | |
|---------------------------------|---------------------------|--|--|
| ZONING: | LIGHT INDUSTRIAL | | |
| PROPOSED LAND USE: | WAREHOUSE, MANUF., OFFICE | | |
| SITE AREA: | 10.18 AC | | |
| BUILDING AREA: | 443,480.8 SF | | |
| EXISTING BUILDING: | 188,516 SF | | |
| OFFICE ADDITION | 11,628 SF | | |
| FIRST FLOOR: | 10,936 SF | | |
| SECOND FLOOR: | 22,564 SF | | |
| TOTAL: | 7,046 SF | | |
| INK ROOM / LOCKER ROOM ADDITION | | | |

| PARKING DATA SUMMARY | | | |
|--|------------|----------|-------------|
| PROPOSED USE | AREA | FACTOR | REQ. SPACES |
| EXISTING BUILDING | | | |
| OFFICE | 26,038 SF | EXISTING | - |
| MANUFACTURING | 18,805 SF | EXISTING | - |
| WAREHOUSE | 143,673 SF | EXISTING | - |
| PROPOSED ADDITION | | | |
| OFFICE (2-STORIES) | 22,564 SF | 1:300 | 75 |
| INK ROOM (WAREHOUSE) | 7,046 SF | 1:1000 | 7 |
| TOTALS | | | |
| - REQUIRED FOR ADDITION | | | 82 |
| - PROVIDED WITH ADDITION (NEW ONLY) | | | 54 |
| TOTAL PARKING VARIANCE REQUESTED | | | 28 |
| ACCESSIBLE PARKING REQUIREMENTS | | | |
| - REQUIRED FOR ADDITION | | | *4 |
| - PROVIDED FOR ADDITION | | | 4 |
| *BASED ON NEW PLUS EXISTING PARKING THAT WILL BE ASSOCIATED WITH THE PARKING LOT SERVING THIS ADDITION | | | |


| TREE SURVEY FIELD DATA | | | | |
|------------------------|--------------|-----------------------|---------------|---------------|
| No. | Di. (Inches) | Species (common name) | Status | Remarks |
| 1 | 5 | CEDAR ELM | TO BE REMOVED | PROTECTED |
| 2 | 3 | LACEBARK ELM | TO BE REMOVED | NOT PROTECTED |
| 3 | 7 | LACEBARK ELM | TO BE REMOVED | PROTECTED |
| 4 | 5.5 | LACEBARK ELM | TO REMAIN | |
| 5 | 3.5 | LACEBARK ELM | TO REMAIN | |
| 6 | 6 | LACEBARK ELM | TO REMAIN | |
| 7 | 4 | CEDAR | TO REMAIN | |
| 8 | 4 | CEDAR | TO REMAIN | |
| 9 | 6 | LACEBARK ELM | TO REMAIN | |
| 10 | 6 | CEDAR | TO REMAIN | |
| 11 | 7 | CEDAR ELM | TO REMAIN | |
| 12 | 4 | CEDAR | TO BE REMOVED | NOT PROTECTED |
| 13 | 6 | CEDAR ELM | TO REMAIN | |
| 14 | 6 | CEDAR ELM | TO REMAIN | |
| 15 | 5.5 | CEDAR ELM | TO REMAIN | |
| 16 | 5 | CEDAR | TO REMAIN | |
| 17 | 7 | CEDAR ELM | TO REMAIN | |
| 18 | 5.5 | BALD CYPRESS | TO REMAIN | |
| 19 | 6 | BALD CYPRESS | TO BE REMOVED | DEAD |
| 20 | 5 | BALD CYPRESS | TO REMAIN | |
| 21 | 5 | CEDAR ELM | TO REMAIN | |
| 22 | 8 | BALD CYPRESS | TO REMAIN | |
| 23 | 5 | BALD CYPRESS | TO REMAIN | |
| 24 | 8 | BALD CYPRESS | TO REMAIN | |
| 25 | 6 | BALD CYPRESS | TO REMAIN | |
| 26 | 3 | BALD CYPRESS | TO REMAIN | |
| 27 | 3 | BALD CYPRESS | TO REMAIN | |
| 28 | 5 | BALD CYPRESS | TO REMAIN | |
| 29 | 5 | BALD CYPRESS | TO REMAIN | |
| 30 | 6 | BALD CYPRESS | TO REMAIN | |
| 31 | 6 | BALD CYPRESS | TO REMAIN | |
| 32 | 4 | BALD CYPRESS | TO REMAIN | |
| 33 | 9 | BALD CYPRESS | TO REMAIN | |
| 34 | 8 | BALD CYPRESS | TO REMAIN | |
| 35 | 7 | BALD CYPRESS | TO REMAIN | |
| 36 | 5 | BALD CYPRESS | TO REMAIN | |
| 37 | 6 | BALD CYPRESS | TO REMAIN | |
| 38 | 3 | BALD CYPRESS | TO REMAIN | |
| 39 | 4 | BALD CYPRESS | TO REMAIN | |
| 40 | 12 | LACEBARK ELM | TO REMAIN | |
| 41 | 12 | LACEBARK ELM | TO REMAIN | |
| 42 | 11 | LACEBARK ELM | TO REMAIN | |
| 43 | 11 | LACEBARK ELM | TO REMAIN | |
| 44 | 10 | CREPE MYRTLE | TO REMAIN | |
| 45 | 11 | CREPE MYRTLE | TO REMAIN | |
| 46 | 6 | CREPE MYRTLE | TO REMAIN | |
| 47 | 6 | BALD CYPRESS | TO REMAIN | |
| 48 | 8 | BALD CYPRESS | TO REMAIN | |
| 49 | 7 | BALD CYPRESS | TO REMAIN | |
| 50 | 4 | LACEBARK ELM | TO REMAIN | |
| 51 | 6 | BALD CYPRESS | TO REMAIN | |
| 52 | 6 | BALD CYPRESS | TO REMAIN | |
| 53 | 3 | BALD CYPRESS | TO REMAIN | |
| 54 | 5 | BALD CYPRESS | TO REMAIN | |
| 55 | 5 | BALD CYPRESS | TO REMAIN | |
| 56 | 5 | BALD CYPRESS | TO REMAIN | |
| 57 | 3 | BALD CYPRESS | TO REMAIN | |
| 58 | 6 | BALD CYPRESS | TO REMAIN | |
| 59 | 7 | BALD CYPRESS | TO REMAIN | |
| 60 | 8 | BALD CYPRESS | TO REMAIN | |
| 61 | 7 | BALD CYPRESS | TO REMAIN | |
| 62 | 4 | LIVE OAK | TO REMAIN | |
| 63 | 4 | LIVE OAK | TO REMAIN | |
| 64 | 5 | LIVE OAK | TO REMAIN | |
| 65 | 9 | BALD CYPRESS | TO REMAIN | |
| 66 | 10 | BALD CYPRESS | TO REMAIN | |
| 67 | 10 | BALD CYPRESS | TO REMAIN | |
| 68 | 11 | LIVE OAK | TO REMAIN | |
| 69 | 5 | LIVE OAK | TO REMAIN | |
| 70 | 10 | LIVE OAK | TO REMAIN | |
| 1113 | 6 | CYPRESS | TO REMAIN | |
| 1114 | 6 | CYPRESS | TO REMAIN | |
| 1117 | 10 | CEDAR | TO BE REMOVED | DEAD |
| 1118 | 6 | CYPRESS | TO REMAIN | |
| 1120 | 12 | CEDAR | TO REMAIN | |
| 1123 | 8 | CEDAR | TO REMAIN | |
| 1125 | 8 | CEDAR | TO REMAIN | |
| 1127 | 8 | CEDAR | TO REMAIN | |
| 1165 | 8 | LACEBARK ELM | TO REMAIN | |
| 1622 | 6 | CEDAR | TO BE REMOVED | NOT PROTECTED |
| 1623 | 6 | CEDAR | TO REMAIN | |
| 1624 | 6 | CEDAR ELM | TO REMAIN | |
| 1625 | 6 | CEDAR ELM | TO REMAIN | |
| 1626 | 27 | HACKBERRY | TO REMAIN | |
| 1627 | 6 | CEDAR | TO REMAIN | |
| 1628 | 6 | CEDAR | TO REMAIN | |
| 1629 | 10 | HACKBERRY | TO BE REMOVED | NOT PROTECTED |
| 1630 | 12 | HACKBERRY | TO REMAIN | |
| 1631 | 12 | HACKBERRY | TO REMAIN | |
| 1648 | 8 | HACKBERRY | TO REMAIN | |
| 1649 | 10 | HACKBERRY | TO REMAIN | |
| 1650 | 8 | HACKBERRY | TO REMAIN | |
| 1651 | 18 | HACKBERRY | TO REMAIN | |
| 1652 | 15 | HACKBERRY | TO REMAIN | |
| 1653 | 9 | HACKBERRY | TO REMAIN | |
| 1654 | 30 | BOIS D'ARC | TO BE REMOVED | NOT PROTECTED |
| 1655 | 12 | HACKBERRY | TO REMAIN | |
| 1656 | 8 | HACKBERRY | TO REMAIN | |
| 1657 | 8 | HACKBERRY | TO REMAIN | |
| 1658 | 27 | MULBERRY | TO REMAIN | |

| | |
|--|-----|
| Total Caliper Inches on Site | 762 |
| Total Caliper Inches Removed | 81 |
| Total Mitigation Inches Required | 12 |
| Total Mitigation Inches Provided (Refer to Landscape Plan) | 12 |

- ### TREE PRESERVATION NOTES
- EXISTING TREES TO REMAIN SHALL BE PROTECTED DURING CONSTRUCTION FROM TREE STRUCTURE DAMAGE AND COMPACTION OF SOIL UNDER AND AROUND DRIP LINE (CANOPY) OF TREE.
 - IF ANY ROOT STRUCTURE IS DAMAGED DURING ADJACENT EXCAVATION CONSTRUCTION, NOTIFY OWNER'S AUTHORIZED REPRESENTATIVE IMMEDIATELY. IT IS RECOMMENDED THAT A LICENSED ARBORIST BE SECURED FOR THE TREATMENT OF ANY POSSIBLE TREE WOUNDS.
 - NO DISTURBANCE OF THE SOIL GREATER THAN 4" SHALL BE LOCATED CLOSER TO THE TREE TRUNK THAN 1/2 THE DISTANCE OF THE DRIP LINE TO THE TREE TRUNK. A MINIMUM OF 75% OF THE DRIP LINE AND ROOT ZONE SHALL BE PRESERVED AT NATURAL GRADE.
 - ANY FINE GRADING DONE WITHIN THE CRITICAL ROOT ZONES OF THE PROTECTED TREES MUST BE DONE WITH LIGHT MACHINERY SUCH AS A BOBCAT OR LIGHT TRACTOR. NO EARTH MOVING EQUIPMENT WITH TRACKS IS ALLOWED WITHIN THE CRITICAL ROOT ZONE OF THE TREES.
 - NO MATERIALS INTENDED FOR USE IN CONSTRUCTION OR WASTE MATERIALS ACCUMULATED DUE TO EXCAVATION OR DEMOLITION SHALL BE PLACED WITHIN THE LIMITS OF THE DRIP LINE OF ANY TREE.
 - NO EQUIPMENT MAY BE CLEANED OR TOXIC SOLUTIONS, OR OTHER LIQUID CHEMICALS, SHALL BE DEPOSITED WITHIN THE LIMITS OF THE DRIP LINE OF A TREE, INCLUDING BUT NOT LIMITED TO: PAINT, OIL, SOLVENTS, ASPHALT, CONCRETE, MORTAR, PRIMERS, ETC.
 - NO SIGNS, WIRES OR OTHER ATTACHMENTS, OTHER THAN THOSE OF A PROTECTIVE NATURE, SHALL BE ATTACHED TO ANY TREE.
 - NO VEHICULAR / CONSTRUCTION EQUIPMENT TRAFFIC OR PARKING IS ALLOWED WITHIN THE LIMITS OF THE DRIP LINE OF TREES.
 - BORING OF UTILITIES MAY BE PERMITTED UNDER PROTECTED TREES IN CERTAIN CIRCUMSTANCES. THE MINIMUM LENGTH OF THE BORE SHALL BE THE WIDTH OF THE TREE'S CANOPY AND SHALL BE A MINIMUM DEPTH OF FORTY-EIGHT (48") INCHES.
 - IRRIGATION TRENCHING WHICH MUST BE DONE WITHIN THE CRITICAL ROOT ZONE OF A TREE SHALL BE DUG BY HAND AND ENTER THE AREA IN A RADIAL MANNER.
 - ALL TREES TO BE REMOVED FROM THE SITE SHALL BE FLAGGED BY THE CONTRACTOR WITH BRIGHT RED VINYL TAPE (3" WIDTH) WRAPPED AROUND THE MAIN TRUNK AT A HEIGHT OF FOUR (4') FEET ABOVE GRADE. FLAGGING SHALL BE APPROVED BY OWNER'S AUTHORIZED REPRESENTATIVE PRIOR TO ANY TREE REMOVAL. CONTRACTOR SHALL CONTACT OWNER'S AUTHORIZED REPRESENTATIVE WITH 72 HOURS NOTICE TO SCHEDULE ON-SITE MEETING.
 - ALL TREES TO REMAIN, AS NOTED ON DRAWINGS, SHALL HAVE PROTECTIVE FENCING LOCATED AT THE TREE'S DRIP LINE. THE PROTECTIVE FENCING MAY BE COMPOSED OF SNOW FENCING, ORANGE VINYL CONSTRUCTION FENCING, CHAIN LINK FENCE OR OTHER SIMILAR FENCING WITH A FOUR (4') FOOT APPROXIMATE HEIGHT. THE PROTECTIVE FENCING SHALL BE LOCATED AS INDICATED ON THE TREE PROTECTION DETAIL.
 - WHEN A LOW HANGING LIMB IS BROKEN DURING THE COURSE OF CONSTRUCTION, THE CONTRACTOR SHALL NOTIFY THE OWNER'S AUTHORIZED REPRESENTATIVE IMMEDIATELY. UNDER NO CIRCUMSTANCE SHALL THE CONTRACTOR PRUNE ANY PORTION OF THE DAMAGED TREE WITHOUT THE PRIOR APPROVAL BY THE OWNER'S AUTHORIZED REPRESENTATIVE.

EXISTING TREE LEGEND

- EXISTING TREE TO REMAIN
- EXISTING TREE TO BE REMOVED
- TREE PROTECTION FENCING TO REMAIN DURING CONSTRUCTION REFER TO 01/L1.01
- EXISTING SHRUBS TO REMAIN

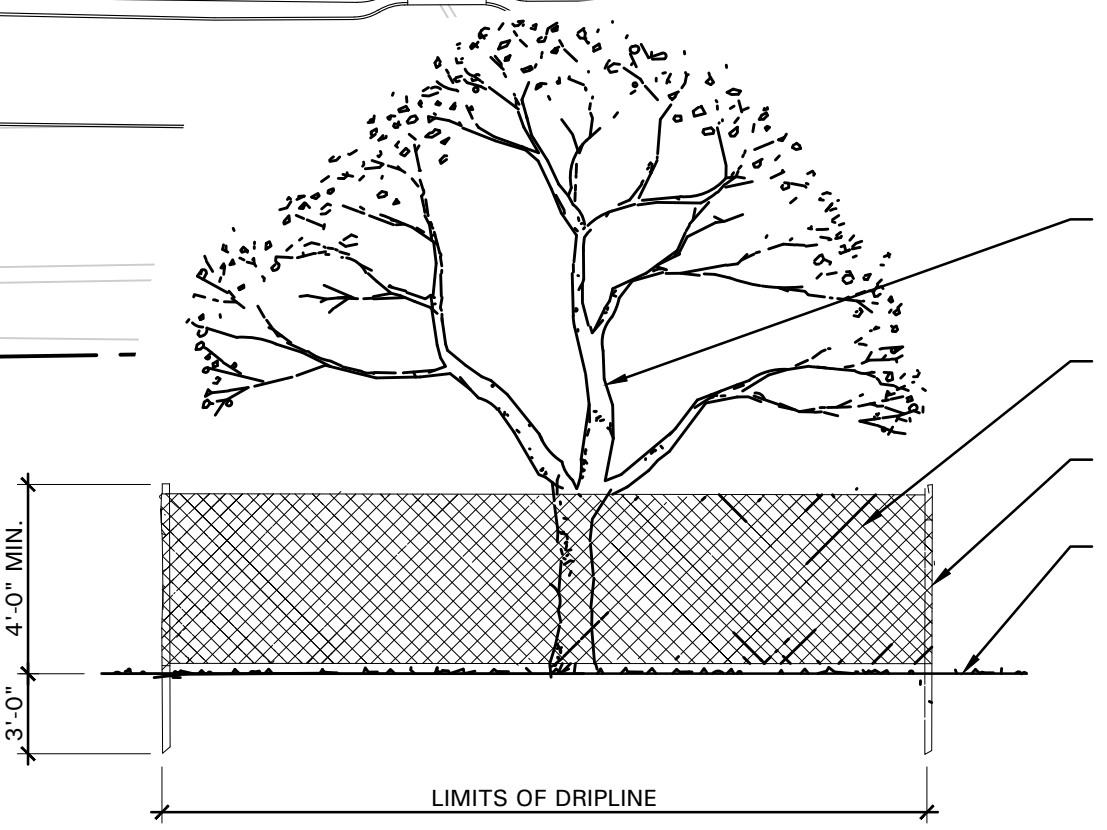

REFER TO PLAN FOR EXISTING TREE TO REMAIN

SNOW FENCE, ORANGE VINYL CONSTRUCTION FENCE, OR CHAINLINK FENCE

METAL T-POST PLACED NO FURTHER THAN 15' APART

EXISTING GRADE TO REMAIN UNDISTURBED

OWNER: ALVAPLAST US, INC. / SPR PACKAGING
CONTACT: CAROLINA MOLINA
1480 JUSTIN ROAD
ROCKWALL, TX 75087
469-402-1232

ARCHITECT: PROSS DESIGN GROUP, INC.
CONTACT: BOBBY PROSS
5310 HARVEST HILL RD., SUITE 180
DALLAS, TX 75230
972-759-1400

TREE PRESERVATION PLAN

4245 North Central Expy
Suite 501
Dallas, Texas 75205
214.865.7192 office


Drawn: NAY
Checked: KATE
Date: 08/14/19

| # | DATE | DESCRIPTION |
|---|------|-------------|
| | | |
| | | |
| | | |
| | | |

pross design group, incorporated
5310 Harvest Hill Road, Suite 180, Dallas, Texas 75230, 972-759-1400

SPR PACKAGING
OFFICE ADDITION
1480 JUSTIN RD., ROCKWALL, TEXAS

job no 1854
sheet
L1.01

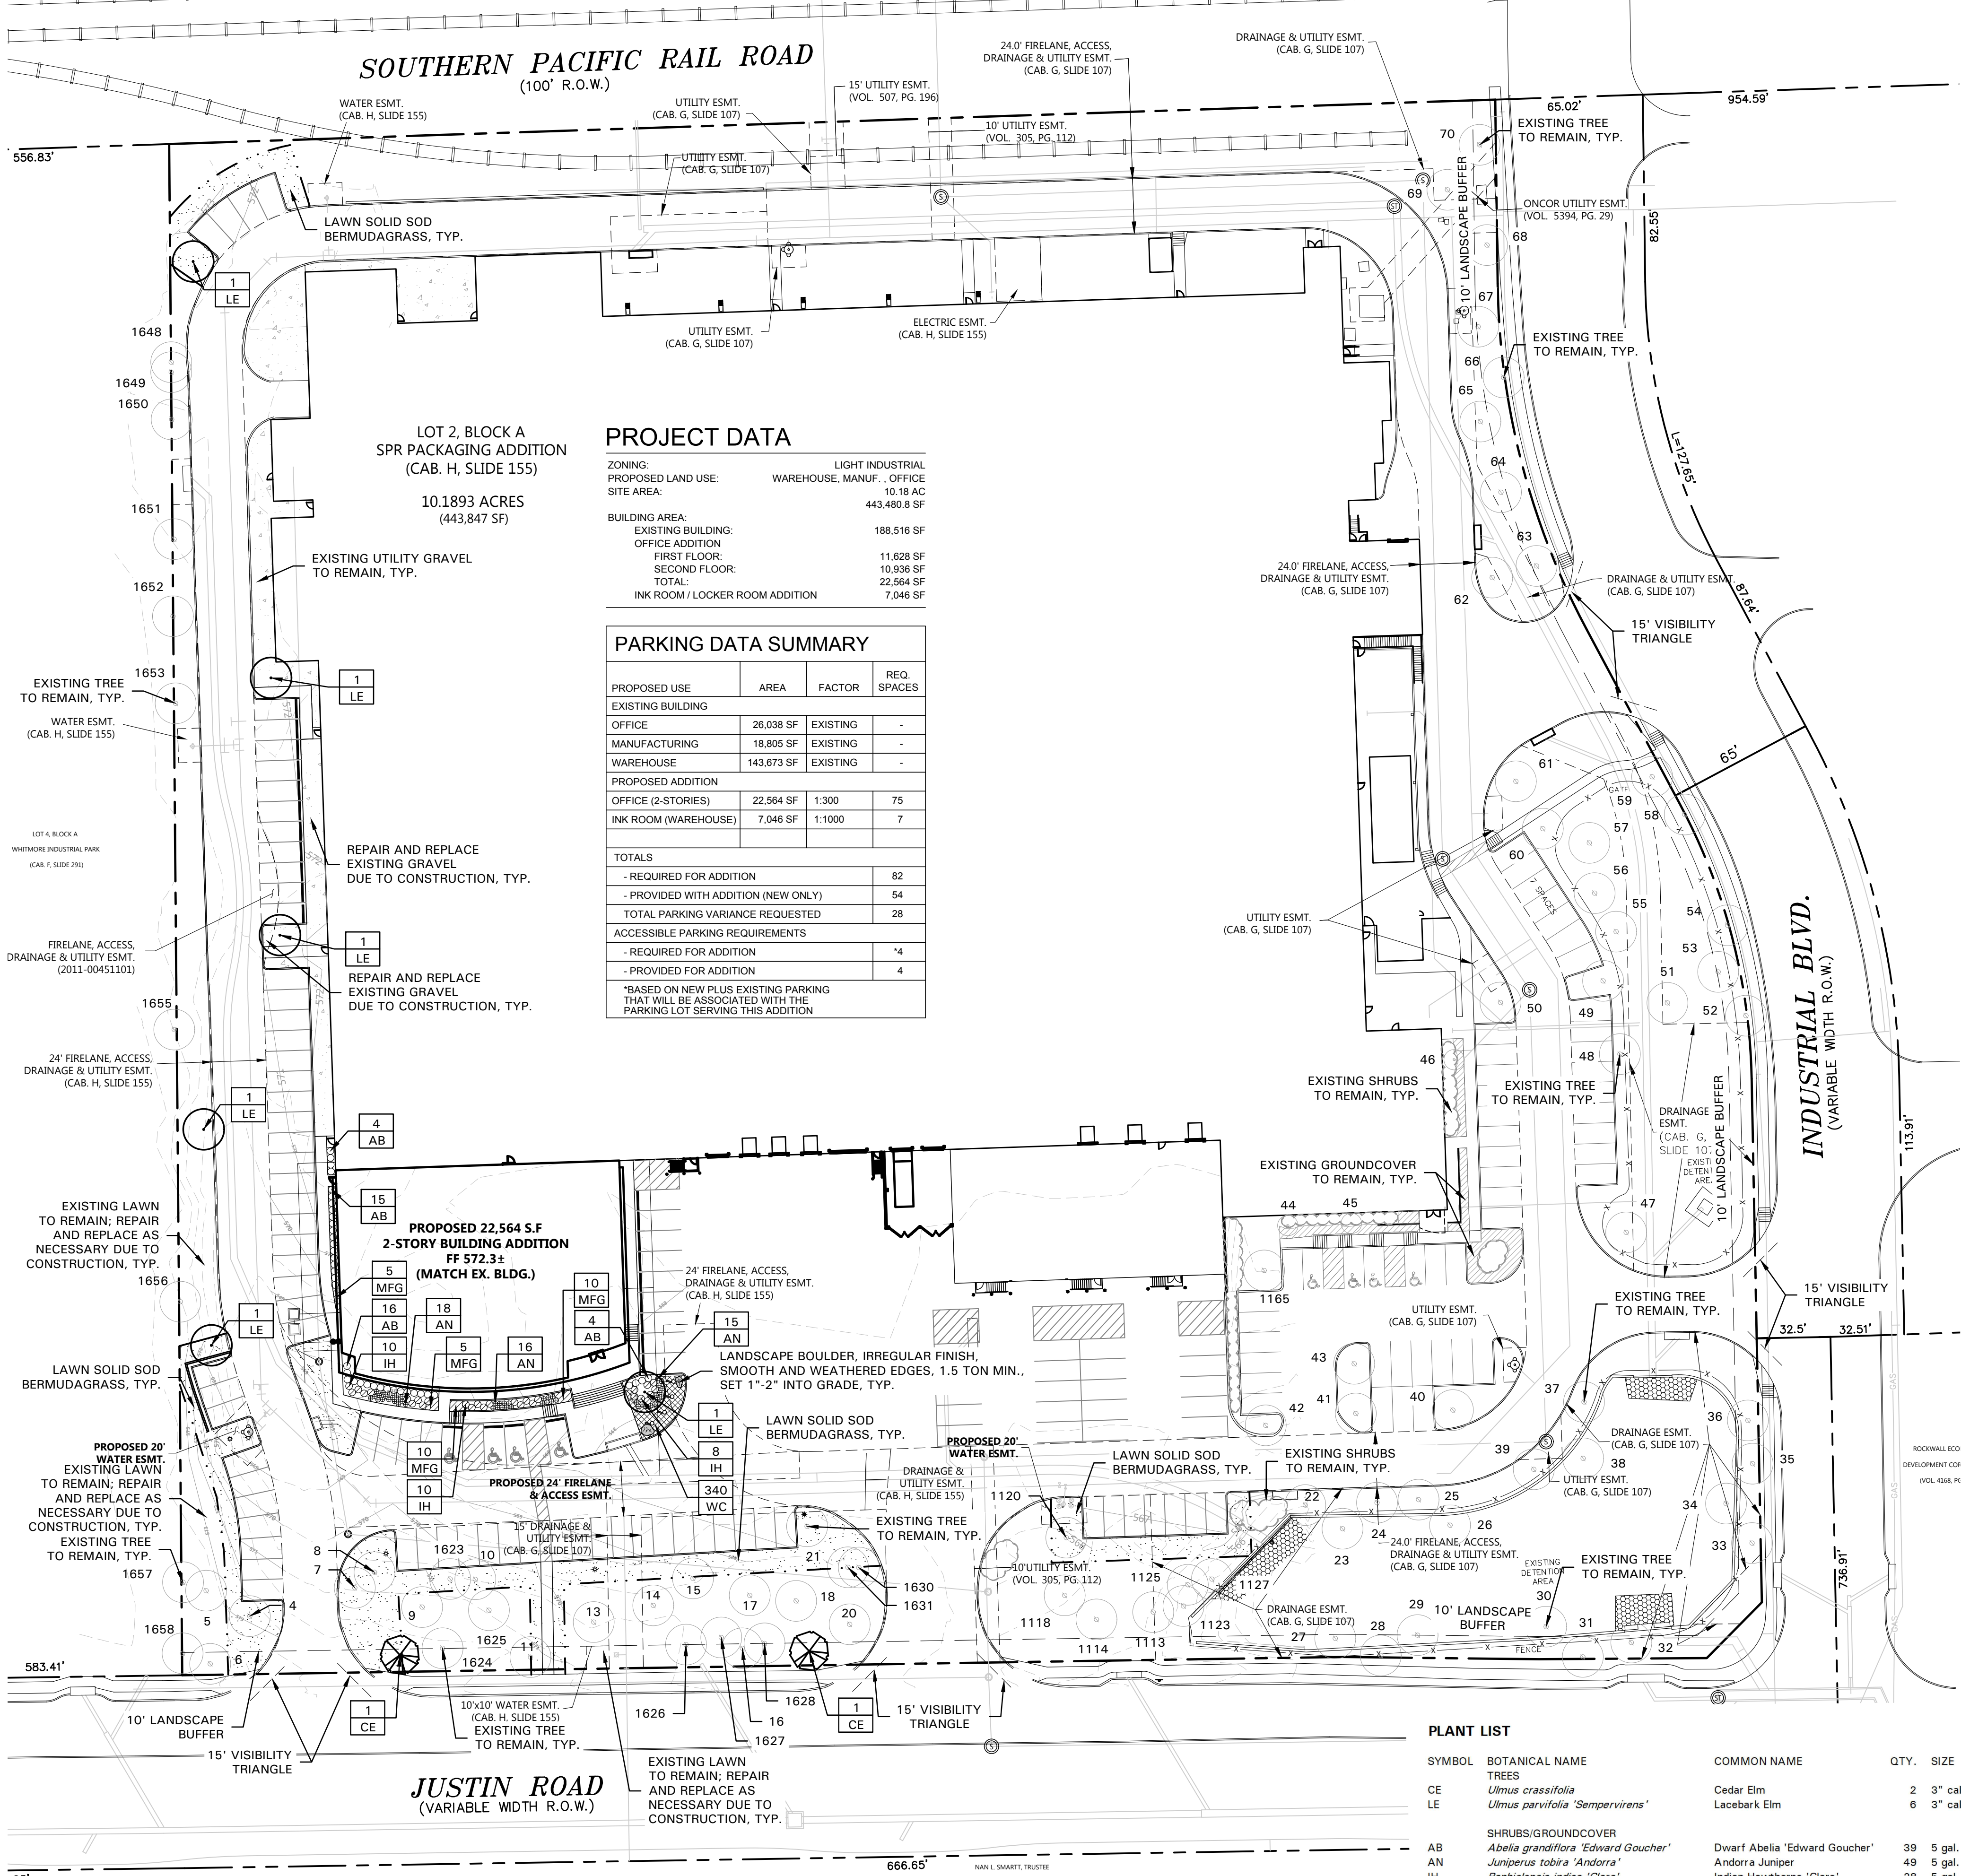

| PROJECT DATA | | | |
|---------------------------------|---------------------------|--|--|
| ZONING: | LIGHT INDUSTRIAL | | |
| PROPOSED LAND USE: | WAREHOUSE, MANUF., OFFICE | | |
| SITE AREA: | 10.18 AC | | |
| BUILDING AREA: | 443,480.8 SF | | |
| EXISTING BUILDING: | 188,516 SF | | |
| OFFICE ADDITION | 11,628 SF | | |
| FIRST FLOOR: | 10,936 SF | | |
| SECOND FLOOR: | 7,046 SF | | |
| TOTAL: | 22,564 SF | | |
| INK ROOM / LOCKER ROOM ADDITION | 7,046 SF | | |

| PARKING DATA SUMMARY | | | |
|-------------------------------------|------------|----------|-------------|
| PROPOSED USE | AREA | FACTOR | REQ. SPACES |
| EXISTING BUILDING | | | |
| OFFICE | 26,038 SF | EXISTING | - |
| MANUFACTURING | 18,805 SF | EXISTING | - |
| WAREHOUSE | 143,673 SF | EXISTING | - |
| PROPOSED ADDITION | | | |
| OFFICE (2-STORIES) | 22,564 SF | 1:300 | 75 |
| INK ROOM (WAREHOUSE) | 7,046 SF | 1:1000 | 7 |
| TOTALS | | | |
| - REQUIRED FOR ADDITION | | | 82 |
| - PROVIDED WITH ADDITION (NEW ONLY) | | | 54 |
| TOTAL PARKING VARIANCE REQUESTED | | | 28 |
| ACCESSIBLE PARKING REQUIREMENTS | | | |
| - REQUIRED FOR ADDITION | | | *4 |
| - PROVIDED FOR ADDITION | | | 4 |

*BASED ON NEW PLUS EXISTING PARKING THAT WILL BE ASSOCIATED WITH THE PARKING LOT SERVING THIS ADDITION

PLANT LIST

| SYMBOL | BOTANICAL NAME | COMMON NAME | QTY. | SIZE | REMARKS |
|---------------------|--|-------------------------------|------|---------|---|
| CE | <i>Ulmus crassifolia</i> | Cedar Elm | 2 | 3" cal. | container grown, 12' ht., 4' spread, 4' branching ht., matching |
| LE | <i>Ulmus parvifolia</i> 'Sempervirens' | Lacebark Elm | 6 | 3" cal. | container grown, 12' ht., 4' spread, 4' branching ht., matching |
| SHRUBS/GROUND COVER | | | | | |
| AB | <i>Abelia grandiflora</i> 'Edward Goucher' | Dwarf Abelia 'Edward Goucher' | 39 | 5 gal. | container full, 24" spread, 36" o.c. |
| AN | <i>Juniperus tobira</i> 'Andorra' | Andorra Juniper | 49 | 5 gal. | container full, 20" spread, 24" o.c. |
| IH | <i>Rachicallis indica</i> 'Clara' | Indian Hawthorne 'Clara' | 28 | 5 gal. | container full, 20" spread, 36" o.c. |
| MFG | <i>Nassella tenuissima</i> | Mexican Feathergrass | 30 | 1 gal. | container full, 24" o.c. |
| WC | <i>Euonymus fortunei</i> 'Coloratus' | Wintercreeper | 340 | 4" pots | container (3) 12" runners min., 12" o.c. |
| | <i>Cynodon dactylon</i> | Common Bermudagrass | | | solid sod, refer to Solid Sod Notes |

NOTE: ALL TREES SHALL HAVE STRAIGHT TRUNKS AND BE MATCHING WITHIN VARIETIES.
PLANT LIST IS AN AID TO BIDDERS ONLY. CONTRACTOR SHALL VERIFY ALL QUANTITIES ON PLAN.
ALL HEIGHTS AND SPREADS ARE MINIMUMS. ALL PLANT MATERIAL SHALL MEET OR EXCEED REMARKS AS INDICATED.

LANDSCAPE NOTES

- CONTRACTOR SHALL VERIFY ALL EXISTING AND PROPOSED SITE ELEMENTS AND NOTIFY LANDSCAPE ARCHITECT OF ANY DISCREPANCIES. SURVEY DATA OF EXISTING CONDITIONS WAS SUPPLIED BY OTHERS.
- CONTRACTOR SHALL LOCATE ALL EXISTING UNDERGROUND UTILITIES AND NOTIFY LANDSCAPE ARCHITECT OF ANY CONFLICTS. CONTRACTOR SHALL EXERCISE CAUTION WHEN WORKING IN THE VICINITY OF UNDERGROUND UTILITIES.
- CONTRACTOR SHALL PROVIDE A MINIMUM 2% SLOPE AWAY FROM ALL STRUCTURES.
- CONTRACTOR SHALL FINE GRADE AREAS TO ACHIEVE FINAL CONTOURS AS INDICATED. LEAVE AREAS TO RECEIVE TOPSOIL 3" BELOW FINAL FINISHED GRADE IN PLANTING AREAS AND 1" BELOW FINAL FINISHED GRADE IN LAWN AREAS.
- ALL PLANTING BEDS AND LAWN AREAS SHALL BE SEPARATED BY STEEL EDGING. NO STEEL EDGING SHALL BE INSTALLED ADJACENT TO BUILDINGS, WALKS, OR CURBS. CUT STEEL EDGING AT 45 DEGREE ANGLE WHERE IT INTERSECTS WALKS AND CURBS.
- TOP OF MULCH SHALL BE 1/2" MINIMUM BELOW THE TOP OF WALKS AND CURBS.
- ALL LAWN AREAS SHALL BE SOLID SOD BERMUDAGRASS, UNLESS OTHERWISE NOTED ON THE DRAWINGS.
- ALL REQUIRED LANDSCAPE AREAS SHALL BE PROVIDED WITH AN AUTOMATIC UNDERGROUND IRRIGATION SYSTEM WITH RAIN AND FREEZE SENSORS AND EVAPOTRANSPIRATION (ET) WEATHER-BASED CONTROLLERS AND SAID IRRIGATION SYSTEM SHALL BE DESIGNED BY A QUALIFIED PROFESSIONAL AND INSTALLED BY A LICENSED IRRIGATOR.
- CONTRACTOR SHALL PROVIDE BID PROPOSAL LISTING UNIT PRICES FOR ALL MATERIAL PROVIDED.
- CONTRACTOR SHALL BE RESPONSIBLE FOR OBTAINING ALL REQUIRED LANDSCAPE AND IRRIGATION PERMITS.

MAINTENANCE NOTES

- THE OWNER, TENANT AND THEIR AGENT, IF ANY, SHALL BE JOINTLY AND SEVERALLY RESPONSIBLE FOR THE MAINTENANCE OF ALL LANDSCAPE.
- ALL LANDSCAPE SHALL BE MAINTAINED IN A NEAT AND ORDERLY MANNER AT ALL TIMES. THIS SHALL INCLUDE MOWING, EDGING, PRUNING, FERTILIZING, WATERING, WEEDING AND OTHER SUCH ACTIVITIES COMMON TO LANDSCAPE MAINTENANCE.
- ALL LANDSCAPE AREAS SHALL BE KEPT FREE OF TRASH, LITTER, WEEDS AND OTHER SUCH MATERIAL OR PLANTS NOT PART OF THIS PLAN.
- ALL PLANT MATERIAL SHALL BE MAINTAINED IN A HEALTHY AND GROWING CONDITION AS IS APPROPRIATE FOR THE SEASON OF THE YEAR.
- ALL PLANT MATERIAL WHICH DIES SHALL BE REPLACED WITH PLANT MATERIAL OF EQUAL OR BETTER VALUE.
- CONTRACTOR SHALL PROVIDE SEPARATE BID PROPOSAL FOR ONE YEAR'S MAINTENANCE TO BEGIN AFTER FINAL ACCEPTANCE.

CITY OF ROCKWALL NOTES

- NO TREES WITHIN 5'-0" OF ANY UTILITIES
- IRRIGATION SYSTEM WILL MEET REQUIREMENTS IN THE UDC

GENERAL LAWN NOTES

- CONTRACTOR SHALL COORDINATE OPERATIONS AND AVAILABILITY OF EXISTING TOPSOIL WITH ON-SITE CONSTRUCTION MANAGER.
- CONTRACTOR SHALL LEAVE LAWN AREAS 1" BELOW FINAL FINISHED GRADE PRIOR TO TOPSOIL INSTALLATION.
- CONTRACTOR SHALL FINE GRADE AREAS TO ACHIEVE FINAL CONTOURS AS INDICATED ON CIVIL PLANS. ADJUST CONTOURS TO ACHIEVE POSITIVE DRAINAGE AWAY FROM BUILDINGS. PROVIDE UNIFORM ROUNDING AT TOP AND BOTTOM OF SLOPES AND OTHER BREAKS IN GRADE. CORRECT IRREGULARITIES AND AREAS WHERE WATER MAY STAND.
- ALL LAWN AREAS SHALL BE FINE GRADED, IRRIGATION TRENCHES COMPLETELY SETTLED AND FINISH GRADE APPROVED BY THE OWNER'S CONSTRUCTION MANAGER OR LANDSCAPE ARCHITECT PRIOR TO LAWN INSTALLATION.
- CONTRACTOR SHALL REMOVE ALL ROCKS 3/4" DIAMETER AND LARGER, DIRT CLODS, STICKS, CONCRETE SPOILS, ETC. PRIOR TO PLACING TOPSOIL AND LAWN INSTALLATION.
- CONTRACTOR SHALL MAINTAIN ALL LAWN AREAS UNTIL FINAL ACCEPTANCE. THIS SHALL INCLUDE, BUT NOT BE LIMITED TO: MOWING, WATERING, WEEDING, CULTIVATING, CLEANING AND REPLACING DEAD OR BARE AREAS TO KEEP PLANTS IN A VIGOROUS, HEALTHY CONDITION.
- CONTRACTOR SHALL GUARANTEE ESTABLISHMENT OF ACCEPTABLE TURF AREA AND SHALL PROVIDE REPLACEMENT FROM LOCAL SUPPLY IF NECESSARY.

SOLID SOD NOTES

- PLANT SOD BY HAND TO COVER INDICATED AREAS COMPLETELY. ENSURE EDGES OF SOD ARE TOUCHING. TOP DRESS JOINTS BY HAND WITH TOPSOIL TO FILL VOIDS.
- ROLL GRASS AREAS TO ACHIEVE A SMOOTH, EVEN SURFACE, FREE FROM UNNATURAL UNDULATIONS.
- WATER SOD THOROUGHLY AS SOD OPERATION PROGRESSES.
- IF INSTALLATION OCCURS BETWEEN SEPTEMBER 1 AND MARCH 1, OVER-SEED BERMUDAGRASS SOD WITH WINTER RYEGRASS, AT A RATE OF FOUR (4) POUNDS PER ONE THOUSAND (1000) SQUARE FEET.

LANDSCAPE TABULATIONS

THE CITY OF ROCKWALL, TEXAS

STREET LANDSCAPING

- 10' wide landscape buffer with one tree per 50 l.f.

| | |
|------------------------------|--|
| INDUSTRIAL BLVD.: 684 l.f. | |
| Required (14) trees, 3" cal. | Provided (14) existing trees, 4" cal. + |
| JUSTIN RD.: 671 l.f. | |
| Required (14) trees, 3" cal. | Provided (2) trees, 3" cal. (12) existing trees, 4" cal. + |

PARKING LOT LANDSCAPING

- 5% of the interior parking lot shall be landscape.
- One (1) tree for every ten (10) parking spaces.
- All parking spaces shall be a minimum eighty (80) feet from a tree.

Total interior parking lot area: 47,761 s.f.

Total parking spaces: 127 spaces

| | |
|-------------------------------------|--|
| Required 2,388 s.f. (5%) (13) trees | Provided 7,580 s.f. (16%) (6) trees, 3" cal. (11) existing trees |
|-------------------------------------|--|

SITE LANDSCAPING

- 10% of the total site shall be landscaped for LIGHT INDUSTRIAL.
- 100% of the total requirements shall be located in the front of and along side buildings for LIGHT INDUSTRIAL.

Total site: 10.18 AC; 443,480 s.f.

| | |
|---|---|
| Required 44,348 s.f. (10%) 44,348 s.f. (100%) | Provided 109,997 s.f. (25%) 76,646 s.f. |
|---|---|

DETENTION BASIN REQUIREMENTS

- A minimum of one (1) tree for every 750 s.f. of dry land area.

Dry Land Area: 26,232 s.f.

| | |
|---------------------|------------------------------|
| Required (35) trees | Provided (35) existing trees |
|---------------------|------------------------------|

CASE NO: SP2019-030

ARCHITECT:

OWNER:
ALVAPLAST US, INC. / SPR PACKAGING
CONTACT: CAROLINA MOLINA
1480 JUSTIN ROAD
ROCKWALL, TX 75087
469-402-1232


PROSS DESIGN GROUP, INC.
CONTACT: BOBBY PROSS
5310 HARVEST HILL RD., SUITE 180
DALLAS, TX 75230
972-759-1400

LANDSCAPE PLAN

- 4245 North Central Expy
- Suite 501
- Dallas, Texas 75205
- 214.865.7192 office

Drawn:
NAY
Checked:
NAY
Date:
08/14/19


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SPR
PACKAGING
OFFICE ADDITION
1480 JUSTIN RD., ROCKWALL, TEXAS

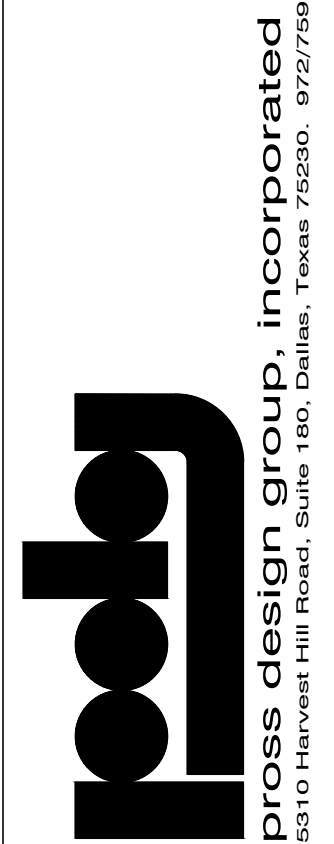job no
1854
sheet

L2.01



SECTION 32 9300 - LANDSCAPE

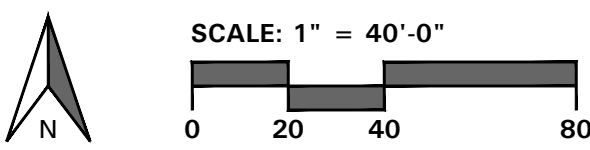PART 1 - GENERAL

1.1 REFERENCED DOCUMENTS

- A. Refer to Landscape Plans, notes, details, bidding requirements, special provisions, and schedules for additional requirements.

1.2 DESCRIPTION OF WORK

- A. Work included: Furnish all supervision, labor, materials, services, equipment and appliances required to complete the work covered in conjunction with the landscaping covered in these specifications and landscaping plans, including:

- Planting (trees, shrubs and grasses)
- Bed preparation and fertilization
- Notification of sources
- Water and maintenance until final acceptance
- Guarantee

1.3 REFERENCE STANDARDS

- A. American Standard for Nursery Stock published by American Association of Nursermen: 27 October 1980, Edition; by American National Standards Institute, Inc. (Z60.1) – plant material
- B. American Joint Committee on Horticultural Nomenclature: 1942 Edition of Standardized Plant Names.
- C. Texas Association of Nurserymen, Grades and Standards
- D. Hortis Third, 1976 - Cornell University

1.4 NOTIFICATION OF SOURCES AND SUBMITTALS

- A. Samples: Provide representative quantities of sandy loam soil, mulch, bed mix material, gravel, crushed stone, steel edging and tree stakes. Samples shall be approved by Owner's Authorized Representative before use on the project.

1.5 JOB CONDITIONS

- A. General Contractor to complete the following punch list: Prior to Landscape Contractor initiating any portion of landscape installation, General Contractor shall leave planting bed areas three (3") inches below final finish grade of sidewalks, drives and curbs as shown on the drawings. All lawn areas to receive solid sod shall be left one (1") inch below the final finish grade of sidewalks, drives and curbs. All construction debris shall be removed prior to Landscape Contractor beginning any work.
- B. Storage of materials and equipment at the job site will be at the risk of the Landscape Contractor. The Owner cannot be held responsible for theft or damage.

1.6 MAINTENANCE AND GUARANTEE

- A. Maintenance:
- The Landscape Contractor shall be held responsible for the maintenance of all work from the time of planting until final acceptance by the Owner. No trees, shrubs, groundcover or grass will be accepted unless they show healthy growth and satisfactory foliage conditions.
 - Maintenance shall include watering of trees and plants, cultivation, weeding spraying, edging, pruning of trees, mowing of grass, cleaning up and all other work necessary of maintenance.
 - A written notice requesting final inspection and acceptance should be submitted to the Owner at least seven (7) days prior to completion. An on-site inspection by the Owner's Authorized Representative will be completed prior to written acceptance.
- B. Guarantee:

- Trees, shrubs and groundcover shall be guaranteed for a twelve (12) month period after final acceptance. The Contractor shall replace all dead materials as soon as weather permits and upon notification of the Owner. Plants, including trees, which have partially died so that shape, size, or symmetry have been damaged, shall be considered subject to replacement. In such cases, the opinion of the Owner shall be final.
 - Plants used for replacement shall be of the same size and kind as those originally planted and shall be planted as originally specified. All work, including materials, labor and equipment used in replacements, shall carry a twelve (12) month guarantee. Any damage, including ruts in lawn or bed areas, incurred as a result of making replacements shall be immediately repaired.
 - At the direction of the Owner, plants may be replaced at the start of the next year's planting season. In such cases, dead plants shall be removed from the premises immediately.
 - When plant replacements are made, plants, soil mix, fertilizer and mulch are to be utilized as originally specified and re-inspected for full compliance with the contract requirements. All replacements are to be included under "Work" of this section.
- The Owner agrees that for the guarantee to be effective, he will water plants at least twice a week during dry periods and cultivate beds once a month after final acceptance.
- The above guarantee shall not apply where plants die after acceptance because of injury from storms, hail, freeze, insects, diseases, injury by humans, machines or theft.
- Acceptance for all landscape work shall be given after final inspection by the Owner provided the job is in a complete, undamaged condition and there is a stand of grass in all lawn areas. At that time, the Owner will assume maintenance on the accepted work.

- C. Repairs: Any necessary repairs under the Guarantee must be made within ten (10) days after receiving notice, weather permitting. In the event the Landscape Contractor does not make repairs accordingly, the Owner, without further notice to Contractor, may provide materials and men to make such repairs at the expense to the Landscape Contractor.

1.7 QUALITY ASSURANCE

- A. General: Comply with applicable federal, state, county and local regulations governing landscape materials and work.
- B. Personnel: Employ only experienced personnel who are familiar with the required work. Provide full time supervision by a qualified foreman acceptable to Landscape Architect.
- C. Selection of Plant Material:
- Make contact with suppliers immediately upon obtaining notice of contract acceptance to select and book materials. Develop a program of maintenance (pruning and fertilization) which will ensure the purchased materials will meet and / or exceed project specifications.
 - Substitutions: Do not make plant material substitutions. If the specified landscape material is not obtainable, submit proof of non-availability to Landscape Architect, together with proposal for use of equivalent material. At the time bids are submitted, the Contractor is assumed to have located the materials necessary to complete the job as specified.
 - Landscape Architect will provide a key identifying each tree location on site. Written verification will be required to document material selection, source and delivery schedules to site.
 - Measurements: Measure trees with branches and trunks or canes in their normal position. Do not prune to obtain required sizes. Take caliper measurements six inches above ground for trees up to and including 4" caliper size, and twelve inches above ground for larger sizes. Measure main body of all plant material of height and spread dimensions,

do not measure from branch or root tip-to-tip.

- Owner's Authorized Representative shall inspect all plant material with requirements for genus, species, cultivar / variety size and quality.
- Owner's Authorized Representative retains the right to further inspect all plant material upon arrival to the site and during installation for size and condition of root balls and the customary nursery usage. For clarification, the term "multi-trunk" defines a plant having three (3) or more trunks of nearly equal diameter.)
- Owner's Authorized Representative may reject unsatisfactory or defective material at any time during the process work. Remove rejected materials immediately from the site and replace with acceptable material at no additional cost to the Owner. Plants damaged in transit or at job site shall be rejected.

1.8 PRODUCT DELIVERY, STORAGE AND HANDLING

A. Preparation:

- Balled and Burlapped (B&B) Plants: Dig and prepare shipment in a manner that will not damage roots, branches, shape and future development.
- Container Grown Plants: Deliver plants in rigid container to hold ball shape and protect root mass.

B. Delivery:

- Deliver packaged materials in sealed containers showing weight, analysis and name of manufacturer. Protect materials from deterioration during delivery and while stored on site.
- Deliver only plant materials that can be planted in one day unless adequate storage and watering facilities are available on job site.
- Protect root balls by heeling in with sawdust or other approved moisture retaining material if not planted within 24 hours of delivery.
- Protect plants during delivery to prevent damage to root balls or desiccation of leaves. Keep plants moist at all times. Cover all materials during transport.
- Notify Owner's Authorized Representative of delivery schedule 72 hours in advance job site.
- Remove rejected plant material immediately from job site.
- To avoid damage or stress, do not lift, move, adjust to plumb, or otherwise manipulate plants by trunk or stems.

PART 2 - PRODUCTS

2.1 PLANTS

- A. General: Well-formed No. 1 grade or better nursery grown stock. Listed plant heights are from tops of root balls to nominal tops of plants. Plant spread refers to nominal outer width of the plant, not to the outer leaf tips. Plants will be individually approved by the Owner's Authorized Representative and his decision as to their acceptability shall be final.
- B. Quantities: The drawings and specifications are complimentary. Anything called for on one and not the other is as binding as if shown and called for on both. The plant schedule is an aid to bidders only. Confirm all quantities on plan.
- C. Quality and size: Plant materials shall conform to the size given on the plan, and shall be healthy, symmetrical, well-shaped, full branched and well rooted. The plants shall be free from injurious insects, diseases, injuries to the bark or roots, broken branches, objectionable disfigurements, insect eggs and larvae, and are to be of specimen quality.
- D. Approval: All plants which are found unsuitable in growth, or are in any unhealthy, badly shaped or undersized condition will be rejected by the Owner's Authorized Representative either before or after planting and shall be removed at the expense of the Landscape Contractor and replaced with acceptable plant as

specified at no additional cost to the Owner.

- Trees shall be healthy, full-branched, well-shaped, and shall meet the minimum trunk and diameter requirements of the plant schedule. Balls shall be firm, neat, slightly tapered and well wrapped in burlap. Any tree loose in the ball or with a broken root ball at time of planting will be rejected. Balls shall be ten (10") inches in diameter for each one (1") inch of trunk diameter, measured six (6") inches above ball. (Nomenclature confirms to the customary nursery usage. For clarification, the term "multi-trunk" defines a plant having three (3) or more trunks of nearly equal diameter.)
- Pruning: All pruning of trees and shrubs, as directed by the Landscape Architect prior to final acceptance, shall be executed by the Landscape Contractor at no additional cost to the Owner.

2.2 SOIL PREPARATION MATERIALS

A. Sandy Loam:

- Friable, fertile, dark, loamy soil, free of clay lumps, subsoil, stones and other extraneous material and reasonably free of weeds and foreign grasses. Loam containing Dallisgrass or Nutgrass shall be rejected.
- Physical properties as follows:
 - Clay – between 7-27 percent
 - Silt – between 15-25 percent
 - Sand – less than 52 percent
- Organic matter shall be 3%-10% of total dry weight.
- If requested, Landscape Contractor shall provide a certified soil analysis conducted by an approved soil testing laboratory verifying that sandy loam meets the above requirements.
- Organic Material: Compost with a mixture of 80% vegetative matter and 20% animal waste. Ingredients should be a mix of course and fine textured material.
- Premixed Bedding Soil as supplied by Vital Earth Resources, Gladewater, Texas; Professional Bedding Soil as supplied by Living Earth Technology, Dallas, Texas or Acid Gro Municipal Mix as supplied by Soil Building Systems, Dallas, Texas or approved equal.
- Sharp Sand: Sharp sand must be free of seeds, soil particles and weeds.
- Mulch: Double Shredded Hardwood Mulch, partially decomposed, dark brown. Living Earth Technologies or approved equal.
- Organic Fertilizer: Fertilaid, Sustane, or Green Sense or equal as recommended for required applications. Fertilizer shall be delivered to the site in original unopened containers, each bearing the manufacturer's guaranteed statement of analysis.
- Commercial Fertilizer: 10-20-10 or similar analysis. Nitrogen source to be a minimum 50% slow release organic Nitrogen (SCU or UF) with a minimum 8% sulfur and 4% iron, plus micronutrients.
- Peat: Commercial sphagnum peat moss or partially decomposed shredded pine bark or other approved organic material.

2.3 MISCELLANEOUS MATERIALS

- Steel Edging: All steel edging shall be 3/16" thick x 4" deep x 16' long with 6 stakes per section, painted black at the factory as manufactured by The J.D. Russell Company and under its trade name DUREEDGE Heavy Duty Steel.
- Staking Material for Shade Trees: refer to details.
- Gravel: Washed native pea gravel, graded 1 inch to 1-1/2 inch.
- Filter Fabric: "Mirafi Mirascape" by Mirafi Construction Products available at Lone Star Products, Inc., (469) 523-0444 or approved equal.
- River Rock: 'Colorado' or native river rock, 2" - 4" dia.

- Decomposed Granite: Base material shall consist of a natural material mix of granite aggregate not to exceed 1/8" diameter in size and shall be composed of various stages of decomposed earth base.

PART 3 - EXECUTION

3.1 BED PREPARATION & FERTILIZATION

- Landscape Contractor to inspect all existing conditions and report any deficiencies to the Owner.
- All planting areas shall be conditioned as follows:
 - Prepare new planting beds by scraping away existing grass and weeds as necessary. Till existing soil to a depth of six (6") inches prior to placing compost and fertilizer. Apply fertilizer as per Manufacturer's recommendations. Add six (6") inches of compost and till into a depth of six (6") inches of the topsoil. Apply organic fertilizer such as Sustane or Green Sense at the rate of twenty (20) pounds per one thousand (1,000) square feet.
 - All planting areas shall receive a two (2") inch layer of specified mulch.
 - Backfill for tree pits shall be as follows: Use existing top soil on site (use imported topsoil as needed) free from large clumps, rocks, debris, caliche, subsoils, etc., placed in nine (9") inch layers and watered in thoroughly.
- Grass Areas:
 - Blocks of sod should be laid joint to joint (staggered joints) after fertilizing the ground first. Roll grass areas to achieve a smooth, even surface. The joints between the blocks of sod should be filled with topsoil where they are evidently gaped open, then watered thoroughly.

3.2 INSTALLATION

- Maintenance of plant materials shall begin immediately after each plant is delivered to the site and shall continue until all construction has been satisfactorily accomplished.
- Plant materials shall be delivered to the site only after the beds are prepared and areas are ready for planting. All shipments of nursery materials shall be thoroughly protected from the drying winds during transit. All plants which cannot be planted at once, after delivery to the site, shall be well protected against the possibility of drying by wind and Balls of earth of B & B plants shall be kept covered with soil or other acceptable material. All plants remain the property of the Contractor until final acceptance.
- Position the trees and shrubs in their intended location as per plan.
- Notify the Owner's Authorized Representative for inspection and approval of all positioning of plant materials.
- Excavate pits with vertical sides and horizontal bottom. Tree pits shall be large enough to permit handling and planting without injury to balls of earth or roots and shall be of such depth that, when planted and settled, the crown of the plant shall bear the same relationship to the finish grade as it did to soil surface in original place of growth.
- Shrub and tree pits shall be no less than twenty-four (24") inches wider than the lateral dimension of the earth ball and six (6") inches deeper than it's vertical dimension. Remove and haul from site all rocks and stones over three-quarter (¾") inch in diameter. Plants should be thoroughly moist before removing containers.
- Dig a wide, rough sided hole exactly the same depth as the height of the ball, especially at the surface of the ground. The sides of the hole should be rough and jagged, never slick or glazed.
- Percolation Test: Fill the hole with water. If the water level does not percolate within 24 hours, the tree needs to move to another location or have drainage added. Install a PVC stand pipe per


tree planting detail as approved by the Landscape Architect if the percolation test fails.

- Backfill only with 5 parts existing soil or sandy loam and 1 part bed preparation. When the hole is dug in solid rock, topsoil from the same area should not be used. Carefully settle by watering to prevent air pockets. Remove the burlap from the top ½ of the ball, as well as all nylon, plastic string and wire. Container trees will usually be root bound, if so follow standard nursery practice of "root scoring".
- Do not wrap trees.
- Do not over prune.
- Mulch the top of the ball. Do not plant grass all the way to the trunk of the tree. Leave the area above the top of the ball and mulch with at least two (2") inches of specified mulch.
- All plant beds and trees to be mulched with a minimum settled thickness of two (2") inches over the entire bed or pit.
- Obstruction below ground: In the event that rock, or underground construction work or obstructions are encountered in any plant pit excavation work to be done under this section, alternate locations may be selected by the Owner. Where locations cannot be changed, the obstructions shall be removed to a depth of not less than three (3') feet below grade and no less than six (6") inches below the bottom of ball when plants are properly set at the intended grade. The work of this section shall include the removal from the site of such rock or underground obstructions encountered at the cost of the Landscape Contractor.
- Trees and large shrubs shall be staked as site conditions require. Position stakes to secure trees against seasonal prevailing winds.
- Pruning and Mulching: Pruning shall be directed by the Landscape Architect and shall be pruned in accordance with standard horticultural practice following Fine Pruning, Class I pruning standards provided by the National Arborist Association.
 - Dead wood, suckers, broken and badly bruised branches shall be removed. General tipping of the branches is not permitted. Do not cut terminal branches.
 - Pruning shall be done with clean, sharp tools.
 - Immediately after planting operations are completed, all tree pits shall be covered with a layer of organic material two (2") inches in depth. This limit of the organic material for trees shall be the diameter of the plant pit.
- Steel Curbing Installation:
 - Curbing shall be aligned as indicated on plans. Stake out limits of steel curbing and obtain Owners approval prior to installation.
 - All steel curbing shall be free of kinks and abrupt bends.
 - Top of curbing shall be ½" maximum height above final finished grade.
 - Stakes are to be installed on the planting bed side of the curbing, as opposed to the grass side.
 - Do not install steel edging along sidewalks or curbs.
 - Cut steel edging at 45 degree angle where edging meets sidewalks or curbs.

3.3 CLEANUP AND ACCEPTANCE

- Cleanup: During the work, the premises shall be kept neat and orderly at all times. Storage areas for all materials shall be so organized so that they, too, are neat and orderly. All trash and debris shall be removed from the site as work progresses. Keep paved areas clean by sweeping or hosing them at end of each work day.


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01 TREE PLANTING DETAIL
NOT TO SCALE

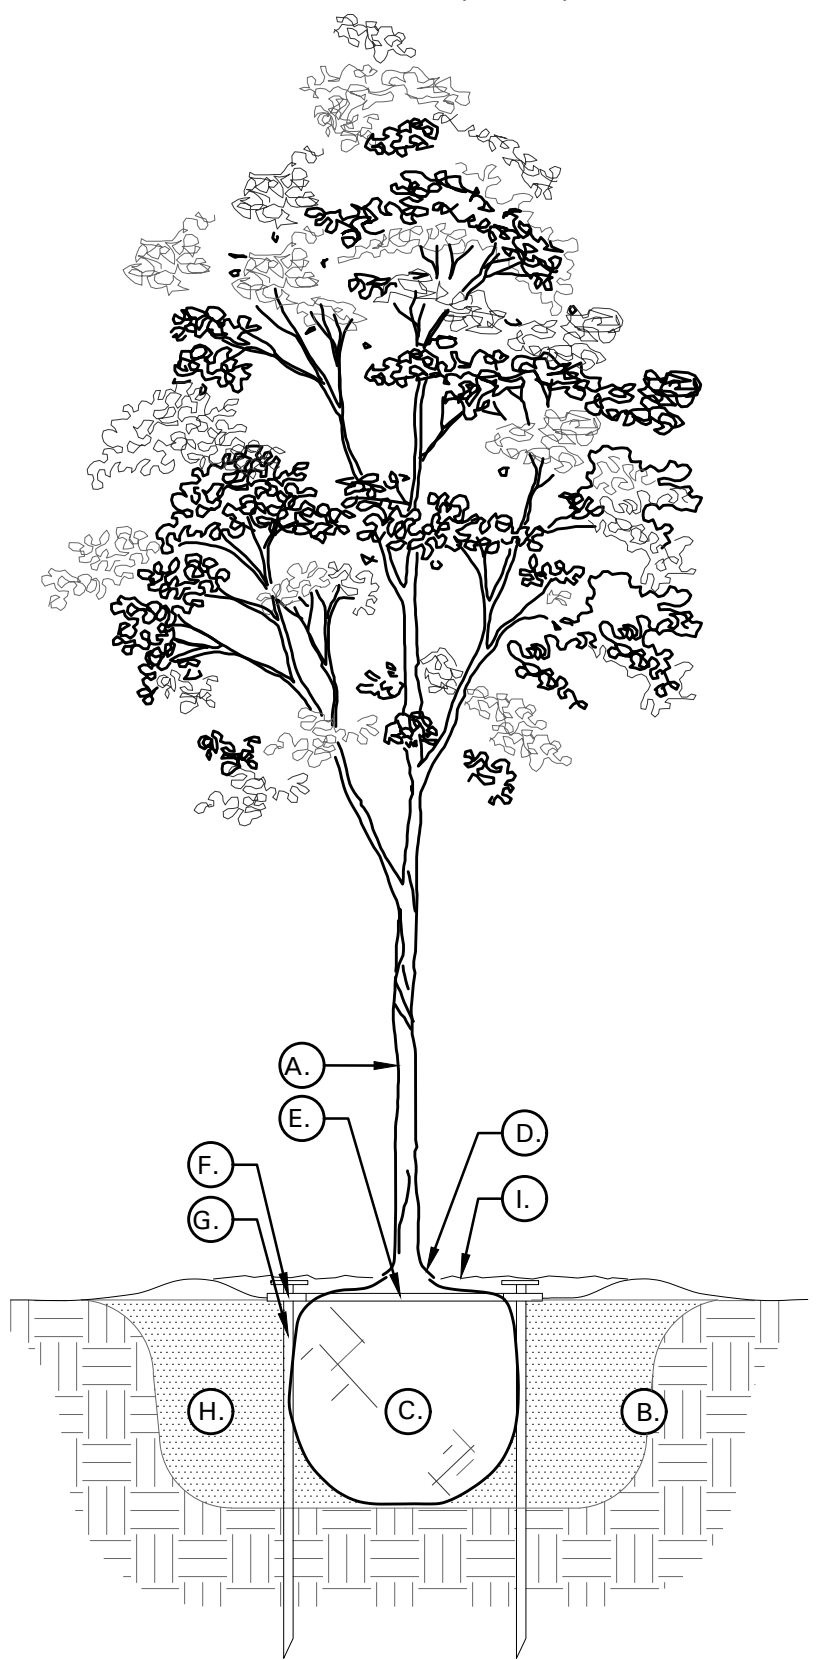TREE PLANTING DETAIL LEGEND
AND NOTES

- TREE: TREES SHALL CONFORM WITH LATEST AMERICAN STANDARD FOR NURSERY STOCK. www.anla.org
- TREE PIT: WIDTH TO BE AT LEAST TWO (2) TIMES THE DIAMETER OF THE ROOT BALL CENTER TREE IN HOLE & REST ROOT BALL ON UNDISTURBED NATIVE SOIL.
- ROOT BALL: REMOVE TOP ½ BURLAP AND ANY OTHER FOREIGN OBJECT; CONTAINER GROWN STOCK TO BE INSPECTED FOR GIRDLING ROOTS.
- ROOT FLARE: ENSURE THAT ROOT FLARE IS EXPOSED, FREE FROM MULCH AND AT LEAST TWO INCHES ABOVE GRADE. TREES SHALL BE REJECTED WHEN GIRDLING ROOTS ARE PRESENT & ROOT FLARE IS NOT APPARENT.
- ROOTBALL ANCHOR RING: REFER TO MANUFACTURER'S GUIDELINES FOR SIZING. PLACE ROOTBALL ANCHOR RING ON BASE OF ROOTBALL, TRUNK SHOULD BE IN THE CENTER OF THE RING.
- ROOT ANCHOR BY TREE STAKE SOLUTIONS.
- NAIL STAKE: REFER TO MANUFACTURER'S GUIDELINES FOR SIZING. INSTALL NAIL STAKES WITH HAMMER OR Mallet FIRMLY INTO UNDISTURBED GROUND. DRIVE NAIL STAKES FLUSH WITH "U" BRACKET ADJACENT TO ROOTBALL (DO NOT DISTURB ROOTBALL).
- BACKFILL: USE EXISTING NATIVE SOIL (no amendments) WATER THOROUGHLY TO ELIMINATE AIR POCKETS.
- MULCH: DOUBLE SHREDDED HARDWOOD MULCH 2 INCH SETTLED THICKNESS. WITH 2" HT. WATERING RING. ENSURE THAT ROOT FLARE IS EXPOSED. BELOW GROUND STAKE SHOULD NOT BE VISIBLE.
- TREE STAKES: TREE STAKE SOLUTIONS "SAFETY STAKE" BELOW GROUND MODEL AVAILABLE FROM: Tree Stake Solutions ATTN: Jeff Tuley (903) 676-6143 jeff@treestakesolutions.com www.treestakesolutions.com
- OR APPROVED EQUAL. TREES SHALL BE STAKED BELOW GROUND WHERE NECESSARY; ABOVE GROUND STAKING IS EXPRESSLY PROHIBITED.
- IT SHALL BE THE RESPONSIBILITY OF THE CONTRACTOR TO OBTAIN A COPY OF THE MANUFACTURER'S SPECIFICATIONS PRIOR TO INSTALLATION OF TREE STAKES. CONTRACTOR SHALL ADHERE TO MANUFACTURER'S INSTALLATION GUIDELINES, SPECIFICATIONS, AND OTHER REQUIREMENTS FOR TREE STAKE INSTALLATION.



02 SHRUB / GROUNDCOVER DETAIL
NOT TO SCALE

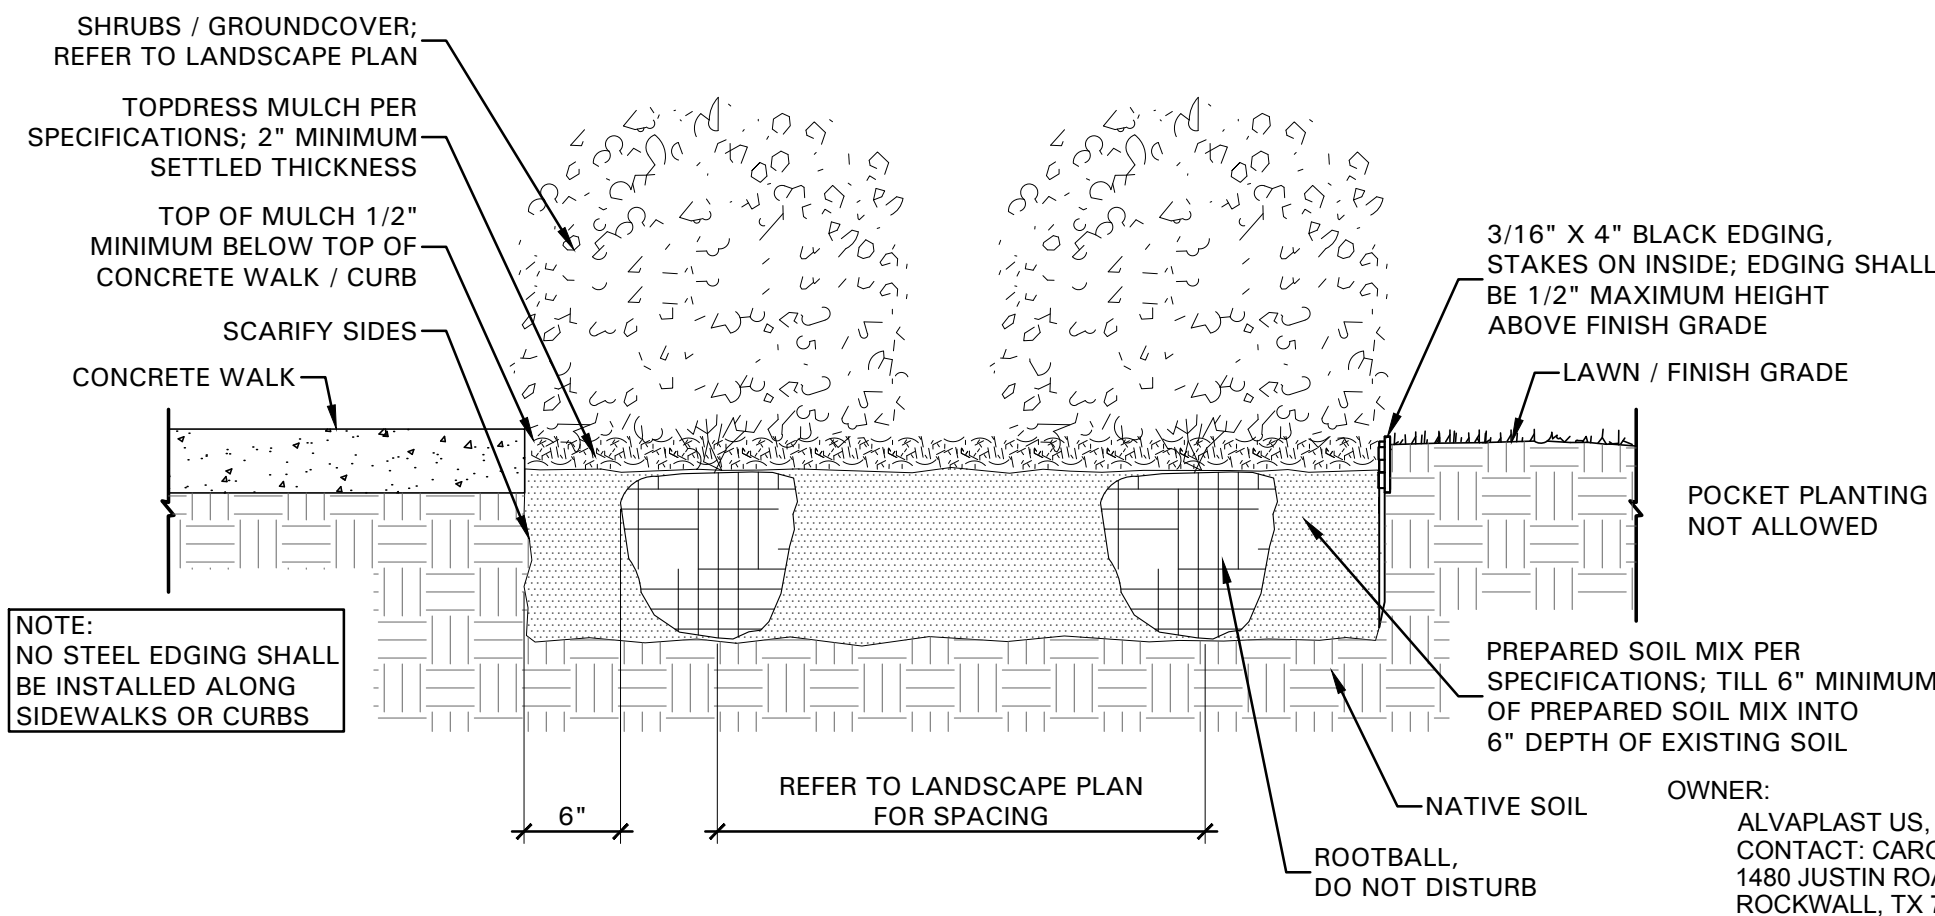CASE NO: SP2019-030

ARCHITECT:

PROSS DESIGN GROUP, INC.
5310 HARVEST HILL RD., SUITE 180
DALLAS, TX 75230
972-759-1400




LANDSCAPE SPECIFICATIONS
AND DETAILS

- 4245 North Central Expy
- Suite 501
- Dallas, Texas 75205
- 214.865.7192 office

Drawn:
Checked:
Date:
08/14/19

DESCRIPTION

DATE

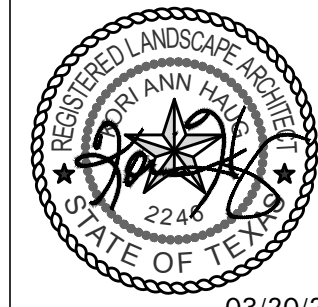


03/20/20

SPR
PACKAGING
OFFICE ADDITION
1480 JUSTIN RD., ROCKWALL, TEXAS

job no
1854
sheet

L2.02

SOUTHERN PACIFIC RAIL ROAD
(100' R.O.W.)

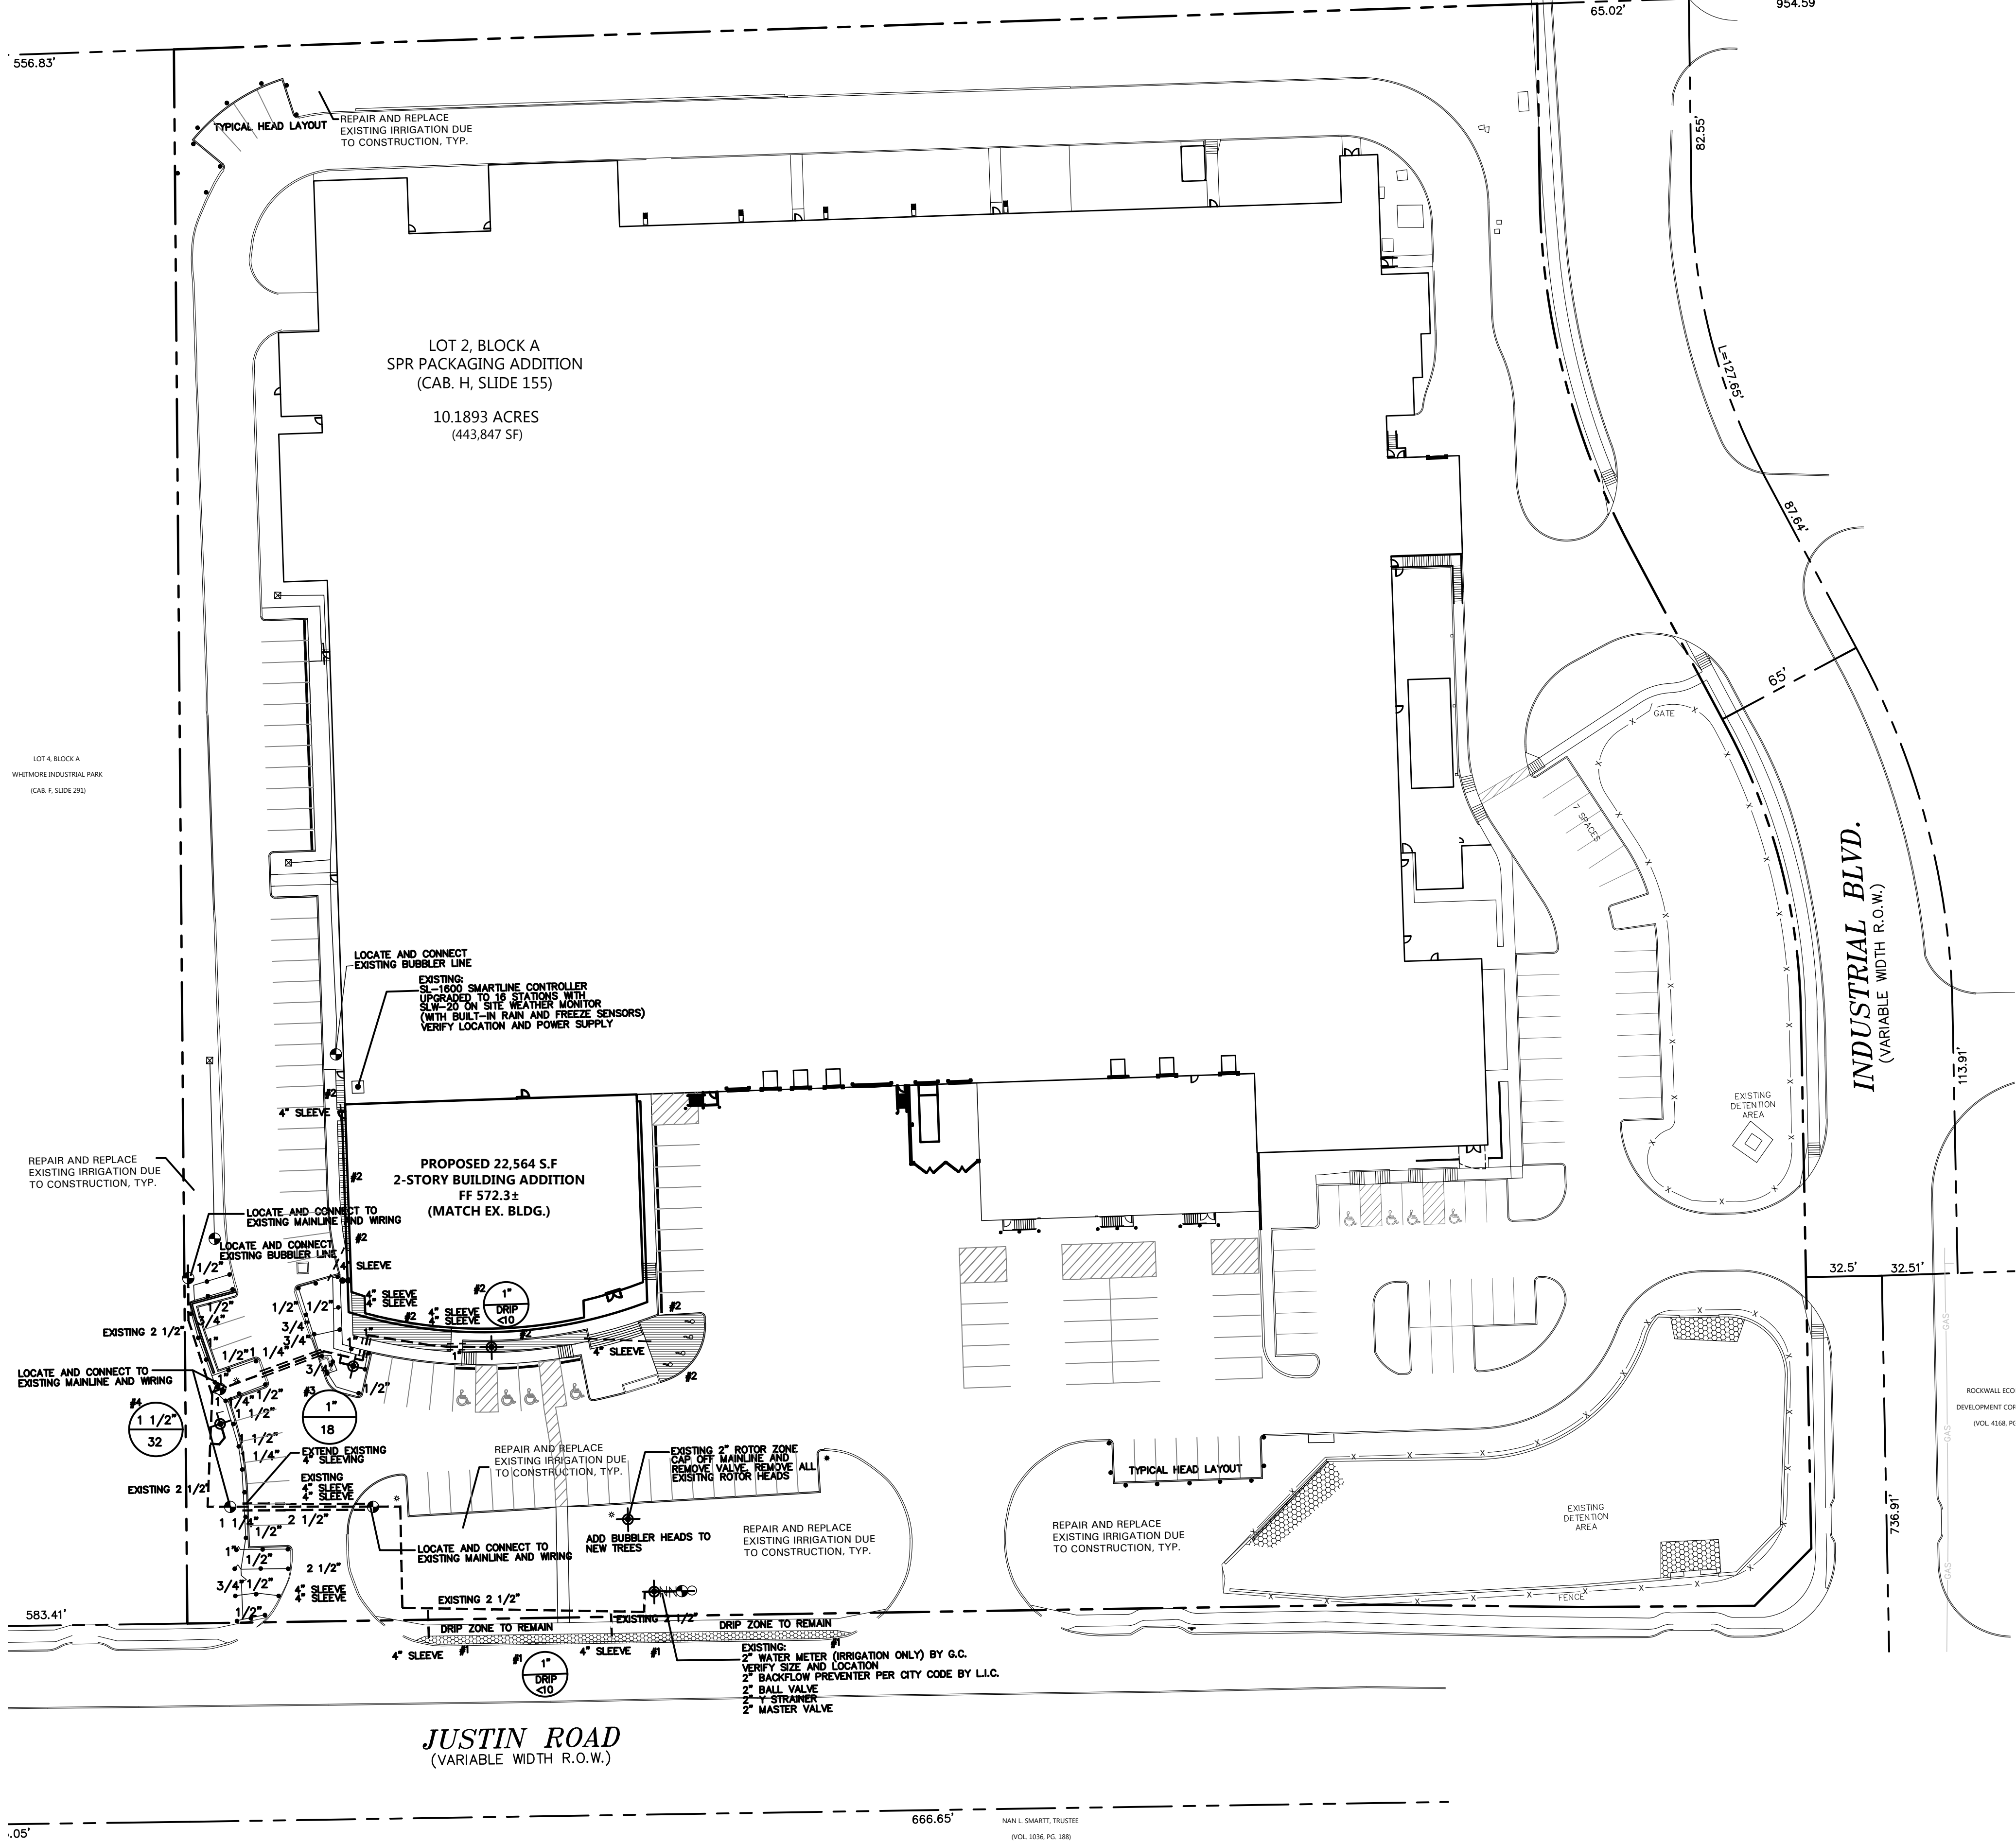

SLEEVING NOTES

1. SLEEVES SHALL BE FURNISHED AND INSTALLED BY GENERAL CONTRACTOR.
2. SLEEVE MATERIAL SHALL BE SCHEDULE 40 PIPE, SIZE AS INDICATED ON PLAN.
3. CONTRACTOR SHALL LAY SLEEVES AND CONDUITS AT TWENTY-FOUR (24") INCHES BELOW FINISH GRADE OF THE TOP OF PAVEMENT.
4. CONTRACTOR SHALL EXTEND SLEEVES ONE (1') FOOT BEYOND EDGE OF ALL PAVEMENT.
5. CONTRACTOR SHALL CAP PIPE ENDS USING PVC CAPS.
6. CONTRACTOR SHALL FURNISH OWNER AND IRRIGATION CONTRACTOR WITH AN "AS-BUILT" DRAWING SHOWING ALL SLEEVE LOCATIONS.

IRRIGATION NOTES

1. THE IRRIGATION CONTRACTOR SHALL COORDINATE INSTALLATION OF THE IRRIGATION SYSTEM WITH THE LANDSCAPE CONTRACTOR SO THAT ALL PLANT MATERIAL WILL BE WATERED IN ACCORDANCE WITH THE INTENT OF THE PLANS AND SPECIFICATIONS.
2. ALL SPRINKLER EQUIPMENT NUMBERS REFERENCE THE WEATHERMATIC EQUIPMENT CATALOG UNLESS OTHERWISE INDICATED.
3. TEN DAYS PRIOR TO START OF CONSTRUCTION, IRRIGATION CONTRACTOR SHALL VERIFY STATIC WATER PRESSURE. IF STATIC PRESSURE IS LESS THAN 65 P.S.I., NOTIFY THE LANDSCAPE ARCHITECT IMMEDIATELY. DO NOT WORK UNTIL NOTIFIED TO DO SO BY OWNER.
4. SLEEVES SHALL BE FURNISHED AND INSTALLED BY GENERAL CONTRACTOR. SLEEVE MATERIAL SHALL BE SCHEDULE 40, SIZE AS INDICATED ON PLAN. REFER TO SLEEVING NOTES.
5. ALL MAIN LINE AND LATERAL LINE PIPING IN PLANTING AND LAWN AREAS SHALL HAVE A MINIMUM OF 12 INCHES OF COVER. ALL PIPING UNDER PAVING SHALL HAVE A MINIMUM OF 18 INCHES OF COVER. CONTRACTOR TO VERIFY LOCAL FREEZE DEPTHS AND ADJUST DEPTH OF COVER ACCORDINGLY.
6. LAWN SPRAY HEADS SHALL BE WEATHERMATIC LX-4 INSTALLED PER DETAIL SHOWN.
7. ROTOR HEADS SHALL BE WEATHERMATIC TURBO INSTALLED PER DETAIL SHOWN. (WITH BUILT-IN CHECK VALVE)
8. NOZZLES SHALL BE WEATHERMATIC 5500 SERIES, UNLESS OTHERWISE NOTED. IRRIGATION CONTRACTOR SHALL SELECT THE PROPER ARC AND RADIUS FOR EACH NOZZLE TO ENSURE 100% AND PROPER COVERAGE OF ALL LAWN AREAS AND PLANT MATERIAL. NO WATER SHALL SPRAY ON BUILDING.
9. ALL NOZZLES IN PARKING LOT ISLANDS AND PLANTING BEDS SHALL BE LOW ANGLE NOZZLES TO MINIMIZE OVER SPRAY ON PAVEMENT SURFACES.
10. ELECTRIC CONTROL VALVES SHALL BE WEATHERMATIC 11000 SERIES INSTALLED PER DETAIL SHOWN. SIZE OF VALVES AS SHOWN ON PLAN. VALVES SHALL BE INSTALLED IN VALVE BOXES LARGE ENOUGH TO PERMIT MANUAL OPERATION, REMOVAL OF SOLENOID AND / OR VALVE COVER WITHOUT ANY EARTH EXCAVATION.
11. QUICK COUPLING VALVES SHALL BE WEATHERMATIC QV75 INSTALLED PER DETAIL SHOWN. SWING JOINTS SHALL BE CONSTRUCTED USING 3/4" SCHEDULE 80 ELBOWS. CONTRACTOR SHALL SUPPLY OWNER WITH THREE (3) CH75 COUPLERS AND THREE (3) #10HSL SWIVEL HOSE ELLS AS PART OF THIS CONTRACT.
12. ALL 24 VOLT VALVE WIRING TO BE UF 14 GAUGE SINGLE CONDUCTOR. ALL WIRE SPLICES ARE TO BE PERMANENT AND WATERPROOF.
13. AUTOMATIC CONTROLLER SHALL BE INSTALLED AT LOCATION SHOWN. POWER (120V) SHALL BE LOCATED IN A JUNCTION BOX WITHIN FIVE (5') FEET OF CONTROLLER, LOCATION BY OTHER TRADES. RAIN AND FREEZE SENSORS SHALL BE INSTALLED WITH EACH CONTROLLER.
14. THE DESIGN PRESSURE IS 65 PSI.
15. ELECTRICAL SPLICES AT EACH VALVE AND CONTROLLER ONLY.
16. IRRIGATION IN TEXAS IS REGULATED BY: THE TEXAS COMMISSION ON ENVIRONMENTAL QUALITY (TCEQ) MC-178 / PO BOX 13087 AUSTIN, TEXAS 78711-3087
17. TCEQ'S WEBSITE IS WWW.TCEQ.STATE.TX.US.

IRRIGATION LEGEND

- WEATHERMATIC LX-4 POP-UP LAWN HEAD
- MP HUNTER MP ROTATOR NOZZLE
- WEATHERMATIC TURBO ROTARY FC
- WEATHERMATIC TURBO ROTARY PC
- ⊗ WEATHERMATIC 106.5 BUBBLER (2 PER TREE, TYP.)
- ⊕ WEATHERMATIC 11000 SERIES ELECTRIC VALVE
- ▲ WEATHERMATIC QV75 QUICK COUPLER
- CONTROLLER, SIZE AS INDICATED
- WATER METER, SIZE AS INDICATED WITH D.C.A., SIZE AS INDICATED
- PVC SCHEDULE 40 SLEEVING
- PVC CLASS 200 MAINLINE
- PVC CLASS 200 LATERAL LINE
- VALVE SIZE GPM
- NETAFIM TECHLINE#TLDL6-1210 (18" LATERAL SPACING, 12" EMITTER SPACING) PVC LATERAL PIPING SIZED AS REQUIRED INSTALL ALL EQUIPMENT ACCORDING TO MANUFACTURERS SPECIFICATIONS
- NETAFIM TECHLINE#TLDL6-1210 (18" LATERAL SPACING, 12" EMITTER SPACING) PVC LATERAL PIPING SIZED AS REQUIRED INSTALL ALL EQUIPMENT ACCORDING TO MANUFACTURERS SPECIFICATIONS
- NETAFIM DISC FILTER #DF100-080 NETAFIM PRESSURE REGULATOR #PRV15025 INSTALL ALL EQUIPMENT ACCORDING TO MANUFACTURERS SPECIFICATIONS

BUBBLER PIPING CHART

| NUMBER OF BUBBLERS | SIZE OF PIPE |
|--------------------|--------------|
| 1 - 5 | 3/4" |
| 6 - 10 | 1" |
| 11 - 20 | 1 1/4" |
| 21 - 30 | 1 1/2" |
| 31 - 40 | 1 3/4" |

SMARTLINE CERTIFIED DESIGN


1. THIS IRRIGATION DESIGN FEATURES SMARTLINE CONTROLLER AND WEATHER MONITOR TECHNOLOGY AND UTILIZES "ET" BASED WATER CONSERVATION AUTO ADJUSTING SCHEDULING.
2. THE IRRIGATION CONTRACTOR MUST PROGRAM THE CONTROLLER BY SELECTING THE PROPER SPRINKLER TYPE, PLANT TYPE, SOIL TYPE, SLOPE AND SUN / SHADE EXPOSURE FOR EACH ZONE.
3. THE IRRIGATION CONTRACTOR MUST CONTACT THE IRRIGATION DESIGNER FOR APPROVAL OF CONTROLLER SETTINGS.
4. THE IRRIGATION DESIGNER IS JOHN WINGFIELD (972) 513-3859.
5. ALL EQUIPMENT MUST BE INSTALLED AS SPECIFIED. NO EQUIPMENT SUBSTITUTIONS WILL BE PERMITTED.

OWNER:
AL/APLAST US, INC. / SPR PACKAGING
CONTACT: BOBBY PROSS
1480 JUSTIN ROAD
ROCKWALL, TX 75087
469-402-1232

CASE NO: SP2019-030
ARCHITECT:
PROSS DESIGN GROUP, INC.
CONTACT: BOBBY PROSS
5310 HARVEST HILL RD., SUITE 180
DALLAS, TX 75230
972-759-1400


IRRIGATION PLAN

- 4245 North Central Expy
- Suite 501
- Dallas, Texas 75205
- 214.865.7192 office

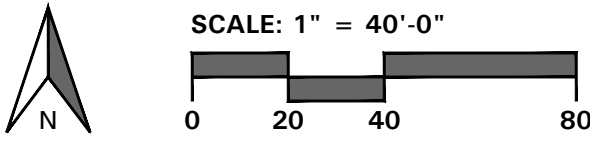

drawn:
checked
date
08/14/19


| DESCRIPTION | DATE |
|-------------|------|
| # | |

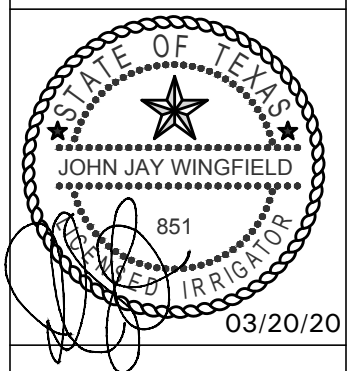

pross design group, incorporated
5310 Harvest Hill Road, Suite 180, Dallas, Texas 75230-1400

SPR PACKAGING
OFFICE ADDITION
1480 JUSTIN RD., ROCKWALL, TEXAS

job no
1854
sheet
L3.01

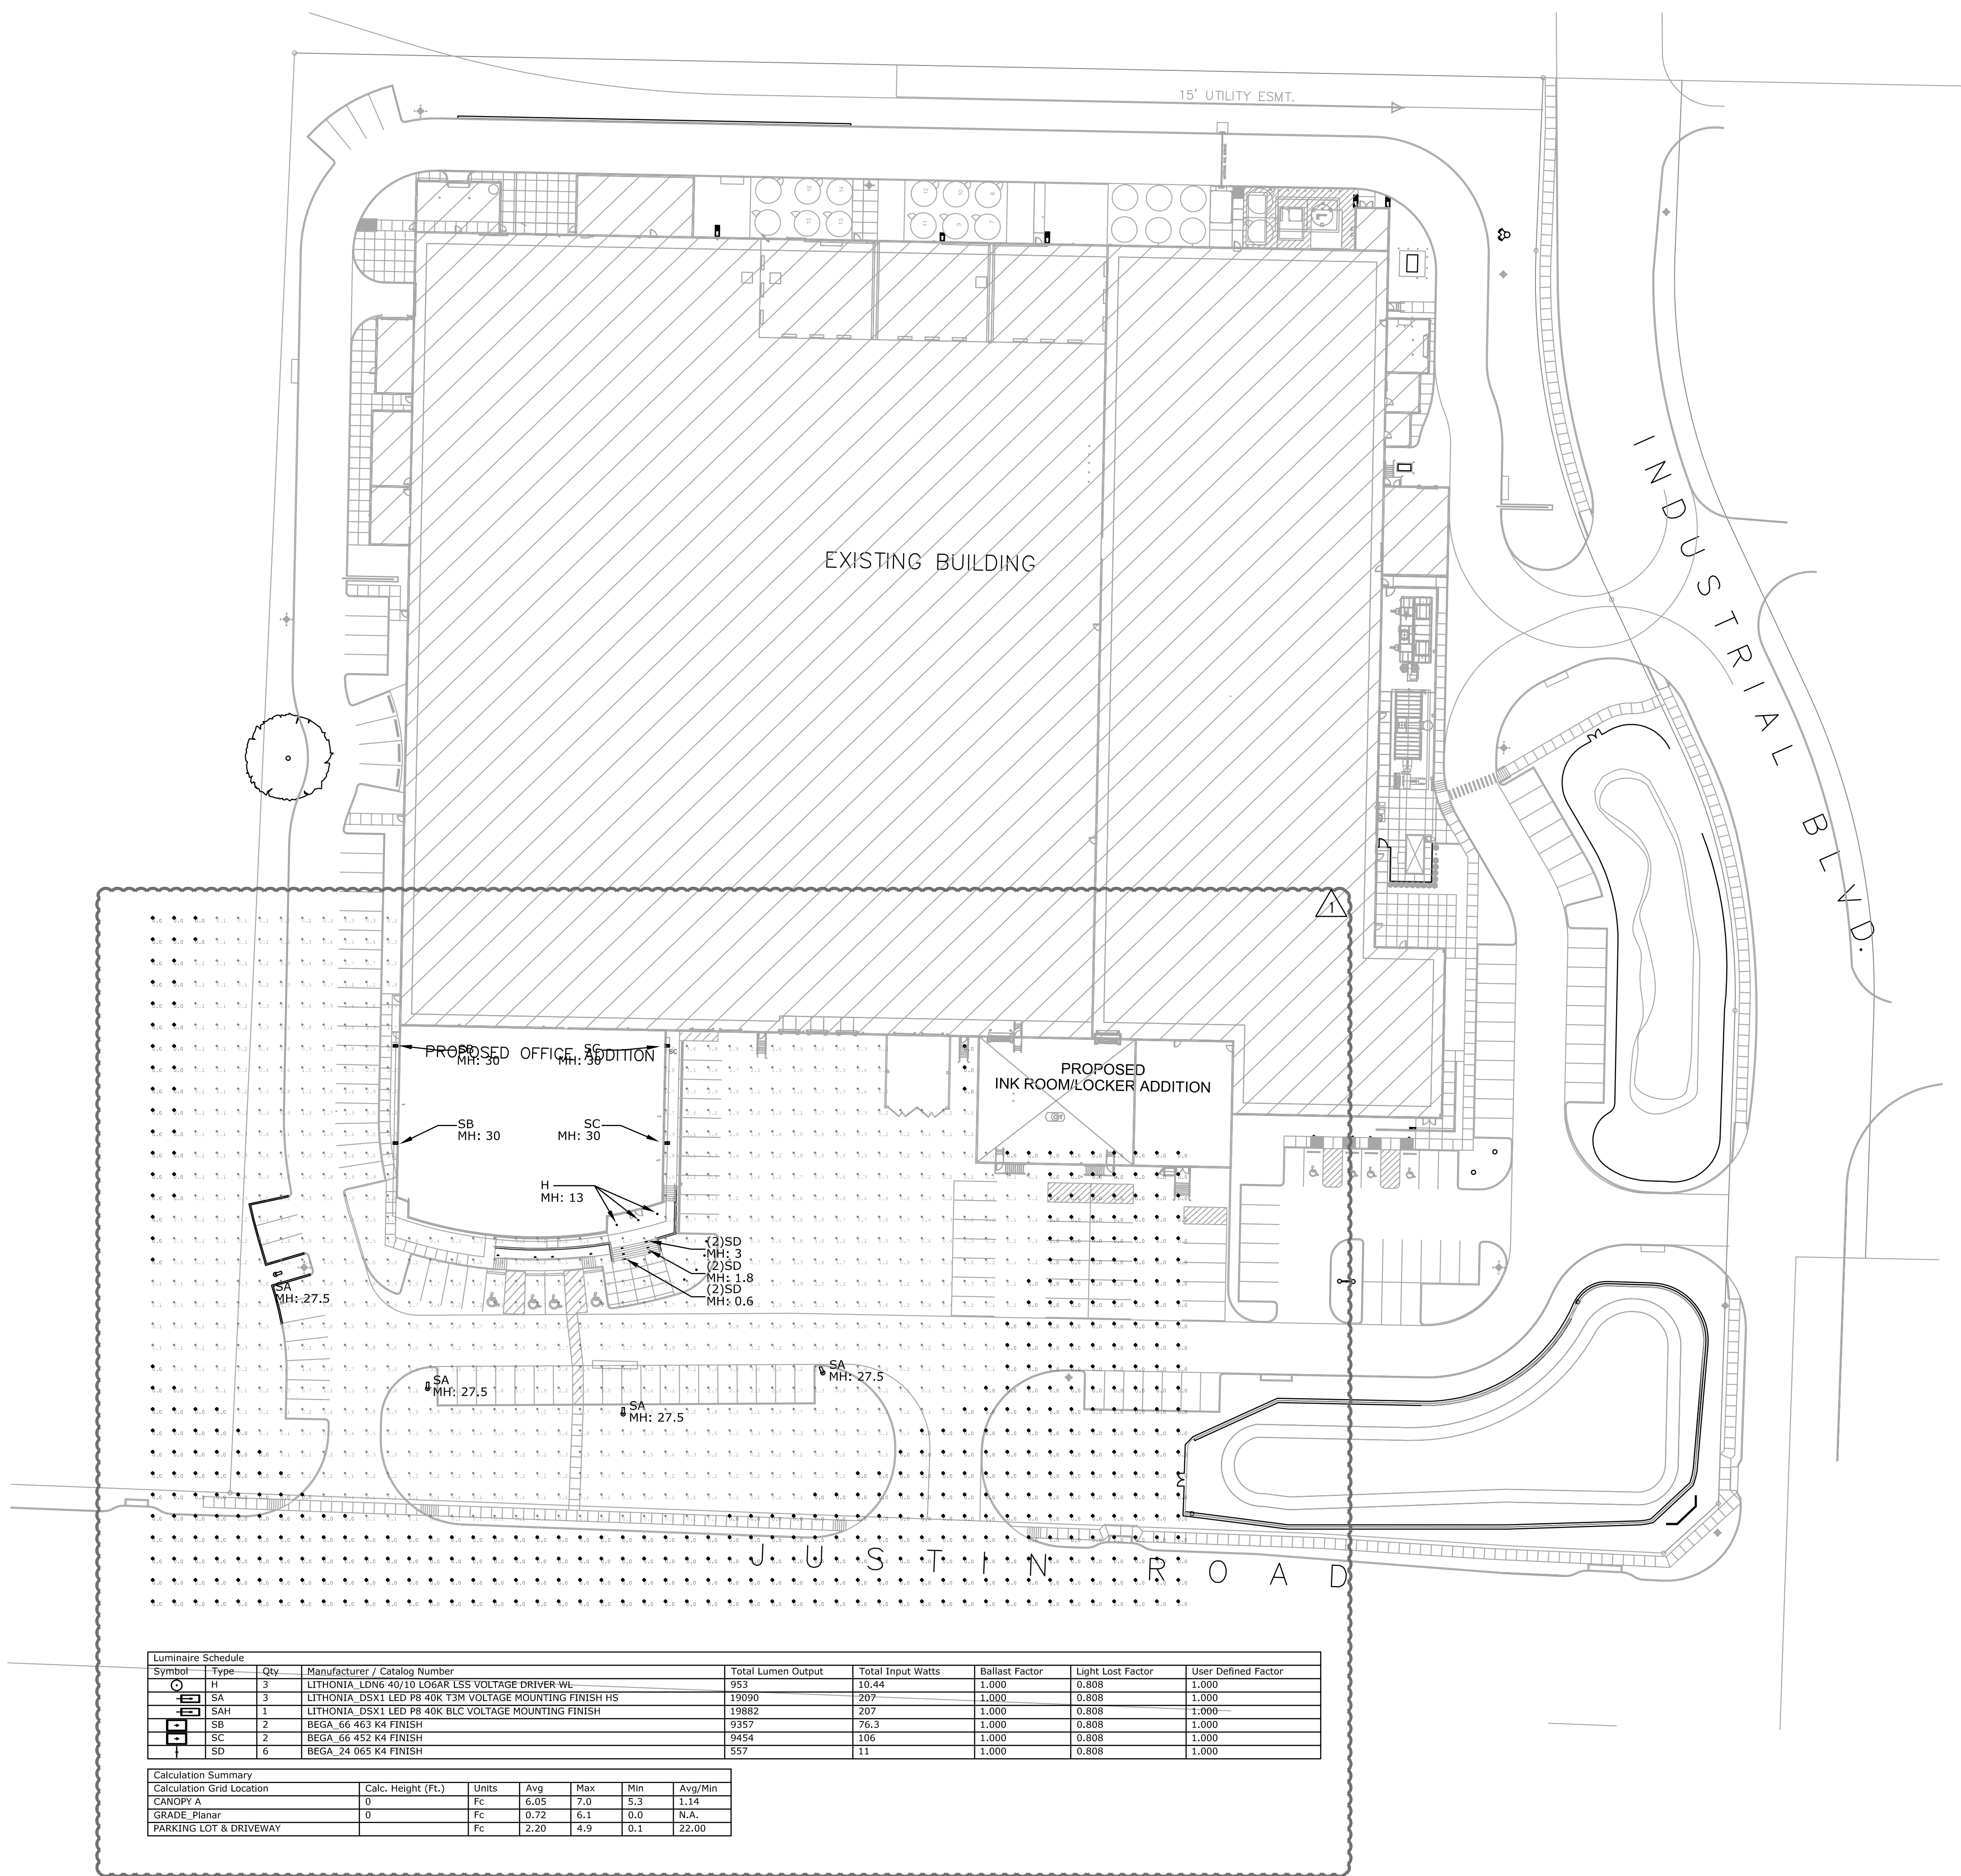


1 MEP SITE PHOTOMETRICS PLAN
MEP1.1 1" = 40'-0"

PROJECT DATA

| | |
|------------------------|---------------------------|
| ZONING: | LIGHT INDUSTRIAL |
| PROPOSED LAND USE: | WAREHOUSE, MANUF., OFFICE |
| SITE AREA: | 10.18 AC |
| | 443,480.8 SF |
| BUILDING AREA: | |
| EXISTING BUILDING: | 188,516 SF |
| ADDITION FIRST FLOOR: | 11,628 SF |
| ADDITION SECOND FLOOR: | 10,936 SF |

LOCATION MAP

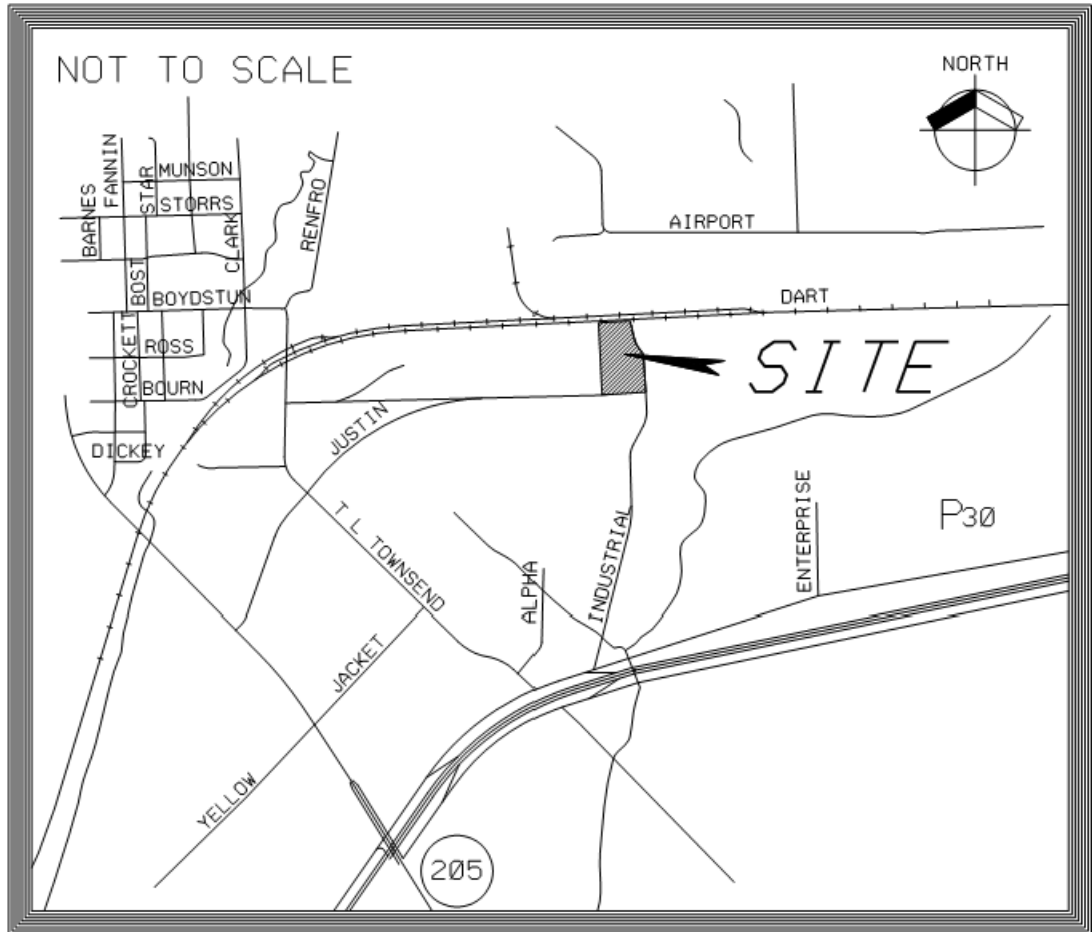

OWNER:
ALVAPLAST US, INC. / SPR PACKAGING
CONTACT: CAROLINA MOLINA
1480 JUSTIN ROAD
ROCKWALL, TX 75087
469-402-1232

ARCHITECT:
PROSS DESIGN GROUP, INC.
CONTACT: BOBBY PROSS
5310 HARVEST HILL RD., SUITE 180
DALLAS, TX 75230
972-759-1400

CASE NO: SP2019-000




DBR Project Number 193029.000

KR DY/HP DS NB -

drawn:
DBR checked
DBR
date
09/03/19

DESCRIPTION

DATE

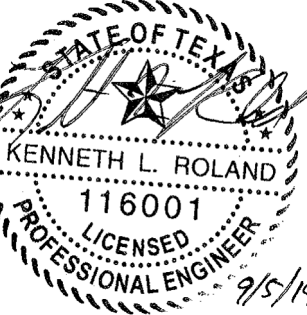


pross design group, incorporated
5310 Harvest Hill Road, Suite 180, Dallas, Texas 75230


SPR PACKAGING
OFFICE ADDITION
1480 JUSTIN RD., ROCKWALL, TEXAS


job no
1854
sheet

MEP1.1

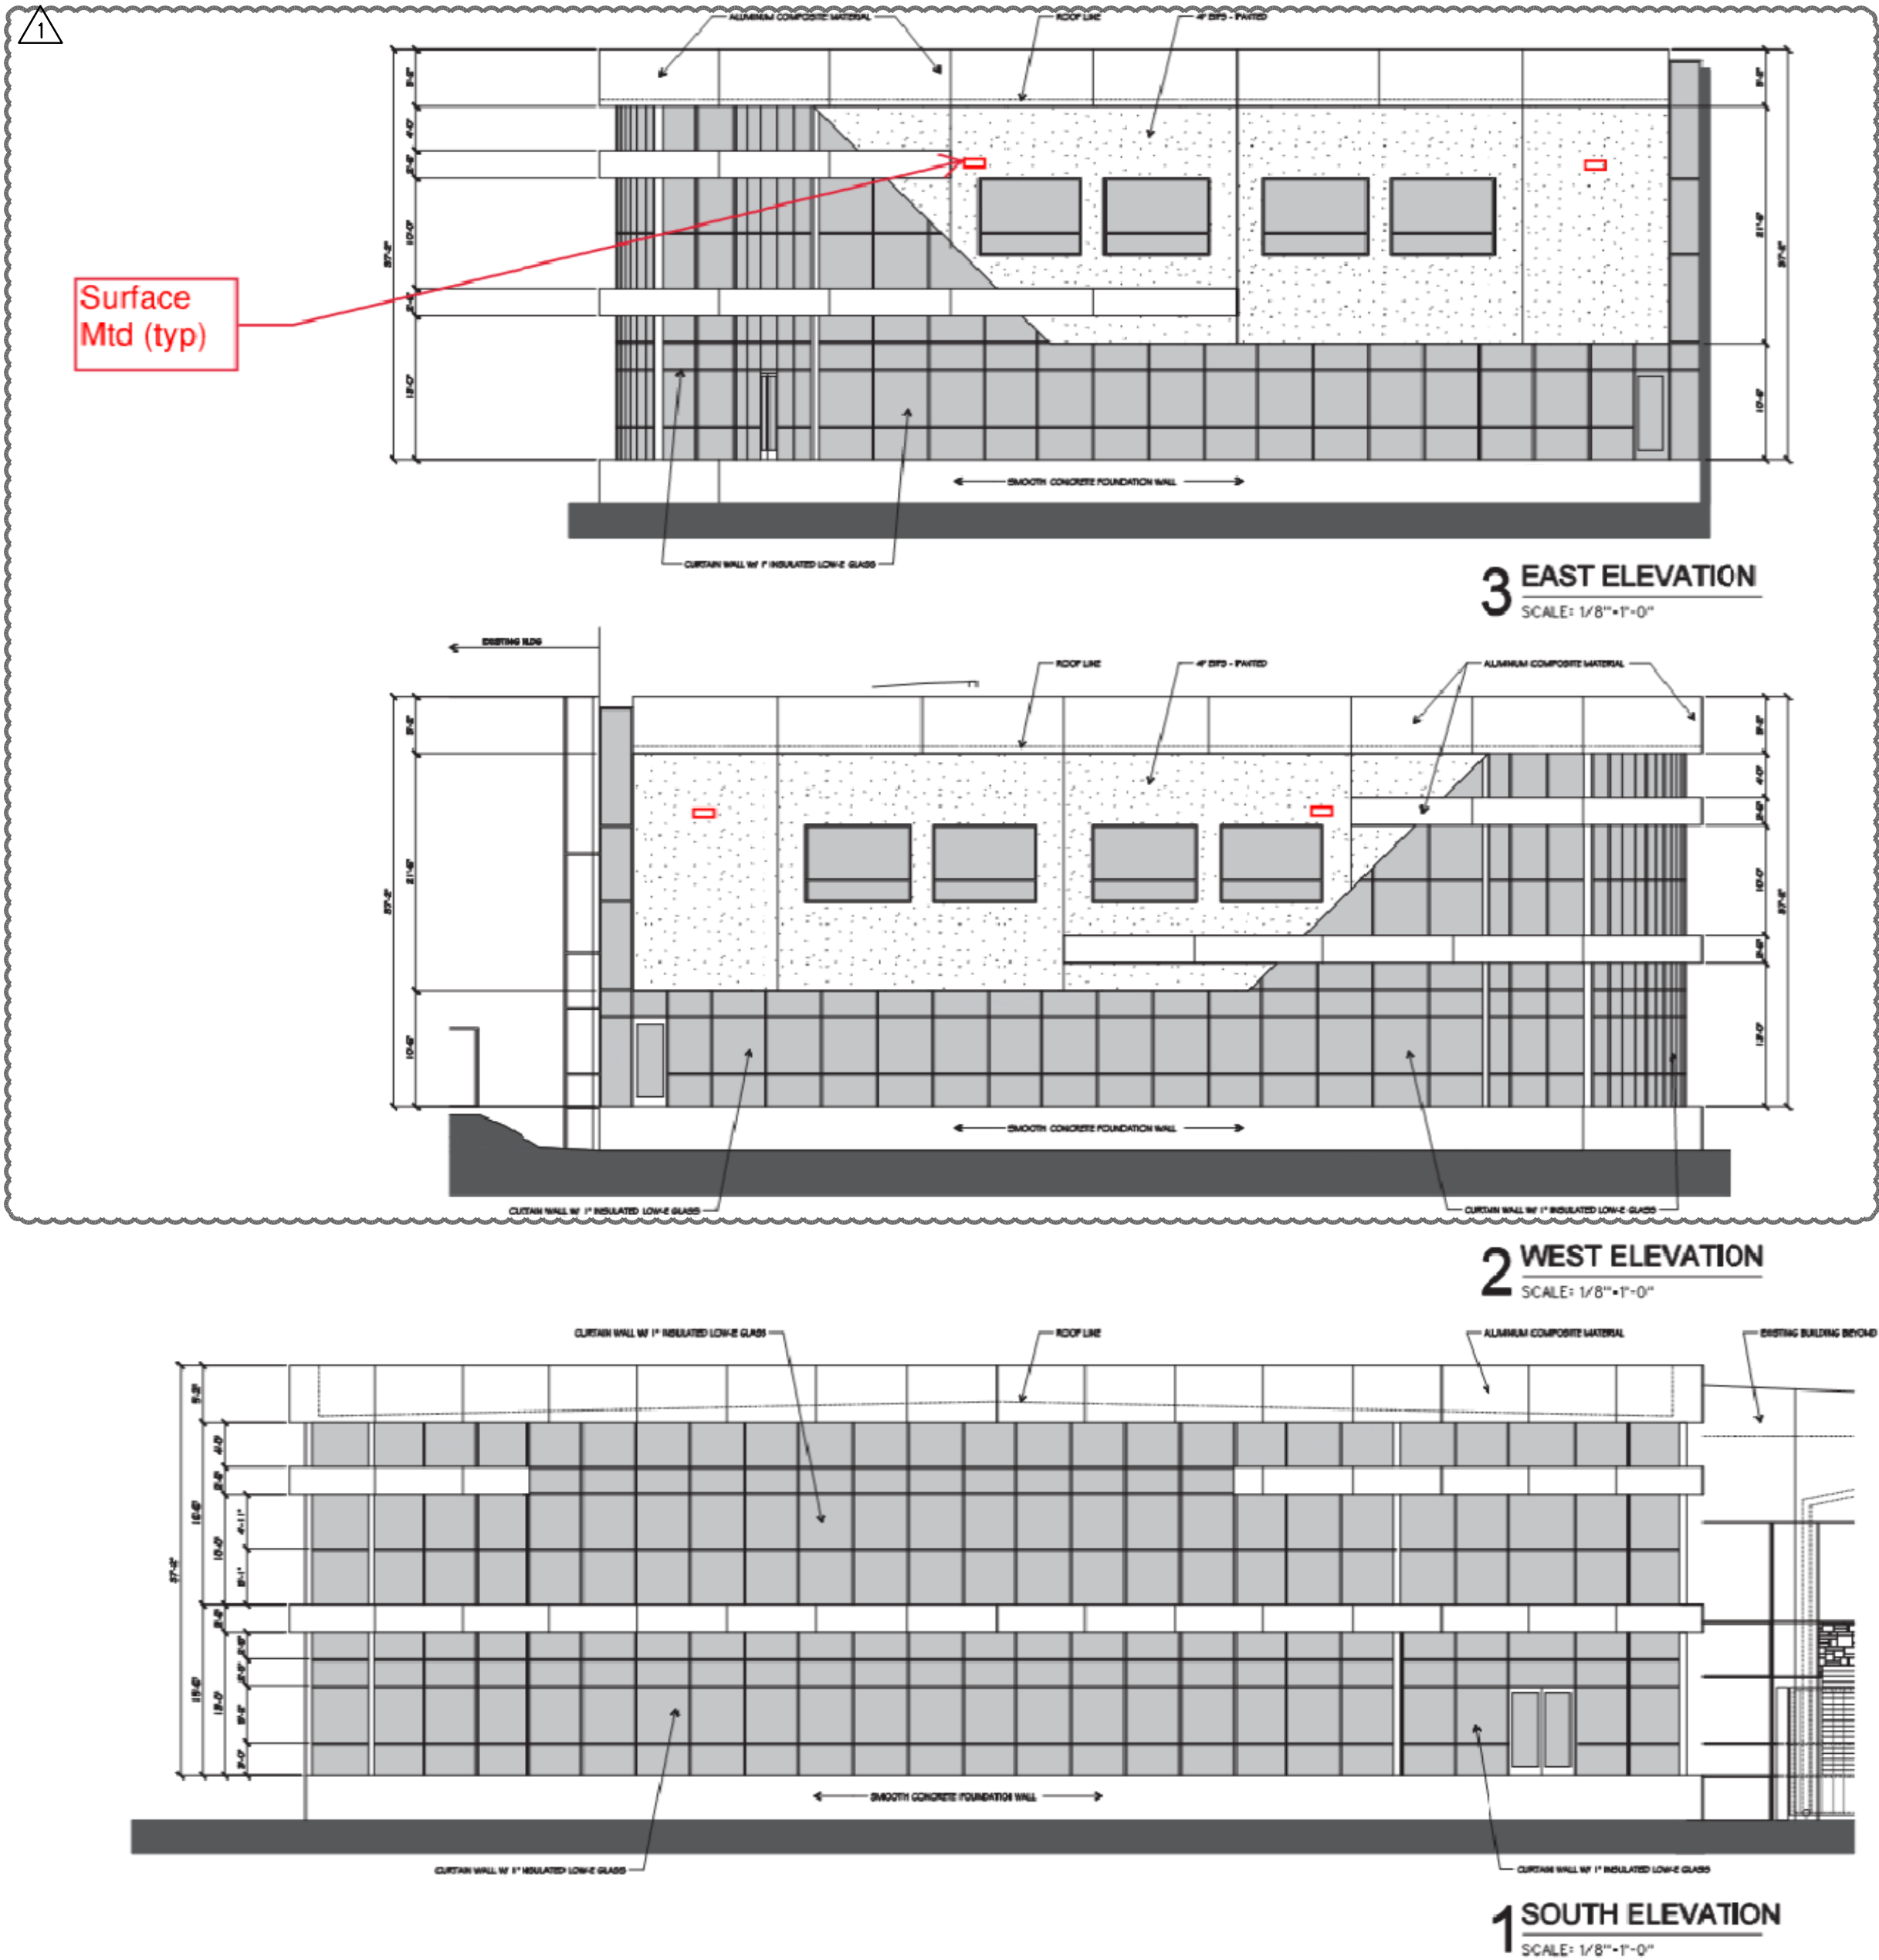

1 MEP LIGHTING WALL ELEVATIONS
MEP1.4 NOT TO SCALE

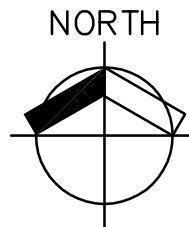




15301 Spectrum Drive, Suite 350
Addison, Texas 75001
214.217.9500 v 214.217.9505 f
TBPPE Firm Registration No. 2234

DBR Project Number 193029.000

| | | | | |
|----|-------|----|----|---|
| KR | DY/HP | DS | NB | - |
|----|-------|----|----|---|

SPR
PACKAGING
OFFICE ADDITION
1480 JUSTIN RD., ROCKWALL, TEXAS

pross design group, incorporated
2010 Harvest Hill Road, Suite 100, Dallas, Texas 75220 972.77281400

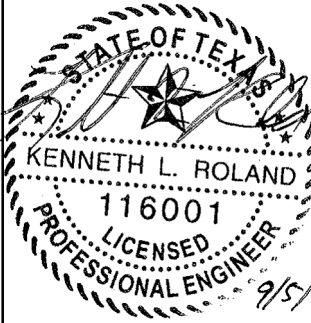


| # | DATE | DESCRIPTION |
|---|------|-------------|
| | | |
| | | |
| | | |
| | | |

drawn: DBR
checked: DBR
date: 09/03/19

job no 1854
sheet

MEP1.4

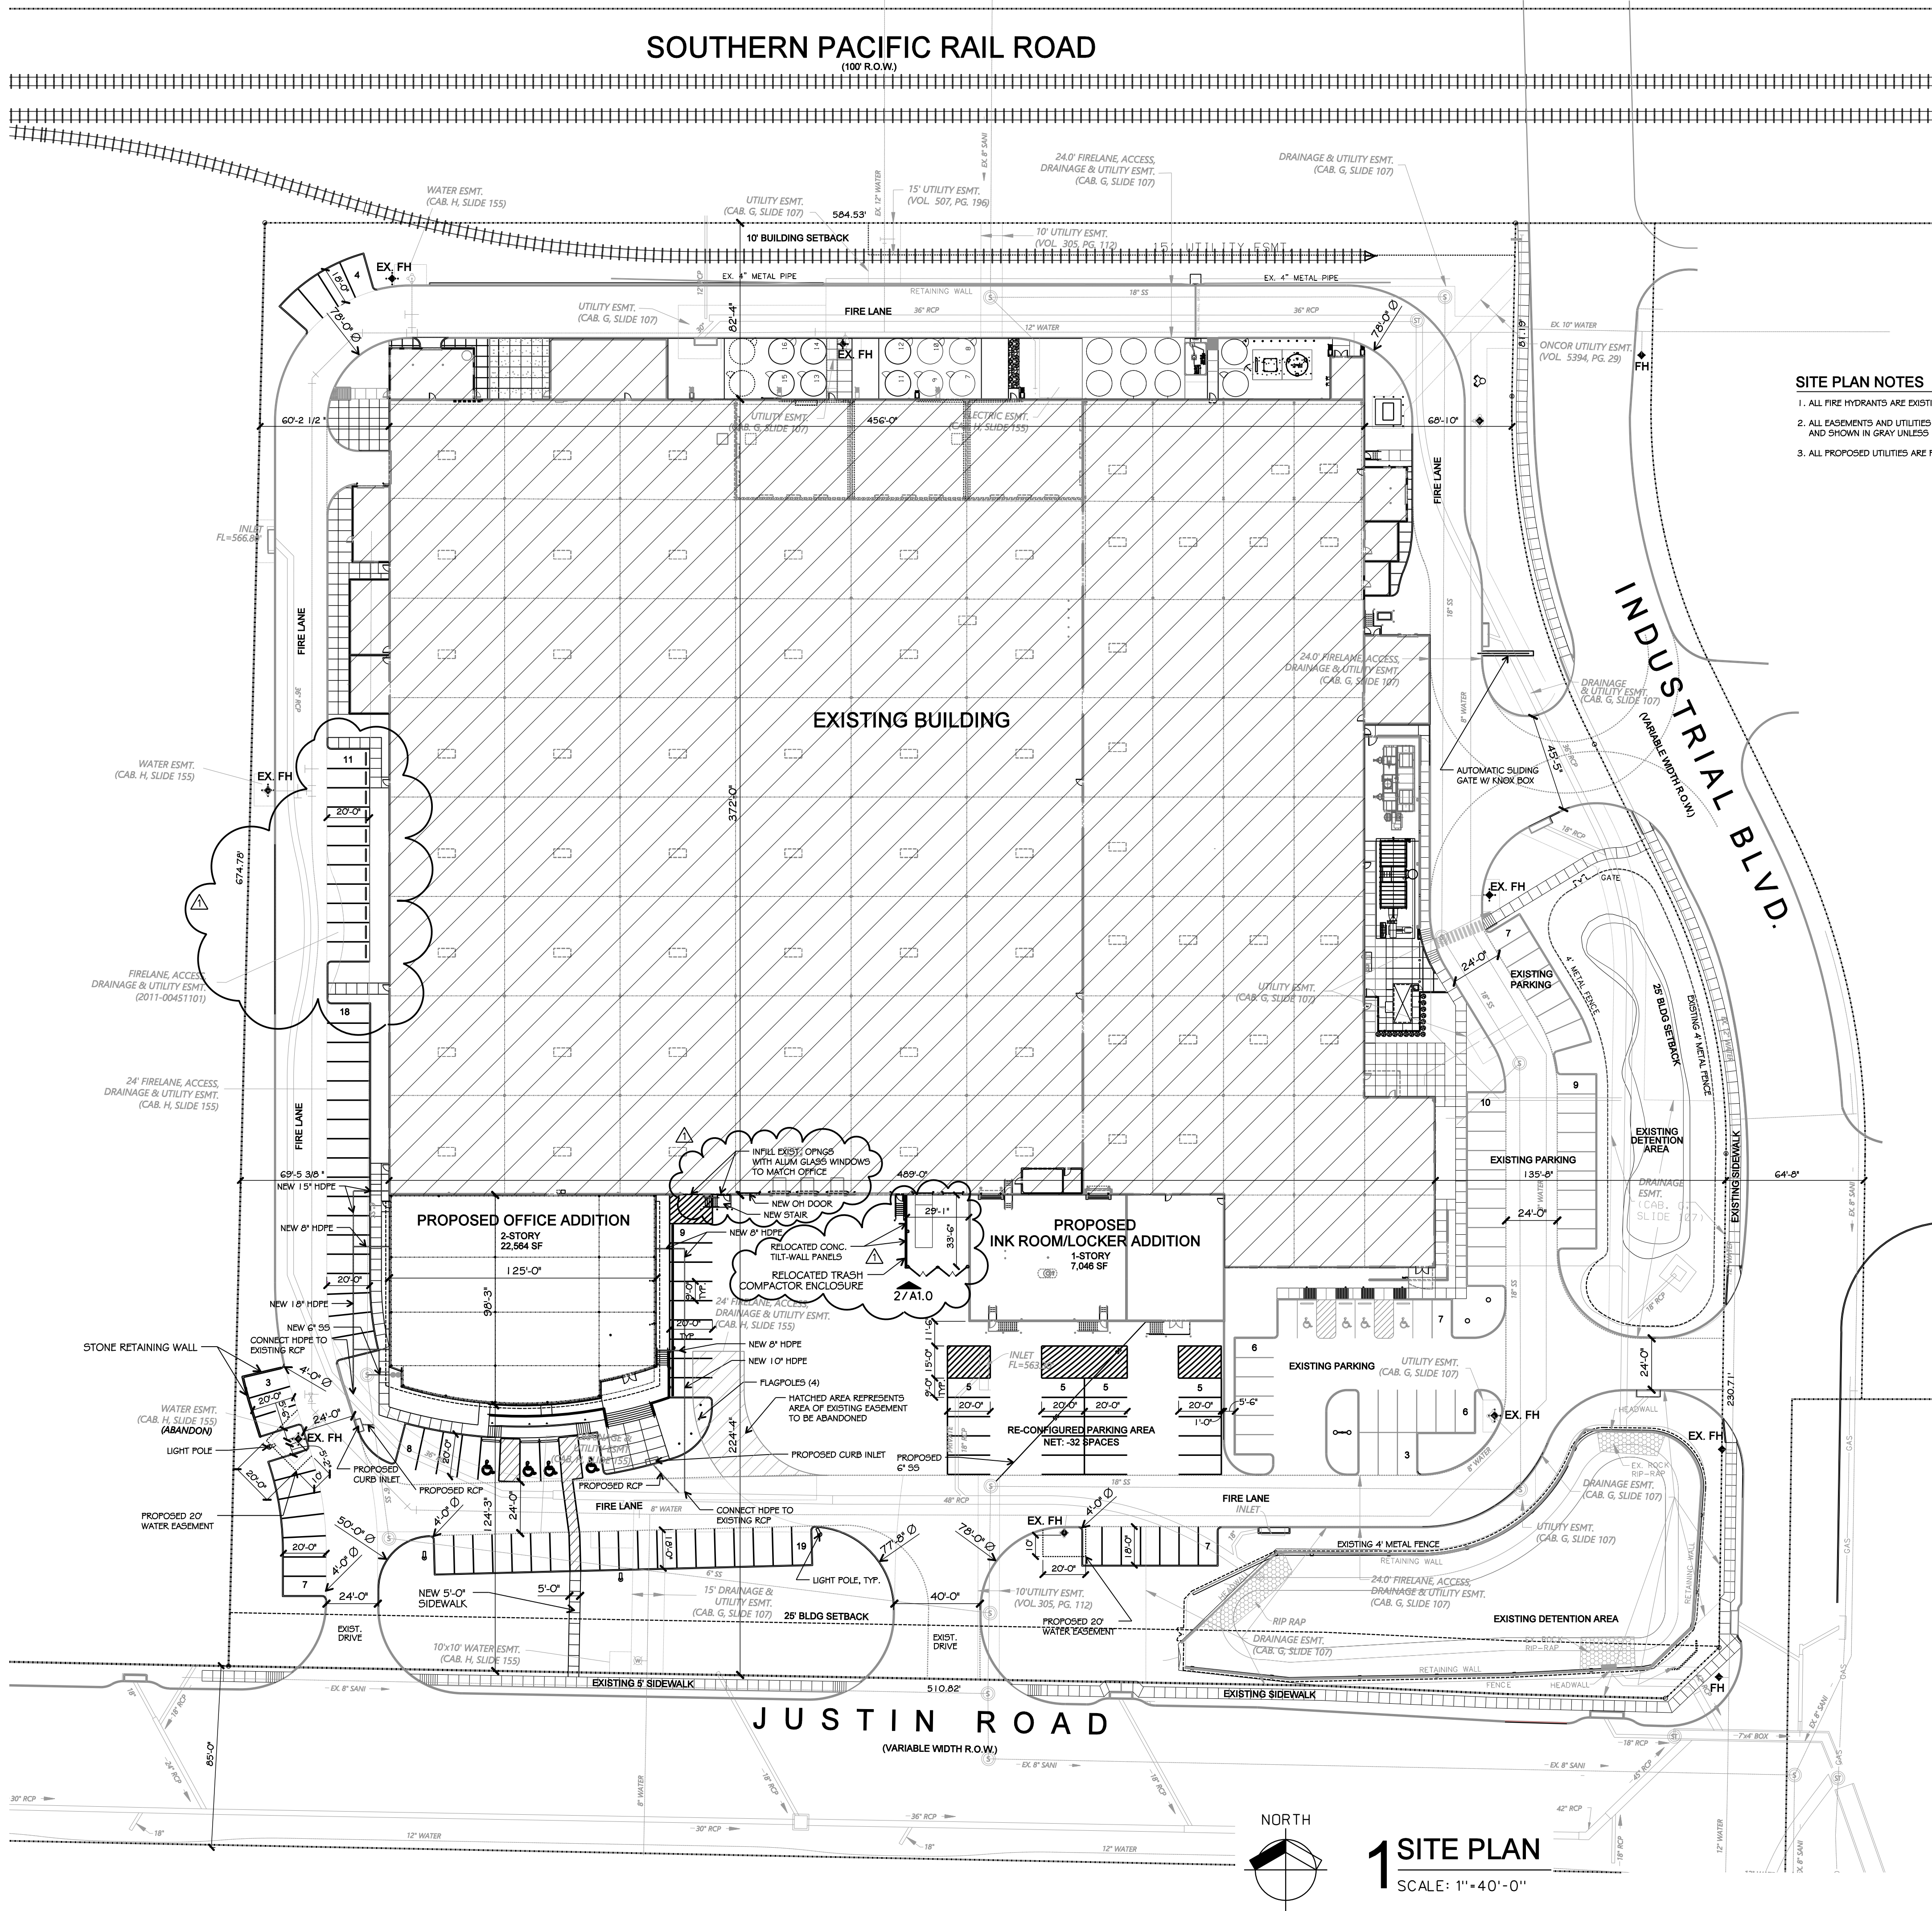

- SITE PLAN NOTES**
1. ALL FIRE HYDRANTS ARE EXISTING TO REMAIN.
 2. ALL EASEMENTS AND UTILITIES ARE EXISTING AND SHOWN IN GRAY UNLESS NOTED OTHERWISE.
 3. ALL PROPOSED UTILITIES ARE PRIVATE.

PROJECT DATA

| | |
|----------------------------------|---------------------------|
| ZONING: | LIGHT INDUSTRIAL |
| PROPOSED LAND USE: | WAREHOUSE, MANUF., OFFICE |
| SITE AREA: | 10.18 AC |
| | 443,480.8 SF |
| BUILDING AREA: | |
| EXISTING BUILDING: | 188,516 SF |
| OFFICE ADDITION: | |
| FIRST FLOOR: | 11,828 SF |
| SECOND FLOOR: | 10,936 SF |
| TOTAL: | 22,564 SF |
| INK ROOM / LOCKER ROOM ADDITION: | 7,046 SF |

PARKING DATA SUMMARY

| PROPOSED USE | AREA | FACTOR | REQ. SPACES |
|----------------------|------------|----------|-------------|
| EXISTING BUILDING | | | |
| OFFICE | 26,038 SF | EXISTING | - |
| MANUFACTURING | 18,805 SF | EXISTING | - |
| WAREHOUSE | 143,673 SF | EXISTING | - |
| PROPOSED ADDITION | | | |
| OFFICE (2-STORIES) | 22,564 SF | 1:300 | 75 |
| INK ROOM (WAREHOUSE) | 7,046 SF | 1:1000 | 7 |


| | | | |
|----------------------------------|--|--|----|
| TOTALS | | | |
| - REQUIRED FOR ADDITIONS | | | 82 |
| - PROVIDED WITH ADDITIONS | | | 54 |
| TOTAL PARKING VARIANCE REQUESTED | | | 28 |
| ACCESSIBLE PARKING REQUIREMENTS | | | |
| - REQUIRED FOR OFFICE ADDITION | | | *4 |
| - PROVIDED FOR OFFICE ADDITION | | | 4 |

*BASED ON NEW PLUS EXISTING PARKING THAT WILL BE ASSOCIATED WITH THE PARKING LOT SERVING THIS ADDITION

AMENDED SITE PLAN PARKING

| | |
|---|-------------|
| TOTAL SITE PARKING FROM APPROVED SITE PLAN DATED 09/06/19 | 151 SPACES |
| TOTAL SITE PARKING FOR THIS AMENDED SITE PLAN | *154 SPACES |


*ADDITIONAL PARKING ADDED AT MODIFIED WEST DRIVE PARKING AREA.

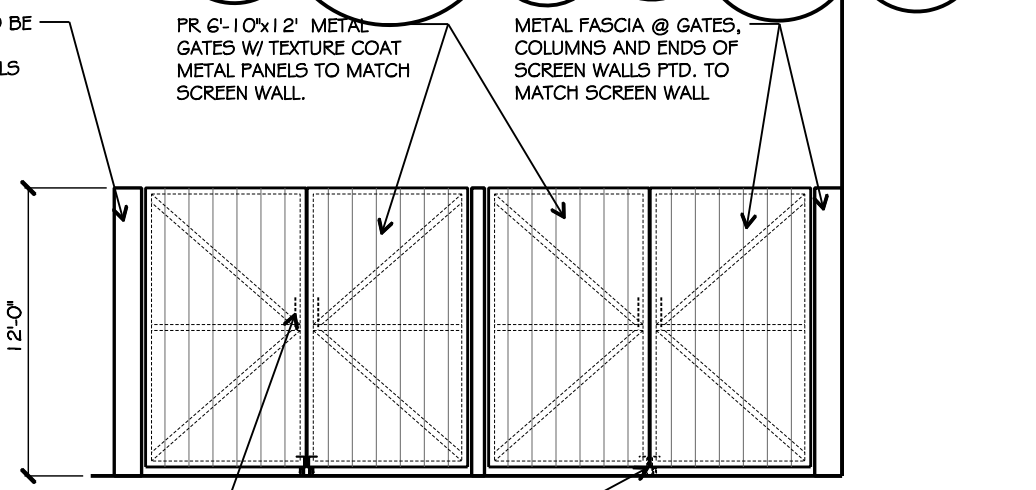

2 COMPACTOR ENCLOSURE

SCALE: 1/8" = 1'-0"

LOCATION MAP

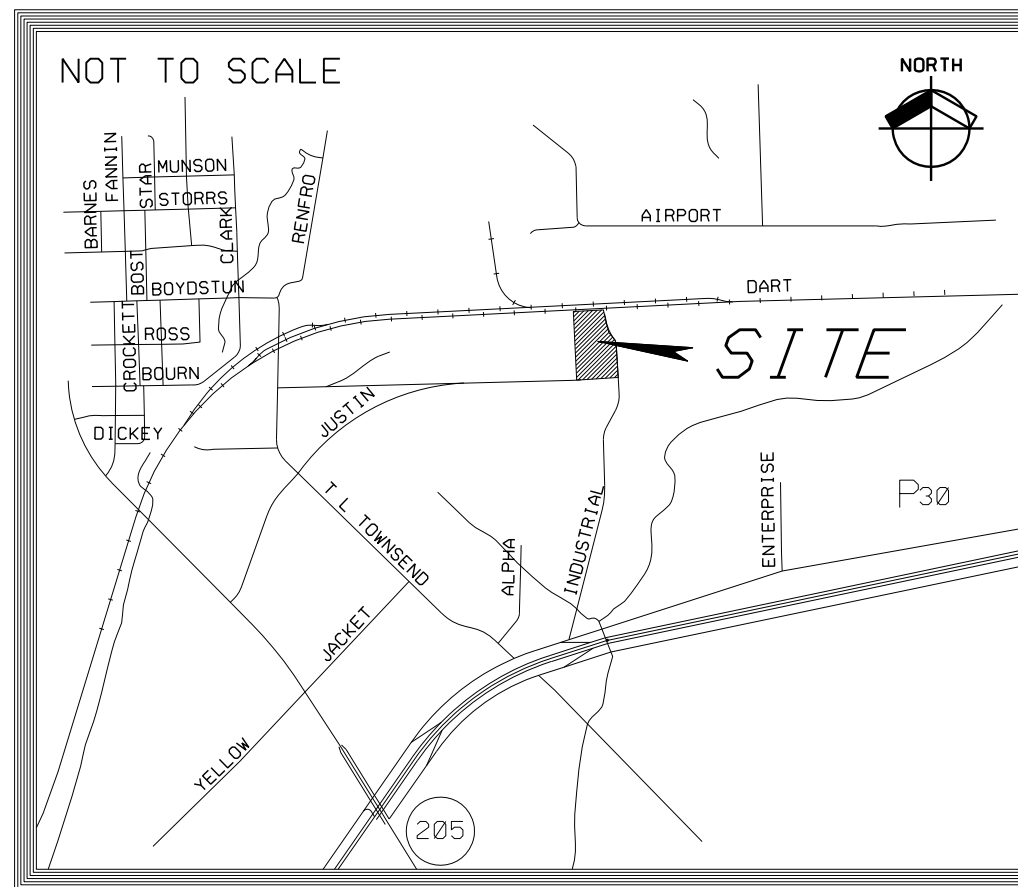

SITE PLAN SIGNATURE BLOCK

APPROVED: I hereby certify that the above and foregoing site plan for a development in the City of Rockwall, Texas, was approved by the Planning & Zoning Commission of the City of Rockwall on the ____ day of ____ 2020.

WITNESS OUR HANDS, this ____ day of ____ 2020.

Planning & Zoning Commission, Chairman Director of Planning and Zoning

OWNER:
ALVAPLAST US, INC. / SPR PACKAGING
CONTACT: CAROLINA MOLINA
1480 JUSTIN ROAD
ROCKWALL, TX 75087
469-402-1232

ARCHITECT:
PROSS DESIGN GROUP, INC.
CONTACT: BOBBY PROSS
5310 HARVEST HILL RD., SUITE 180
DALLAS, TX 75230
972-759-1400

CASE NO: SP2020-007

Drawn:
DAN SOKOL
ROBERT PROSS
COT: e
09/08/19

| # | DATE | DESCRIPTION |
|---|------------|-----------------------------|
| 1 | 03/20/2020 | AMENDED SITE PLAN SUBMITTAL |



04/03/2020

pross design group, incorporated
5310 Harvest Hill Road, Suite 180, Dallas, Texas 75230
972-759-1400

SPR PACKAGING
OFFICE ADDITION
1480 JUSTIN RD., ROCKWALL, TEXAS

job no
1854
sheet
A1.0



May 5, 2020

ATTN:

DAVID MORALES
5310 HARVEST HILL, SUITE 180
DALLAS, TX 75230


RE: ADMINISTRATIVE SITE PLAN (SP2020-007), 1480 Justin Rd.

Dear Applicant:

This letter serves to notify you that the above mentioned case has been approved administratively by staff on 04/06/2020. Please note that final engineering and building plan approvals are required before issuance of a building permit.

Please contact the City of Rockwall Planning staff at (972) 771-7745 or at the address below with any questions or concerns regarding this matter.

Sincerely,



David Gonzales, AICP
Planning and Zoning Manager
Planning & Zoning Department
City of Rockwall, Texas