

PLANNING & ZONING CASE NO.

PLANNING & ZONING FEE

PLATTING APPLICATION

MASTER PLAT PRELIMINARY PLAT FINAL PLAT REPLAT

AMENDING OR MINOR PLAT PLAT REINSTATEMENT REQUEST

SITE PLAN APPLICATION

SITE PLAN

AMENDED SITE PLAN/ELEVATIONS/LANDSCAPING

ZONING APPLICATION

ZONING CHANGE SPECIFIC USE PERMIT PD DEVELOPMENT PLAN

OTHER APPLICATION

TREE REMOVAL

VARIANCE REQUEST/SPECIAL EXCEPTIONS

RECORD OF RECOMMENDATIONS, VOTING RECORDS, AND CONDITIONS OF APPROVAL

ARCHITECTURE REVIEW BOARD	CITY COUNCIL READING #2
PLANNING AND ZONING COMMISSION	CONDITIONS OF APPROVAL
CITY COUNCIL READING #1	NOTES





DEVELOPMENT APPLICATION

City of Rockwall Planning and Zoning Department 385 S. Goliad Street Rockwall, Texas 75087

PLANNING & ZONING CASE NO.
NOTE: THE APPLICATION IS NOT CONSIDERED ACCEPTED BY THE CITY UNTIL THE PLANNING DIRECTOR AND CITY ENGINEER HAVE SIGNED BELOW.
DIRECTOR OF PLANNING:
CITY ENGINEED.

		Lint	ENGINEER:		
PLEASE CHECK THE	APPROPRIATE BOX BELOW TO INDICATE THE TYPE (OF DEVELOPMENT RE	QUEST [SELECT ONLY ONE BOX]:		
☐ PRELIMINARY ☐ FINAL PLAT (\$3 ☐ REPLAT (\$300.) ☐ AMENDING OR ☐ PLAT REINSTA SITE PLAN APPLI ☒ SITE PLAN (\$25	(\$100.00 + \$15.00 ACRE) 1 PLAT (\$200.00 + \$15.00 ACRE) 1 300.00 + \$20.00 ACRE) 1 00 + \$20.00 ACRE) 1 MINOR PLAT (\$150.00) TEMENT REQUEST (\$100.00)	☐ ZONING CH/ ☐ SPECIFIC US ☐ PD DEVELO OTHER APPLIC ☐ TREE REMC ☐ VARIANCE F NOTES: 1: IN DETERMINING 1 PER ACRE AMOUNT. 2: A \$1,000.00 FEE	ZONING APPLICATION FEES: ☐ ZONING CHANGE (\$200.00 + \$15.00 ACRE) ☐ SPECIFIC USE PERMIT (\$200.00 + \$15.00 ACRE) ☐ PD DEVELOPMENT PLANS (\$200.00 + \$15.00 ACRE) ☐ OTHER APPLICATION FEES: ☐ TREE REMOVAL (\$75.00) ☐ VARIANCE REQUEST/SPECIAL EXCEPTIONS (\$100.00) ☐ VARIANCE REQUEST/SPECIAL EXCEPTIONS (\$100.00) ☐ NOTES: ☐: IN DETERMINING THE FEE, PLEASE USE THE EXACT ACREAGE WHEN MULTIPLYING BY THE PER ACRE AMOUNT. FOR REQUESTS ON LESS THAN ONE ACRE, ROUND UP TO ONE (1) ACRE. 2: A \$1,000.00 FEE WILL BE ADDED TO THE APPLICATION FEE FOR ANY REQUEST THAT INVOLVES CONSTRUCTION WITHOUT OR NOT IN COMPLIANCE TO AN APPROVED BUILDING		
PROPERTY INFO	ORMATION [PLEASE PRINT]				
ADDRES					
SUBDIVISIO	N Quail Hollow Phase 2		LOT	BLOCK	
GENERAL LOCATIO	Northeast Corner of Hays Lane	and Quail Rur	Road		
ZONING SITE P	LAN AND PLATTING INFORMATION [PLEA	SE PRINTI			
CURRENT ZONIN		CURRENT USE			
PROPOSED ZONIN	G (PROPOSED USE			
ACREAG	E 42.742 LOTS [CURREN	тј	LOTS [PROPOSED]	111	
REGARD TO ITS RESULT IN THE	<u>D PLATS</u> : BY CHECKING THIS BOX YOU ACKNOWLEDGE APPROVAL PROCESS, AND FAILURE TO ADDRESS ANY OF DENIAL OF YOUR CASE.	F STAFF'S COMMENTS B	Y THE DATE PROVIDED ON THE DEV	ELOPMENT CALENDAR WILL	
	CANT/AGENT INFORMATION (PLEASE PRINT/C			REQUIRED]	
	Quail Hollow SF, LTD.		Corwin Engineering		
CONTACT PERSON	John Arnold	ADDRESS	CONTACT PERSON Chase Finch		
AUURE55	8214 Westchester Drive Ste. 900	ADDRESS	200 W. Belmont St	e. E	
CITY, STATE & ZIP	Dallas, TX 75202	CITY, STATE & ZIP	Allen, Tx 75013		
PHONE	214-522-4945	PHONE	972-396-1200		
E-MAIL	jarnold@skorburgcompany.com	E-MAIL	cfinch@corwinengin	eering.com	
BEFORE ME, THE UNDE	ICATION [REQUIRED] ERSIGNED AUTHORITY, ON THIS DAY PERSONALLY APPEAR TION ON THIS APPLICATION TO BE TRUE AND CERTIFIED TH		ld [OWNER]	THE UNDERSIGNED, WHO	
S 1,110.00 WOOLL INFORMATION CONTAIN SUBMITTED IN CONJUNC	T I AM THE OWNER FOR THE PURPOSE OF THIS APPLICATION; TO COVER THE COST OF THIS APPLICATION, I TO COVER THE COST OF THIS APPLICATION, I TO COVER THE COST OF THIS APPLICATION, I BY SIGNING THIS APPLICATION, I AS THE WITHIN THIS APPLICATION TO THE PUBLIC. THE CITY TO AND SEAL OF OFFICE ON THIS THE 17 OWNER'S SIGNATURE TO FOR THE STATE OF TEXAS	HAS BEEN PAID TO THE CI' REE THAT THE CITY OF R IS ALSO AUTHORIZED AI SOCIATED OR IN RESPONS	TY OF ROCKWALL ON THIS THE // OCKWALL (I.E. "CITY") IS AUTHORIZED NO PERMITTED TO REPRODUCE ANY SE TO A REQUEST FOR PUBLIC THY OWN Brooke My Co	DAY OF AND PERMITTED TO PROVIDE COPYRIGHTED INFORMATION ATION. Ashtey-Ven Veerhis ommission Expires 2/1/2028 ry ID 134742171	
NOTARY PUBLIC IN AN	D FOR THE STATE OF TEXAS		MY COMMISSION EXPIRES	2/1/2028	

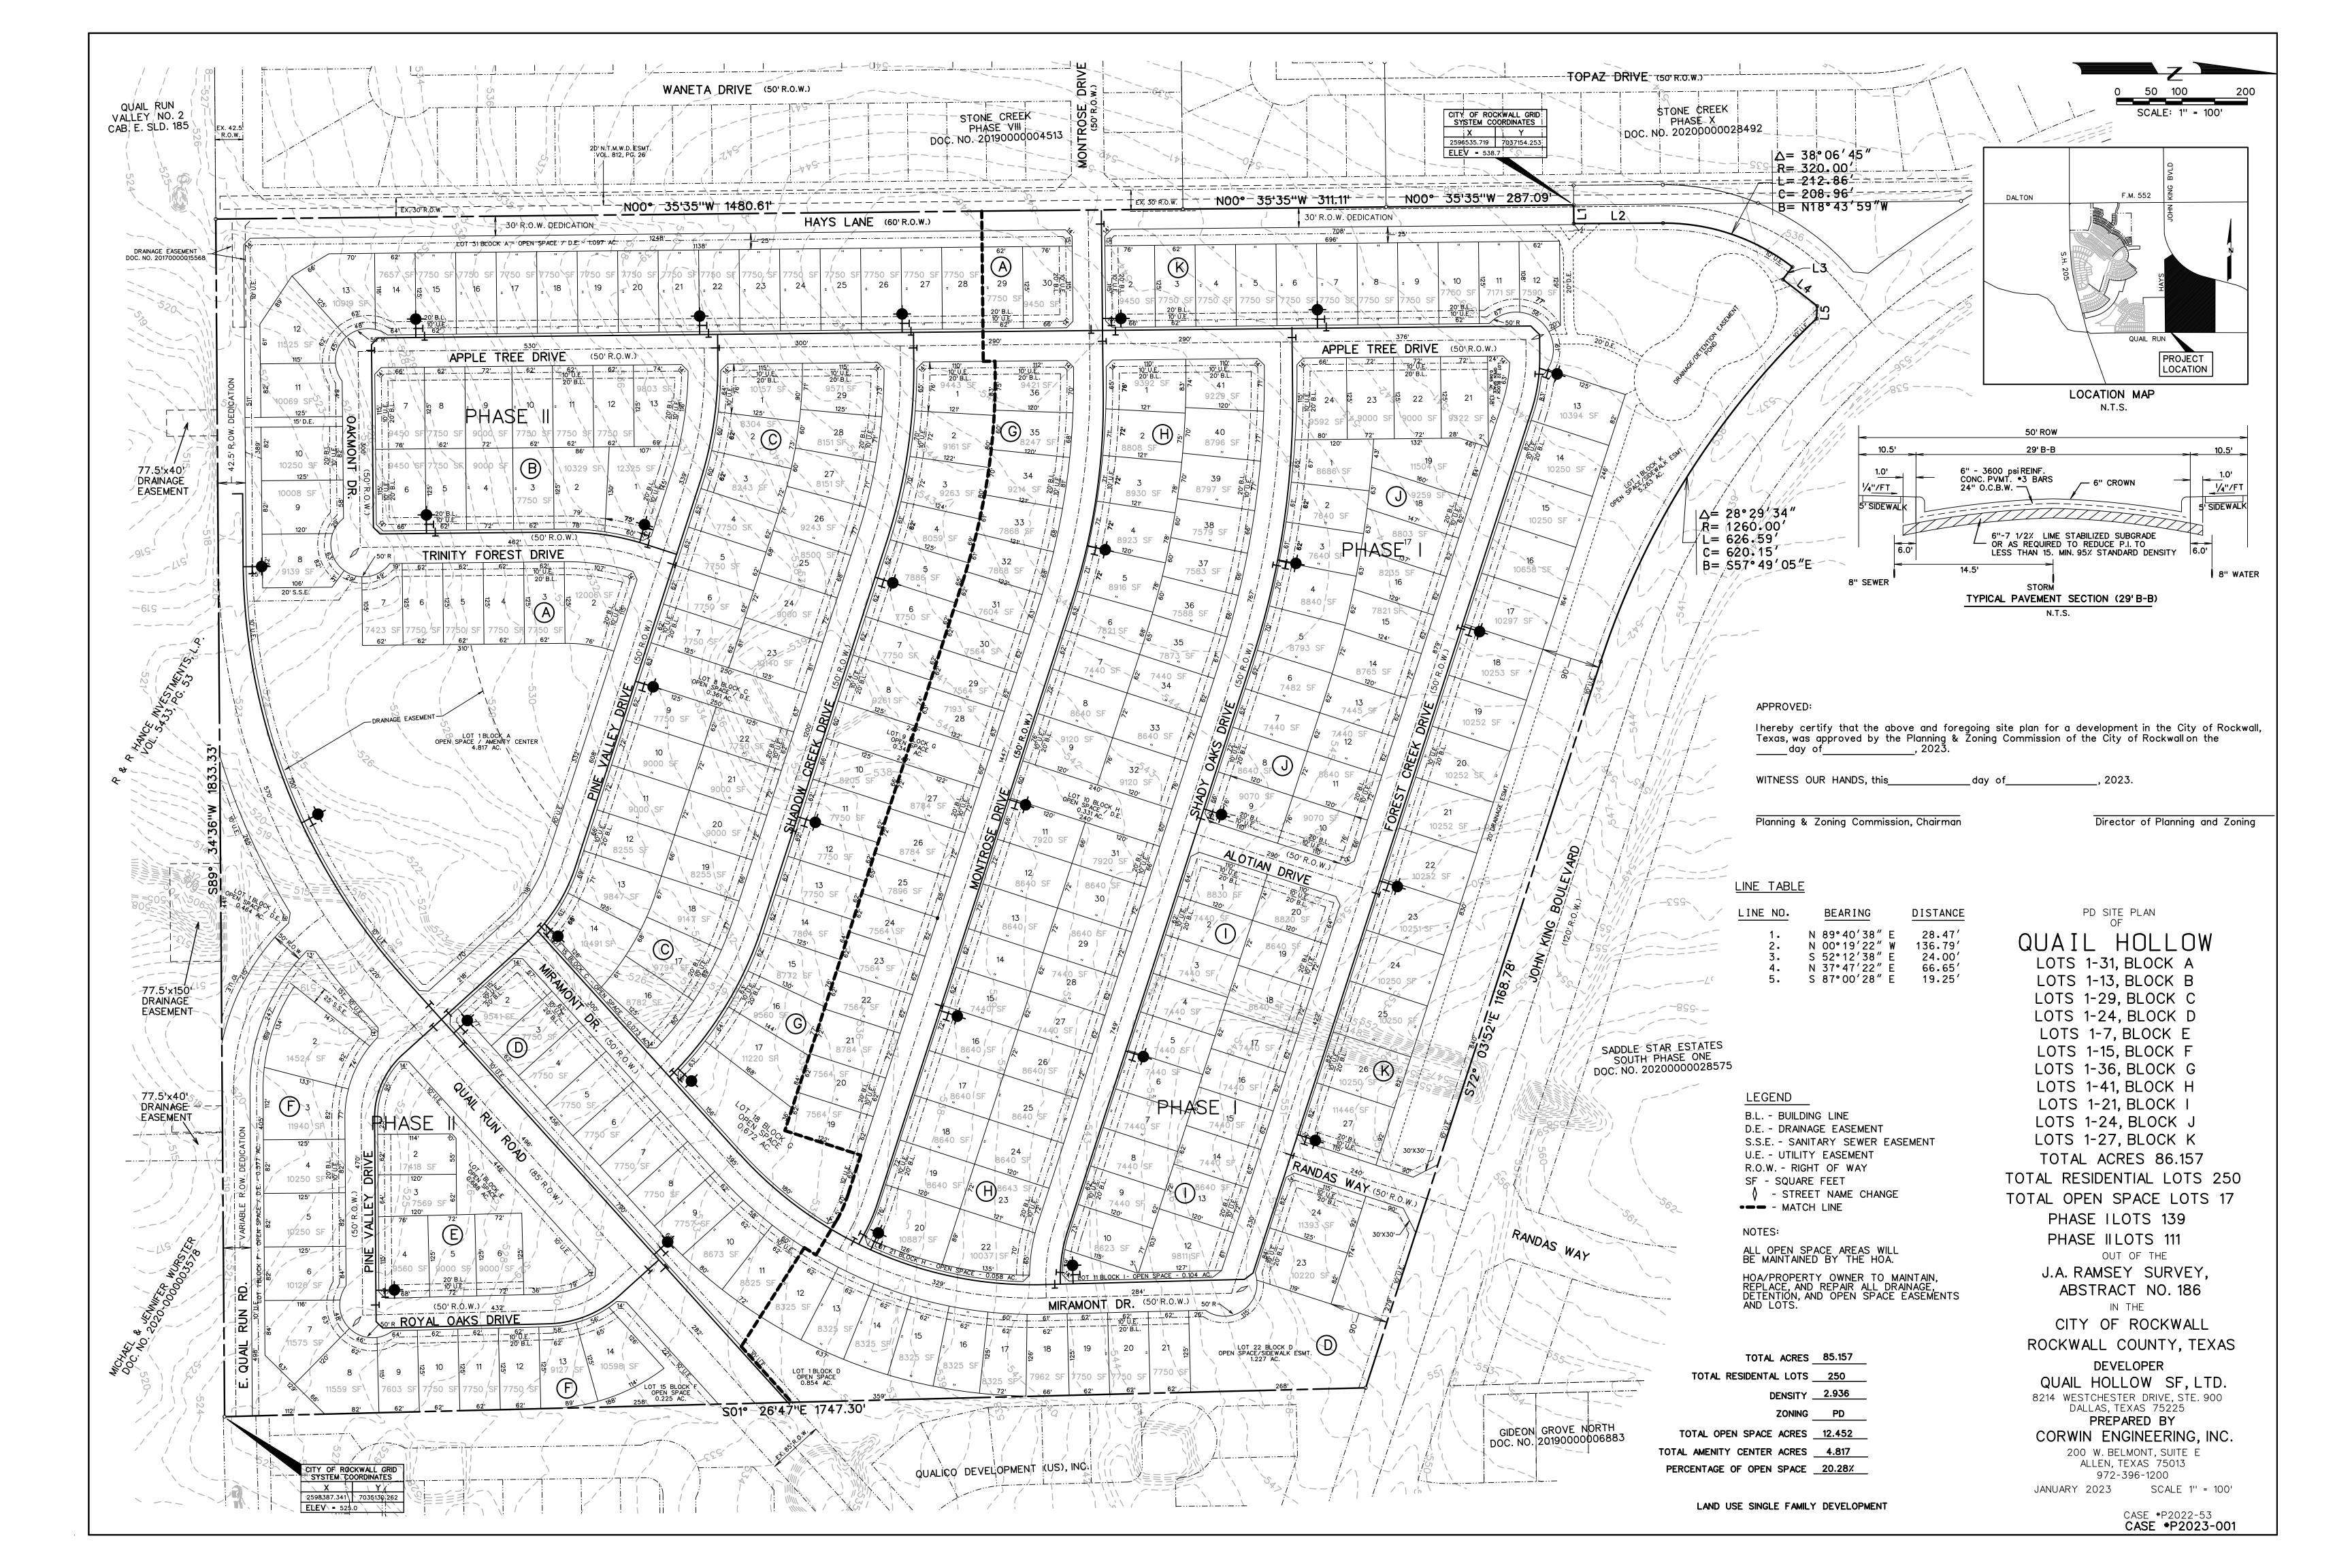

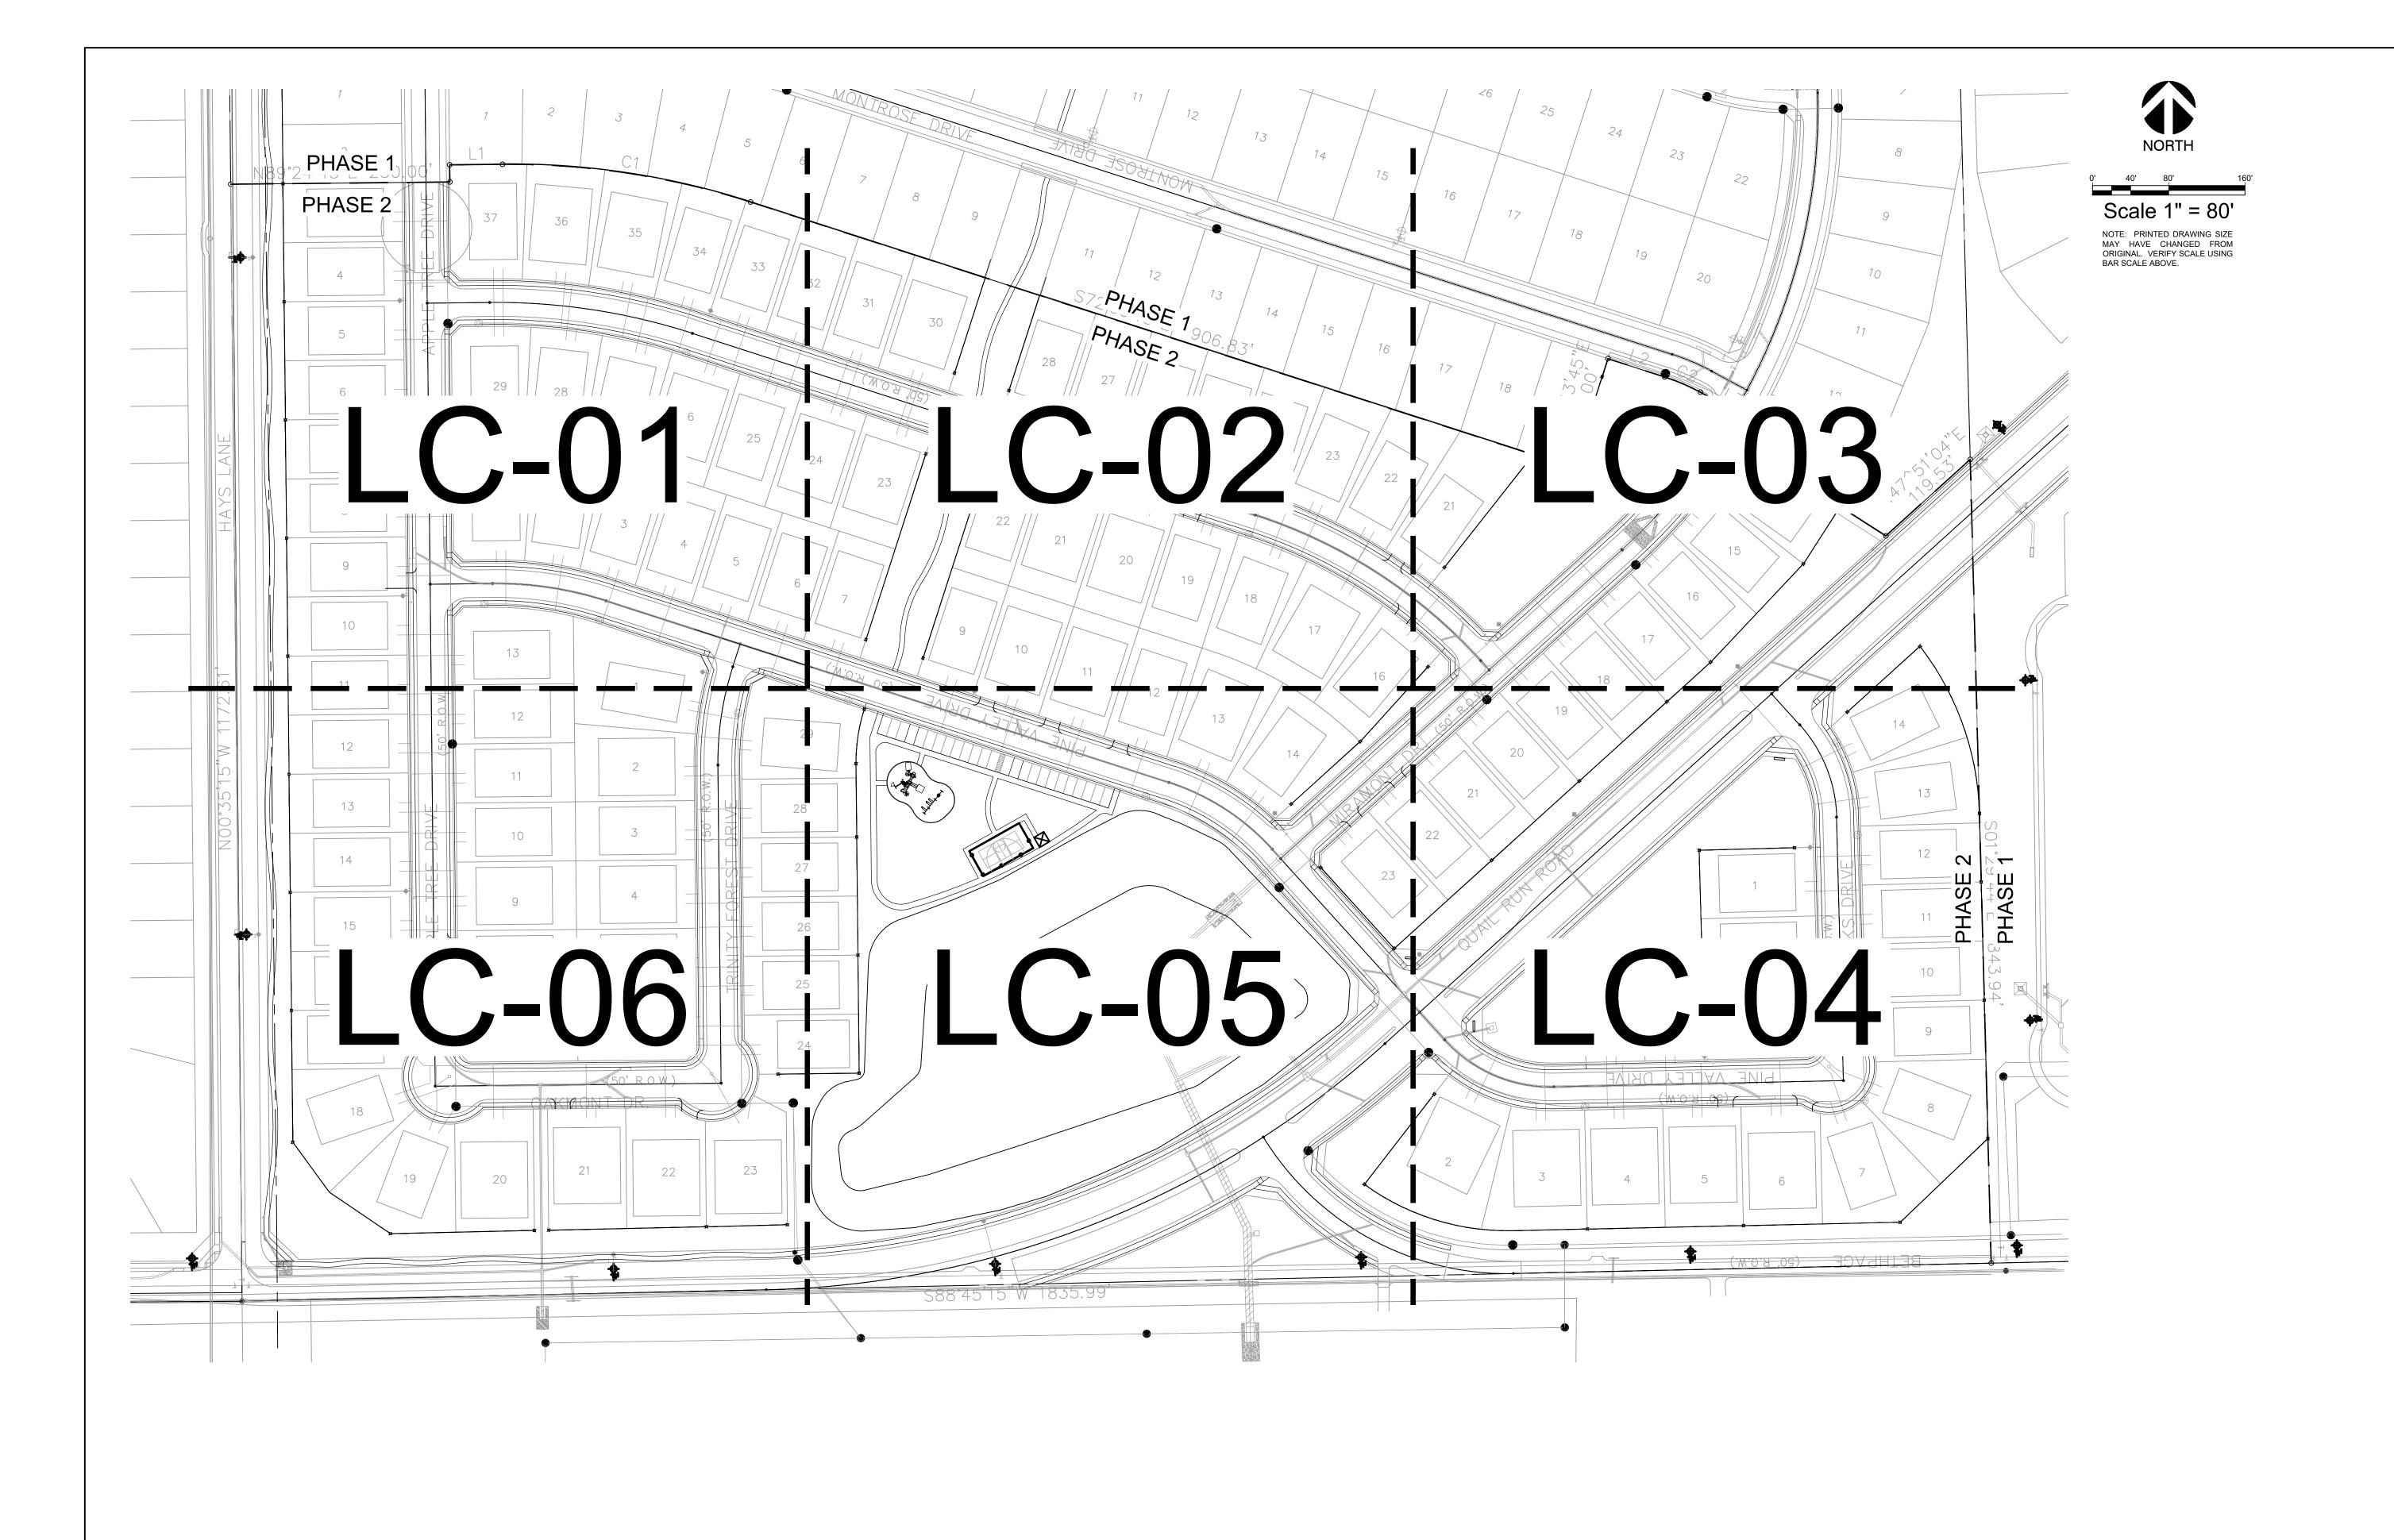



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MARY N. BATES TEXAS L.A. #3613 ISSUED ON: OCTOBER 04, 2024

Company
er Drive, Suite 900

Skorburg (8214 Westchester Dallas, Texas 75225

Quail Hollow Rockwall, TX

OVERALL HARDSCAPE PLAN


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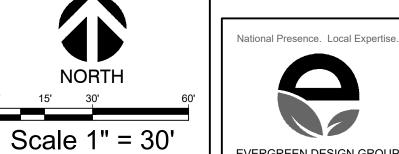
Project Number

 Date
 10/04/24

 Drawn By
 KB

I C-00



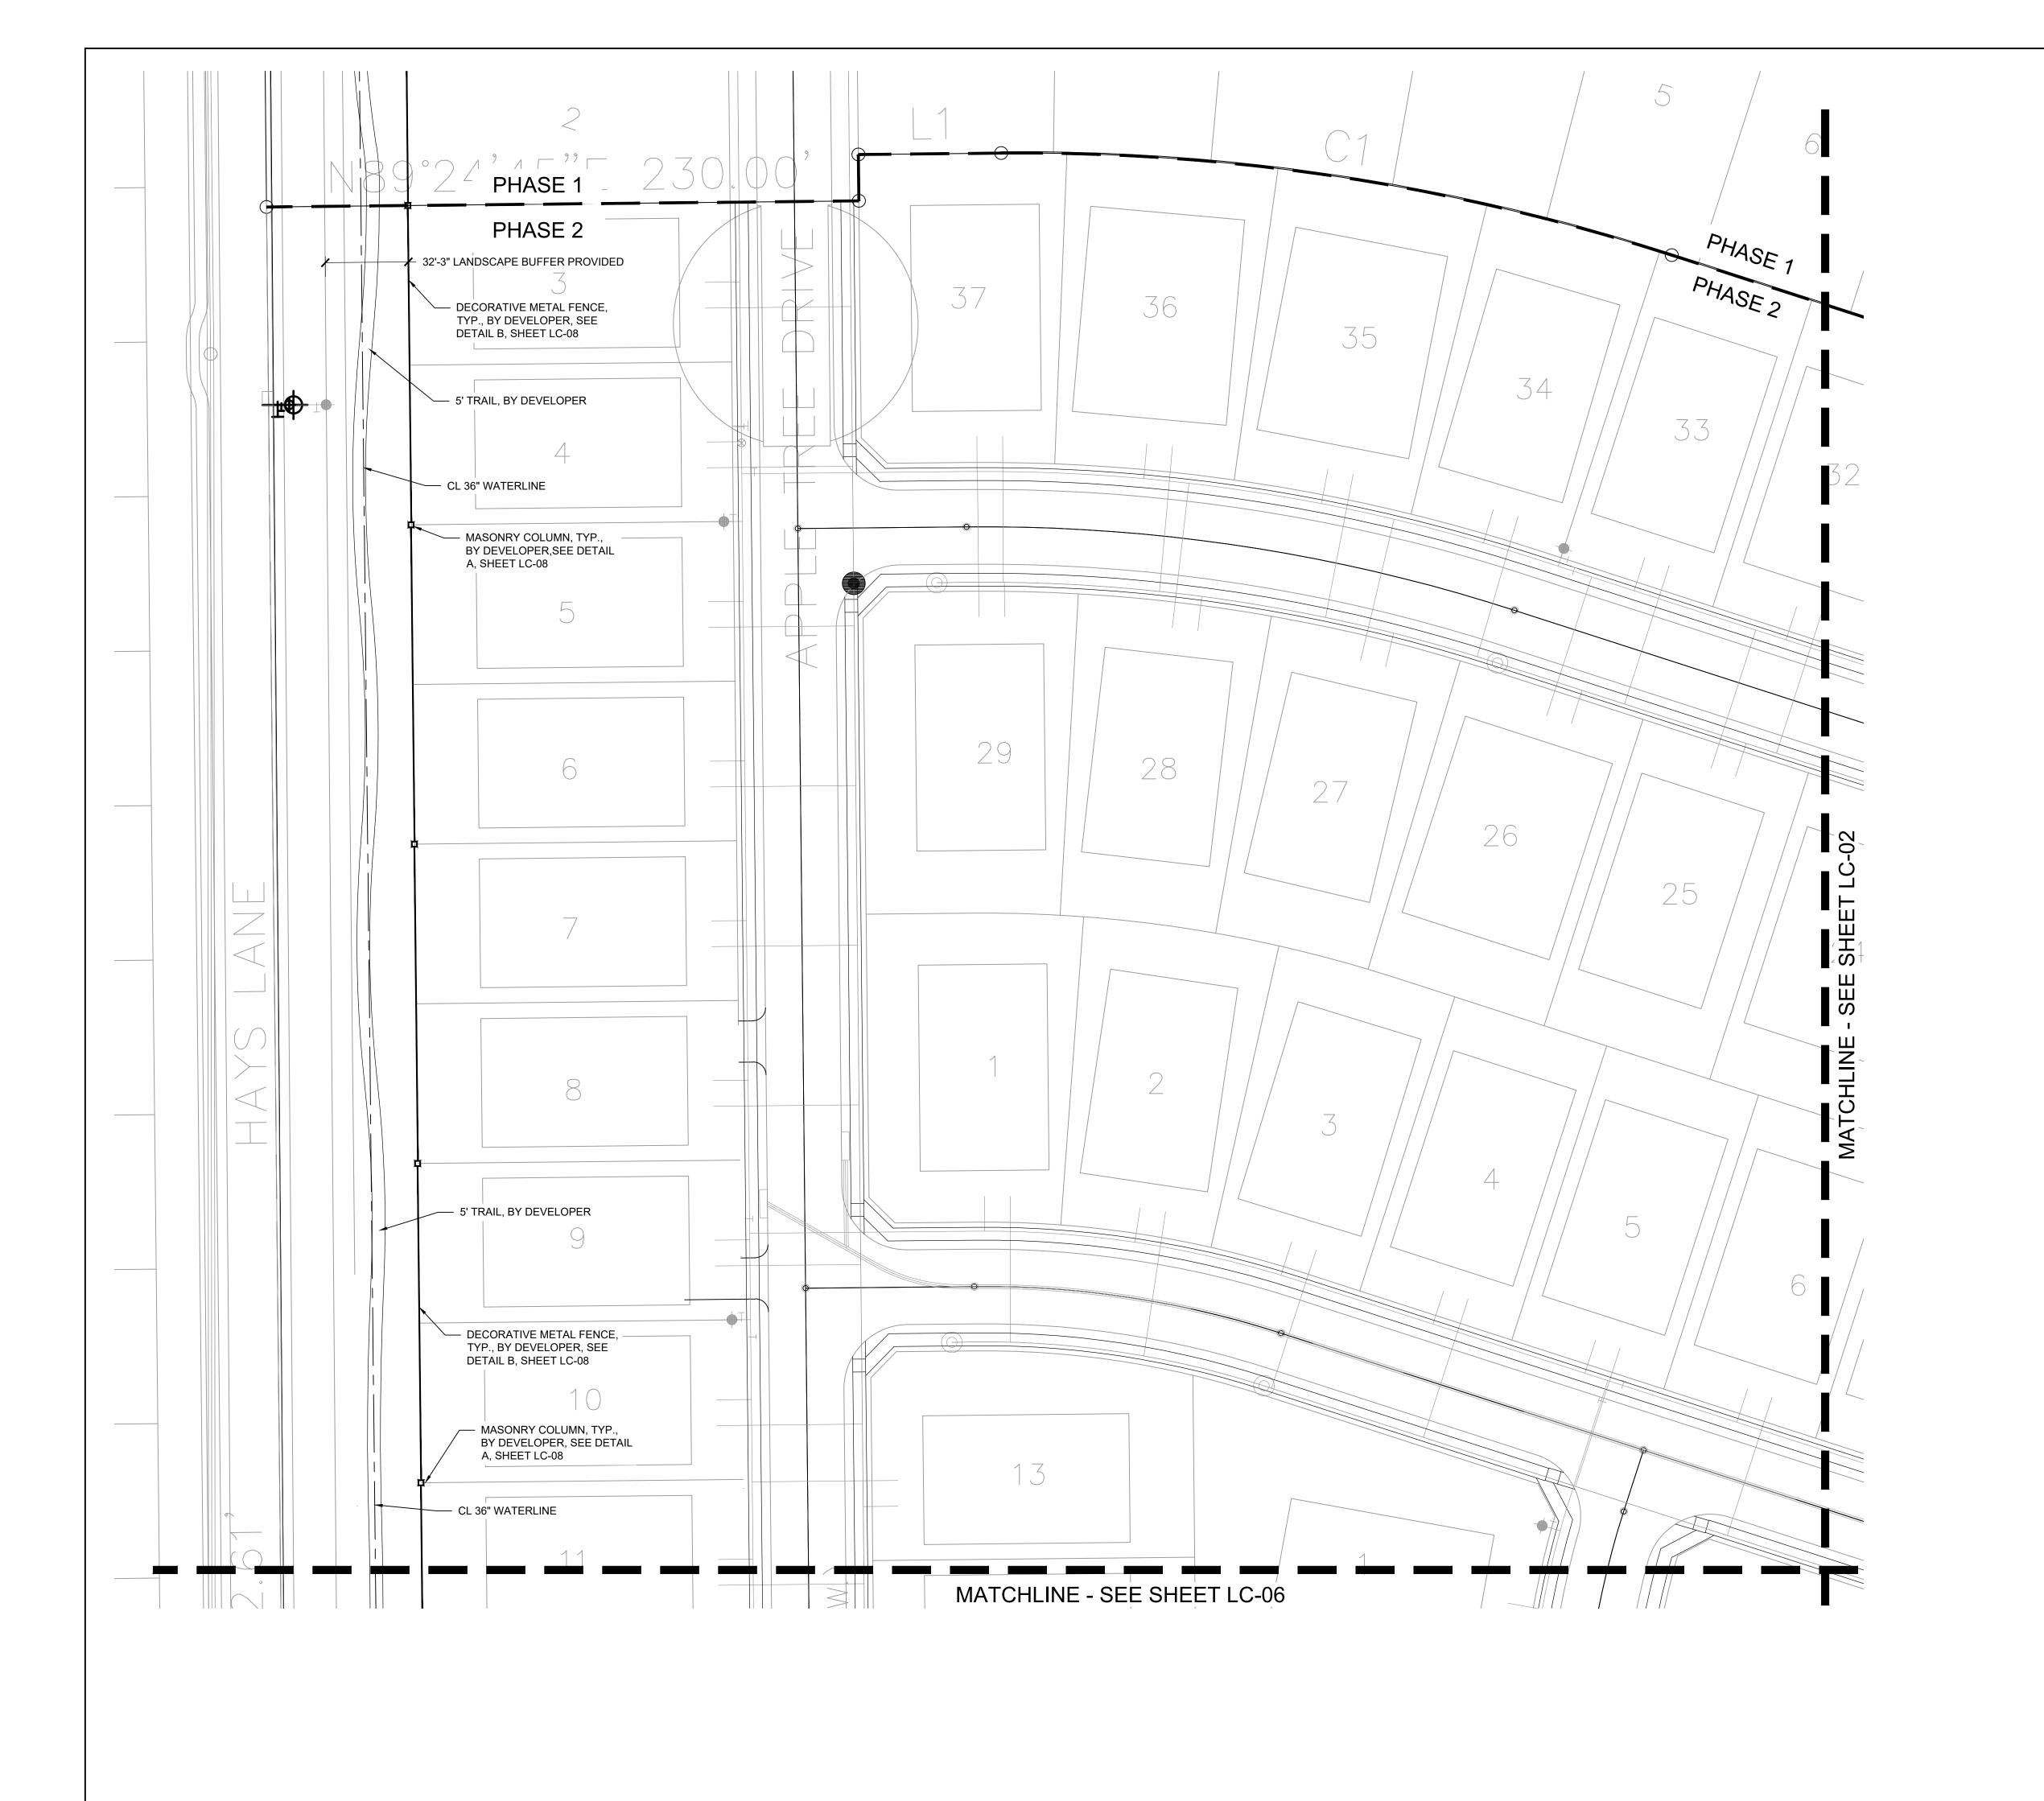

CONSTRUCTION LEGEND

2. EXPANSION JOINT WITH COLOR CAULK TO MATCH ADJACENT PAVEMENT. SEE DETAIL A, SHEET LC-07.

3. 4" CONCRETE PAD, LIGHT BROOM FINISH, NATURAL GRAY

4. PLAYGROUND EQUIPMENT, SEE DETAIL D, SHEET LC-08

5. PLAYGROUND SAFETY SURFACING - ENGINEERED WOOD

(7.) MULTI SPORT COURT. SEE DETAIL D, SHEET LC-07.

9. PRIMARY COLUMN. SEE DETAIL A, SHEET LC-08.

(10.) WROUGHT IRON FENCE W/ MASONRY COLUMN. SEE DETAIL A, SHEET LC-08.

MULCH; SEE DETAIL C, SHEET LC-08.

6.) SWINGS, SEE DETAIL D, SHEET LC-08.

(8.) ADA RAMP. SEE DETAIL C, SHEET LC-07.

COLOR; W/ SAWCUT CONTROL JOINTS; SEE DETAIL B,

(MASTER LIST - NOT ALL ITEMS ARE ON EVERY SHEET)

SHEET LC-07.

EVERGREEN DESIGN GROUP NOTE: PRINTED DRAWING SIZE MAY HAVE CHANGED FROM ORIGINAL. VERIFY SCALE USING BAR SCALE ABOVE. 800.680.6630 www.evergreendesigngroup.com LANDSCAPE ARCHITECTURE LAND PLANNING · IRRIGATION DESIGN

 4-IN THK. CONCRETE WALK, LIGHT BROOM FINISH, NATURAL GRAY COLOR; SEE DETAIL B, SHEET LC-07. THIS DOCUMENT IS ISSUED FOR INTERIM REVIEW AND IS NOT TO BE USED FOR CONSTRUCTION, BIDDING, OR PERMITTING PURPOSES.

> MARY N. BATES TEXAS L.A. #3613

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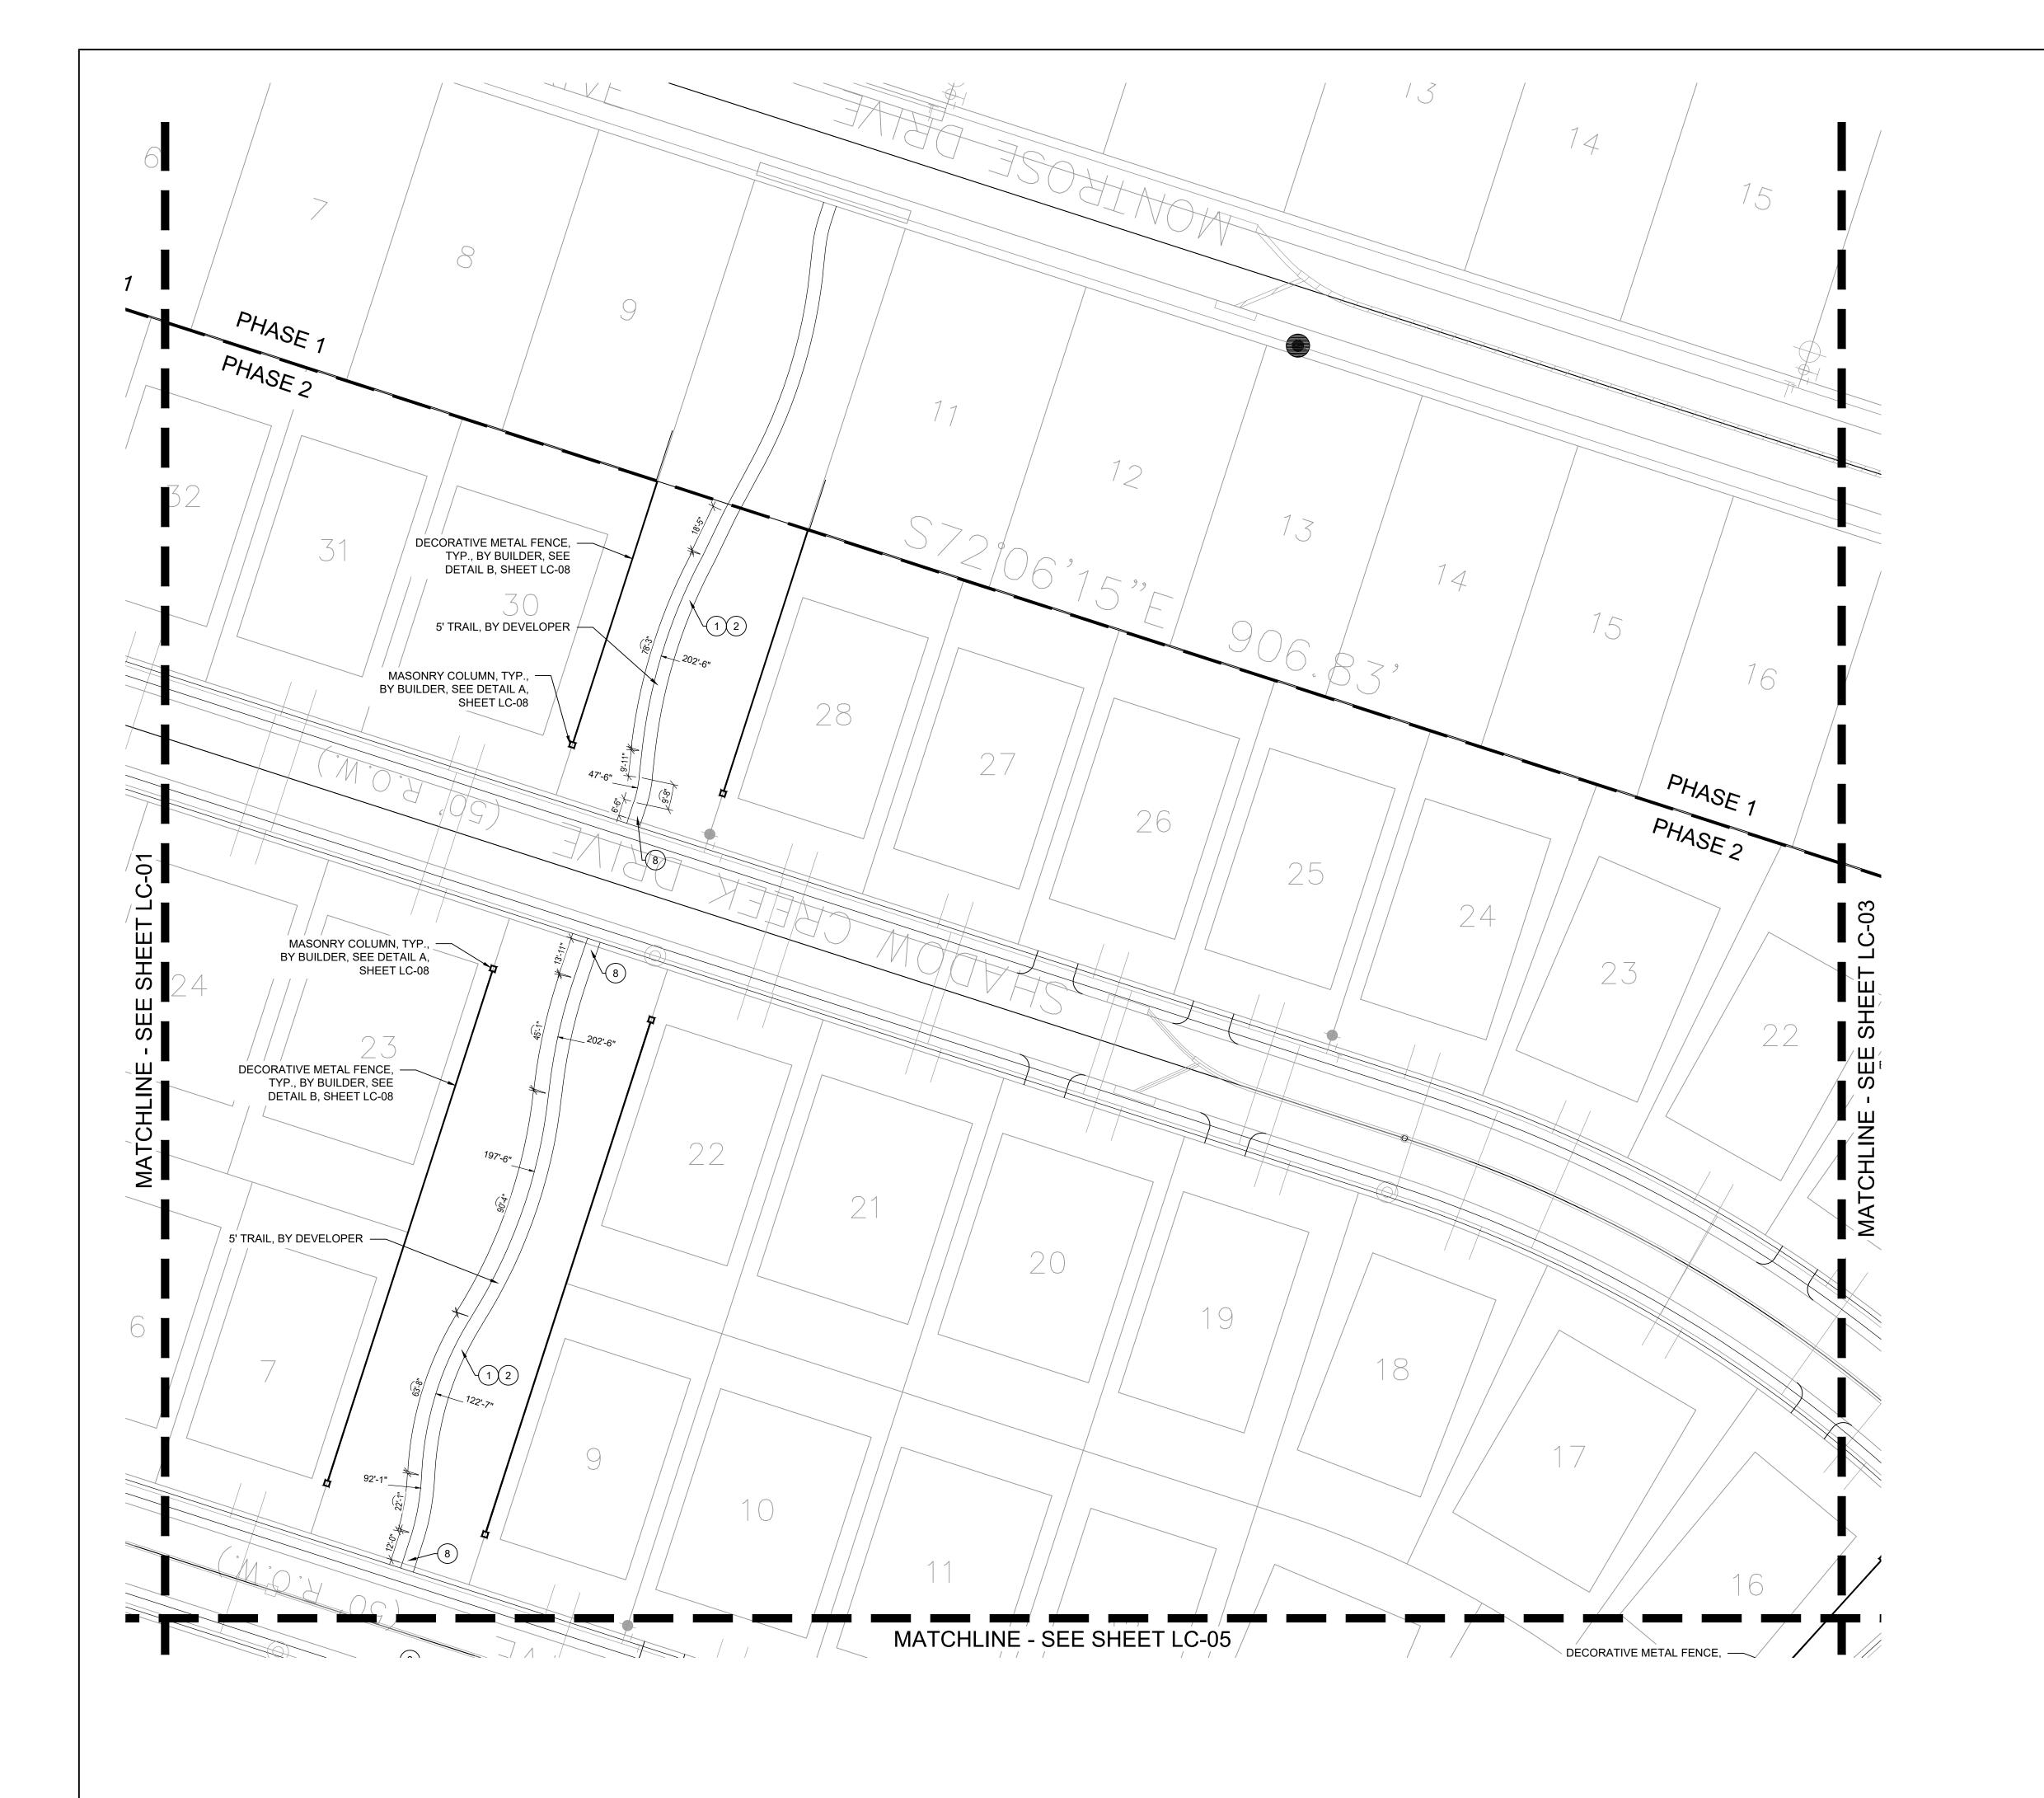
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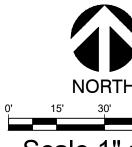
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Quail Hollow Rockwall, TX

HARDSCAPE PLAN

Date Comment





Scale 1" = 30'

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MARY N. BATES
TEXAS L.A. #3613

ISSUED ON: OCTOBER 04, 2024

skorburg Company 214 Westchester Drive, Suite 900 allas, Texas 75225

Quail Hollow Rockwall, TX

HARDSCAPE PLAN


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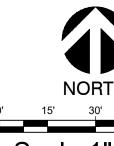
Project Number

Date 10/04/2

Date 10/04/24
Drawn By KB

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Scale 1" = 30'

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- 4. PLAYGROUND EQUIPMENT, SEE DETAIL D, SHEET LC-08
- 5. PLAYGROUND SAFETY SURFACING ENGINEERED WOOD MULCH; SEE DETAIL C, SHEET LC-08.
- 6. SWINGS, SEE DETAIL D, SHEET LC-08.

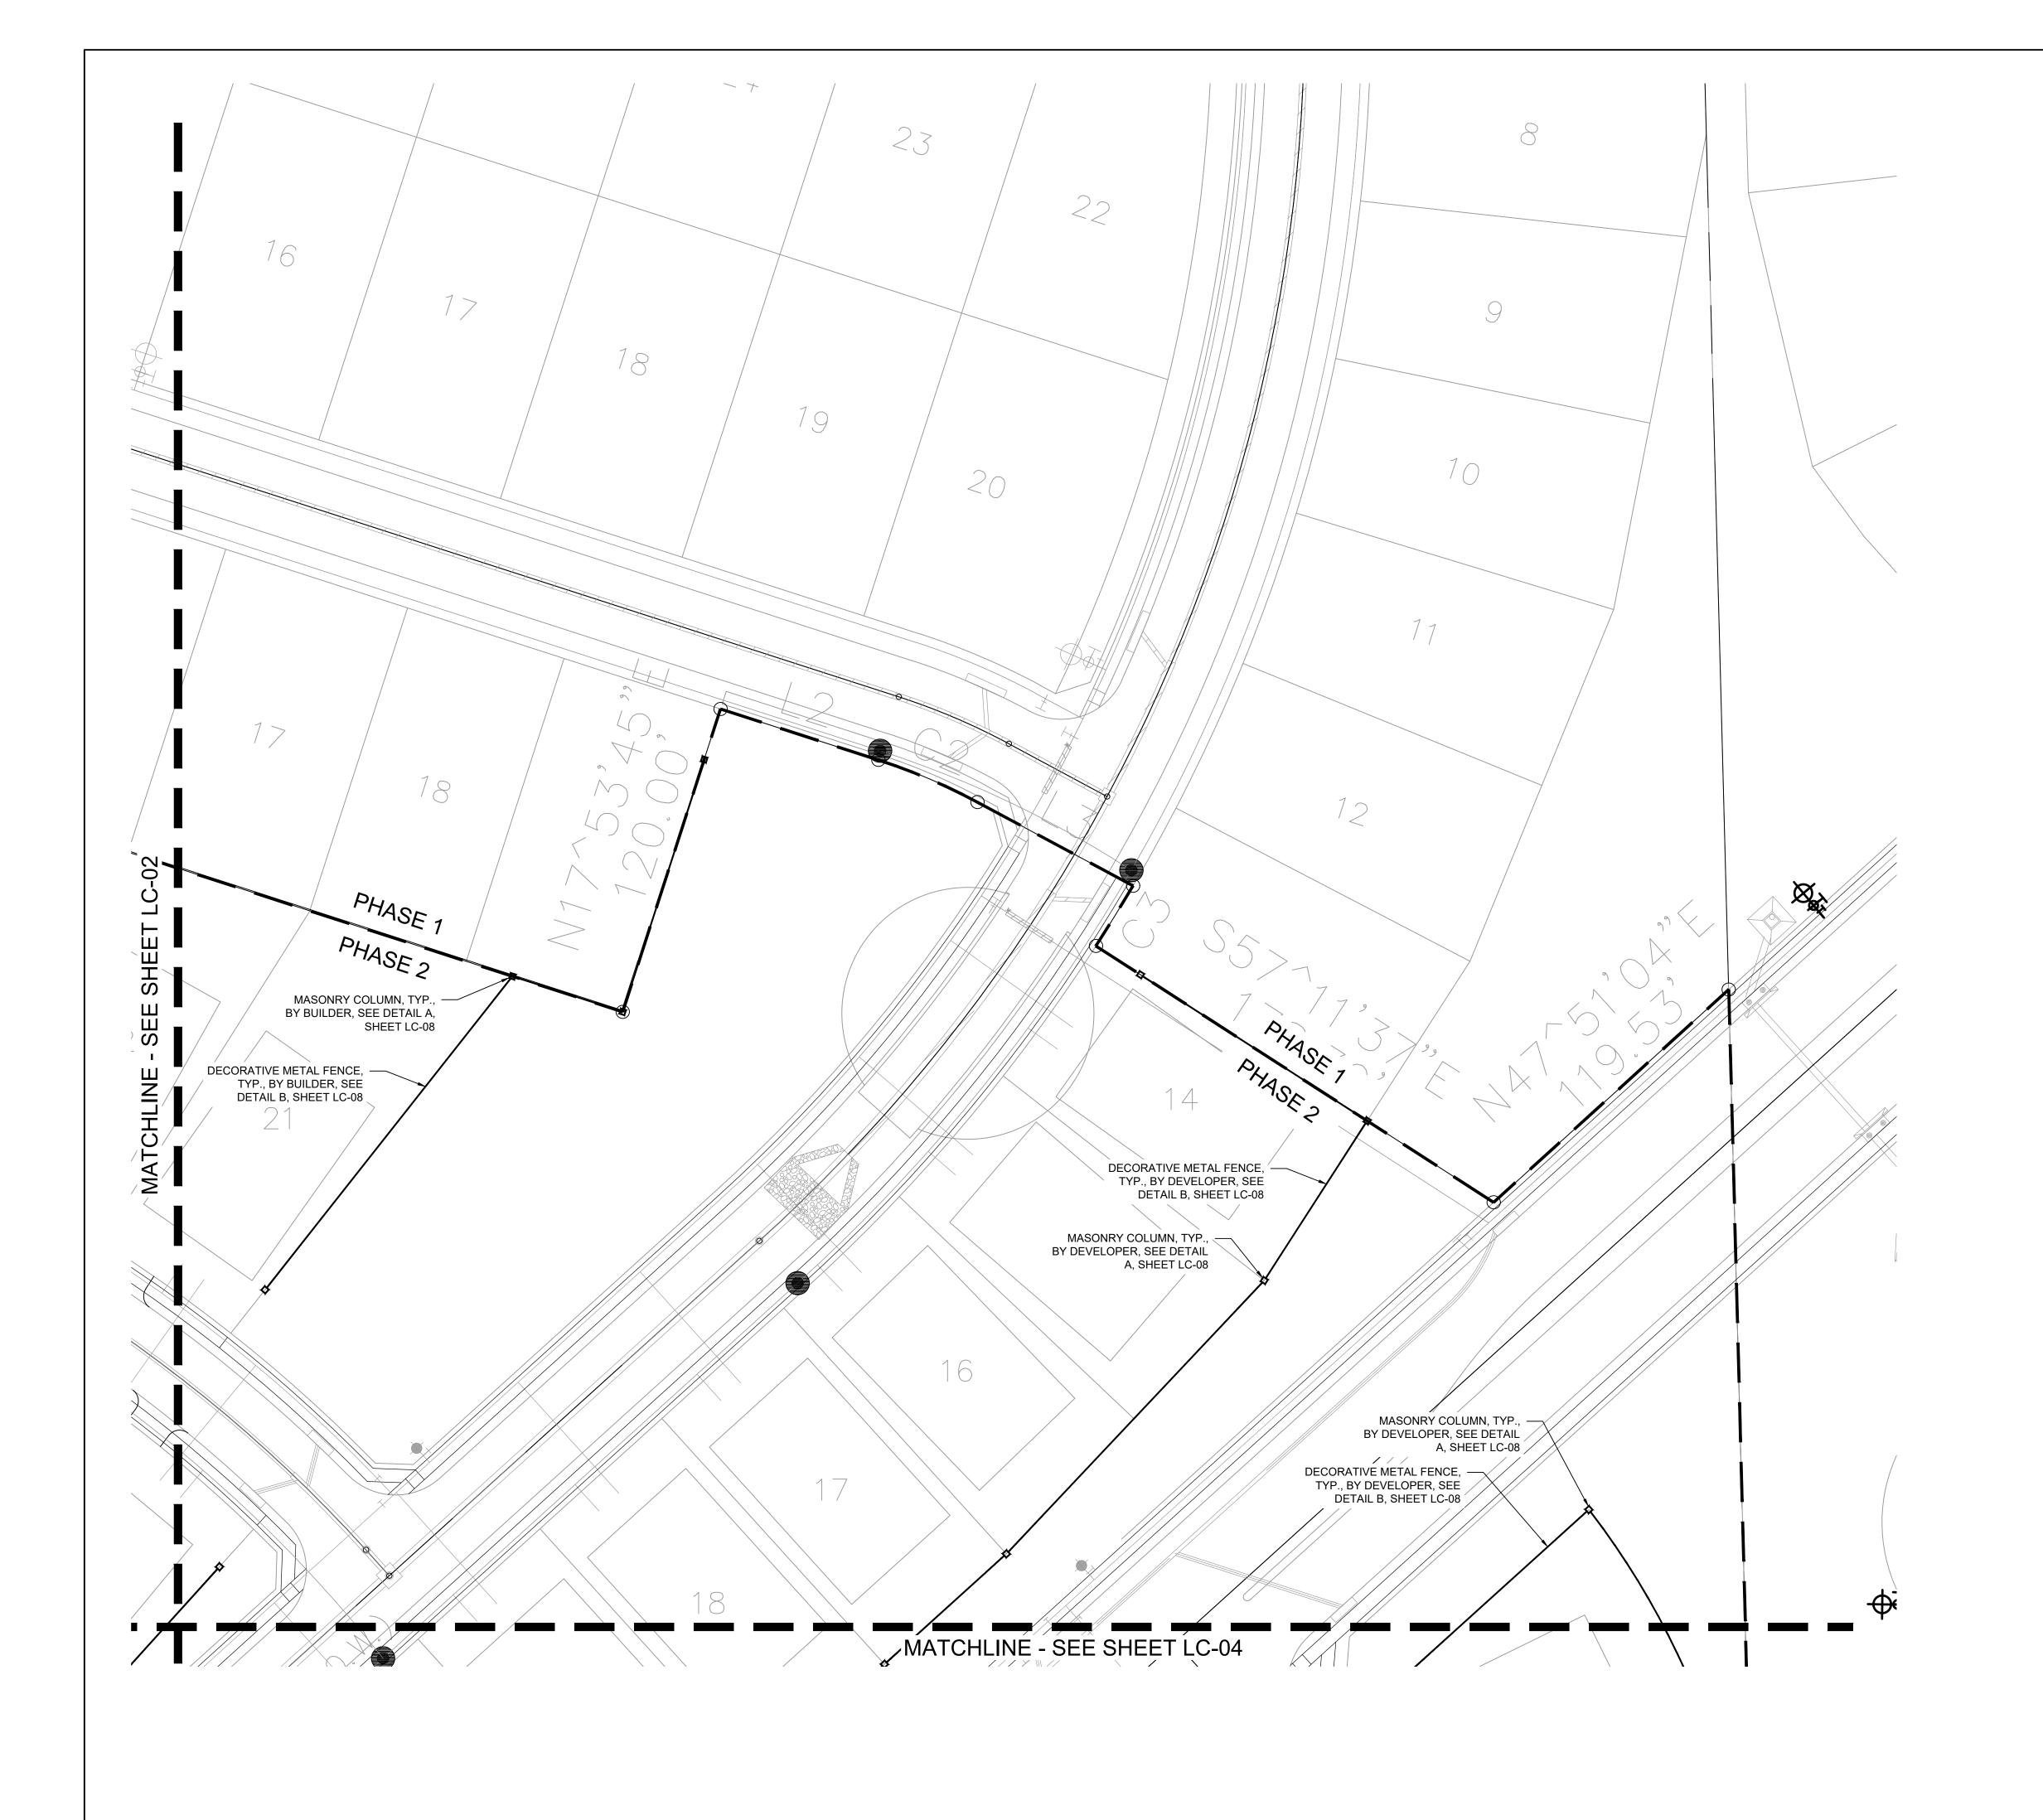SHEET LC-07.

- (7.) MULTI SPORT COURT. SEE DETAIL D, SHEET LC-07.
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Quail Hollow Rockwall, TX

HARDSCAPE PLAN


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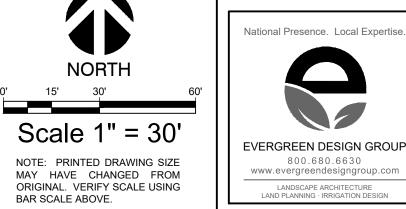
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 KB

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> > MARY N. BATES TEXAS L.A. #3613

MULCH; SEE DETAIL C, SHEET LC-08.

CONSTRUCTION LEGEND

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(MASTER LIST - NOT ALL ITEMS ARE ON EVERY SHEET)

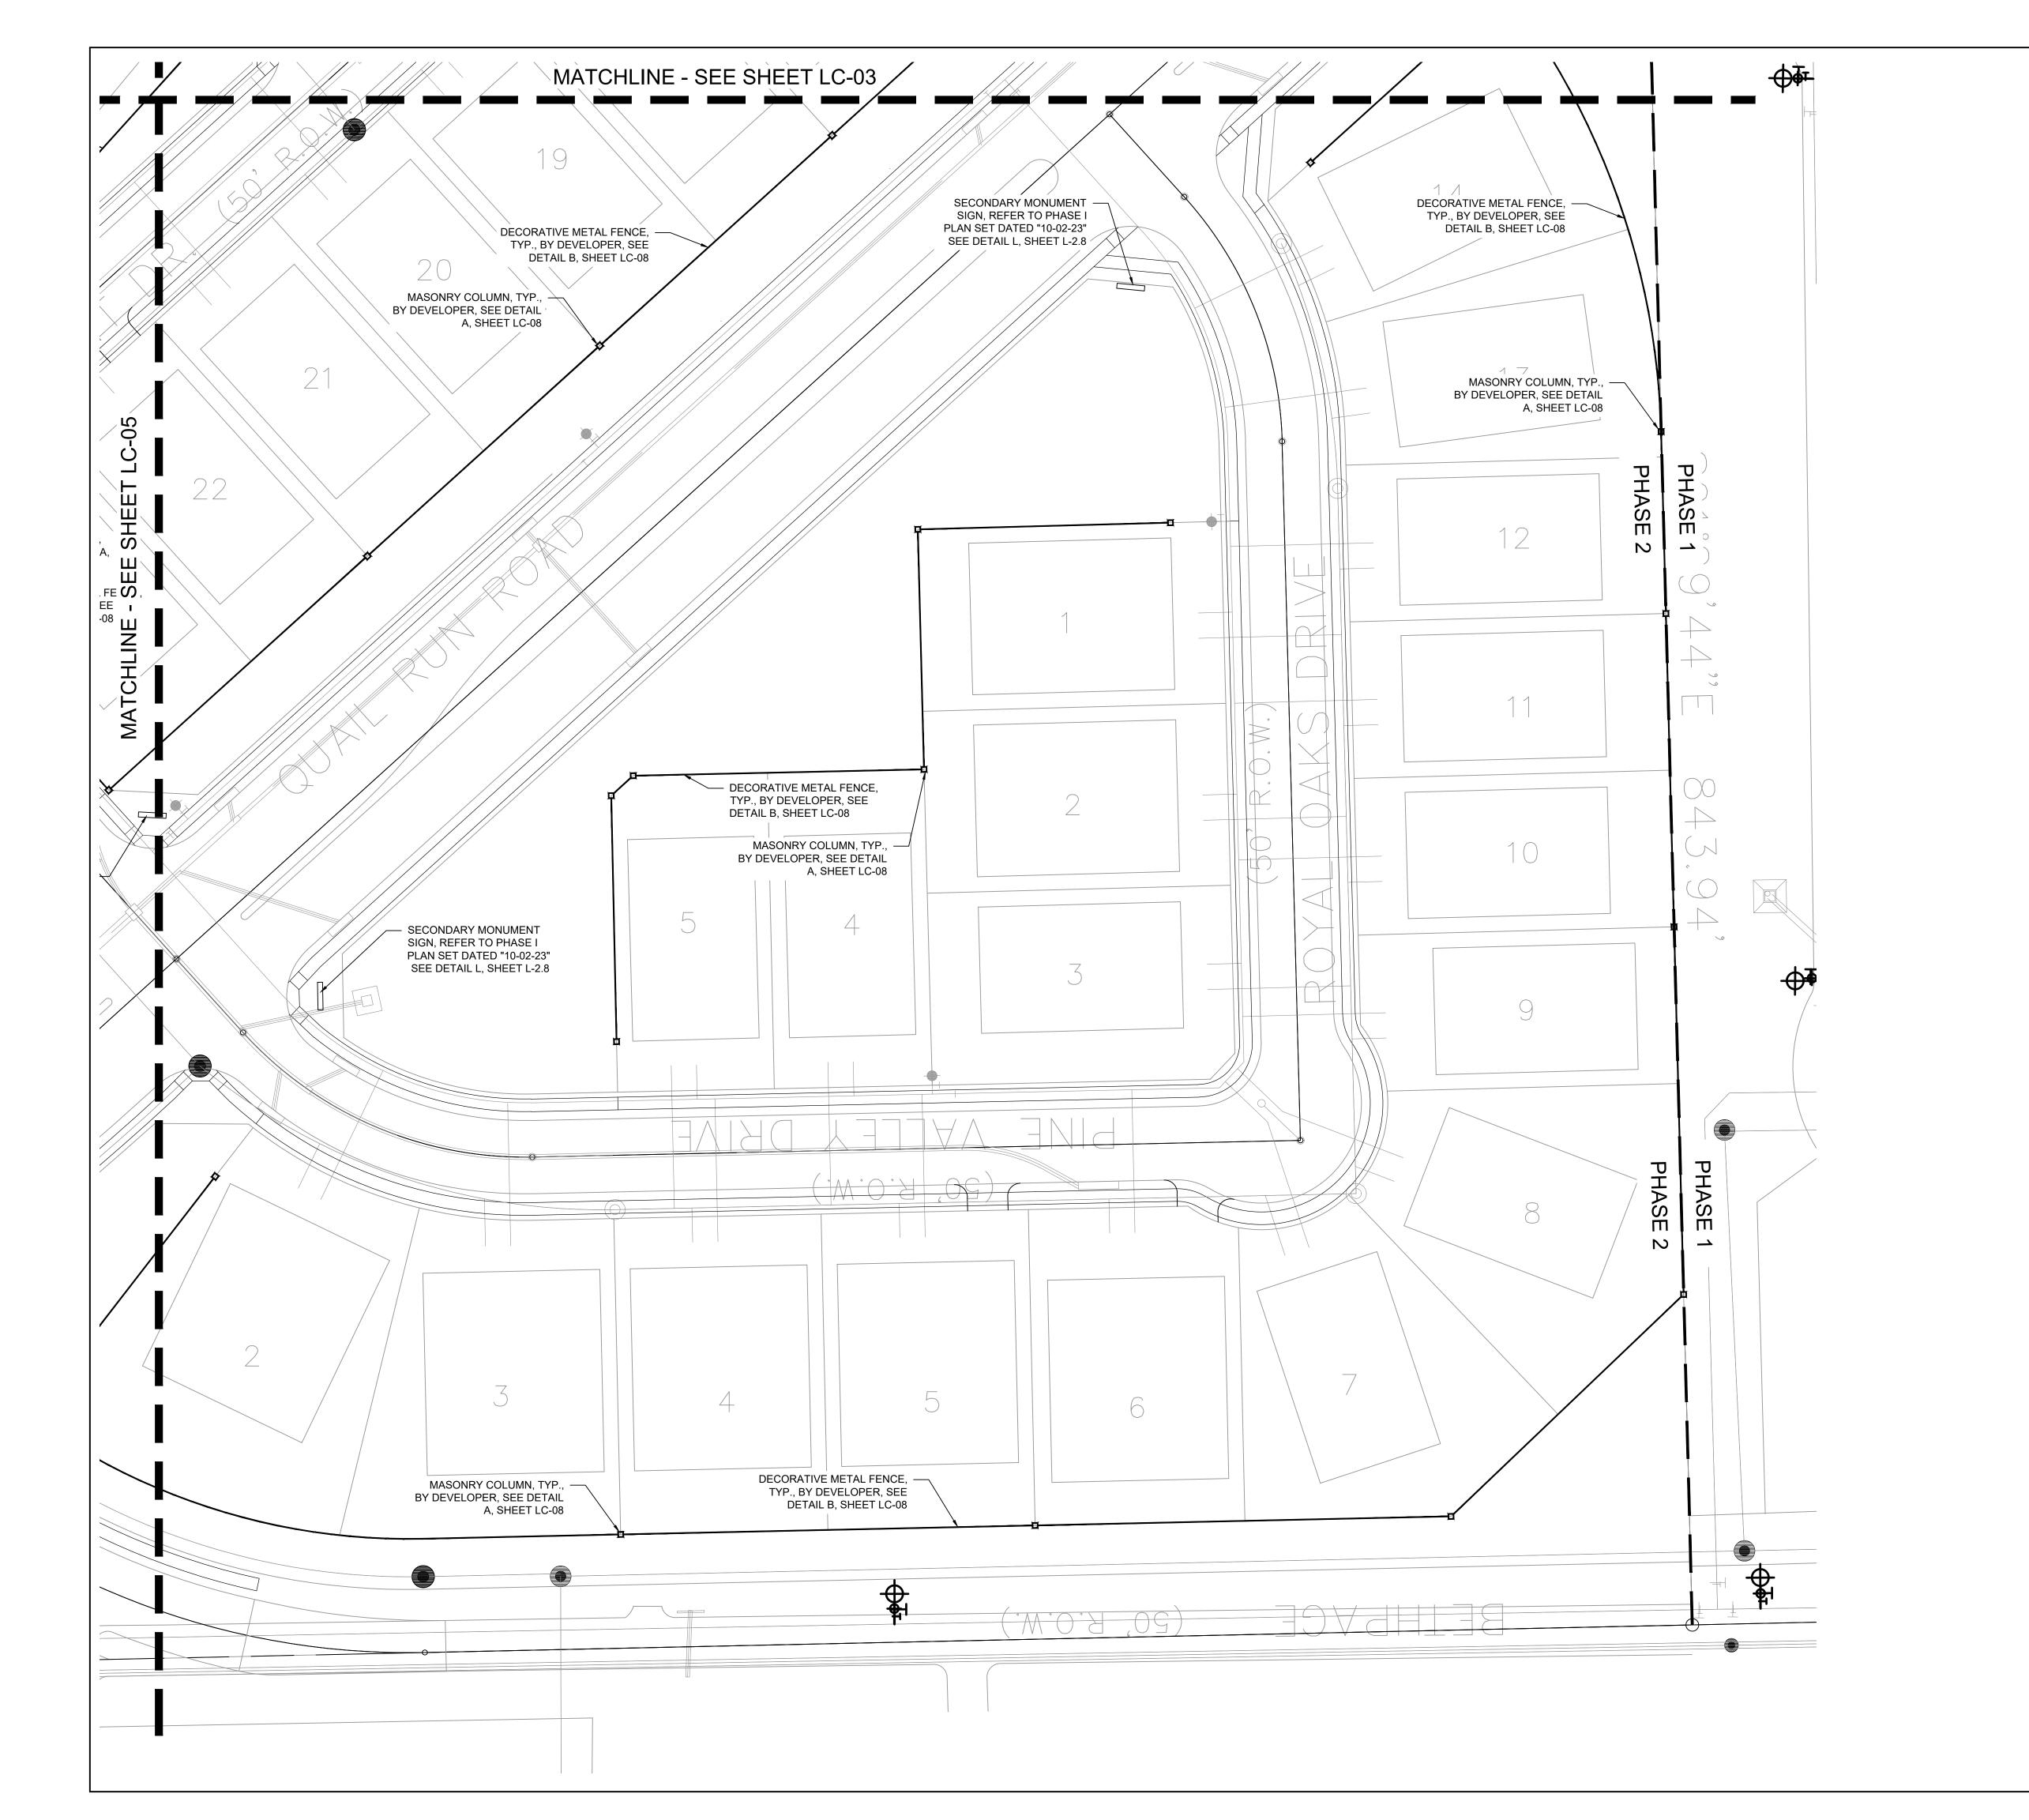6.) SWINGS, SEE DETAIL D, SHEET LC-08. (7.) MULTI SPORT COURT. SEE DETAIL D, SHEET LC-07.

8.) ADA RAMP. SEE DETAIL C, SHEET LC-07.

(9.) PRIMARY COLUMN. SEE DETAIL A, SHEET LC-08.

SHEET LC-07.

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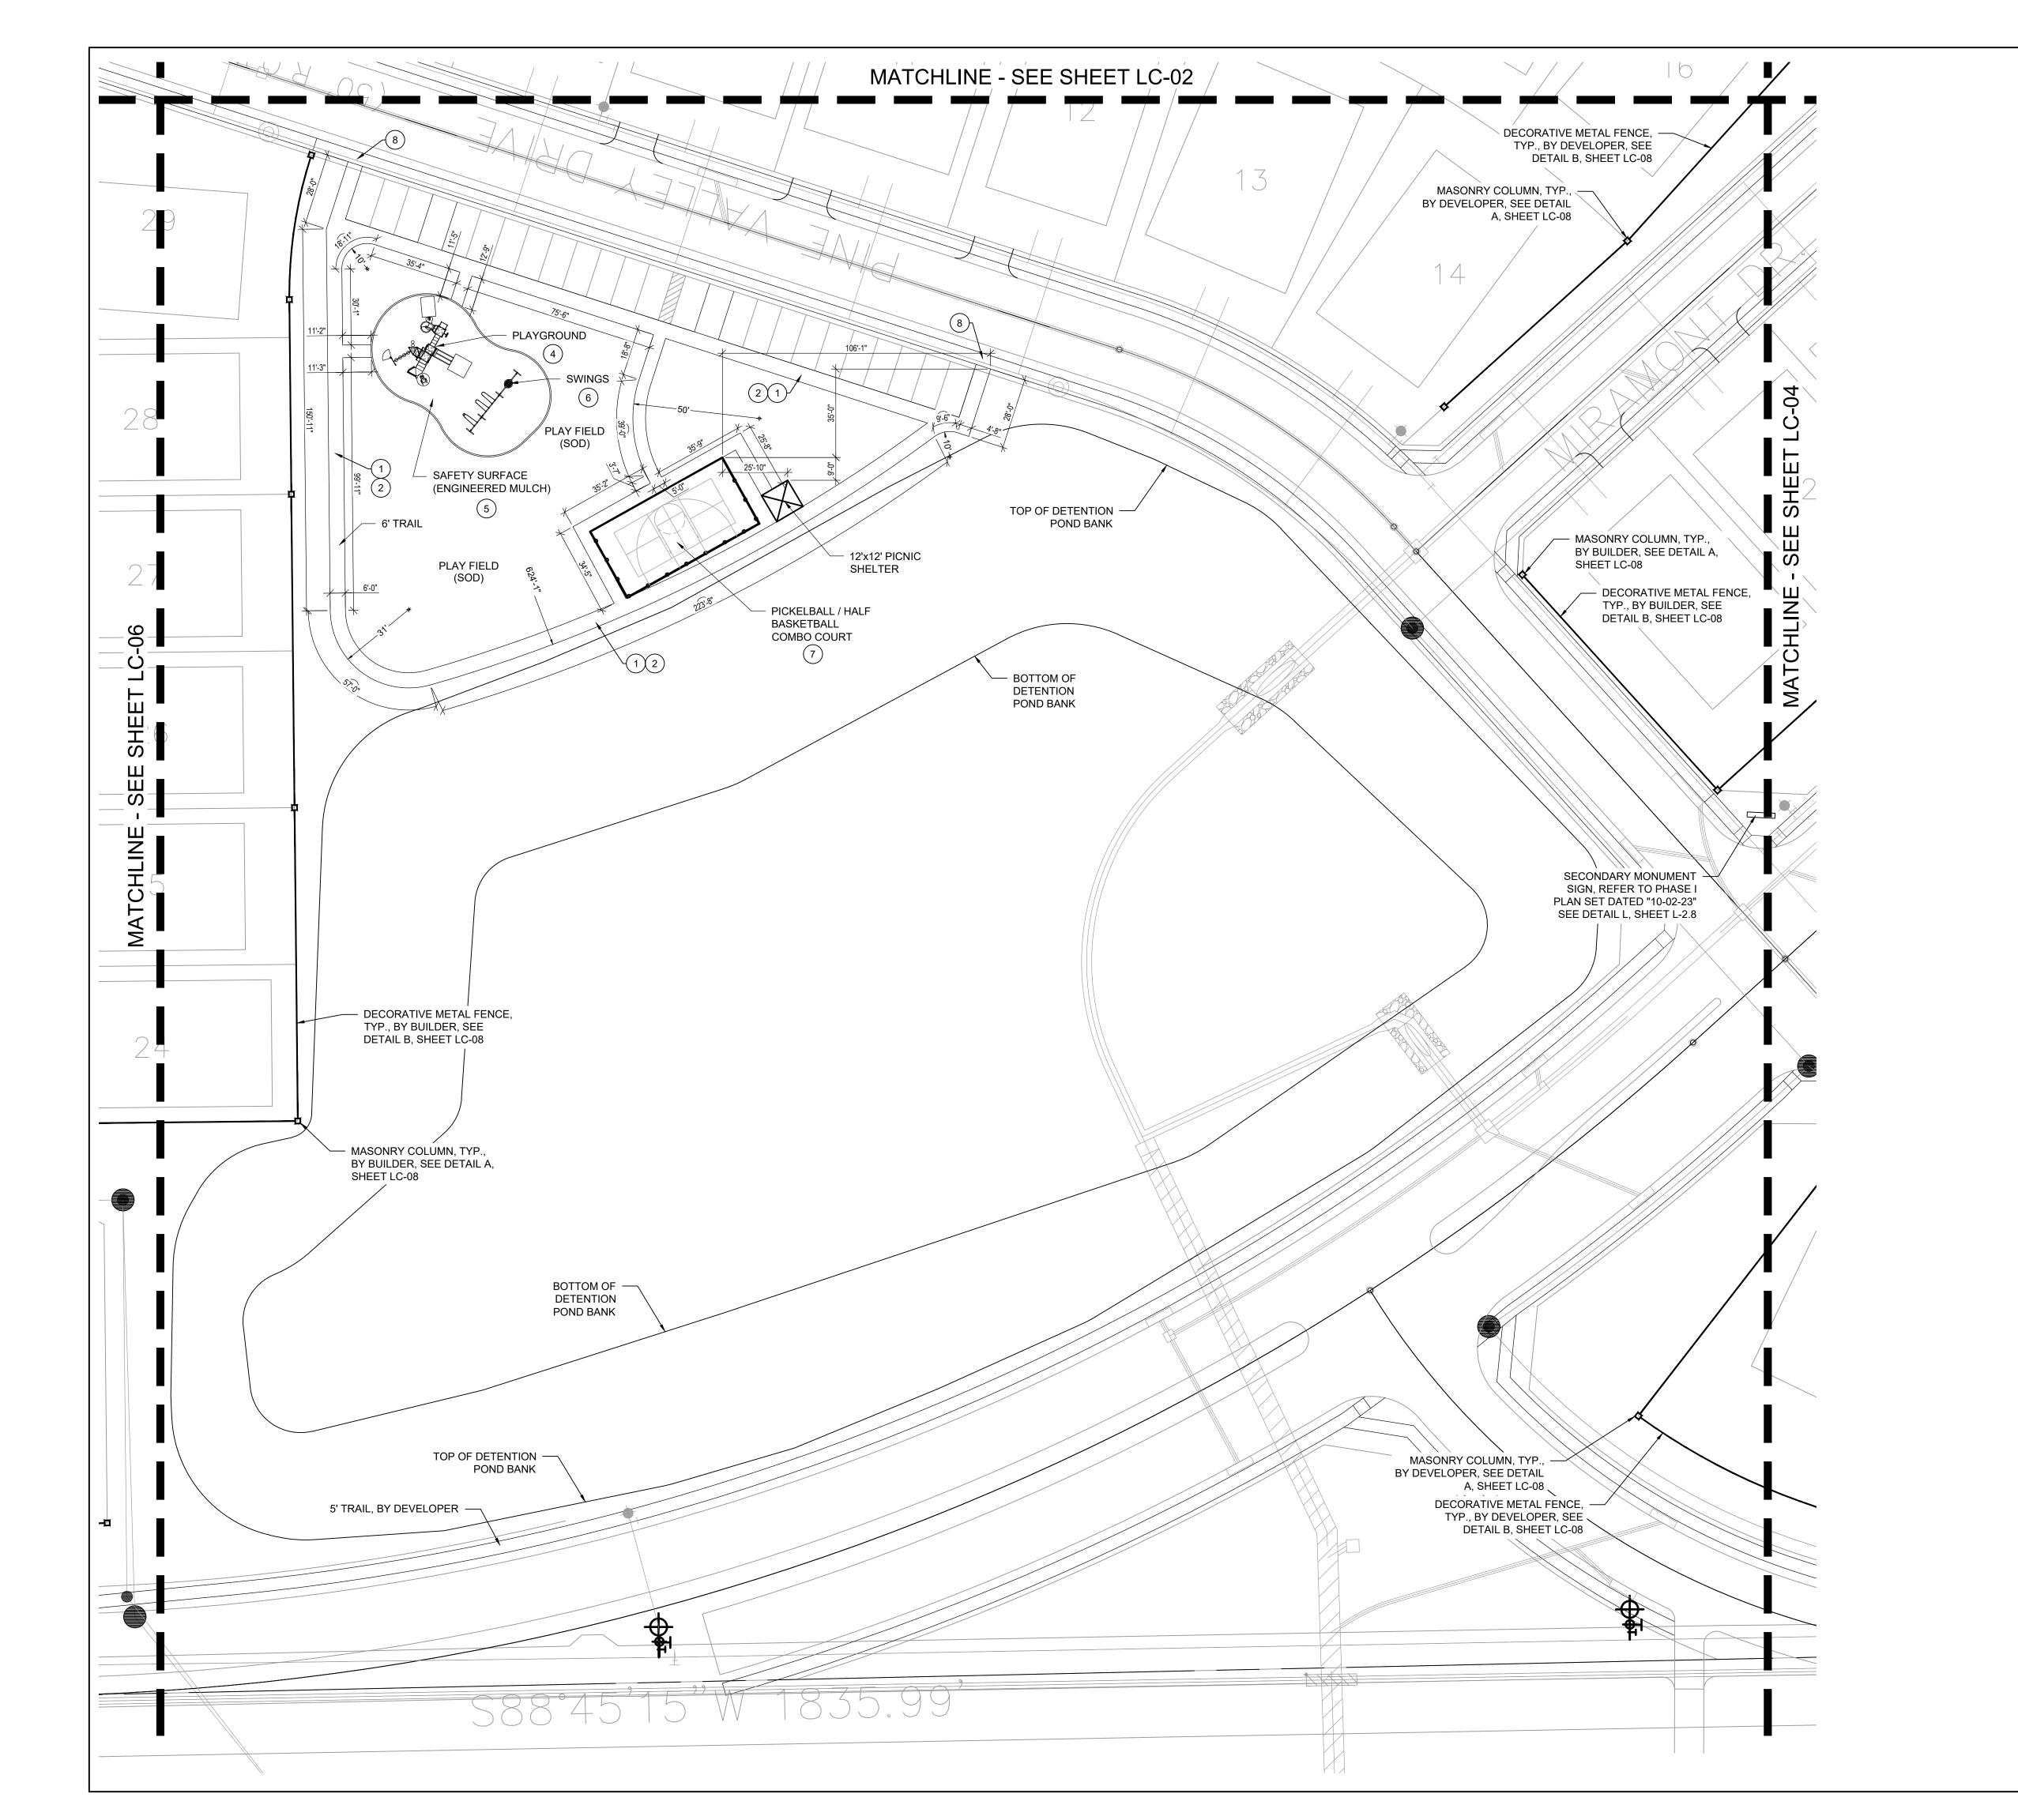
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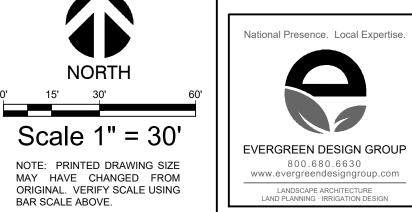
Quail Hollow Rockwall, TX

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Date Comment

10/04/24 Drawn By





CONSTRUCTION LEGEND (MASTER LIST - NOT ALL ITEMS ARE ON EVERY SHEET)

SHEET LC-07.

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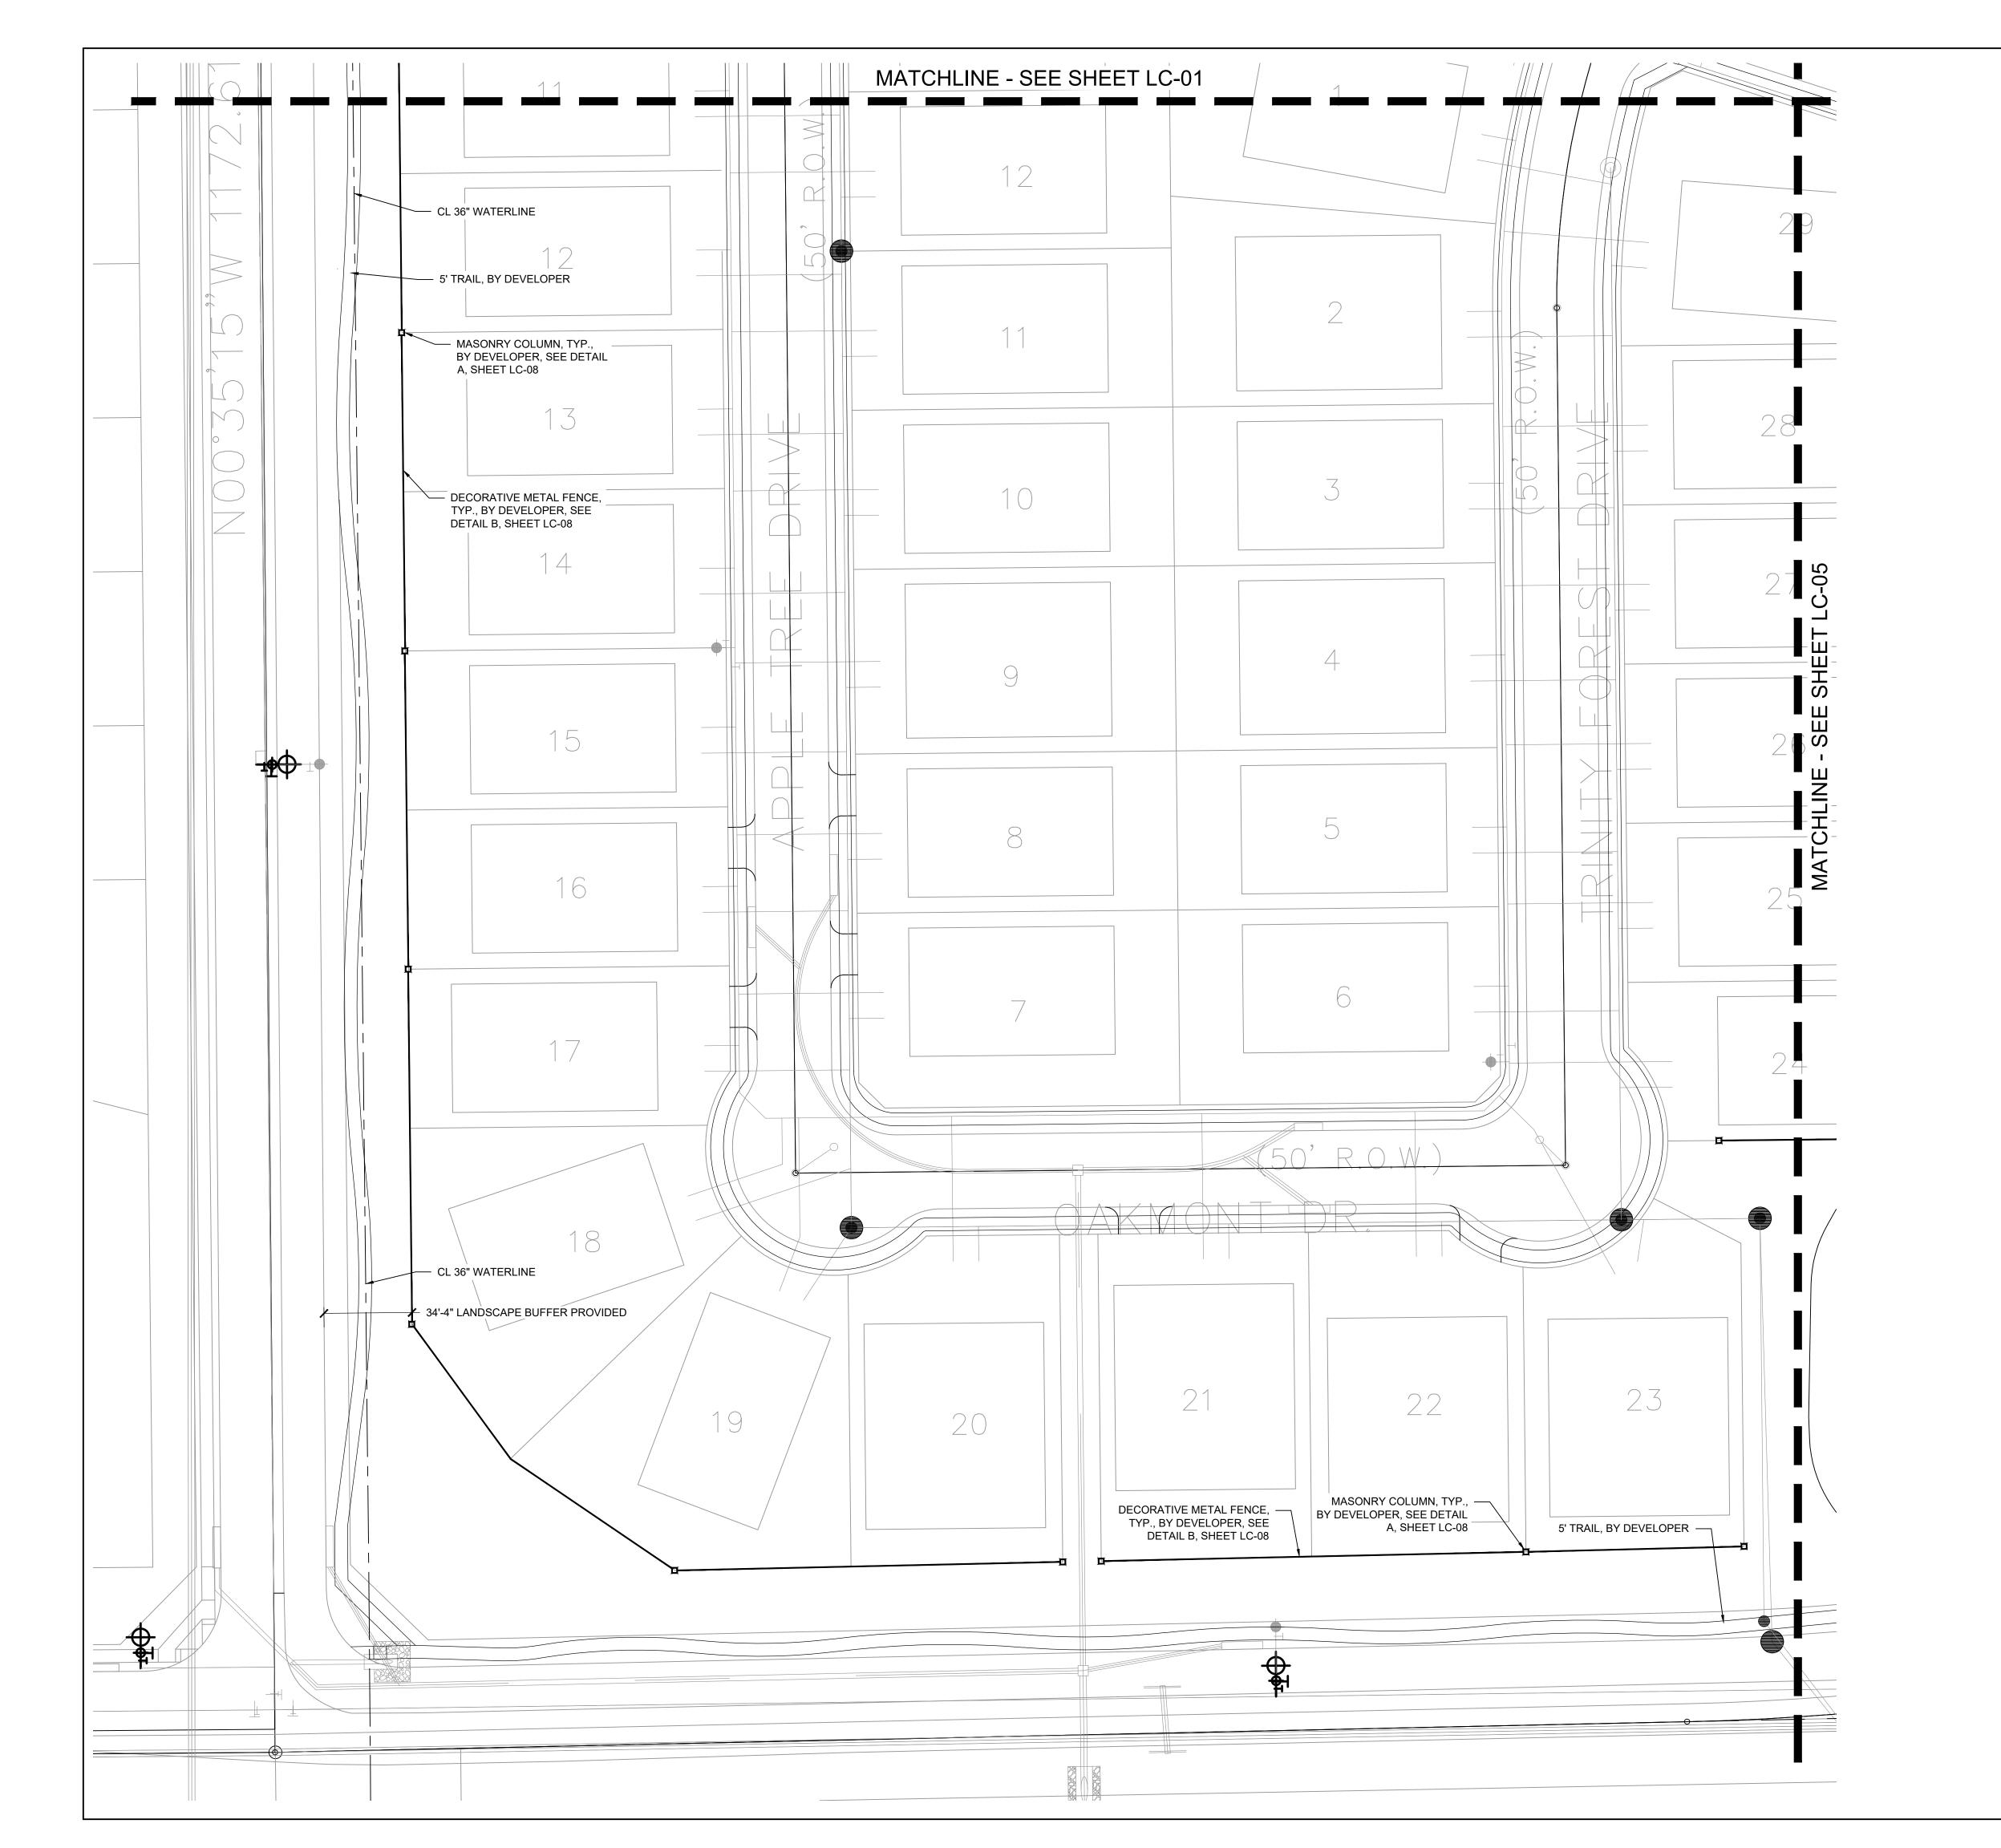
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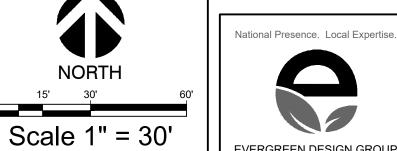
Hollow Quail Rockwall,

HARDSCAPE PLAN

Date Comment

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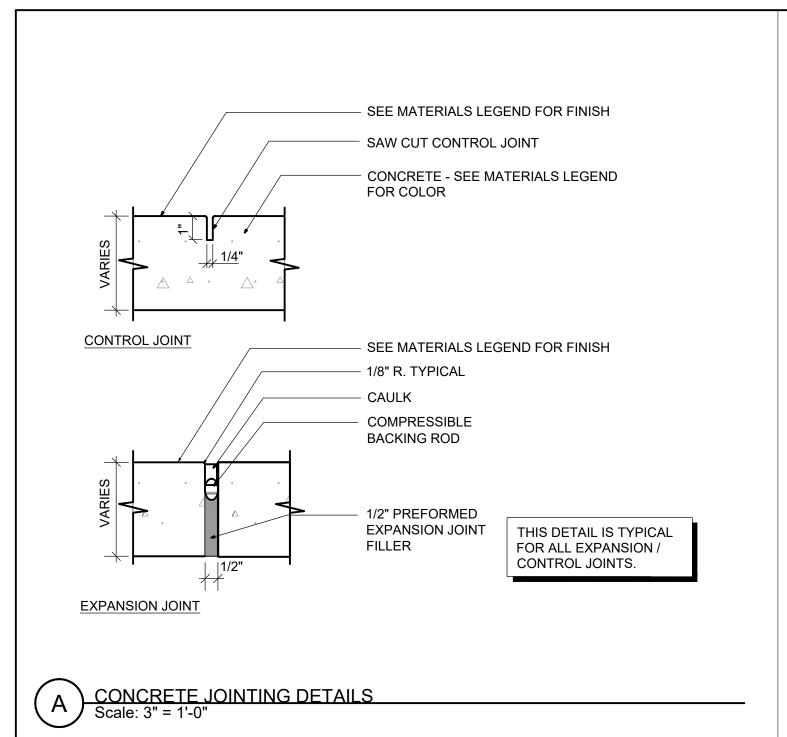
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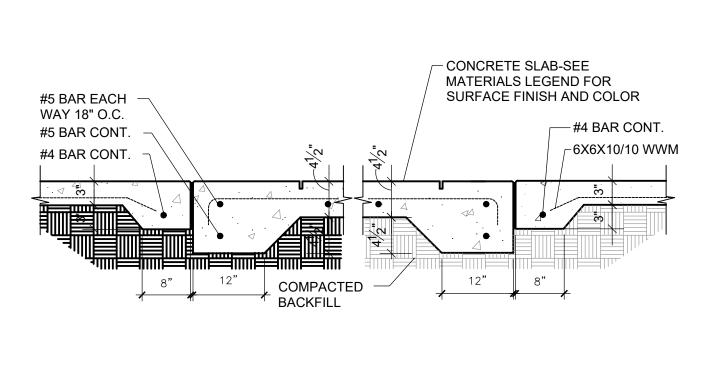
Skol 8214 w Dallas,

Quail Hollow Rockwall, TX


HARDSCAPE PLAN

Date Comment





B CONCRETE PAVEMENT - LIGHT DUTY
Scale: 3/4" = 1'-0"

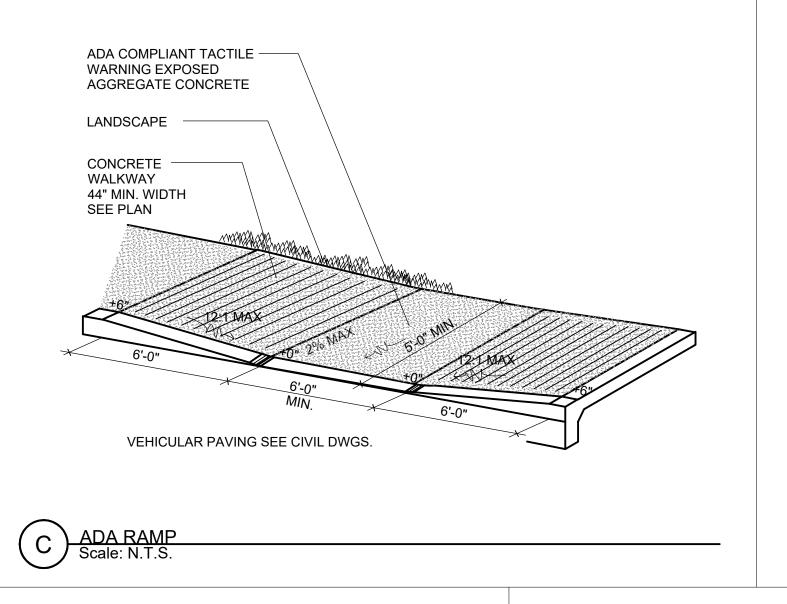



COURT BUILDER "



MANUFACTURER: SPORT COURT SUPPLIER: NEXCOURT CONTACT: CHRIS WALKER PHONE: 972-898-7529 COLORS: TBD OPTIONS: 30'X60' MULTI-SPORT COURT, 1/2 BASKETBALL, PICKLEBALL, 2 SINGLE LIGHTS, FULL 3 SIDES BLACK VINYL COATED CHAIN LINK FENCE BACKSTOP PICKLE BALL COURT FENCE NOTE: 8' HIGH FENCE AT REAR OF COURT. 4' HIGH FENCE AT SIDES OF COURT.



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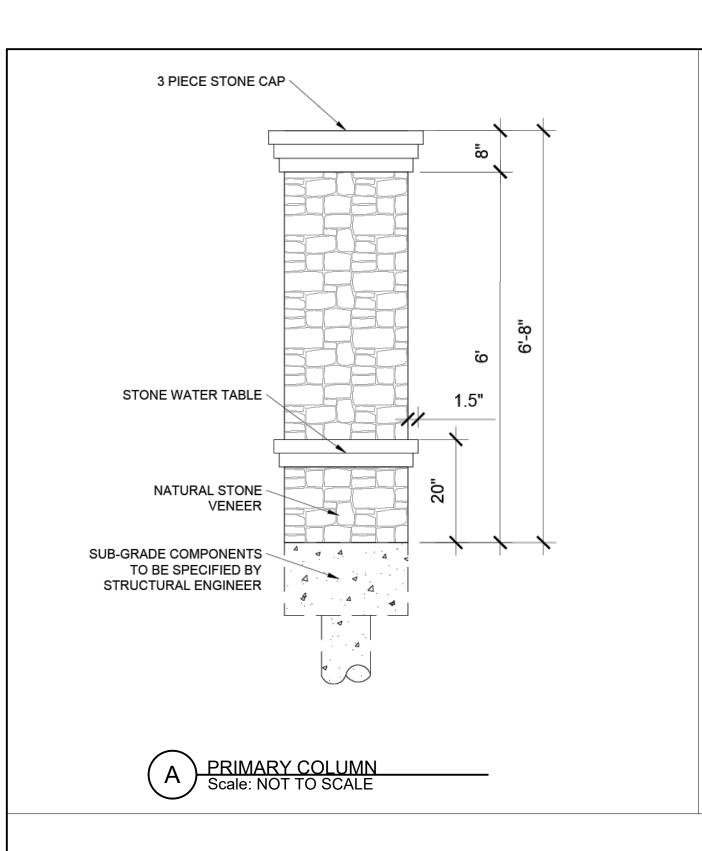
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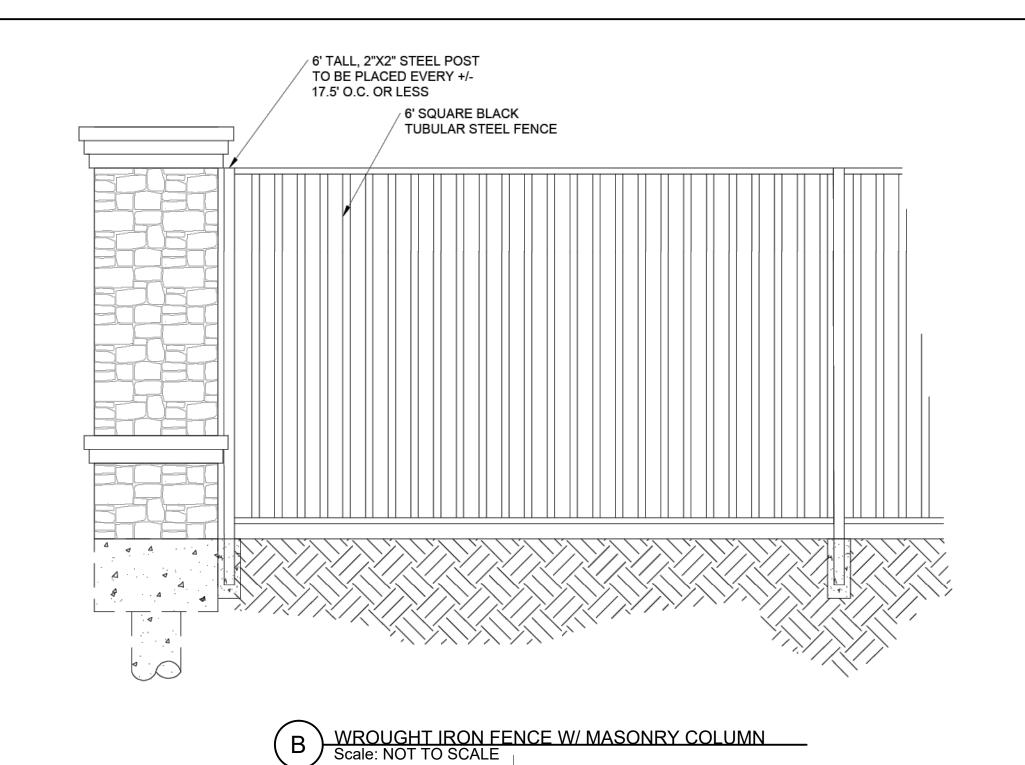
Comparion Drive, Suite Skorburg (8214 Westchester IDallas, Texas 75225

Hollow LTX Quail Rockwall,

HARDSCAPE **DETAILS**

Date Comment





— ACCESSIBLE CONCRETE RAMP INSIDE EDGE OF RAMP -----FIBAR® WOOD FIBER MUST FALL OUTSIDE ASTM USE ZONE ← FIBAR® WOOD FIBER SLOPE>1% ABOVE GROUND INSTALLATION ABOVE GROUND INSTALLATION ACCESSIBILITY DETAIL

1. INSTALLATION TO BE COMPLETED IN ACCORDANCE WITH MANUFACTURER'S SPECIFICATIONS.

2. DO NOT SCALE DRAWING. 3. THIS DRAWING IS INTENDED FOR USE BY ARCHITECTS, ENGINEERS, CONTRACTORS, CONSULTANTS AND DESIGN PROFESSIONALS

FOR PLANNING PURPOSES ONLY. THIS DRAWING MAY NOT BE USED FOR CONSTRUCTION. 4. ALL INFORMATION CONTAINED HEREIN WAS CURRENT AT THE TIME OF DEVELOPMENT BUT MUST BE REVIEWED AND APPROVED BY

THE PRODUCT MANUFACTURER TO BE CONSIDERED ACCURATE. 5. CONTRACTOR'S NOTE: FOR PRODUCT AND COMPANY INFORMATION VISIT www.CADdetails.com/info AND ENTER

THE FIBAR GROUP LLC 80 BUSINESS PARK DRIVE, SUITE 300 ARMONK, NY 10504 TOLL FREE: 1-800-342-2721 PHONE: (914) 273-8770 FAX: (914) 273-8659

www.fibar.com

ENGINEERED WOOD FIBER PLAYGROUND SAFETY SURFACING
Scale: NOT TO SCALE



MANUFACTURER: LITTLE TYKES SUPPLIER: LEA PARK & PLAY PHONE: (972) 690-8163 COLORS: TBD MODEL: R0306_45555298831



NOTES:

1. INSTALL ALL SHELTER ELEMENTS PER
MANUFACTURER'S RECOMMENDATIONS.

2. CONTRACTOR TO PROVIDE SIGNED AND SEALED
STRUCTURAL DRAWINGS FOR REVIEW PRIOR TO INSTALLATION. INSTALL WITH 12'X20' (4") CONCRETE SLAB.

MODEL: 12' X 12' NAVAJO SHELTER MANUFACTURER: AMERICANA BUILDING PRODUCTS CONTACT: LEA PARK & PLAY NICK BOLLIG, (940) 205-2761

SHELTER DETAILS



NOTES:

1. SURFACE MOUNT TO SHELTER SLAB

2. SUBMIT COLORS TO MATCH PLAYGROUND EQUIPMENT FOR APPROVAL PRIOR TO ORDERING.

MODEL: 8' RECTANGULAR EXPANDED STEEL ADA TABLE MANUFACTURER: ANOVA CONTACT: LEA PARK & PLAY NICK BOLLIG, (940) 205-2761

PICNIC TABLE



NOTES:

1. SURFACE MOUNT TO 4" CONCRETE SLAB
2. SUBMIT COLORS TO MATCH PLAYGROUND
EQUIPMENT FOR APPROVAL PRIOR TO ORDERING.

SCALE: NOT TO SCALE

NICK BOLLIG, (940) 205-2761

MODEL: 6' LATITUDE CONTOUR BENCH MANUFACTURER: ANOVA CONTACT: LEA PARK & PLAY

National Presence. Local Expertise EVERGREEN DESIGN GROUP 800.680.6630 www.evergreendesigngroup.com

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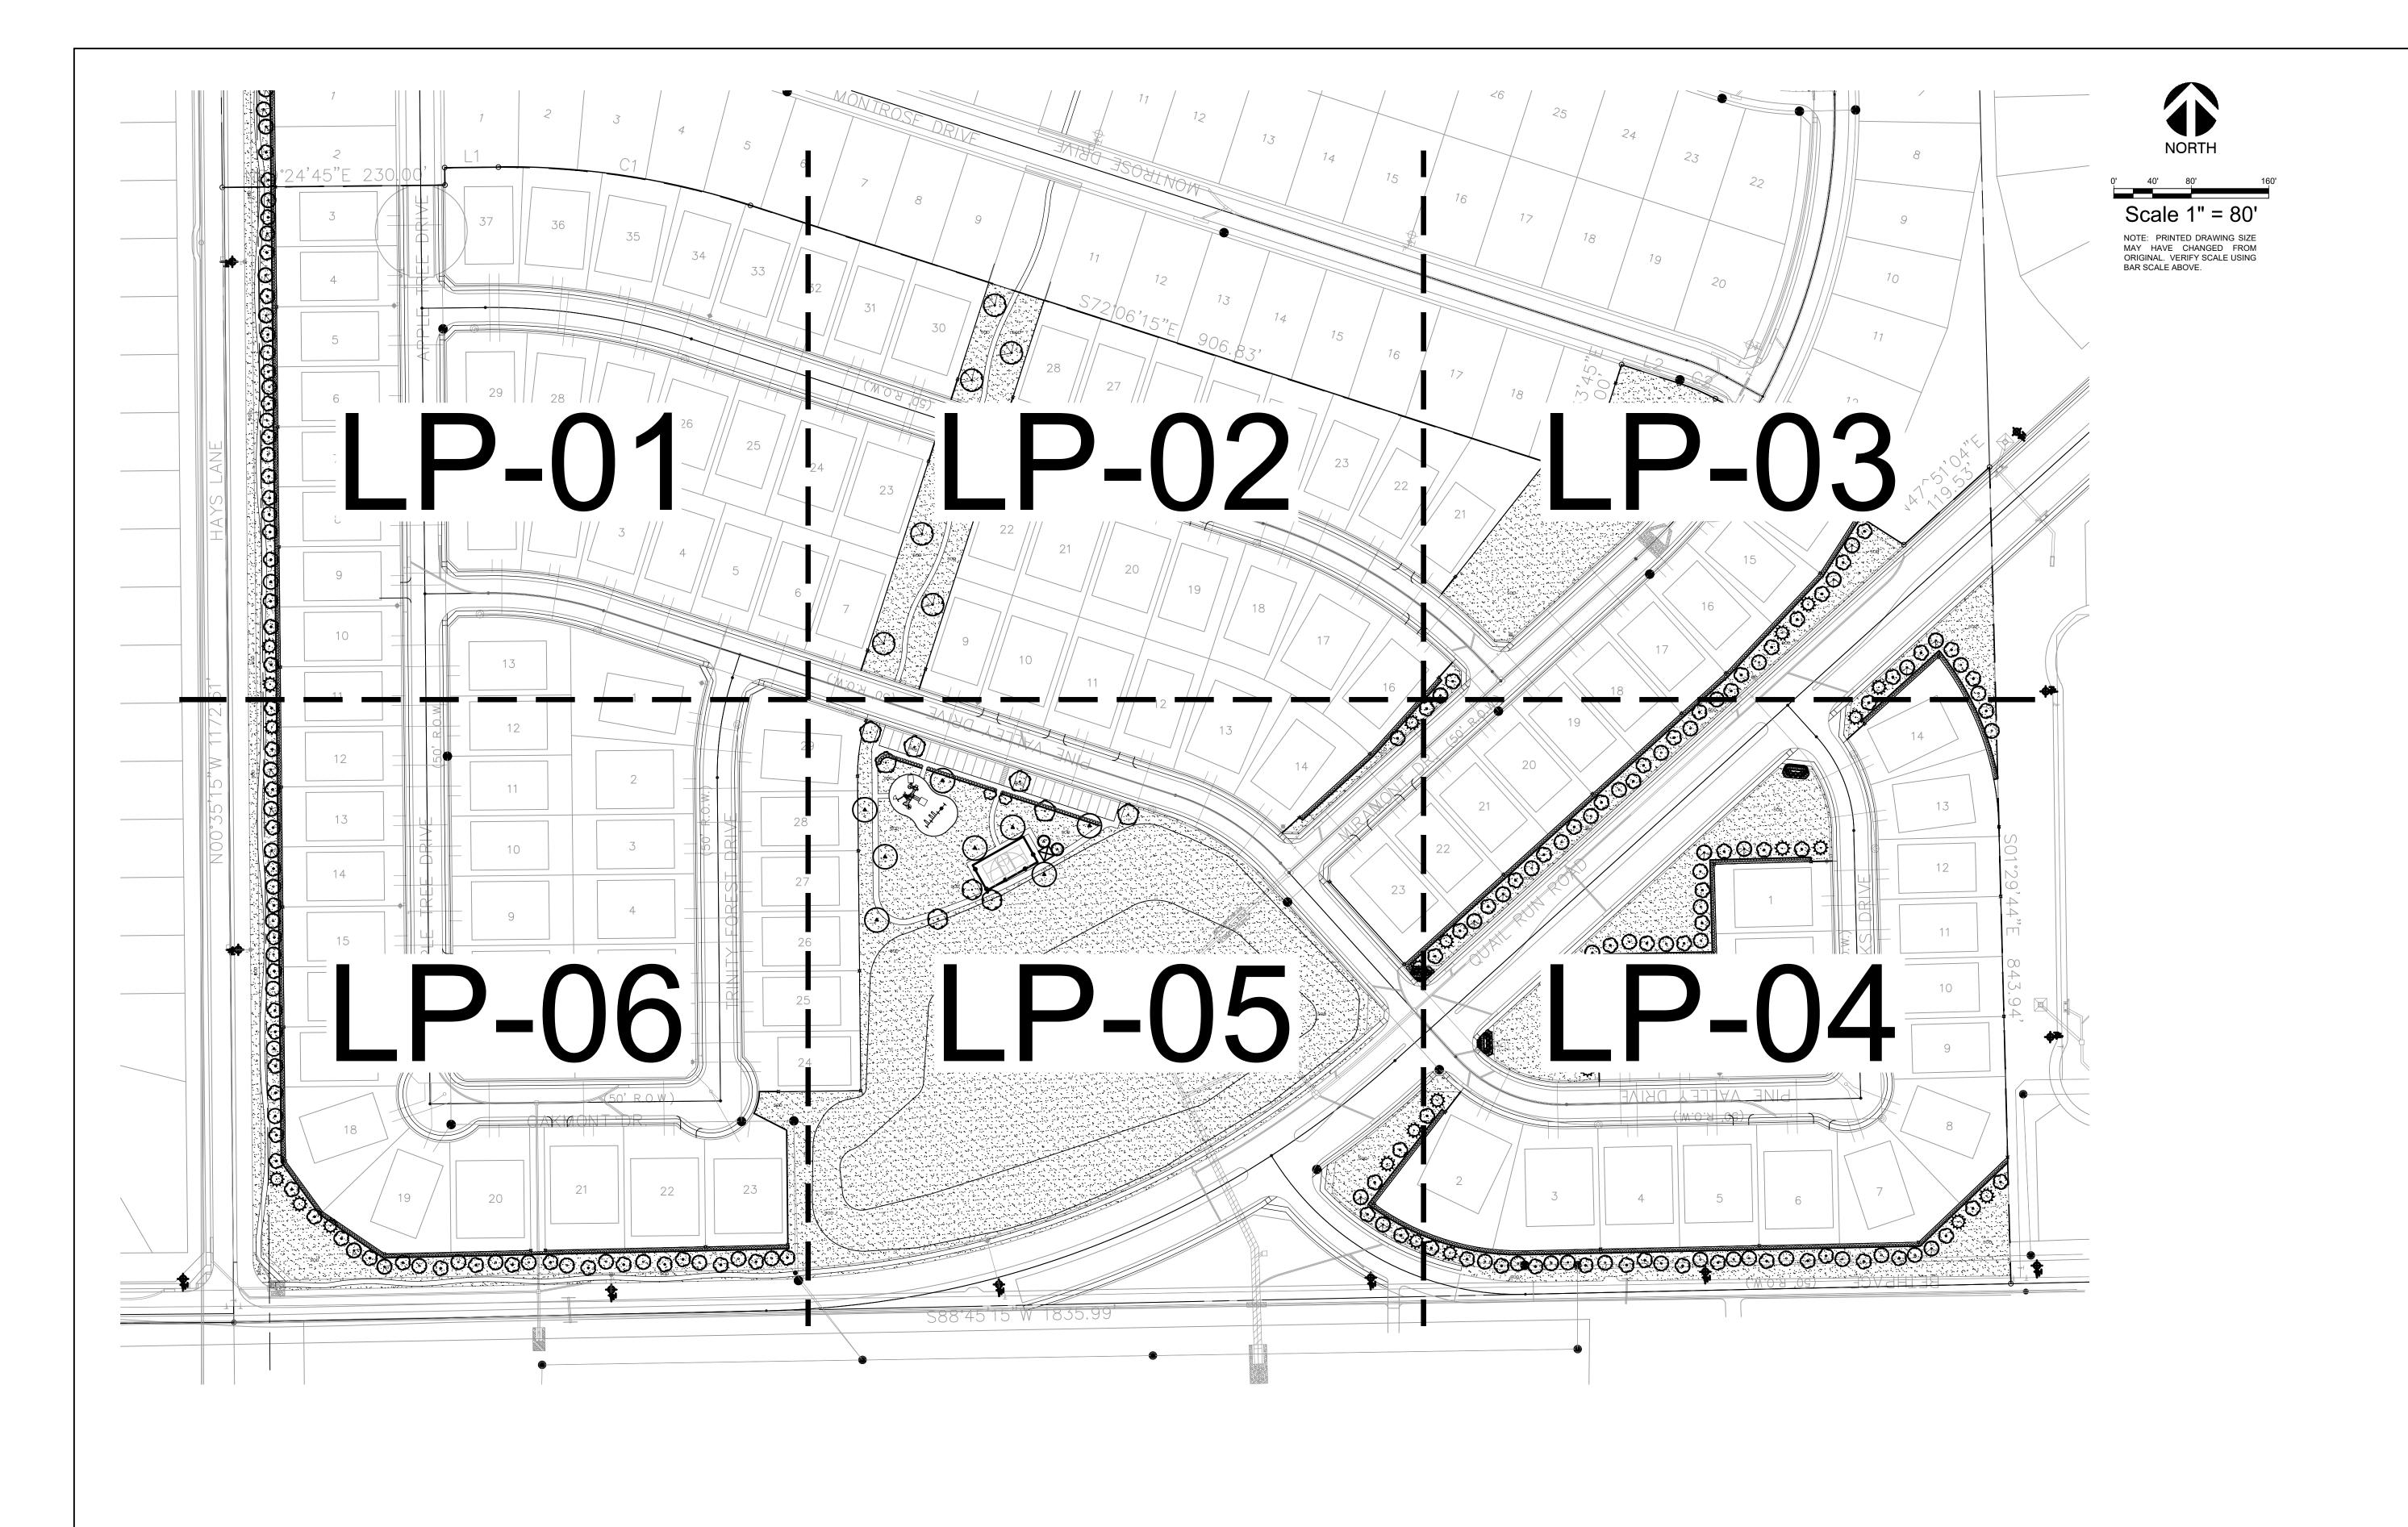
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HARDSCAPE DETAILS

Date Comment

Project Number

10/04/24 Drawn By Checked By





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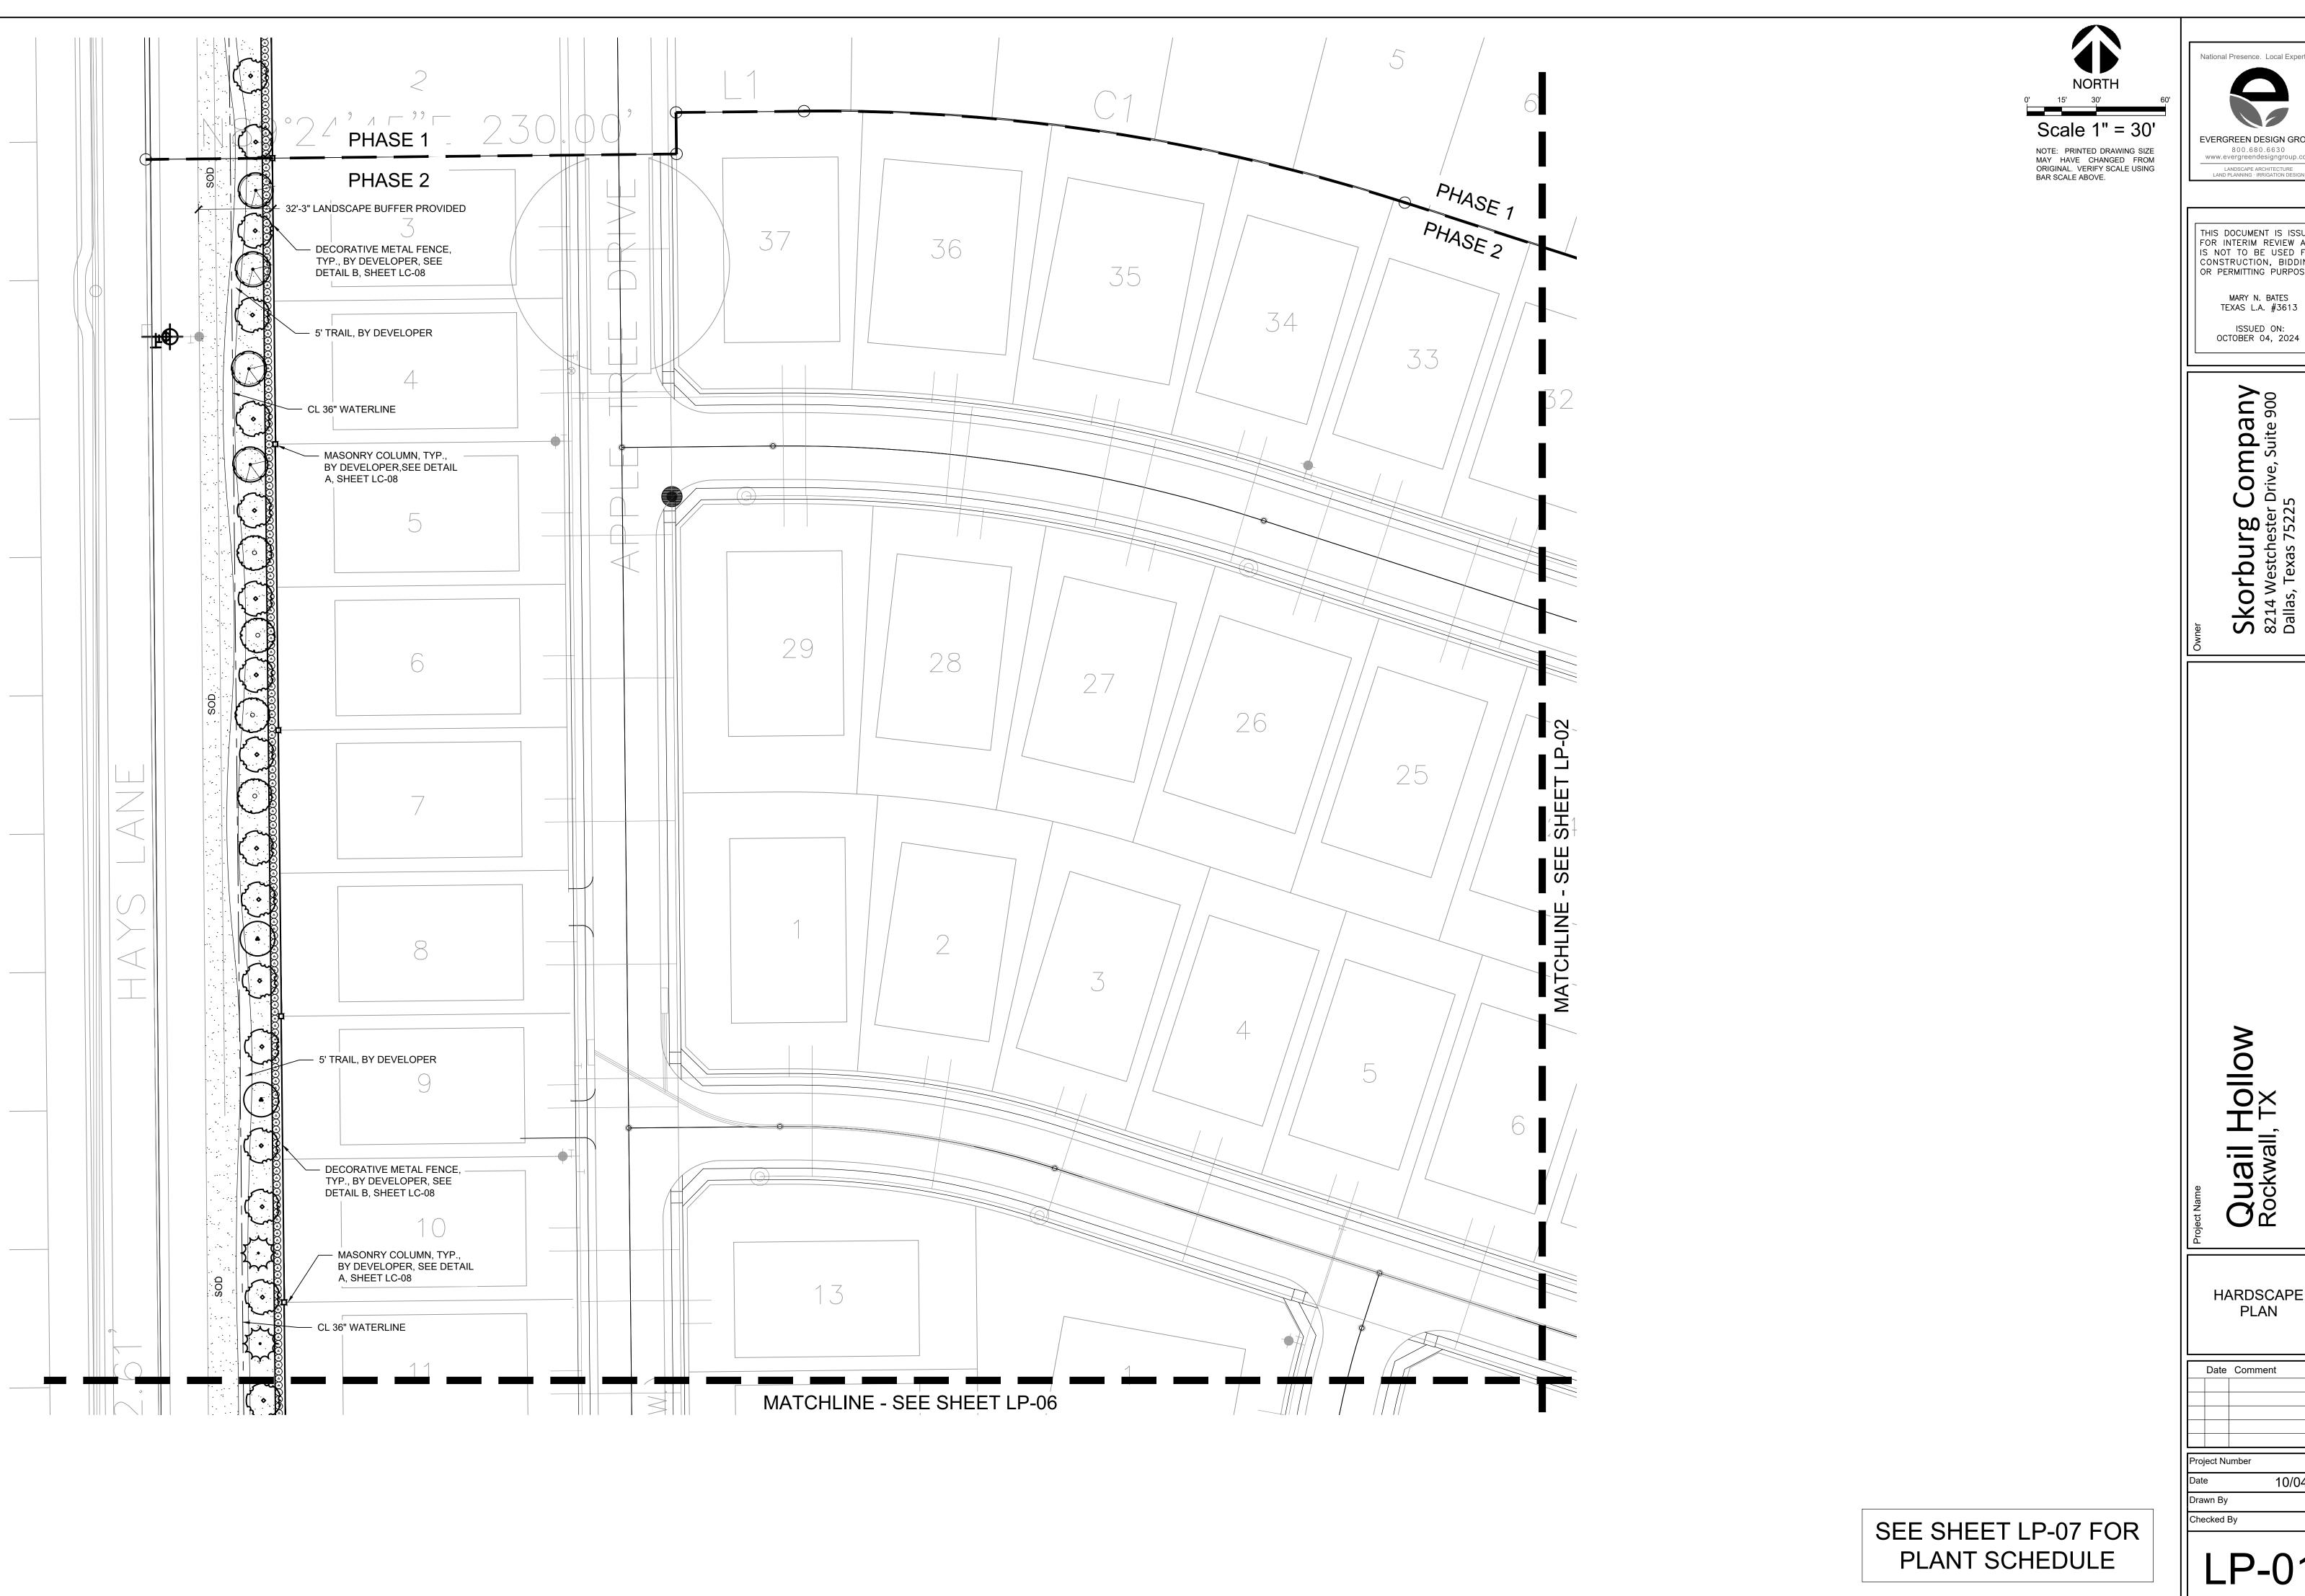
mpal ,e, Suite 9 CO r Drive Skorburg (8214 Westchester | Dallas, Texas 75225

Quail Hollow Rockwall, TX

OVERALL HARDSCAPE PLAN

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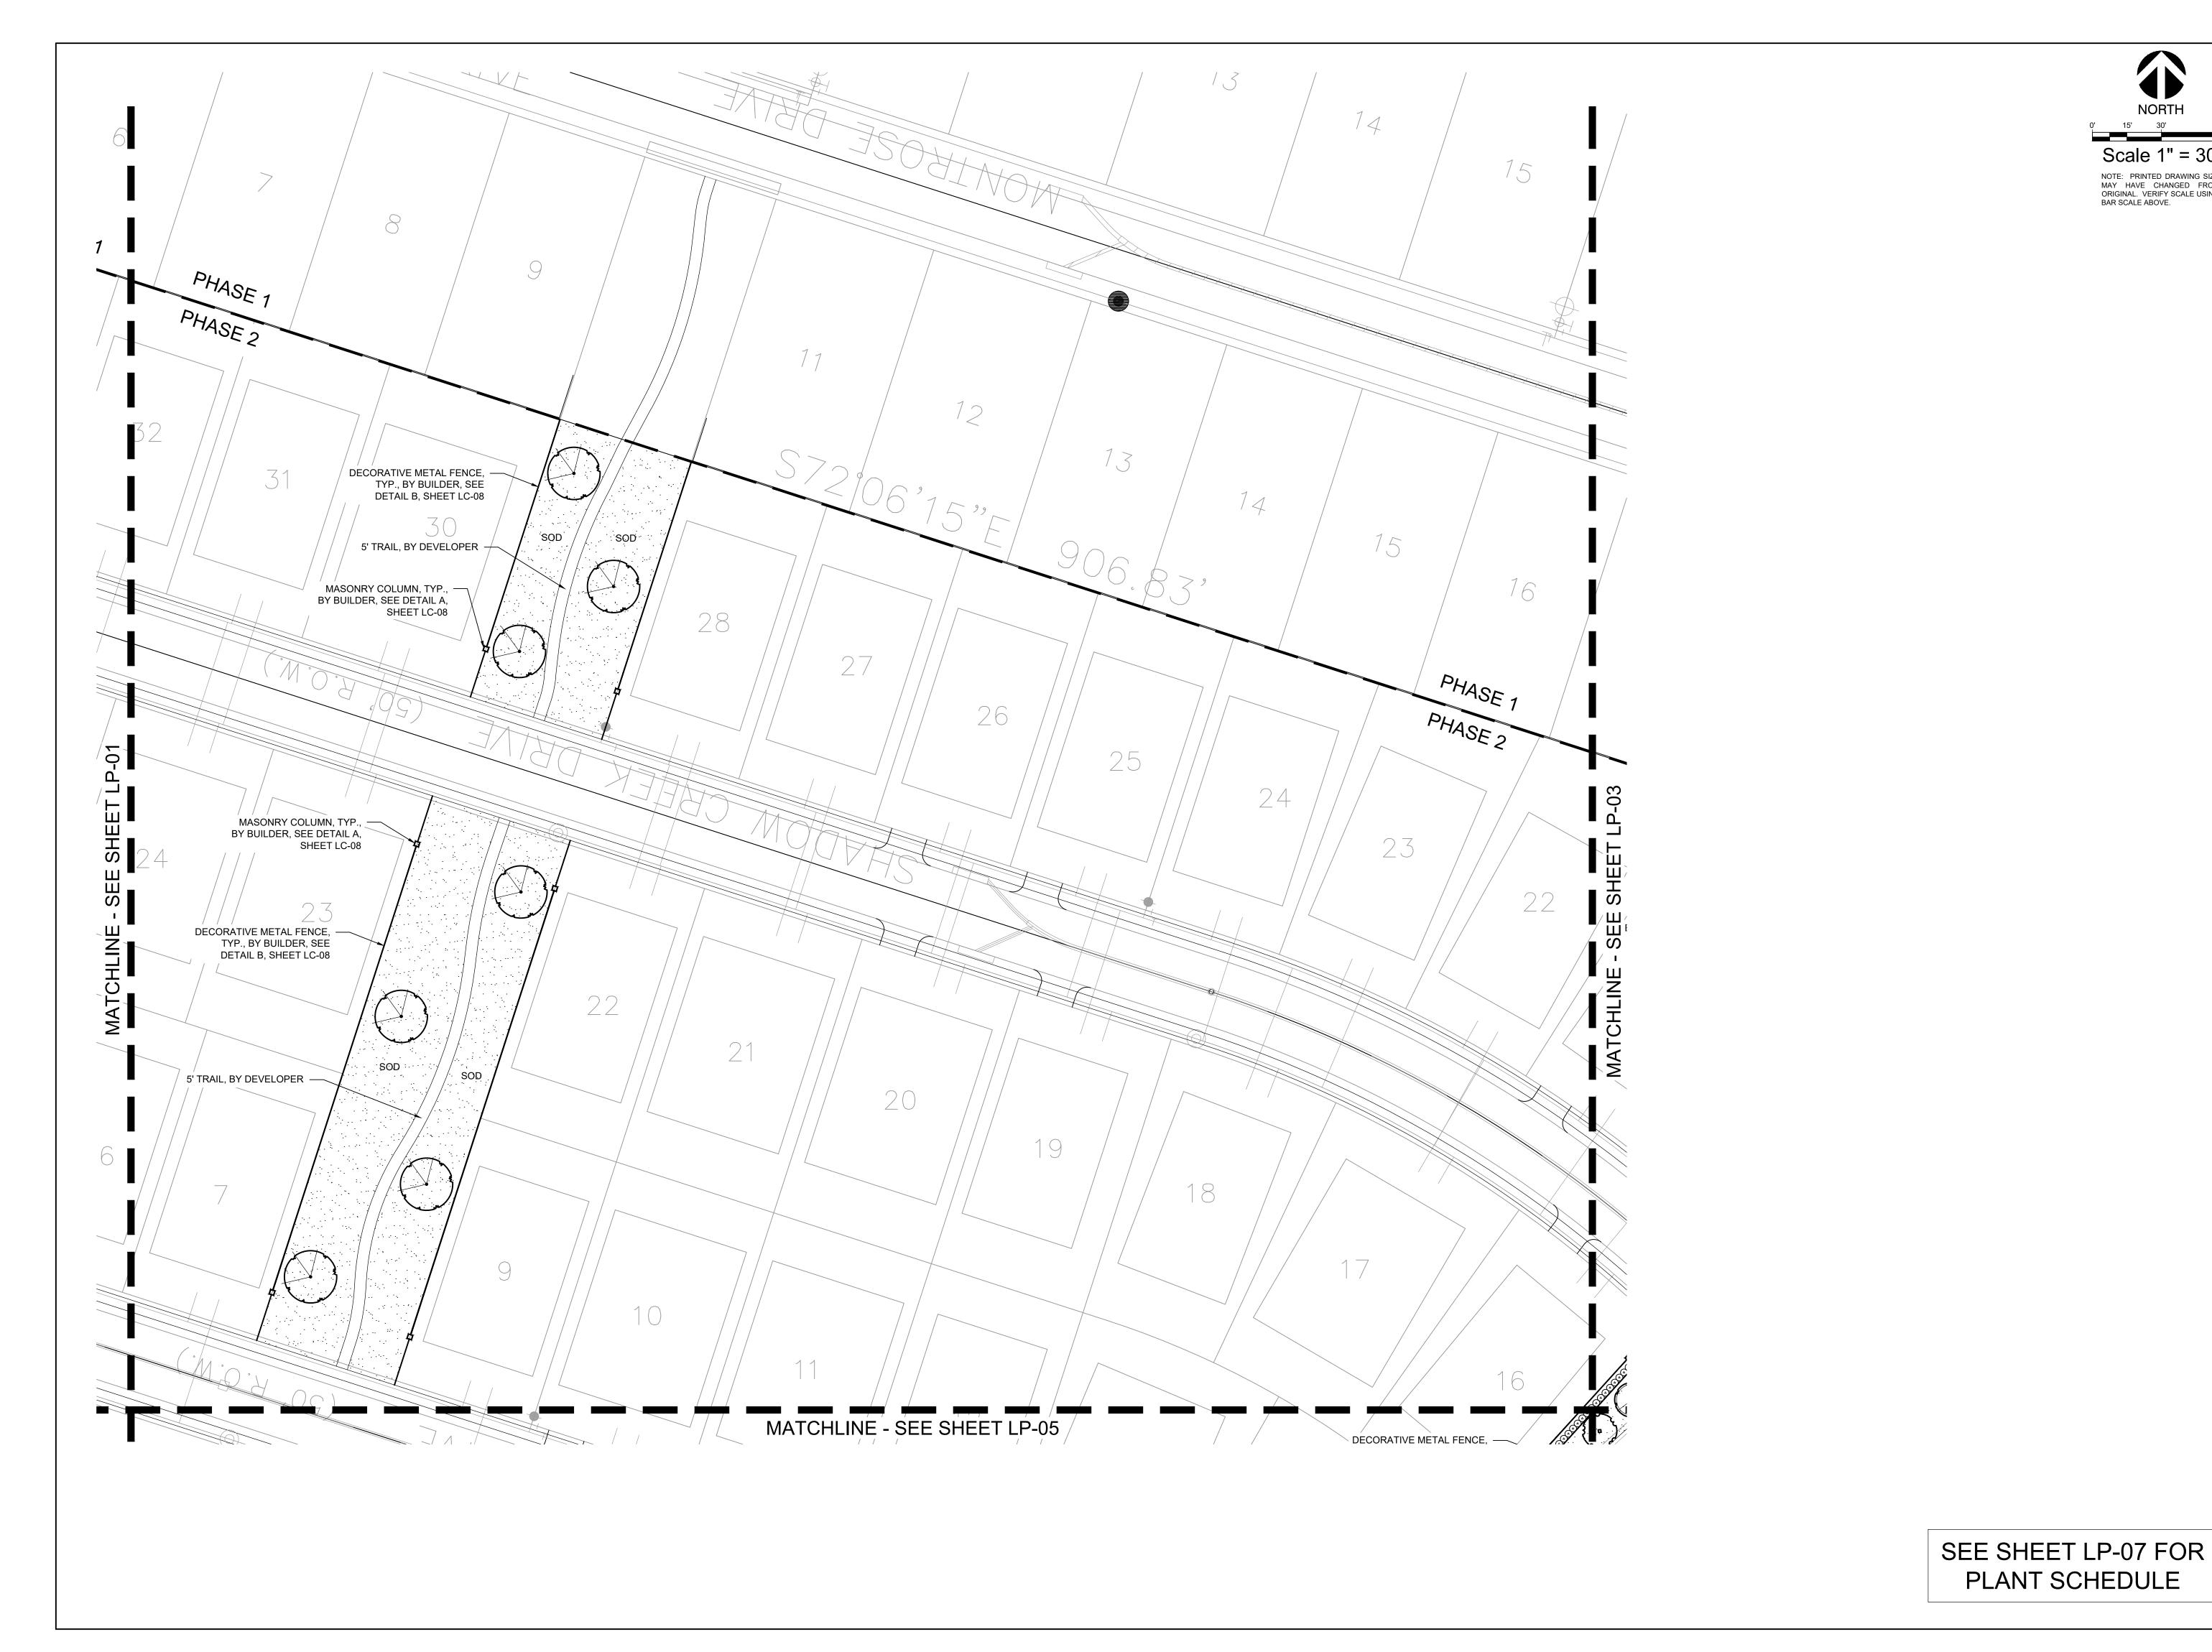
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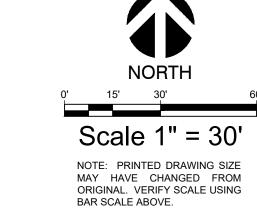
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Quail Hollow Rockwall, TX

HARDSCAPE PLAN

Date Comment








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Date Comment



Scale 1" = 30' NOTE: PRINTED DRAWING SIZE MAY HAVE CHANGED FROM ORIGINAL. VERIFY SCALE USING BAR SCALE ABOVE.




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ISSUED ON: OCTOBER 04, 2024

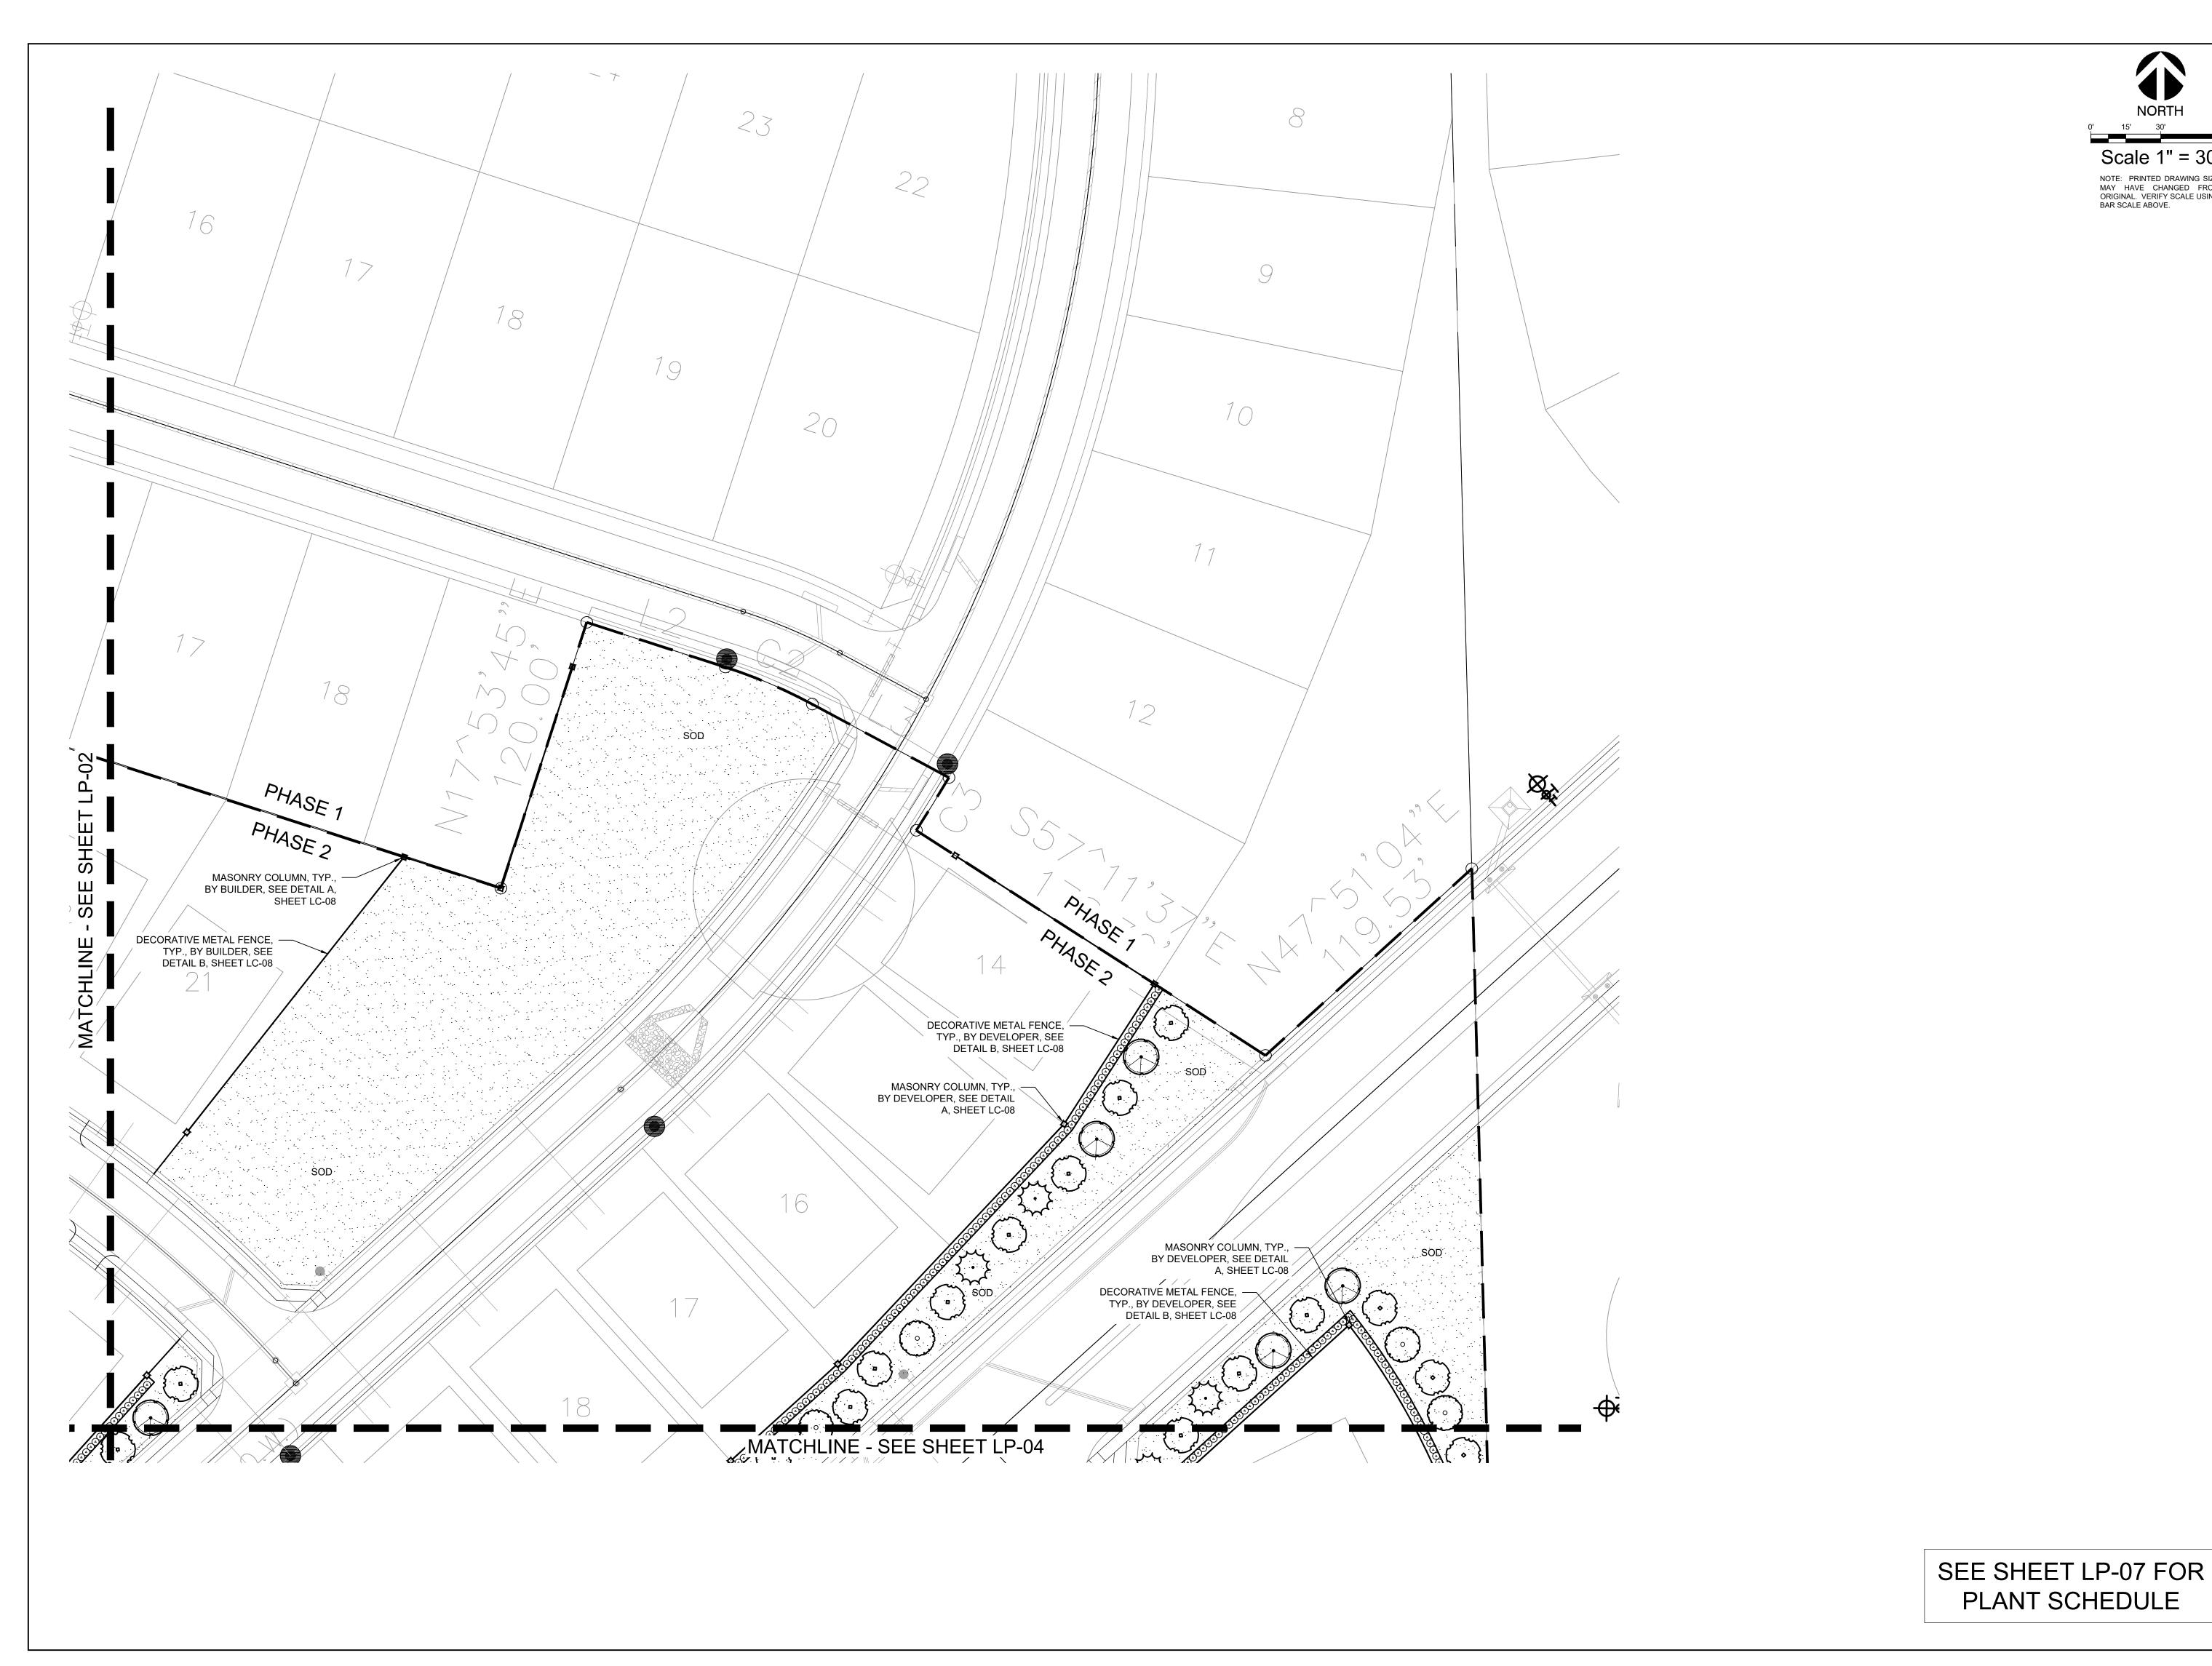Hollow I, TX Quail F Rockwall,

HARDSCAPE PLAN

Date Comment

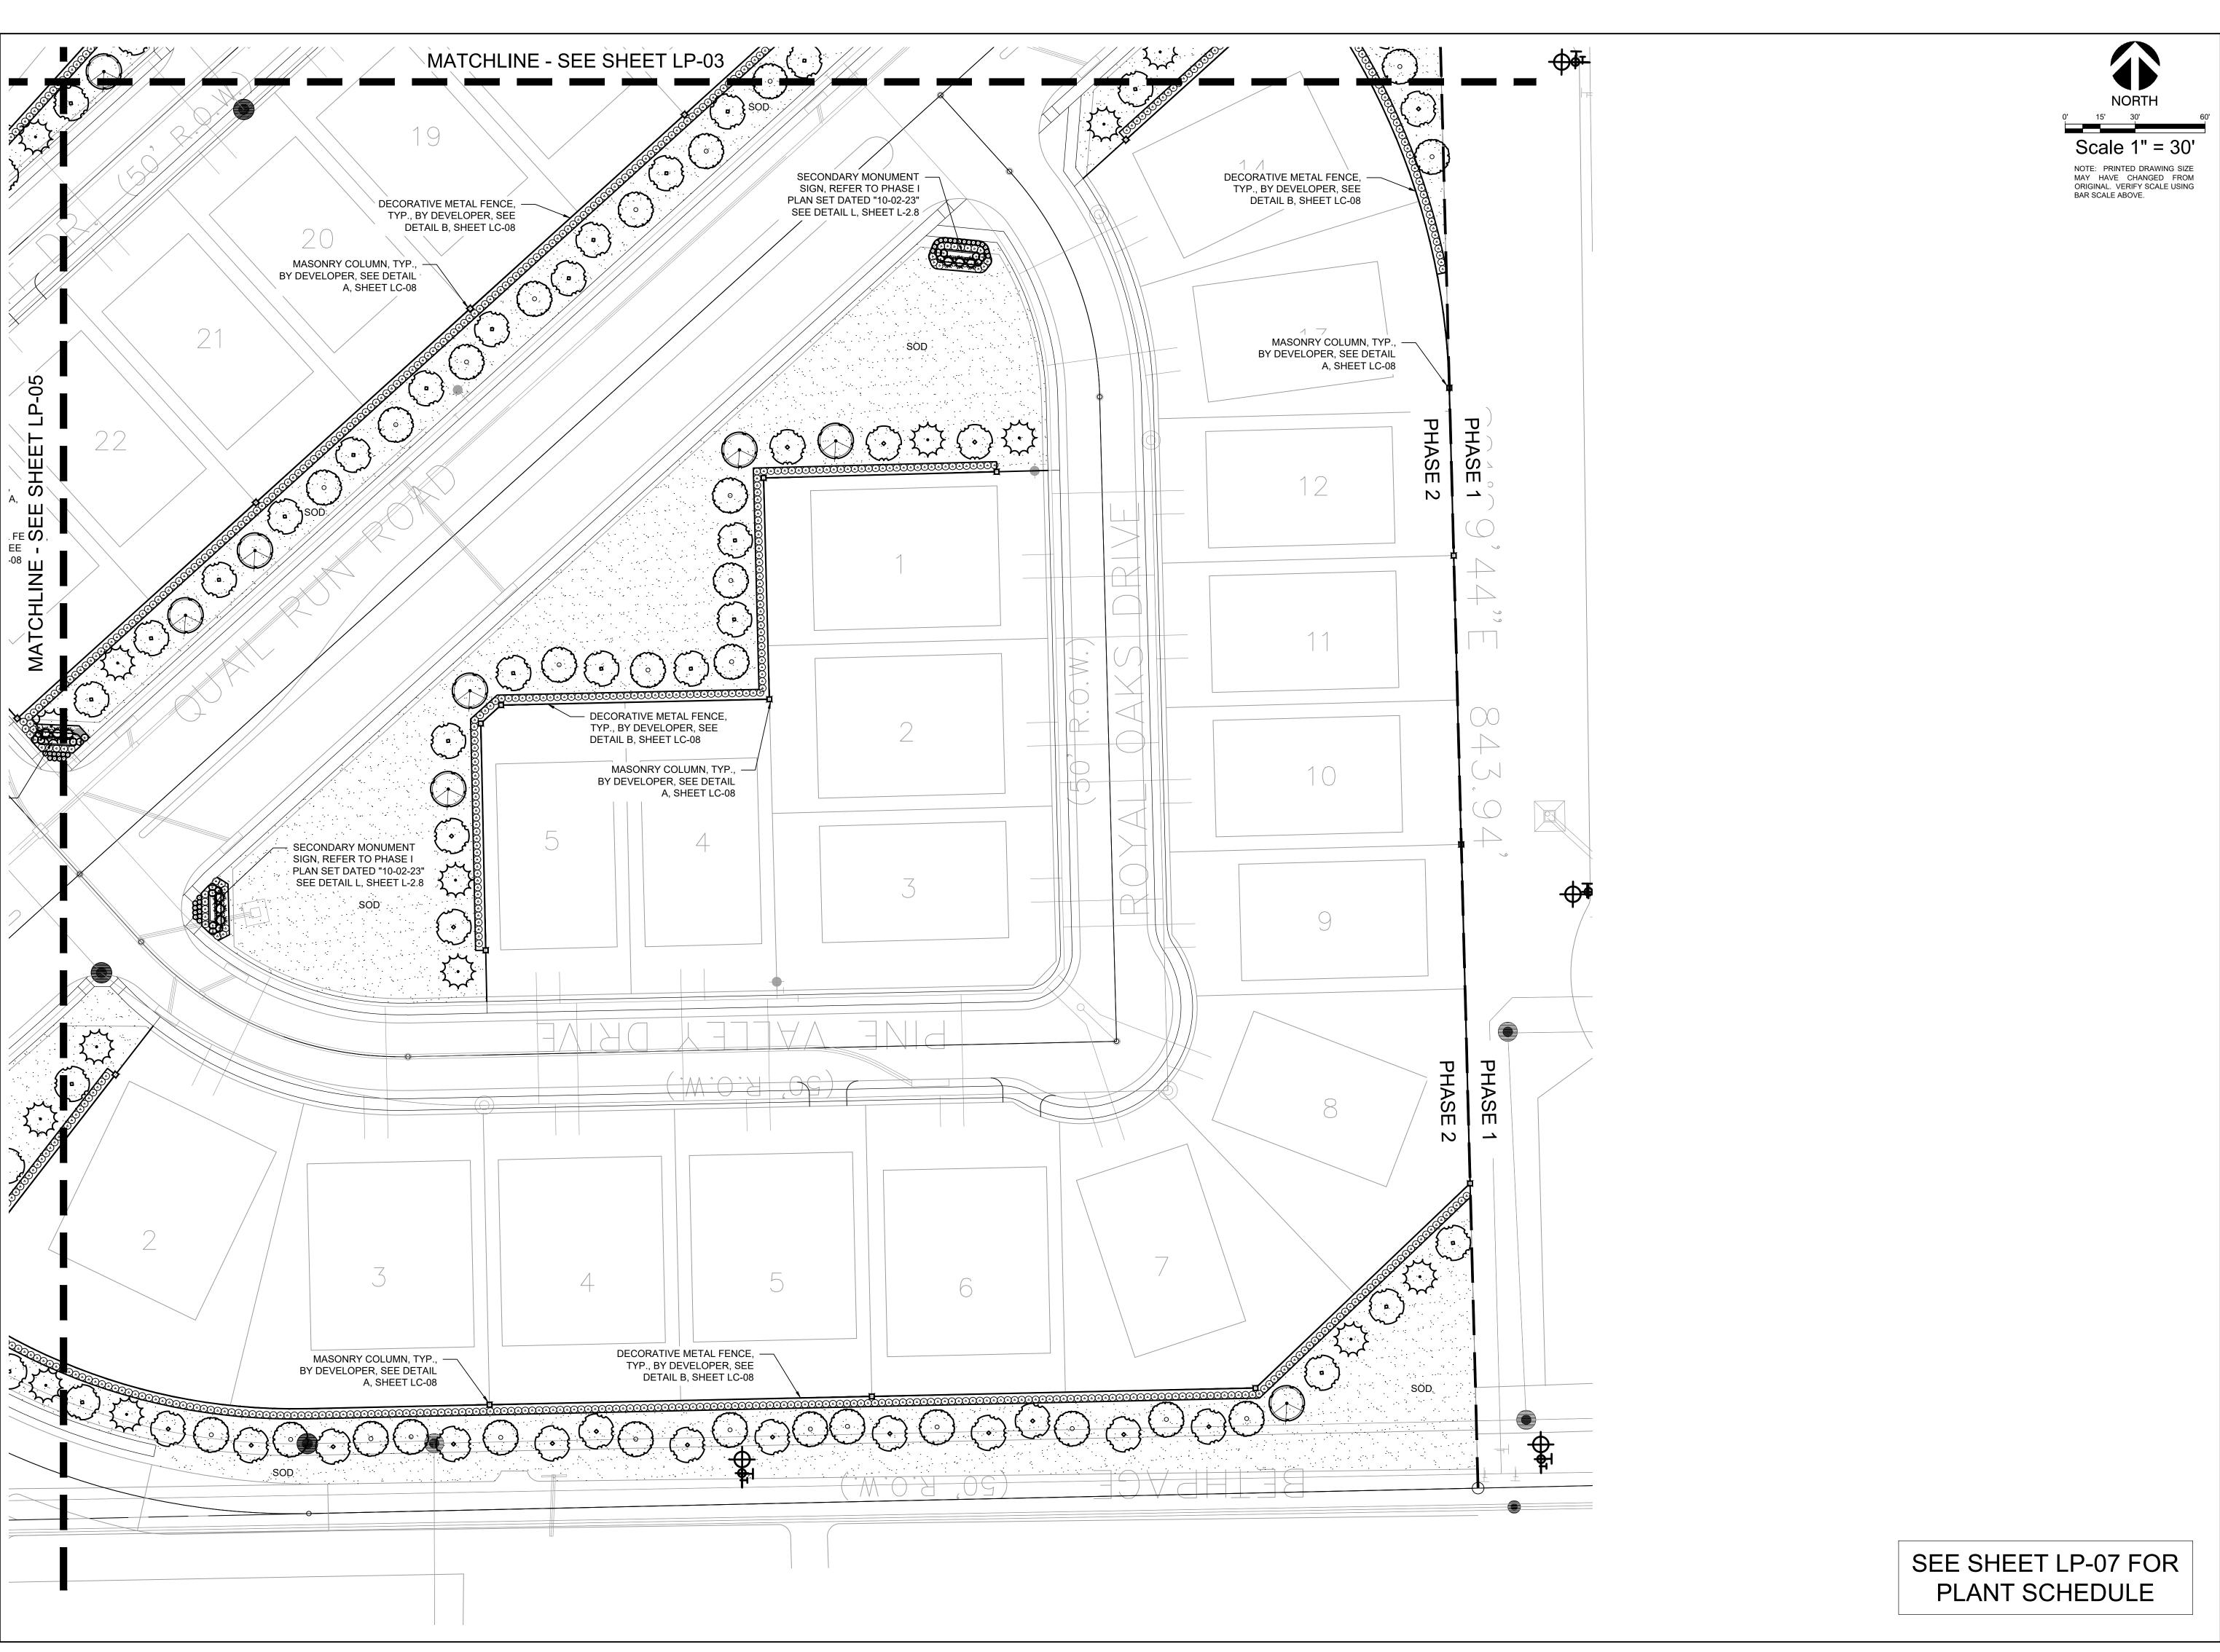

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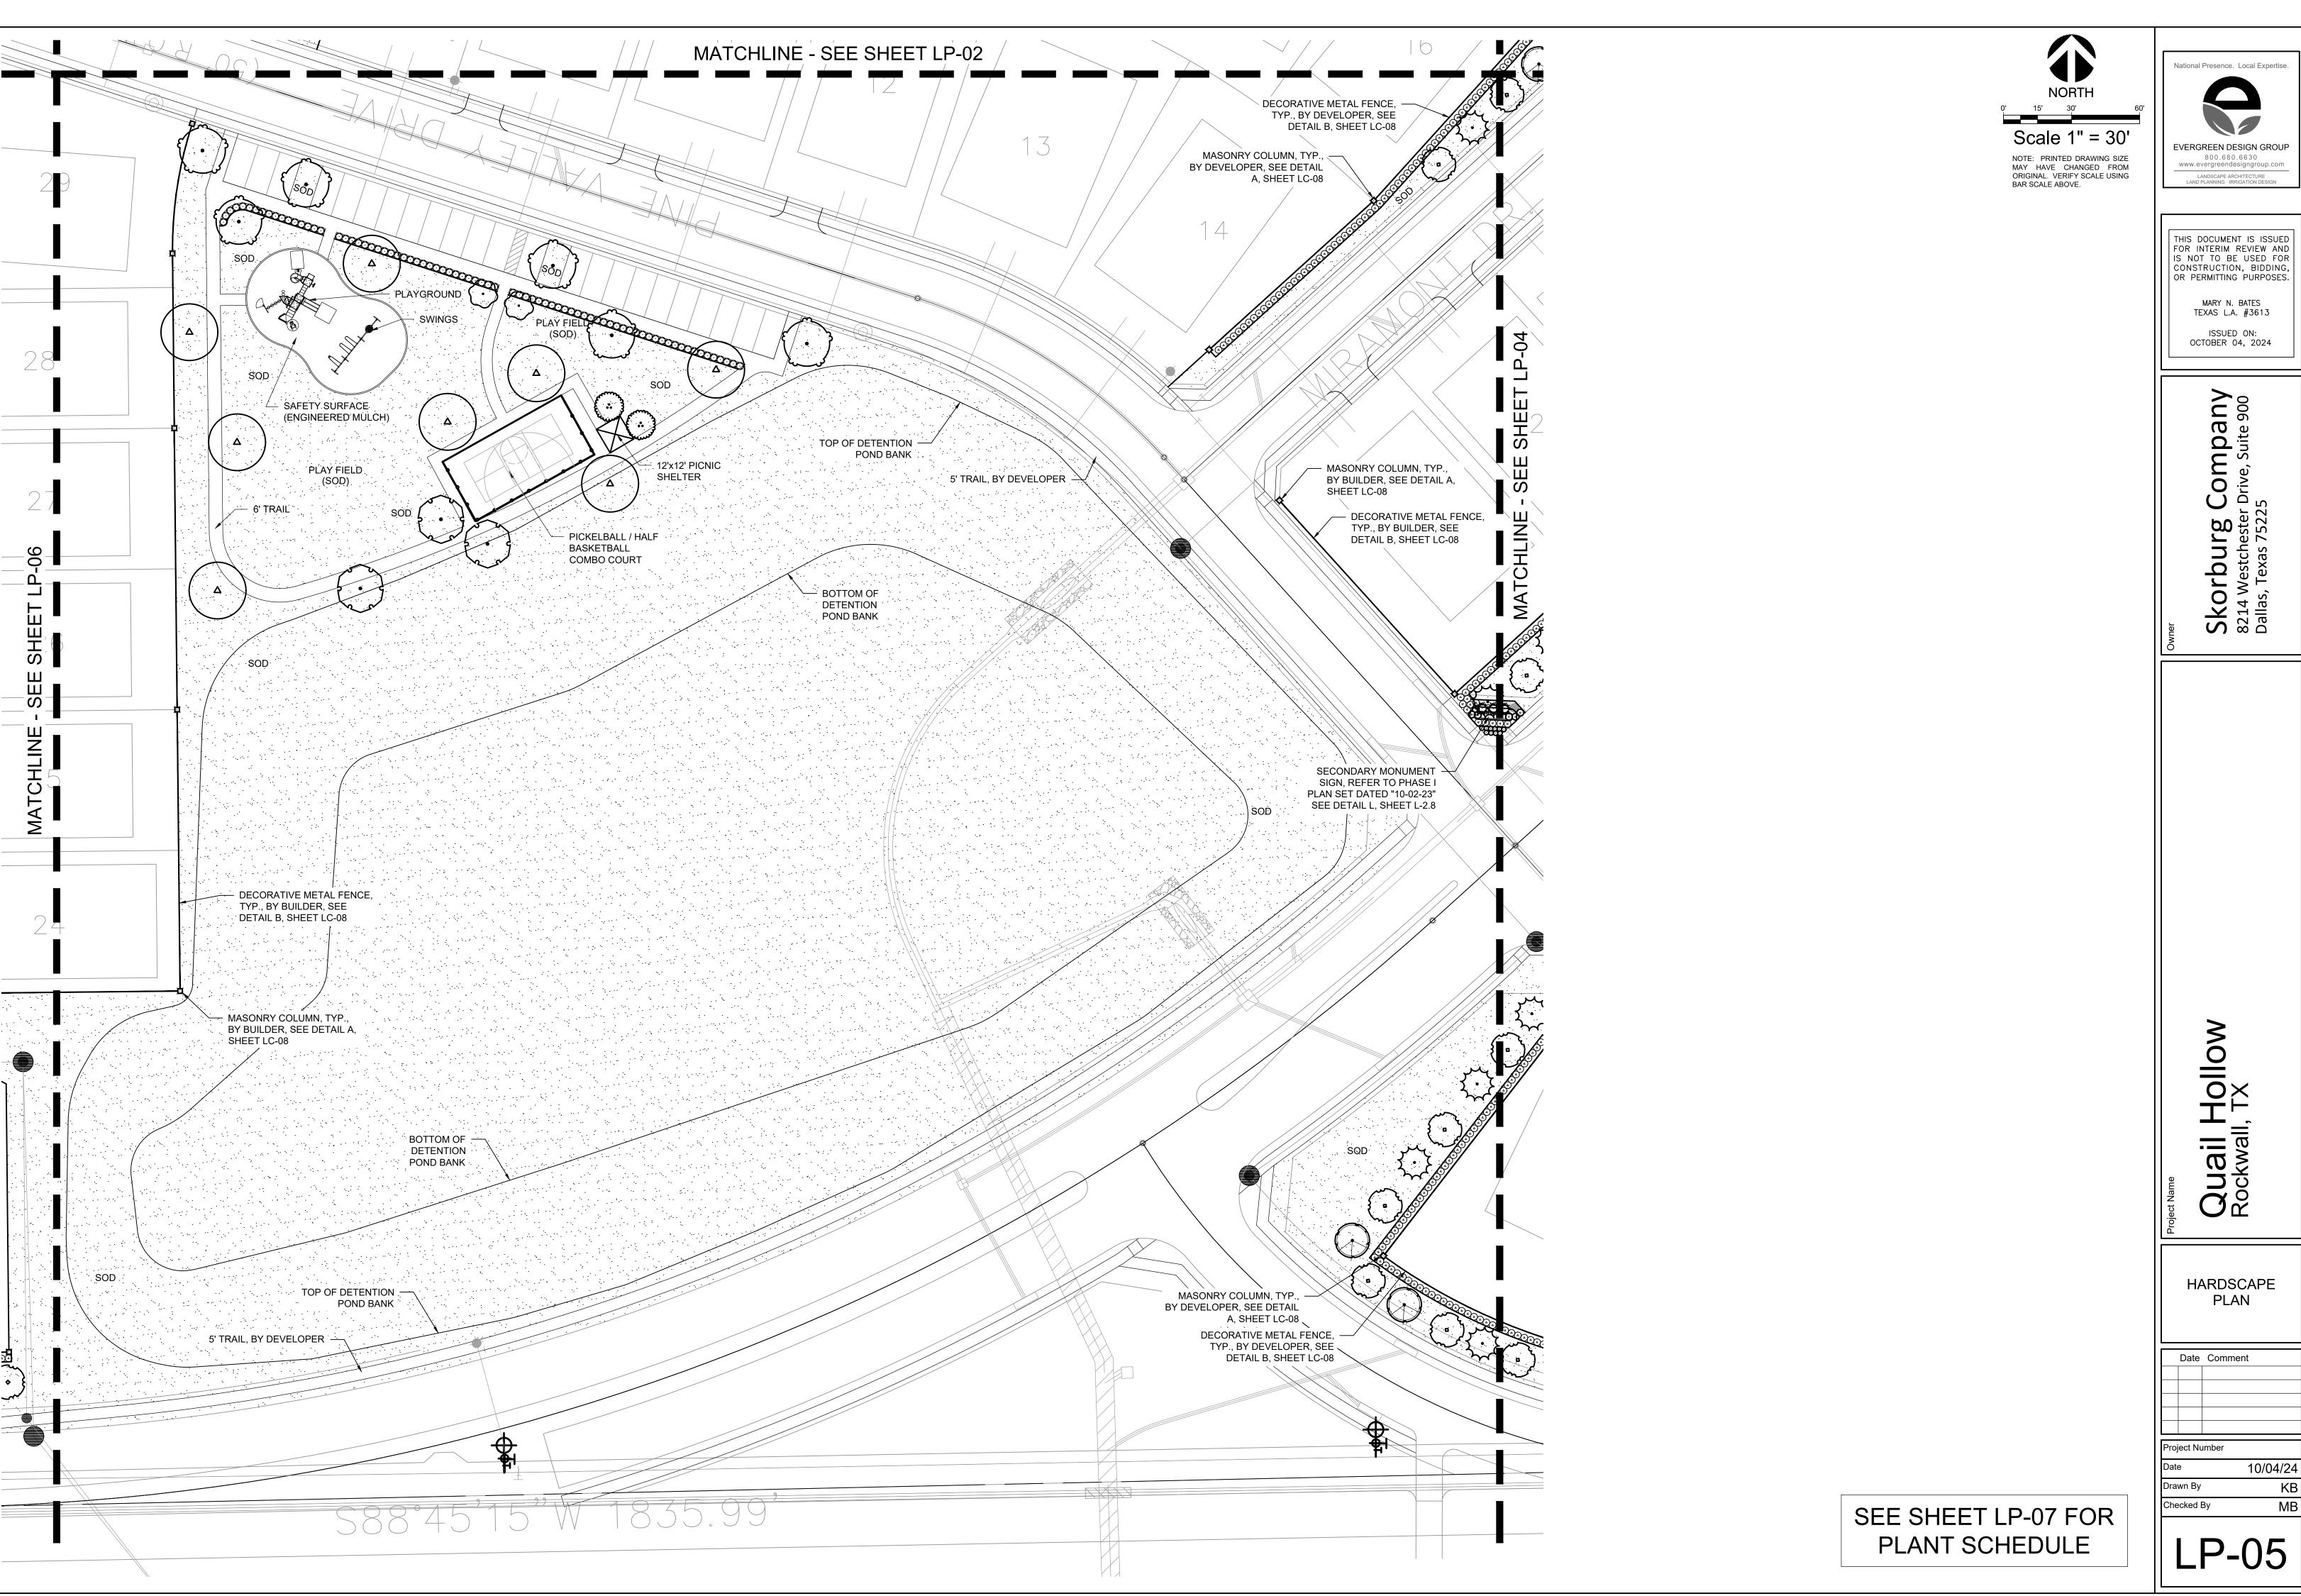
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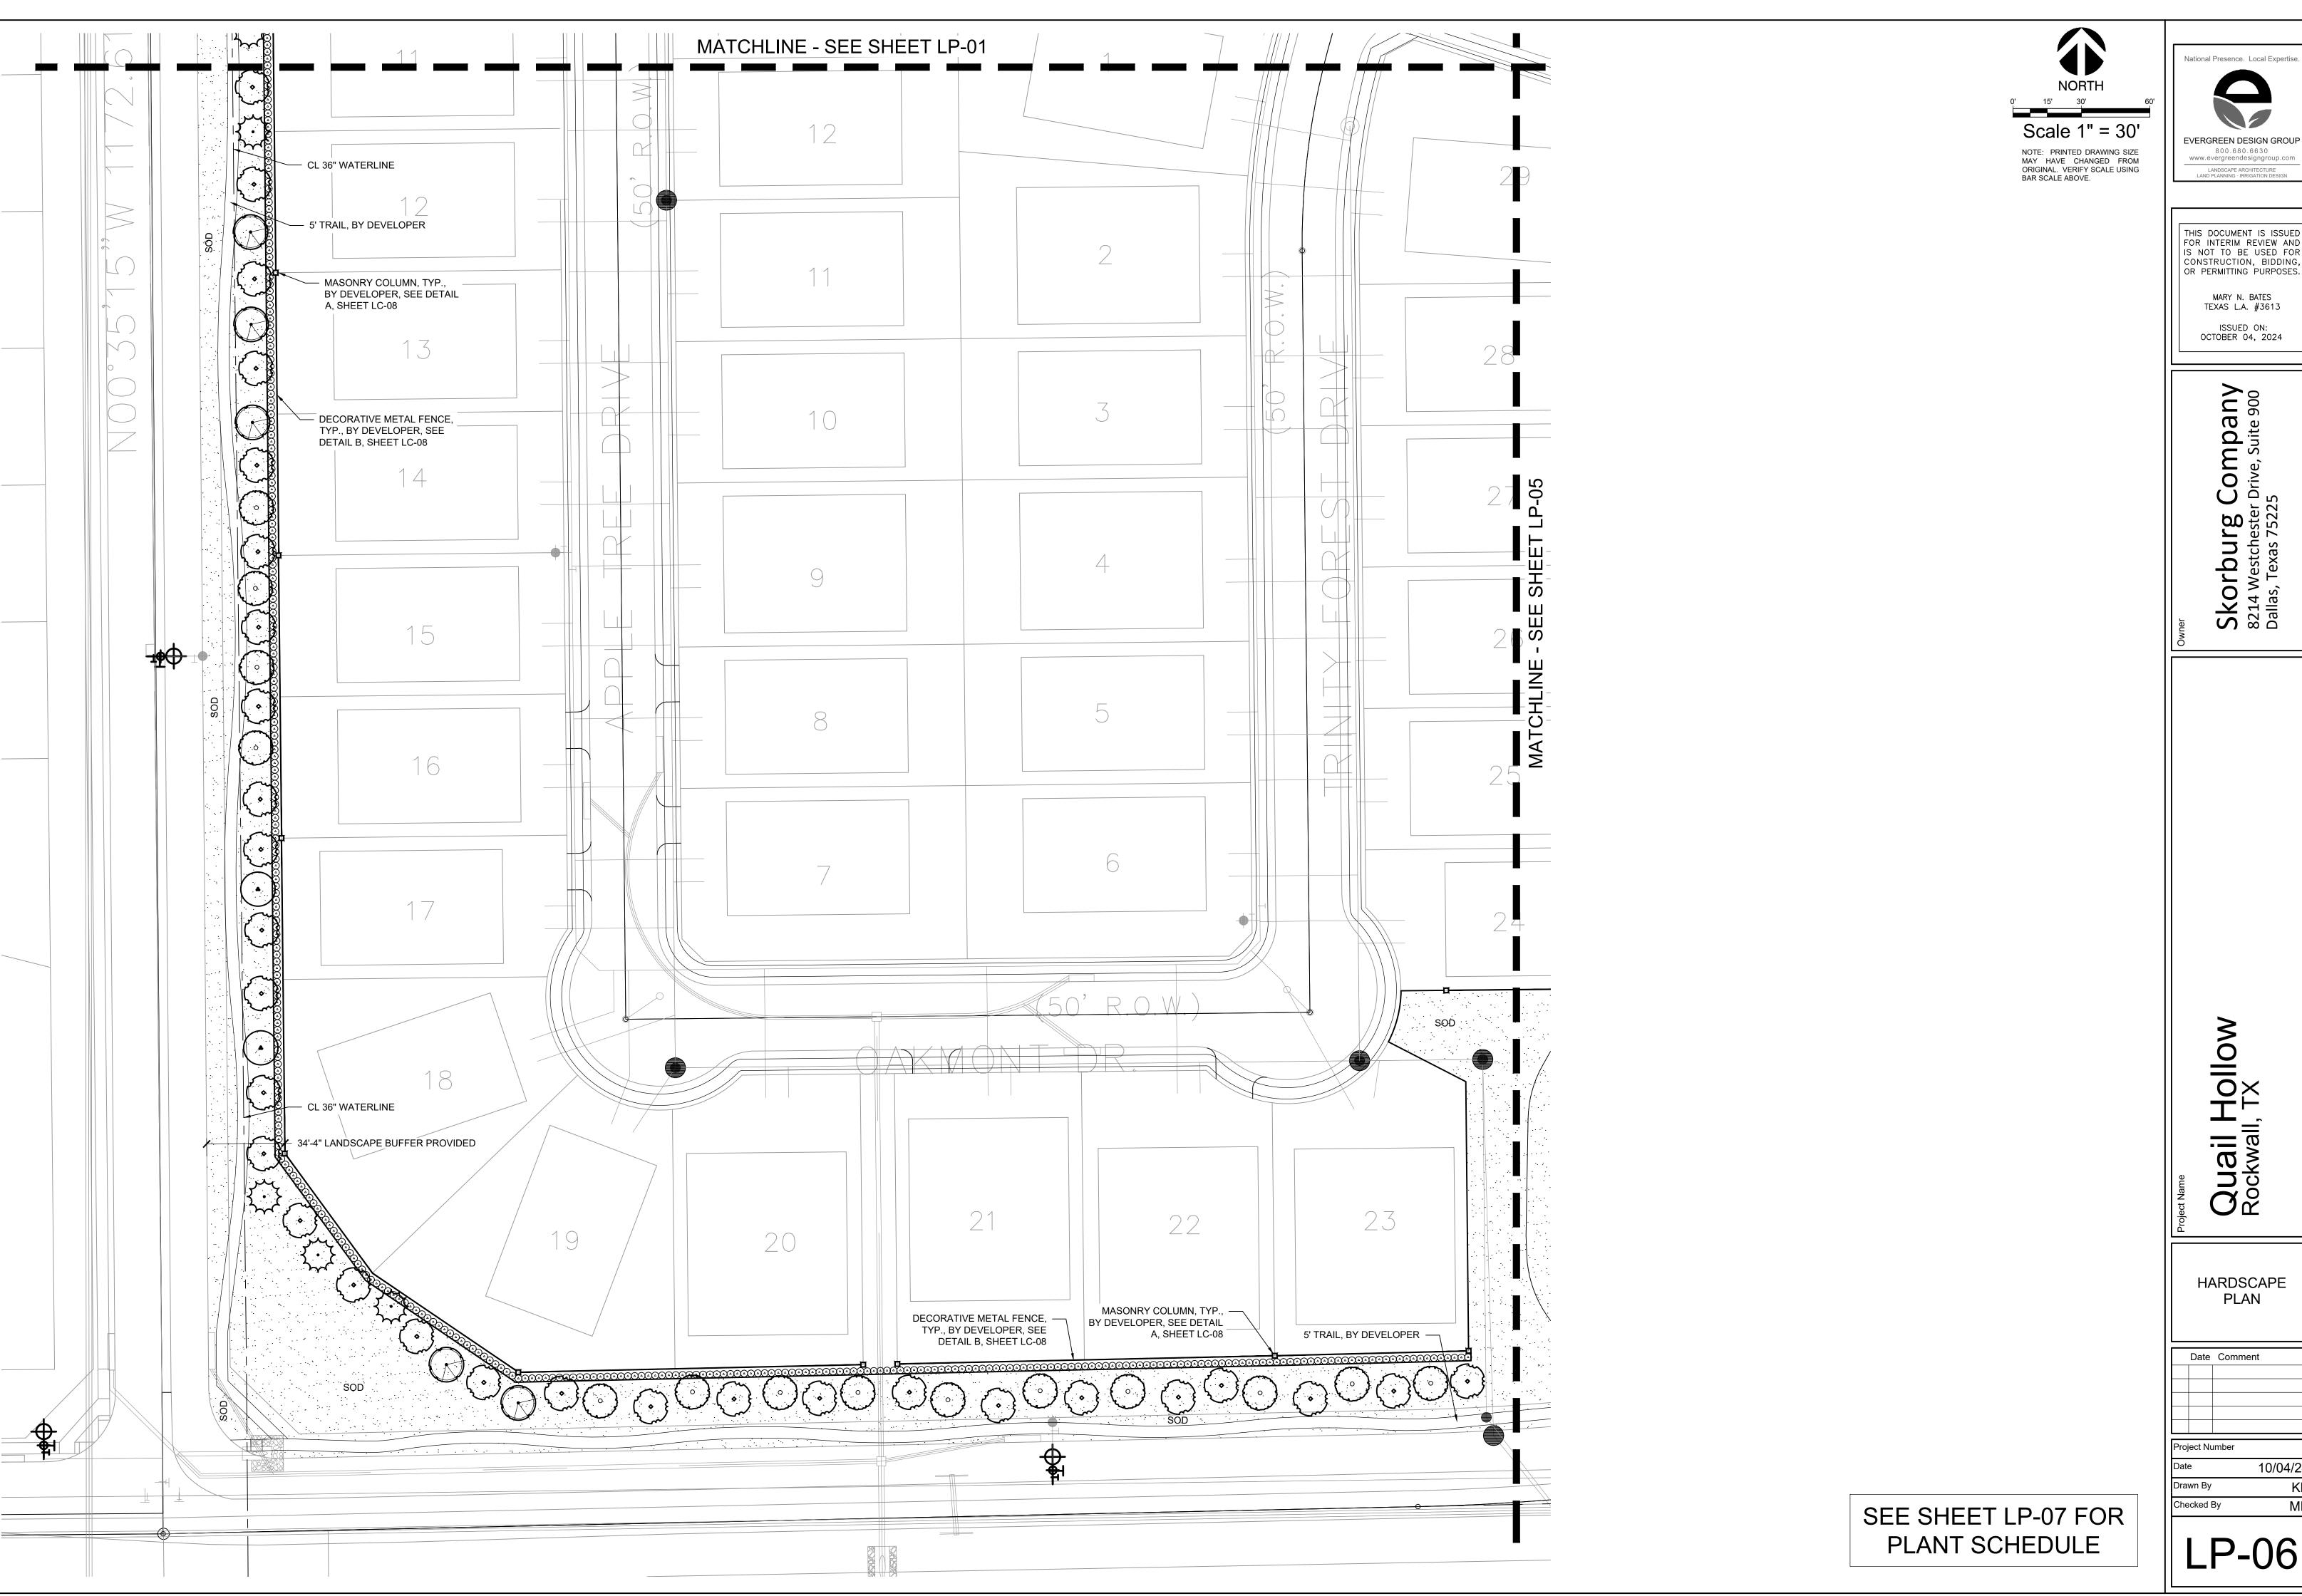
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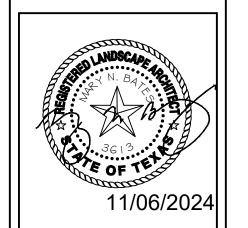
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ANT SCHEDULE								
EES	CODE	QUANTITY	COMMON NAME	BOTANICAL NAME	CONTAINER	CALIPER	SIZE	NOTES
₹·}	CL	24	DESERT WILLOW	CHILOPSIS LINEARIS	CONT OR B & B	4"		FULL, MATCHING, SYMMETRICAL
	ID	23	POSSUMHAW HOLLY	ILEX DECIDUA	CONT OR B & B	4"		FULL, MATCHING, SYMMETRICAL
\odot	IV	47	YAUPON HOLLY	ILEX VOMITORIA	CONT OR B & B	4"		FULL, MATCHING, SYMMETRICAL
	MG	104	DWARF SOUTHERN MAGNOLIA	MAGNOLIA GRANDIFLORA 'LITTLE GEM'	CONT OR B & B	4"		FULL, MATCHING, SYMMETRICAL
	QS	3	SHUMARD OAK	QUERCUS SHUMARDII	CONT OR B & B	4"		FULL, MATCHING, SYMMETRICAL
\odot	QV	8	SOUTHERN LIVE OAK	QUERCUS VIRGINIANA	CONT OR B & B	4"		FULL, MATCHING, SYMMETRICAL
	UC	6	CEDAR ELM	ULMUS CRASSIFOLIA	CONT OR B & B	4"		FULL, MATCHING, SYMMETRICAL
•	US	4	MEXICAN BUCKEYE	UNGNADIA SPECIOSA	CONT OR B & B	4"		FULL, MATCHING, SYMMETRICAL
NAMENTAL TREES	CODE	QUANITITY	COMMON NAME	BOTANICAL NAME	CONTAINER	SIZE	SIZE	NOTES
\bigcirc	CL	2	DESERT WILLOW	CHILOPSIS LINEARIS	CONT OR B & B		4' HT MIN	FULL, MATCHING, SYMMETRICAL
\odot	LI	2	CRAPE MYRTLE	LAGERSTROEMIA INDICA	CONT OR B & B		4' HT MIN	FULL, MATCHING, SYMMETRICAL
RUBS	CODE	QUANITITY	COMMON NAME	BOTANICAL NAME	CONTAINER	SIZE	SPACING	NOTES
	cs	9	PAPAS GRASS	CORTAGERIA SELLOANA	5 GAL.	24" HT.	36" O.C.	FULL, MATCHING, SYMMETRICAL
0	DX	78	DWARF WAX MYRTLE	MYRICA PUSILLA	5 GAL.		36" O.C.	FULL, MATCHING, SYMMETRICAL
0	IC	1345	DWARF BUFORD HOLLY	ILEX CORNUTA 'DWARF BURFORD'	5 GAL.	24" HT.	36" O.C.	FULL, MATCHING, SYMMETRICAL
	MC	18	PINK MUHLY	MUHLENBERGIA CAPILLARIS	5 GAL.	24" HT.	36" O.C.	FULL, MATCHING, SYMMETRICAL
\odot	SG	36	AUTUMN SAGE	SALVIA GREGGII	1 GAL.	12" HT.	24" O.C.	FULL, MATCHING, SYMMETRICAL
)	CODE	QUANITITY	COMMON NAME	BOTANICAL NAME	CONTAINER	SIZE	SPACING	NOTES
SON	SOD	387,179 SF	CYNODON DACTYLON 'TIF 419'	TIF 419 BERMUDAGRASS		SOLID SOD		





Skorburg Company 8214 Westchester Drive, Suite 900 Dallas, Texas 75225

Quail Hollow Rockwall, TX

> HARDSCAPE PLAN

Date Comment

Project Number

 Date
 10/04/24

 Drawn By
 KB

 Checked By
 MB

I P-07

PLANTING SPECIFICATIONS

GENERAL

- A. QUALIFICATIONS OF LANDSCAPE CONTRACTOR ALL LANDSCAPE WORK SHOWN ON THESE PLANS SHALL BE PERFORMED BY A SINGLE FIRM
- SPECIALIZING IN LANDSCAPE PLANTING. A LIST OF SUCCESSFULLY COMPLETED PROJECTS OF THIS TYPE, SIZE AND NATURE MAY BE REQUESTED BY THE OWNER FOR FURTHER QUALIFICATION MEASURES.
- THE LANDSCAPE CONTRACTOR SHALL HOLD A VALID NURSERY AND FLORAL CERTIFICATE ISSUED BY THE TEXAS DEPARTMENT OF AGRICULTURE, AS WELL AS OPERATE UNDER A COMMERCIAL PESTICIDE APPLICATOR LICENSE ISSUED BY EITHER THE TEXAS DEPARTMENT OF AGRICULTURE OR THE TEXAS STRUCTURAL PEST CONTROL BOARD.
- WORK COVERED BY THESE SECTIONS INCLUDES THE FURNISHING AND PAYMENT OF ALL MATERIALS, LABOR SERVICES FOUIPMENT LICENSES TAXES AND ANY OTHER ITEMS THAT ARE NECESSARY FOR THE EXECUTION, INSTALLATION AND COMPLETION OF ALL WORK, SPECIFIED HEREIN AND / OR SHOWN
- ON THE LANDSCAPE PLANS, NOTES, AND DETAILS. ALL WORK SHALL BE PERFORMED IN ACCORDANCE WITH ALL APPLICABLE LAWS, CODES AND REGULATIONS REQUIRED BY AUTHORITIES HAVING JURISDICTION OVER SUCH WORK, INCLUDING ALL INSPECTIONS AND PERMITS REQUIRED BY FEDERAL, STATE AND LOCAL AUTHORITIES IN SUPPLY, TRANSPORTATION AND INSTALLATION OF MATERIALS.
- THE LANDSCAPE CONTRACTOR SHALL VERIFY THE LOCATION OF ALL UNDERGROUND UTILITY LINES (WATER, SEWER, ELECTRICAL, TELEPHONE, GAS, CABLE, TELEVISION, ETC.) PRIOR TO THE START OF

PRODUCTS

- ALL MANUFACTURED PRODUCTS SHALL BE NEW. CONTAINER AND BALLED-AND-BURLAPPED PLANTS
- FURNISH NURSERY-GROWN PLANTS COMPLYING WITH ANSI Z60.1-2014. PROVIDE WELL-SHAPED, FULLY BRANCHED, HEALTHY, VIGOROUS STOCK FREE OF DISEASE, INSECTS, EGGS, LARVAE, AND DEFECTS SUCH AS KNOTS, SUN SCALD, INJURIES, ABRASIONS, AND DISFIGUREMENT. ALL PLANTS WITHIN A SPECIES SHALL HAVE SIMILAR SIZE, AND SHALL BE OF A FORM TYPICAL FOR THE SPECIES. ALL TREES SHALL BE OBTAINED FROM SOURCES WITHIN 200 MILES OF THE PROJECT SITE, AND WITH SIMILAR
- CLIMACTIC CONDITIONS. ROOT SYSTEMS SHALL BE HEALTHY, DENSELY BRANCHED ROOT SYSTEMS, NON-POT-BOUND, FREE FROM ENCIRCLING AND/OR GIRDLING ROOTS, AND FREE FROM ANY OTHER ROOT DEFECTS (SUCH AS
- TREES MAY BE PLANTED FROM CONTAINERS OR BALLED-AND-BURLAPPED (B&B), UNLESS SPECIFIED ON THE PLANTING LEGEND. BARE-ROOT TREES ARE NOT ACCEPTABLE. ANY PLANT DEEMED UNACCEPTABLE BY THE LANDSCAPE ARCHITECT OR OWNER SHALL BE IMMEDIATELY REMOVED FROM THE SITE AND SHALL BE REPLACED WITH AN ACCEPTBLE PLANT OF LIKE
- TYPE AND SIZE AT THE CONTRACTOR'S OWN EXPENSE. ANY PLANTS APPEARING TO BE UNHEALTHY EVEN IF DETERMINED TO STILL BE ALIVE. SHALL NOT BE ACCEPTED. THE LANDSCAPE ARCHITECT AND OWNER SHALL BE THE SOLE JUDGES AS TO THE ACCEPTABILITY OF PLANT MATERIAL
- 5. ALL TREES SHALL BE STANDARD IN FORM, UNLESS OTHERWISE SPECIFIED. TREES WITH CENTRAL LEADERS WILL NOT BE ACCEPTED IF LEADER IS DAMAGED OR REMOVED. PRUNE ALL DAMAGED TWIGS
- CALIPER MEASUREMENTS FOR STANDARD (SINGLE TRUNK) TREES SHALL BE AS FOLLOWS: SIX INCHES ABOVE THE ROOT FLARE FOR TREES UP TO AND INCLUDING FOUR INCHES IN CALIPER, AND TWELVE INCHES ABOVE THE ROOT FLARE FOR TREES EXCEEDING FOUR INCHES IN CALIPER. MULTI-TRUNK TREES SHALL BE MEASURED BY THEIR OVERALL HEIGHT, MEASURED FROM THE TOP OF THE ROOT BALL. WHERE CALIPER MEASUREMENTS ARE USED, THE CALIPER SHALL BE CALCULATED
- AS ONE-HALF OF THE SUM OF THE CALIPER OF THE THREE LARGEST TRUNKS. ANY TREE OR SHRUB SHOWN TO HAVE EXCESS SOIL PLACED ON TOP OF THE ROOT BALL, SO THAT THE ROOT FLARE HAS BEEN COMPLETELY COVERED, SHALL BE REJECTED. SOD: PROVIDE WELL-ROOTED SOD OF THE VARIETY NOTED ON THE PLANS. SOD SHALL BE CUT FROM
- HEALTHY, MATURE TURF WITH SOIL THICKNESS OF 3/4" TO 1". EACH PALLET OF SOD SHALL BE ACCOMPANIED BY A CERTIFICATE FROM SUPPLIER STATING THE COMPOSITION OF THE SOD.
- SEED: PROVIDE BLEND OF SPECIES AND VARIETIES AS NOTED ON THE PLANS, WITH MAXIMUM PERCENTAGES OF PURITY, GERMINATION, AND MINIMUM PERCENTAGE OF WEED SEED AS INDICATED ON PLANS. EACH BAG OF SEED SHALL BE ACCOMPANIED BY A TAG FROM THE SUPPLIER INDICATING THE
- TOPSOIL: SANDY TO CLAY LOAM TOPSOIL, FREE OF STONES LARGER THAN ½ INCH, FOREIGN MATTER, PLANTS, ROOTS, AND SEEDS.
- COMPOST: WELL-COMPOSTED, STABLE, AND WEED-FREE ORGANIC MATTER, pH RANGE OF 5.5 TO 8; MOISTURE CONTENT 35 TO 55 PERCENT BY WEIGHT; 100 PERCENT PASSING THROUGH 3/4-INCH SIEVE; SOLUBLE SALT CONTENT OF 5 TO 10 DECISIEMENS/M; NOT EXCEEDING 0.5 PERCENT INERT CONTAMINANTS AND FREE OF SUBSTANCES TOXIC TO PLANTINGS. NO MANURE OR ANIMAL-BASED PRODUCTS SHALL BE
- G. FERTILIZER: GRANULAR FERTILIZER CONSISTING OF NITROGEN, PHOSPHORUS, POTASSIUM, AND OTHER NUTRIENTS IN PROPORTIONS, AMOUNTS, AND RELEASE RATES RECOMMENDED IN A SOIL REPORT FROM A
- QUALIFIED SOIL-TESTING AGENCY (SEE BELOW). H. MULCH: SIZE AND TYPE AS INDICATED ON PLANS, FREE FROM DELETERIOUS MATERIALS AND SUITABLE AS A TOP DRESSING OF TREES AND SHRUBS. TREE STAKING AND GLIVING
- STAKES: 6' LONG GREEN METAL T-POSTS. GUY AND TIE WIRE: ASTM A 641, CLASS 1, GALVANIZED-STEEL WIRE, 2-STRAND, TWISTED, 0.106 INCH
- STRAP CHAFING GUARD: REINFORCED NYLON OR CANVAS AT LEAST 1-1/2 INCH WIDE, WITH GROMMETS TO PROTECT TREE TRUNKS FROM DAMAGE STEEL EDGING: PROFESSIONAL STEEL EDGING. 14 GAUGE THICK X 4 INCHES WIDE. FACTORY PAINTED DARK
- GREEN. ACCEPTABLE MANUFACTURERS INCLUDE COL-MET OR APPROVED EQUAL. M. PRE-EMERGENT HERBICIDES: ANY GRANULAR, NON-STAINING PRE-EMERGENT HERBICIDE THAT IS LABELED FOR THE SPECIFIC ORNAMENTALS OR TURF ON WHICH IT WILL BE UTILIZED. PRE-EMERGENT HERBICIDES SHALL BE APPLIED PER THE MANUFACTURER'S LABELED RATES.

METHODS

 A. SOIL PREPARATION BEFORE STARTING WORK, THE LANDSCAPE CONTRACTOR SHALL VERIFY THAT THE GRADE OF ALL LANDSCAPE AREAS ARE WITHIN +/-0.1' OF FINISH GRADE. THE CONTRACTOR SHALL NOTIFY THE

OWNER IMMEDIATELY SHOULD ANY DISCREPANCIES EXIST.

- a. AFTER FINISH GRADES HAVE BEEN ESTABLISHED, CONTRACTOR SHALL HAVE SOIL SAMPLES FROM THE PROJECT'S LANDSCAPE AREAS TESTED BY AN ESTABLISHED SOIL TESTING LABORATORY. EACH SAMPLE SUBMITTED TO THE LAB SHALL CONTAIN NO LESS THAN ONE QUART OF SOIL, TAKEN FROM BETWEEN THE SOIL SURFACE AND 6" DEPTH. IF NO SAMPLE LOCATIONS ARE INDICATED ON THE PLANS, THE CONTRACTOR SHALL TAKE A MINIMUM OF THREE SAMPLES FROM VARIOUS REPRESENTATIVE LOCATIONS FOR TESTING.
- THE CONTRACTOR SHALL HAVE THE SOIL TESTING LABORATORY PROVIDE RESULTS FOR THE FOLLOWING: SOIL TEXTURAL CLASS, GENERAL SOIL FERTILITY, pH, ORGANIC MATTER CONTENT, SALT (CEC), LIME, SODIUM ADSORPTION RATIO (SAR) AND BORON CONTENT. c. THE CONTRACTOR SHALL ALSO SUBMIT THE PROJECT'S PLANT LIST TO THE LABORATORY ALONG
- WITH THE SOIL SAMPLES. d. THE SOIL REPORT PRODUCED BY THE LABORATORY SHALL CONTAIN RECOMMENDATIONS FOR THE FOLLOWING (AS APPROPRIATE): SEPARATE SOIL PREPARATION AND BACKFILL MIX RECOMMENDATIONS FOR GENERAL ORNAMENTAL PLANTS, XERIC PLANTS, TURE, AND NATIVE SEED. AS WELL AS PRE-PLANT FERTILIZER APPLICATIONS AND RECOMMENDATIONS FOR ANY OTHER SOIL RELATED ISSUES. THE REPORT SHALL ALSO PROVIDE A FERTILIZER PROGRAM FOR
- THE ESTABLISHMENT PERIOD AND FOR LONG-TERM MAINTENANCE. THE CONTRACTOR SHALL INSTALL SOIL AMENDMENTS AND FERTILIZERS PER THE SOILS REPORT RECOMMENDATIONS. ANY CHANGE IN COST DUE TO THE SOIL REPORT RECOMMENDATIONS. EITHER
- INCREASE OR DECREASE. SHALL BE SUBMITTED TO THE OWNER WITH THE REPORT. FOR BIDDING PURPOSES ONLY, THE SOIL PREPARATION SHALL CONSIST OF THE FOLLOWING TURF: INCORPORATE THE FOLLOWING AMENDMENTS INTO THE TOP 8" OF SOIL BY MEANS OF
- ROTOTILLING AFTER CROSS-RIPPING: NITROGEN STABILIZED ORGANIC AMENDMENT - 4 CU. YDS. PER 1,000 S.F. PREPLANT TURF FERTILIZER (10-20-10 OR SIMILAR, SLOW RELEASE, ORGANIC) - 15 LBS PER 1,000
- iii. "CLAY BUSTER" OR EQUAL USE MANUFACTURER'S RECOMMENDED RATE TREES, SHRUBS, AND PERENNIALS: INCORPORATE THE FOLLOWING AMENDMENTS INTO THE TOP 8" OF SOIL BY MEANS OF ROTOTILLING AFTER CROSS-RIPPING:
- NITROGEN STABILIZED ORGANIC AMENDMENT 4 CU. YDS. PER 1,000 S.F. 12-12-12 FERTILIZER (OR SIMILAR, ORGANIC, SLOW RELEASE) - 10 LBS. PER CU. YD.
- "CLAY BUSTER" OR EQUAL USE MANUFACTURER'S RECOMMENDED RATE IRON SULPHATE - 2 LBS. PER CU. YD. 5. IN THE CONTEXT OF THESE PLANS, NOTES, AND SPECIFICATIONS, "FINISH GRADE" REFERS TO THE
- FINAL ELEVATION OF THE SOIL SURFACE (NOT TOP OF MULCH) AS INDICATED ON THE GRADING PLANS. a. BEFORE STARTING WORK, THE LANDSCAPE CONTRACTOR SHALL VERIFY THAT THE ROUGH GRADES OF ALL LANDSCAPE AREAS ARE WITHIN +/-0.1' OF FINISH GRADE. SEE SPECIFICATIONS FOR MORE DETAILED INSTRUCTION ON TURF AREA AND PLANTING BED PREPARATION.
- CONSTRUCT AND MAINTAIN FINISH GRADES AS SHOWN ON GRADING PLANS, AND CONSTRUCT AND MAINTAIN SLOPES AS RECOMMENDED BY THE GEOTECHNICAL REPORT. ALL LANDSCAPE AREAS SHALL HAVE POSITIVE DRAINAGE AWAY FROM STRUCTURES AT THE MINIMUM SLOPE SPECIFIED IN THE REPORT AND ON THE GRADING PLANS, AND AREAS OF POTENTIAL PONDING SHALL BE REGRADED TO BLEND IN WITH THE SURROUNDING GRADES AND ELIMINATE PONDING
- c. THE LANDSCAPE CONTRACTOR SHALL DETERMINE WHETHER OR NOT THE EXPORT OF ANY SOIL WILL BE NEEDED. TAKING INTO ACCOUNT THE ROUGH GRADE PROVIDED. THE AMOUNT OF SOIL AMENDMENTS TO BE ADDED (BASED ON A SOIL TEST, PER SPECIFICATIONS), AND THE FINISH GRADES TO BE ESTABLISHED.
- d. ENSURE THAT THE FINISH GRADE IN SHRUB AREAS IMMEDIATELY ADJACENT TO WALKS AND OTHER WALKING SURFACES, AFTER INSTALLING SOIL AMENDMENTS, IS 3" BELOW THE ADJACENT FINISH SURFACE IN ORDER TO ALLOW FOR PROPER MUI CHIDEPTH. TAPER THE SOIL SURFACE TO MEET FINISH GRADE, AS SPECIFIED ON THE GRADING PLANS, AT APPROXIMATELY 18" AWAY FROM THE WALKS
- e. ENSURE THAT THE FINISH GRADE IN TURF AREAS IMMEDIATELY ADJACENT TO WALKS AND OTHER WALKING SURFACES, AFTER INSTALLING SOIL AMENDMENTS, IS 1" BELOW THE FINISH SURFACE OF THE WALKS. TAPER THE SOIL SURFACE TO MEET FINISH GRADE, AS SPECIFIED ON THE GRADING PLANS, AT APPROXIMATELY 18" AWAY FROM THE WALKS.
- SHOULD ANY CONFLICTS AND/OR DISCREPANCIES ARISE BETWEEN THE GRADING PLANS, GEOTECHNICAL REPORT, THESE NOTES AND PLANS, AND ACTUAL CONDITIONS, THE CONTRACTOR SHALL IMMEDIATELY BRING SUCH ITEMS TO THE ATTENTION OF THE LANDSCAPE
- ARCHITECT, GENERAL CONTRACTOR, AND OWNER. ONCE SOIL PREPARATION IS COMPLETE, THE LANDSCAPE CONTRACTOR SHALL ENSURE THAT THERE ARE NO DEBRIS, TRASH, OR STONES LARGER THAN 1" REMAINING IN THE TOP 6" OF SOIL.

- THE CONTRACTOR SHALL PROVIDE SUBMITTALS AND SAMPLES, IF REQUIRED, TO THE LANDSCAPE ARCHITECT, AND RECEIVE APPROVAL IN WRITING FOR SUCH SUBMITTALS BEFORE WORK COMMENCES. SUBMITTALS SHALL INCLUDE PHOTOS OF PLANTS WITH A RULER OR MEASURING STICK FOR SCALE, PHOTOS OR SAMPLES OF ANY REQUIRED MULCHES, AND SOIL TEST RESULTS AND PREPARATION RECOMMENDATIONS FROM THE TESTING LAB (INCLUDING COMPOST AND FERTILIZER RATES AND TYPES, AND OTHER AMENDMENTS FOR TREE/SHRUB, TURF, AND SEED AREAS AS MAY BE
 - APPROPRIATE). 3. SUBMITTALS SHALL ALSO INCLUDE MANUFACTURER CUT SHEETS FOR PLANTING ACCESSORIES SUCH AS TREE STAKES AND TIES EDGING AND LANDSCAPE FABRICS (IF ANY) WHERE MULTIPLE ITEMS ARE SHOWN ON A PAGE, THE CONTRACTOR SHALL CLEARLY INDICATE THE ITEM BEING CONSIDERED.
- C. GENERAL PLANTING REMOVE ALL NURSERY TAGS AND STAKES FROM PLANTS.
- EXCEPT IN AREAS TO BE PLANTED WITH ORNAMENTAL GRASSES, APPLY PRE-EMERGENT HERBICIDES AT THE MANUFACTURER'S RECOMMENDED RATE. TRENCHING NEAR EXISTING TREES:
- CONTRACTOR SHALL NOT DISTURB ROOTS 1-1/2" AND LARGER IN DIAMETER WITHIN THE CRITICAL ROOT ZONE (CRZ) OF EXISTING TREES, AND SHALL EXERCISE ALL POSSIBLE CARE AND PRECAUTIONS TO AVOID INJURY TO TREE ROOTS, TRUNKS, AND BRANCHES. THE CRZ IS DEFINED AS A CIRCULAR AREA EXTENDING OUTWARD FROM THE TREE TRUNK. WITH A RADIUS EQUAL TO 1' FOR EVERY 1" OF TRUNK DIAMETER-AT-BREAST-HEIGHT (4.5' ABOVE THE AVERAGE
- ALL EXCAVATION WITHIN THE CRZ SHALL BE PERFORMED USING HAND TOOLS. NO MACHINE EXCAVATION OR TRENCHING OF ANY KIND SHALL BE ALLOWED WITHIN THE CRZ.
- ALTER ALIGNMENT OF PIPE TO AVOID TREE ROOTS 1-1/2" AND LARGER IN DIAMETER. WHERE TREE ROOTS 1-1/2" AND LARGER IN DIAMETER ARE ENCOUNTERED IN THE FIELD, TUNNEL UNDER SUCH ROOTS. WRAP EXPOSED ROOTS WITH SEVERAL LAYERS OF BURLAP AND KEEP MOIST.
- CLOSE ALL TRENCHES WITHIN THE CANOPY DRIP LINES WITHIN 24 HOURS. ALL SEVERED ROOTS SHALL BE HAND PRUNED WITH SHARP TOOLS AND ALLOWED TO AIR-DRY. DO NOT USE ANY SORT OF SEALERS OR WOUND PAINTS.
- TREE PLANTING HOLES SHALL BE EXCAVATED TO MINIMUM WIDTH OF TWO TIMES THE WIDTH OF THE ROOTBALL. AND TO A DEPTH EQUAL TO THE DEPTH OF THE ROOTBALL LESS TWO TO FOUR INCHES. SCARIFY THE SIDES AND BOTTOM OF THE PLANTING HOLE PRIOR TO THE PLACEMENT OF THE TREE. REMOVE ANY GLAZING THAT MAY HAVE BEEN CAUSED DURING THE EXCAVATION OF THE HOLE.
- 3. FOR CONTAINER AND BOX TREES. TO REMOVE ANY POTENTIALLY GIRDLING ROOTS AND OTHER ROOT DEFECTS, THE CONTRACTOR SHALL SHAVE A 1" LAYER OFF OF THE SIDES AND BOTTOM OF THE ROOTBALL OF ALL TREES JUST BEFORE PLACING INTO THE PLANTING PIT. DO NOT "TEASE" ROOTS OUT FROM THE ROOTBALL.
- 4. INSTALL THE TREE ON UNDISTURBED SUBGRADE SO THAT THE TOP OF THE ROOTBALL IS TWO TO FOUR INCHES ABOVE THE SURROUNDING GRADE 5. BACKFILL THE TREE HOLE UTILIZING THE EXISTING TOPSOIL FROM ON-SITE. ROCKS LARGER THAN 1" DIA. AND ALL OTHER DEBRIS SHALL BE REMOVED FROM THE SOIL PRIOR TO THE BACKFILL. SHOULD ADDITIONAL SOIL BE REQUIRED TO ACCOMPLISH THIS TASK. USE STORED TOPSOIL FROM ON-SITE OR

IMPORT ADDITIONAL TOPSOIL FROM OFF-SITE AT NO ADDITIONAL COST TO THE OWNER. IMPORTED

- TOPSOIL SHALL BE OF SIMILAR TEXTURAL CLASS AND COMPOSITION IN THE ON-SITE SOIL. TREES SHALL NOT BE STAKED UNLESS LOCAL CONDITIONS (SUCH AS HEAVY WINDS OR SLOPES) REQUIRE STAKES TO KEEP TREES UPRIGHT. SHOULD STAKING BE REQUIRED. THE TOTAL NUMBER OF TREE STAKES (BEYOND THE MINIMUMS LISTED BELOW) WILL BE LEFT TO THE LANDSCAPE CONTRACTOR'S DISCRETION. SHOULD ANY TREES FALL OR LEAN, THE LANDSCAPE CONTRACTOR SHALL STRAIGHTEN THE TREE, OR REPLACE IT SHOULD IT BECOME DAMAGED. TREE STAKING SHALL
- ADHERE TO THE FOLLOWING GUIDELINES: TWO STAKES PER TREE 2-1/2"-4" TREES THREE STAKES PER TREE
- TREES OVER 4" CALIPER GUY AS NEEDED THREE STAKES PER TREE MINIMUM, QUANTITY AND POSITIONS AS MULTI-TRUNK TREES NEEDED TO STABILIZE THE TREE
- UPON COMPLETION OF PLANTING, CONSTRUCT AN EARTH WATERING BASIN AROUND THE TREE. COVER THE INTERIOR OF THE TREE RING WITH THE WEED BARRIER CLOTH AND TOPDRESS WITH MULCH (TYPE AND DEPTH PER PLANS).
- SHRUB, PERENNIAL, AND GROUNDCOVER PLANTING DIG THE PLANTING HOLES TWICE AS WIDE AND 2" LESS DEEP THAN EACH PLANT'S ROOTBALL. INSTALL THE PLANT IN THE HOLE. BACKFILL AROUND THE PLANT WITH SOIL AMENDED PER SOIL TEST
- RECOMMENDATIONS. INSTALL THE WEED BARRIER CLOTH, OVERLAPPING IT AT THE ENDS. UTILIZE STEEL STAPLES TO KEEP THE WEED BARRIER CLOTH IN PLACE. WHEN PLANTING IS COMPLETE, INSTALL MULCH (TYPE AND DEPTH PER PLANS) OVER ALL PLANTING BEDS. COVERING THE ENTIRE PLANTING AREA.
- F. SODDING SOD VARIETY TO BE AS SPECIFIED ON THE LANDSCAPE PLAN. LAY SOD WITHIN 24 HOURS FROM THE TIME OF STRIPPING. DO NOT LAY IF THE GROUND IS FROZEN. LAY THE SOD TO FORM A SOLID MASS WITH TIGHTLY FITTED JOINTS. BUTT ENDS AND SIDES OF SOD STRIPS - DO NOT OVERLAP STAGGER STRIPS TO DESET JOINTS IN ADJACENT COLIRSES.

4 ROLL THE SOD TO ENSURE GOOD CONTACT OF THE SOD'S ROOT SYSTEM WITH THE SOIL

- 5. WATER THE SOD THOROUGHLY WITH A FINE SPRAY IMMEDIATELY AFTER PLANTING TO OBTAIN AT LEAST SIX INCHES OF PENETRATION INTO THE SOIL BELOW THE SOD.
- G. HYDROMULCHING 1. TURF HYDROMULCH MIX (PER 1,000 SF) SHALL BE AS FOLLOWS:
 - WINTER MIX (OCTOBER 1 MARCH 31) 50# CELLULOSE FIBER MULCH P# UNHULLED BERMUDA SEED
 - # ANNUAL RYE SEED 15# 15-15-15 WATER SOLUBLE FERTILIZER
 - 50# CELLULOSE FIBER MULCH
- HULLED BERMUDA SEED 15# 15-15-15 WATER SOLUBLE FERTILIZER
- 2. SEED HYDROMULCH MIX (PER 1,000 SF) SHALL BE AS FOLLOWS:
- 50# CELLULOSE FIBER MULCH 15# 15-15-15 WATER SOLUBLE FERTILIZER
- SEED RATE PER LEGEND
- ALL SEED SHALL BE DRILL SEEDED AT THE RATES SHOWN ON THE PLANS, WITH A HYDROMULCH MIX APPLIED AFTER SEEDING.
- THE HYDROMULCH MIX (PER 1.000 SF) SHALL BE AS FOLLOWS: 50# CELLULOSE FIBER MULCH
- 15# 15-15-15 WATER SOLUBLE FERTILIZER 4# ORGANIC BINDER
- MULCH
- 1. INSTALL MULCH TOPDRESSING, TYPE AND DEPTH PER MULCH NOTE, IN ALL PLANTING AREAS AND TREE RINGS. 2. DO NOT INSTALL MULCH WITHIN 6" OF TREE ROOT FLARE AND WITHIN 24" OF HABITABLE STRUCTURES, EXCEPT AS MAY BE NOTED ON THESE PLANS. MULCH COVER WITHIN 6" OF CONCRETE WALKS AND CURBS SHALL NOT PROTRUDE ABOVE THE FINISH SURFACE OF THE WALKS AND CURBS. MULCH
- COVER WITHIN 12" OF WALLS SHALL BE AT LEAST 3" LOWER THAN THE TOP OF WALL. 1. DURING LANDSCAPE PREPARATION AND PLANTING, KEEP ALL PAVEMENT CLEAN AND ALL WORK AREAS
- IN A NEAT, ORDERLY CONDITION. DISPOSED LEGALLY OF ALL EXCAVATED MATERIALS OFF THE PROJECT SITE. K. INSPECTION AND ACCEPTANCE
- 1. UPON COMPLETION OF THE WORK, THE LANDSCAPE CONTRACTOR SHALL PROVIDE THE SITE CLEAN, FREE OF DEBRIS AND TRASH, AND SUITABLE FOR USE AS INTENDED. THE LANDSCAPE CONTRACTOR SHALL THEN REQUEST AN INSPECTION BY THE OWNER TO DETERMINE FINAL ACCEPTABILITY. 2. WHEN THE INSPECTED PLANTING WORK DOES NOT COMPLY WITH THE CONTRACT DOCUMENTS, THE LANDSCAPE CONTRACTOR SHALL REPLACE AND/OR REPAIR THE REJECTED WORK TO THE OWNER'S
- SATISFACTION WITHIN 24 HOURS. THE LANDSCAPE MAINTENANCE PERIOD WILL NOT COMMENCE UNTIL THE LANDSCAPE WORK HAS BEEN RE-INSPECTED BY THE OWNER AND FOUND TO BE ACCEPTABLE. AT THAT TIME, A WRITTEN NOTICE OF FINAL ACCEPTANCE WILL BE ISSUED BY THE OWNER, AND THE MAINTENANCE AND GUARANTEE PERIODS WILL COMMENCE.
- LANDSCAPE MAINTENANCE THE LANDSCAPE CONTRACTOR SHALL BE RESPONSIBLE FOR THE MAINTENANCE OF ALL WORK SHOWN ON THESE PLANS FOR 90 DAYS BEYOND FINAL ACCEPTANCE OF ALL LANDSCAPE WORK BY THE OWNER. LANDSCAPE MAINTENANCE SHALL INCLUDE WEEKLY SITE VISITS FOR THE FOLLOWING ACTIONS (AS APPROPRIATE): PROPER PRUNING, RESTAKING OF TREES, RESETTING OF PLANTS THAT HAVE SETTLED, MOWING AND AERATION OF LAWNS, WEEDING, RESEEDING AREAS WHICH HAVE NOT GERMINATED WELL, TREATING FOR INSECTS AND DISEASES, REPLACEMENT OF MULCH, REMOVAL OF LITTER, REPAIRS TO THE IRRIGATION SYSTEM DUE TO FAULTY PARTS AND/OR WORKMANSHIP, AND THE APPROPRIATE WATERING OF ALL PLANTINGS. THE LANDSCAPE CONTRACTOR SHALL MAINTAIN THE IRRIGATION SYSTEM IN PROPER WORKING ORDER, WITH SCHEDULING ADJUSTMENTS BY SEASON
- TO MAXIMIZE WATER CONSERVATION. SHOULD SEEDED AND/OR SODDED AREAS NOT BE COVERED BY AN AUTOMATIC IRRIGATION SYSTEM. THE LANDSCAPE CONTRACTOR SHALL BE RESPONSIBLE FOR WATERING THESE AREAS AND OBTAINING A FULL HEALTHY STAND OF PLANTS AT NO ADDITIONAL COST TO THE OWNER TO ACHIEVE FINAL ACCEPTANCE AT THE END OF THE MAINTENANCE PERIOD, ALL OF THE FOLLOWING CONDITIONS MUST OCCUR-


THE LANDSCAPE SHALL SHOW ACTIVE, HEALTHY GROWTH (WITH EXCEPTIONS MADE FOR

GROWTH. BARE AREAS LARGER THAN TWELVE SQUARE INCHES MUST BE RESODDED OR

- SEASONAL DORMANCY). ALL PLANTS NOT MEETING THIS CONDITION SHALL BE REJECTED AND REPLACED BY HEALTHY PLANT MATERIAL PRIOR TO FINAL ACCEPTANCE ALL HARDSCAPE SHALL BE CLEANED PRIOR TO FINAL ACCEPTANCE. SODDED AREAS MUST BE ACTIVELY GROWING AND MUST REACH A MINIMUM HEIGHT OF 1 1/2 INCHES BEFORE FIRST MOWING. HYDROMULCHED AREAS SHALL SHOW ACTIVE, HEALTHY
- RESEEDED (AS APPROPRIATE) PRIOR TO FINAL ACCEPTANCE. ALL SODDED TURF SHALL BE NEATLY MOWED. M. WARRANTY PERIOD, PLANT GUARANTEE AND REPLACEMENTS THE LANDSCAPE CONTRACTOR SHALL GUARANTEE ALL TREES, SHRUBS, PERENNIALS, SOD, SEEDED/HYDROMULCHED AREAS, AND IRRIGATION SYSTEMS FOR A PERIOD OF ONE YEAR FROM THE DATE OF THE OWNER'S FINAL ACCEPTANCE (90 DAYS FOR ANNUAL PLANTS). THE CONTRACTOR SHALL REPLACE, AT HIS OWN EXPENSE AND TO THE SATISFACTION OF THE OWNER, ANY PLANTS WHICH DIE IN THAT TIME, OR REPAIR ANY PORTIONS OF THE IRRIGATION SYSTEM WHICH OPERATE IMPROPERLY.
- CANNOT BE ATTRIBUTED DIRECTLY TO OVERWATERING OR OTHER DAMAGE BY HUMAN ACTIONS. PROVIDE A MINIMUM OF (2) COPIES OF RECORD DRAWINGS TO THE OWNER UPON COMPLETION OF WORK. A RECORD DRAWING IS A RECORD OF ALL CHANGES THAT OCCURRED IN THE FIELD AND THAT ARE DOCUMENTED THROUGH CHANGE ORDERS, ADDENDA, OR CONTRACTOR/CONSULTANT DRAWING MARKUPS.

2. AFTER THE INITIAL MAINTENANCE PERIOD AND DURING THE GUARANTEE PERIOD, THE LANDSCAPE

CONTRACTOR SHALL ONLY BE RESPONSIBLE FOR REPLACEMENT OF PLANTS WHEN PLANT DEATH

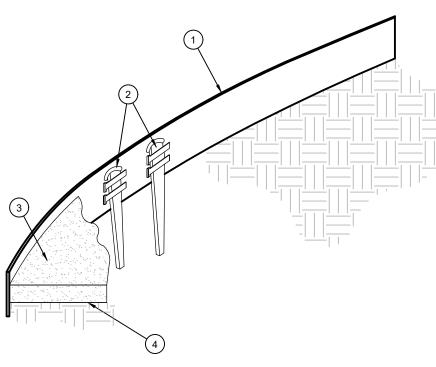

- (1) ROLLED-TOP STEEL EDGING PER PLANS.
- (2) TAPERED STEEL STAKES. (3) MULCH, TYPE AND DEPTH PER PLANS.
- 1) INSTALL EDGING SO THAT STAKES WILL BE ON INSIDE OF PLANTING BED. BOTTOM OF EDGING SHALL BE BURIED A MINIMUM OF 1" BELOW FINISH GRADE

DISTANCE PER PLAN

(2) MULCH LAYER

(4) TURF (WHERE SHOWN ON PLAN).

(1) TYPICAL WALKWAY OR PAVING

TYPICAL PLANTING AREA

TYPICAL CURB AND GUTTER

1) INSTALL ROOT BARRIERS NEAR ALL

NEWLY-PLANTED TREES THAT ARE LOCATED

WITHIN FIVE (5) FEET OF PAVING OR CURBS.

2) BARRIERS SHALL BE LOCATED IMMEDIATELY

USE ROOT BARRIERS OF A TYPE THAT

COMPLETELY ENCIRCLE THE ROOTBALL

ADJACENT TO HARDSCAPE. UNDER NO

CIRCUMSTANCES SHALL THE CONTRACTOR

LINEAR ROOT BARRIER MATERIAL. SEE

PLANTING NOTES FOR TYPE AND

MANUFACTURER'S SPECIFICATIONS.

MANUFACTURER. INSTALL PER

TREE TRUNK

TREE CANOPY

(3) PLANT.

PLANTING AT PARKING AREA

ROOT BARRIER - PLAN VIEW

OPEN LANDSCAPE


PARKWAY

OR ISLAND


24" MIN. TO EDGE

OF MATURE CANOPY



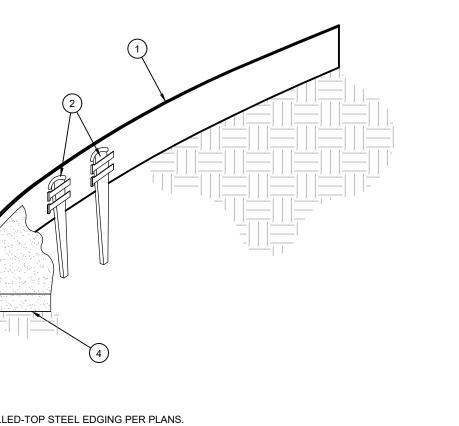

(4) FINISH GRADE. 3) TOP OF MULCH SHALL BE 1" LOWER THAN TOP OF EDGING.

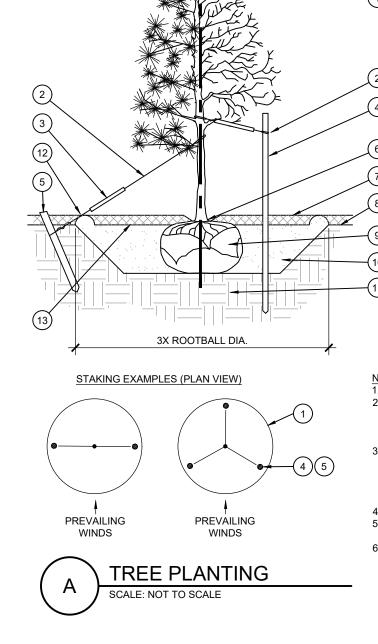

CONIFEROUS

NON-CONIFEROUS

(1) TREE CANOPY. CINCH-TIES (24" BOX/2" CAL. TREES AND SMALLER) OR

12 GAUGE GAI VANIZED WIRE WITH NYI ON TREE STRAPS AT TREE AND STAKE (36" BOX/2.5" CAL. TREES AND LARGER). SECURE TIES OR STRAPS TO TRUNK JUST ABOVE LOWEST MAJOR BRANCHES

(3) 24" X 3/4" P.V.C. MARKERS OVER WIRES.

(4) GREEN STEEL T-POSTS. EXTEND POSTS 12" MIN. INTO UNDISTURBED SOIL.

PRESSURE-TREATED WOOD DEADMAN, TWO PER TREE (MIN.). BURY OUTSIDE OF PLANTING PIT AND

18" MIN. INTO UNDISTURBED SOIL. (6) TRUNK FLARE

7) MULCH, TYPE AND DEPTH PER PLANS. DO NOT PLACE MULCH WITHIN 6" OF TRUNK.

(8) FINISH GRADE

9) ROOT BALL.

10) BACKFILL. AMEND AND FERTILIZE ONLY AS RECOMMENDED IN SOIL FERTILITY ANALYSIS.

(11) UNDISTURBED NATIVE SOIL. (12) 4" HIGH EARTHEN WATERING BASIN.

(13) FINISH GRADE.

SCARIFY SIDES OF PLANTING PIT PRIOR TO SETTING TREE. REMOVE EXCESS SOIL APPLIED ON TOP OF THE ROOTBALL THAT COVERS THE ROOT FLARE. THE PLANTING HOLE DEPTH SHALL BE SUCH THAT THE ROOTBALL RESTS ON UNDISTURBED SOIL, AND THE

ROOT FLARE IS 2"-4" ABOVE FINISH GRADE. FOR B&B TREES, CUT OFF BOTTOM 1/3 OF WIRE BASKET BEFORE PLACING TREE IN HOLE, CUT OFF AND REMOVE REMAINDER OF BASKET AFTER TREE IS SET IN HOLE, REMOVE ALL NYLON TIES, TWINE, ROPE, AND OTHER PACKING MATERIAL. REMOVE AS MUCH BURLAP FROM AROUND ROOTBALL AS IS PRACTICAL.

REMOVE ALL NURSERY STAKES AFTER PLANTING. 5. FOR TREES 36" BOX/2.5" CAL. AND LARGER, USE THREE STAKES OR DEADMEN (AS APPROPRIATE), SPACED EVENLY AROUND TREE.

6 STAKING SHALL BE TIGHT ENOUGH TO PREVENT TRUNK FROM BENDING, BUT LOOSE ENOUGH TO ALLOW SOME TRUNK MOVEMENT

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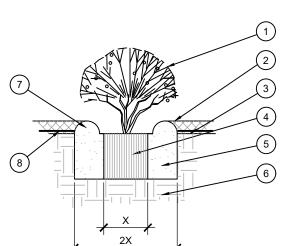
MARY N. BATES

TEXAS L.A. #3613

ISSUED ON:


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- (1) SHRUB, PERENNIAL, OR ORNAMENTAL GRASS.
- 2) MULCH, TYPE AND DEPTH PER PLANS. PLACE NO MORE THAN 1" OF MULCH WITHIN 6" OF PLANT CENTER.
- (3) FINISH GRADE
- (4) ROOT BALL.
- (5) BACKFILL, AMEND AND FERTILIZE ONLY AS
- (6) UNDISTURBED NATIVE SOIL.
- (7) 3" HIGH EARTHEN WATERING BASIN.
- (8) WEED FABRIC UNDER MULCH.

SHRUB AND PERENNIAL PLANTING



NOTE: ALL PLANTS SHALL BE PLANTED AT EQUAL TRIANGULAR SPACING (EXCEPT WHERE SHOWN ON PLANS AS INFORMAL GROUPINGS). REFER TO PLANT LEGEND FOR SPACING DISTANCE BETWEEN PLANTS. 1) STEP 1: DETERMINE TOTAL PLANTS FOR THE AREA WITH THE FOLLOWING FORMULA:

TOTAL AREA / AREA DIVIDER = TOTAL PLANTS PLANT SPACING AREA DIVIDER

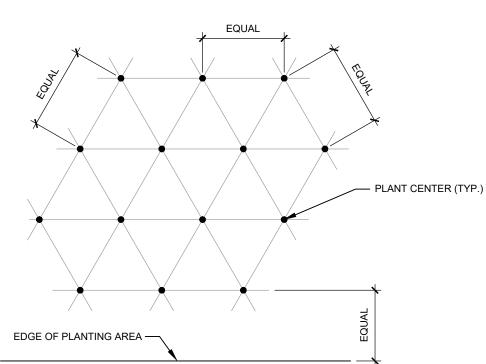2) STEP 2: SUBTRACT THE ROW (S) OF PLANTS THAT WOULD OCCUR AT THE EDGE OF THE PLANTED AREA WITH THE FOLLOWING FORMULA: TOTAL PERIMETER LENGTH / PLANT SPACING = TOTAL PLANT SUBTRACTION

EXAMPLE: PLANTS AT 18" O.C. IN 100 SF PLANTING AREA, 40 LF PERIMETER STEP 1: 100 SF/1.95 = 51 PLANTS STEP 2: 51 PLANTS - (40 LF / 1.95 = 21 PLANTS) = 30 PLANTS TOTAL

0 ail kwall

> **HARDSCAPE** PLAN

Date Comment

roject Number 10/04/24 Drawn By

Checked By




NOTARY PUBLIC IN AND FOR THE STATE OF TEXAS

DEVELOPMENT APPLICATION

City of Rockwall Planning and Zoning Department 385 S. Goliad Street Rockwall, Texas 75087

PLANNING & ZONING CASE NO.
<u>NOTE:</u> THE APPLICATION IS NOT CONSIDERED ACCEPTED BY THE CITY UNTIL THE PLANNING DIRECTOR AND CITY ENGINEER HAVE SIGNED BELOW.
DIRECTOR OF PLANNING:
CITY ENGINEER:

	Nockwall, Texas 75007	СПУ	ENGINEER:	HER THERE	
PLEASE CHECK THE	APPROPRIATE BOX BELOW TO INDICATE THE TYPE C	OF DEVELOPMENT RE	QUEST [SELECT ONLY ONE BOX]:	
☐ PRELIMINARY ☐ FINAL PLAT (\$3 ☐ REPLAT (\$300.) ☐ AMENDING OR ☐ PLAT REINSTA SITE PLAN APPLI ☑ SITE PLAN (\$25	(\$100.00 + \$15.00 ACRE) 1 PLAT (\$200.00 + \$15.00 ACRE) 1 300.00 + \$20.00 ACRE) 1 00 + \$20.00 ACRE) 1 MINOR PLAT (\$150.00) TEMENT REQUEST (\$100.00)	☐ ZONING CH. ☐ SPECIFIC USE ☐ PD DEVELO OTHER APPLICE ☐ TREE REMOUNT. ☐ VARIANCE FOR NOTES: 1: IN DETERMINING PER ACRE AMOUNT. 2: A \$1,000.00 FEE	ZONING APPLICATION FEES: ☐ ZONING CHANGE (\$200.00 + \$15.00 ACRE) ¹ ☐ SPECIFIC USE PERMIT (\$200.00 + \$15.00 ACRE) ¹ ☐ PD DEVELOPMENT PLANS (\$200.00 + \$15.00 ACRE) ¹ OTHER APPLICATION FEES: ☐ TREE REMOVAL (\$75.00) ☐ VARIANCE REQUEST/SPECIAL EXCEPTIONS (\$100.00) ² NOTES: ¹: IN DETERMINING THE FEE, PLEASE USE THE EXACT ACREAGE WHEN MULTIPLYING BY THE PER ACRE AMOUNT. FOR REQUESTS ON LESS THAN ONE ACRE, ROUND UP TO ONE (1) ACRE. ²: A \$1.000.00 FEE WILL BE ADDED TO THE APPLICATION FEE FOR ANY REQUEST THAT INVOLVES CONSTRUCTION WITHOUT OR NOT IN COMPLIANCE TO AN APPROVED BUILDING		
PROPERTY INFO	ORMATION [PLEASE PRINT]				
ADDRES	s was the same of				
SUBDIVISIO	N Quail Hollow Phase 2		LOT	BLOCK	
GENERAL LOCATIO	Northeast Corner of Hays Lane	and Quail Rur	Road		
ZONING. SITE P	LAN AND PLATTING INFORMATION [PLEAS	SE PRINTI			
CURRENT ZONIN		CURRENT USE			
PROPOSED ZONIN	G	PROPOSED USE			
ACREAG	E 42.742 LOTS [CURRENT	n de en de	LOTS [PROPOSED]	111	
REGARD TO ITS RESULT IN THE	D PLATS: BY CHECKING THIS BOX YOU ACKNOWLEDGE TO APPROVAL PROCESS, AND FAILURE TO ADDRESS ANY OF DENIAL OF YOUR CASE.	STAFF'S COMMENTS B	Y THE DATE PROVIDED ON THE DE	VELOPMENT CALENDAR WILL	
	CANT/AGENT INFORMATION [PLEASE PRINT/CI Quail Hollow SF, LTD.	APPLICANT		REQUIRED	
CONTACT PERSON		CONTACT PERSON	Chase Finch		
	John Arnold 8214 Westchester Drive Ste. 900	ADDRESS	200 W. Belmont Ste. E		
	8214 Westchester Dilve Ste. 300		200 W. Deimont S	.e. L	
CITY, STATE & ZIP	Dallas, TX 75202	CITY, STATE & ZIP	Allen, Tx 75013		
PHONE	214-522-4945	PHONE	972-396-1200		
E-MAIL	jarnold@skorburgcompany.com	E-MAIL	cfinch@corwinengir	neering.com	
BEFORE ME, THE UNDE STATED THE INFORMA "I HEREBY CERTIFY THA S 1,110.00 INFORMATION CONTAIN	ERSIGNED AUTHORITY, ON THIS DAY PERSONALLY APPEARITION ON THIS APPLICATION TO BE TRUE AND CERTIFIED THE TIAM THE OWNER FOR THE PURPOSE OF THIS APPLICATION; AND COVER THE COST OF THIS APPLICATION, I AGRED WITHIN THIS APPLICATION TO THE PUBLIC. THE CITY I	IE FOLLOWING: ALL INFORMATION SUBMI IAS BEEN PAID TO THE CI REE THAT THE CITY OF R IS ALSO AUTHORIZED AI	TTED HEREIN IS TRUE AND CORRECT. TY OF ROCKWALL ON THIS THE	DAY OF DAY OF AND PERMITTED TO PROVIDE	
	CTION WITH THIS APPLICATION, IF SUCH REPRODUCTION IS ASS		Brook My C	commission Expires 2/1/2028 ary ID 134742171	
	OWNER'S SIGNATURE		Not	ary 10 10-7-12-77 1	

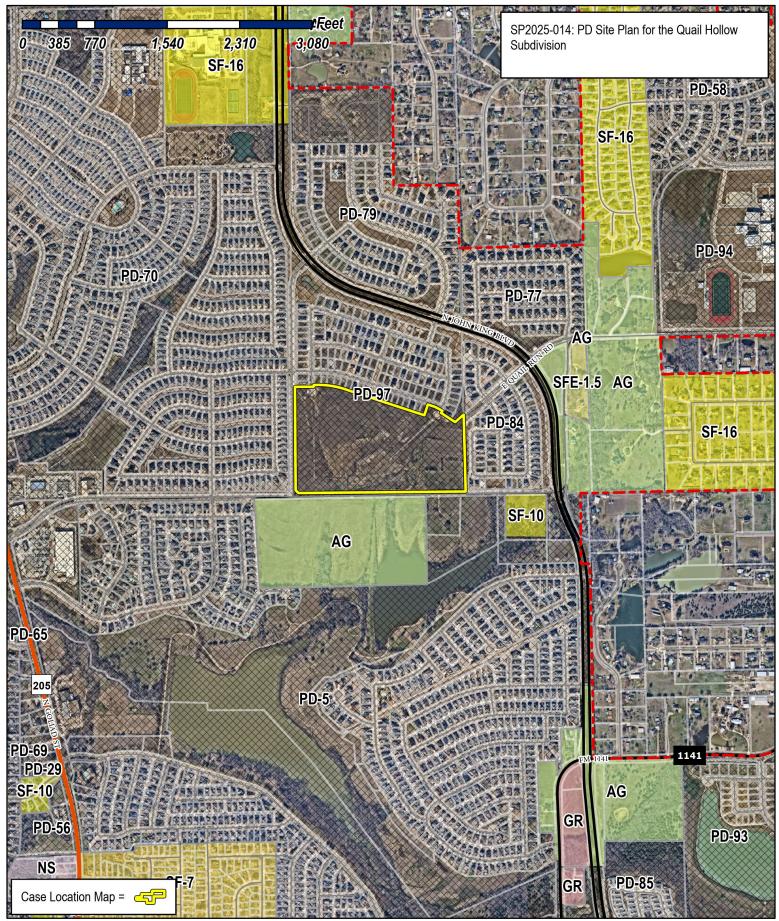





City of Rockwall Planning & Zoning Department 385 S. Goliad Street

Planning & Zoning Department 385 S. Goliad Street Rockwall, Texas 75087 (P): (972) 771-7745 (W): www.rockwall.com The City of Rockwall GIS maps are continually under development and therefore subject to change without notice. While we endeavor to provide timely and accurate information, we make no guarantees. The City of Rockwall makes no warranty, express or implied, including warranties of merchantability and fitness for a particular purpose. Use of the information is the sole responsibility of the user.



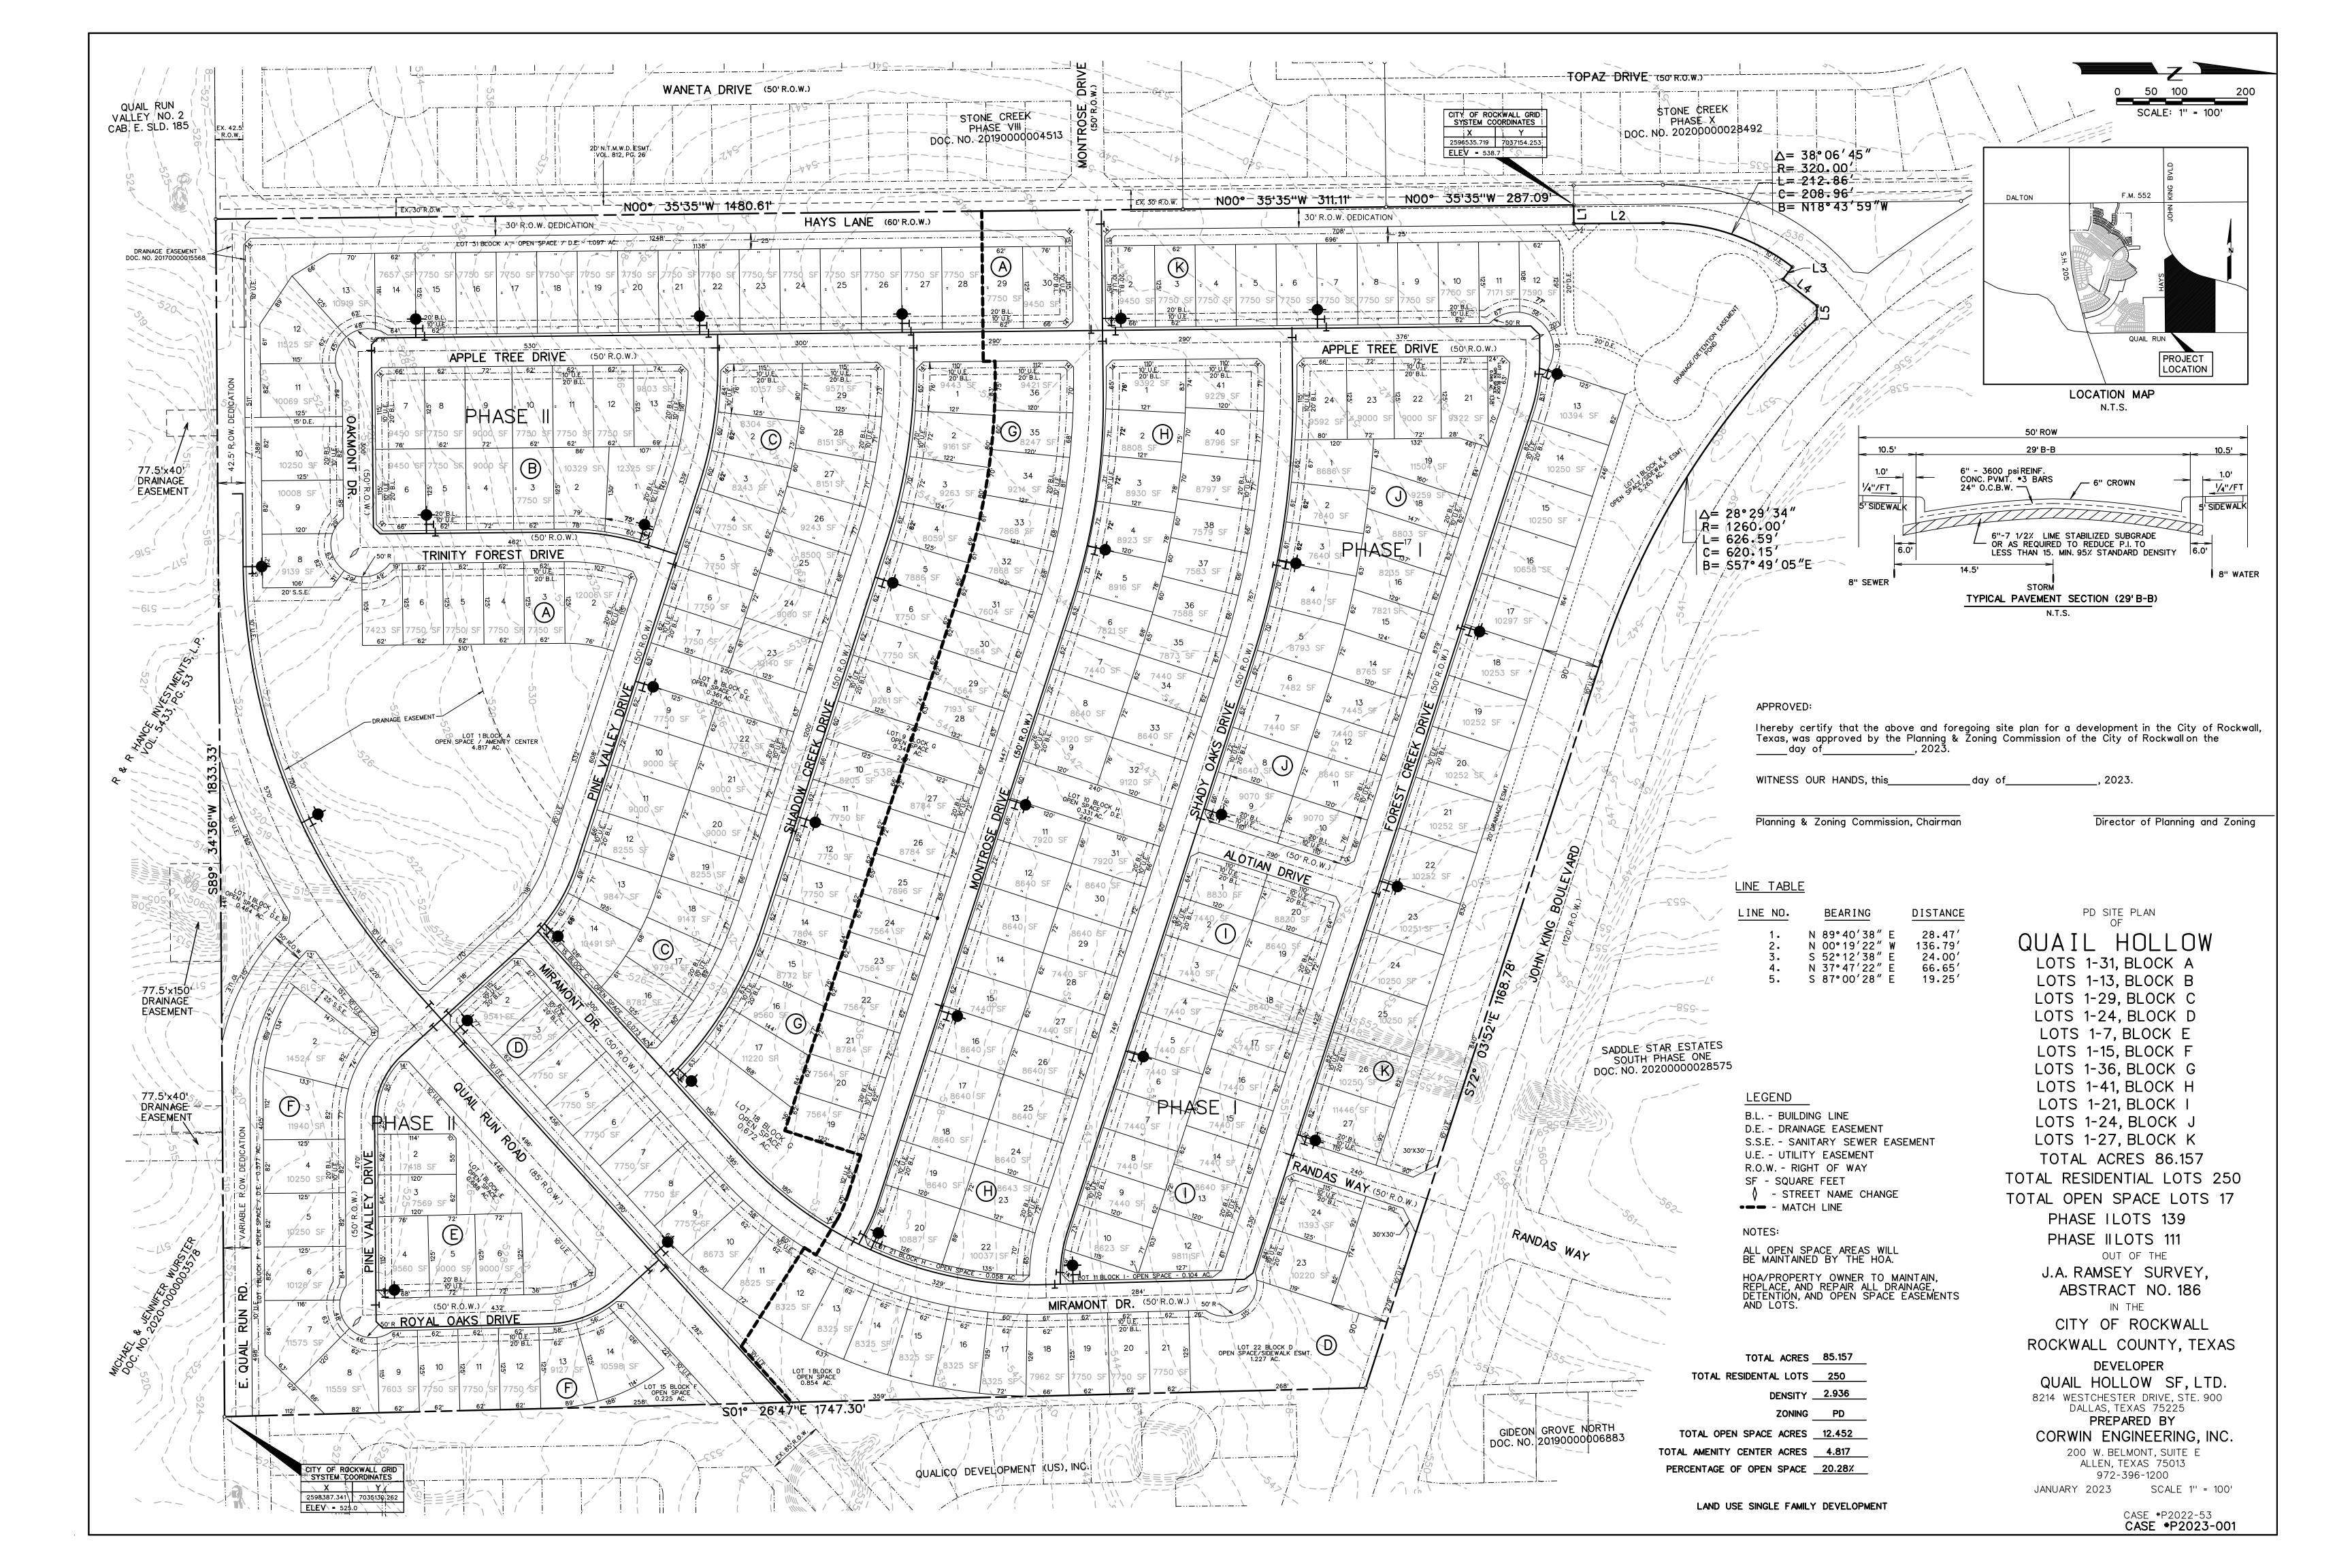

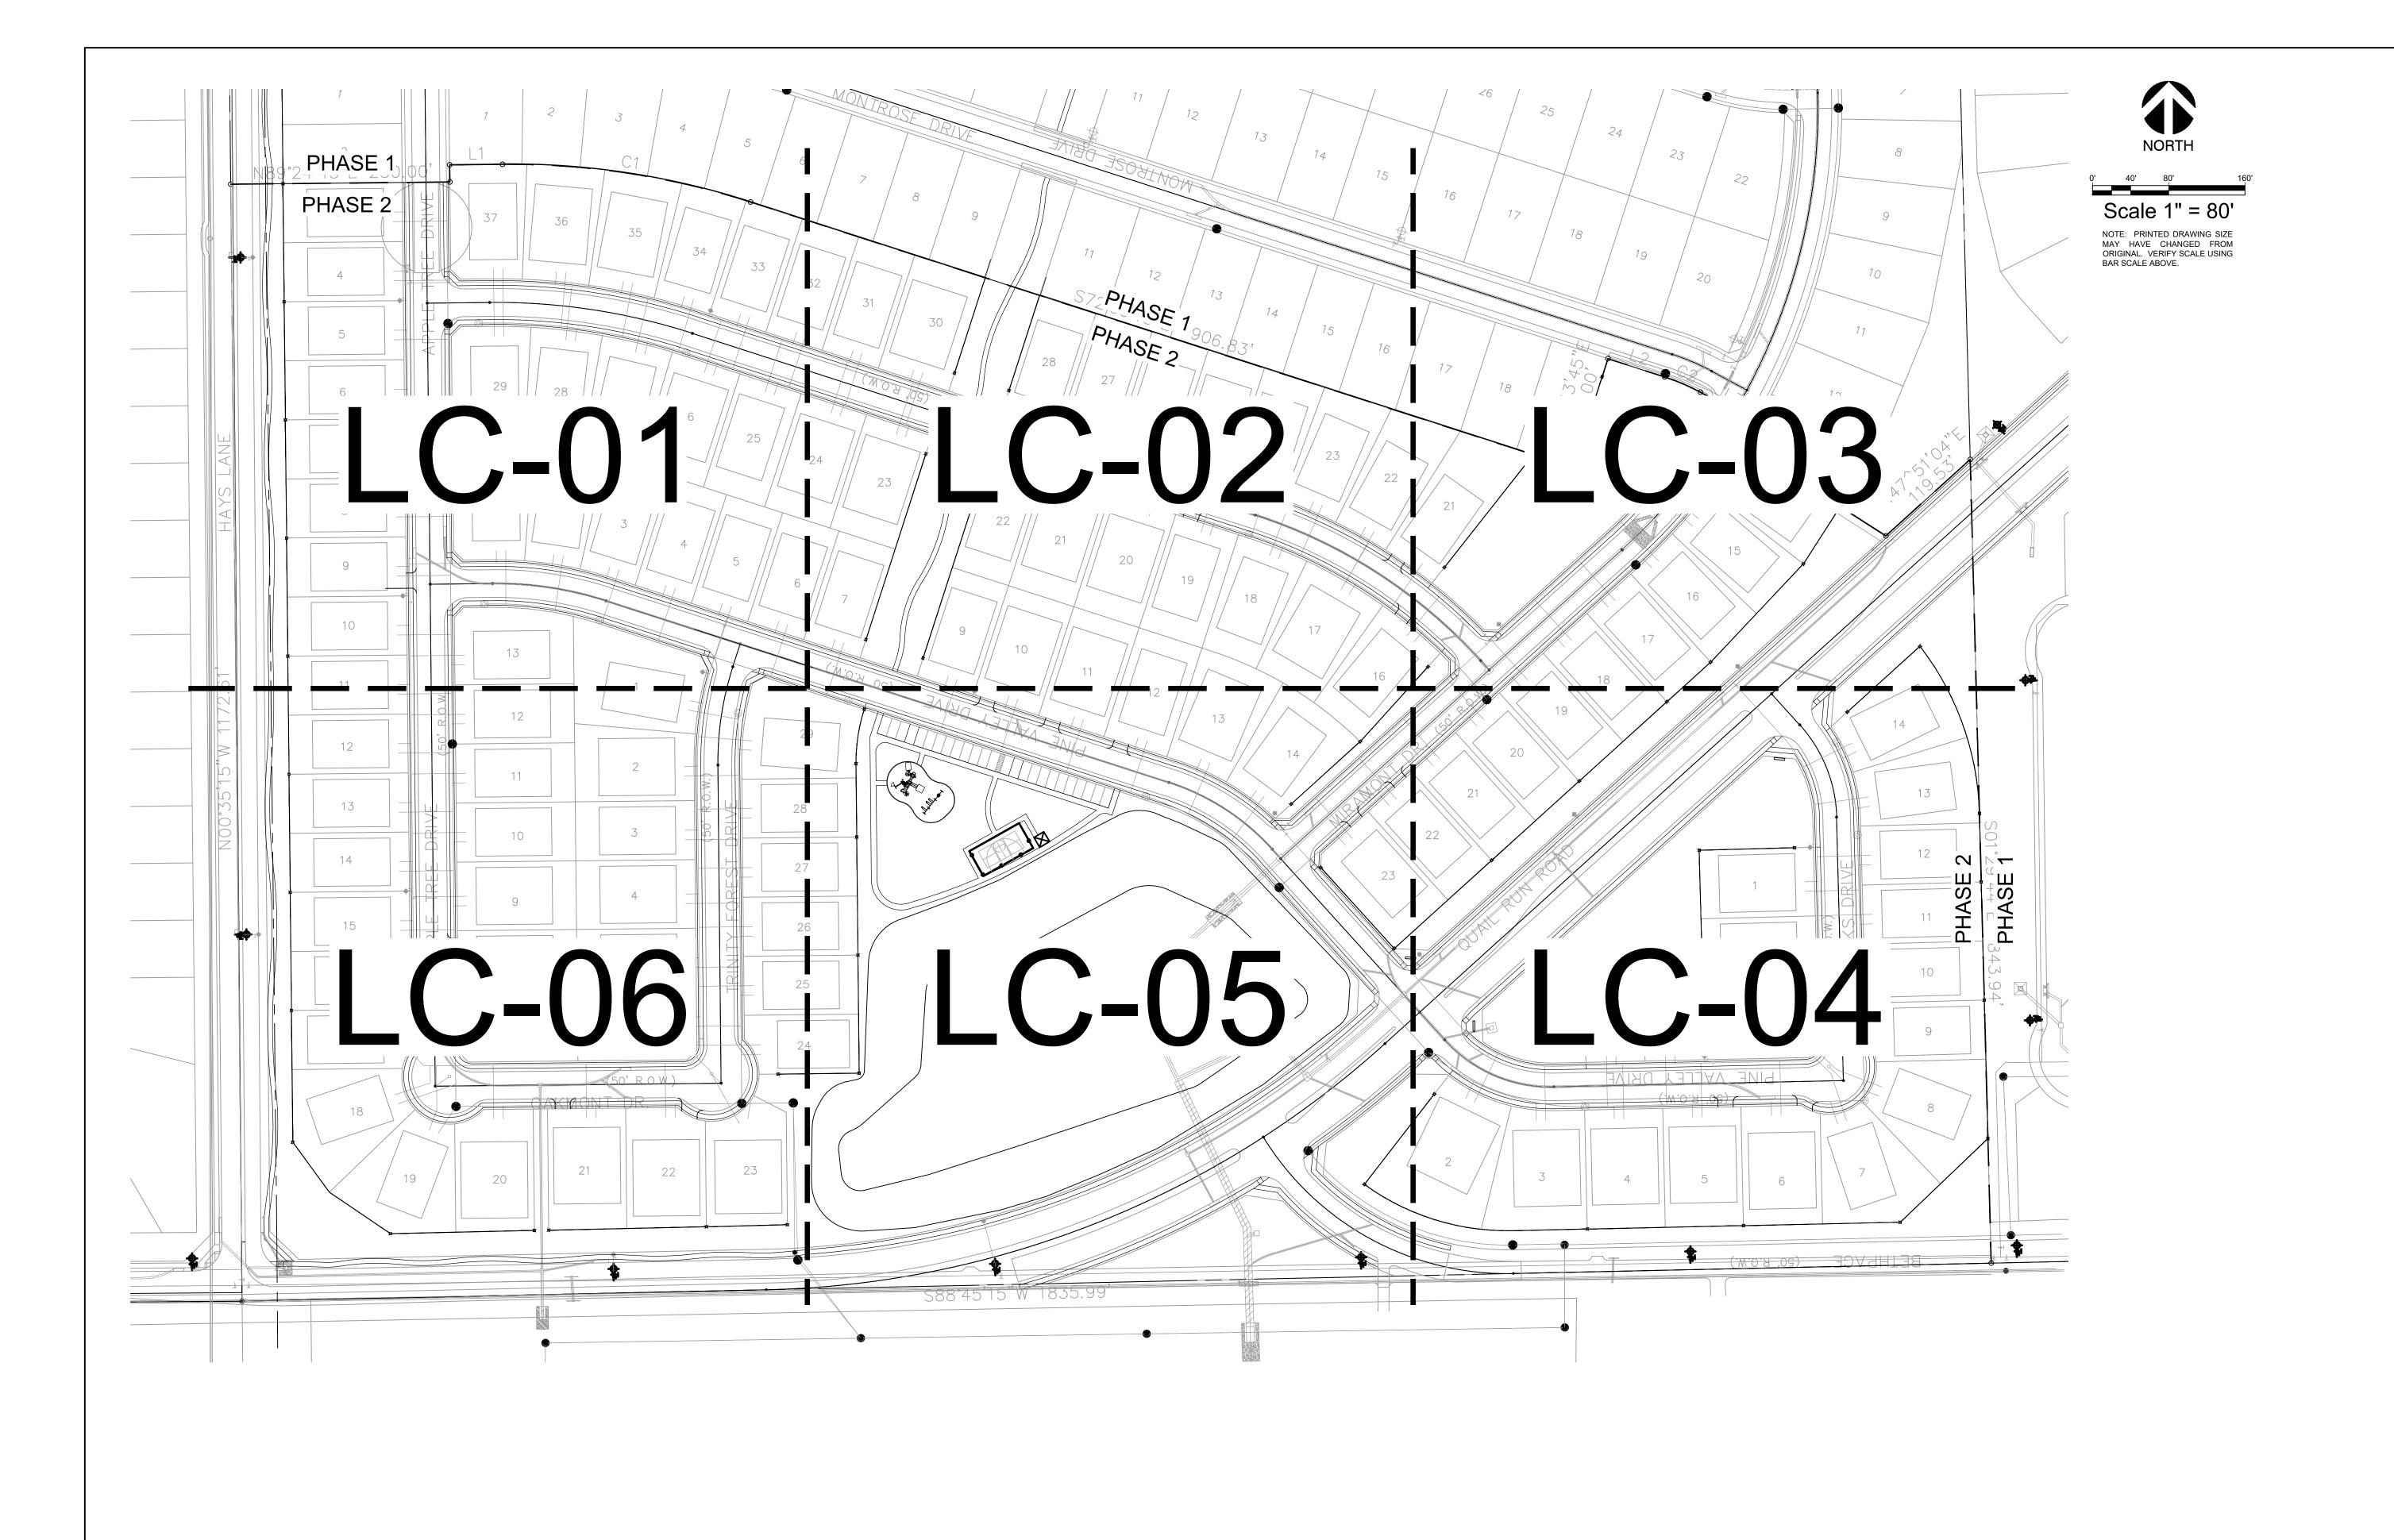



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MARY N. BATES TEXAS L.A. #3613 ISSUED ON: OCTOBER 04, 2024

Company
er Drive, Suite 900

Skorburg (8214 Westchester Dallas, Texas 75225

Quail Hollow Rockwall, TX

OVERALL HARDSCAPE PLAN


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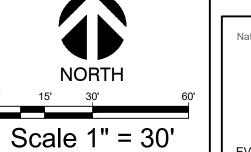
Project Number

 Date
 10/04/24

 Drawn By
 KB

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NOTE: PRINTED DRAWING SIZE MAY HAVE CHANGED FROM ORIGINAL. VERIFY SCALE USING BAR SCALE ABOVE.

CONSTRUCTION LEGEND (MASTER LIST - NOT ALL ITEMS ARE ON EVERY SHEET)

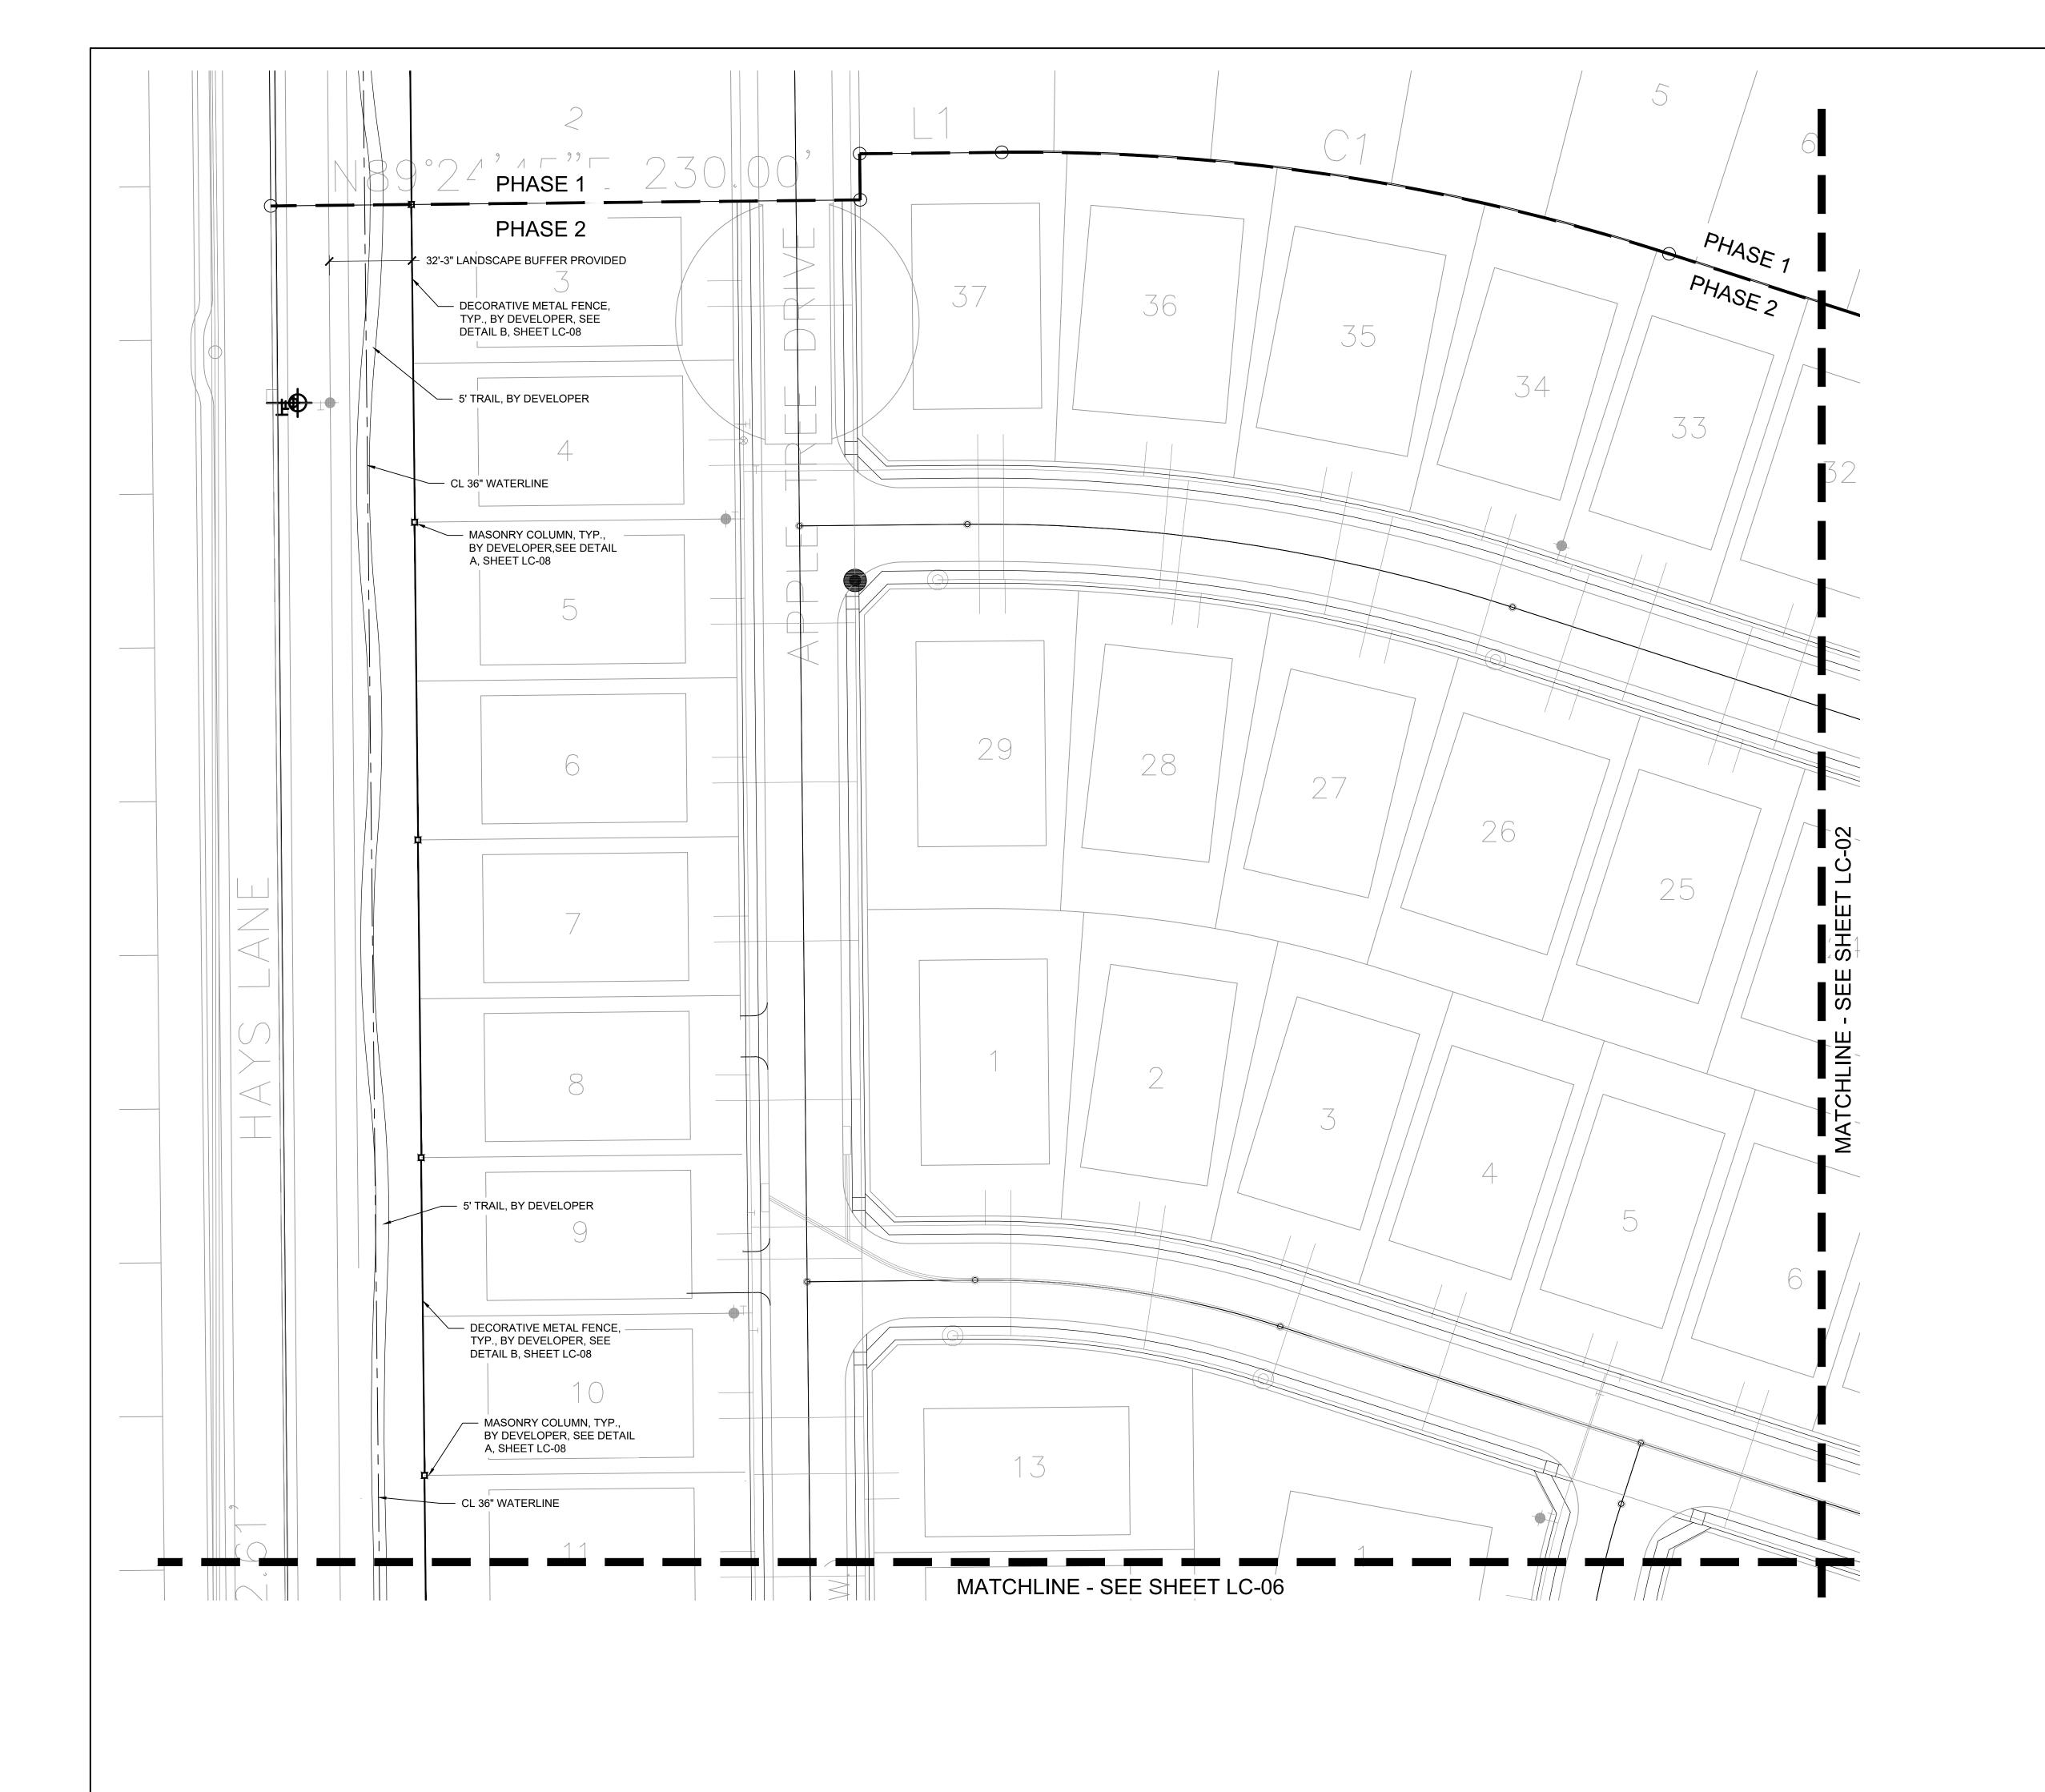- 4-IN THK. CONCRETE WALK, LIGHT BROOM FINISH, NATURAL GRAY COLOR; SEE DETAIL B, SHEET LC-07.
- 2. EXPANSION JOINT WITH COLOR CAULK TO MATCH ADJACENT PAVEMENT. SEE DETAIL A, SHEET LC-07.
- 3. 4" CONCRETE PAD, LIGHT BROOM FINISH, NATURAL GRAY COLOR; W/ SAWCUT CONTROL JOINTS; SEE DETAIL B, SHEET LC-07.
- 4. PLAYGROUND EQUIPMENT, SEE DETAIL D, SHEET LC-08
- 5. PLAYGROUND SAFETY SURFACING ENGINEERED WOOD MULCH; SEE DETAIL C, SHEET LC-08.
- 6.) SWINGS, SEE DETAIL D, SHEET LC-08.
- (7.) MULTI SPORT COURT. SEE DETAIL D, SHEET LC-07.
- (8.) ADA RAMP. SEE DETAIL C, SHEET LC-07.
- 9. PRIMARY COLUMN. SEE DETAIL A, SHEET LC-08.
- (10.) WROUGHT IRON FENCE W/ MASONRY COLUMN. SEE DETAIL A, SHEET LC-08.

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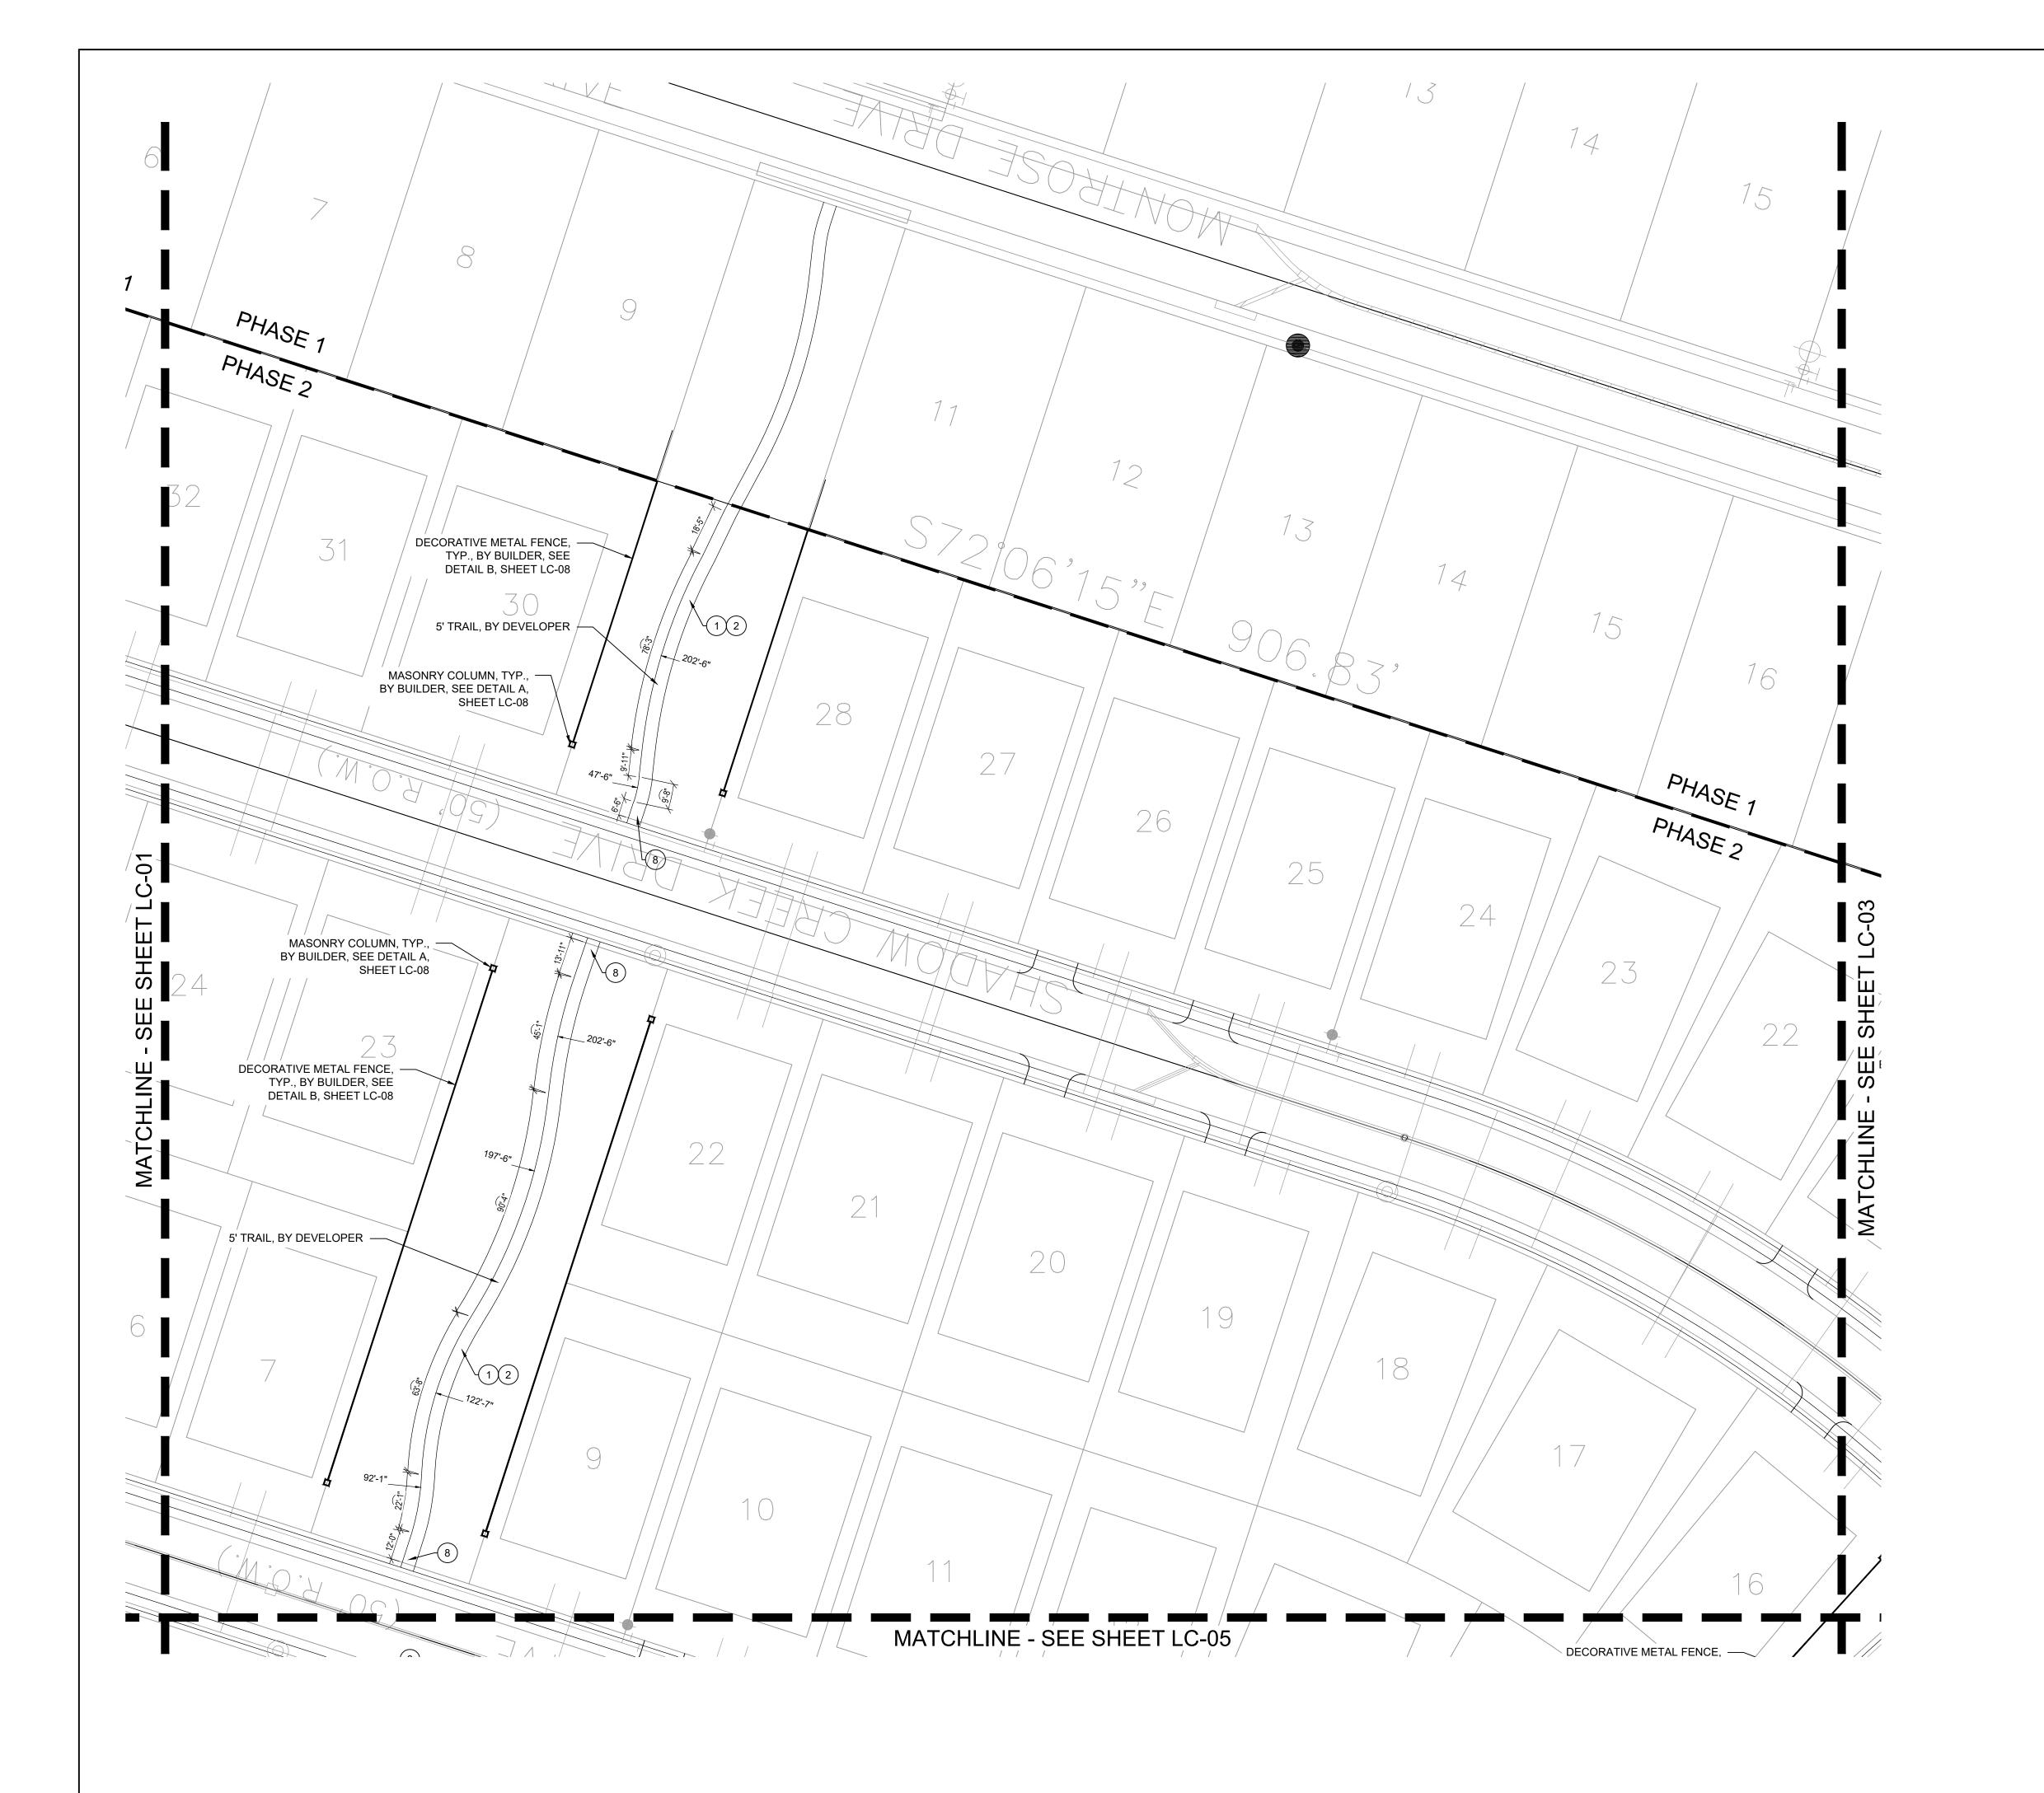
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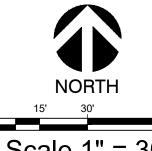
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Quail Hollow Rockwall, TX

HARDSCAPE PLAN

Date Comment





Scale 1" = 30'

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- 6. SWINGS, SEE DETAIL D, SHEET LC-08.
- (7.) MULTI SPORT COURT. SEE DETAIL D, SHEET LC-07.
- 8. ADA RAMP. SEE DETAIL C, SHEET LC-07.
- 9. PRIMARY COLUMN. SEE DETAIL A, SHEET LC-08.
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MARY N. BATES
TEXAS L.A. #3613

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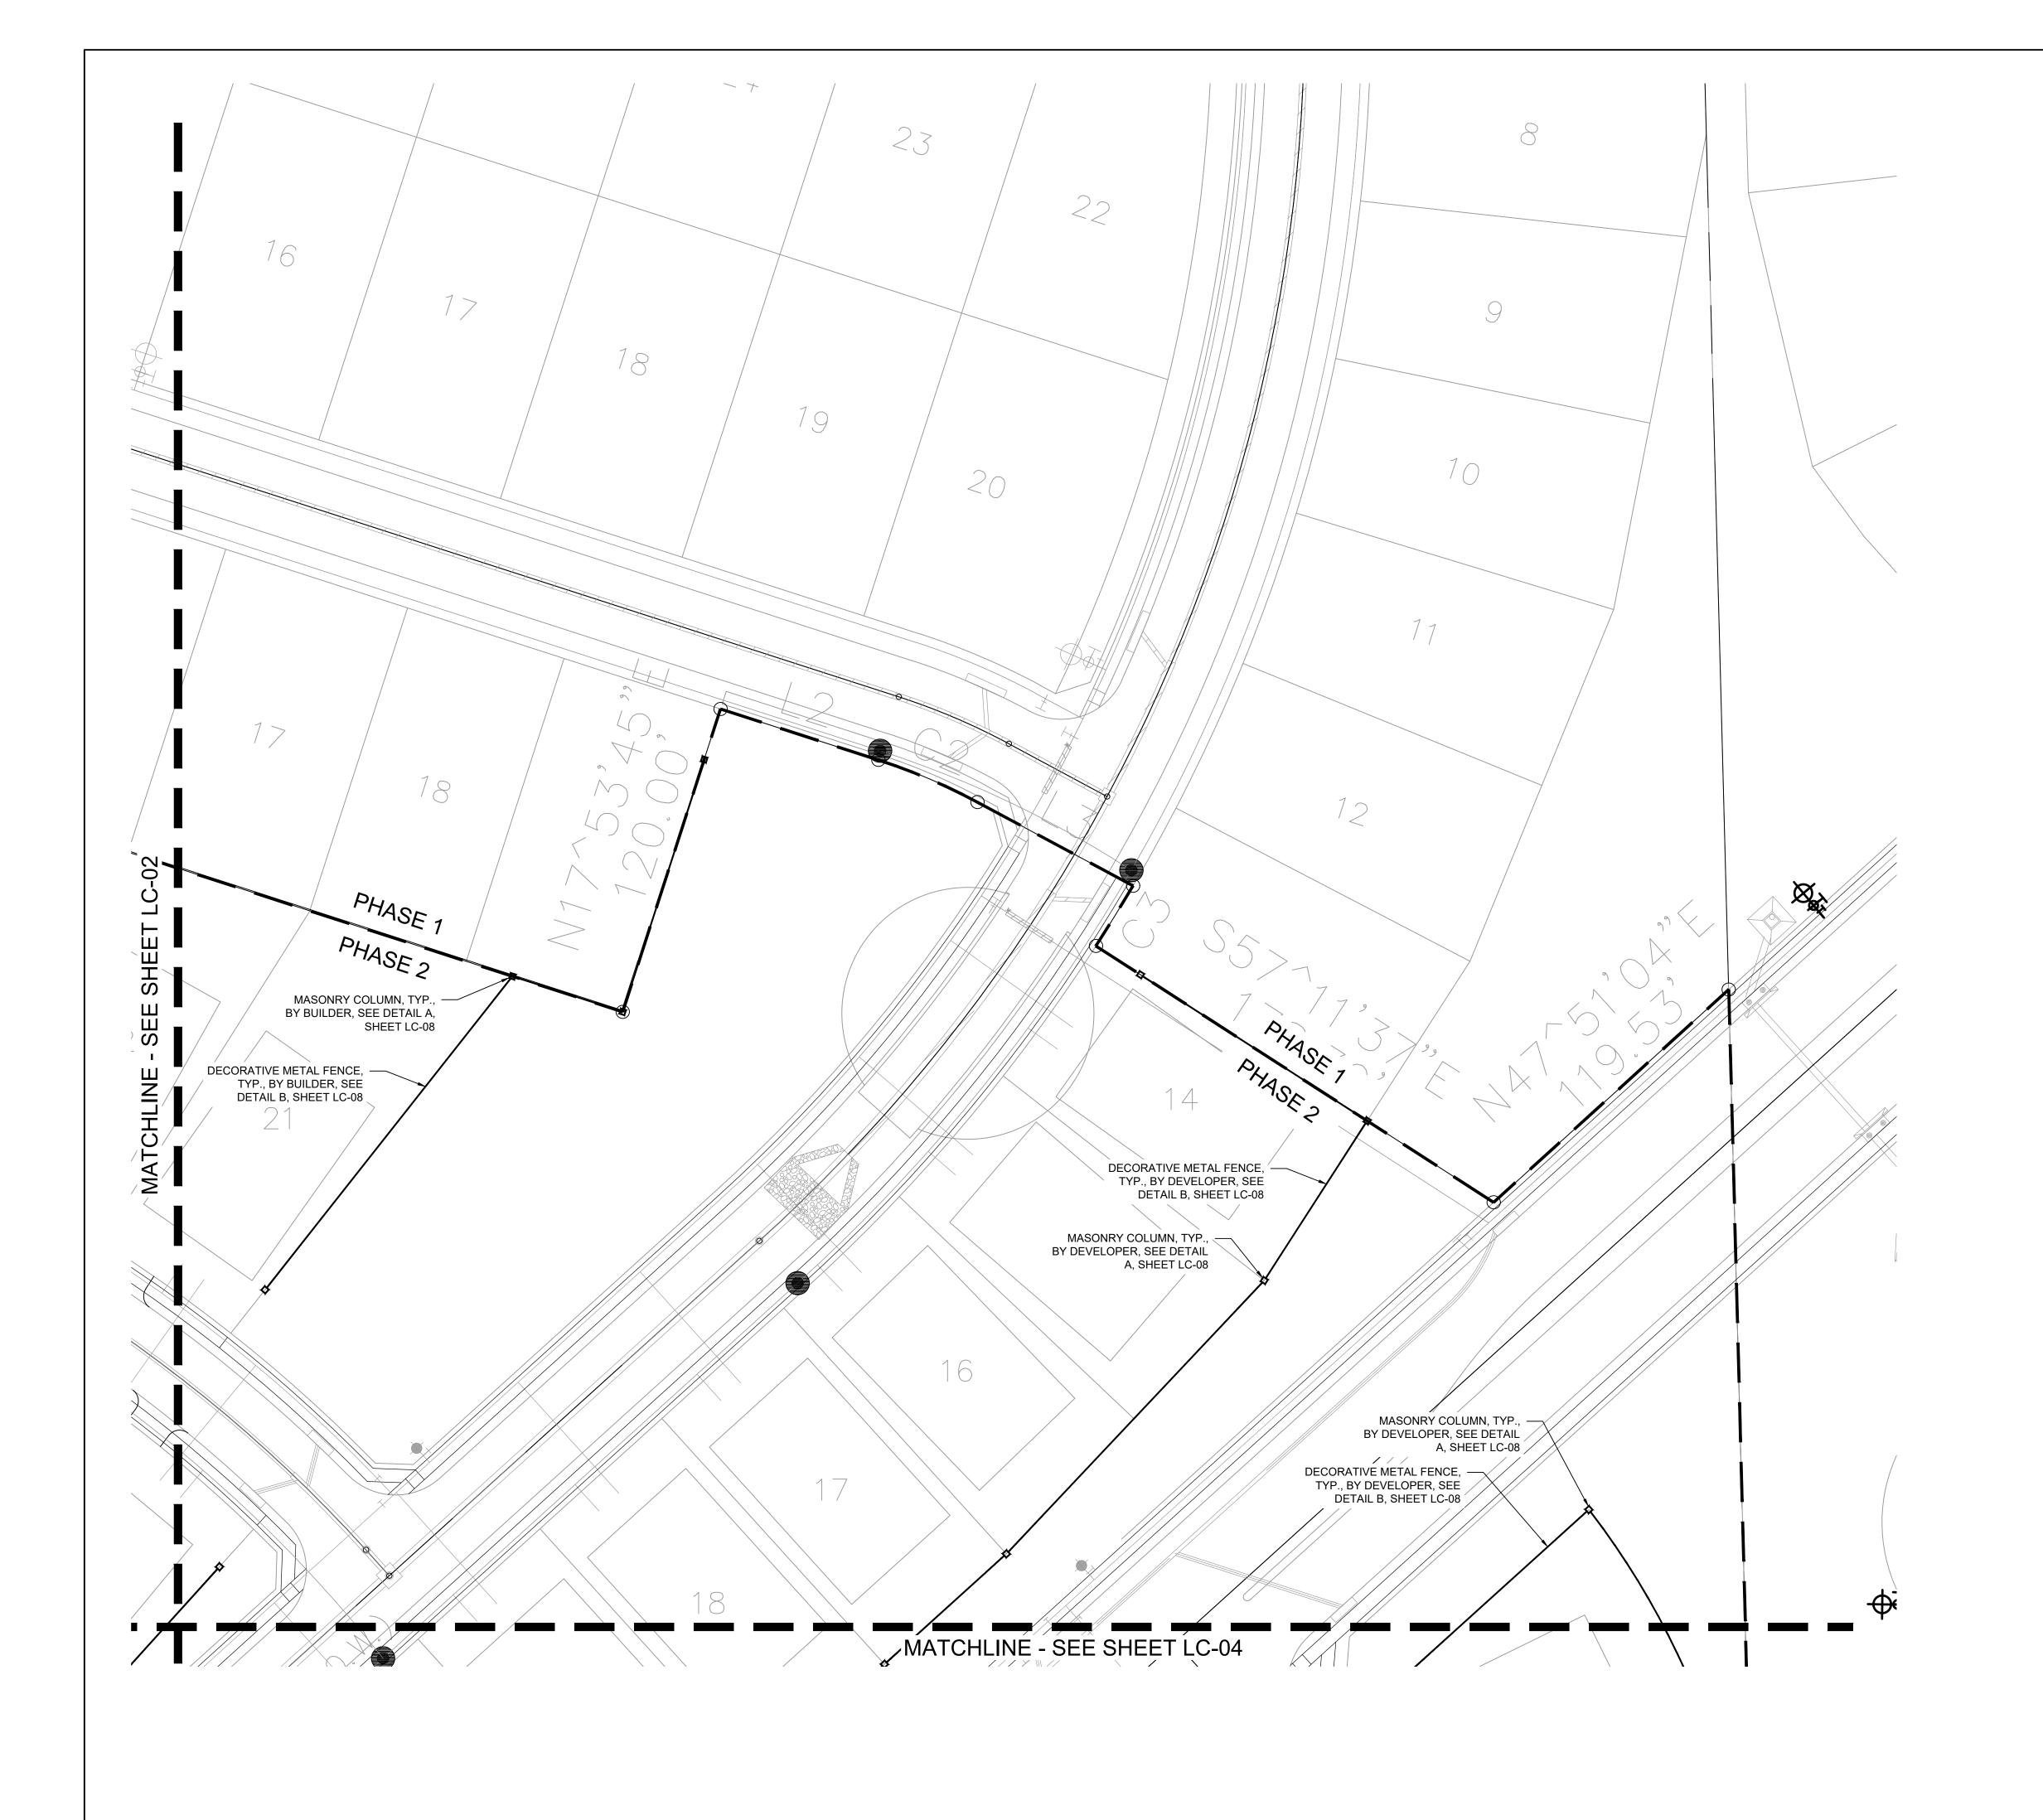
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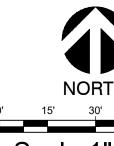
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- 4. PLAYGROUND EQUIPMENT, SEE DETAIL D, SHEET LC-08
- 5. PLAYGROUND SAFETY SURFACING ENGINEERED WOOD MULCH; SEE DETAIL C, SHEET LC-08.
- 6. SWINGS, SEE DETAIL D, SHEET LC-08.

SHEET LC-07.

- (7.) MULTI SPORT COURT. SEE DETAIL D, SHEET LC-07.
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HARDSCAPE PLAN


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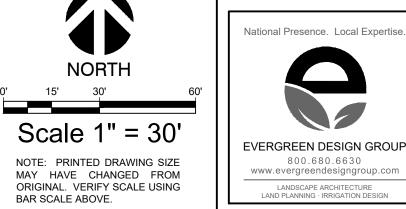
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> > MARY N. BATES TEXAS L.A. #3613

MULCH; SEE DETAIL C, SHEET LC-08.

CONSTRUCTION LEGEND

4-IN THK. CONCRETE WALK, LIGHT BROOM FINISH, NATURAL GRAY COLOR; SEE DETAIL B, SHEET LC-07.

3. 4" CONCRETE PAD, LIGHT BROOM FINISH, NATURAL GRAY

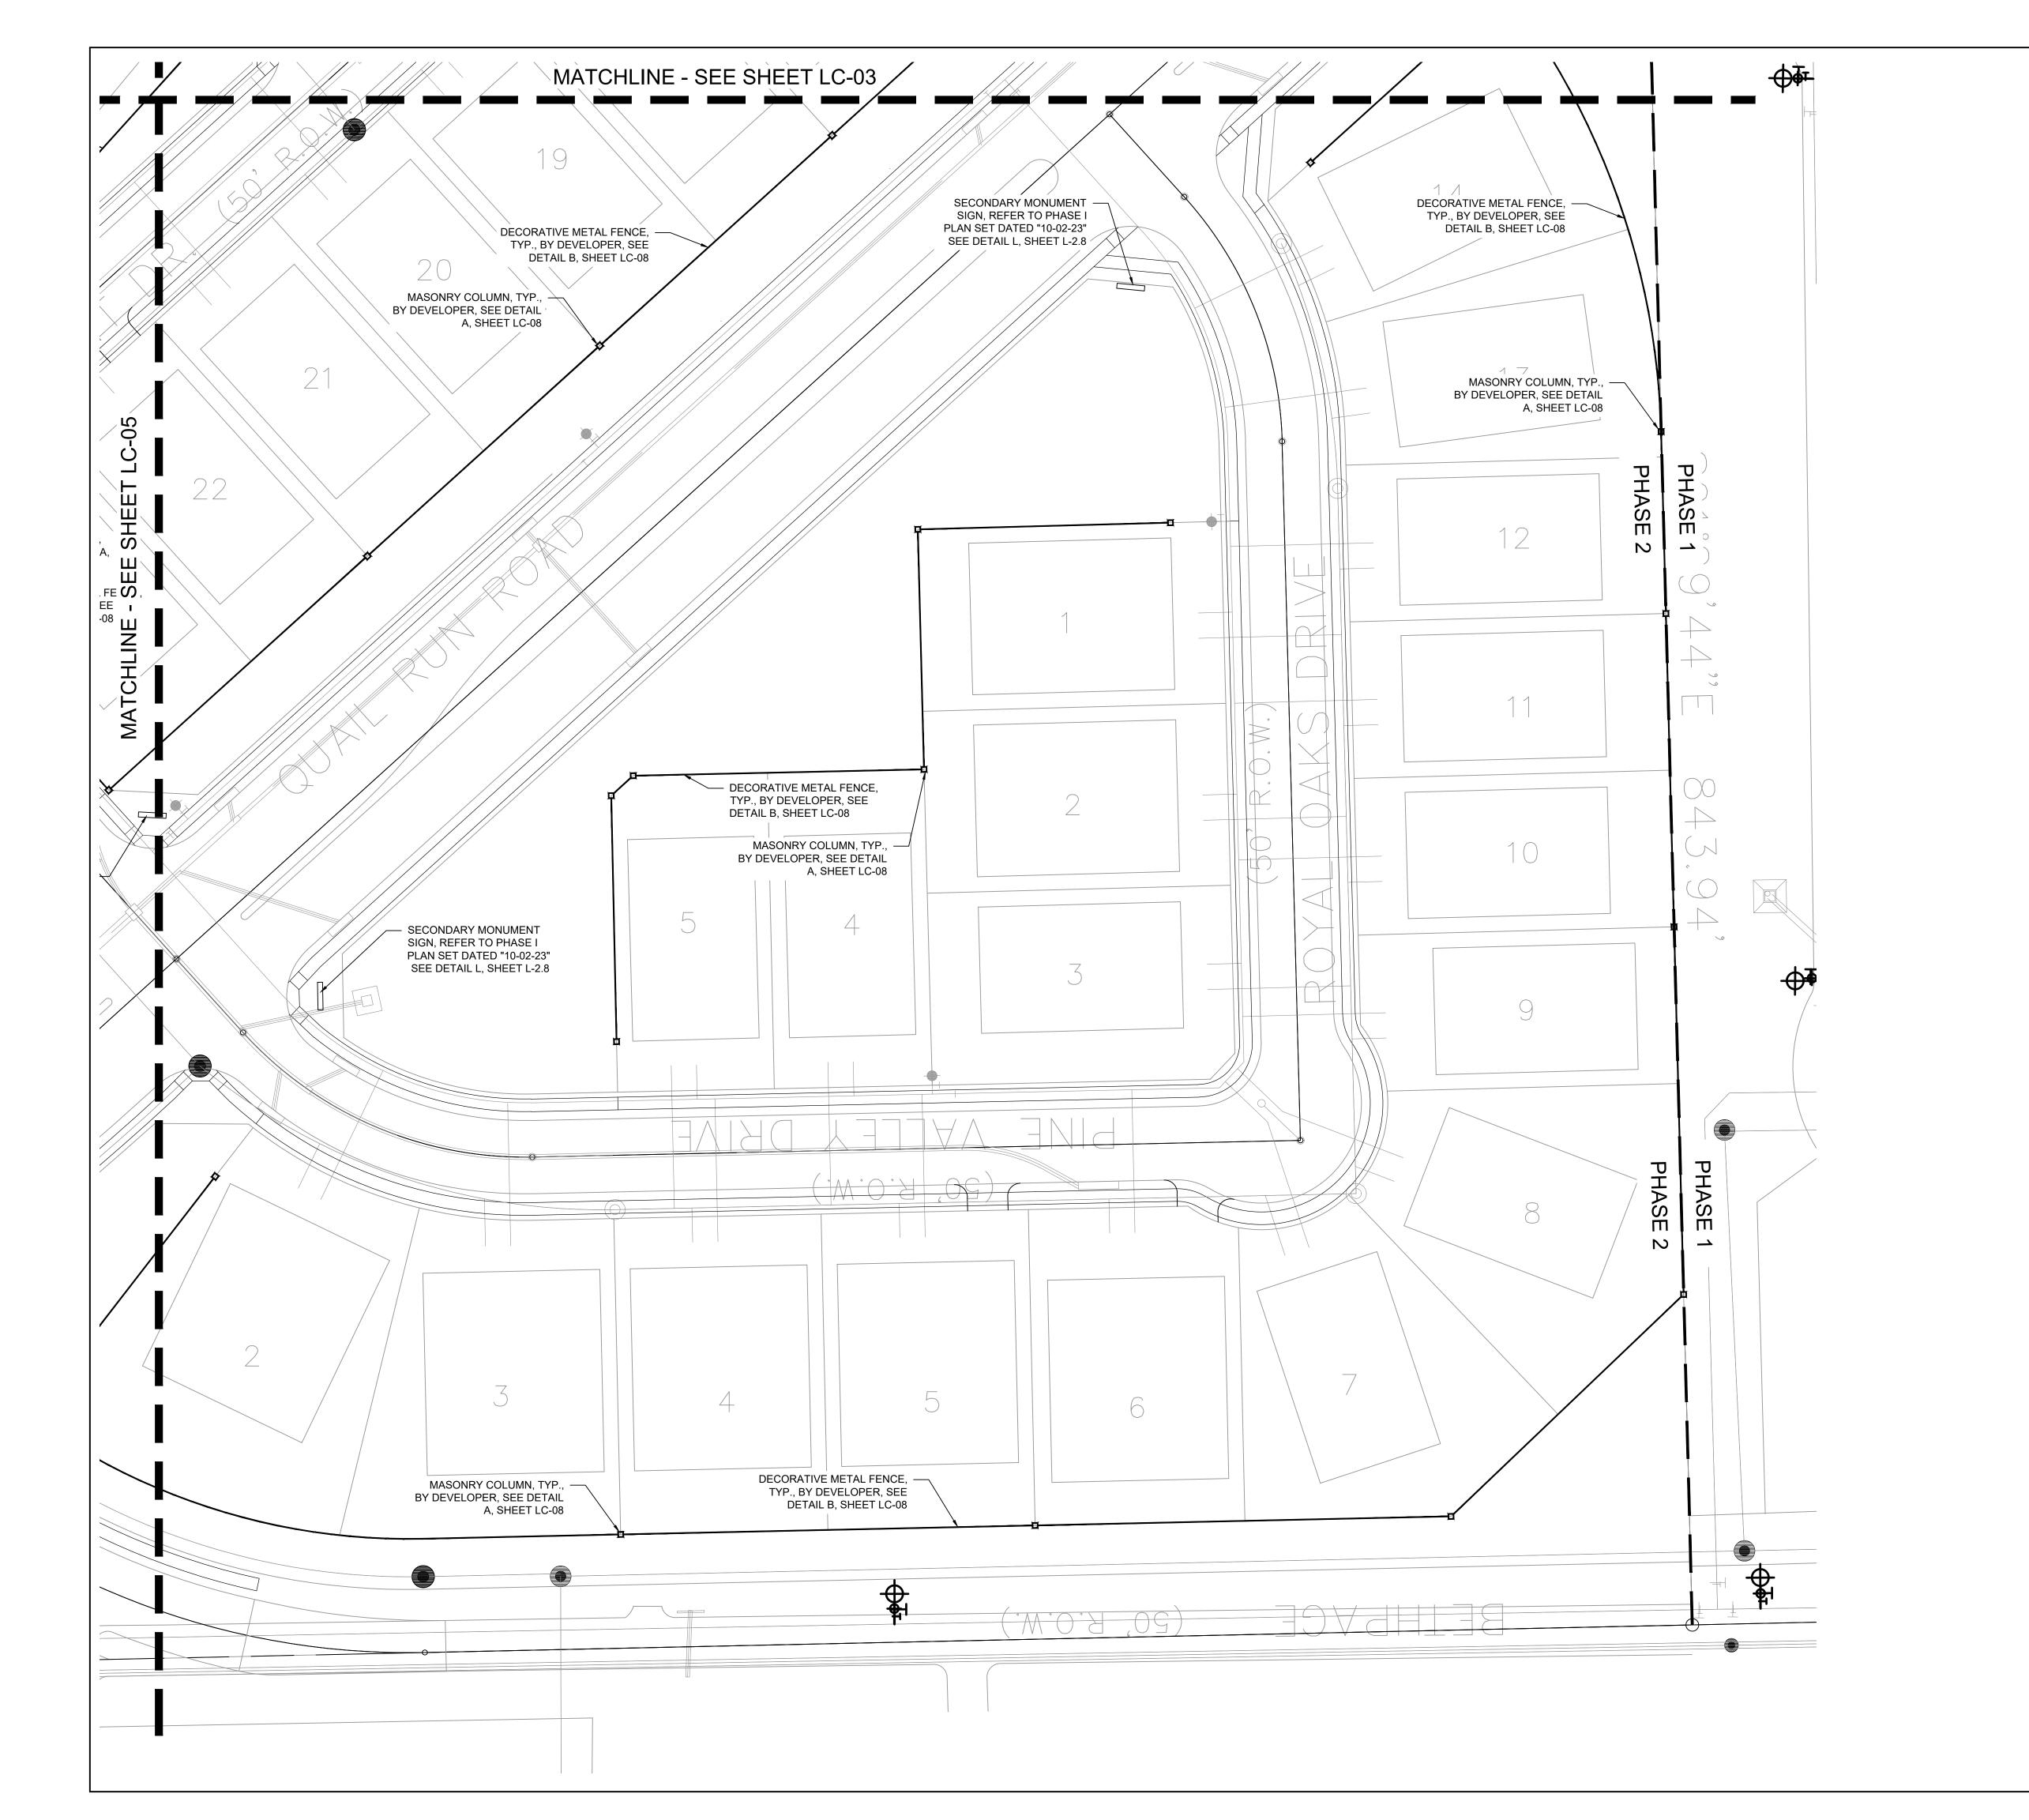4.) PLAYGROUND EQUIPMENT, SEE DETAIL D, SHEET LC-08

(5.) PLAYGROUND SAFETY SURFACING - ENGINEERED WOOD

COLOR; W/ SAWCUT CONTROL JOINTS; SEE DETAIL B,

2. EXPANSION JOINT WITH COLOR CAULK TO MATCH ADJACENT PAVEMENT. SEE DETAIL A, SHEET LC-07.

(MASTER LIST - NOT ALL ITEMS ARE ON EVERY SHEET)

6.) SWINGS, SEE DETAIL D, SHEET LC-08. (7.) MULTI SPORT COURT. SEE DETAIL D, SHEET LC-07.

8.) ADA RAMP. SEE DETAIL C, SHEET LC-07.

(9.) PRIMARY COLUMN. SEE DETAIL A, SHEET LC-08.

SHEET LC-07.

(10.) WROUGHT IRON FENCE W/ MASONRY COLUMN. SEE DETAIL A, SHEET LC-08.

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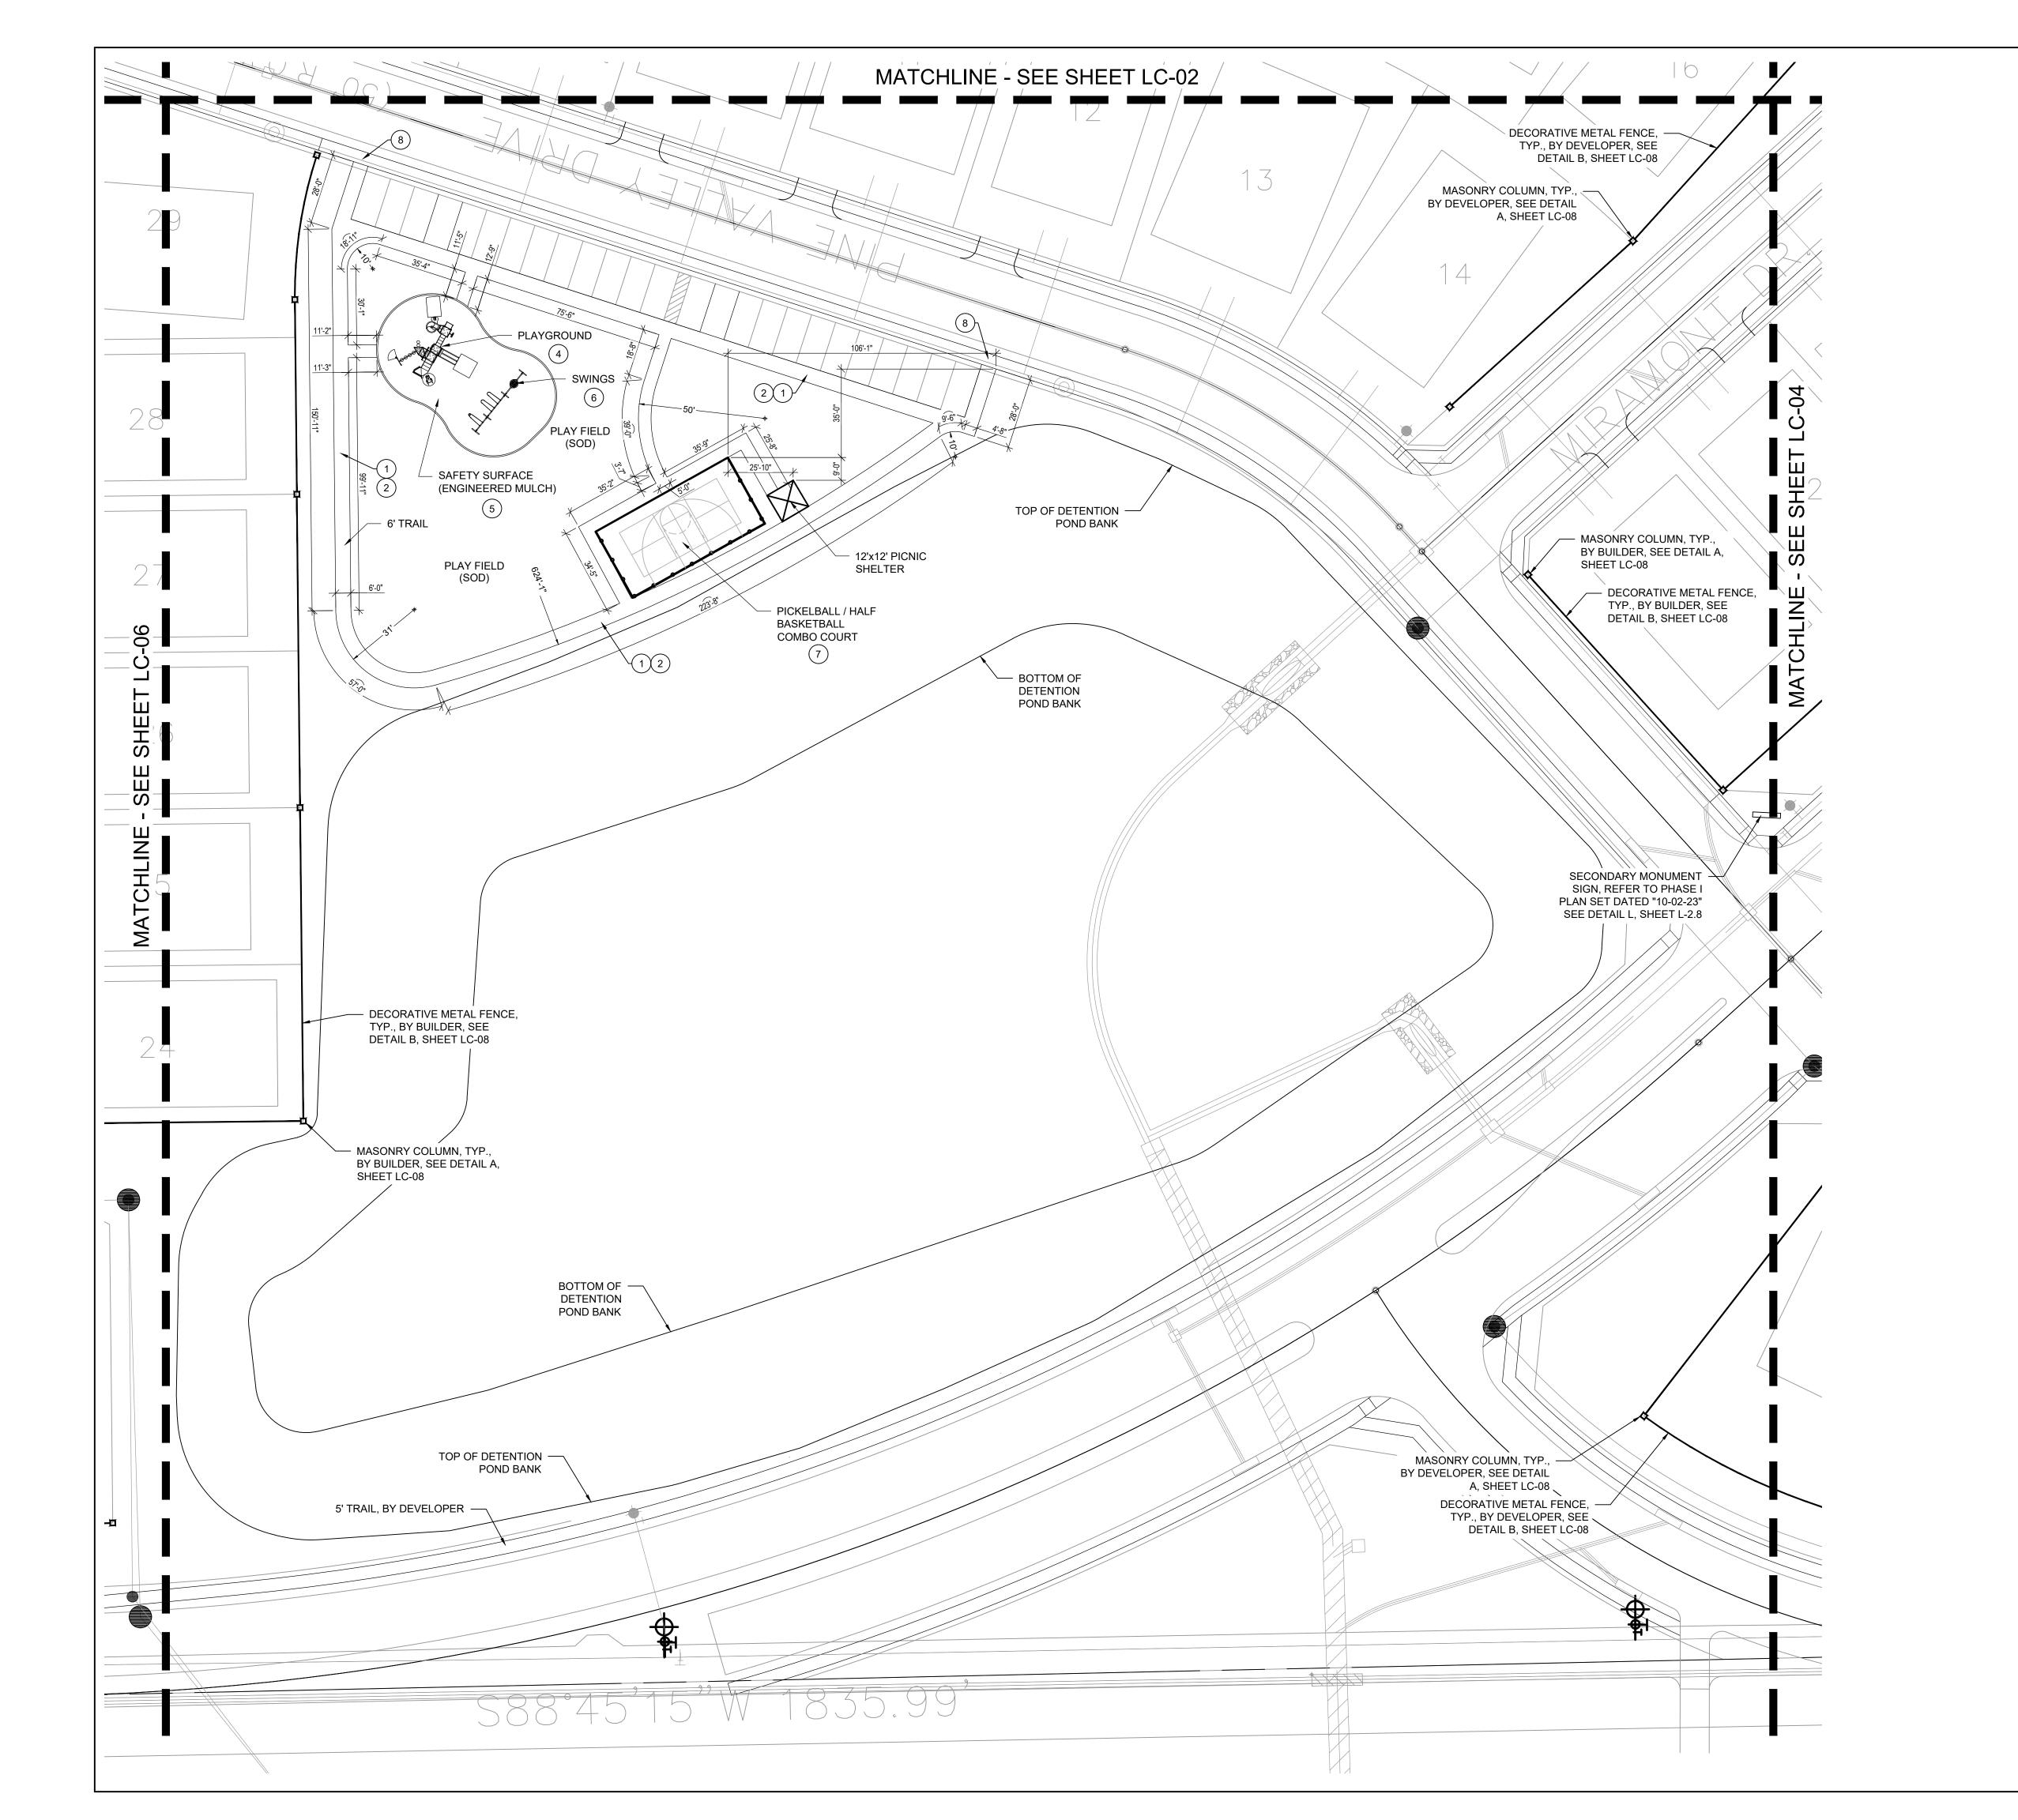
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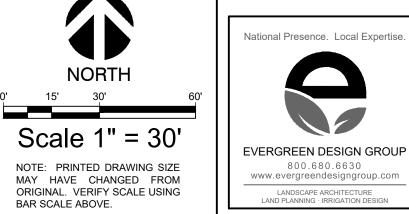
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(5.) PLAYGROUND SAFETY SURFACING - ENGINEERED WOOD

4-IN THK. CONCRETE WALK, LIGHT BROOM FINISH, NATURAL GRAY COLOR; SEE DETAIL B, SHEET LC-07.

3.) 4" CONCRETE PAD, LIGHT BROOM FINISH, NATURAL GRAY

COLOR; W/ SAWCUT CONTROL JOINTS; SEE DETAIL B,

EXPANSION JOINT WITH COLOR CAULK TO MATCH ADJACENT PAVEMENT. SEE DETAIL A, SHEET LC-07.

MULCH; SEE DETAIL C, SHEET LC-08.

4.) PLAYGROUND EQUIPMENT, SEE DETAIL D, SHEET LC-08

6.) SWINGS, SEE DETAIL D, SHEET LC-08.

SHEET LC-07.

CONSTRUCTION LEGEND (MASTER LIST - NOT ALL ITEMS ARE ON EVERY SHEET)

- (7.) MULTI SPORT COURT. SEE DETAIL D, SHEET LC-07. 8.) ADA RAMP. SEE DETAIL C, SHEET LC-07.
- (9.) PRIMARY COLUMN. SEE DETAIL A, SHEET LC-08.
- (10.) WROUGHT IRON FENCE W/ MASONRY COLUMN. SEE DETAIL A, SHEET LC-08.

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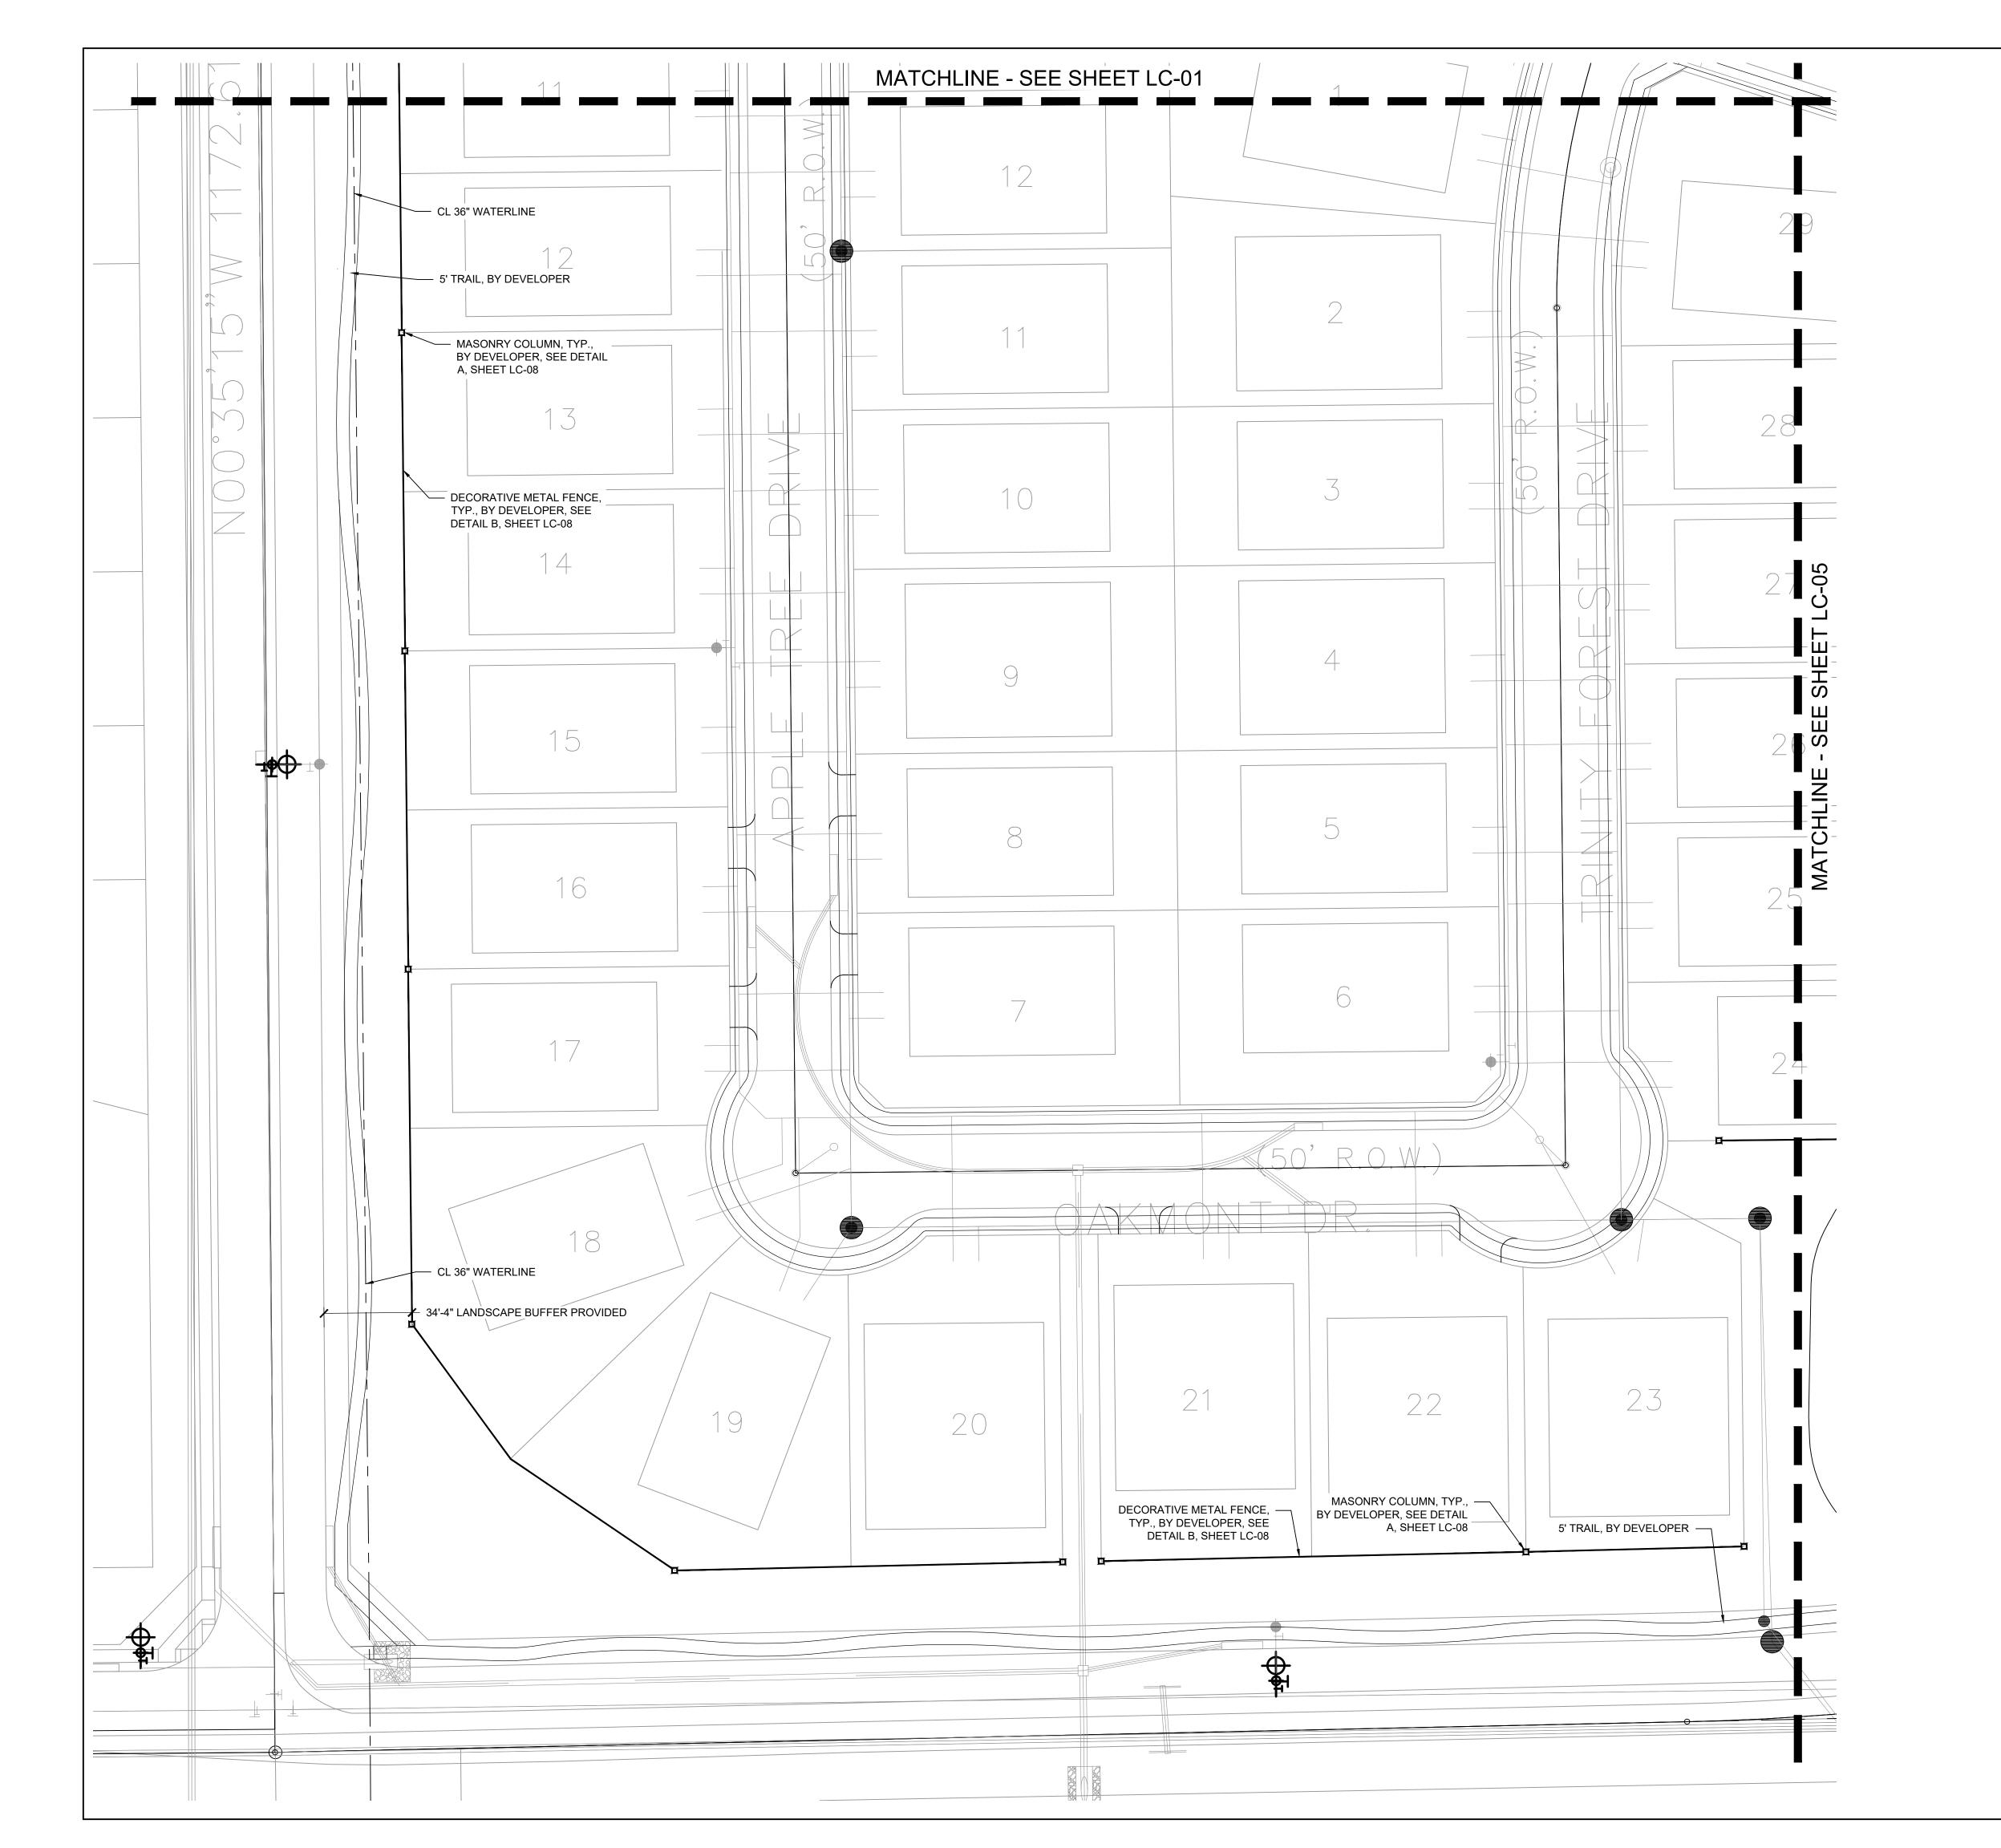
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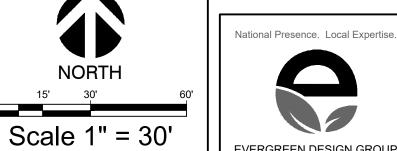
Hollow Quail Rockwall,

HARDSCAPE PLAN

Date Comment

10/04/24 Drawn By





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CONSTRUCTION LEGEND (MASTER LIST - NOT ALL ITEMS ARE ON EVERY SHEET)

- 4-IN THK. CONCRETE WALK, LIGHT BROOM FINISH, NATURAL GRAY COLOR; SEE DETAIL B, SHEET LC-07.
- 2. EXPANSION JOINT WITH COLOR CAULK TO MATCH ADJACENT PAVEMENT. SEE DETAIL A, SHEET LC-07.
- 3.) 4" CONCRETE PAD, LIGHT BROOM FINISH, NATURAL GRAY COLOR; W/ SAWCUT CONTROL JOINTS; SEE DETAIL B, SHEET LC-07.
- 4. PLAYGROUND EQUIPMENT, SEE DETAIL D, SHEET LC-08
- 5. PLAYGROUND SAFETY SURFACING ENGINEERED WOOD MULCH; SEE DETAIL C, SHEET LC-08.
- 6.) SWINGS, SEE DETAIL D, SHEET LC-08.
- (7.) MULTI SPORT COURT. SEE DETAIL D, SHEET LC-07.
- (8.) ADA RAMP. SEE DETAIL C, SHEET LC-07.
- 9. PRIMARY COLUMN. SEE DETAIL A, SHEET LC-08.
- (10.) WROUGHT IRON FENCE W/ MASONRY COLUMN. SEE DETAIL A, SHEET LC-08.

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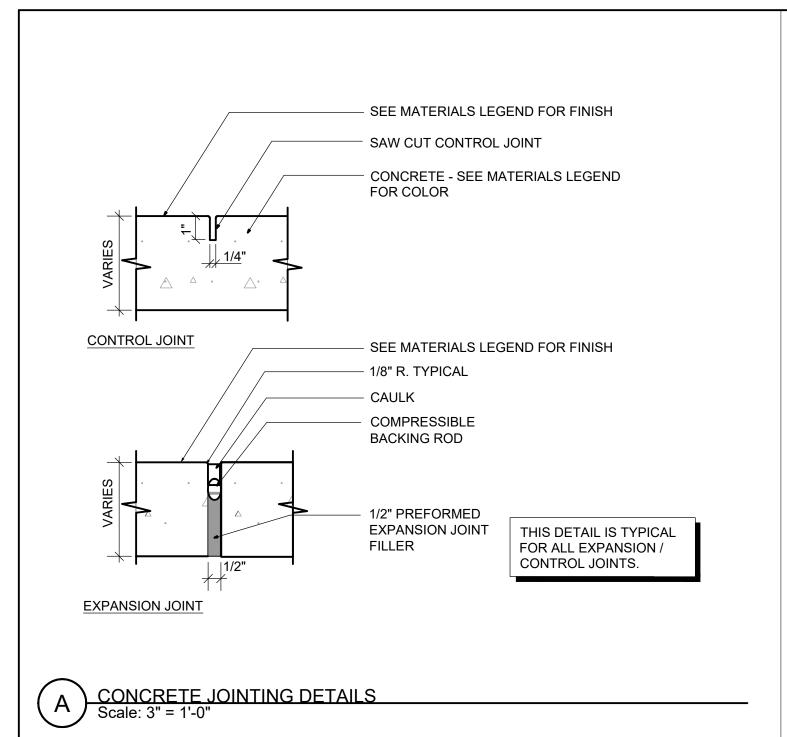
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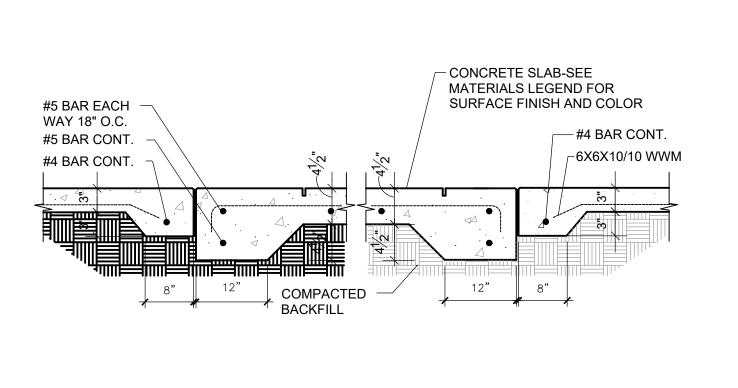
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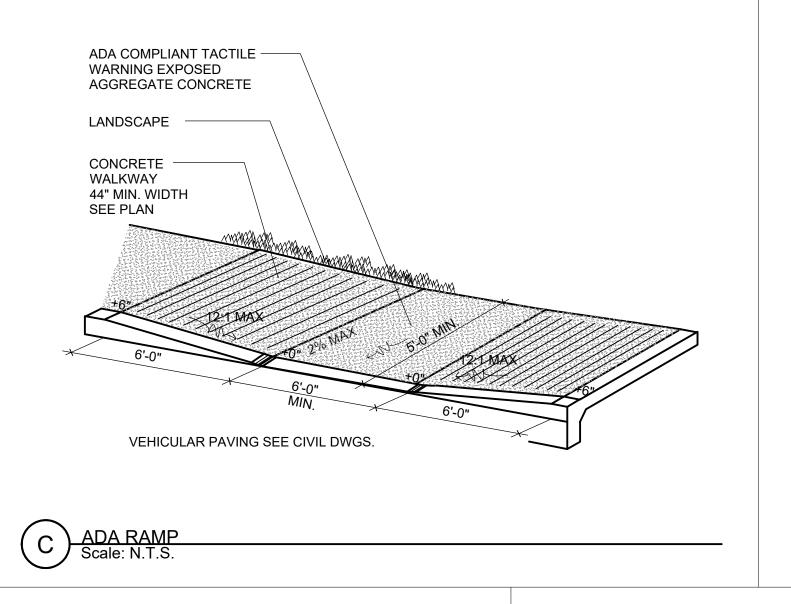
Quail Hollow Rockwall, TX

HARDSCAPE PLAN

Date Comment









COURT BUILDER "



B CONCRETE PAVEMENT - LIGHT DUTY
Scale: 3/4" = 1'-0"

MANUFACTURER: SPORT COURT SUPPLIER: NEXCOURT CONTACT: CHRIS WALKER PHONE: 972-898-7529 COLORS: TBD OPTIONS: 30'X60' MULTI-SPORT COURT, 1/2 BASKETBALL, PICKLEBALL, 2 SINGLE LIGHTS, FULL 3 SIDES BLACK VINYL COATED CHAIN LINK FENCE BACKSTOP

PICKLE BALL COURT FENCE NOTE: 8' HIGH FENCE AT REAR OF COURT. 4' HIGH FENCE AT SIDES OF COURT.

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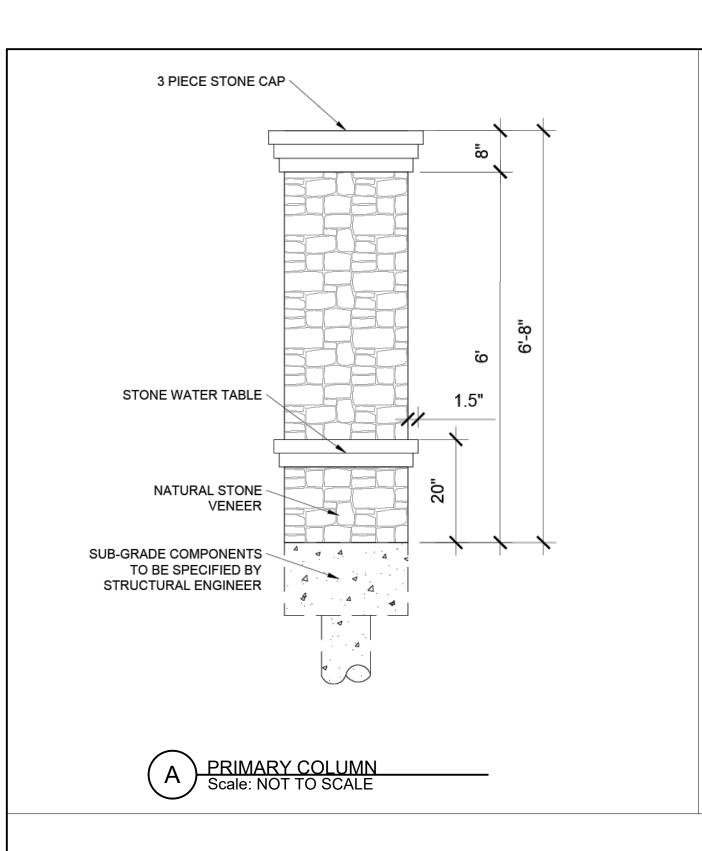
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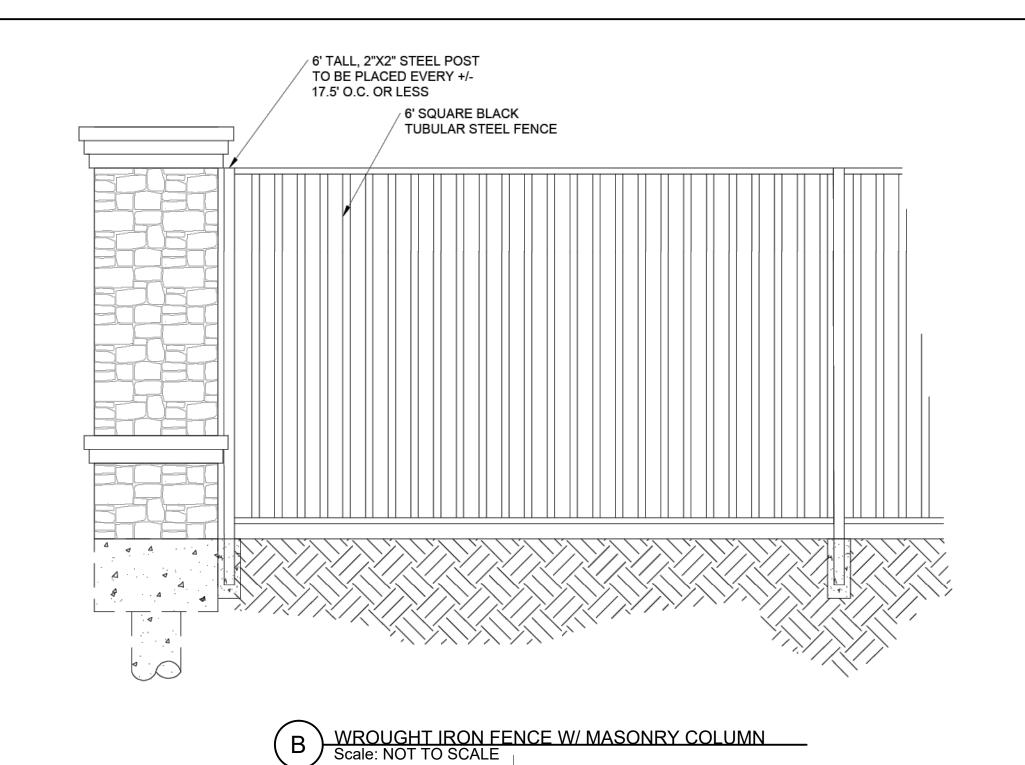
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Hollow LTX Quail Rockwall,

HARDSCAPE **DETAILS**

Date Comment





— ACCESSIBLE CONCRETE RAMP INSIDE EDGE OF RAMP -----FIBAR® WOOD FIBER MUST FALL OUTSIDE ASTM USE ZONE ← FIBAR® WOOD FIBER SLOPE>1% ABOVE GROUND INSTALLATION ABOVE GROUND INSTALLATION ACCESSIBILITY DETAIL

1. INSTALLATION TO BE COMPLETED IN ACCORDANCE WITH MANUFACTURER'S SPECIFICATIONS.

2. DO NOT SCALE DRAWING. 3. THIS DRAWING IS INTENDED FOR USE BY ARCHITECTS, ENGINEERS, CONTRACTORS, CONSULTANTS AND DESIGN PROFESSIONALS

FOR PLANNING PURPOSES ONLY. THIS DRAWING MAY NOT BE USED FOR CONSTRUCTION. 4. ALL INFORMATION CONTAINED HEREIN WAS CURRENT AT THE TIME OF DEVELOPMENT BUT MUST BE REVIEWED AND APPROVED BY

THE PRODUCT MANUFACTURER TO BE CONSIDERED ACCURATE. 5. CONTRACTOR'S NOTE: FOR PRODUCT AND COMPANY INFORMATION VISIT www.CADdetails.com/info AND ENTER

THE FIBAR GROUP LLC 80 BUSINESS PARK DRIVE, SUITE 300 ARMONK, NY 10504 TOLL FREE: 1-800-342-2721 PHONE: (914) 273-8770 FAX: (914) 273-8659

www.fibar.com

ENGINEERED WOOD FIBER PLAYGROUND SAFETY SURFACING
Scale: NOT TO SCALE



MANUFACTURER: LITTLE TYKES SUPPLIER: LEA PARK & PLAY PHONE: (972) 690-8163 COLORS: TBD MODEL: R0306_45555298831



NOTES:

1. INSTALL ALL SHELTER ELEMENTS PER
MANUFACTURER'S RECOMMENDATIONS.

2. CONTRACTOR TO PROVIDE SIGNED AND SEALED
STRUCTURAL DRAWINGS FOR REVIEW PRIOR TO INSTALLATION. INSTALL WITH 12'X20' (4") CONCRETE SLAB.

MODEL: 12' X 12' NAVAJO SHELTER MANUFACTURER: AMERICANA BUILDING PRODUCTS CONTACT: LEA PARK & PLAY NICK BOLLIG, (940) 205-2761

SHELTER DETAILS



NOTES:

1. SURFACE MOUNT TO SHELTER SLAB

2. SUBMIT COLORS TO MATCH PLAYGROUND EQUIPMENT FOR APPROVAL PRIOR TO ORDERING.

MODEL: 8' RECTANGULAR EXPANDED STEEL ADA TABLE MANUFACTURER: ANOVA CONTACT: LEA PARK & PLAY NICK BOLLIG, (940) 205-2761

PICNIC TABLE



NOTES:

1. SURFACE MOUNT TO 4" CONCRETE SLAB
2. SUBMIT COLORS TO MATCH PLAYGROUND
EQUIPMENT FOR APPROVAL PRIOR TO ORDERING.

SCALE: NOT TO SCALE

NICK BOLLIG, (940) 205-2761

MODEL: 6' LATITUDE CONTOUR BENCH MANUFACTURER: ANOVA CONTACT: LEA PARK & PLAY

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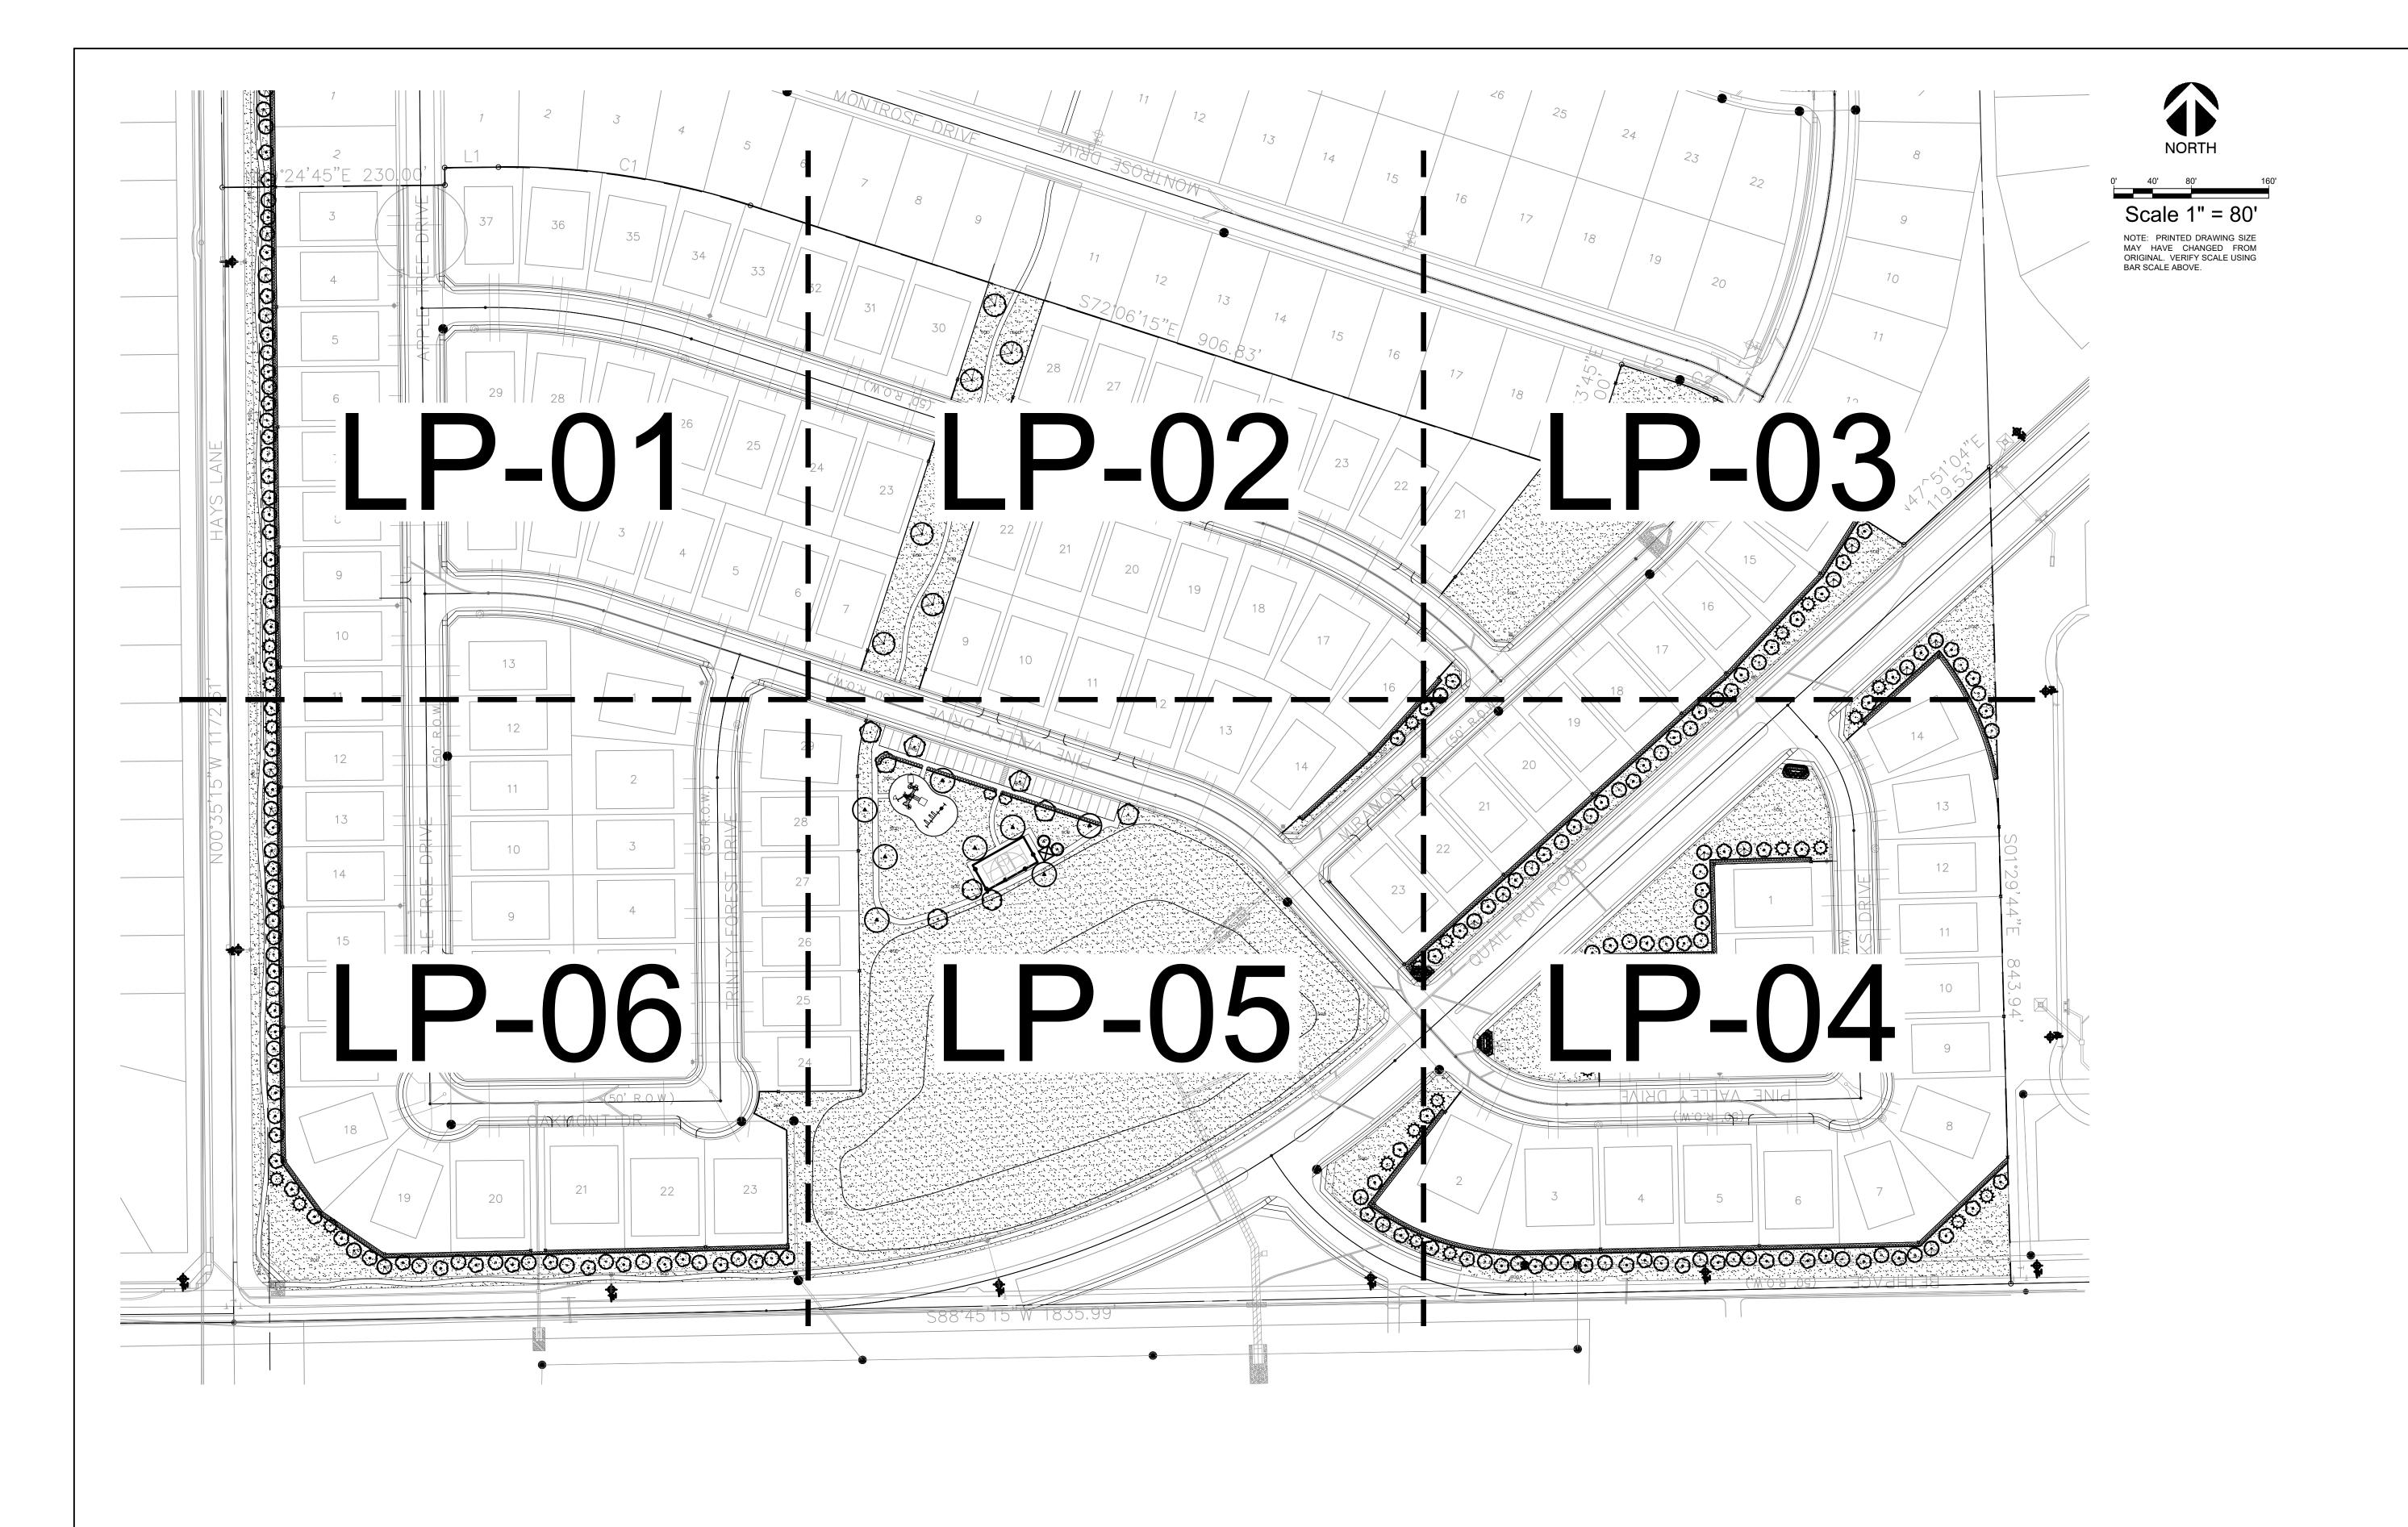
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HARDSCAPE DETAILS

Date Comment

Project Number

10/04/24 Drawn By Checked By





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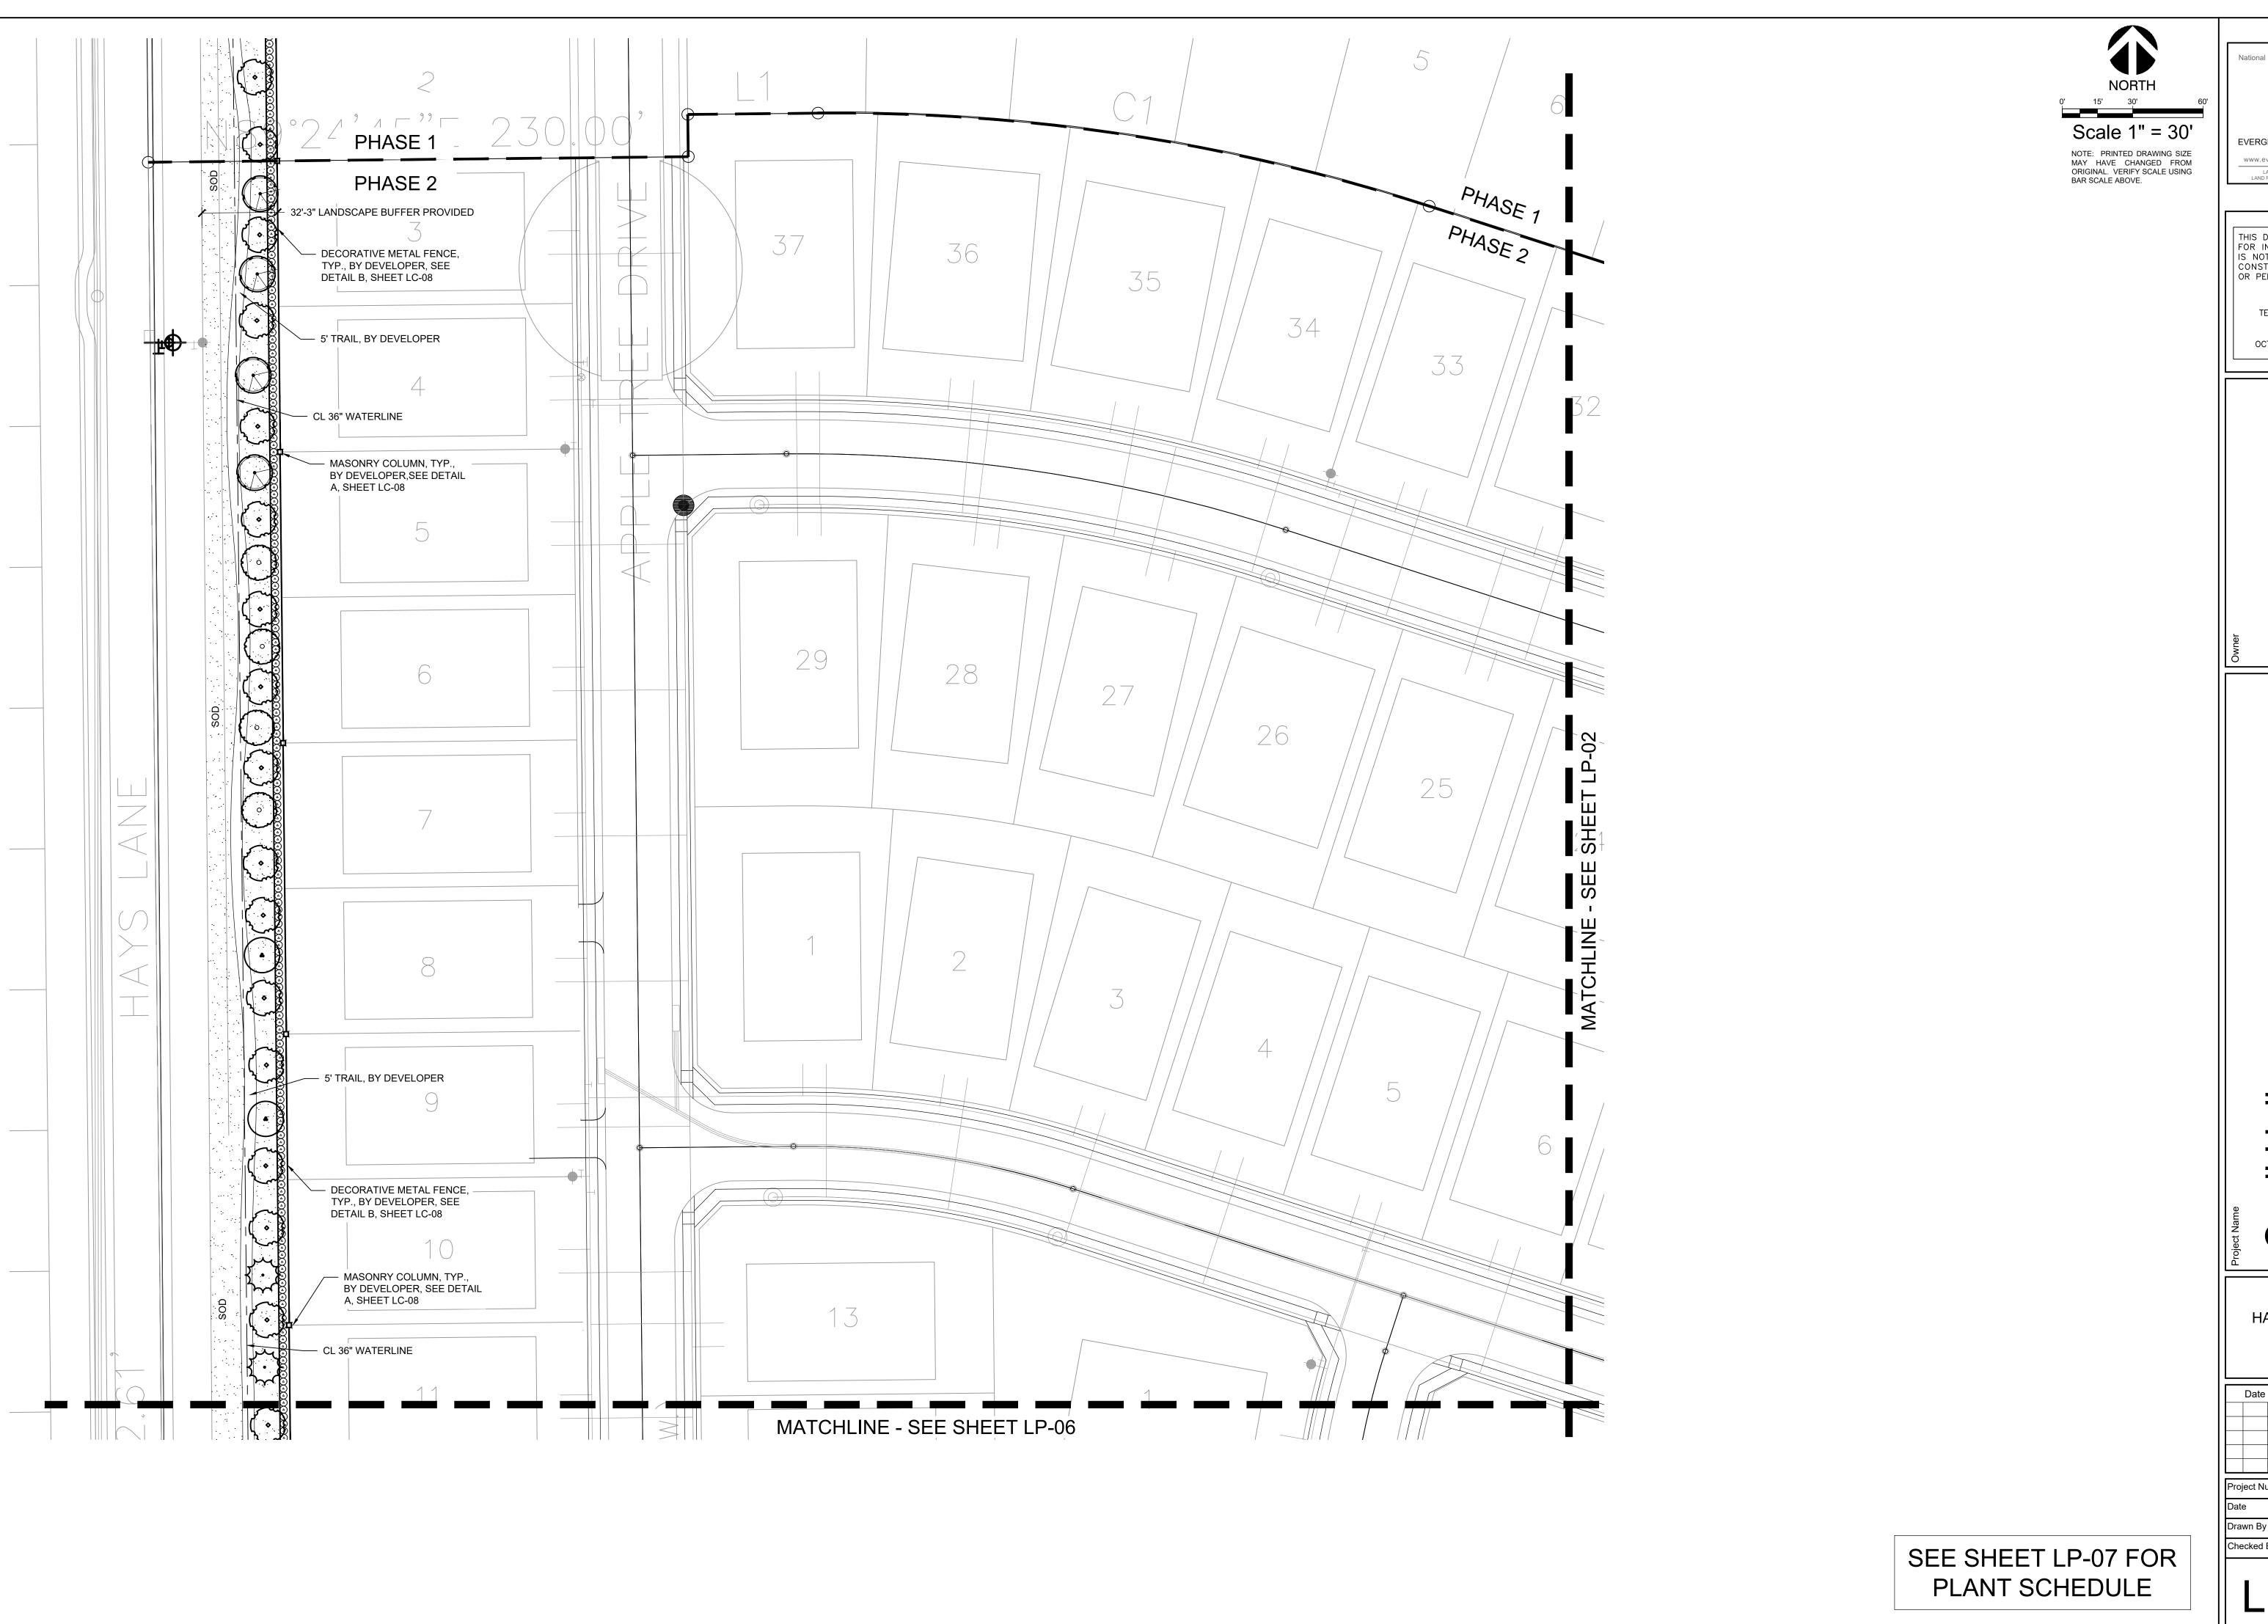
mpal ,e, Suite 9 CO r Drive Skorburg (8214 Westchester | Dallas, Texas 75225

Quail Hollow Rockwall, TX

OVERALL HARDSCAPE PLAN

Date Comment

10/04/24 Drawn By



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LANDSCAPE ARCHITECTURE

LAND PLANNING · IRRIGATION DESIGN

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MARY N. BATES TEXAS L.A. #3613

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TEXAS L.A. #3613
ISSUED ON:
OCTOBER 04, 2024

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Quail Hollow Rockwall, TX

HARDSCAPE PLAN


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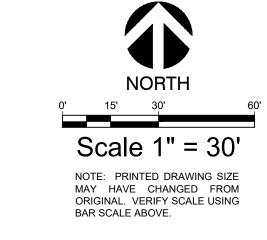
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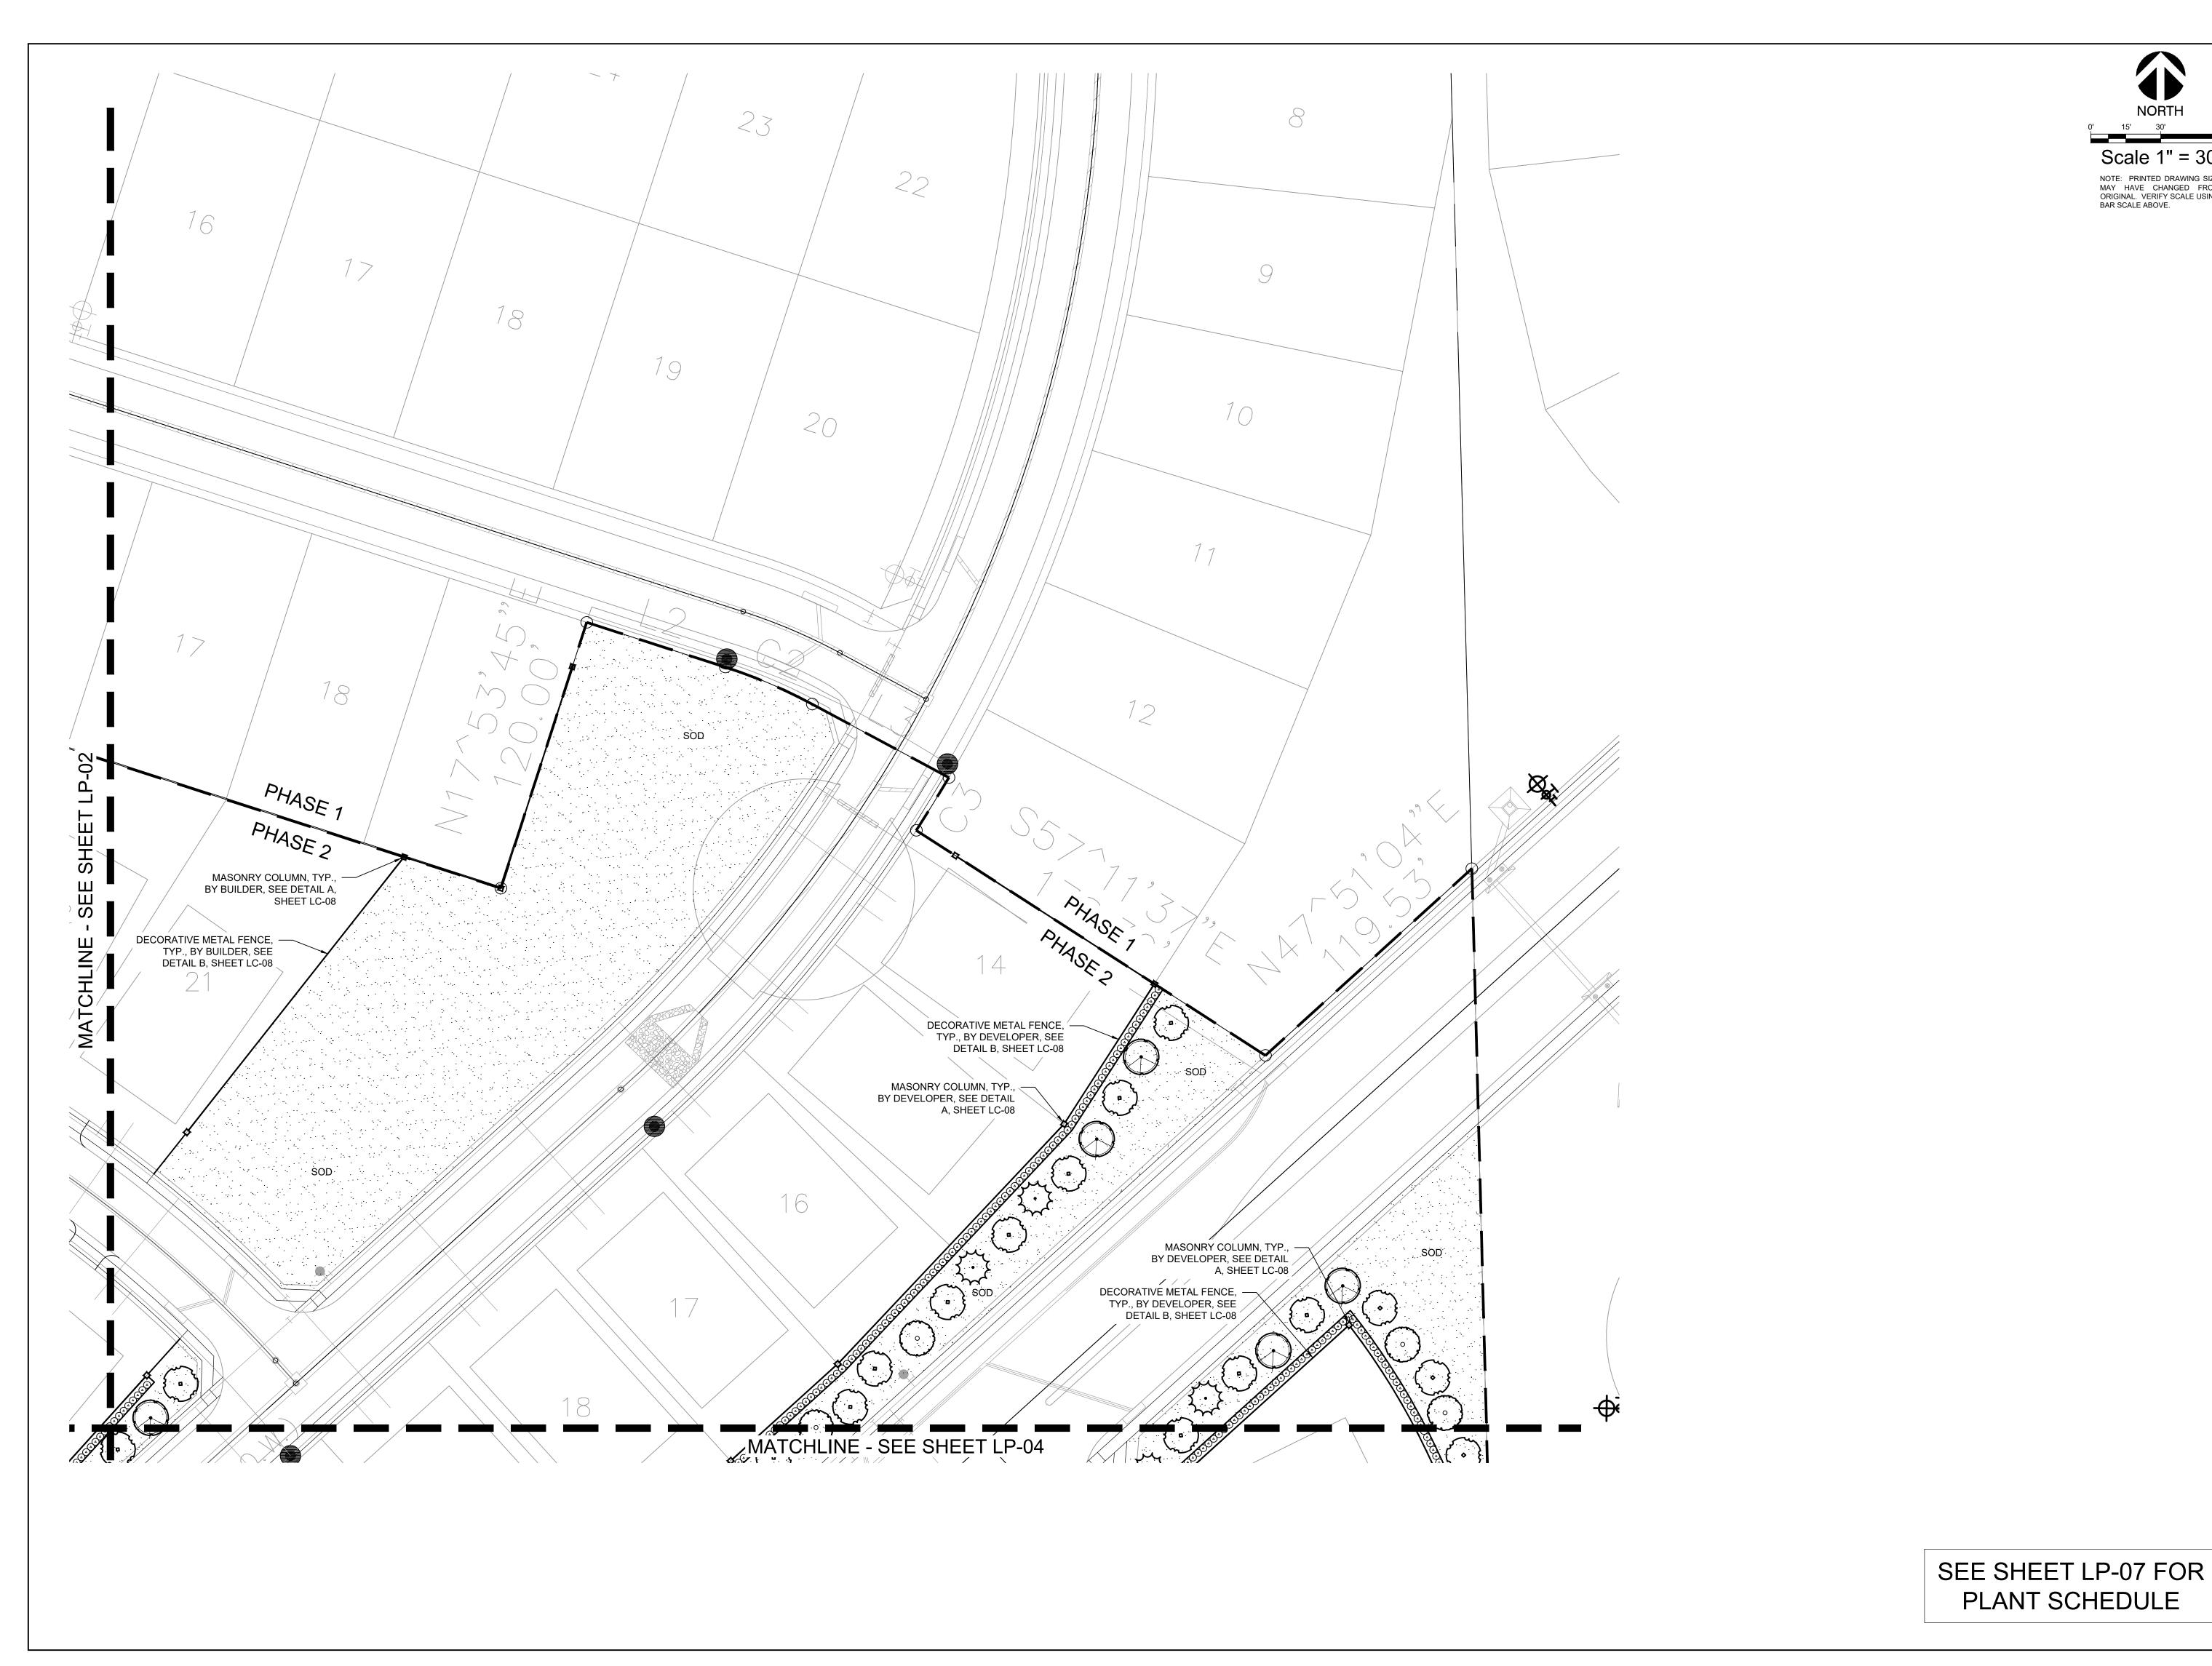
Quail Hollow Rockwall, TX

HARDSCAPE PLAN

Project Number

Date 10/04/24

SEE SHEET LP-07 FOR PLANT SCHEDULE

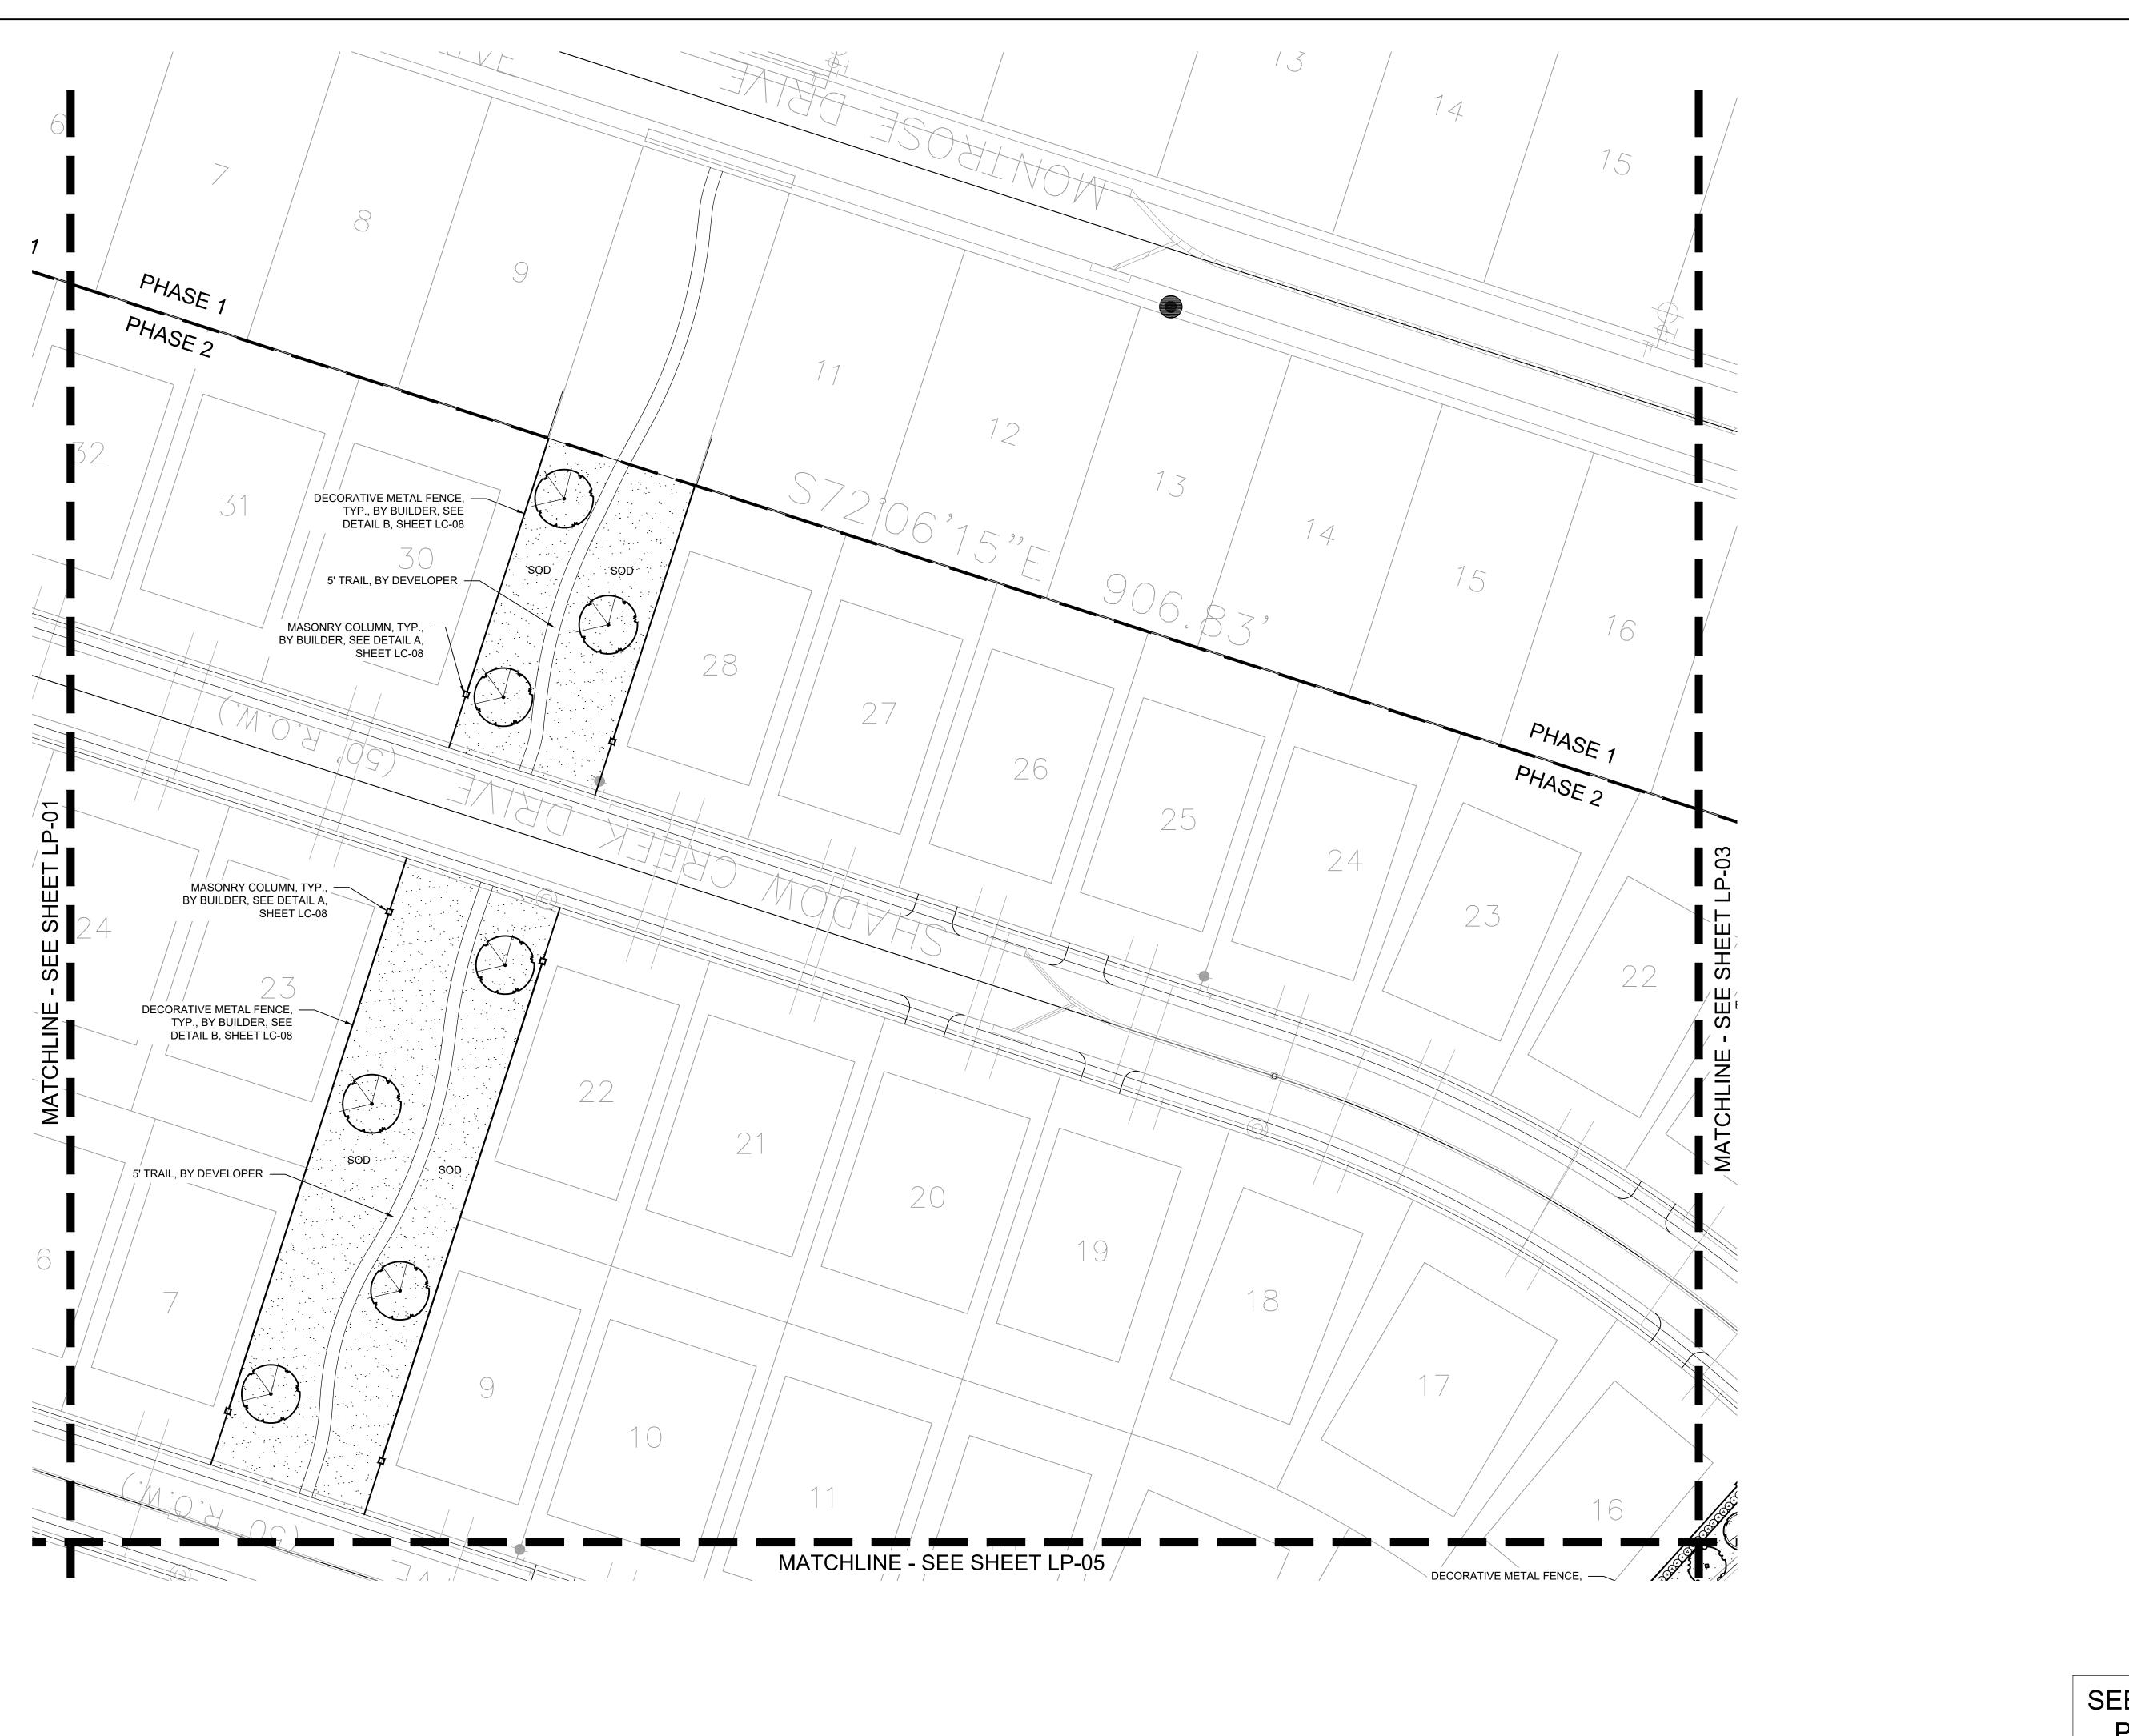

Scale 1" = 30' NOTE: PRINTED DRAWING SIZE MAY HAVE CHANGED FROM ORIGINAL. VERIFY SCALE USING BAR SCALE ABOVE.




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Hollow I, TX Quail F Rockwall,

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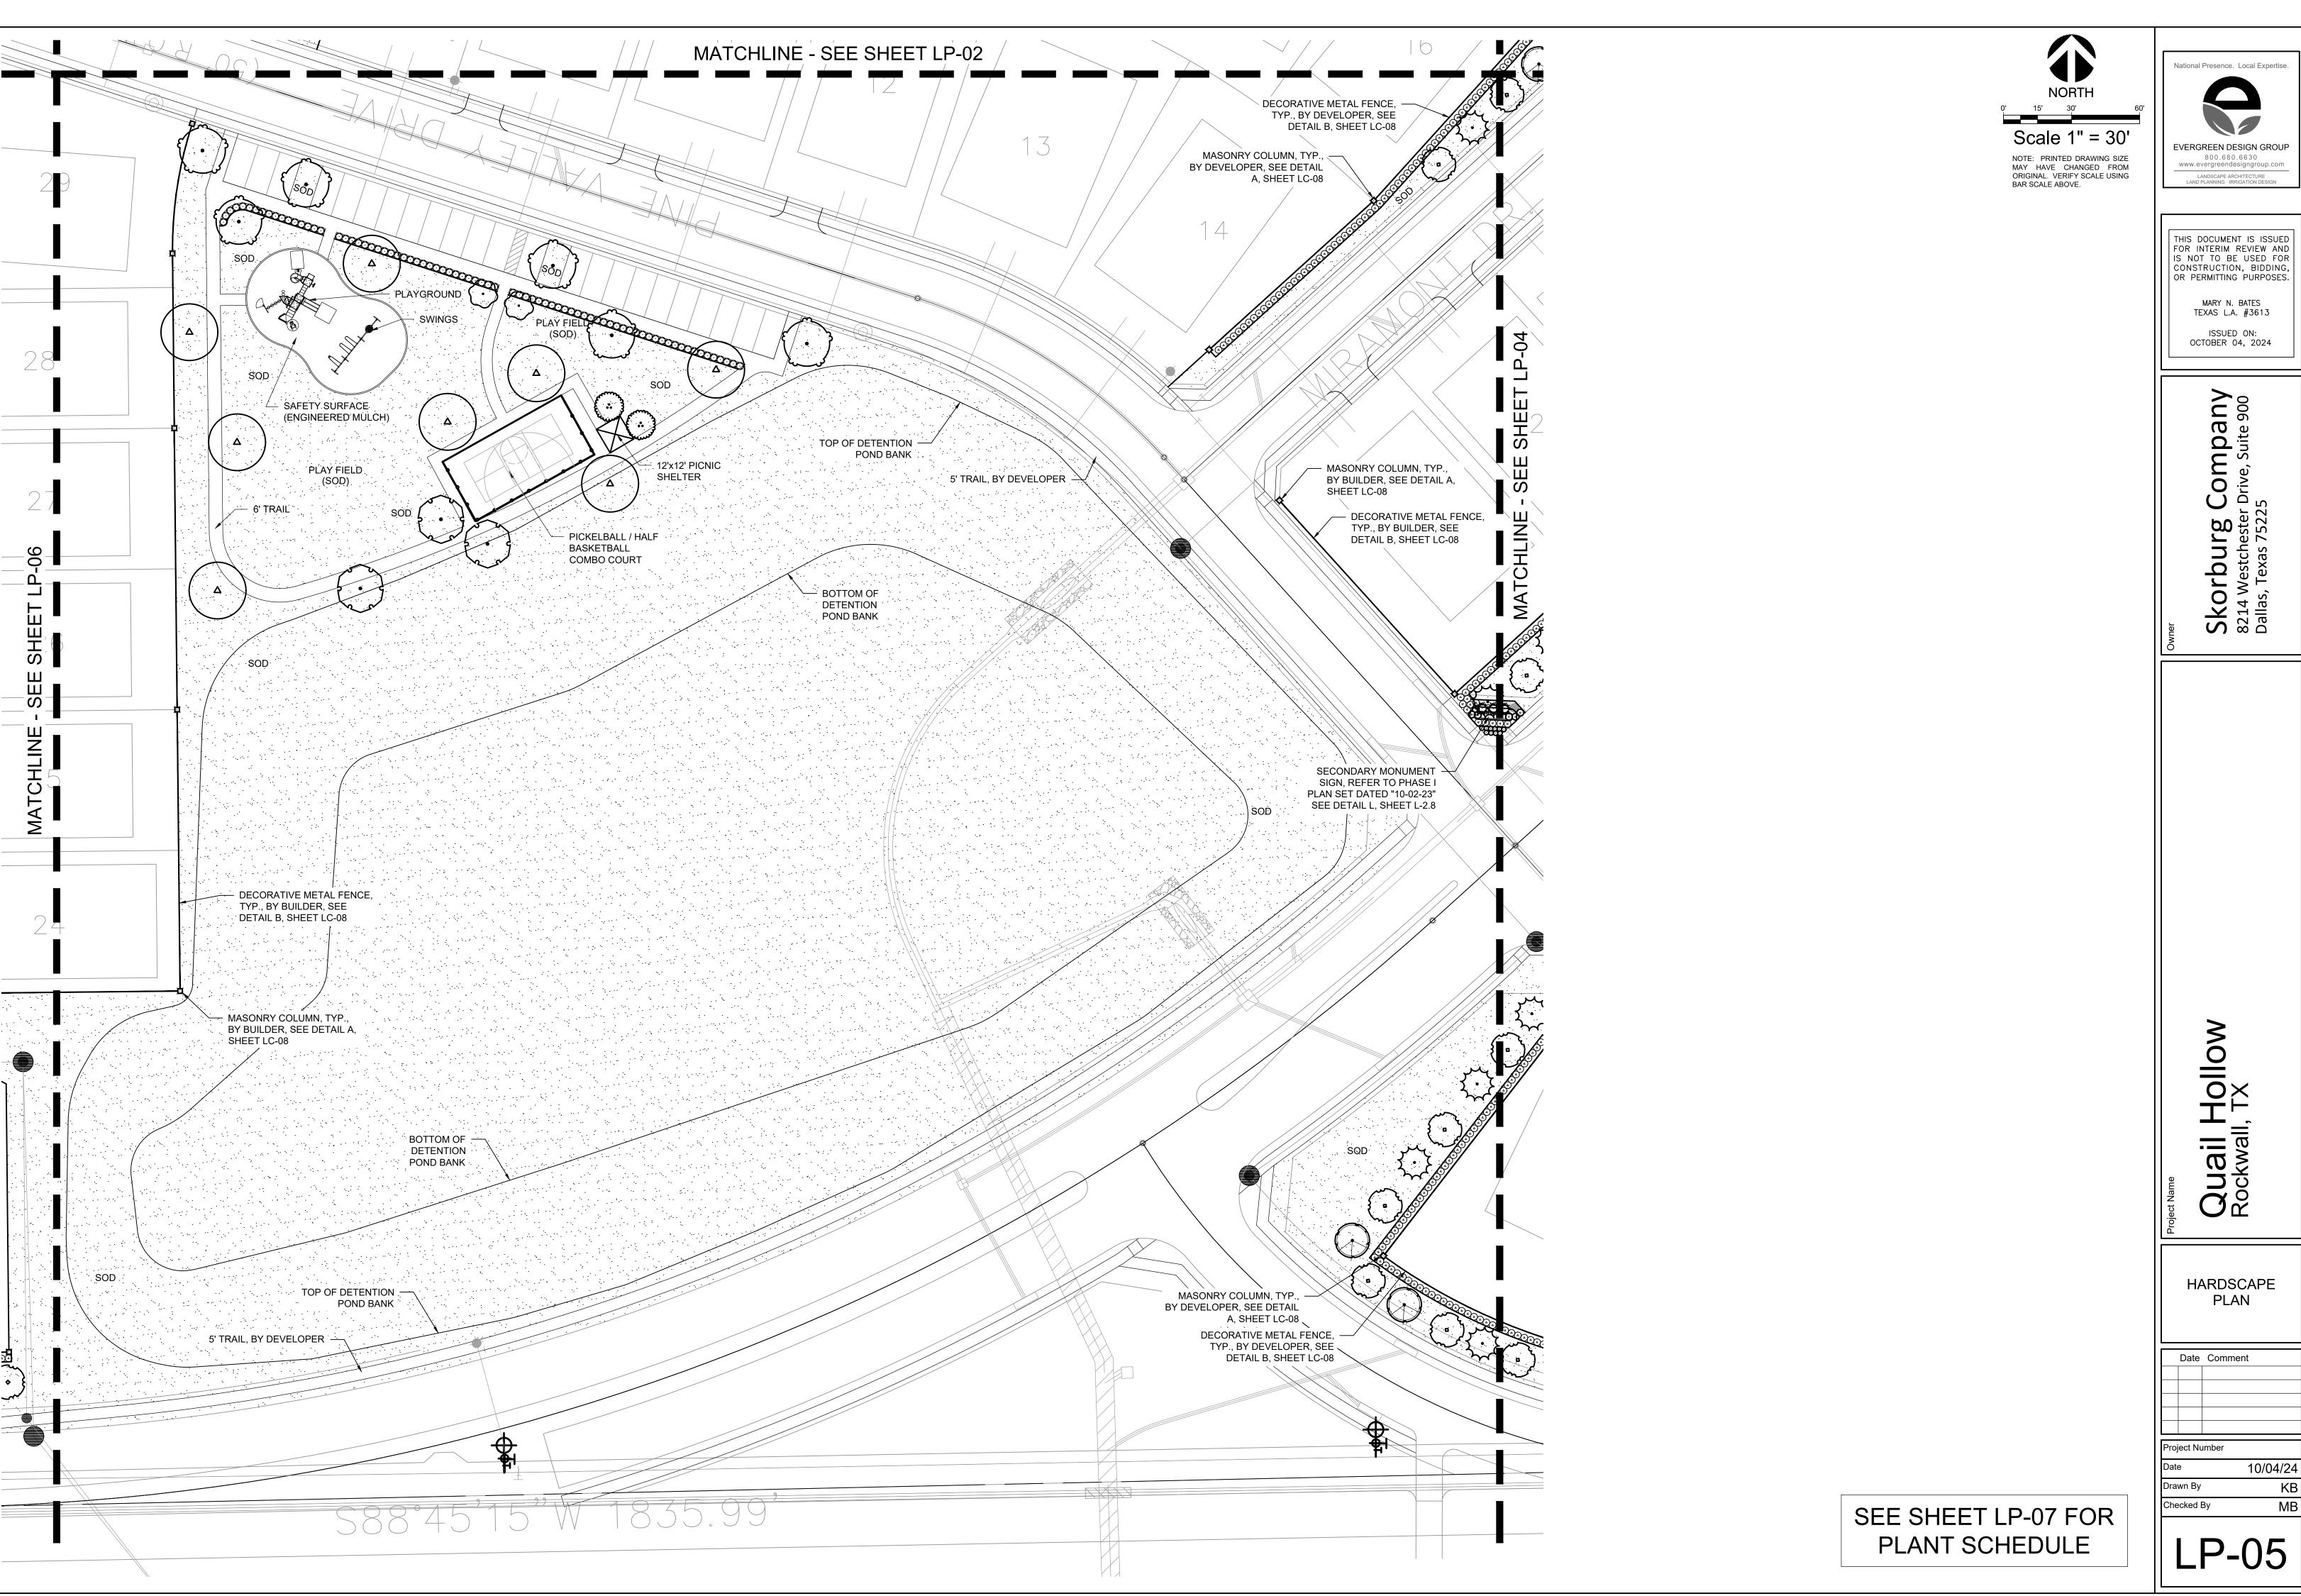
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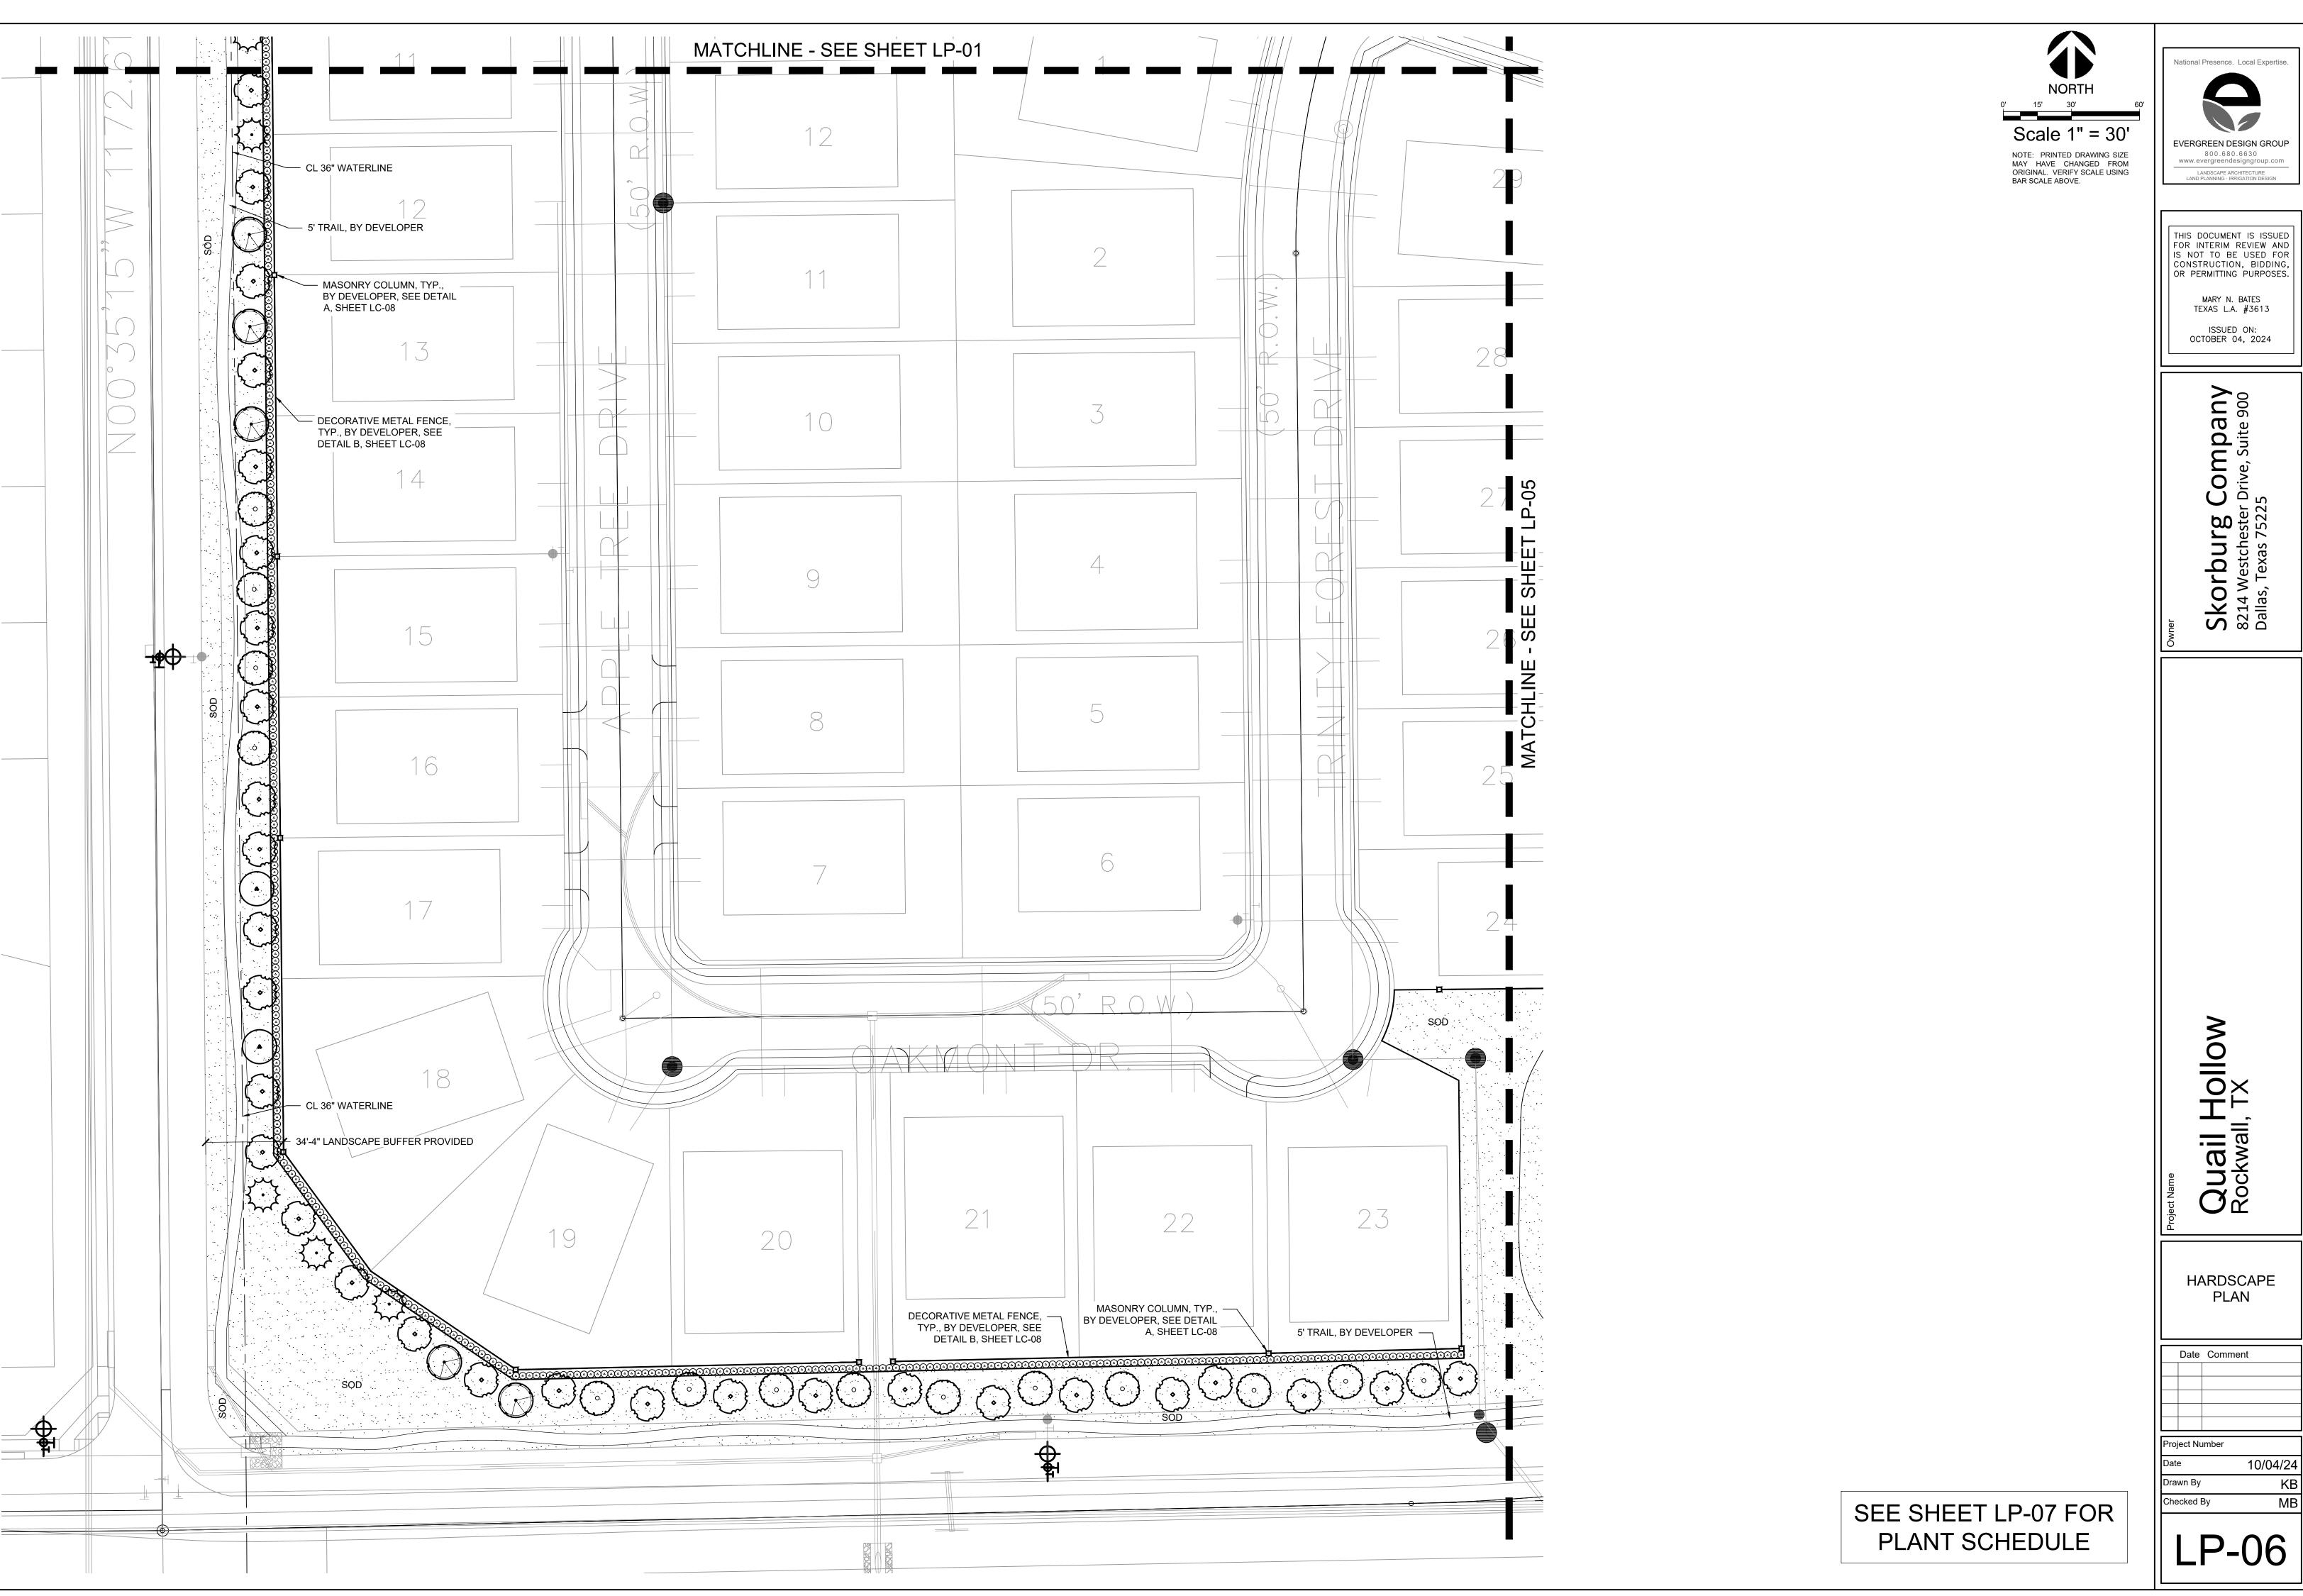
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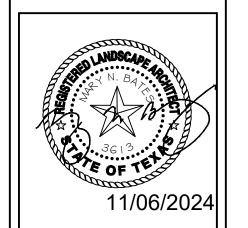


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ANT SCHEDULE								
EES	CODE	QUANTITY	COMMON NAME	BOTANICAL NAME	CONTAINER	CALIPER	SIZE	NOTES
₹·}	CL	24	DESERT WILLOW	CHILOPSIS LINEARIS	CONT OR B & B	4"		FULL, MATCHING, SYMMETRICAL
	ID	23	POSSUMHAW HOLLY	ILEX DECIDUA	CONT OR B & B	4"		FULL, MATCHING, SYMMETRICAL
\odot	IV	47	YAUPON HOLLY	ILEX VOMITORIA	CONT OR B & B	4"		FULL, MATCHING, SYMMETRICAL
	MG	104	DWARF SOUTHERN MAGNOLIA	MAGNOLIA GRANDIFLORA 'LITTLE GEM'	CONT OR B & B	4"		FULL, MATCHING, SYMMETRICAL
	QS	3	SHUMARD OAK	QUERCUS SHUMARDII	CONT OR B & B	4"		FULL, MATCHING, SYMMETRICAL
\odot	QV	8	SOUTHERN LIVE OAK	QUERCUS VIRGINIANA	CONT OR B & B	4"		FULL, MATCHING, SYMMETRICAL
\bigcirc	UC	6	CEDAR ELM	ULMUS CRASSIFOLIA	CONT OR B & B	4"		FULL, MATCHING, SYMMETRICAL
•	US	4	MEXICAN BUCKEYE	UNGNADIA SPECIOSA	CONT OR B & B	4"		FULL, MATCHING, SYMMETRICAL
NAMENTAL TREES	CODE	QUANITITY	COMMON NAME	BOTANICAL NAME	CONTAINER	SIZE	SIZE	NOTES
\odot	CL	2	DESERT WILLOW	CHILOPSIS LINEARIS	CONT OR B & B		4' HT MIN	FULL, MATCHING, SYMMETRICAL
	LI	2	CRAPE MYRTLE	LAGERSTROEMIA INDICA	CONT OR B & B		4' HT MIN	FULL, MATCHING, SYMMETRICAL
RUBS	CODE	QUANITITY	COMMON NAME	BOTANICAL NAME	CONTAINER	SIZE	SPACING	NOTES
	cs	9	PAPAS GRASS	CORTAGERIA SELLOANA	5 GAL.	24" HT.	36" O.C.	FULL, MATCHING, SYMMETRICAL
0	DX	78	DWARF WAX MYRTLE	MYRICA PUSILLA	5 GAL.		36" O.C.	FULL, MATCHING, SYMMETRICAL
0	IC	1345	DWARF BUFORD HOLLY	ILEX CORNUTA 'DWARF BURFORD'	5 GAL.	24" HT.	36" O.C.	FULL, MATCHING, SYMMETRICAL
	MC	18	PINK MUHLY	MUHLENBERGIA CAPILLARIS	5 GAL.	24" HT.	36" O.C.	FULL, MATCHING, SYMMETRICAL
\odot	SG	36	AUTUMN SAGE	SALVIA GREGGII	1 GAL.	12" HT.	24" O.C.	FULL, MATCHING, SYMMETRICAL
)	CODE	QUANITITY	COMMON NAME	BOTANICAL NAME	CONTAINER	SIZE	SPACING	NOTES
SON	SOD	387,179 SF	CYNODON DACTYLON 'TIF 419'	TIF 419 BERMUDAGRASS		SOLID SOD		



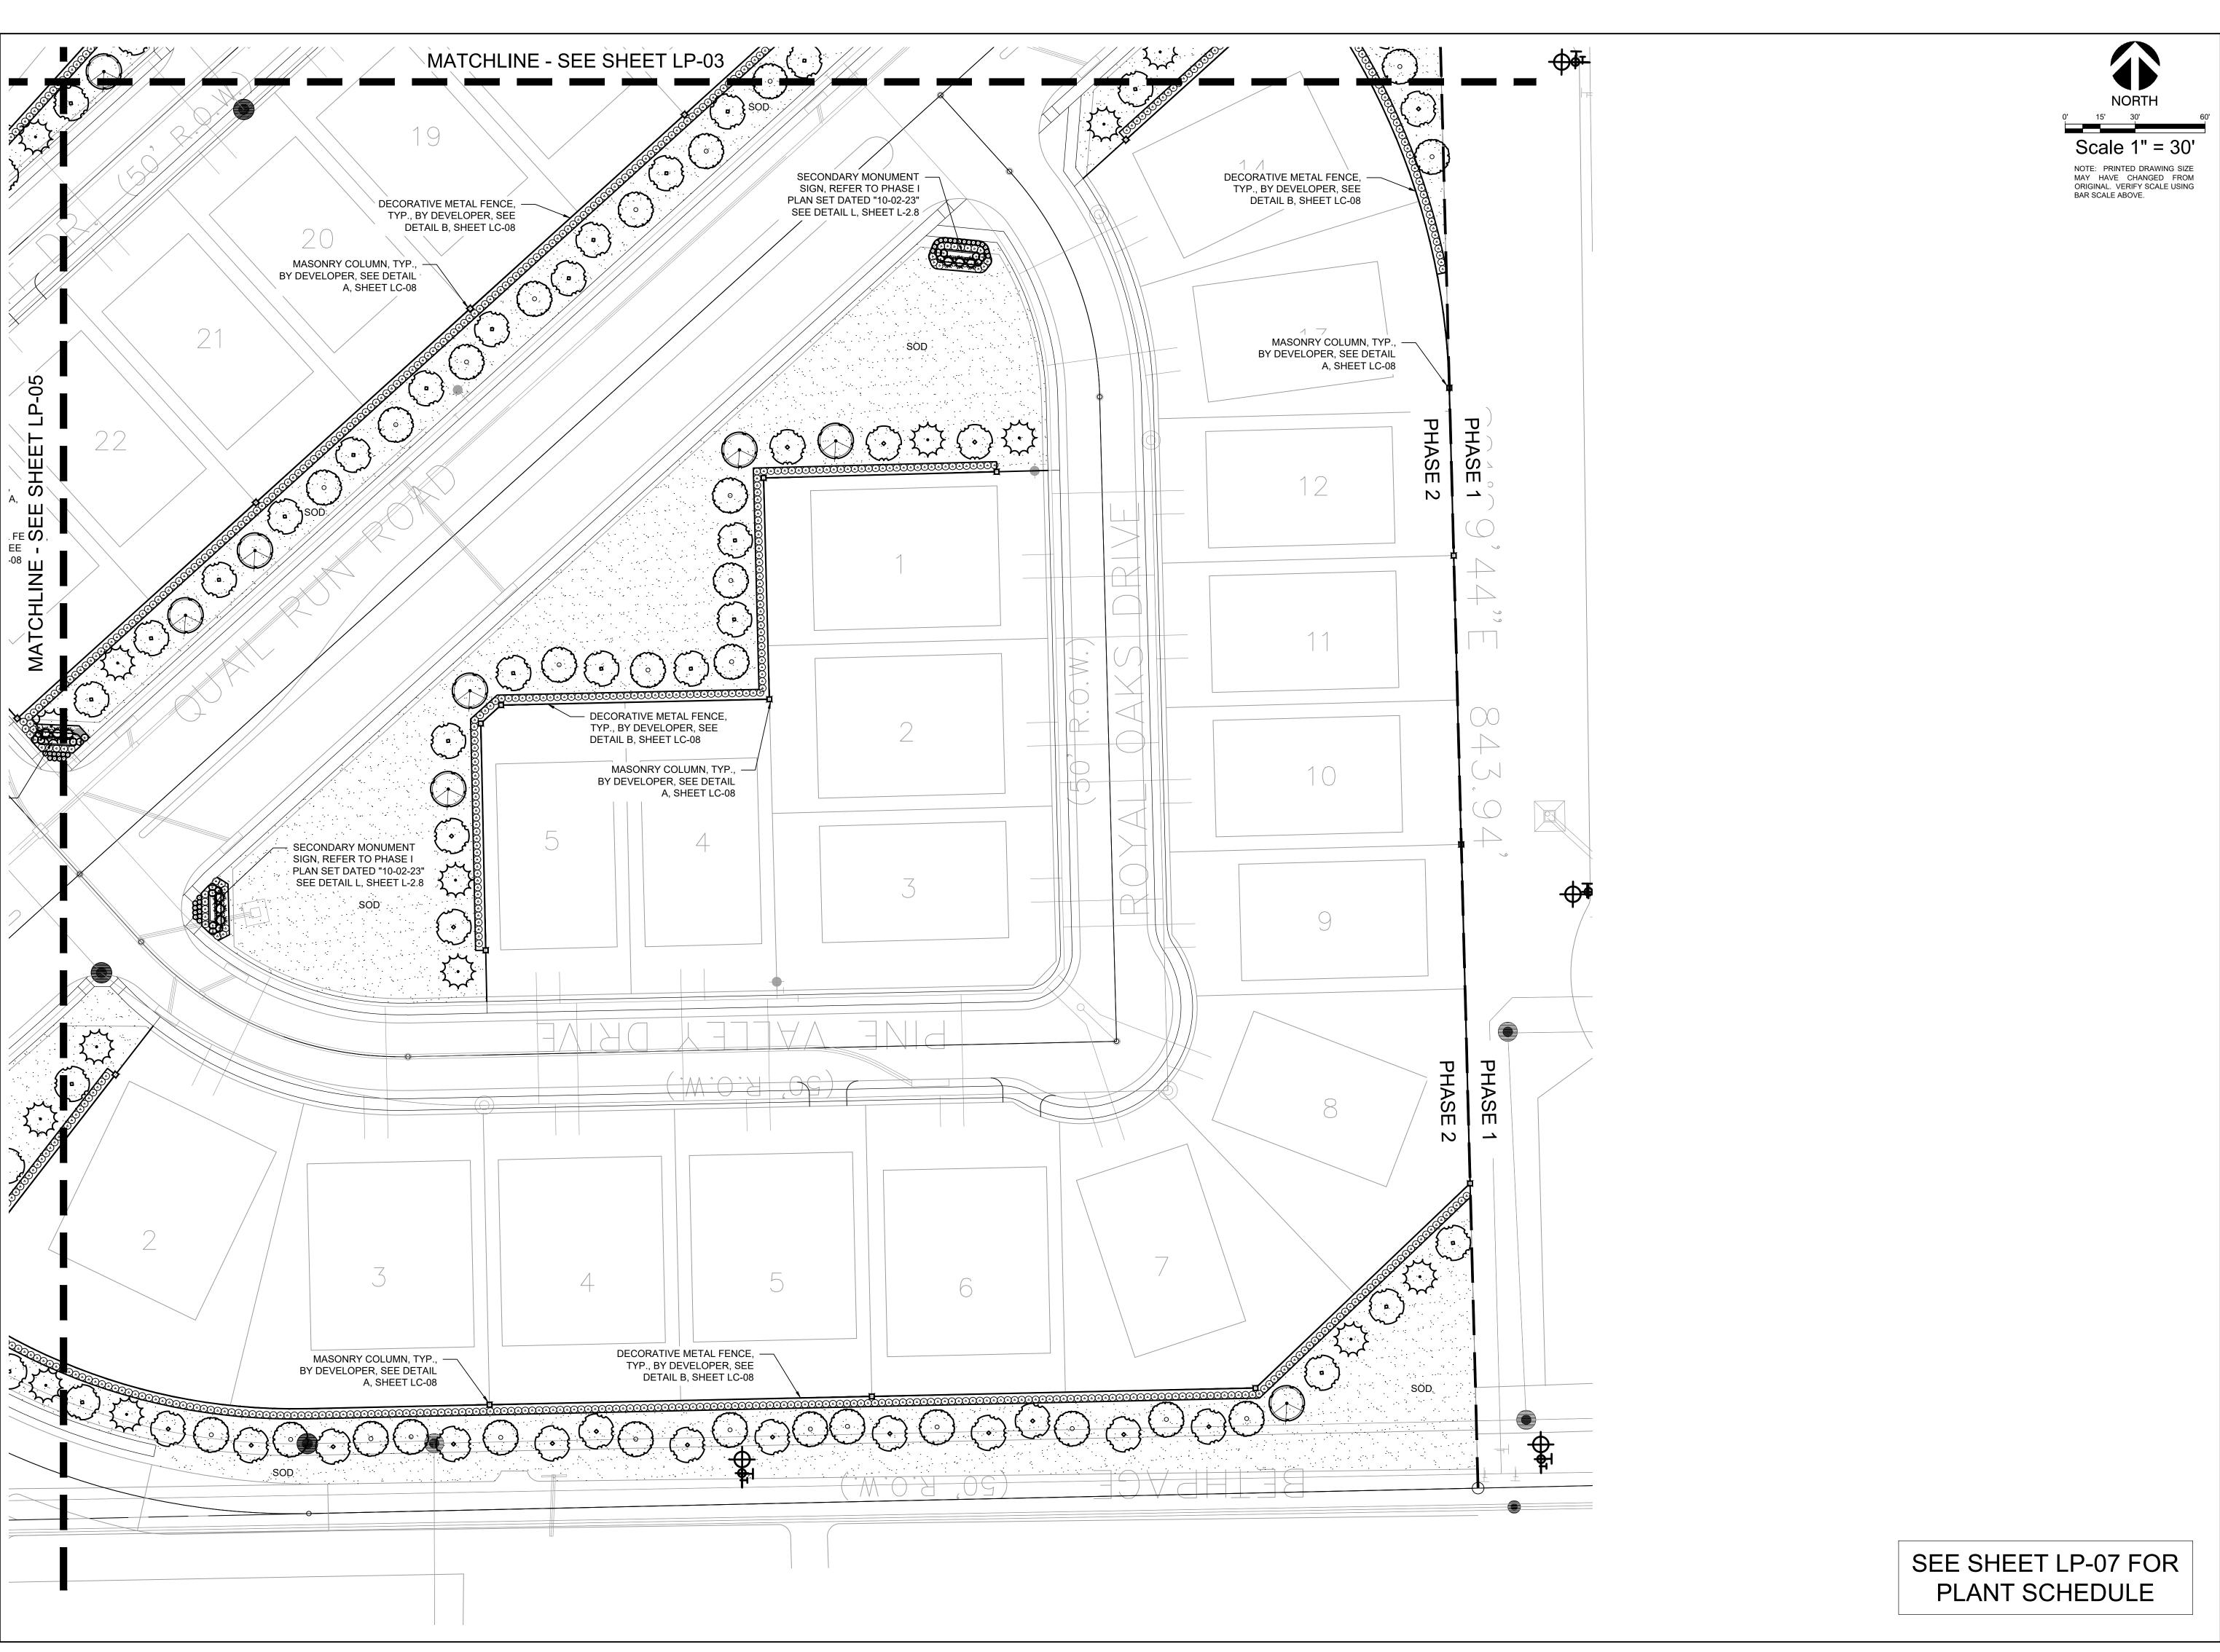

Skorburg Company 8214 Westchester Drive, Suite 900 Dallas, Texas 75225

Quail Hollow Rockwall, TX

> HARDSCAPE PLAN

Date Comment

Project Number

 Date
 10/04/24

 Drawn By
 KB

 Checked By
 MB

I P-07

PLANTING SPECIFICATIONS

GENERAL

- A. QUALIFICATIONS OF LANDSCAPE CONTRACTOR ALL LANDSCAPE WORK SHOWN ON THESE PLANS SHALL BE PERFORMED BY A SINGLE FIRM
- SPECIALIZING IN LANDSCAPE PLANTING. A LIST OF SUCCESSFULLY COMPLETED PROJECTS OF THIS TYPE, SIZE AND NATURE MAY BE REQUESTED BY THE OWNER FOR FURTHER QUALIFICATION MEASURES.
- THE LANDSCAPE CONTRACTOR SHALL HOLD A VALID NURSERY AND FLORAL CERTIFICATE ISSUED BY THE TEXAS DEPARTMENT OF AGRICULTURE, AS WELL AS OPERATE UNDER A COMMERCIAL PESTICIDE APPLICATOR LICENSE ISSUED BY EITHER THE TEXAS DEPARTMENT OF AGRICULTURE OR THE TEXAS STRUCTURAL PEST CONTROL BOARD.
- WORK COVERED BY THESE SECTIONS INCLUDES THE FURNISHING AND PAYMENT OF ALL MATERIALS, LABOR SERVICES FOUIPMENT LICENSES TAXES AND ANY OTHER ITEMS THAT ARE NECESSARY FOR THE EXECUTION, INSTALLATION AND COMPLETION OF ALL WORK, SPECIFIED HEREIN AND / OR SHOWN
- ON THE LANDSCAPE PLANS, NOTES, AND DETAILS. ALL WORK SHALL BE PERFORMED IN ACCORDANCE WITH ALL APPLICABLE LAWS, CODES AND REGULATIONS REQUIRED BY AUTHORITIES HAVING JURISDICTION OVER SUCH WORK, INCLUDING ALL INSPECTIONS AND PERMITS REQUIRED BY FEDERAL, STATE AND LOCAL AUTHORITIES IN SUPPLY, TRANSPORTATION AND INSTALLATION OF MATERIALS.
- THE LANDSCAPE CONTRACTOR SHALL VERIFY THE LOCATION OF ALL UNDERGROUND UTILITY LINES (WATER, SEWER, ELECTRICAL, TELEPHONE, GAS, CABLE, TELEVISION, ETC.) PRIOR TO THE START OF

PRODUCTS

- ALL MANUFACTURED PRODUCTS SHALL BE NEW. CONTAINER AND BALLED-AND-BURLAPPED PLANTS
- FURNISH NURSERY-GROWN PLANTS COMPLYING WITH ANSI Z60.1-2014. PROVIDE WELL-SHAPED, FULLY BRANCHED, HEALTHY, VIGOROUS STOCK FREE OF DISEASE, INSECTS, EGGS, LARVAE, AND DEFECTS SUCH AS KNOTS, SUN SCALD, INJURIES, ABRASIONS, AND DISFIGUREMENT. ALL PLANTS WITHIN A SPECIES SHALL HAVE SIMILAR SIZE, AND SHALL BE OF A FORM TYPICAL FOR THE SPECIES. ALL TREES SHALL BE OBTAINED FROM SOURCES WITHIN 200 MILES OF THE PROJECT SITE, AND WITH SIMILAR
- CLIMACTIC CONDITIONS. ROOT SYSTEMS SHALL BE HEALTHY, DENSELY BRANCHED ROOT SYSTEMS, NON-POT-BOUND, FREE FROM ENCIRCLING AND/OR GIRDLING ROOTS, AND FREE FROM ANY OTHER ROOT DEFECTS (SUCH AS
- TREES MAY BE PLANTED FROM CONTAINERS OR BALLED-AND-BURLAPPED (B&B), UNLESS SPECIFIED ON THE PLANTING LEGEND. BARE-ROOT TREES ARE NOT ACCEPTABLE. ANY PLANT DEEMED UNACCEPTABLE BY THE LANDSCAPE ARCHITECT OR OWNER SHALL BE
- IMMEDIATELY REMOVED FROM THE SITE AND SHALL BE REPLACED WITH AN ACCEPTBLE PLANT OF LIKE TYPE AND SIZE AT THE CONTRACTOR'S OWN EXPENSE. ANY PLANTS APPEARING TO BE UNHEALTHY EVEN IF DETERMINED TO STILL BE ALIVE. SHALL NOT BE ACCEPTED. THE LANDSCAPE ARCHITECT AND OWNER SHALL BE THE SOLE JUDGES AS TO THE ACCEPTABILITY OF PLANT MATERIAL
- 5. ALL TREES SHALL BE STANDARD IN FORM, UNLESS OTHERWISE SPECIFIED. TREES WITH CENTRAL LEADERS WILL NOT BE ACCEPTED IF LEADER IS DAMAGED OR REMOVED. PRUNE ALL DAMAGED TWIGS
- CALIPER MEASUREMENTS FOR STANDARD (SINGLE TRUNK) TREES SHALL BE AS FOLLOWS: SIX INCHES ABOVE THE ROOT FLARE FOR TREES UP TO AND INCLUDING FOUR INCHES IN CALIPER, AND TWELVE INCHES ABOVE THE ROOT FLARE FOR TREES EXCEEDING FOUR INCHES IN CALIPER.
- MULTI-TRUNK TREES SHALL BE MEASURED BY THEIR OVERALL HEIGHT, MEASURED FROM THE TOP OF THE ROOT BALL. WHERE CALIPER MEASUREMENTS ARE USED, THE CALIPER SHALL BE CALCULATED AS ONE-HALF OF THE SUM OF THE CALIPER OF THE THREE LARGEST TRUNKS. ANY TREE OR SHRUB SHOWN TO HAVE EXCESS SOIL PLACED ON TOP OF THE ROOT BALL, SO THAT
- THE ROOT FLARE HAS BEEN COMPLETELY COVERED, SHALL BE REJECTED. SOD: PROVIDE WELL-ROOTED SOD OF THE VARIETY NOTED ON THE PLANS. SOD SHALL BE CUT FROM HEALTHY, MATURE TURF WITH SOIL THICKNESS OF 3/4" TO 1". EACH PALLET OF SOD SHALL BE
- ACCOMPANIED BY A CERTIFICATE FROM SUPPLIER STATING THE COMPOSITION OF THE SOD. SEED: PROVIDE BLEND OF SPECIES AND VARIETIES AS NOTED ON THE PLANS, WITH MAXIMUM PERCENTAGES OF PURITY, GERMINATION, AND MINIMUM PERCENTAGE OF WEED SEED AS INDICATED ON PLANS. EACH BAG OF SEED SHALL BE ACCOMPANIED BY A TAG FROM THE SUPPLIER INDICATING THE
- TOPSOIL: SANDY TO CLAY LOAM TOPSOIL, FREE OF STONES LARGER THAN ½ INCH, FOREIGN MATTER,
- PLANTS, ROOTS, AND SEEDS. COMPOST: WELL-COMPOSTED, STABLE, AND WEED-FREE ORGANIC MATTER, pH RANGE OF 5.5 TO 8; MOISTURE CONTENT 35 TO 55 PERCENT BY WEIGHT; 100 PERCENT PASSING THROUGH 3/4-INCH SIEVE; SOLUBLE SALT CONTENT OF 5 TO 10 DECISIEMENS/M; NOT EXCEEDING 0.5 PERCENT INERT CONTAMINANTS AND FREE OF SUBSTANCES TOXIC TO PLANTINGS. NO MANURE OR ANIMAL-BASED PRODUCTS SHALL BE
- G. FERTILIZER: GRANULAR FERTILIZER CONSISTING OF NITROGEN, PHOSPHORUS, POTASSIUM, AND OTHER NUTRIENTS IN PROPORTIONS, AMOUNTS, AND RELEASE RATES RECOMMENDED IN A SOIL REPORT FROM A
- QUALIFIED SOIL-TESTING AGENCY (SEE BELOW). H. MULCH: SIZE AND TYPE AS INDICATED ON PLANS, FREE FROM DELETERIOUS MATERIALS AND SUITABLE AS A
- TOP DRESSING OF TREES AND SHRUBS. TREE STAKING AND GLIVING
- STAKES: 6' LONG GREEN METAL T-POSTS. GUY AND TIE WIRE: ASTM A 641, CLASS 1, GALVANIZED-STEEL WIRE, 2-STRAND, TWISTED, 0.106 INCH
- STRAP CHAFING GUARD: REINFORCED NYLON OR CANVAS AT LEAST 1-1/2 INCH WIDE, WITH GROMMETS TO PROTECT TREE TRUNKS FROM DAMAGE STEEL EDGING: PROFESSIONAL STEEL EDGING. 14 GAUGE THICK X 4 INCHES WIDE. FACTORY PAINTED DARK
- GREEN. ACCEPTABLE MANUFACTURERS INCLUDE COL-MET OR APPROVED EQUAL. M. PRE-EMERGENT HERBICIDES: ANY GRANULAR, NON-STAINING PRE-EMERGENT HERBICIDE THAT IS LABELED FOR THE SPECIFIC ORNAMENTALS OR TURF ON WHICH IT WILL BE UTILIZED. PRE-EMERGENT HERBICIDES SHALL BE APPLIED PER THE MANUFACTURER'S LABELED RATES.

METHODS

 A. SOIL PREPARATION BEFORE STARTING WORK, THE LANDSCAPE CONTRACTOR SHALL VERIFY THAT THE GRADE OF ALL LANDSCAPE AREAS ARE WITHIN +/-0.1' OF FINISH GRADE. THE CONTRACTOR SHALL NOTIFY THE

OWNER IMMEDIATELY SHOULD ANY DISCREPANCIES EXIST.

- a. AFTER FINISH GRADES HAVE BEEN ESTABLISHED, CONTRACTOR SHALL HAVE SOIL SAMPLES FROM THE PROJECT'S LANDSCAPE AREAS TESTED BY AN ESTABLISHED SOIL TESTING LABORATORY. EACH SAMPLE SUBMITTED TO THE LAB SHALL CONTAIN NO LESS THAN ONE QUART OF SOIL, TAKEN FROM BETWEEN THE SOIL SURFACE AND 6" DEPTH. IF NO SAMPLE LOCATIONS ARE INDICATED ON THE PLANS, THE CONTRACTOR SHALL TAKE A MINIMUM OF THREE SAMPLES FROM VARIOUS REPRESENTATIVE LOCATIONS FOR TESTING.
- THE CONTRACTOR SHALL HAVE THE SOIL TESTING LABORATORY PROVIDE RESULTS FOR THE FOLLOWING: SOIL TEXTURAL CLASS, GENERAL SOIL FERTILITY, pH, ORGANIC MATTER CONTENT, SALT (CEC), LIME, SODIUM ADSORPTION RATIO (SAR) AND BORON CONTENT. c. THE CONTRACTOR SHALL ALSO SUBMIT THE PROJECT'S PLANT LIST TO THE LABORATORY ALONG
- WITH THE SOIL SAMPLES. d. THE SOIL REPORT PRODUCED BY THE LABORATORY SHALL CONTAIN RECOMMENDATIONS FOR THE FOLLOWING (AS APPROPRIATE): SEPARATE SOIL PREPARATION AND BACKFILL MIX RECOMMENDATIONS FOR GENERAL ORNAMENTAL PLANTS, XERIC PLANTS, TURE, AND NATIVE SEED. AS WELL AS PRE-PLANT FERTILIZER APPLICATIONS AND RECOMMENDATIONS FOR ANY OTHER SOIL RELATED ISSUES. THE REPORT SHALL ALSO PROVIDE A FERTILIZER PROGRAM FOR
- THE ESTABLISHMENT PERIOD AND FOR LONG-TERM MAINTENANCE. THE CONTRACTOR SHALL INSTALL SOIL AMENDMENTS AND FERTILIZERS PER THE SOILS REPORT RECOMMENDATIONS. ANY CHANGE IN COST DUE TO THE SOIL REPORT RECOMMENDATIONS. EITHER
- INCREASE OR DECREASE. SHALL BE SUBMITTED TO THE OWNER WITH THE REPORT. FOR BIDDING PURPOSES ONLY, THE SOIL PREPARATION SHALL CONSIST OF THE FOLLOWING TURF: INCORPORATE THE FOLLOWING AMENDMENTS INTO THE TOP 8" OF SOIL BY MEANS OF
- ROTOTILLING AFTER CROSS-RIPPING: NITROGEN STABILIZED ORGANIC AMENDMENT - 4 CU. YDS. PER 1,000 S.F. PREPLANT TURF FERTILIZER (10-20-10 OR SIMILAR, SLOW RELEASE, ORGANIC) - 15 LBS PER 1,000
- iii. "CLAY BUSTER" OR EQUAL USE MANUFACTURER'S RECOMMENDED RATE TREES, SHRUBS, AND PERENNIALS: INCORPORATE THE FOLLOWING AMENDMENTS INTO THE TOP 8" OF SOIL BY MEANS OF ROTOTILLING AFTER CROSS-RIPPING:
- NITROGEN STABILIZED ORGANIC AMENDMENT 4 CU. YDS. PER 1,000 S.F. 12-12-12 FERTILIZER (OR SIMILAR, ORGANIC, SLOW RELEASE) - 10 LBS. PER CU. YD. "CLAY BUSTER" OR EQUAL - USE MANUFACTURER'S RECOMMENDED RATE IRON SULPHATE - 2 LBS. PER CU. YD.
- 5. IN THE CONTEXT OF THESE PLANS, NOTES, AND SPECIFICATIONS, "FINISH GRADE" REFERS TO THE FINAL ELEVATION OF THE SOIL SURFACE (NOT TOP OF MULCH) AS INDICATED ON THE GRADING PLANS. a. BEFORE STARTING WORK, THE LANDSCAPE CONTRACTOR SHALL VERIFY THAT THE ROUGH GRADES OF ALL LANDSCAPE AREAS ARE WITHIN +/-0.1' OF FINISH GRADE. SEE SPECIFICATIONS
- FOR MORE DETAILED INSTRUCTION ON TURF AREA AND PLANTING BED PREPARATION. CONSTRUCT AND MAINTAIN FINISH GRADES AS SHOWN ON GRADING PLANS, AND CONSTRUCT AND MAINTAIN SLOPES AS RECOMMENDED BY THE GEOTECHNICAL REPORT. ALL LANDSCAPE AREAS SHALL HAVE POSITIVE DRAINAGE AWAY FROM STRUCTURES AT THE MINIMUM SLOPE SPECIFIED IN THE REPORT AND ON THE GRADING PLANS, AND AREAS OF POTENTIAL PONDING SHALL BE REGRADED TO BLEND IN WITH THE SURROUNDING GRADES AND ELIMINATE PONDING
- c. THE LANDSCAPE CONTRACTOR SHALL DETERMINE WHETHER OR NOT THE EXPORT OF ANY SOIL WILL BE NEEDED. TAKING INTO ACCOUNT THE ROUGH GRADE PROVIDED. THE AMOUNT OF SOIL AMENDMENTS TO BE ADDED (BASED ON A SOIL TEST, PER SPECIFICATIONS), AND THE FINISH GRADES TO BE ESTABLISHED.
- d. ENSURE THAT THE FINISH GRADE IN SHRUB AREAS IMMEDIATELY ADJACENT TO WALKS AND OTHER WALKING SURFACES, AFTER INSTALLING SOIL AMENDMENTS, IS 3" BELOW THE ADJACENT FINISH SURFACE IN ORDER TO ALLOW FOR PROPER MUI CHIDEPTH. TAPER THE SOIL SURFACE TO MEET FINISH GRADE, AS SPECIFIED ON THE GRADING PLANS, AT APPROXIMATELY 18" AWAY FROM THE WALKS
- e. ENSURE THAT THE FINISH GRADE IN TURF AREAS IMMEDIATELY ADJACENT TO WALKS AND OTHER WALKING SURFACES, AFTER INSTALLING SOIL AMENDMENTS, IS 1" BELOW THE FINISH SURFACE OF THE WALKS. TAPER THE SOIL SURFACE TO MEET FINISH GRADE, AS SPECIFIED ON THE GRADING PLANS, AT APPROXIMATELY 18" AWAY FROM THE WALKS.
- SHOULD ANY CONFLICTS AND/OR DISCREPANCIES ARISE BETWEEN THE GRADING PLANS, GEOTECHNICAL REPORT, THESE NOTES AND PLANS, AND ACTUAL CONDITIONS, THE CONTRACTOR SHALL IMMEDIATELY BRING SUCH ITEMS TO THE ATTENTION OF THE LANDSCAPE
- ARCHITECT, GENERAL CONTRACTOR, AND OWNER. ONCE SOIL PREPARATION IS COMPLETE, THE LANDSCAPE CONTRACTOR SHALL ENSURE THAT THERE ARE NO DEBRIS, TRASH, OR STONES LARGER THAN 1" REMAINING IN THE TOP 6" OF SOIL.

THE CONTRACTOR SHALL PROVIDE SUBMITTALS AND SAMPLES, IF REQUIRED, TO THE LANDSCAPE ARCHITECT, AND RECEIVE APPROVAL IN WRITING FOR SUCH SUBMITTALS BEFORE WORK COMMENCES. SUBMITTALS SHALL INCLUDE PHOTOS OF PLANTS WITH A RULER OR MEASURING STICK FOR SCALE, PHOTOS OR SAMPLES OF ANY REQUIRED MULCHES, AND SOIL TEST RESULTS AND PREPARATION RECOMMENDATIONS FROM THE TESTING LAB (INCLUDING COMPOST AND FERTILIZER RATES AND

TYPES, AND OTHER AMENDMENTS FOR TREE/SHRUB, TURF, AND SEED AREAS AS MAY BE

- APPROPRIATE). 3. SUBMITTALS SHALL ALSO INCLUDE MANUFACTURER CUT SHEETS FOR PLANTING ACCESSORIES SUCH AS TREE STAKES AND TIES EDGING AND LANDSCAPE FABRICS (IF ANY) WHERE MULTIPLE ITEMS ARE SHOWN ON A PAGE, THE CONTRACTOR SHALL CLEARLY INDICATE THE ITEM BEING CONSIDERED.
- C. GENERAL PLANTING REMOVE ALL NURSERY TAGS AND STAKES FROM PLANTS.
- EXCEPT IN AREAS TO BE PLANTED WITH ORNAMENTAL GRASSES, APPLY PRE-EMERGENT HERBICIDES AT THE MANUFACTURER'S RECOMMENDED RATE. TRENCHING NEAR EXISTING TREES:
- CONTRACTOR SHALL NOT DISTURB ROOTS 1-1/2" AND LARGER IN DIAMETER WITHIN THE CRITICAL ROOT ZONE (CRZ) OF EXISTING TREES, AND SHALL EXERCISE ALL POSSIBLE CARE AND PRECAUTIONS TO AVOID INJURY TO TREE ROOTS, TRUNKS, AND BRANCHES. THE CRZ IS DEFINED AS A CIRCULAR AREA EXTENDING OUTWARD FROM THE TREE TRUNK. WITH A RADIUS EQUAL TO 1' FOR EVERY 1" OF TRUNK DIAMETER-AT-BREAST-HEIGHT (4.5' ABOVE THE AVERAGE
- ALL EXCAVATION WITHIN THE CRZ SHALL BE PERFORMED USING HAND TOOLS. NO MACHINE
- EXCAVATION OR TRENCHING OF ANY KIND SHALL BE ALLOWED WITHIN THE CRZ. ALTER ALIGNMENT OF PIPE TO AVOID TREE ROOTS 1-1/2" AND LARGER IN DIAMETER. WHERE TREE ROOTS 1-1/2" AND LARGER IN DIAMETER ARE ENCOUNTERED IN THE FIELD, TUNNEL UNDER SUCH ROOTS. WRAP EXPOSED ROOTS WITH SEVERAL LAYERS OF BURLAP AND KEEP MOIST.
- CLOSE ALL TRENCHES WITHIN THE CANOPY DRIP LINES WITHIN 24 HOURS. ALL SEVERED ROOTS SHALL BE HAND PRUNED WITH SHARP TOOLS AND ALLOWED TO AIR-DRY. DO NOT USE ANY SORT OF SEALERS OR WOUND PAINTS.
- TREE PLANTING HOLES SHALL BE EXCAVATED TO MINIMUM WIDTH OF TWO TIMES THE WIDTH OF THE ROOTBALL. AND TO A DEPTH EQUAL TO THE DEPTH OF THE ROOTBALL LESS TWO TO FOUR INCHES. SCARIFY THE SIDES AND BOTTOM OF THE PLANTING HOLE PRIOR TO THE PLACEMENT OF THE TREE.
 - REMOVE ANY GLAZING THAT MAY HAVE BEEN CAUSED DURING THE EXCAVATION OF THE HOLE. 3. FOR CONTAINER AND BOX TREES, TO REMOVE ANY POTENTIALLY GIRDLING ROOTS AND OTHER ROOT DEFECTS, THE CONTRACTOR SHALL SHAVE A 1" LAYER OFF OF THE SIDES AND BOTTOM OF THE ROOTBALL OF ALL TREES JUST BEFORE PLACING INTO THE PLANTING PIT. DO NOT "TEASE" ROOTS
 - OUT FROM THE ROOTBALL. 4. INSTALL THE TREE ON UNDISTURBED SUBGRADE SO THAT THE TOP OF THE ROOTBALL IS TWO TO FOUR INCHES ABOVE THE SURROUNDING GRADE 5. BACKFILL THE TREE HOLE UTILIZING THE EXISTING TOPSOIL FROM ON-SITE. ROCKS LARGER THAN 1" DIA. AND ALL OTHER DEBRIS SHALL BE REMOVED FROM THE SOIL PRIOR TO THE BACKFILL. SHOULD

ADDITIONAL SOIL BE REQUIRED TO ACCOMPLISH THIS TASK. USE STORED TOPSOIL FROM ON-SITE OR

- IMPORT ADDITIONAL TOPSOIL FROM OFF-SITE AT NO ADDITIONAL COST TO THE OWNER. IMPORTED TOPSOIL SHALL BE OF SIMILAR TEXTURAL CLASS AND COMPOSITION IN THE ON-SITE SOIL. TREES SHALL NOT BE STAKED UNLESS LOCAL CONDITIONS (SUCH AS HEAVY WINDS OR SLOPES) REQUIRE STAKES TO KEEP TREES UPRIGHT. SHOULD STAKING BE REQUIRED. THE TOTAL NUMBER OF TREE STAKES (BEYOND THE MINIMUMS LISTED BELOW) WILL BE LEFT TO THE LANDSCAPE CONTRACTOR'S DISCRETION. SHOULD ANY TREES FALL OR LEAN, THE LANDSCAPE CONTRACTOR SHALL STRAIGHTEN THE TREE, OR REPLACE IT SHOULD IT BECOME DAMAGED. TREE STAKING SHALL
- ADHERE TO THE FOLLOWING GUIDELINES: TWO STAKES PER TREE 2-1/2"-4" TREES THREE STAKES PER TREE
- TREES OVER 4" CALIPER GUY AS NEEDED THREE STAKES PER TREE MINIMUM, QUANTITY AND POSITIONS AS MULTI-TRUNK TREES NEEDED TO STABILIZE THE TREE
- UPON COMPLETION OF PLANTING, CONSTRUCT AN EARTH WATERING BASIN AROUND THE TREE. COVER THE INTERIOR OF THE TREE RING WITH THE WEED BARRIER CLOTH AND TOPDRESS WITH MULCH (TYPE AND DEPTH PER PLANS).
- SHRUB, PERENNIAL, AND GROUNDCOVER PLANTING DIG THE PLANTING HOLES TWICE AS WIDE AND 2" LESS DEEP THAN EACH PLANT'S ROOTBALL. INSTALL THE PLANT IN THE HOLE. BACKFILL AROUND THE PLANT WITH SOIL AMENDED PER SOIL TEST
- RECOMMENDATIONS. INSTALL THE WEED BARRIER CLOTH, OVERLAPPING IT AT THE ENDS. UTILIZE STEEL STAPLES TO KEEP THE WEED BARRIER CLOTH IN PLACE. WHEN PLANTING IS COMPLETE, INSTALL MULCH (TYPE AND DEPTH PER PLANS) OVER ALL PLANTING BEDS. COVERING THE ENTIRE PLANTING AREA.
- F. SODDING SOD VARIETY TO BE AS SPECIFIED ON THE LANDSCAPE PLAN. LAY SOD WITHIN 24 HOURS FROM THE TIME OF STRIPPING. DO NOT LAY IF THE GROUND IS FROZEN. LAY THE SOD TO FORM A SOLID MASS WITH TIGHTLY FITTED JOINTS. BUTT ENDS AND SIDES OF SOD STRIPS - DO NOT OVERLAP STAGGER STRIPS TO DESET JOINTS IN ADJACENT COLIRSES.
- 4 ROLL THE SOD TO ENSURE GOOD CONTACT OF THE SOD'S ROOT SYSTEM WITH THE SOIL 5. WATER THE SOD THOROUGHLY WITH A FINE SPRAY IMMEDIATELY AFTER PLANTING TO OBTAIN AT
- LEAST SIX INCHES OF PENETRATION INTO THE SOIL BELOW THE SOD. G. HYDROMULCHING 1. TURF HYDROMULCH MIX (PER 1,000 SF) SHALL BE AS FOLLOWS:
 - WINTER MIX (OCTOBER 1 MARCH 31) 50# CELLULOSE FIBER MULCH P# UNHULLED BERMUDA SEED
 - # ANNUAL RYE SEED 15# 15-15-15 WATER SOLUBLE FERTILIZER
 - 50# CELLULOSE FIBER MULCH
- HULLED BERMUDA SEED 15# 15-15-15 WATER SOLUBLE FERTILIZER
- 2. SEED HYDROMULCH MIX (PER 1,000 SF) SHALL BE AS FOLLOWS: 50# CELLULOSE FIBER MULCH
- 15# 15-15-15 WATER SOLUBLE FERTILIZER SEED RATE PER LEGEND
- ALL SEED SHALL BE DRILL SEEDED AT THE RATES SHOWN ON THE PLANS, WITH A HYDROMULCH MIX APPLIED AFTER SEEDING.
- THE HYDROMULCH MIX (PER 1.000 SF) SHALL BE AS FOLLOWS: 50# CELLULOSE FIBER MULCH
- 15# 15-15-15 WATER SOLUBLE FERTILIZER 4# ORGANIC BINDER
- MULCH
- 1. INSTALL MULCH TOPDRESSING, TYPE AND DEPTH PER MULCH NOTE, IN ALL PLANTING AREAS AND TREE RINGS. 2. DO NOT INSTALL MULCH WITHIN 6" OF TREE ROOT FLARE AND WITHIN 24" OF HABITABLE STRUCTURES, EXCEPT AS MAY BE NOTED ON THESE PLANS. MULCH COVER WITHIN 6" OF CONCRETE WALKS AND CURBS SHALL NOT PROTRUDE ABOVE THE FINISH SURFACE OF THE WALKS AND CURBS. MULCH
- COVER WITHIN 12" OF WALLS SHALL BE AT LEAST 3" LOWER THAN THE TOP OF WALL. 1. DURING LANDSCAPE PREPARATION AND PLANTING, KEEP ALL PAVEMENT CLEAN AND ALL WORK AREAS
- IN A NEAT, ORDERLY CONDITION. DISPOSED LEGALLY OF ALL EXCAVATED MATERIALS OFF THE PROJECT SITE. K. INSPECTION AND ACCEPTANCE
- 1. UPON COMPLETION OF THE WORK, THE LANDSCAPE CONTRACTOR SHALL PROVIDE THE SITE CLEAN, FREE OF DEBRIS AND TRASH, AND SUITABLE FOR USE AS INTENDED. THE LANDSCAPE CONTRACTOR SHALL THEN REQUEST AN INSPECTION BY THE OWNER TO DETERMINE FINAL ACCEPTABILITY. 2. WHEN THE INSPECTED PLANTING WORK DOES NOT COMPLY WITH THE CONTRACT DOCUMENTS, THE LANDSCAPE CONTRACTOR SHALL REPLACE AND/OR REPAIR THE REJECTED WORK TO THE OWNER'S SATISFACTION WITHIN 24 HOURS.
- THE LANDSCAPE MAINTENANCE PERIOD WILL NOT COMMENCE UNTIL THE LANDSCAPE WORK HAS BEEN RE-INSPECTED BY THE OWNER AND FOUND TO BE ACCEPTABLE. AT THAT TIME, A WRITTEN NOTICE OF FINAL ACCEPTANCE WILL BE ISSUED BY THE OWNER, AND THE MAINTENANCE AND GUARANTEE PERIODS WILL COMMENCE.
- LANDSCAPE MAINTENANCE THE LANDSCAPE CONTRACTOR SHALL BE RESPONSIBLE FOR THE MAINTENANCE OF ALL WORK SHOWN ON THESE PLANS FOR 90 DAYS BEYOND FINAL ACCEPTANCE OF ALL LANDSCAPE WORK BY THE OWNER. LANDSCAPE MAINTENANCE SHALL INCLUDE WEEKLY SITE VISITS FOR THE FOLLOWING ACTIONS (AS APPROPRIATE): PROPER PRUNING, RESTAKING OF TREES, RESETTING OF PLANTS THAT HAVE SETTLED, MOWING AND AERATION OF LAWNS, WEEDING, RESEEDING AREAS WHICH HAVE NOT GERMINATED WELL, TREATING FOR INSECTS AND DISEASES, REPLACEMENT OF MULCH, REMOVAL OF LITTER, REPAIRS TO THE IRRIGATION SYSTEM DUE TO FAULTY PARTS AND/OR WORKMANSHIP, AND THE APPROPRIATE WATERING OF ALL PLANTINGS. THE LANDSCAPE CONTRACTOR SHALL MAINTAIN THE IRRIGATION SYSTEM IN PROPER WORKING ORDER, WITH SCHEDULING ADJUSTMENTS BY SEASON
- TO MAXIMIZE WATER CONSERVATION. SHOULD SEEDED AND/OR SODDED AREAS NOT BE COVERED BY AN AUTOMATIC IRRIGATION SYSTEM. THE LANDSCAPE CONTRACTOR SHALL BE RESPONSIBLE FOR WATERING THESE AREAS AND OBTAINING A FULL HEALTHY STAND OF PLANTS AT NO ADDITIONAL COST TO THE OWNER TO ACHIEVE FINAL ACCEPTANCE AT THE END OF THE MAINTENANCE PERIOD, ALL OF THE FOLLOWING
- CONDITIONS MUST OCCUR-THE LANDSCAPE SHALL SHOW ACTIVE, HEALTHY GROWTH (WITH EXCEPTIONS MADE FOR SEASONAL DORMANCY). ALL PLANTS NOT MEETING THIS CONDITION SHALL BE REJECTED AND REPLACED BY HEALTHY PLANT MATERIAL PRIOR TO FINAL ACCEPTANCE ALL HARDSCAPE SHALL BE CLEANED PRIOR TO FINAL ACCEPTANCE. SODDED AREAS MUST BE ACTIVELY GROWING AND MUST REACH A MINIMUM HEIGHT OF 1 1/2
- INCHES BEFORE FIRST MOWING. HYDROMULCHED AREAS SHALL SHOW ACTIVE, HEALTHY GROWTH. BARE AREAS LARGER THAN TWELVE SQUARE INCHES MUST BE RESODDED OR RESEEDED (AS APPROPRIATE) PRIOR TO FINAL ACCEPTANCE. ALL SODDED TURF SHALL BE NEATLY MOWED. M. WARRANTY PERIOD, PLANT GUARANTEE AND REPLACEMENTS THE LANDSCAPE CONTRACTOR SHALL GUARANTEE ALL TREES, SHRUBS, PERENNIALS, SOD,
- 2. AFTER THE INITIAL MAINTENANCE PERIOD AND DURING THE GUARANTEE PERIOD, THE LANDSCAPE CONTRACTOR SHALL ONLY BE RESPONSIBLE FOR REPLACEMENT OF PLANTS WHEN PLANT DEATH CANNOT BE ATTRIBUTED DIRECTLY TO OVERWATERING OR OTHER DAMAGE BY HUMAN ACTIONS. PROVIDE A MINIMUM OF (2) COPIES OF RECORD DRAWINGS TO THE OWNER UPON COMPLETION OF WORK. A RECORD DRAWING IS A RECORD OF ALL CHANGES THAT OCCURRED IN THE FIELD AND THAT ARE


DOCUMENTED THROUGH CHANGE ORDERS, ADDENDA, OR CONTRACTOR/CONSULTANT DRAWING MARKUPS.

SEEDED/HYDROMULCHED AREAS, AND IRRIGATION SYSTEMS FOR A PERIOD OF ONE YEAR FROM THE

REPLACE, AT HIS OWN EXPENSE AND TO THE SATISFACTION OF THE OWNER, ANY PLANTS WHICH DIE

IN THAT TIME, OR REPAIR ANY PORTIONS OF THE IRRIGATION SYSTEM WHICH OPERATE IMPROPERLY.

DATE OF THE OWNER'S FINAL ACCEPTANCE (90 DAYS FOR ANNUAL PLANTS). THE CONTRACTOR SHALL

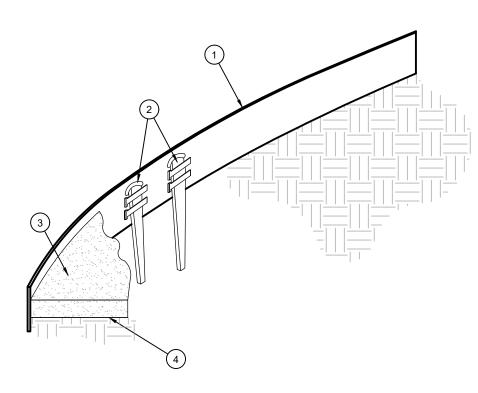

- (1) ROLLED-TOP STEEL EDGING PER PLANS.
- (2) TAPERED STEEL STAKES. (3) MULCH, TYPE AND DEPTH PER PLANS.

(4) FINISH GRADE.

1) INSTALL EDGING SO THAT STAKES WILL BE ON INSIDE OF PLANTING BED. BOTTOM OF EDGING SHALL BE BURIED A MINIMUM OF 1" BELOW FINISH GRADE

DISTANCE PER PLAN

(2) MULCH LAYER


(4) TURF (WHERE SHOWN ON PLAN).

(3) PLANT.

3) TOP OF MULCH SHALL BE 1" LOWER THAN TOP OF EDGING.

24" MIN. TO EDGE

OF MATURE CANOPY

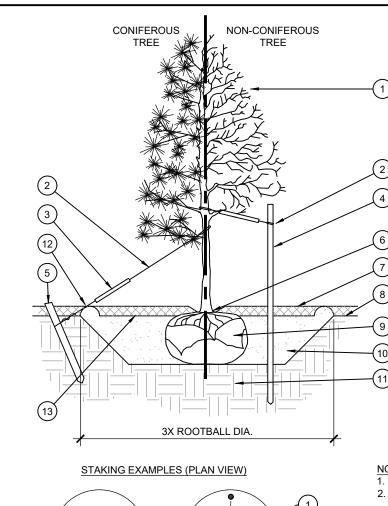

- PREVAILING PREVAILING WINDS
- SCALE: NOT TO SCALE

- (1) TREE CANOPY. CINCH-TIES (24" BOX/2" CAL. TREES AND SMALLER) OR 12 GAUGE GAI VANIZED WIRE WITH NYI ON TREE STRAPS AT TREE AND STAKE (36" BOX/2.5" CAL. TREES AND LARGER). SECURE TIES OR STRAPS TO TRUNK JUST ABOVE LOWEST MAJOR BRANCHES (3) 24" X 3/4" P.V.C. MARKERS OVER WIRES. (4) GREEN STEEL T-POSTS. EXTEND POSTS 12" MIN. INTO UNDISTURBED SOIL. PRESSURE-TREATED WOOD DEADMAN, TWO PER

ational Presence. Local Expertise

EVERGREEN DESIGN GROUP

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MARY N. BATES


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ISSUED ON:

OCTOBER 04, 2024


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- TREE (MIN.). BURY OUTSIDE OF PLANTING PIT AND 18" MIN. INTO UNDISTURBED SOIL.
- (6) TRUNK FLARE
- 7) MULCH, TYPE AND DEPTH PER PLANS. DO NOT
- PLACE MULCH WITHIN 6" OF TRUNK.
- (8) FINISH GRADE 9) ROOT BALL.
- 10) BACKFILL. AMEND AND FERTILIZE ONLY AS RECOMMENDED IN SOIL FERTILITY ANALYSIS.
- (11) UNDISTURBED NATIVE SOIL.
- (12) 4" HIGH EARTHEN WATERING BASIN.
- (13) FINISH GRADE.
- SCARIFY SIDES OF PLANTING PIT PRIOR TO SETTING TREE. REMOVE EXCESS SOIL APPLIED ON TOP OF THE ROOTBALL THAT COVERS THE ROOT FLARE. THE PLANTING HOLE DEPTH SHALL BE SUCH THAT THE ROOTBALL RESTS ON UNDISTURBED SOIL, AND THE
- ROOT FLARE IS 2"-4" ABOVE FINISH GRADE. FOR B&B TREES, CUT OFF BOTTOM 1/3 OF WIRE BASKET BEFORE PLACING TREE IN HOLE, CUT OFF AND REMOVE REMAINDER OF BASKET AFTER TREE IS SET IN HOLE, REMOVE ALL NYLON TIES, TWINE, ROPE, AND OTHER PACKING MATERIAL. REMOVE AS MUCH
- BURLAP FROM AROUND ROOTBALL AS IS PRACTICAL. REMOVE ALL NURSERY STAKES AFTER PLANTING. 5. FOR TREES 36" BOX/2.5" CAL. AND LARGER, USE THREE STAKES OR DEADMEN (AS APPROPRIATE), SPACED EVENLY AROUND TREE.
- 6 STAKING SHALL BE TIGHT ENOUGH TO PREVENT TRUNK FROM BENDING, BUT LOOSE ENOUGH TO ALLOW SOME TRUNK MOVEMENT




- (1) SHRUB, PERENNIAL, OR ORNAMENTAL GRASS.
- 2) MULCH, TYPE AND DEPTH PER PLANS. PLACE NO MORE THAN 1" OF MULCH WITHIN 6" OF PLANT CENTER.
- (3) FINISH GRADE
- (4) ROOT BALL.
- (5) BACKFILL, AMEND AND FERTILIZE ONLY AS
- (6) UNDISTURBED NATIVE SOIL.
- (7) 3" HIGH EARTHEN WATERING BASIN.
- (8) WEED FABRIC UNDER MULCH.

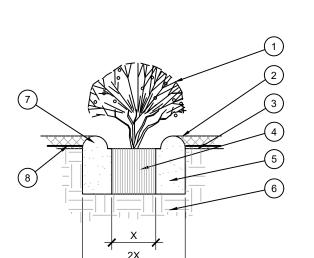PLANTING AT PARKING AREA



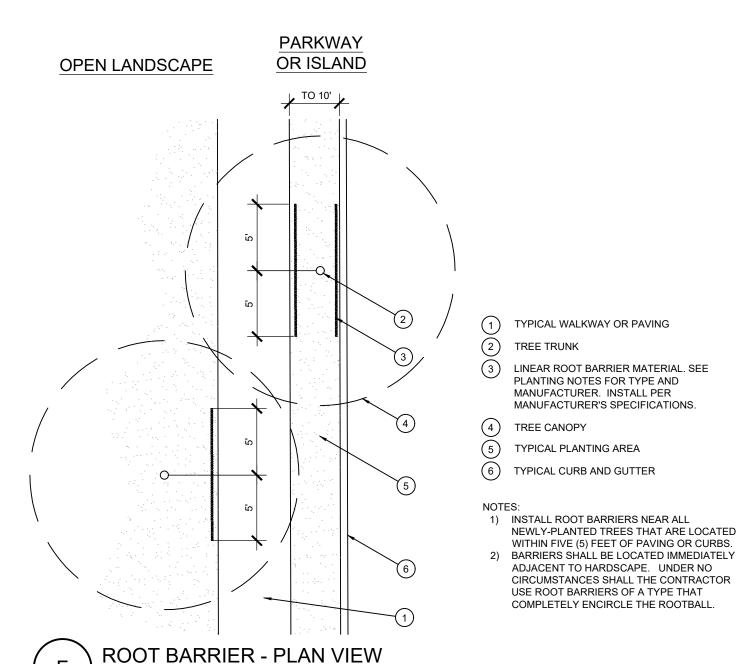

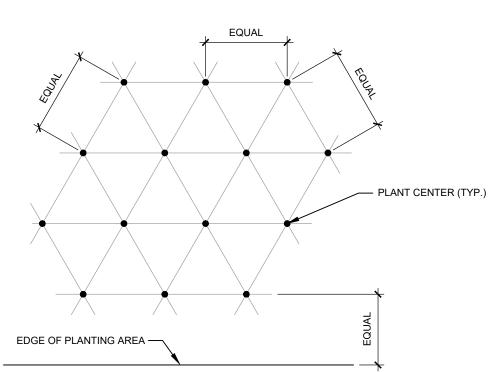

NOTE: ALL PLANTS SHALL BE PLANTED AT EQUAL TRIANGULAR SPACING (EXCEPT WHERE SHOWN ON PLANS AS INFORMAL GROUPINGS). REFER TO PLANT LEGEND FOR SPACING DISTANCE BETWEEN PLANTS.

1) STEP 1: DETERMINE TOTAL PLANTS FOR THE AREA WITH THE FOLLOWING FORMULA: TOTAL AREA / AREA DIVIDER = TOTAL PLANTS PLANT SPACING AREA DIVIDER

2) STEP 2: SUBTRACT THE ROW (S) OF PLANTS THAT WOULD OCCUR AT THE EDGE OF THE PLANTED AREA WITH THE FOLLOWING FORMULA: TOTAL PERIMETER LENGTH / PLANT SPACING = TOTAL PLANT SUBTRACTION

EXAMPLE: PLANTS AT 18" O.C. IN 100 SF PLANTING AREA, 40 LF PERIMETER STEP 1: 100 SF/1.95 = 51 PLANTS STEP 2: 51 PLANTS - (40 LF / 1.95 = 21 PLANTS) = 30 PLANTS TOTAL


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HARDSCAPE PLAN

Date Comment

roject Number 10/04/24 Drawn By Checked By

PROJECT COMMENTS

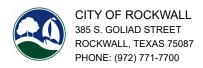

DATE: 4/24/2025

PROJECT NUMBER: SP2025-015

PROJECT NAME: Site Plan for Quail Hollow

SITE ADDRESS/LOCATIONS:

CASE CAPTION: Discuss and consider a request by Chase Finch of Corwin Engineering, Inc. on behalf of John Arnold of Quail Hollow SF, LTD for the

approval of a Site Plan for Phase 2 of the Quail Hollow Subdivision consisting of 111 lots on 42.742-acres being identified as Lot 20,

Block G of Quail Hollow, Phase 1 Addition, City of Rockwall, Rockwall County, Texas, zoned Planned Development District 97 (PD-97) for Single-Family 10 (SF-10) District land uses, generally located at the northwest corner of the intersection of E. Quail Run

Road and Hays Road, and take any action necessary.

DEPARTMENT	REVIEWER	DATE OF REVIEW	STATUS OF PROJECT	
PLANNING	Bethany Ross	04/24/2025	Needs Review	

04/24/2025: SP2025-015; PD Site Plan for Quail Hollow Phase II

Please address the following comments (M= Mandatory Comments; I = Informational Comments)

- I.1 This is a request for the approval of a Site Plan for Phase 2 of the Quail Hollow Subdivision consisting of 111 lots on 42.742-acres being identified as Lot 20, Block G of Quail Hollow, Phase 1 Addition, City of Rockwall, Rockwall County, Texas, zoned Planned Development District 97 (PD-97) for Single-Family 10 (SF-10) District land uses, and generally located at the northwest corner of the intersection of E. Quail Run Road and Hays Road.
- 1.2 For questions or comments concerning this case please contact Bethany Ross in the Planning Department at (972) 772-6488 or email bross@rockwall.com.
- M.3 For reference, include the case number (SP2025-015) in the lower right-hand corner of all pages of all revised plan submittals. (Subsection 01.02(D), Article 11, UDC).
- 1.4 This project is subject to all requirements stipulated by the Unified Development Code (UDC) and Planned Development District 97 (PD-97).
- M.5 Provide the standard signature block with signature space for the Planning and Zoning Chairman and the Planning Director on all pages of the plans. Also remove the red placeholder text from the signature block. (Subsection 03.04. A, of Article 11)

APPROVED:

I hereby certify that the above and foregoing site plan for a develope	ment in the City of Rockwall, Texas, was approved by the Planning & Zoning Commission of the City of Rockwal
on the day of,	
WITNESS OUR HANDS, this day of,	
Planning & Zoning Commission, Chairman	Director of Planning and Zoning

M.6 Site Plan:

(1) Provide an overall fence exhibit that shows the entirety of Phase II on one (1) sheet.

(2) Update the site plan to match the Final Plat revisions.

M.7 Landscape Plan:

- (1) Crape Myrtle is not a permitted accent tree. Please propose a different accent tree.
- (2) Please change the colors of the basketball court to match RISD yellowjacket colors.
- (3) The detention area is required to have 1 canopy tree per 1500 SF of detention and 1 accent tree per 750 SF of detention. The proposed 150,000 SF of detention would require 100 canopy trees and 200 accent trees. (Subsection 05.03(D), Article 08, Unified Development Code)
- (4) Remove the street name BethPage from all plans, this is Old E. Quail Run Road. Old E Quail Run Road is required a 5' sidewalk and ten (10) foot landscape buffer along the entire adjacency. Extend the sidewalk. (Exhibit D, Density and Dimensional Standards, (7) Landscape and Hardscape Standards, (b) Landscape Buffers, (2) Landscape Buffer and Sidewalks (Hays Road and E. Quail Run Road and Old Quail Run Road, PD-97; Ordinance No. 22-44)
- (5) The landscape buffer is required along the entire adjacency of Quail Run Road. Provide the landscape buffer adjacent to the detention pond and along the adjacency between the two secondary monuments. (Exhibit D, Density and Dimensional Standards, (7) Landscape and Hardscape Standards, (b) Landscape Buffers, (2) Landscape Buffer and Sidewalks (Hays Road and E. Quail Run Road and Old Quail Run Road, PD-97; Ordinance No. 22-44)

M.8 Hardscape Plan:

- (1) Provide exhibits of secondary entry monumentation. (PD, 97; Ordinance No. 22-44)
- I.9 Please note that failure to address all comments provided by staff by 3:00 PM on May 6, 2025 will result in the automatic denial of the case on the grounds of an incomplete submittal. No refund will be given for cases that are denied due to an incomplete submittal, and a new application and fee will be required to resubmit the case.
- I.10 Staff has identified the aforementioned items necessary to continue the submittal process. Please make these revisions and corrections, and provide any additional information that is requested. Revisions for this case will be due on May 6, 2025; however, it is encouraged for applicants to submit revisions as soon as possible to give staff ample time to review the case prior to the May 13, 2025 Planning & Zoning Meeting.
- I.11 Please note the scheduled meetings for this case:
- 1) Planning & Zoning Work Session meeting will be held on April 29, 2025.
- 2) Parks Board meeting will be held on May 6, 2025.
- 3) Planning & Zoning meeting/public hearing meeting will be held on May 13, 2025.
- I.12 All meetings will be held in person and in the City's Council Chambers. All meetings listed above are scheduled to begin at 6:00 p.m. (P&Z). The City prefers that a representative(s) be present for these meetings. During the upcoming work session meeting with the Planning and Zoning Commission, representative(s) are expected to present their case and answer any questions the Planning Commission may have regarding this request.

bold text

DEPARTMENT	REVIEWER	DATE OF REVIEW	STATUS OF PROJECT
ENGINEERING	Madelyn Price	04/22/2025	Approved w/ Comments

04/22/2025: 1. Show and label NTMWD easement along Hays Lane for all sheets.

- 2. Min 20' for all easements.
- 3. This line isn't on the final plat
- 4. "and Detention"
- 5. "E. Quail Run Road"
- 6. "Old E. Quail Run"
- 7. All sheets: Label ROW line for Hays and E. Quail Run and "Old E. Quail Run"
- 8. Need to show the NTMWD easement and 36" water line along Hays
- 9. Need street names labeled for all sheets.
- 10. Street hasn't been named. Name it "Old E. Quail Run" for now

- 11. Show and label detention & drainage easement. Playground area can't be in detention easement
- 12. Remove. No parking allowed to back out onto a public street
- 13. This water line is to be abandoned
- 14. FYI Detention area to be irrigated

General Comments:

General Items:

- Must meet City 2023 Standards of Design and Construction
- 4% Engineering Inspection Fees
- Impact Fees (Water, Sewer, Roadway).
- Minimum easement width is 20' for new easements.
- No structures, including walls, allowed in easements.
- Retaining walls 3' and over must be engineered.
- All retaining walls (18" or taller) must be rock or stone face. No smooth concrete walls.
- Required 10' utility easement along all street frontages.
- All utilities must be underground. Existing overhead utility lines, if present, will need to be placed underground.
- The property must be platted.
- Tree mitigation will be required when removing existing trees on the property.
- Utility easements may not cross through residential properties. Must be in a HOA maintained lot.
- Additional comments may be provided at time of Engineering.

Streets/Paving:

- All Residential Streets to be concrete, 50' ROW, 29' back-to-back paving minimum with 5' sidewalk on each side. Streets must be curb and gutter style. No asphalt or rock streets.
- No dead-end streets allowed. Must have a cul-de-sac or turnaround per City Standards.
- City driveway spacing requirements must be met.
- Any medians must be curbed, and streets draining away from medians.
- All streets must be curb and gutter. Bar ditches are not allowed.
- All non-divided streets/intersections that have medians for entry features/landscaping/signage must be in a separate lot and block owned by HOA.
- Must construct all roadways on the current Master Thoroughfare Plan
- A TIA will be required. Please refer to the 2023 Standards of Design and Construction Manual (Subsection 2.21.06) for the TIA Preparation and Review Requirements. review fees apply.

Water and Wastewater Items:

- Must loop min 8" water line on site.
- Only one "use" off a dead-end line (domestic, irrigation, fire sprinkler, fire hydrant, etc.)
- Must have 8" sewer line minimum through the property.
- An Infrastructural Study will be required. Review fees apply.
- Infrastructure called out to be required by study must be installed.
- Must follow and construct per the City's master water and sanitary sewer plans, or requirements per infrastructure study, whichever is most stringent.
- Utilities may not cross through a property. Must be within own HOA lot within an easement. Minimum 20'.
- Provide water main stubs and wastewater stubs to all adjacent properties for future/existing development connection points.

Drainage/Floodplain/Lakes:

- Existing flow patterns must be maintained.
- Detention is required. Drainage areas larger than 20 acres will need a detention study using unit hydrograph method. Review fees apply.
- Drainage calculations are based on property zoning, not land area use.
- Detention pond max side slope of 4:1 with a minimum bottom slope of 1%.
- Detention easement required at freeboard elevation.

- Detention pond is required to have an emergency spillway, located at the freeboard elevation.
- Detention ponds must be irrigated.
- Detention ponds must be in a drainage easement maintained by the property owner. The drainage easement shall be located at the freeboard elevation.
- No vertical walls are allowed in detention easement.
- No water or sewer lines can be in detention easement.
- The property owner will be responsible for maintaining, repair, and replacement of the drainage systems.
- The 100-year WSEL must be called out for detention ponds.
- Grate inlets are not allowed.
- Drainage easement/erosion hazard setback easement shall be in its own separate lot owned by the HOA.
- Drainage system may not cross through a property. Must be within own HOA lot within an easement. Minimum 20'.
- Lot to Lot drainage is not allowed.

Landscaping:

- No trees to be with 10' of any public water, sewer or storm line that is 10" in diameter or larger.
- No trees to be with 5' of any public water, sewer, or storm line that is less than 10".
- No berms allowed in water or sewer easements.

DEPARTMENT	REVIEWER	DATE OF REVIEW	STATUS OF PROJECT	
BUILDING	Craig Foshee	04/23/2025	Approved	
No Comments				
DEPARTMENT	REVIEWER	DATE OF REVIEW	STATUS OF PROJECT	
FIRE	Ariana Kistner	04/24/2025	Approved	
No Comments				
DEPARTMENT	REVIEWER	DATE OF REVIEW	STATUS OF PROJECT	
GIS	Lance Singleton	04/23/2025	Approved	
No Comments				
DEPARTMENT	REVIEWER	DATE OF REVIEW	STATUS OF PROJECT	
POLICE	Chris Cleveland	04/21/2025	Approved	
No Comments				
DEPARTMENT	REVIEWER	DATE OF REVIEW	STATUS OF PROJECT	
PARKS	Travis Sales	04/22/2025	Approved w/ Comments	

04/22/2025: 1. Please calculate and show required detention pond landscape

One canopy tree for every 750 sqft of detention

One accent tree for every 1500 sqft of detention

2. There are better varieties of turfgrass available that are more drought, shade, wear and cold tolerant than 419 such as Tif Tuf and Tahoma 31




DEVELOPMENT APPLICATION

City of Rockwall Planning and Zoning Department 385 S. Goliad Street Rockwall, Texas 75087

PLANNING & ZONING CASE NO.
NOTE: THE APPLICATION IS NOT CONSIDERED ACCEPTED BY THE CITY UNTIL THE PLANNING DIRECTOR AND CITY ENGINEER HAVE SIGNED BELOW.
DIRECTOR OF PLANNING:
CITY ENGINEED.

	, , , , , , , , , , , , , , , , , , , ,	Lint	ENGINEER:			
PLEASE CHECK THE	APPROPRIATE BOX BELOW TO INDICATE THE TYPE (OF DEVELOPMENT RE	QUEST [SELECT ONLY ONE BOX]:			
☐ PRELIMINARY ☐ FINAL PLAT (\$3 ☐ REPLAT (\$300.) ☐ AMENDING OR ☐ PLAT REINSTA SITE PLAN APPLI ☒ SITE PLAN (\$25	(\$100.00 + \$15.00 ACRE) 1 PLAT (\$200.00 + \$15.00 ACRE) 1 300.00 + \$20.00 ACRE) 1 00 + \$20.00 ACRE) 1 MINOR PLAT (\$150.00) TEMENT REQUEST (\$100.00)	☐ ZONING CH/ ☐ SPECIFIC US ☐ PD DEVELO OTHER APPLIC ☐ TREE REMC ☐ VARIANCE F NOTES: 1: IN DETERMINING 1 PER ACRE AMOUNT. 2: A \$1,000.00 FEE	ZONING APPLICATION FEES: ☐ ZONING CHANGE (\$200.00 + \$15.00 ACRE) ☐ SPECIFIC USE PERMIT (\$200.00 + \$15.00 ACRE) ☐ PD DEVELOPMENT PLANS (\$200.00 + \$15.00 ACRE) ☐ OTHER APPLICATION FEES: ☐ TREE REMOVAL (\$75.00) ☐ VARIANCE REQUEST/SPECIAL EXCEPTIONS (\$100.00) ☐ VARIANCE REQUEST/SPECIAL EXCEPTIONS (\$100.00) ☐ NOTES: 1: IN DETERMINING THE FEE, PLEASE USE THE EXACT ACREAGE WHEN MULTIPLYING BY THE PER ACRE AMOUNT. FOR REQUESTS ON LESS THAN ONE ACRE, ROUND UP TO ONE (1) ACRE. 2: A \$1,000.00 FEE WILL BE ADDED TO THE APPLICATION FEE FOR ANY REQUEST THAT INVOLVES CONSTRUCTION WITHOUT OR NOT IN COMPLIANCE TO AN APPROVED BUILDING			
PROPERTY INFO	ORMATION [PLEASE PRINT]					
ADDRES						
SUBDIVISIO	N Quail Hollow Phase 2		LOT	BLOCK		
GENERAL LOCATIO	Northeast Corner of Hays Lane	and Quail Rur	Road			
ZONING SITE P	LAN AND PLATTING INFORMATION [PLEA	SE PRINTI				
CURRENT ZONIN		CURRENT USE				
PROPOSED ZONIN	G (PROPOSED USE				
ACREAG	E 42.742 LOTS [CURREN	тј	LOTS [PROPOSED]	111		
REGARD TO ITS RESULT IN THE	D PLATS: BY CHECKING THIS BOX YOU ACKNOWLEDGE APPROVAL PROCESS, AND FAILURE TO ADDRESS ANY OF DENIAL OF YOUR CASE.	F STAFF'S COMMENTS B	Y THE DATE PROVIDED ON THE DEV	ELOPMENT CALENDAR WILL		
	CANT/AGENT INFORMATION (PLEASE PRINT/C			REQUIRED]		
	Quail Hollow SF, LTD.		Corwin Engineering			
CONTACT PERSON	John Arnold	CONTACT PERSON ADDRESS	Chase Finch			
AUURE55	8214 Westchester Drive Ste. 900	ADDRESS	200 W. Belmont St	e. E		
CITY, STATE & ZIP	Dallas, TX 75202	CITY, STATE & ZIP	Allen, Tx 75013			
PHONE	214-522-4945	PHONE	972-396-1200			
E-MAIL	jarnold@skorburgcompany.com	E-MAIL	cfinch@corwinengin	eering.com		
BEFORE ME, THE UNDE	ICATION [REQUIRED] ERSIGNED AUTHORITY, ON THIS DAY PERSONALLY APPEAR TION ON THIS APPLICATION TO BE TRUE AND CERTIFIED TH		ld [OWNER]	THE UNDERSIGNED, WHO		
S 1,110.00 WOOLL INFORMATION CONTAIN SUBMITTED IN CONJUNC	T I AM THE OWNER FOR THE PURPOSE OF THIS APPLICATION; TO COVER THE COST OF THIS APPLICATION, I TO COVER THE COST OF THIS APPLICATION, I TO COVER THE COST OF THIS APPLICATION, I BY SIGNING THIS APPLICATION, I AS THE WITHIN THIS APPLICATION TO THE PUBLIC. THE CITY TO AND SEAL OF OFFICE ON THIS THE 17 OWNER'S SIGNATURE TO FOR THE STATE OF TEXAS	HAS BEEN PAID TO THE CI' REE THAT THE CITY OF R IS ALSO AUTHORIZED AI SOCIATED OR IN RESPONS	TY OF ROCKWALL ON THIS THE // OCKWALL (I.E. "CITY") IS AUTHORIZED NO PERMITTED TO REPRODUCE ANY SE TO A REQUEST FOR PUBLIC THY OWN Brooke My Co	DAY OF AND PERMITTED TO PROVIDE COPYRIGHTED INFORMATION ATION. Ashtey-Ven Veerhis ommission Expires 2/1/2028 ry ID 134742171		
NOTARY PUBLIC IN AN	D FOR THE STATE OF TEXAS		MY COMMISSION EXPIRES	2/1/2028		

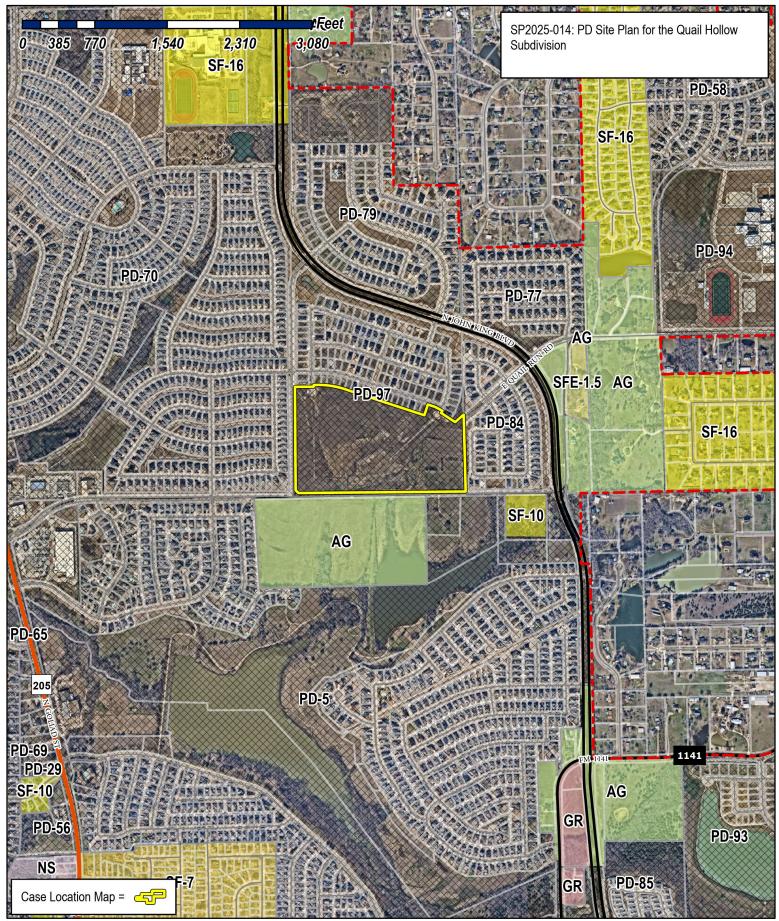





City of Rockwall Planning & Zoning Department 385 S. Goliad Street

Planning & Zoning Department 385 S. Goliad Street Rockwall, Texas 75087 (P): (972) 771-7745 (W): www.rockwall.com The City of Rockwall GIS maps are continually under development and therefore subject to change without notice. While we endeavor to provide timely and accurate information, we make no guarantees. The City of Rockwall makes no warranty, express or implied, including warranties of merchantability and fitness for a particular purpose. Use of the information is the sole responsibility of the user.



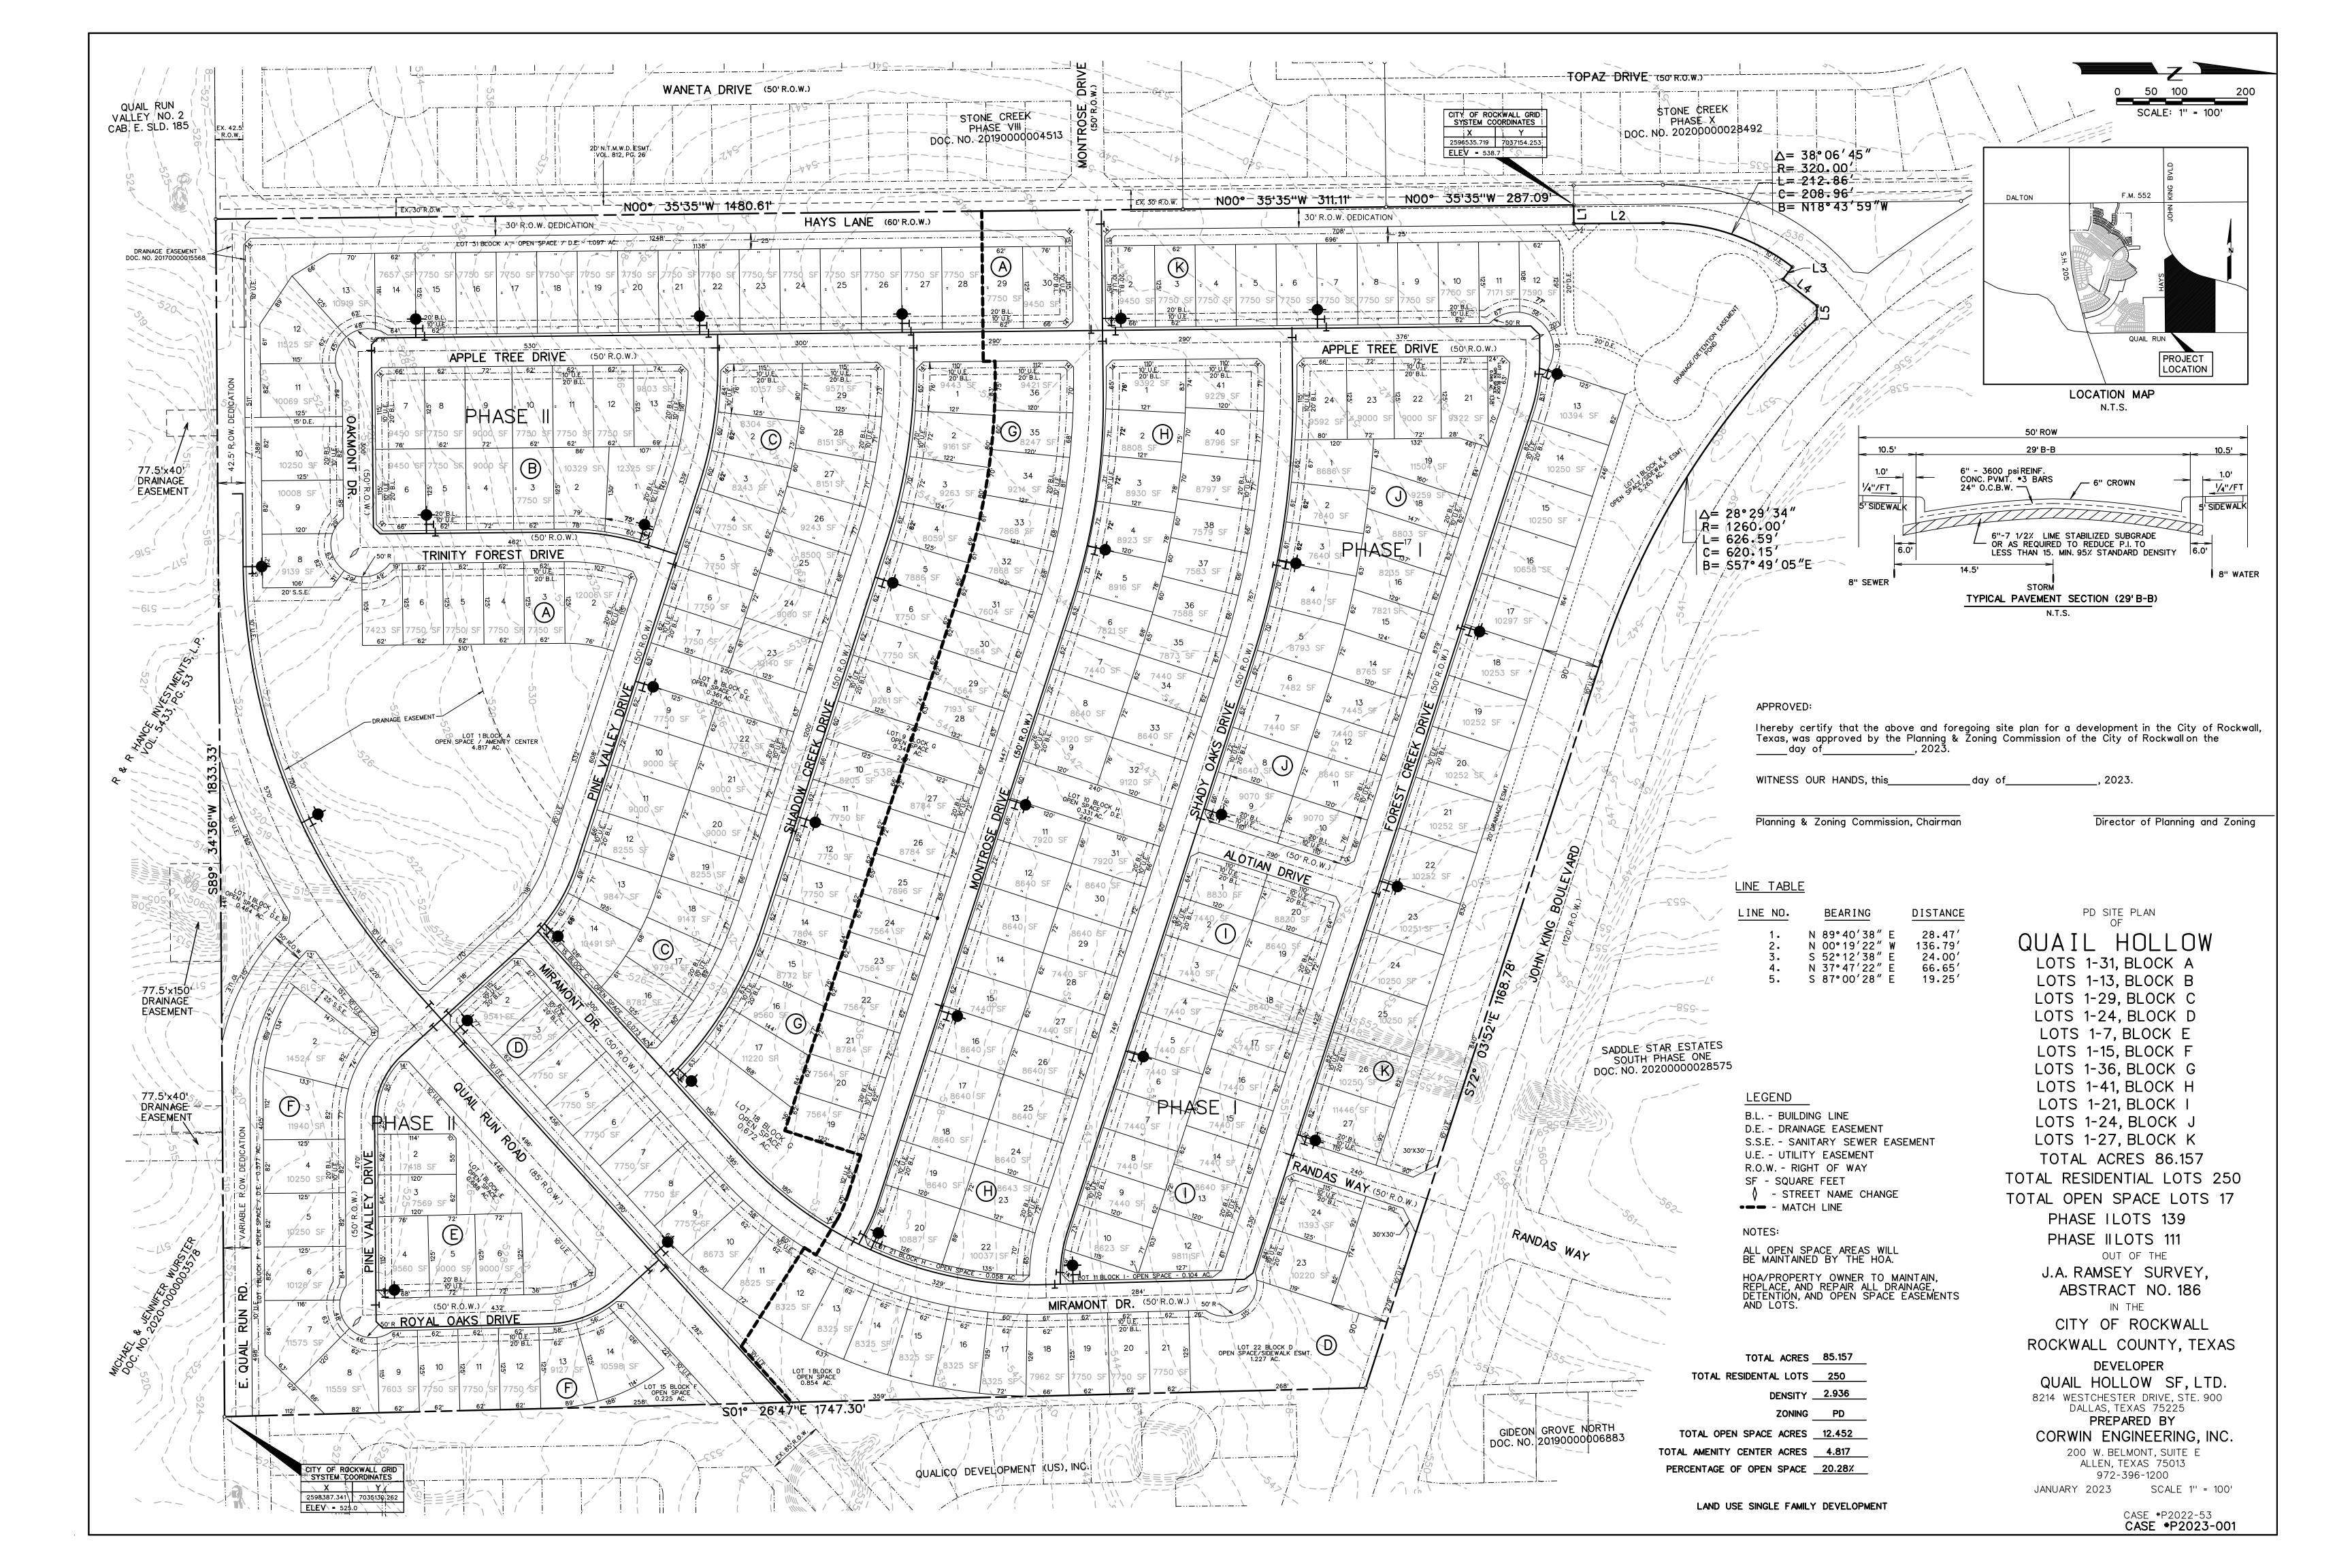

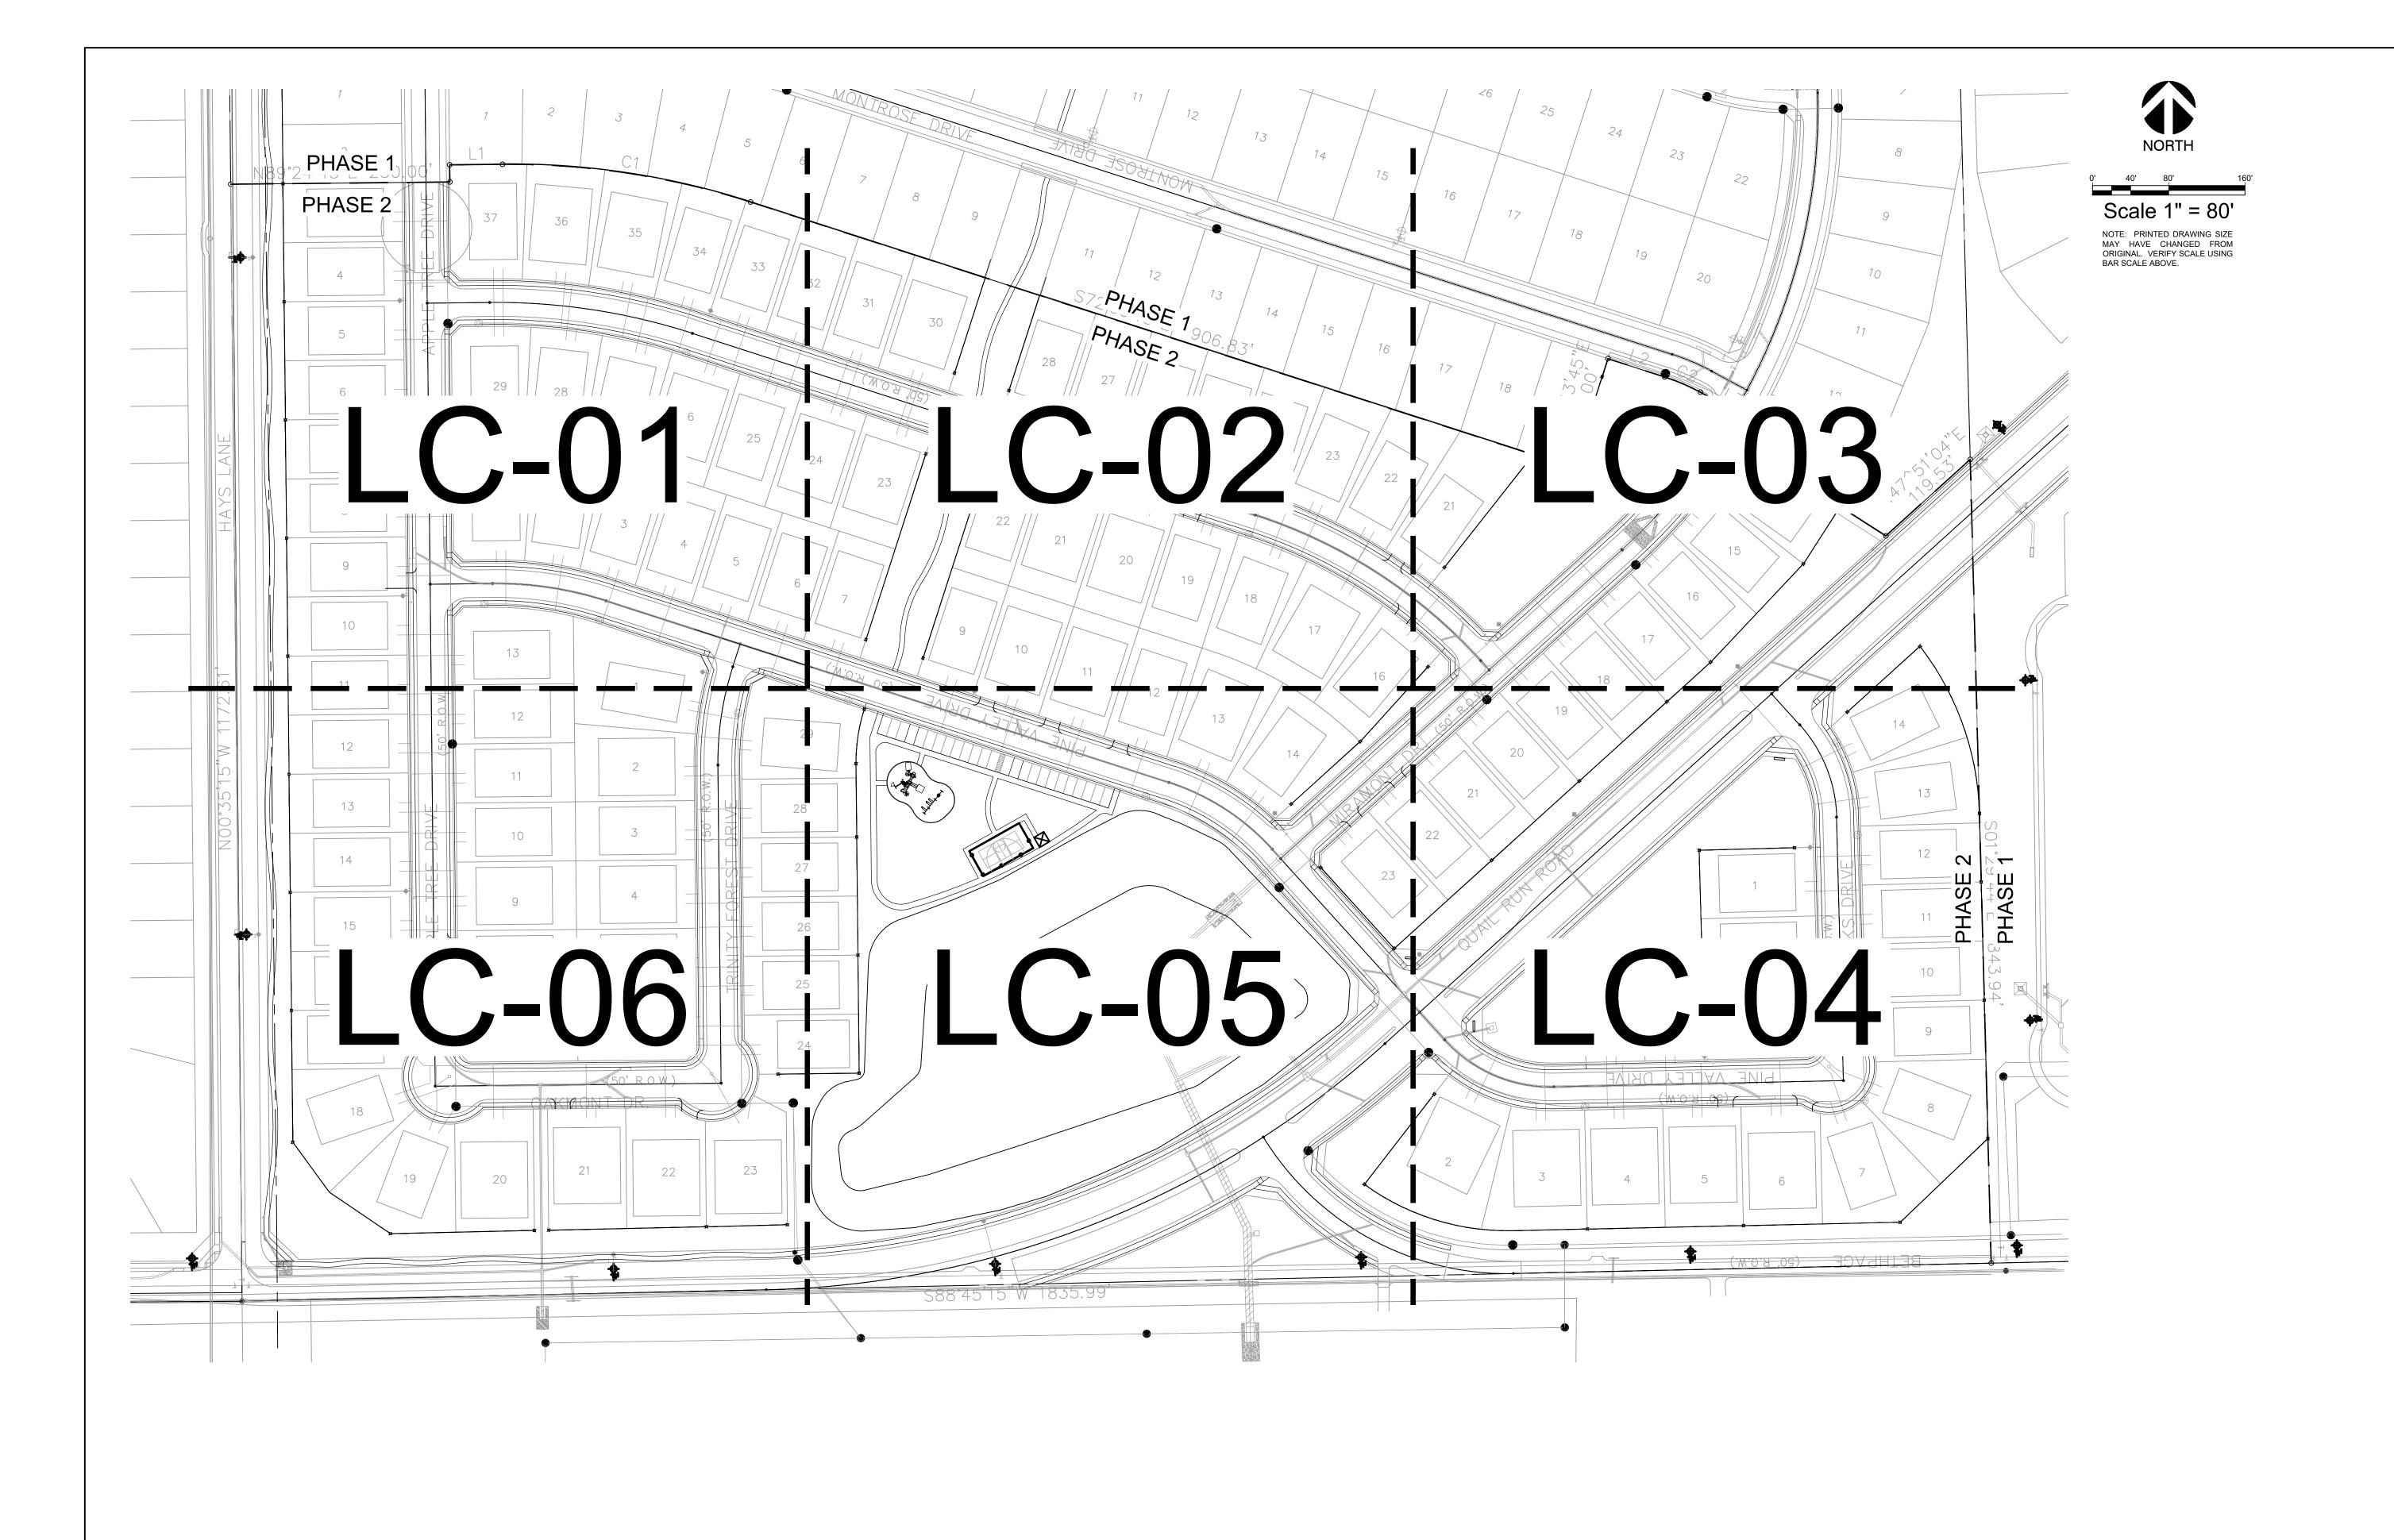



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MARY N. BATES TEXAS L.A. #3613 ISSUED ON: OCTOBER 04, 2024

Company
er Drive, Suite 900

Skorburg (8214 Westchester Dallas, Texas 75225

Quail Hollow Rockwall, TX

OVERALL HARDSCAPE PLAN


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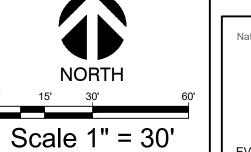
Project Number

 Date
 10/04/24

 Drawn By
 KB

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NOTE: PRINTED DRAWING SIZE MAY HAVE CHANGED FROM ORIGINAL. VERIFY SCALE USING BAR SCALE ABOVE.

CONSTRUCTION LEGEND (MASTER LIST - NOT ALL ITEMS ARE ON EVERY SHEET)

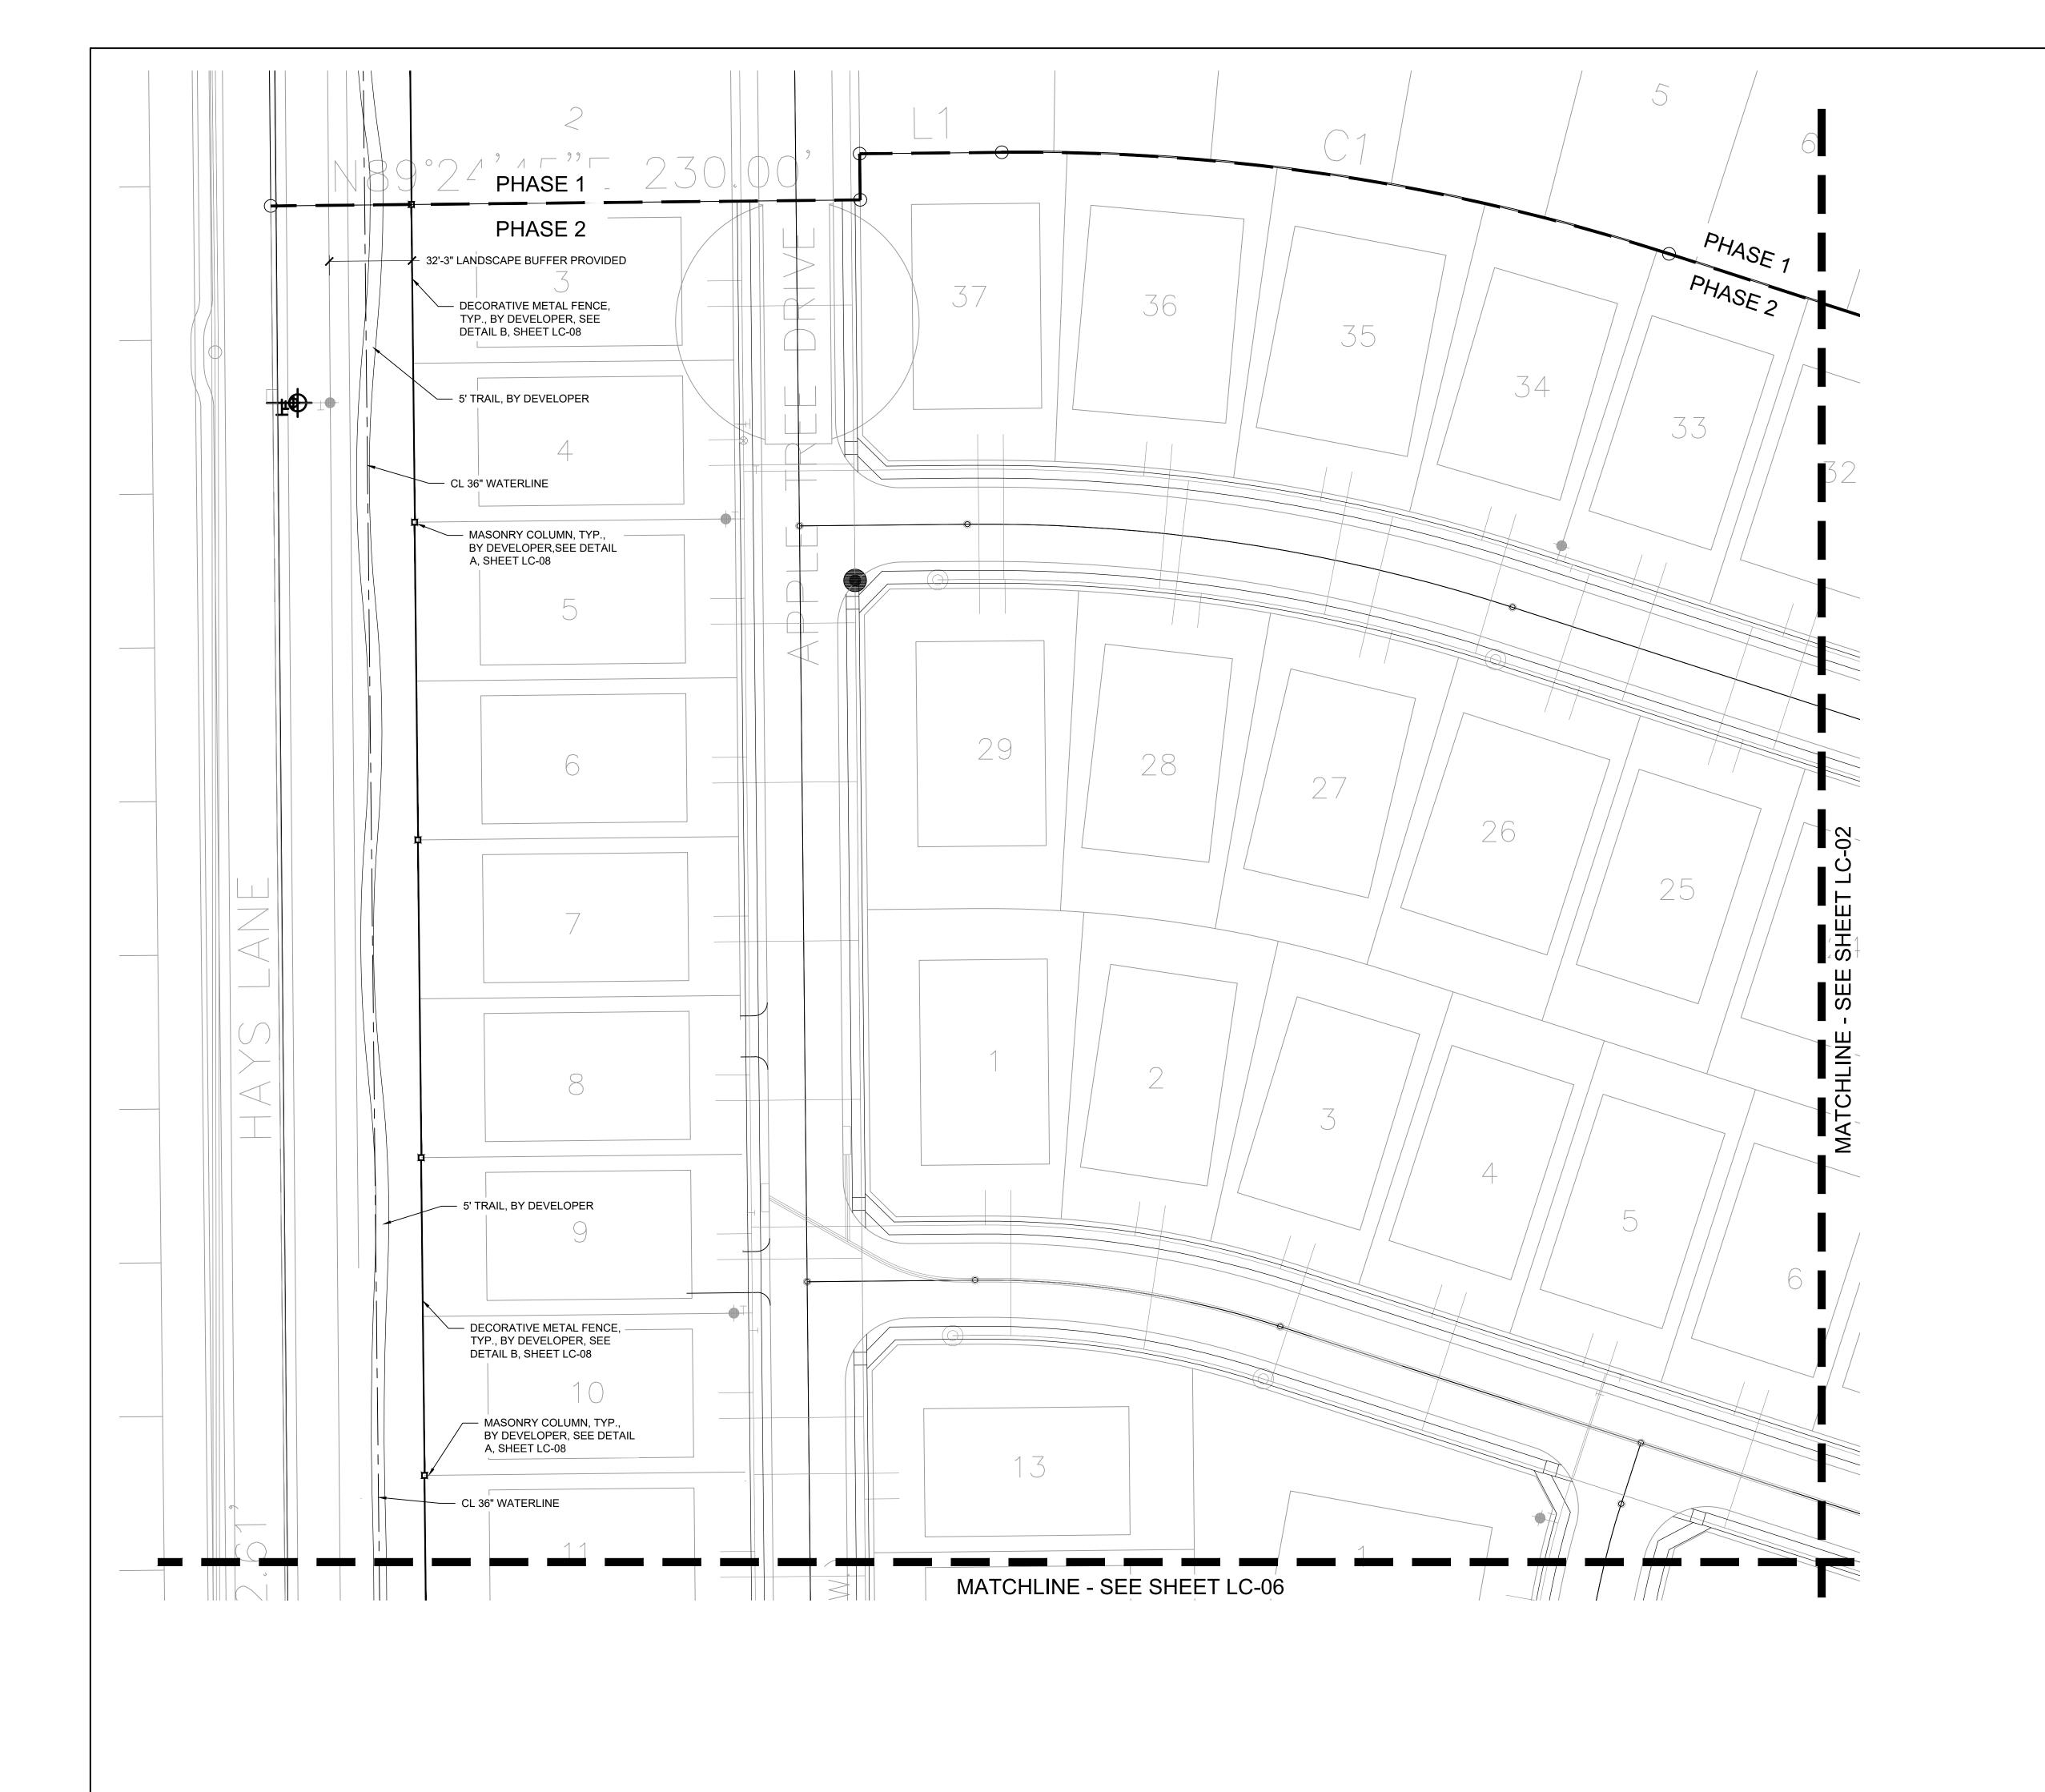- 4-IN THK. CONCRETE WALK, LIGHT BROOM FINISH, NATURAL GRAY COLOR; SEE DETAIL B, SHEET LC-07.
- 2. EXPANSION JOINT WITH COLOR CAULK TO MATCH ADJACENT PAVEMENT. SEE DETAIL A, SHEET LC-07.
- 3. 4" CONCRETE PAD, LIGHT BROOM FINISH, NATURAL GRAY COLOR; W/ SAWCUT CONTROL JOINTS; SEE DETAIL B, SHEET LC-07.
- 4. PLAYGROUND EQUIPMENT, SEE DETAIL D, SHEET LC-08
- 5. PLAYGROUND SAFETY SURFACING ENGINEERED WOOD MULCH; SEE DETAIL C, SHEET LC-08.
- 6.) SWINGS, SEE DETAIL D, SHEET LC-08.
- (7.) MULTI SPORT COURT. SEE DETAIL D, SHEET LC-07.
- (8.) ADA RAMP. SEE DETAIL C, SHEET LC-07.
- 9. PRIMARY COLUMN. SEE DETAIL A, SHEET LC-08.
- (10.) WROUGHT IRON FENCE W/ MASONRY COLUMN. SEE DETAIL A, SHEET LC-08.

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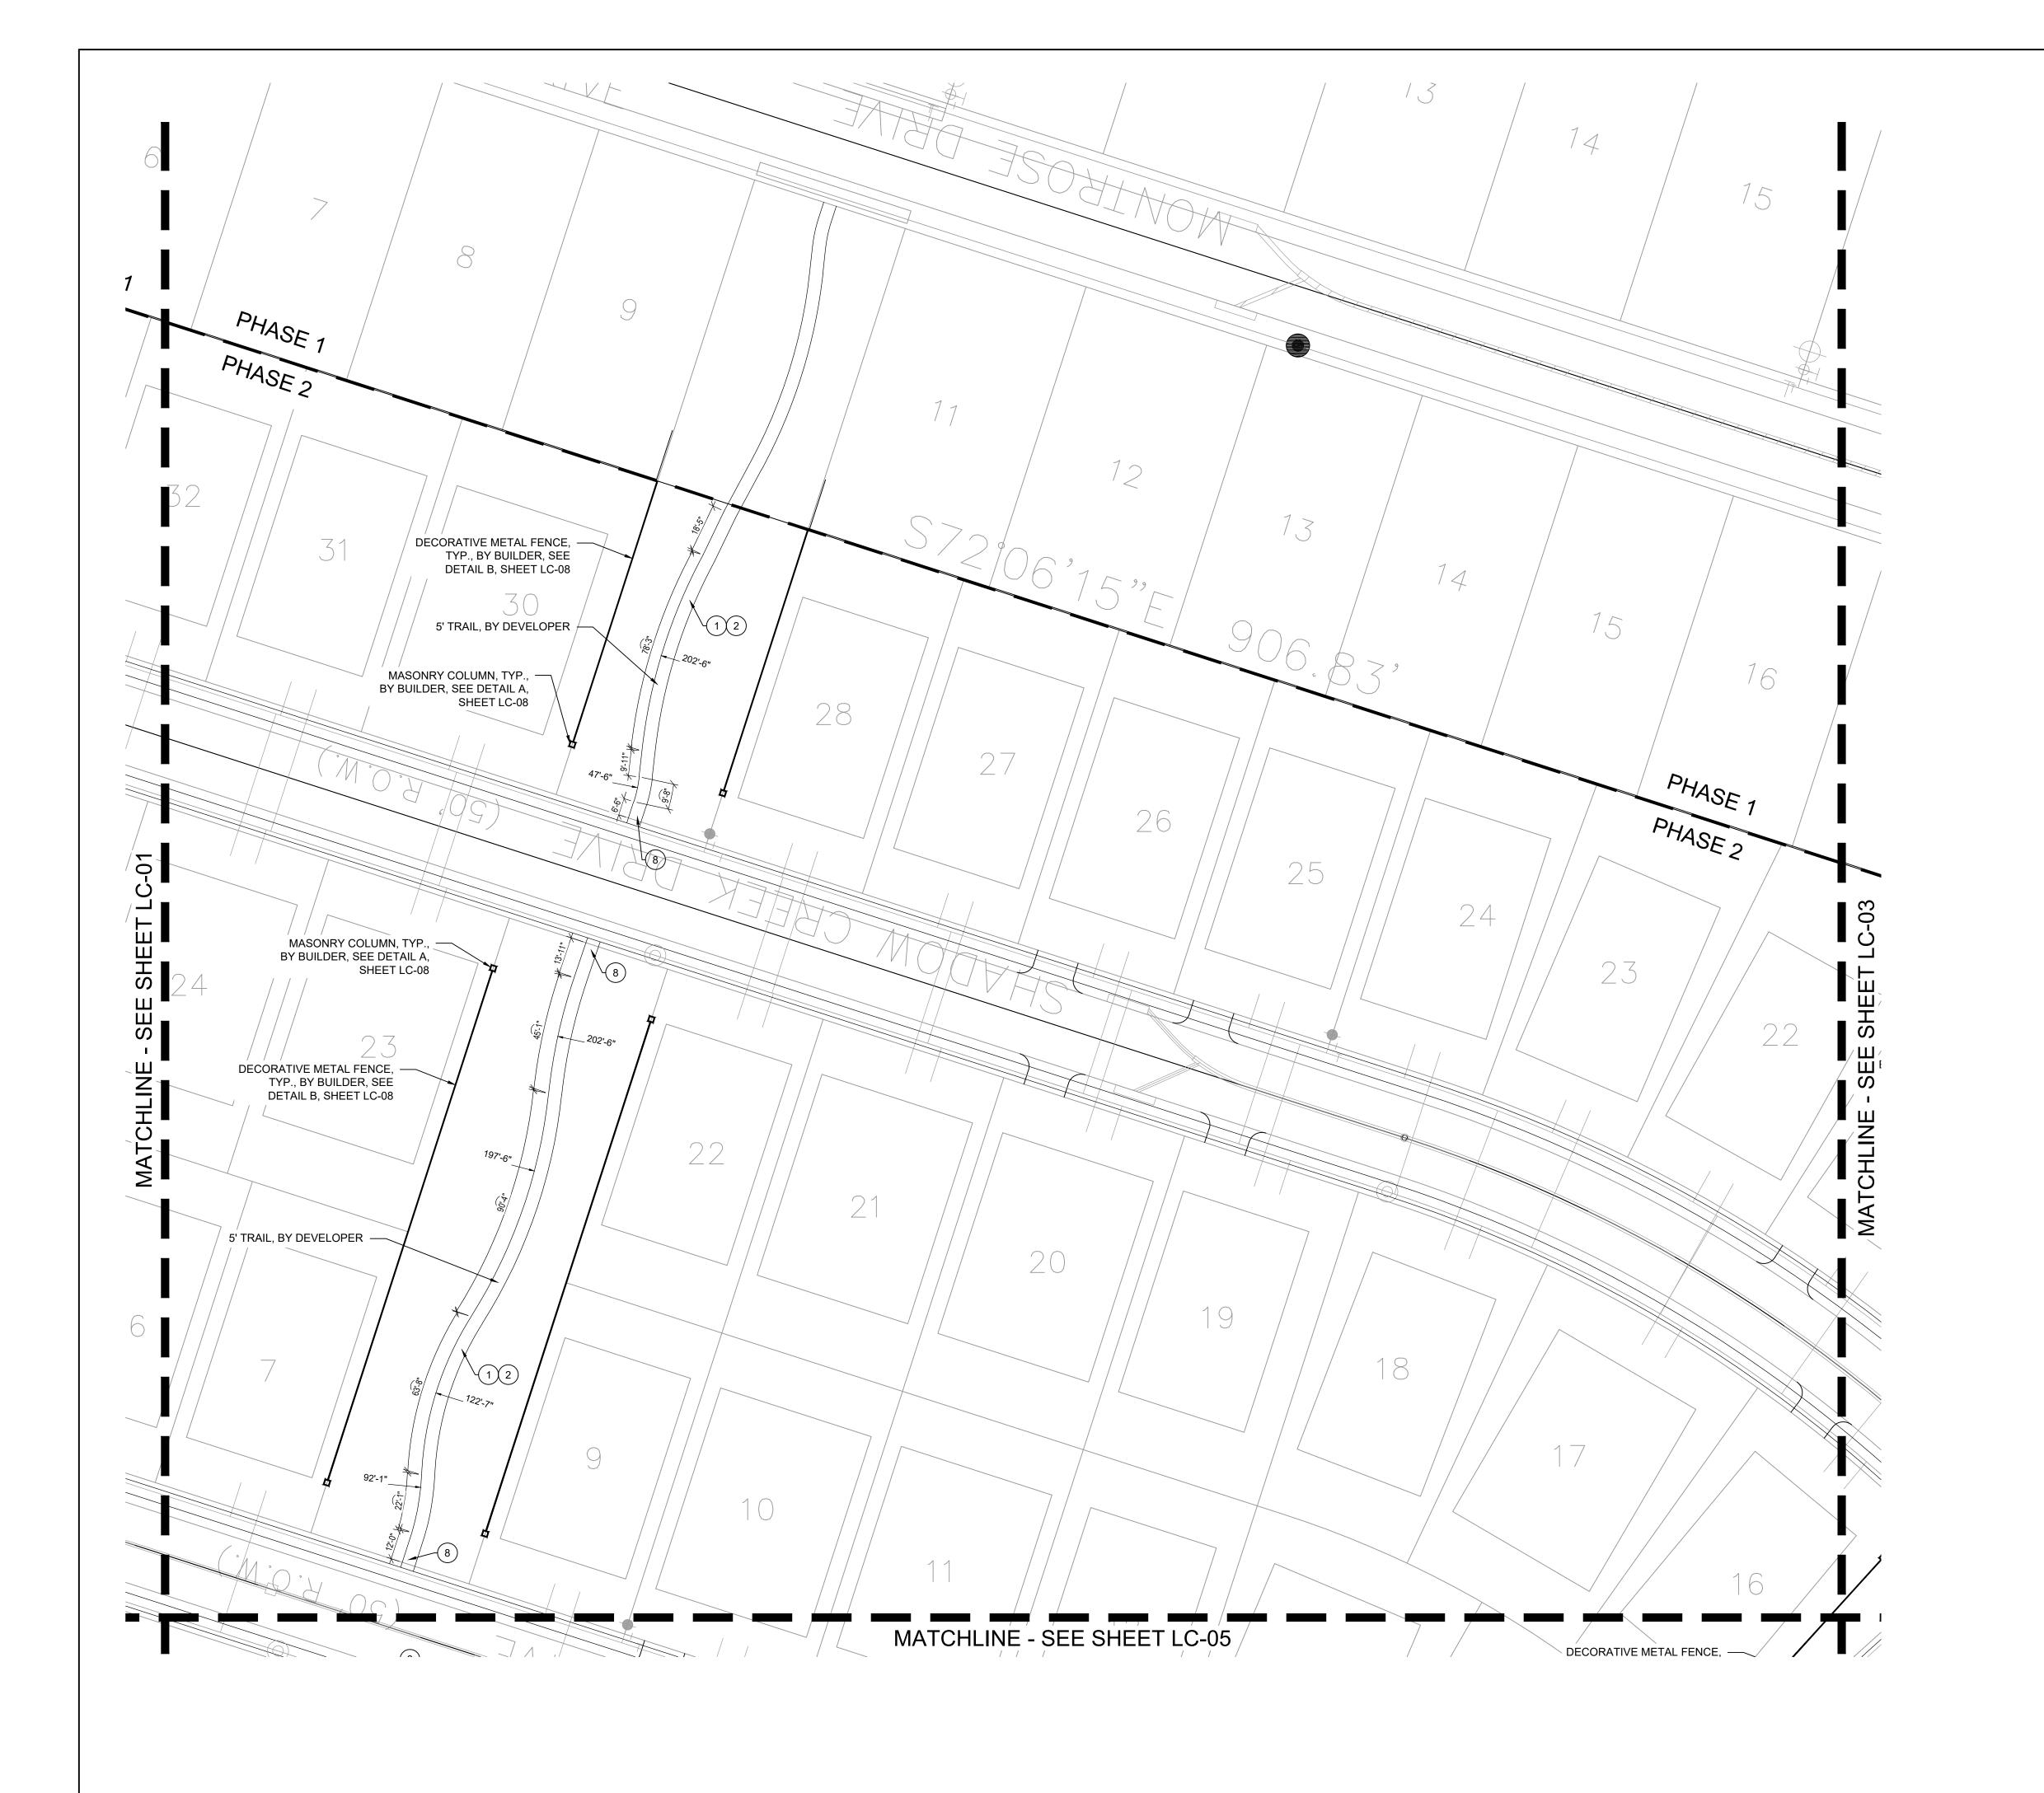
OCTOBER 04, 2024


D ij

Quail Hollow Rockwall, TX

HARDSCAPE PLAN

Date Comment



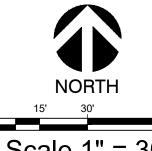

Scale 1" = 30'

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MARY N. BATES
TEXAS L.A. #3613

ISSUED ON: OCTOBER 04, 2024

korburg Company 214 Westchester Drive, Suite 900 allas, Texas 75225

Quail Hollow Rockwall, TX

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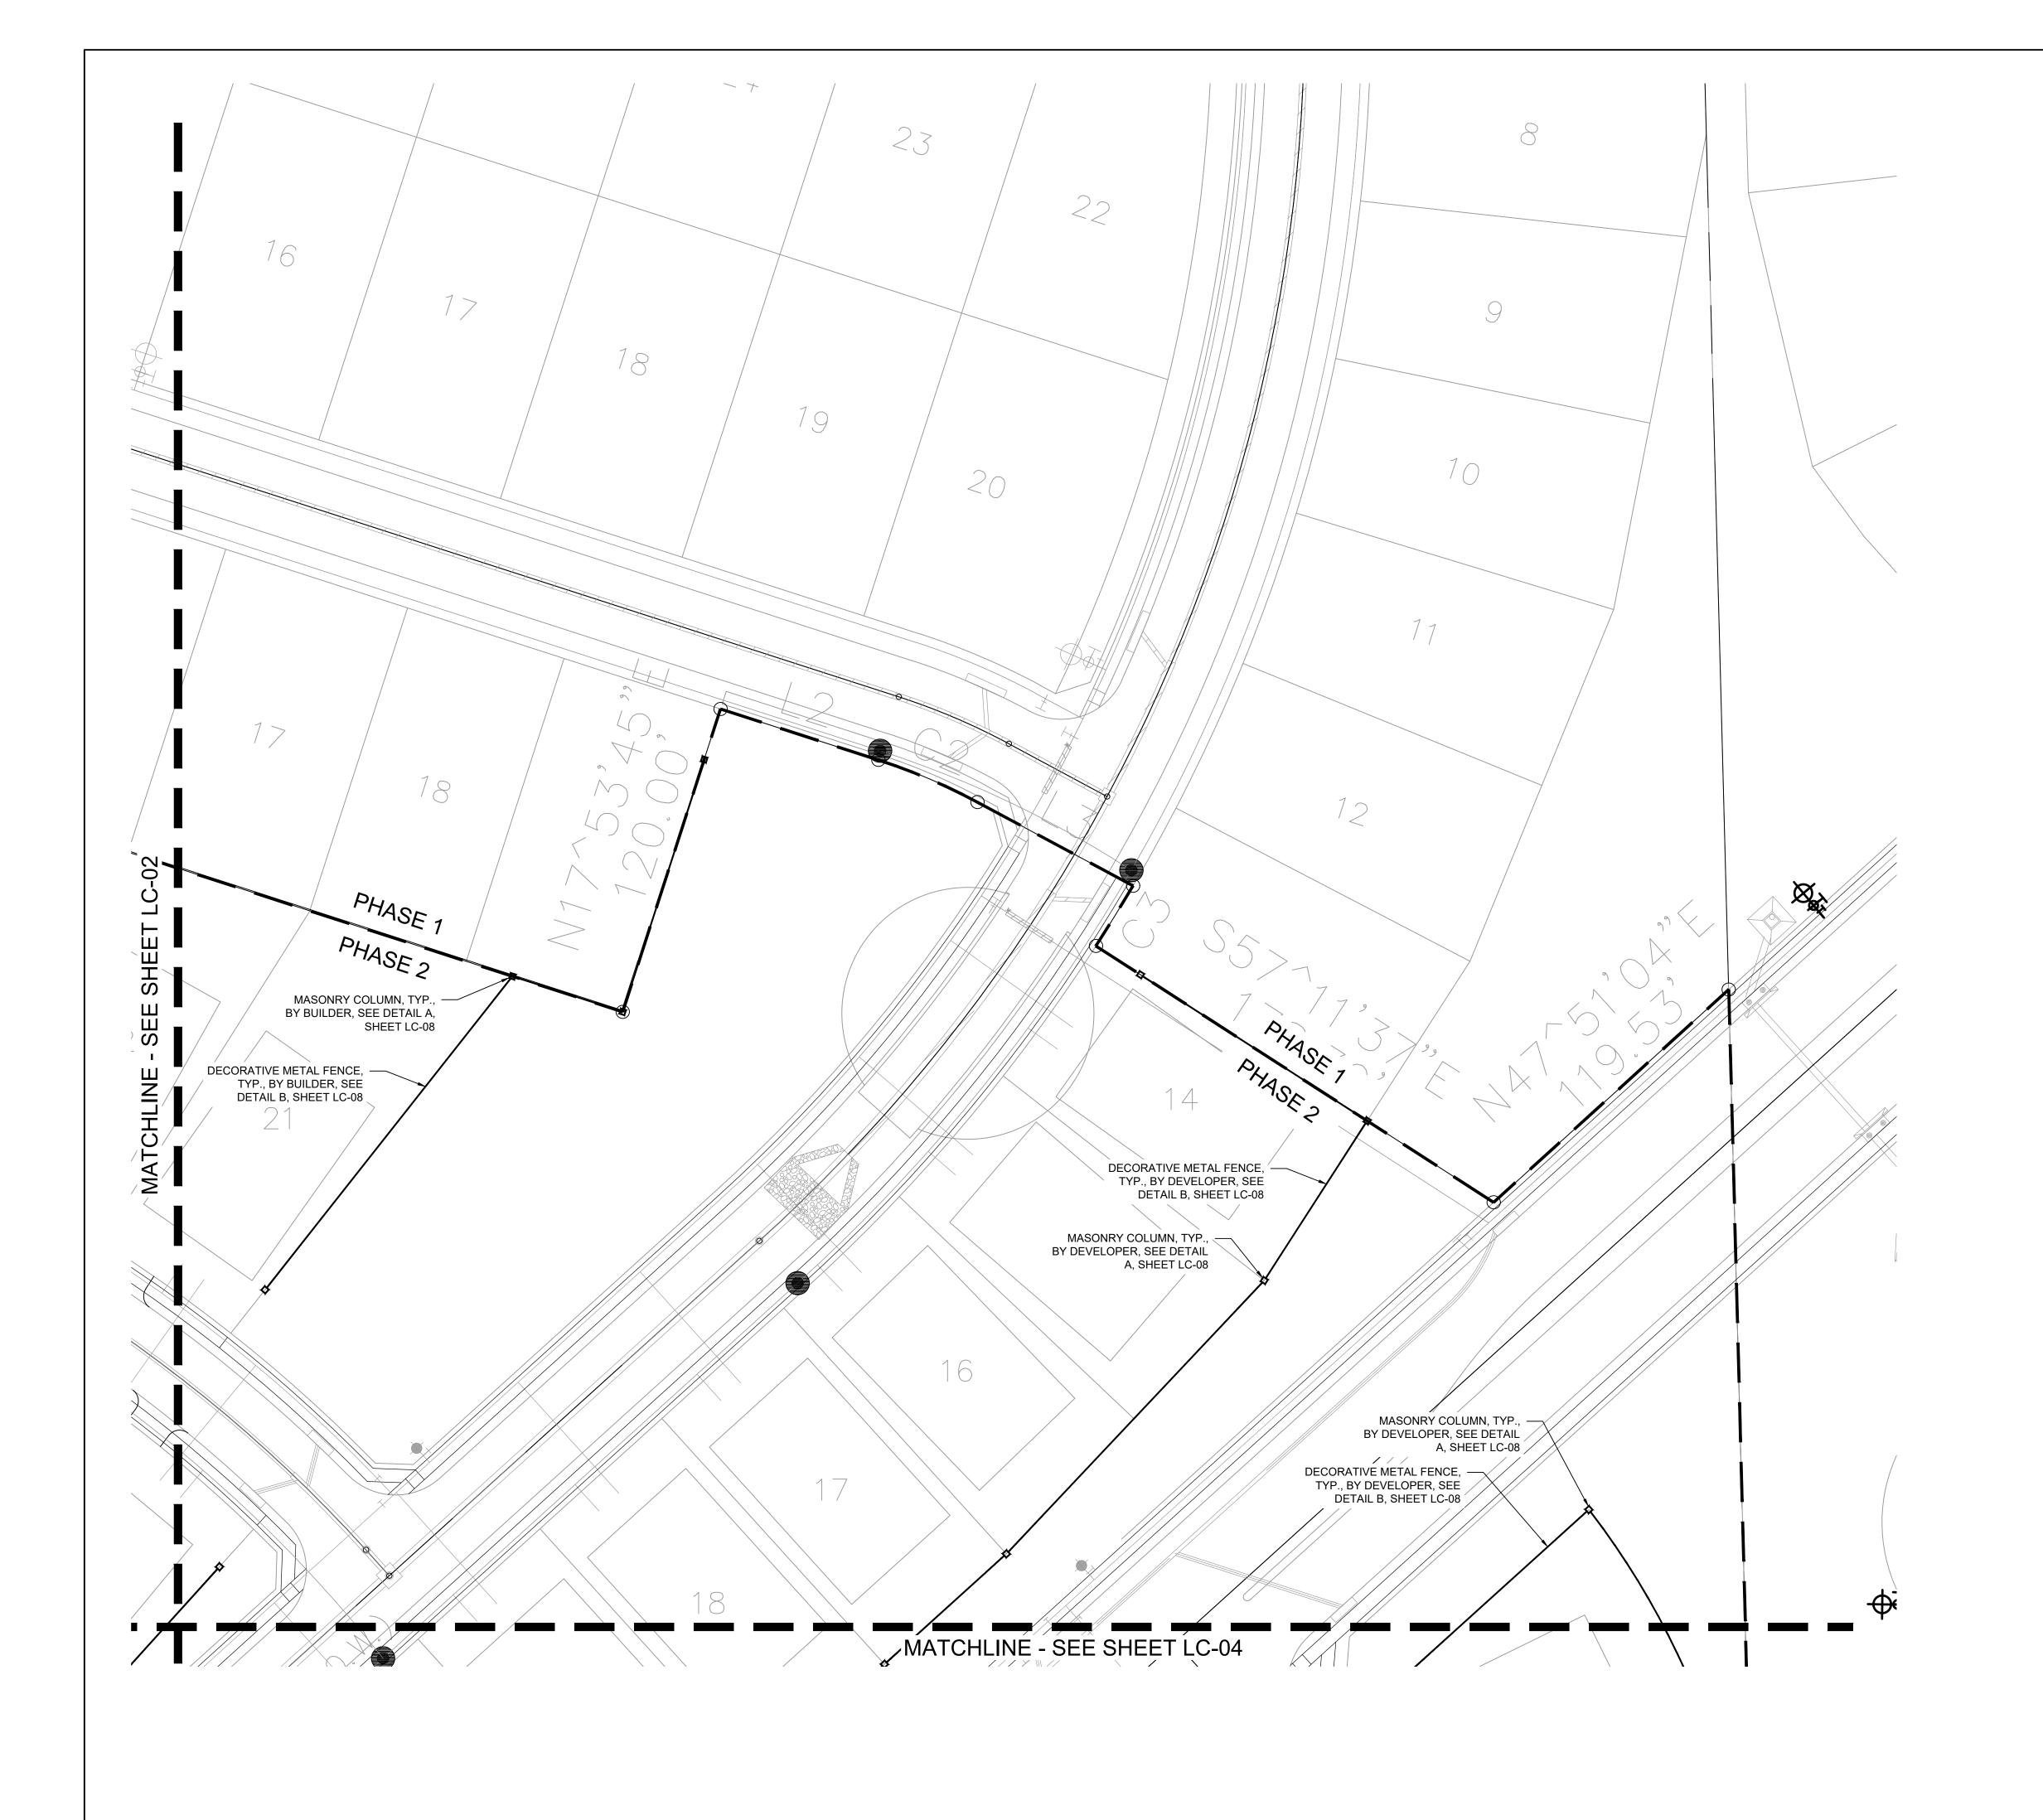
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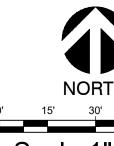
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- 5. PLAYGROUND SAFETY SURFACING ENGINEERED WOOD MULCH; SEE DETAIL C, SHEET LC-08.
- 6. SWINGS, SEE DETAIL D, SHEET LC-08.

SHEET LC-07.

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Quail Hollow Rockwall, TX

HARDSCAPE PLAN


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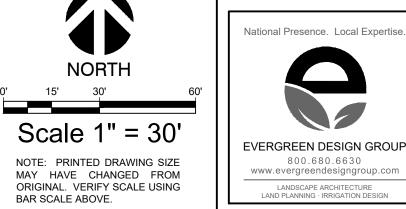
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MULCH; SEE DETAIL C, SHEET LC-08.

CONSTRUCTION LEGEND

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4.) PLAYGROUND EQUIPMENT, SEE DETAIL D, SHEET LC-08

(5.) PLAYGROUND SAFETY SURFACING - ENGINEERED WOOD

COLOR; W/ SAWCUT CONTROL JOINTS; SEE DETAIL B,

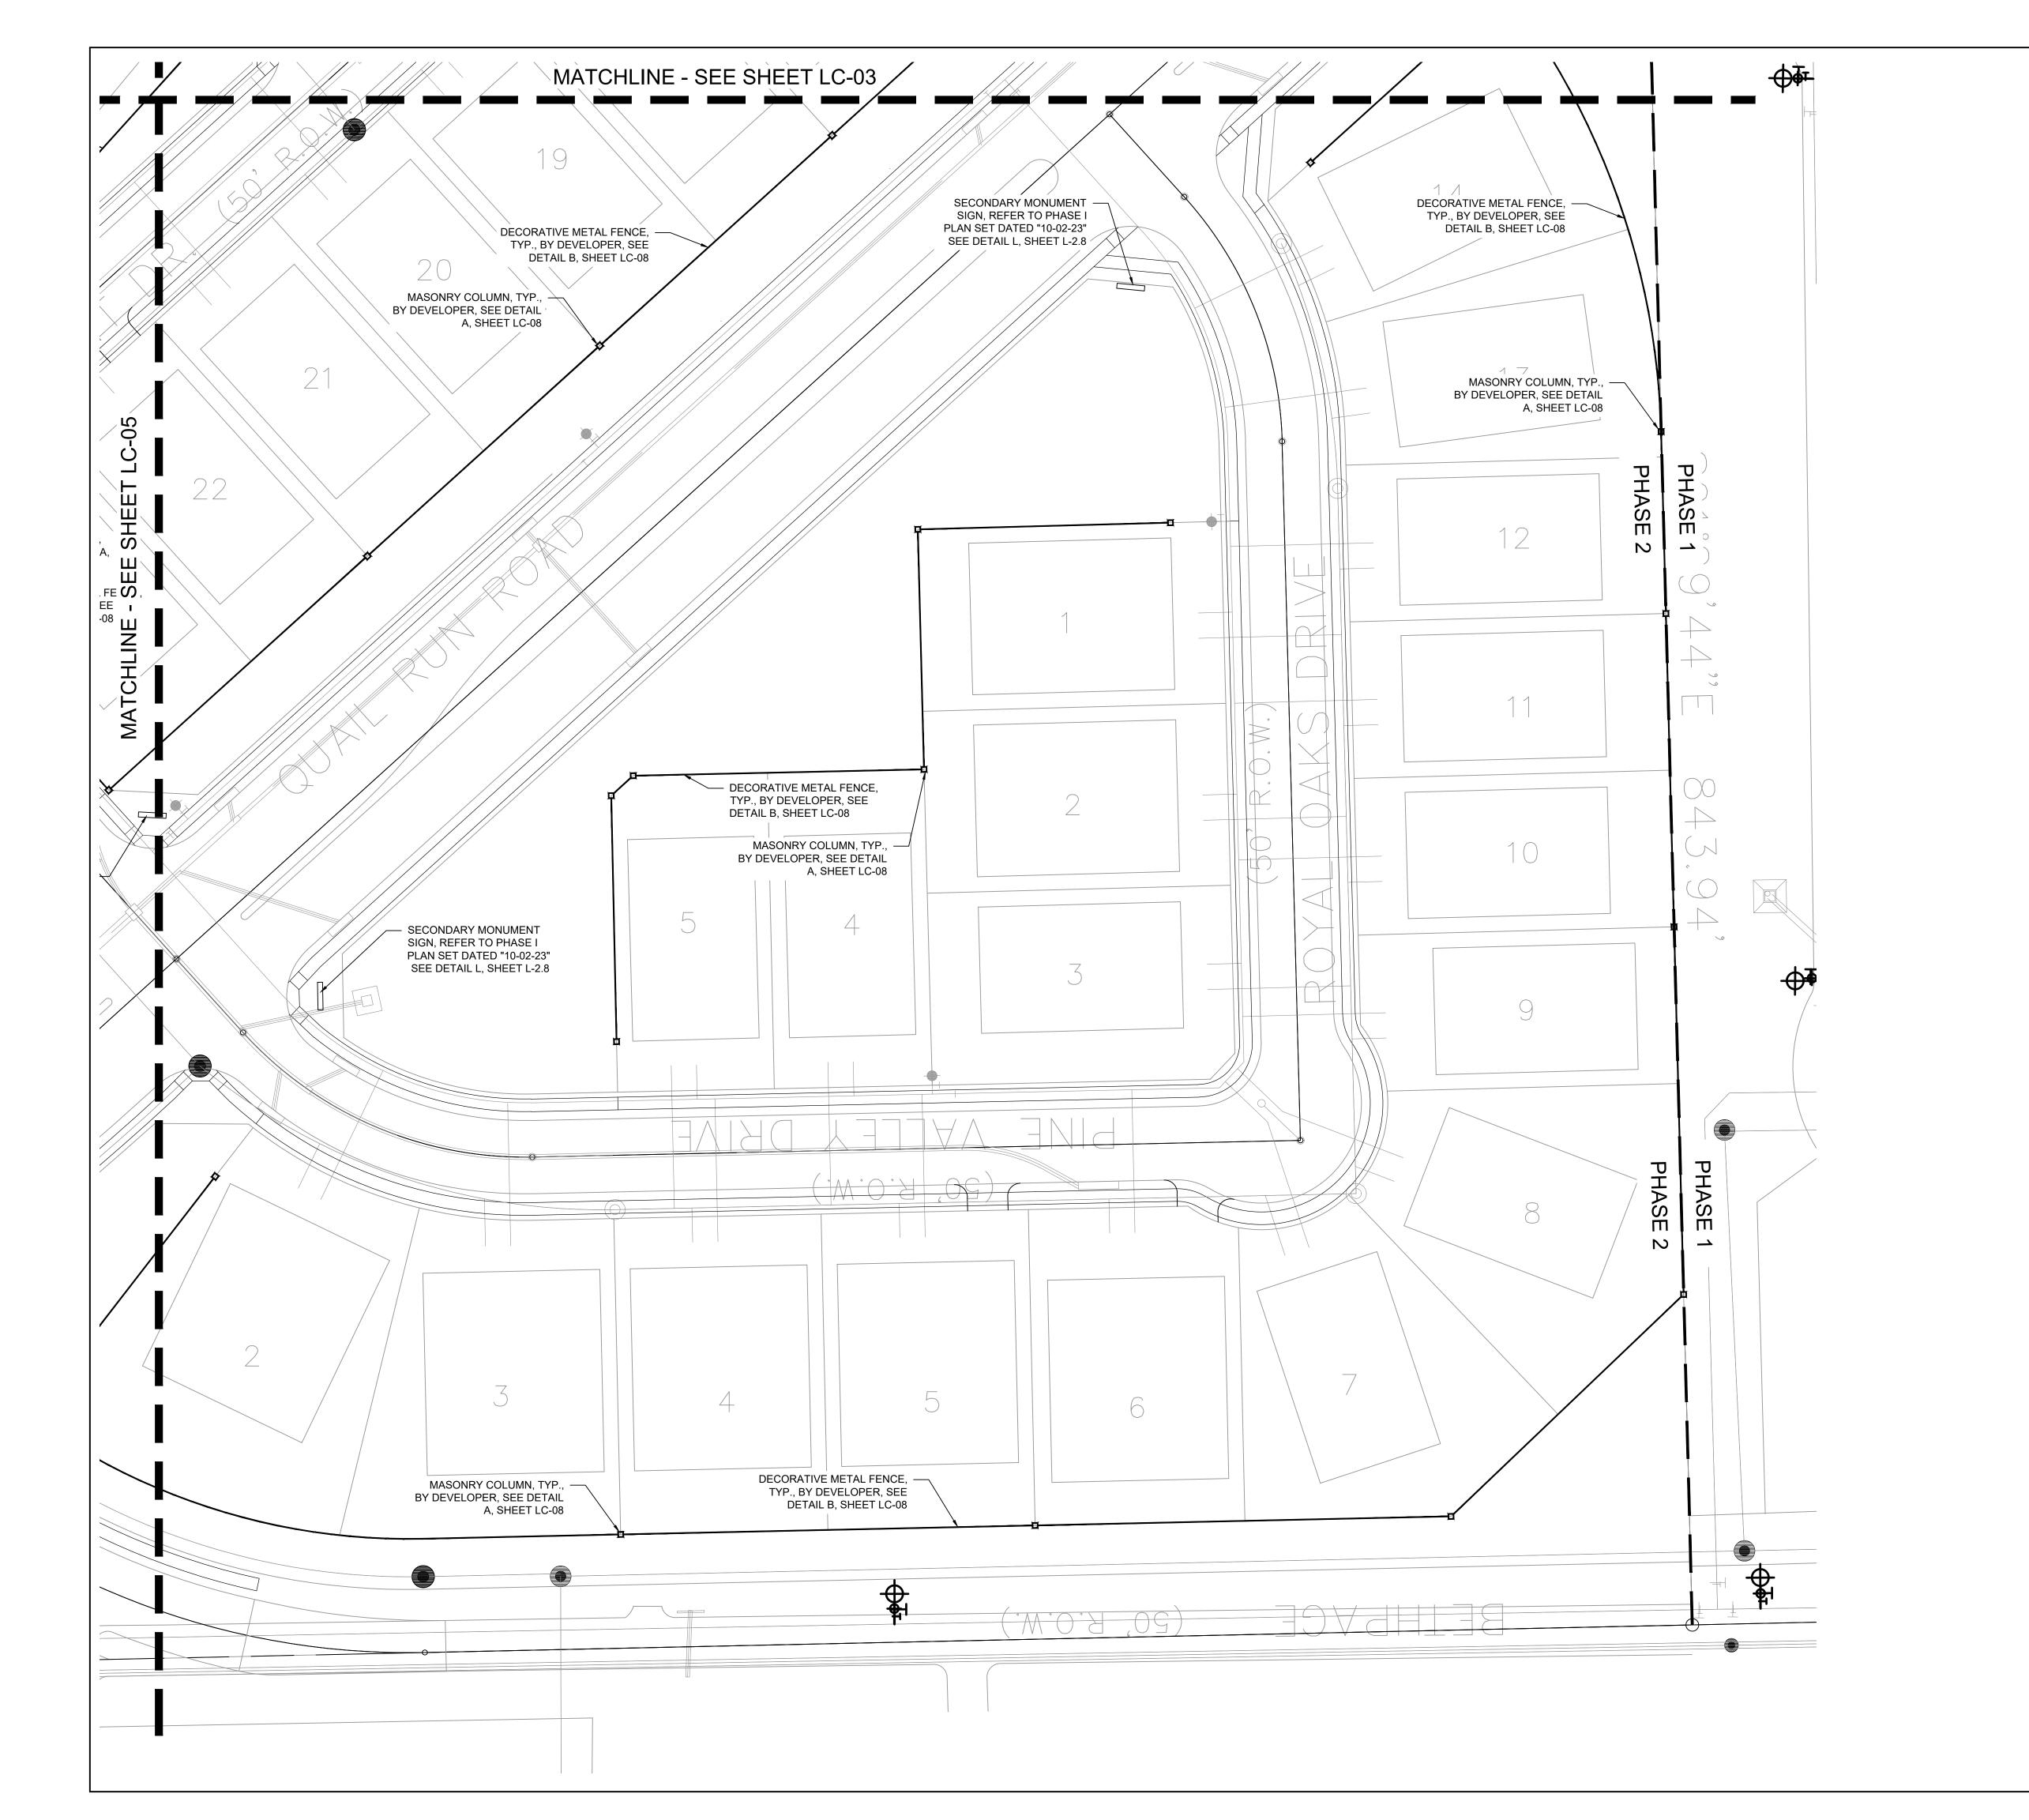2. EXPANSION JOINT WITH COLOR CAULK TO MATCH ADJACENT PAVEMENT. SEE DETAIL A, SHEET LC-07.

(MASTER LIST - NOT ALL ITEMS ARE ON EVERY SHEET)

6.) SWINGS, SEE DETAIL D, SHEET LC-08. (7.) MULTI SPORT COURT. SEE DETAIL D, SHEET LC-07.

8.) ADA RAMP. SEE DETAIL C, SHEET LC-07.

(9.) PRIMARY COLUMN. SEE DETAIL A, SHEET LC-08.

SHEET LC-07.

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ISSUED ON:


OCTOBER 04, 2024


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(5.) PLAYGROUND SAFETY SURFACING - ENGINEERED WOOD

4-IN THK. CONCRETE WALK, LIGHT BROOM FINISH, NATURAL GRAY COLOR; SEE DETAIL B, SHEET LC-07.

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CONSTRUCTION LEGEND (MASTER LIST - NOT ALL ITEMS ARE ON EVERY SHEET)

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TEXAS L.A. #3613

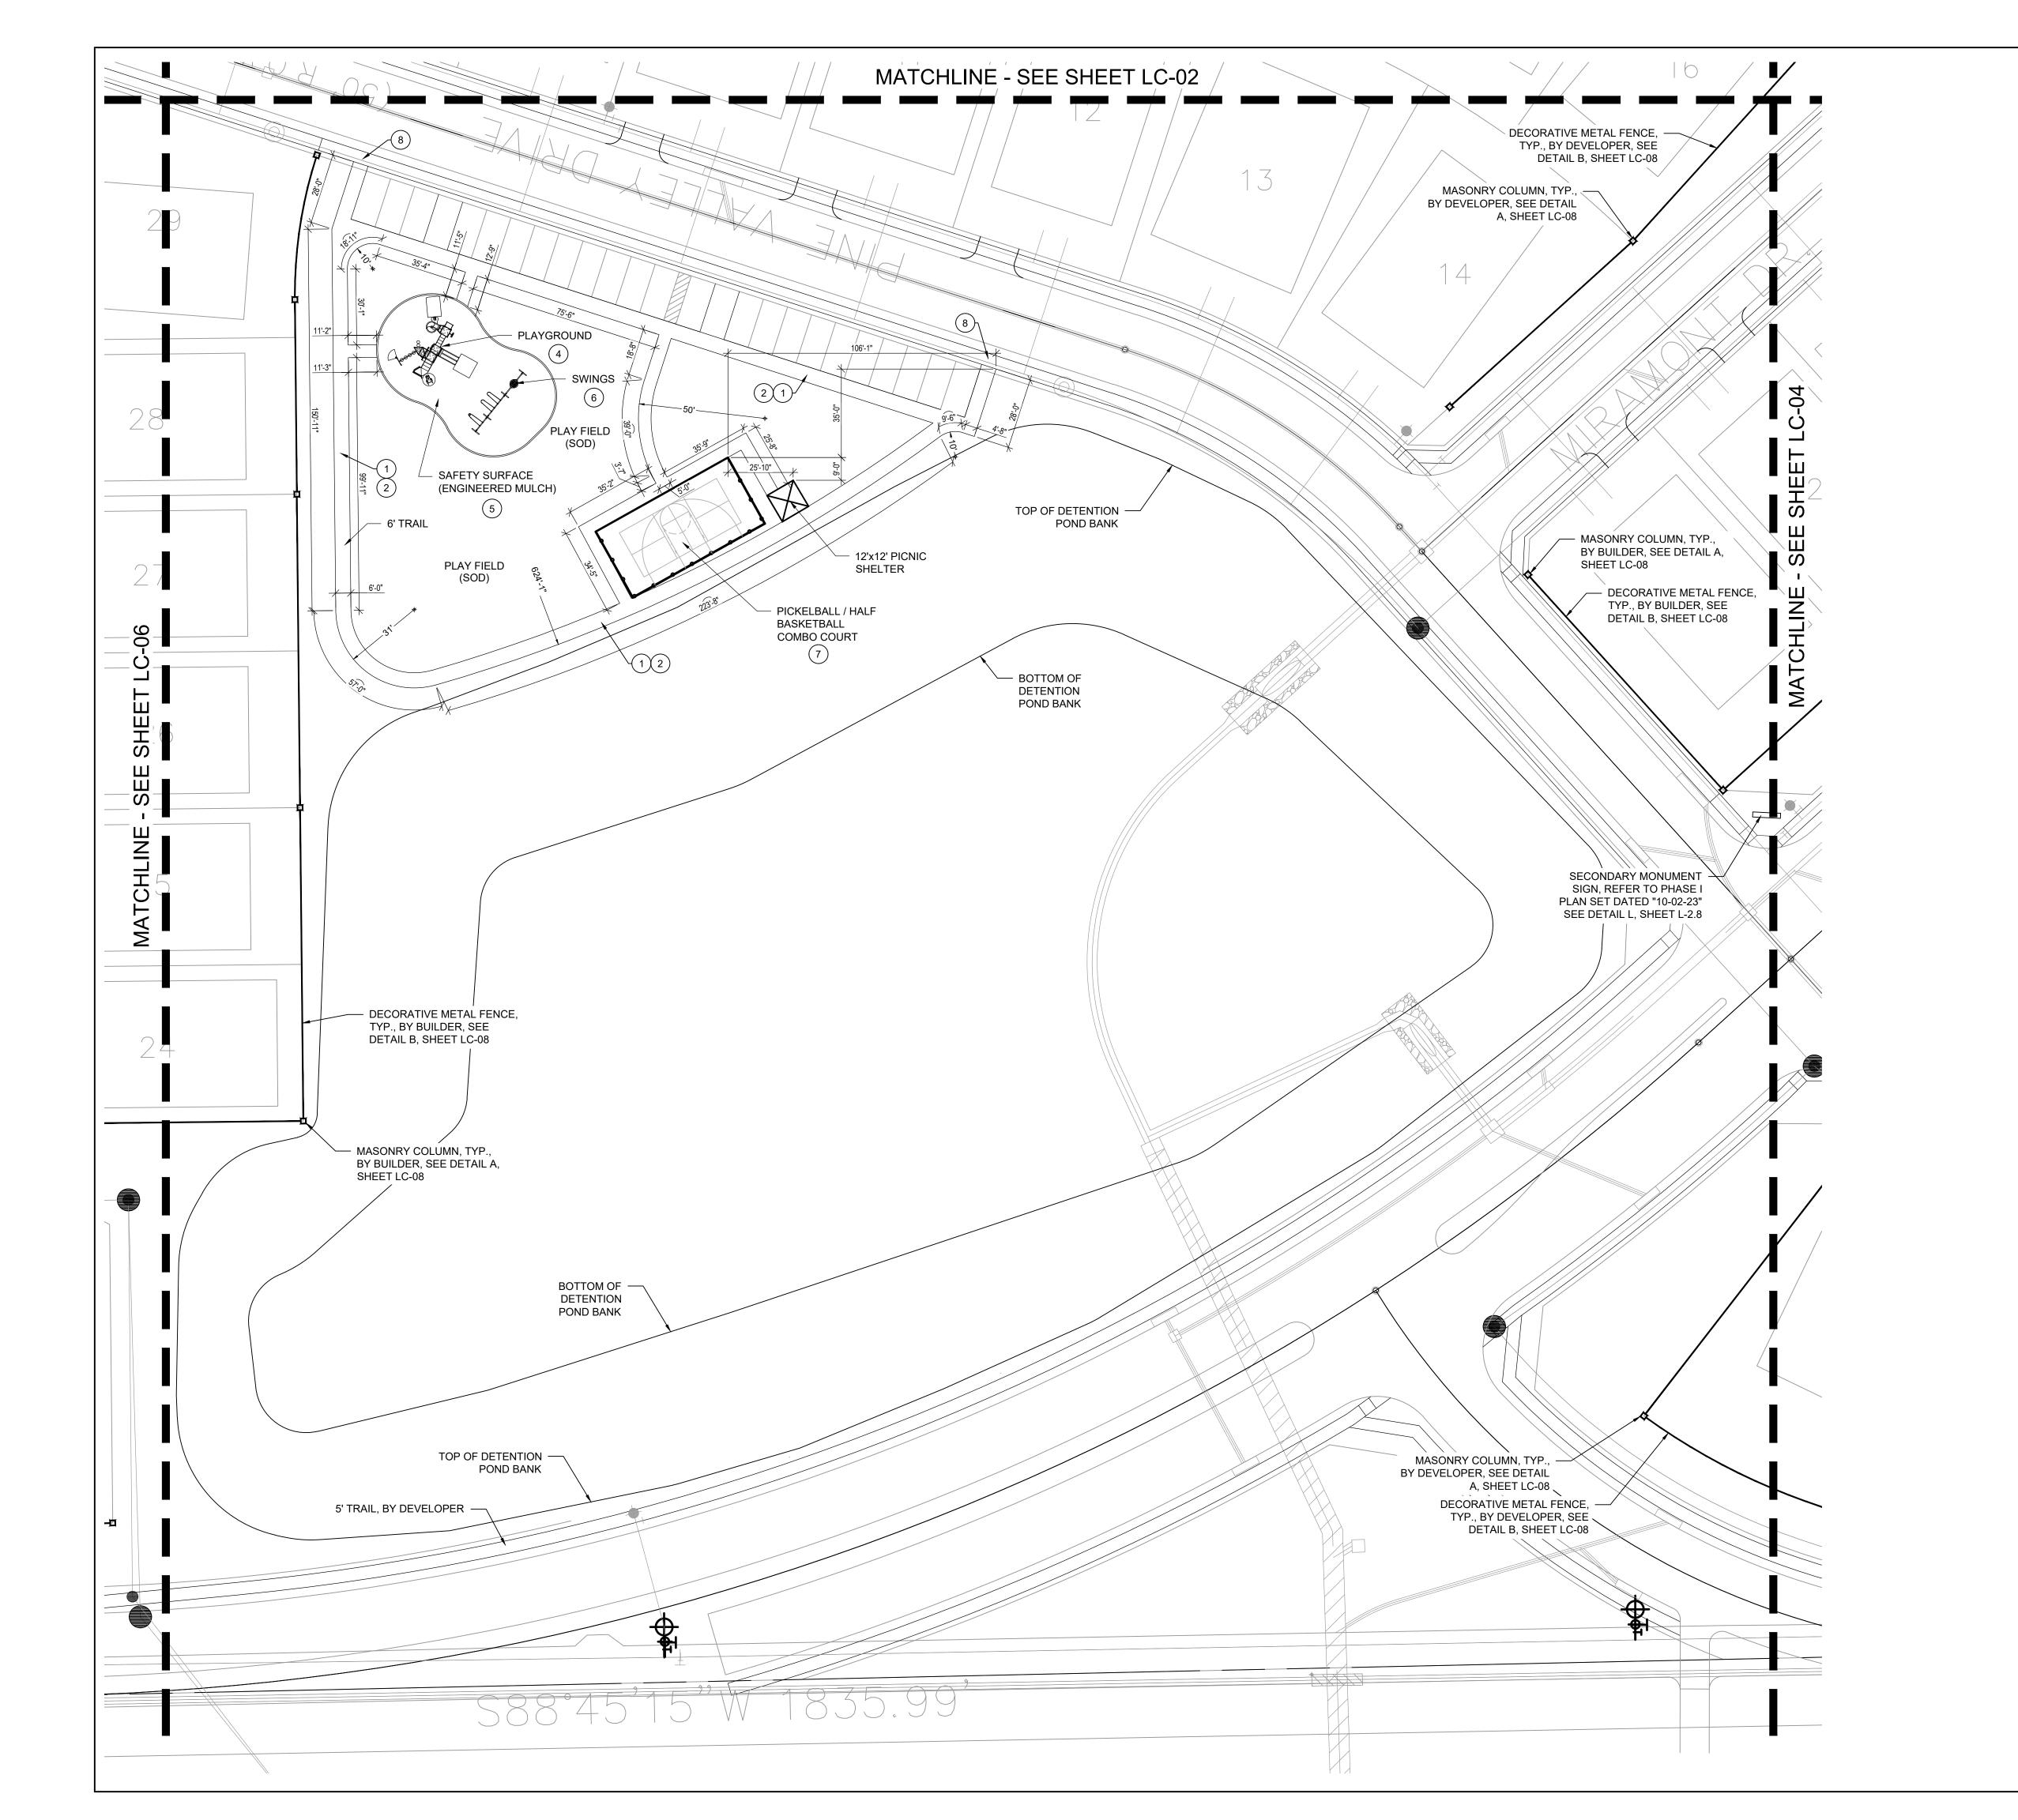
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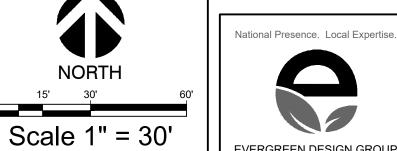
Hollow Quail Rockwall,

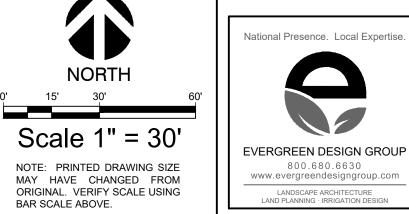HARDSCAPE PLAN

Date Comment

10/04/24 Drawn By



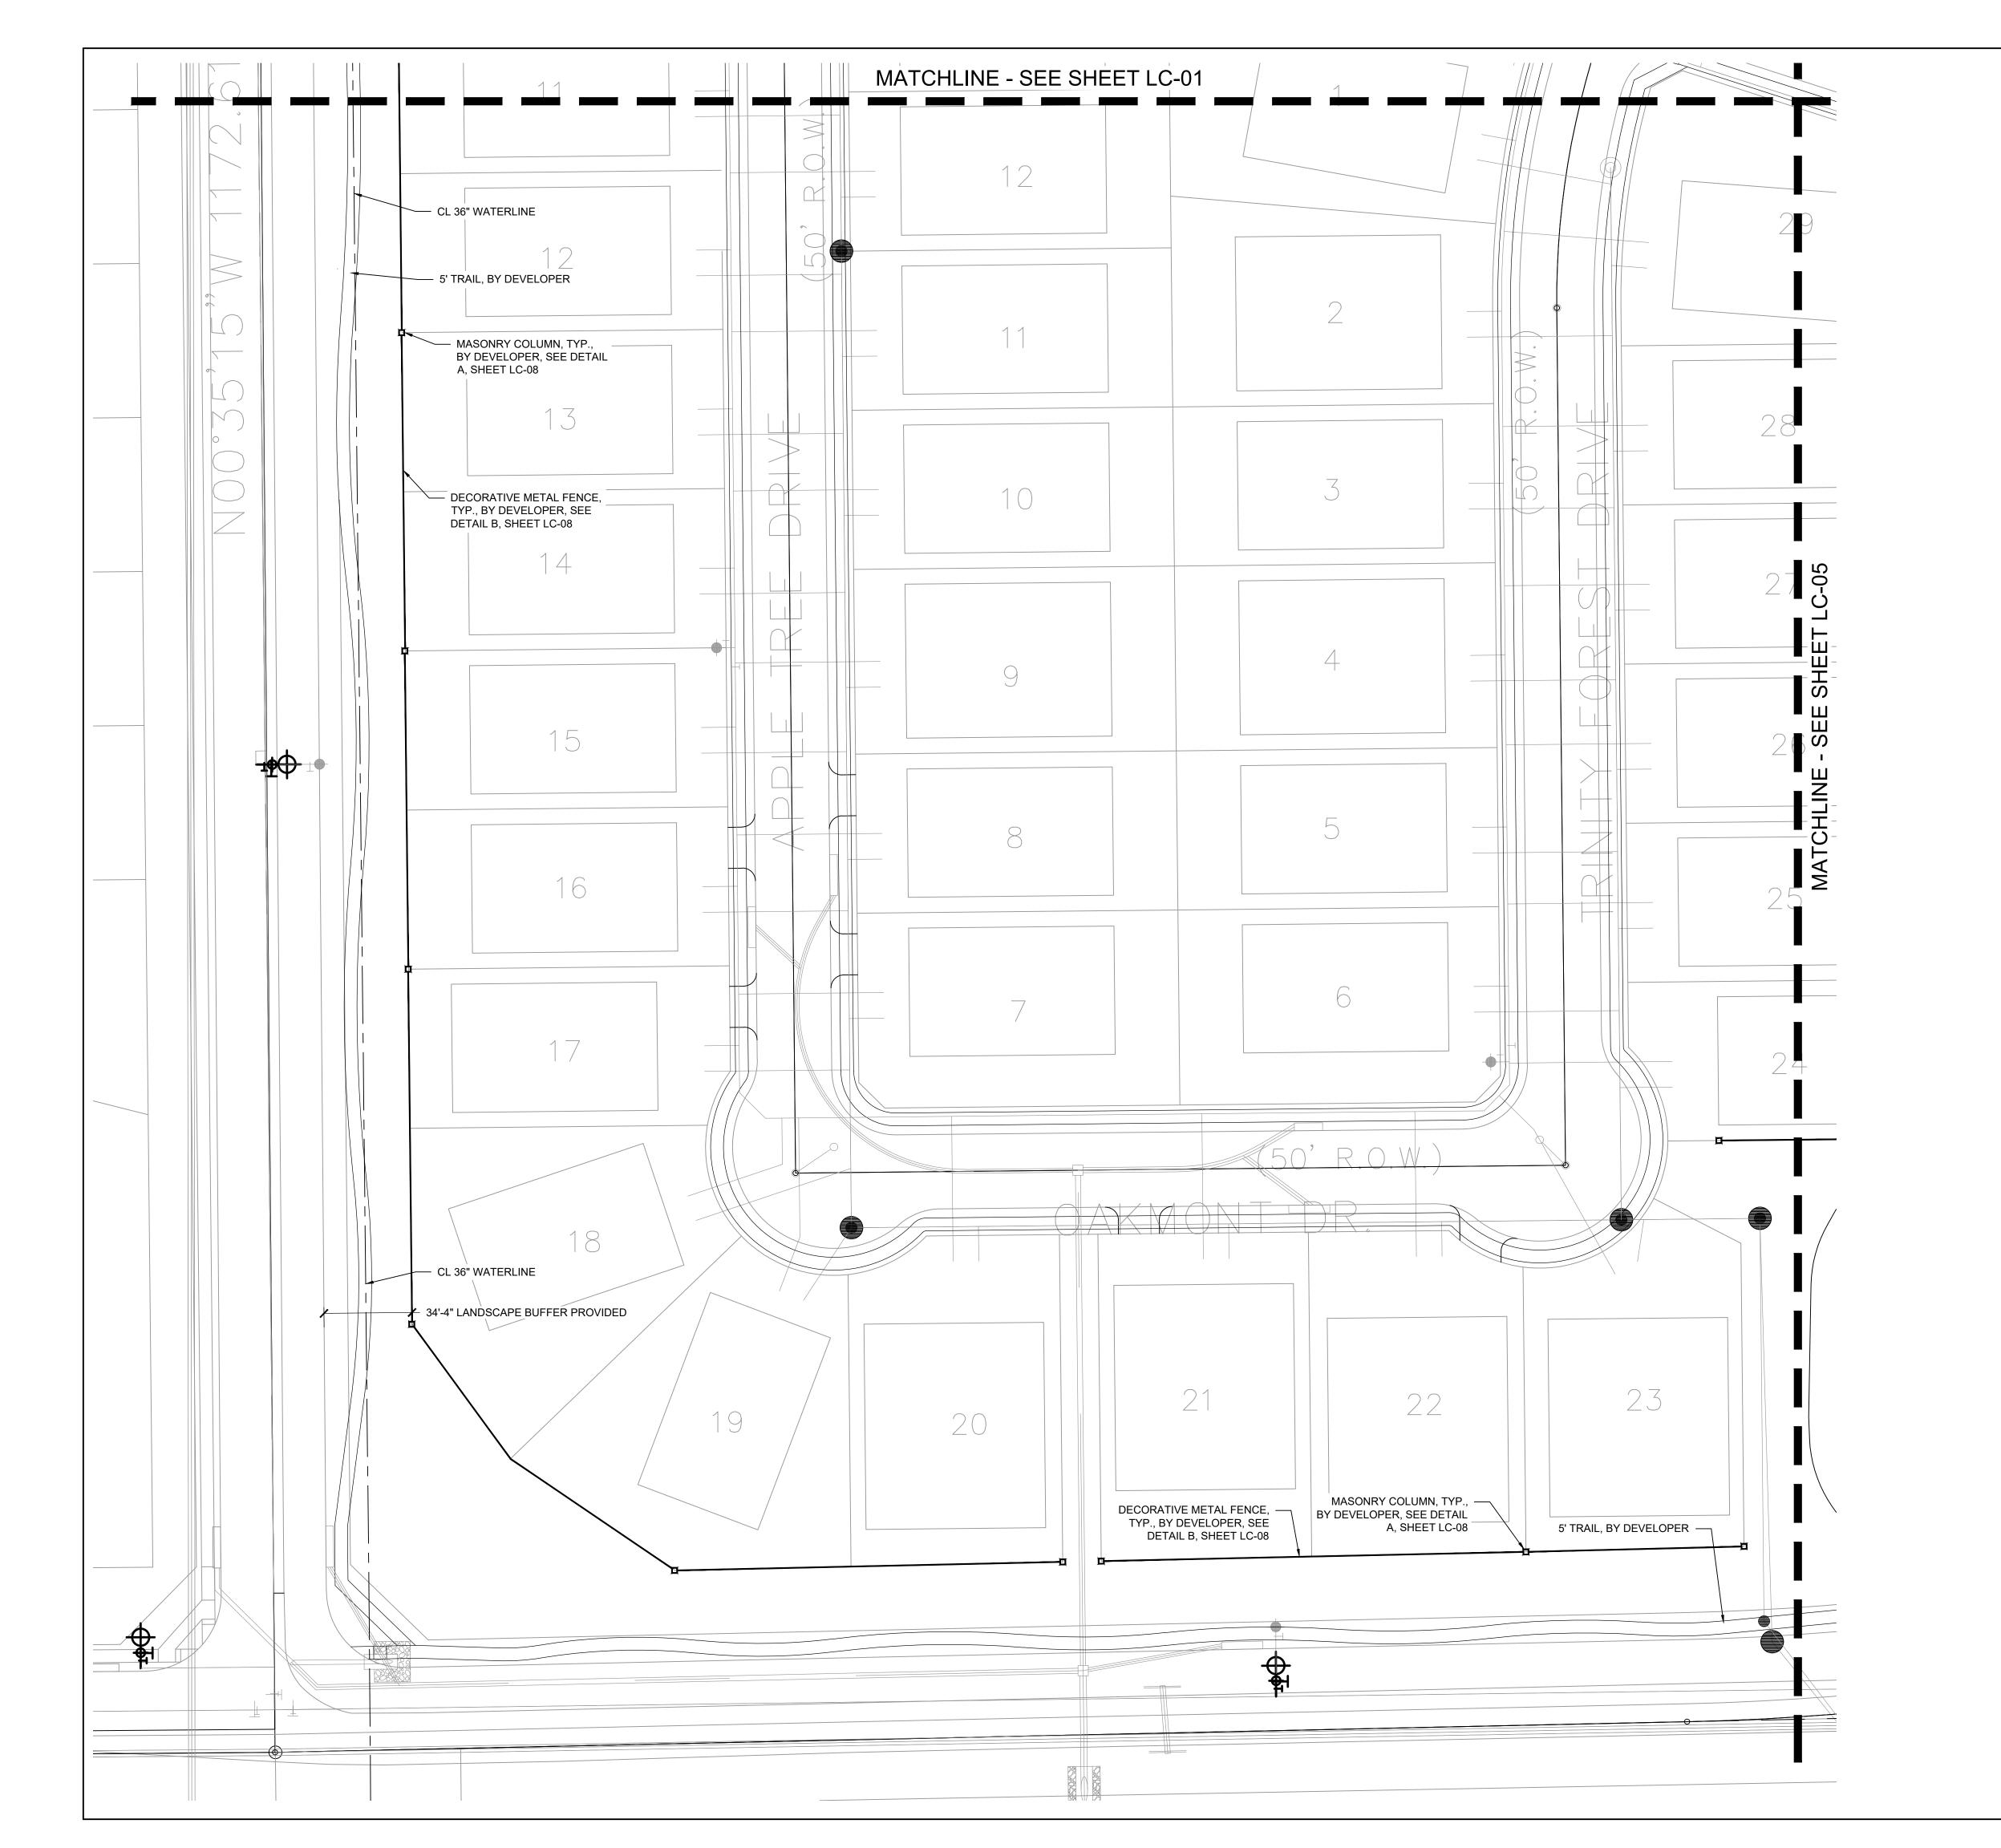

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> MARY N. BATES TEXAS L.A. #3613 ISSUED ON: OCTOBER 04, 2024


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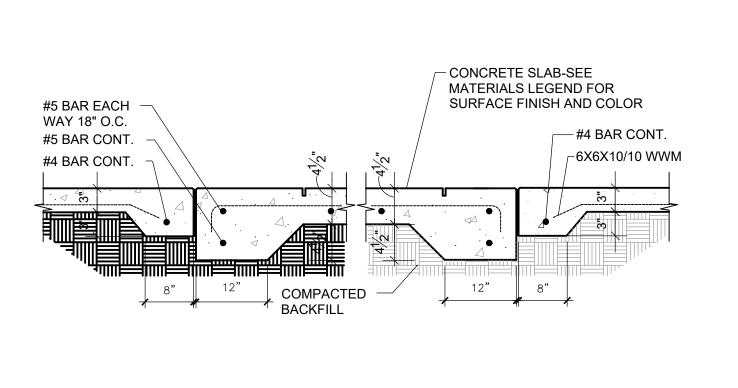
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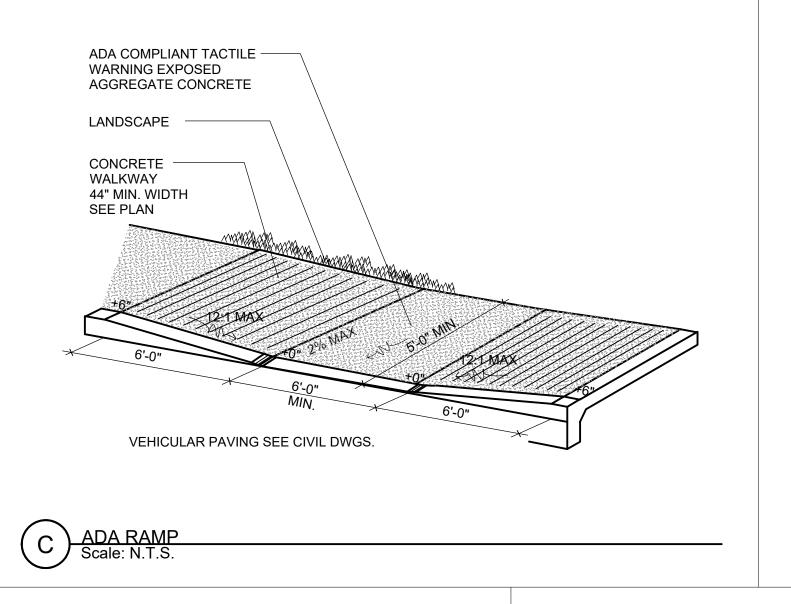
Quail Hollow Rockwall, TX

HARDSCAPE PLAN

Date Comment





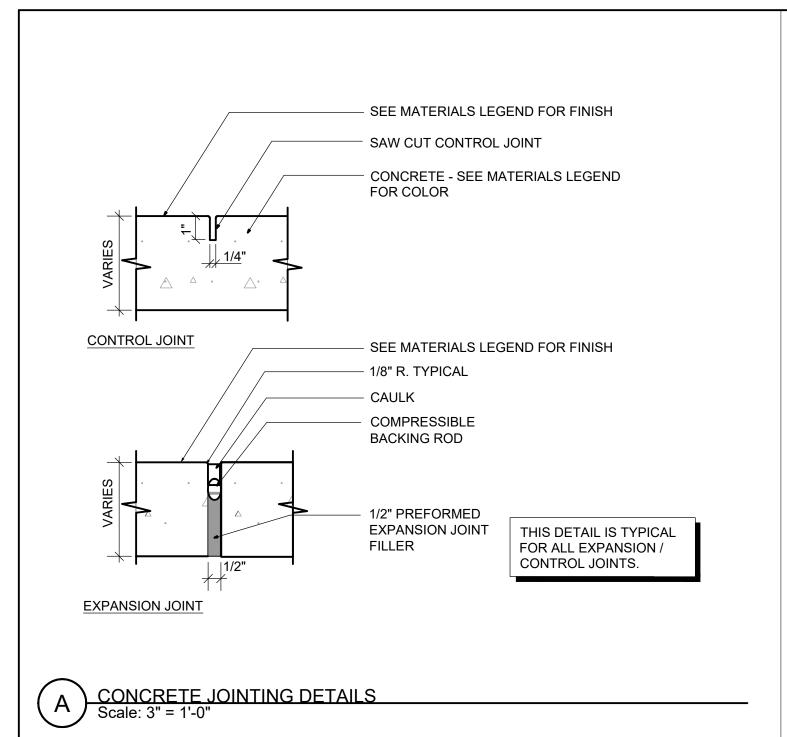



COURT BUILDER "



B CONCRETE PAVEMENT - LIGHT DUTY
Scale: 3/4" = 1'-0"

MANUFACTURER: SPORT COURT SUPPLIER: NEXCOURT CONTACT: CHRIS WALKER PHONE: 972-898-7529 COLORS: TBD OPTIONS: 30'X60' MULTI-SPORT COURT, 1/2 BASKETBALL, PICKLEBALL, 2 SINGLE LIGHTS, FULL 3 SIDES BLACK VINYL COATED CHAIN LINK FENCE BACKSTOP

PICKLE BALL COURT FENCE NOTE: 8' HIGH FENCE AT REAR OF COURT. 4' HIGH FENCE AT SIDES OF COURT.

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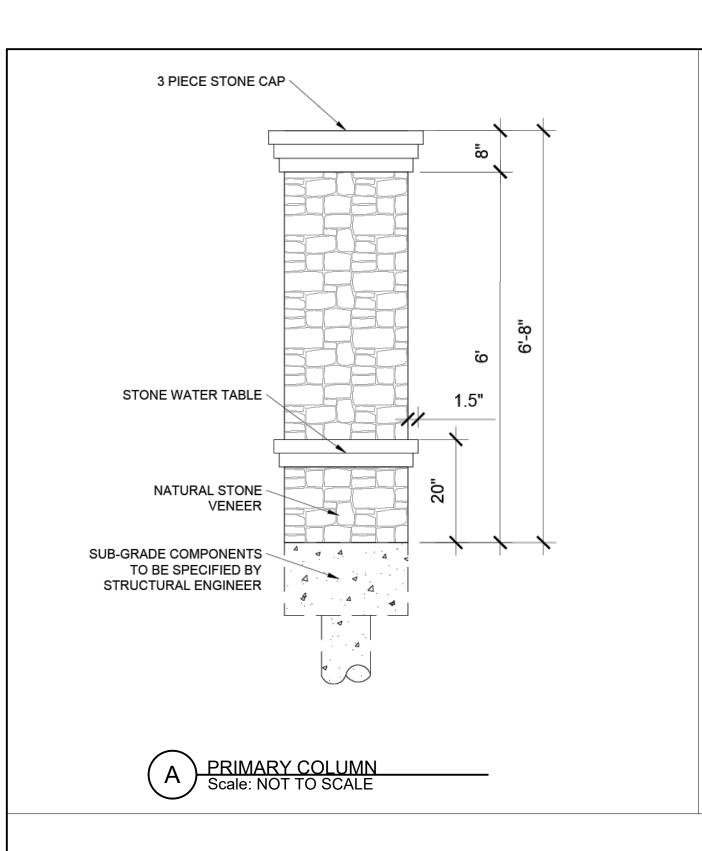
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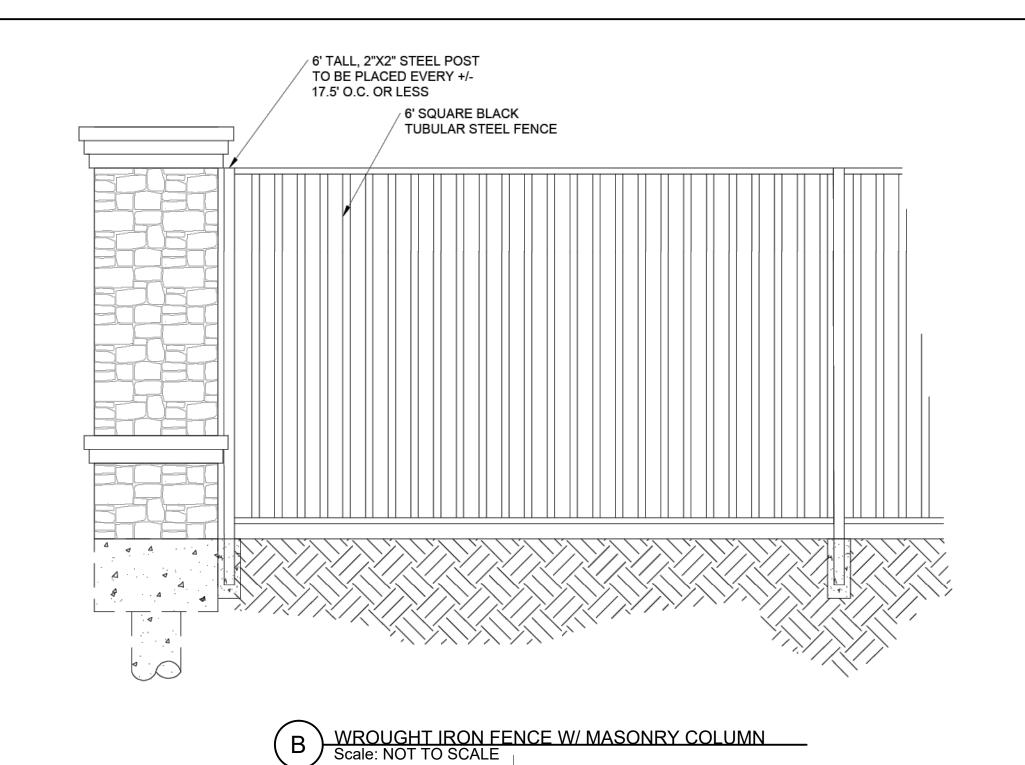
Comparion Drive, Suite Skorburg (8214 Westchester I Dallas, Texas 75225

Hollow LTX Quail Rockwall,

HARDSCAPE DETAILS

Date Comment





— ACCESSIBLE CONCRETE RAMP INSIDE EDGE OF RAMP -----FIBAR® WOOD FIBER MUST FALL OUTSIDE ASTM USE ZONE ← FIBAR® WOOD FIBER SLOPE>1% ABOVE GROUND INSTALLATION ABOVE GROUND INSTALLATION ACCESSIBILITY DETAIL

1. INSTALLATION TO BE COMPLETED IN ACCORDANCE WITH MANUFACTURER'S SPECIFICATIONS.

2. DO NOT SCALE DRAWING. 3. THIS DRAWING IS INTENDED FOR USE BY ARCHITECTS, ENGINEERS, CONTRACTORS, CONSULTANTS AND DESIGN PROFESSIONALS

FOR PLANNING PURPOSES ONLY. THIS DRAWING MAY NOT BE USED FOR CONSTRUCTION. 4. ALL INFORMATION CONTAINED HEREIN WAS CURRENT AT THE TIME OF DEVELOPMENT BUT MUST BE REVIEWED AND APPROVED BY

THE PRODUCT MANUFACTURER TO BE CONSIDERED ACCURATE. 5. CONTRACTOR'S NOTE: FOR PRODUCT AND COMPANY INFORMATION VISIT www.CADdetails.com/info AND ENTER

THE FIBAR GROUP LLC 80 BUSINESS PARK DRIVE, SUITE 300 ARMONK, NY 10504 TOLL FREE: 1-800-342-2721 PHONE: (914) 273-8770 FAX: (914) 273-8659

www.fibar.com

ENGINEERED WOOD FIBER PLAYGROUND SAFETY SURFACING
Scale: NOT TO SCALE



MANUFACTURER: LITTLE TYKES SUPPLIER: LEA PARK & PLAY PHONE: (972) 690-8163 COLORS: TBD MODEL: R0306_45555298831



NOTES:

1. INSTALL ALL SHELTER ELEMENTS PER
MANUFACTURER'S RECOMMENDATIONS.

2. CONTRACTOR TO PROVIDE SIGNED AND SEALED
STRUCTURAL DRAWINGS FOR REVIEW PRIOR TO INSTALLATION. INSTALL WITH 12'X20' (4") CONCRETE SLAB.

MODEL: 12' X 12' NAVAJO SHELTER MANUFACTURER: AMERICANA BUILDING PRODUCTS CONTACT: LEA PARK & PLAY NICK BOLLIG, (940) 205-2761

SHELTER DETAILS



NOTES:

1. SURFACE MOUNT TO SHELTER SLAB

2. SUBMIT COLORS TO MATCH PLAYGROUND EQUIPMENT FOR APPROVAL PRIOR TO ORDERING.

MODEL: 8' RECTANGULAR EXPANDED STEEL ADA TABLE MANUFACTURER: ANOVA CONTACT: LEA PARK & PLAY NICK BOLLIG, (940) 205-2761

PICNIC TABLE



NOTES:

1. SURFACE MOUNT TO 4" CONCRETE SLAB
2. SUBMIT COLORS TO MATCH PLAYGROUND
EQUIPMENT FOR APPROVAL PRIOR TO ORDERING.

SCALE: NOT TO SCALE

NICK BOLLIG, (940) 205-2761

MODEL: 6' LATITUDE CONTOUR BENCH MANUFACTURER: ANOVA CONTACT: LEA PARK & PLAY

National Presence. Local Expertise EVERGREEN DESIGN GROUP 800.680.6630 www.evergreendesigngroup.com

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> MARY N. BATES TEXAS L.A. #3613

ISSUED ON: OCTOBER 04, 2024


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HARDSCAPE DETAILS

Date Comment

Project Number

10/04/24 Drawn By Checked By



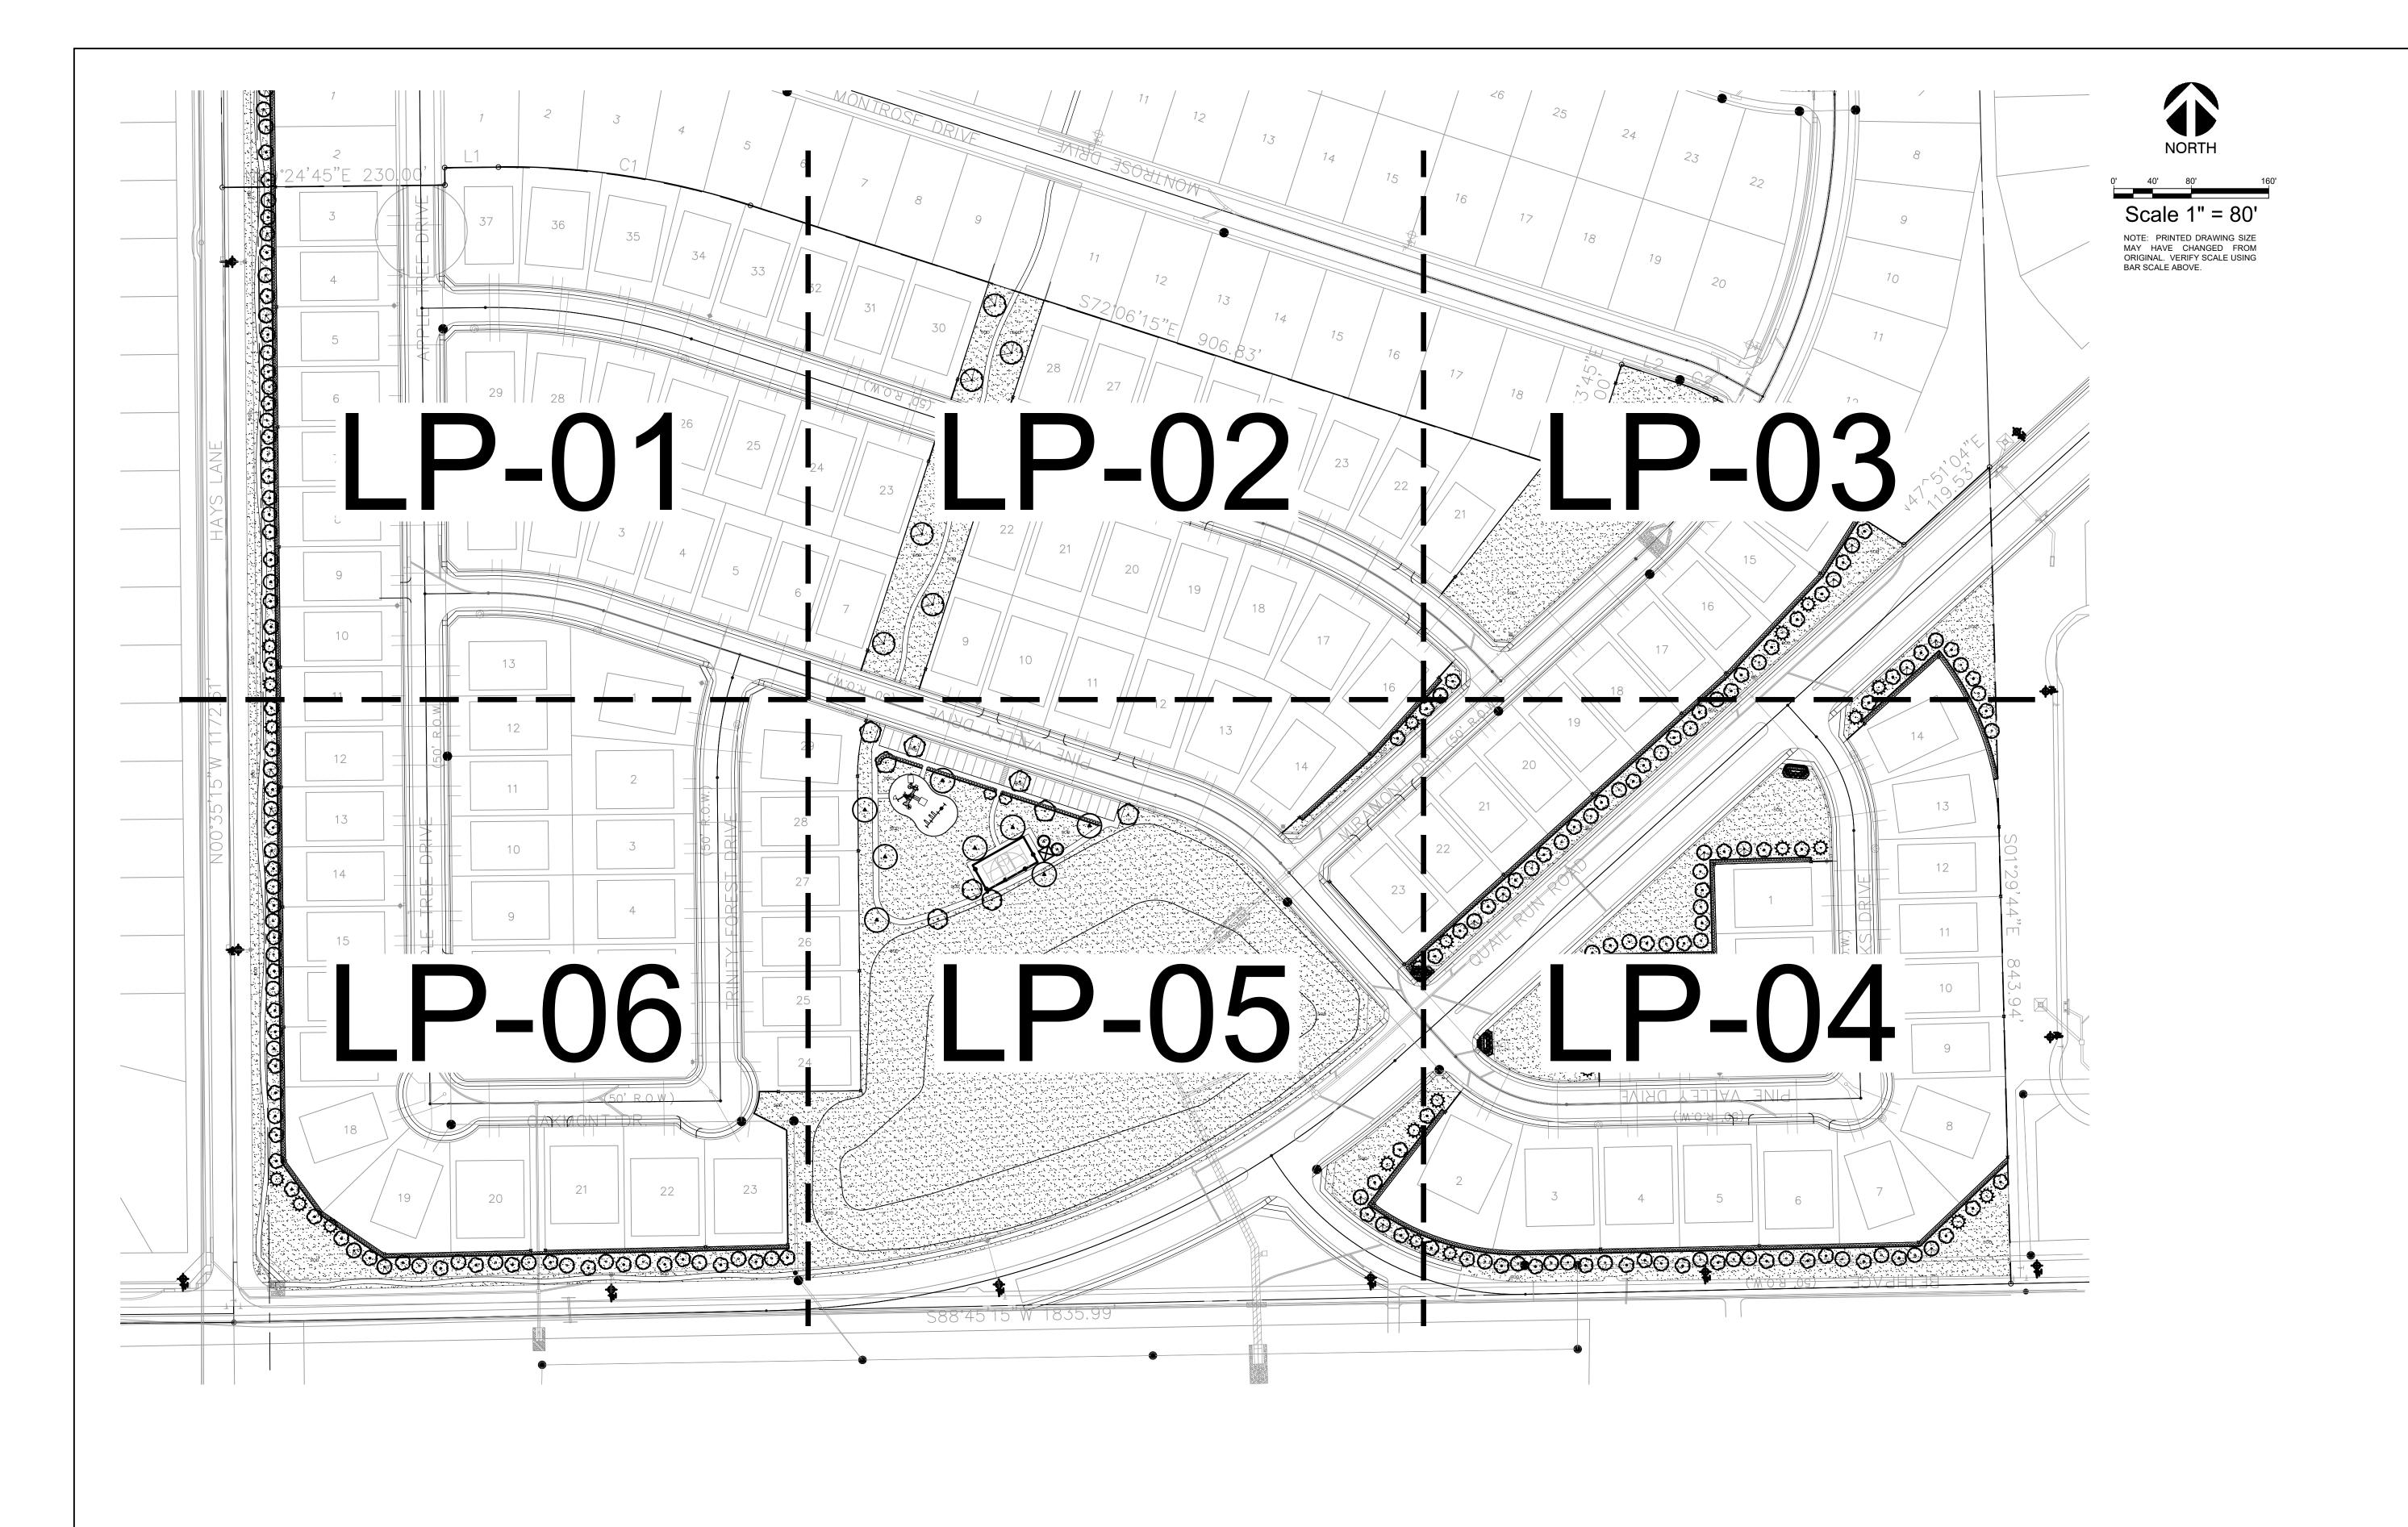

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MARY N. BATES TEXAS L.A. #3613 ISSUED ON: OCTOBER 04, 2024


mpal ,e, Suite 9 CO r Drive Skorburg (8214 Westchester | Dallas, Texas 75225

Quail Hollow Rockwall, TX

OVERALL HARDSCAPE PLAN

Date Comment

10/04/24 Drawn By

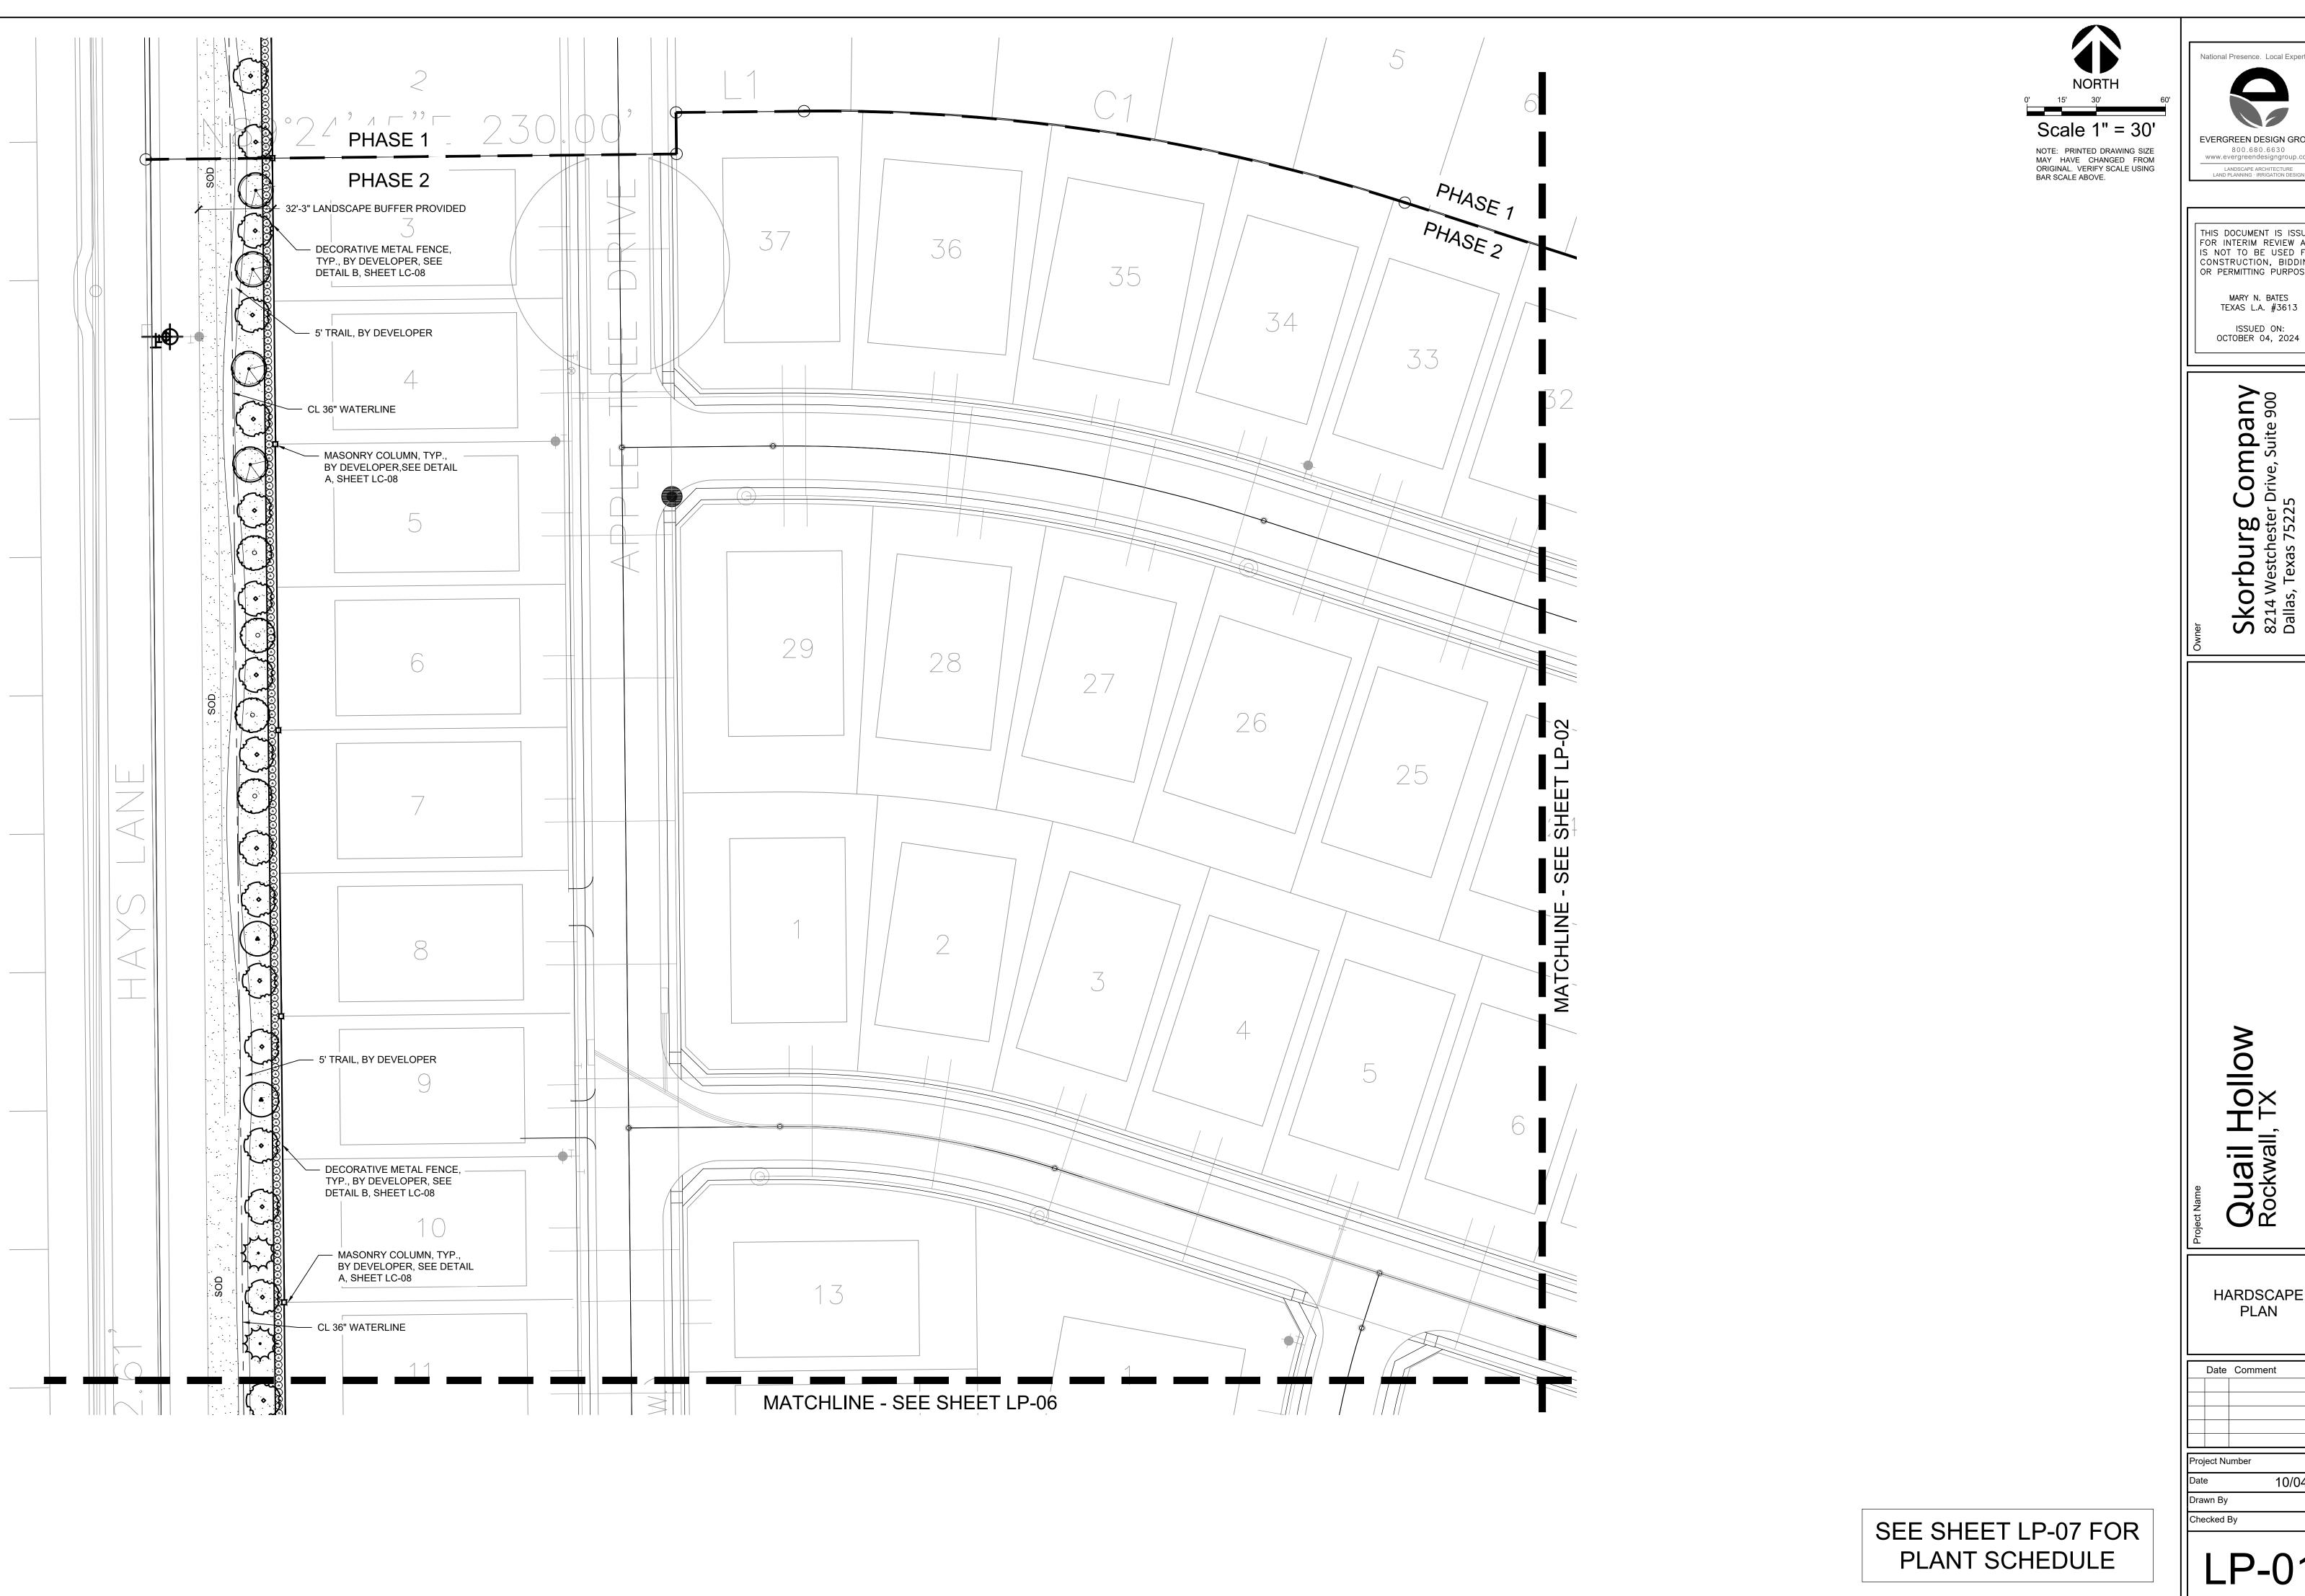

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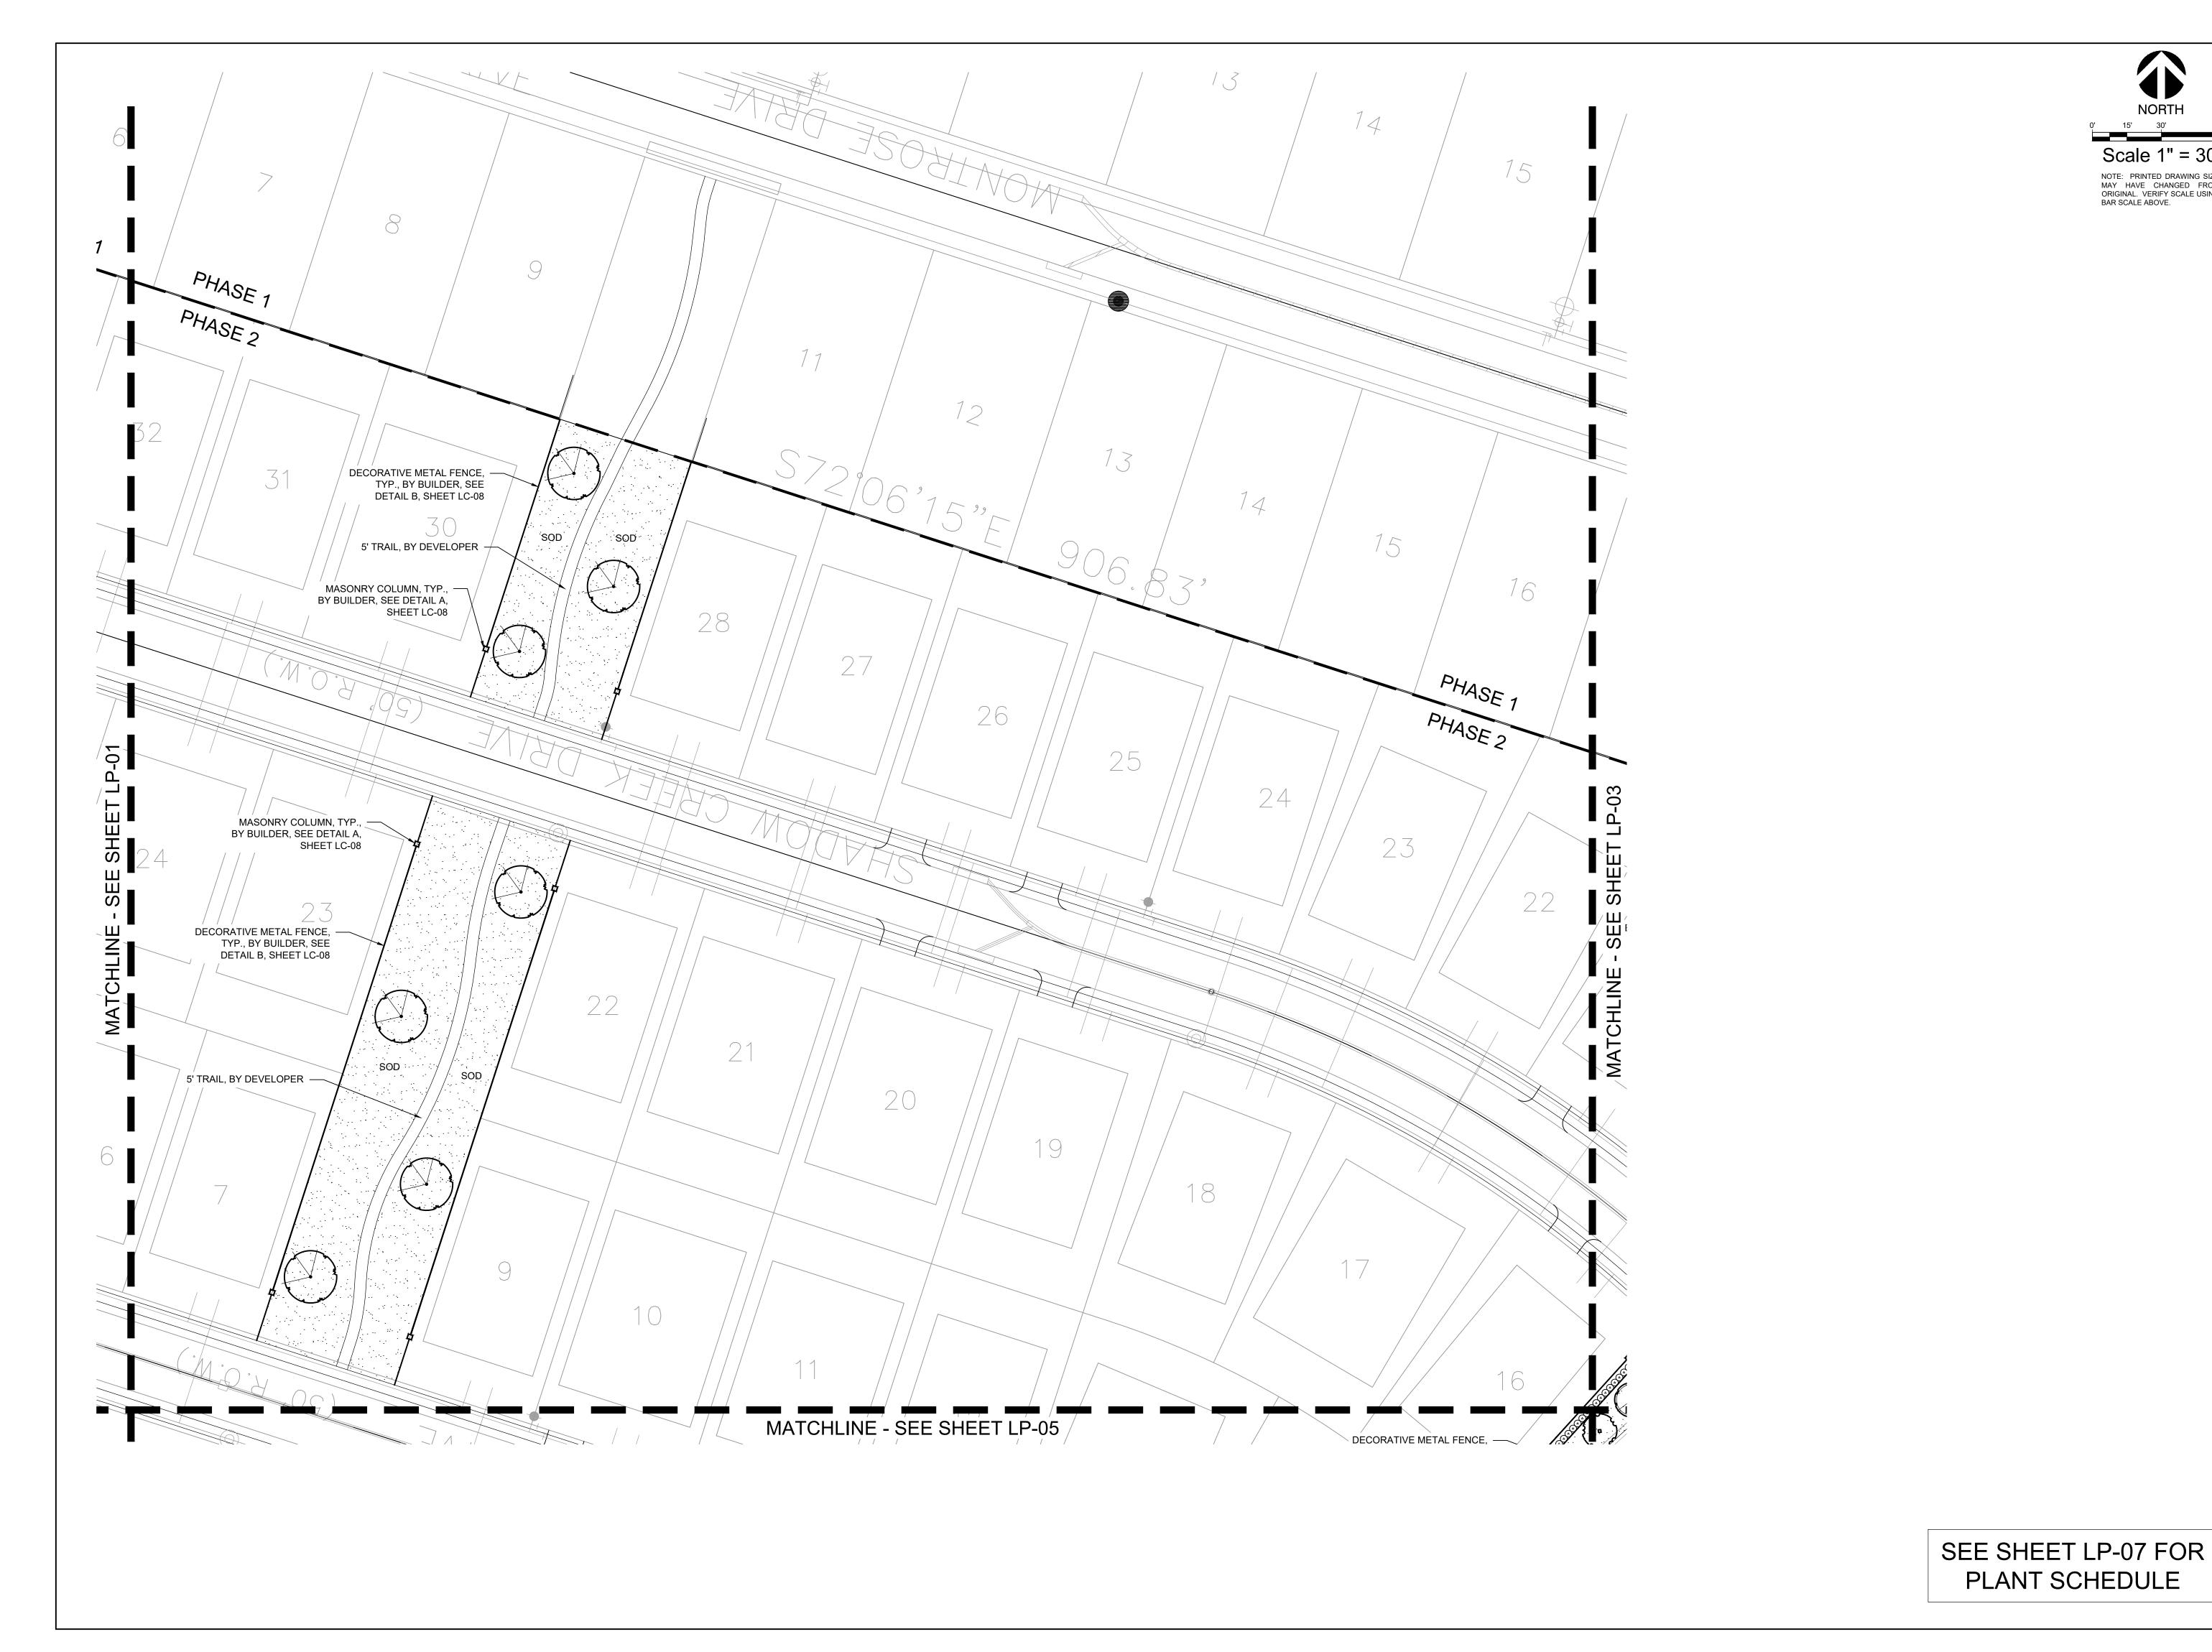
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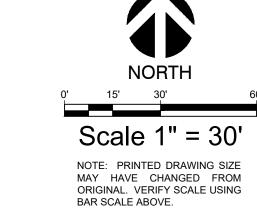
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Quail Hollow Rockwall, TX

HARDSCAPE PLAN

Date Comment








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HARDSCAPE PLAN

Date Comment



Scale 1" = 30' NOTE: PRINTED DRAWING SIZE MAY HAVE CHANGED FROM ORIGINAL. VERIFY SCALE USING BAR SCALE ABOVE.

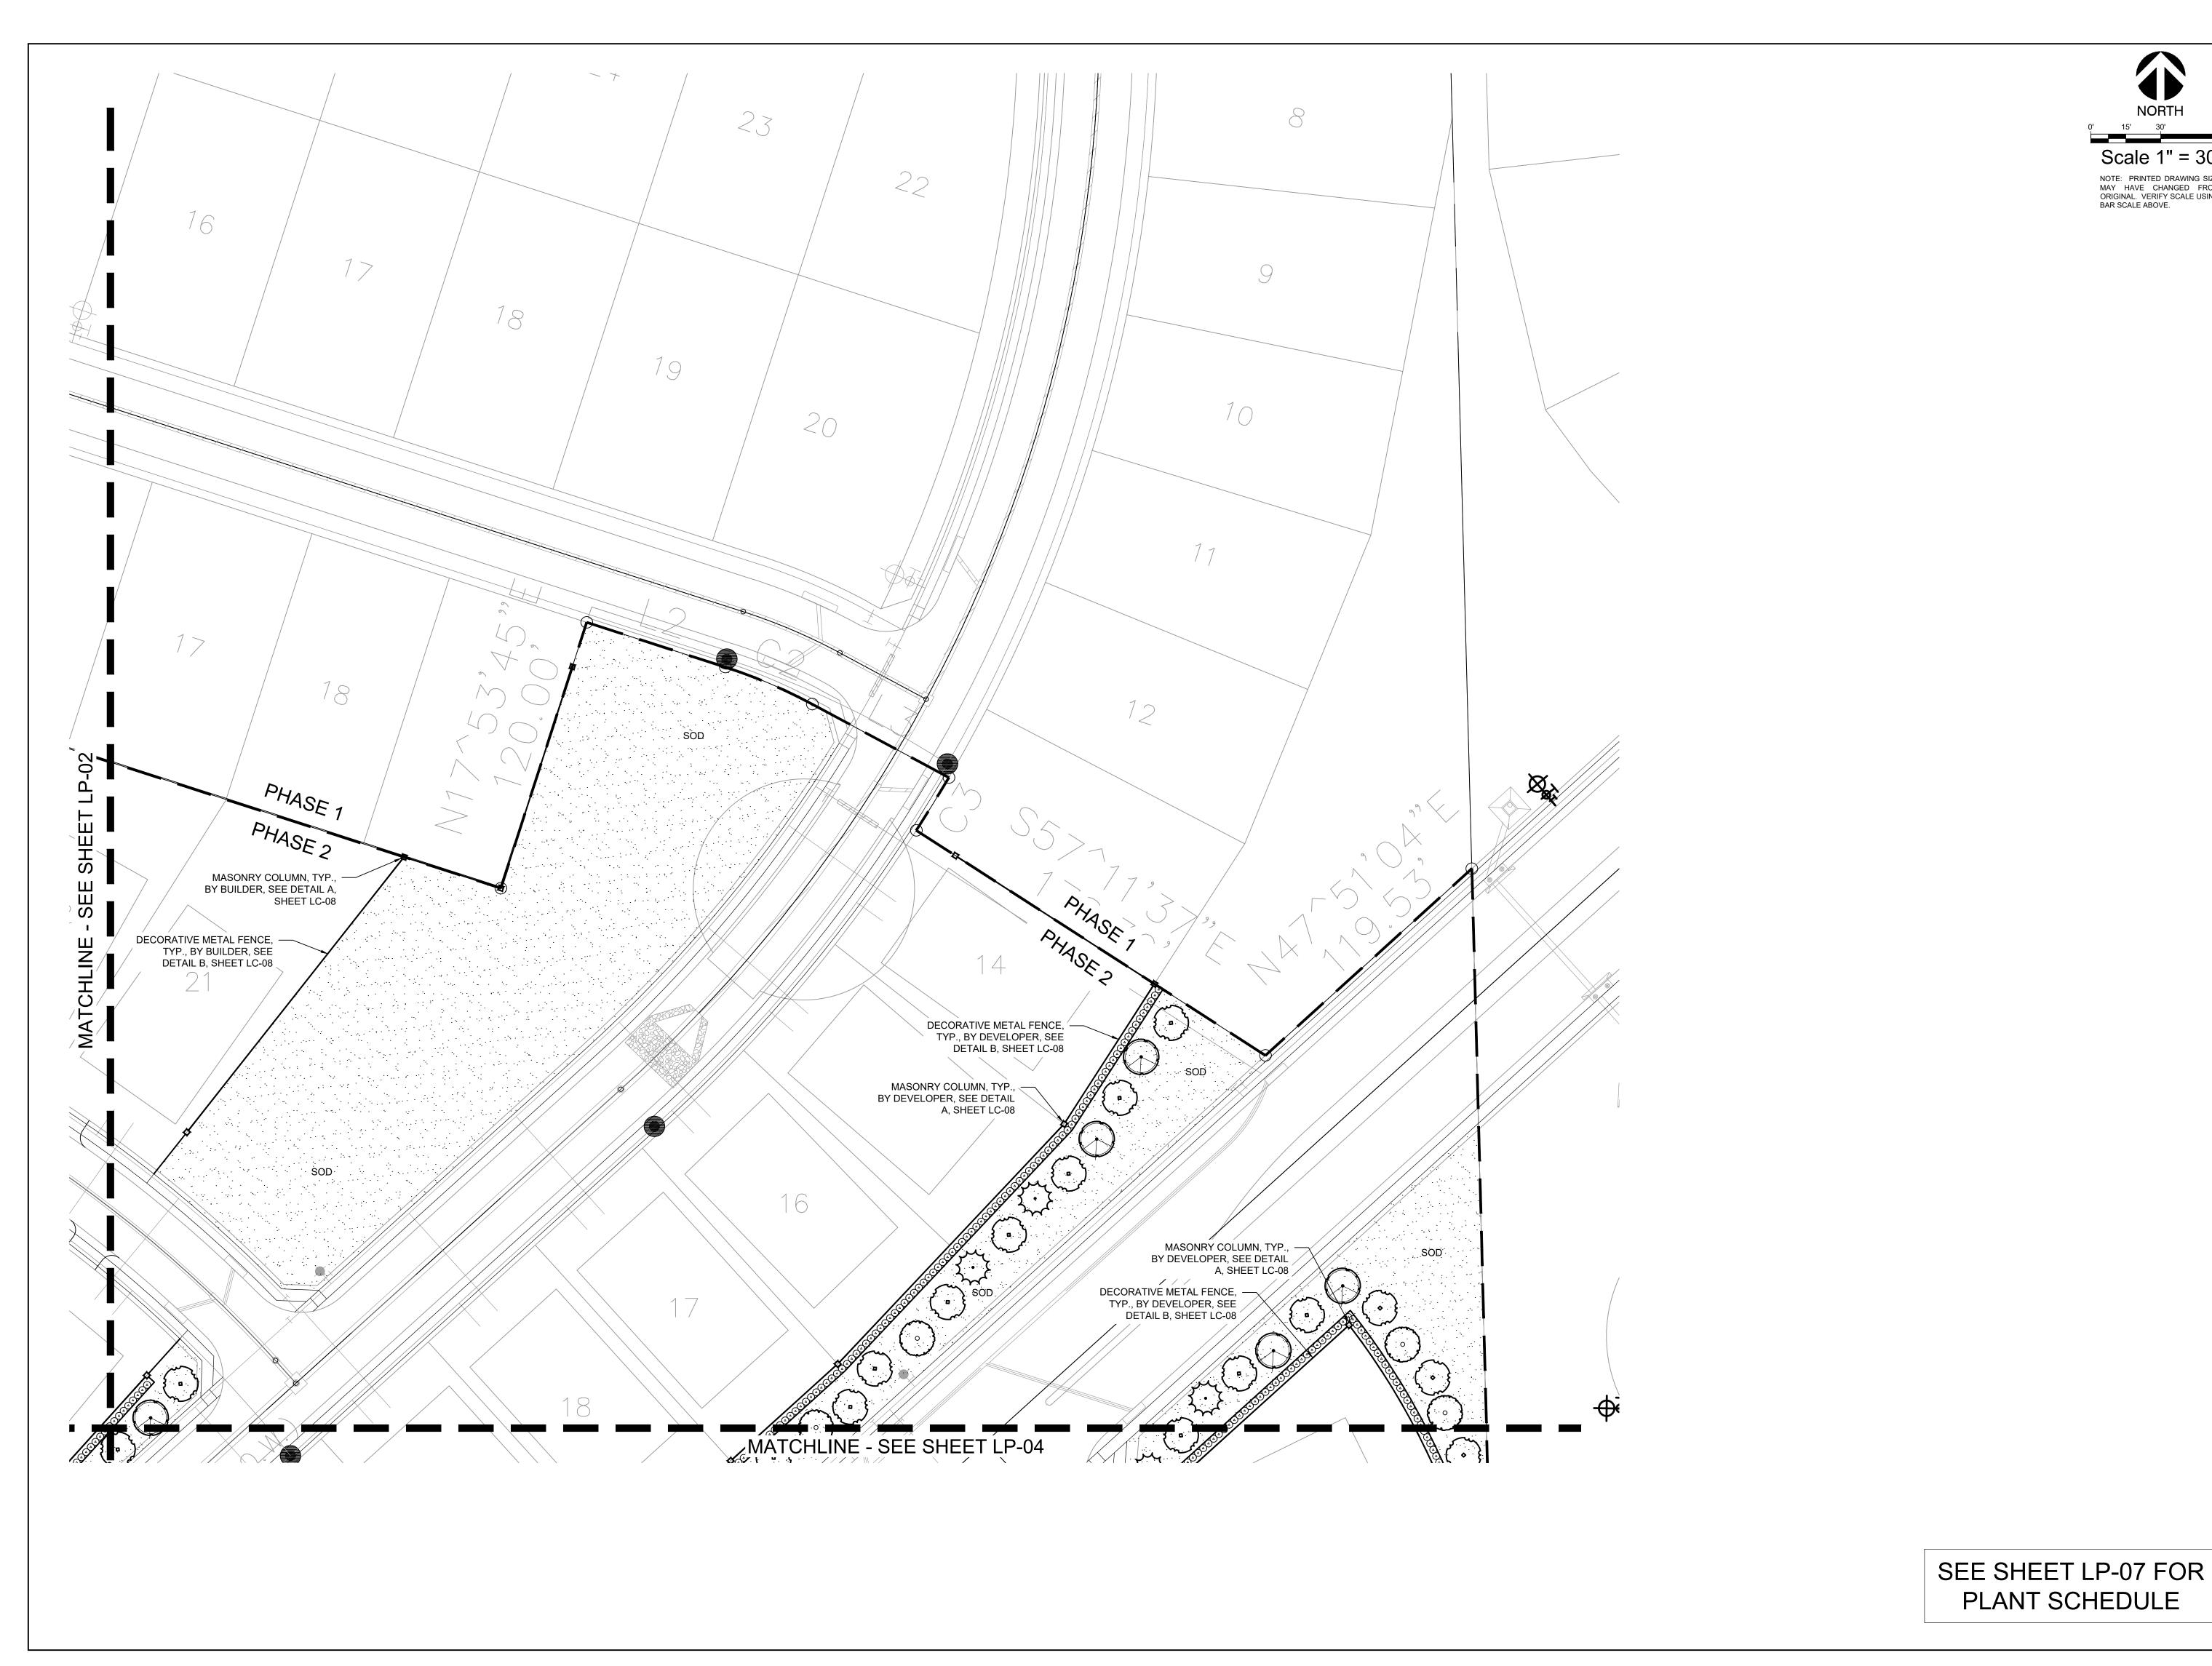


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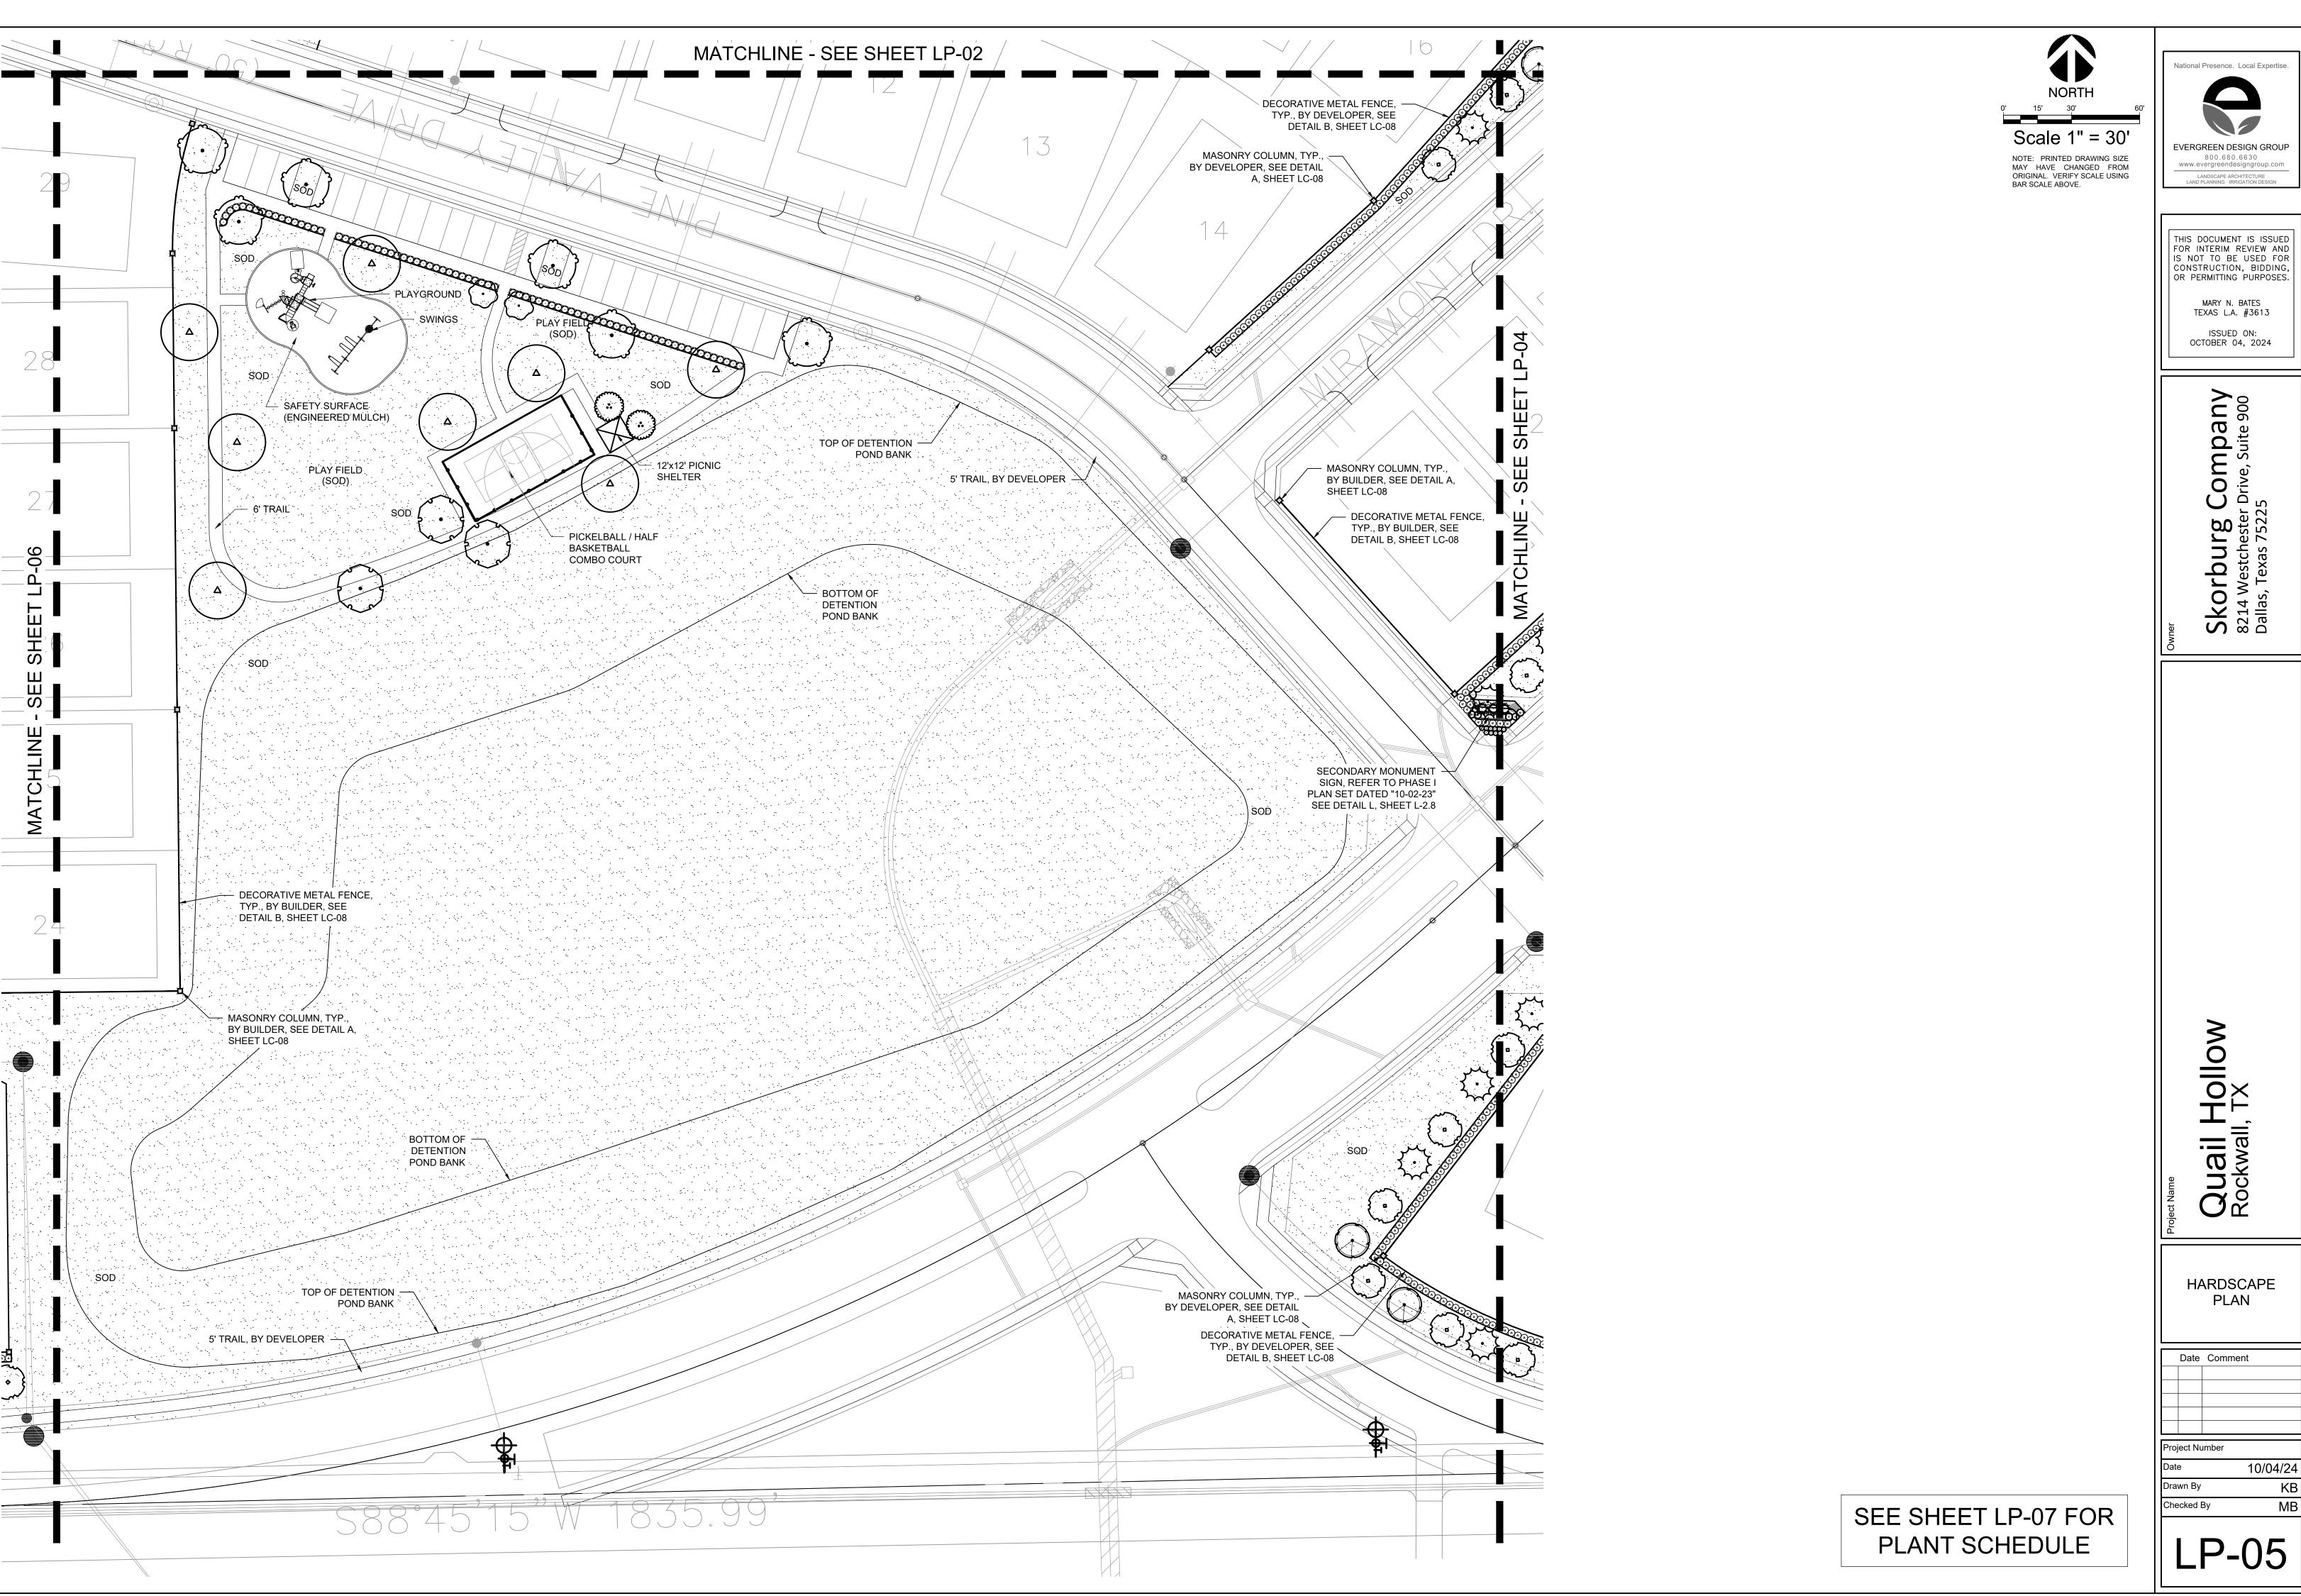
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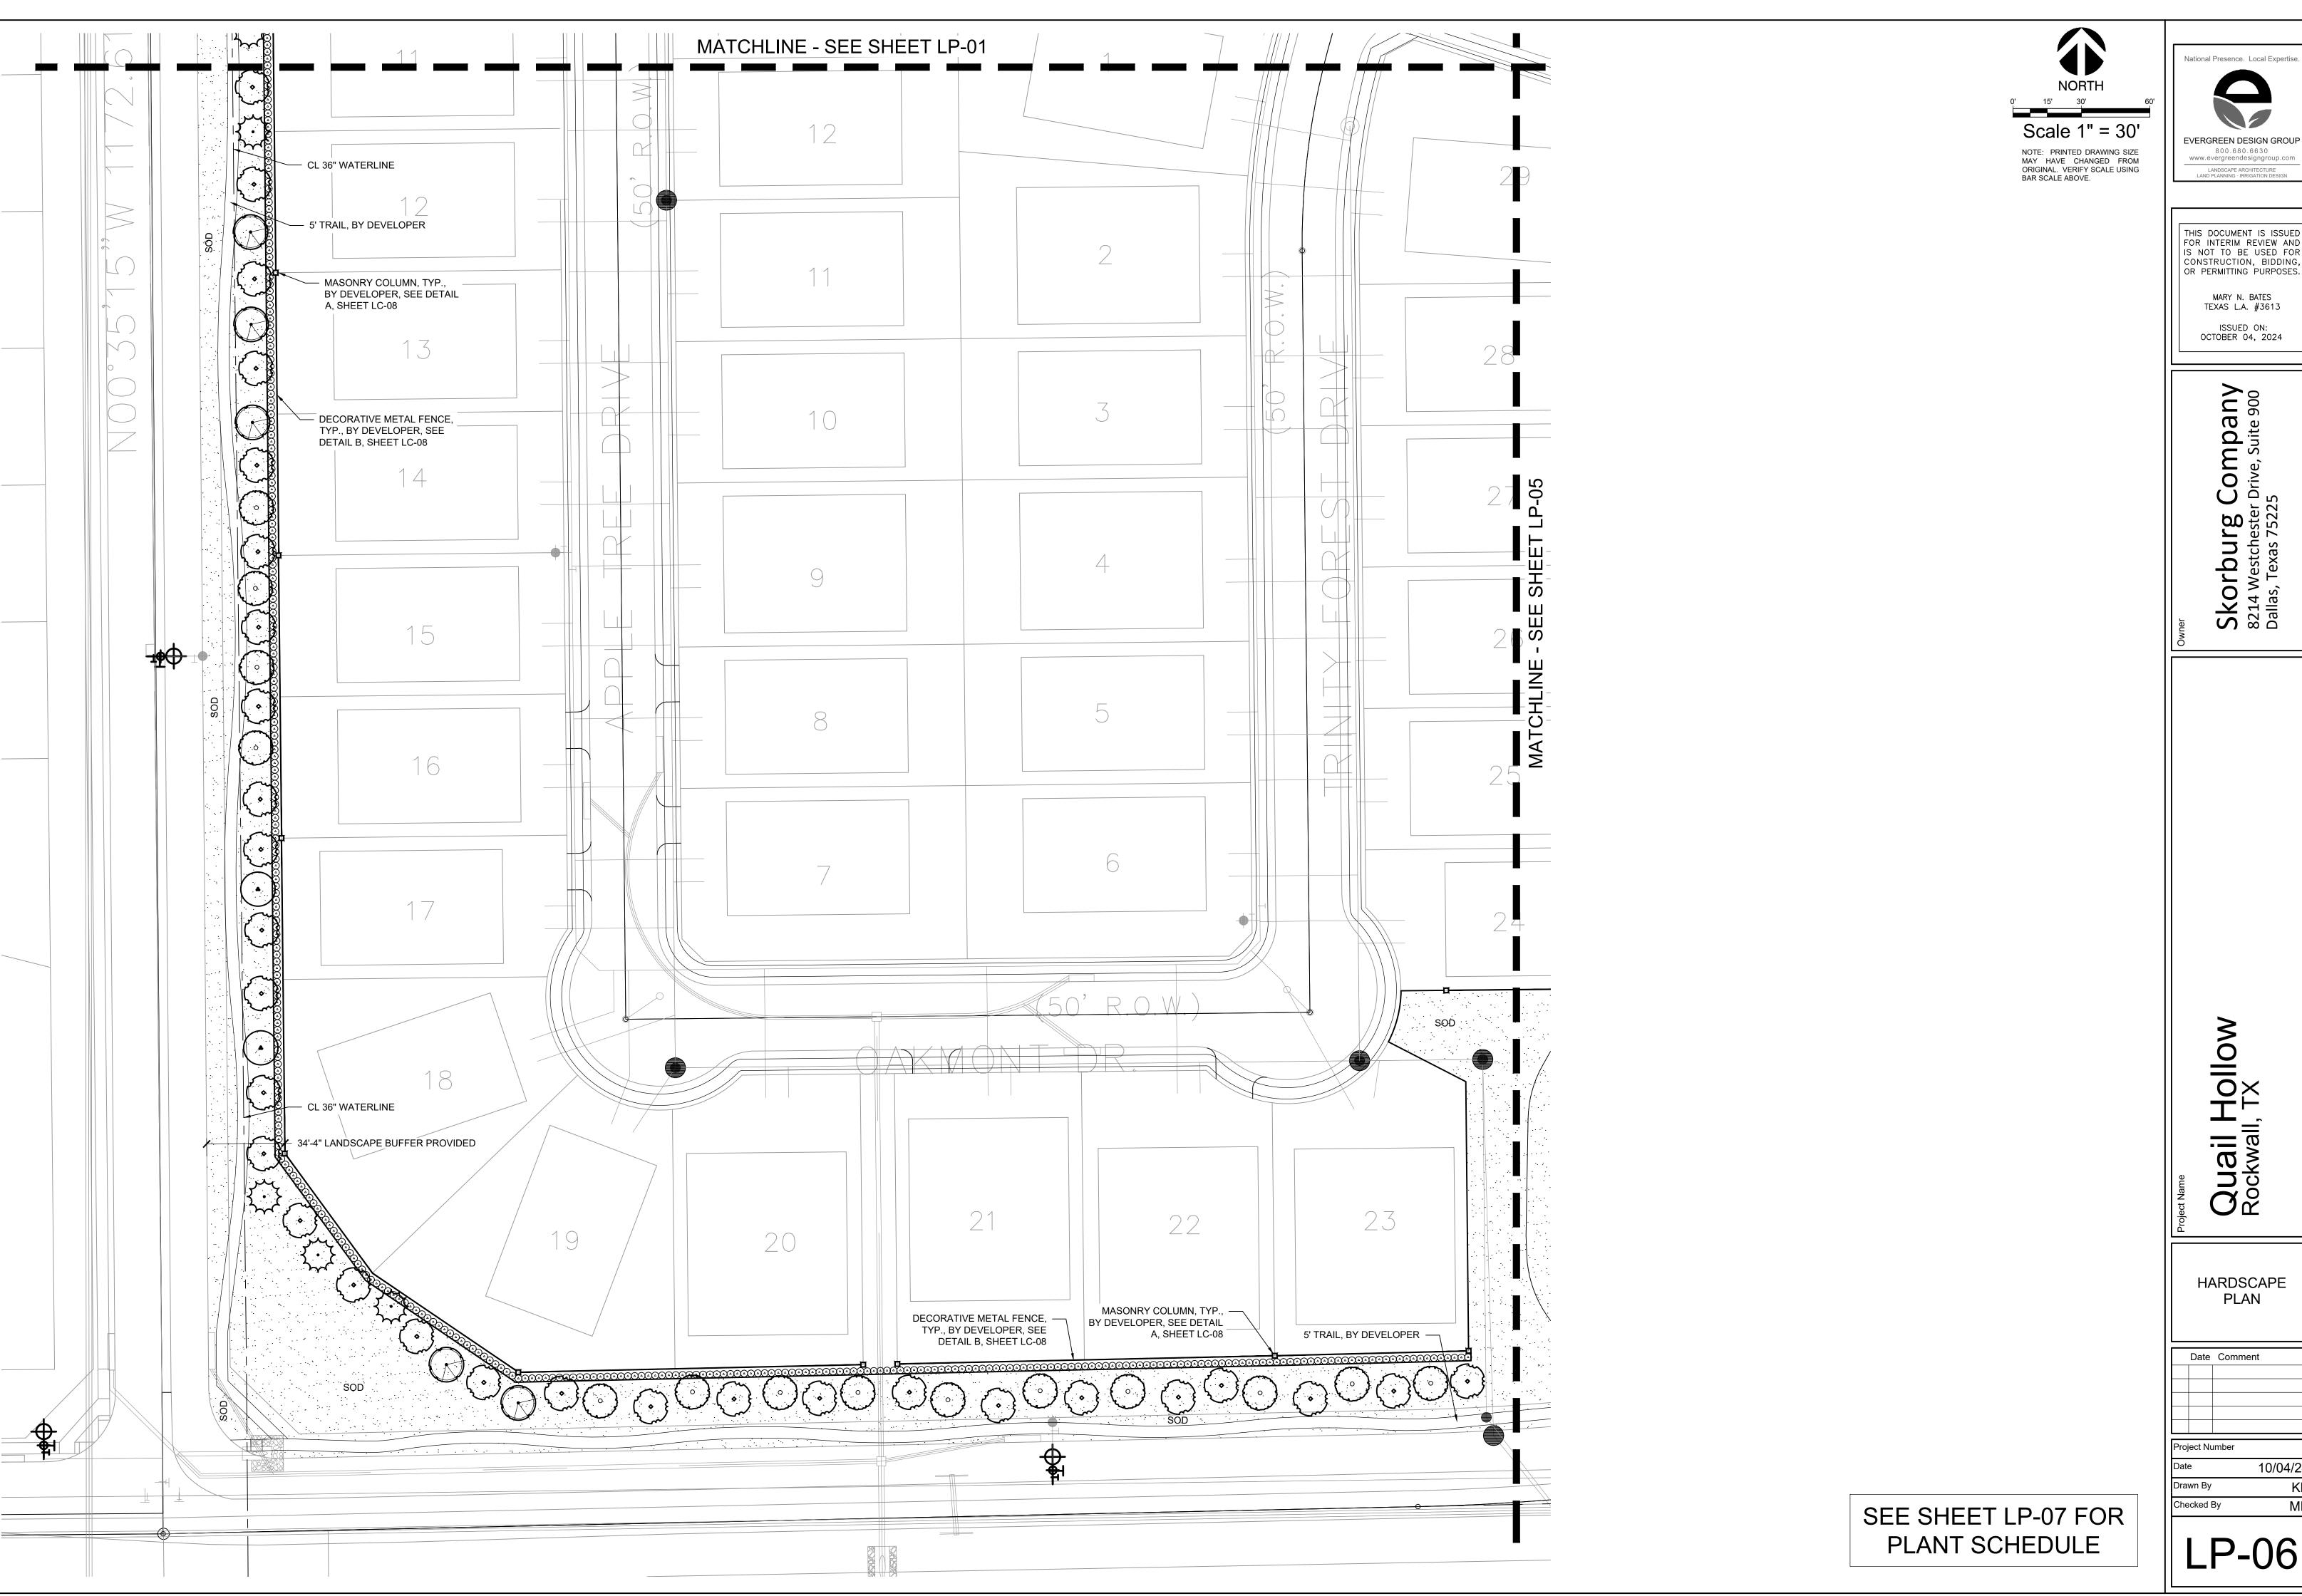
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HARDSCAPE PLAN

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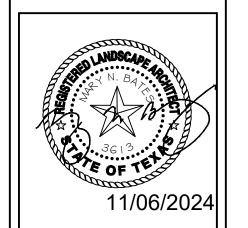
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ANT SCHEDULE								
EES	CODE	QUANTITY	COMMON NAME	BOTANICAL NAME	CONTAINER	CALIPER	SIZE	NOTES
₹·}	CL	24	DESERT WILLOW	CHILOPSIS LINEARIS	CONT OR B & B	4"		FULL, MATCHING, SYMMETRICAL
	ID	23	POSSUMHAW HOLLY	ILEX DECIDUA	CONT OR B & B	4"		FULL, MATCHING, SYMMETRICAL
\odot	IV	47	YAUPON HOLLY	ILEX VOMITORIA	CONT OR B & B	4"		FULL, MATCHING, SYMMETRICAL
	MG	104	DWARF SOUTHERN MAGNOLIA	MAGNOLIA GRANDIFLORA 'LITTLE GEM'	CONT OR B & B	4"		FULL, MATCHING, SYMMETRICAL
	QS	3	SHUMARD OAK	QUERCUS SHUMARDII	CONT OR B & B	4"		FULL, MATCHING, SYMMETRICAL
\odot	QV	8	SOUTHERN LIVE OAK	QUERCUS VIRGINIANA	CONT OR B & B	4"		FULL, MATCHING, SYMMETRICAL
\bigcirc	UC	6	CEDAR ELM	ULMUS CRASSIFOLIA	CONT OR B & B	4"		FULL, MATCHING, SYMMETRICAL
•	US	4	MEXICAN BUCKEYE	UNGNADIA SPECIOSA	CONT OR B & B	4"		FULL, MATCHING, SYMMETRICAL
NAMENTAL TREES	CODE	QUANITITY	COMMON NAME	BOTANICAL NAME	CONTAINER	SIZE	SIZE	NOTES
\odot	CL	2	DESERT WILLOW	CHILOPSIS LINEARIS	CONT OR B & B		4' HT MIN	FULL, MATCHING, SYMMETRICAL
	LI	2	CRAPE MYRTLE	LAGERSTROEMIA INDICA	CONT OR B & B		4' HT MIN	FULL, MATCHING, SYMMETRICAL
RUBS	CODE	QUANITITY	COMMON NAME	BOTANICAL NAME	CONTAINER	SIZE	SPACING	NOTES
	cs	9	PAPAS GRASS	CORTAGERIA SELLOANA	5 GAL.	24" HT.	36" O.C.	FULL, MATCHING, SYMMETRICAL
0	DX	78	DWARF WAX MYRTLE	MYRICA PUSILLA	5 GAL.		36" O.C.	FULL, MATCHING, SYMMETRICAL
0	IC	1345	DWARF BUFORD HOLLY	ILEX CORNUTA 'DWARF BURFORD'	5 GAL.	24" HT.	36" O.C.	FULL, MATCHING, SYMMETRICAL
	MC	18	PINK MUHLY	MUHLENBERGIA CAPILLARIS	5 GAL.	24" HT.	36" O.C.	FULL, MATCHING, SYMMETRICAL
\odot	SG	36	AUTUMN SAGE	SALVIA GREGGII	1 GAL.	12" HT.	24" O.C.	FULL, MATCHING, SYMMETRICAL
)	CODE	QUANITITY	COMMON NAME	BOTANICAL NAME	CONTAINER	SIZE	SPACING	NOTES
SON	SOD	387,179 SF	CYNODON DACTYLON 'TIF 419'	TIF 419 BERMUDAGRASS		SOLID SOD		





Skorburg Company 8214 Westchester Drive, Suite 900 Dallas, Texas 75225

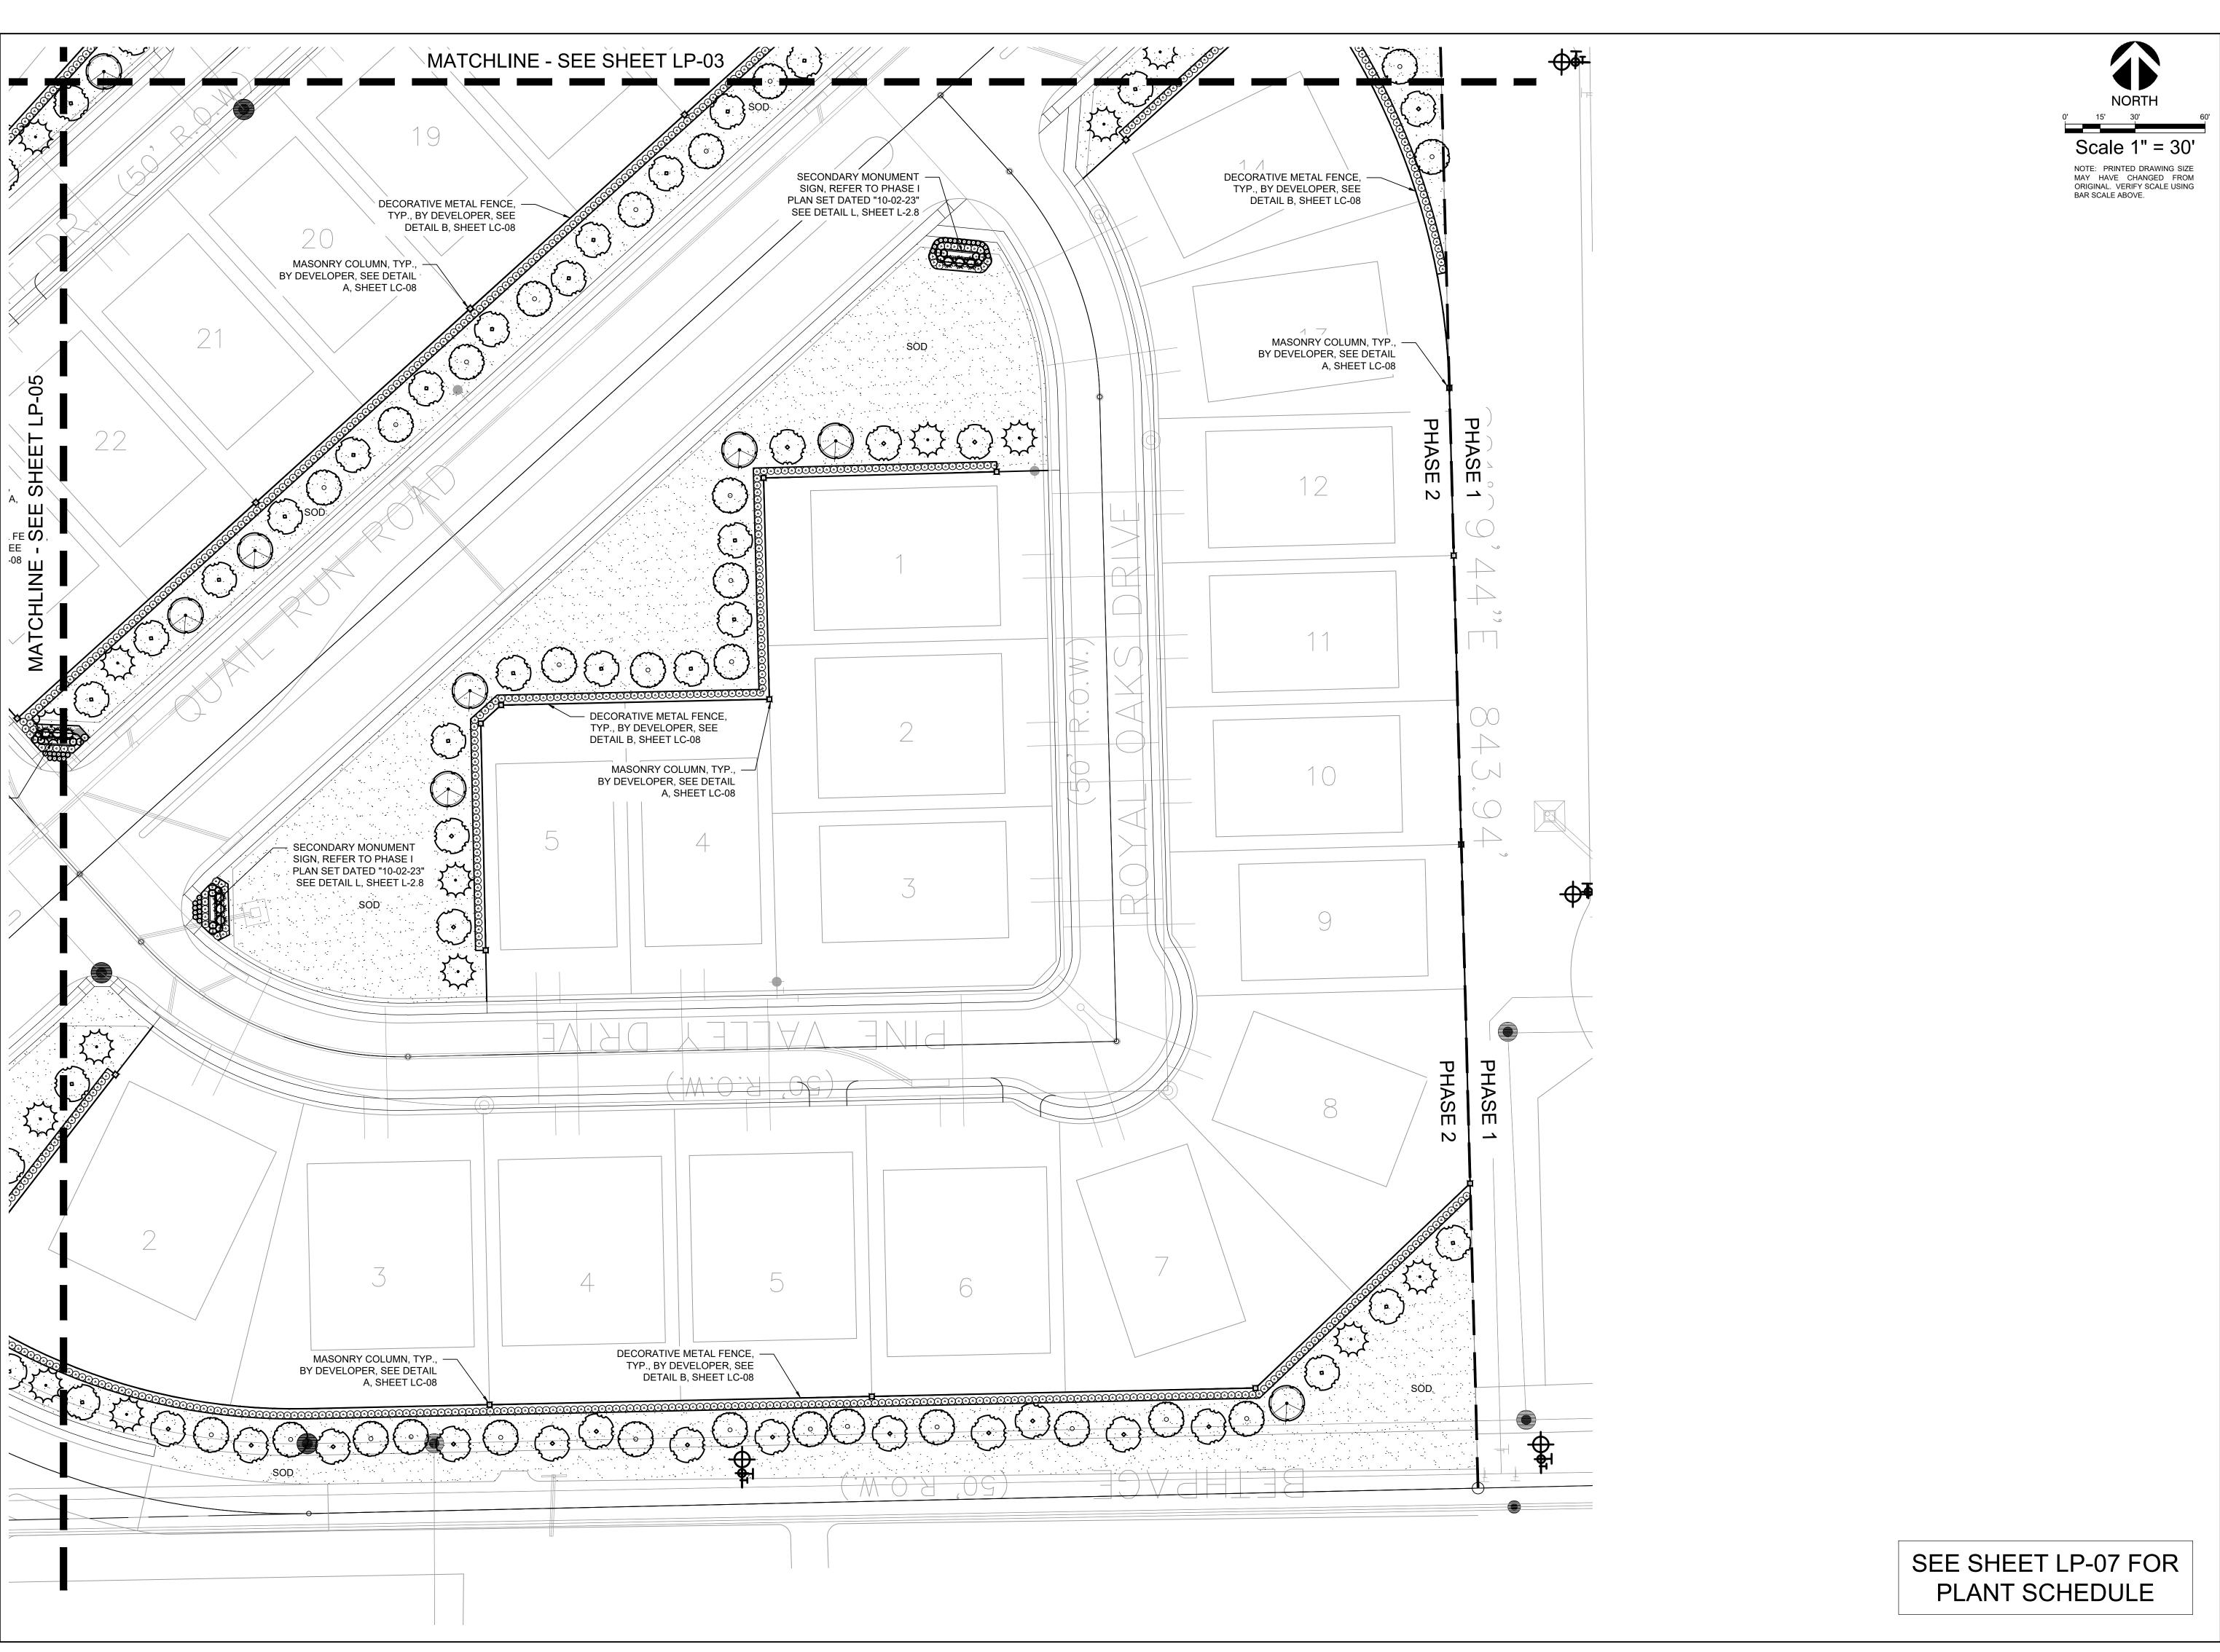Quail Hollow Rockwall, TX

> HARDSCAPE PLAN

Date Comment

Project Number

 Date
 10/04/24

 Drawn By
 KB

 Checked By
 MB

I P-07

PLANTING SPECIFICATIONS

GENERAL

- A. QUALIFICATIONS OF LANDSCAPE CONTRACTOR ALL LANDSCAPE WORK SHOWN ON THESE PLANS SHALL BE PERFORMED BY A SINGLE FIRM
- SPECIALIZING IN LANDSCAPE PLANTING. A LIST OF SUCCESSFULLY COMPLETED PROJECTS OF THIS TYPE, SIZE AND NATURE MAY BE REQUESTED BY THE OWNER FOR FURTHER QUALIFICATION MEASURES.
- THE LANDSCAPE CONTRACTOR SHALL HOLD A VALID NURSERY AND FLORAL CERTIFICATE ISSUED BY THE TEXAS DEPARTMENT OF AGRICULTURE, AS WELL AS OPERATE UNDER A COMMERCIAL PESTICIDE APPLICATOR LICENSE ISSUED BY EITHER THE TEXAS DEPARTMENT OF AGRICULTURE OR THE TEXAS STRUCTURAL PEST CONTROL BOARD.
- WORK COVERED BY THESE SECTIONS INCLUDES THE FURNISHING AND PAYMENT OF ALL MATERIALS, LABOR SERVICES FOUIPMENT LICENSES TAXES AND ANY OTHER ITEMS THAT ARE NECESSARY FOR THE EXECUTION, INSTALLATION AND COMPLETION OF ALL WORK, SPECIFIED HEREIN AND / OR SHOWN
- ON THE LANDSCAPE PLANS, NOTES, AND DETAILS. ALL WORK SHALL BE PERFORMED IN ACCORDANCE WITH ALL APPLICABLE LAWS, CODES AND REGULATIONS REQUIRED BY AUTHORITIES HAVING JURISDICTION OVER SUCH WORK, INCLUDING ALL INSPECTIONS AND PERMITS REQUIRED BY FEDERAL, STATE AND LOCAL AUTHORITIES IN SUPPLY, TRANSPORTATION AND INSTALLATION OF MATERIALS.
- THE LANDSCAPE CONTRACTOR SHALL VERIFY THE LOCATION OF ALL UNDERGROUND UTILITY LINES (WATER, SEWER, ELECTRICAL, TELEPHONE, GAS, CABLE, TELEVISION, ETC.) PRIOR TO THE START OF

PRODUCTS

- ALL MANUFACTURED PRODUCTS SHALL BE NEW. CONTAINER AND BALLED-AND-BURLAPPED PLANTS
- FURNISH NURSERY-GROWN PLANTS COMPLYING WITH ANSI Z60.1-2014. PROVIDE WELL-SHAPED, FULLY BRANCHED, HEALTHY, VIGOROUS STOCK FREE OF DISEASE, INSECTS, EGGS, LARVAE, AND DEFECTS SUCH AS KNOTS, SUN SCALD, INJURIES, ABRASIONS, AND DISFIGUREMENT. ALL PLANTS WITHIN A SPECIES SHALL HAVE SIMILAR SIZE, AND SHALL BE OF A FORM TYPICAL FOR THE SPECIES. ALL TREES SHALL BE OBTAINED FROM SOURCES WITHIN 200 MILES OF THE PROJECT SITE, AND WITH SIMILAR
- CLIMACTIC CONDITIONS. ROOT SYSTEMS SHALL BE HEALTHY, DENSELY BRANCHED ROOT SYSTEMS, NON-POT-BOUND, FREE FROM ENCIRCLING AND/OR GIRDLING ROOTS, AND FREE FROM ANY OTHER ROOT DEFECTS (SUCH AS
- TREES MAY BE PLANTED FROM CONTAINERS OR BALLED-AND-BURLAPPED (B&B), UNLESS SPECIFIED ON THE PLANTING LEGEND. BARE-ROOT TREES ARE NOT ACCEPTABLE. ANY PLANT DEEMED UNACCEPTABLE BY THE LANDSCAPE ARCHITECT OR OWNER SHALL BE IMMEDIATELY REMOVED FROM THE SITE AND SHALL BE REPLACED WITH AN ACCEPTBLE PLANT OF LIKE
- TYPE AND SIZE AT THE CONTRACTOR'S OWN EXPENSE. ANY PLANTS APPEARING TO BE UNHEALTHY EVEN IF DETERMINED TO STILL BE ALIVE. SHALL NOT BE ACCEPTED. THE LANDSCAPE ARCHITECT AND OWNER SHALL BE THE SOLE JUDGES AS TO THE ACCEPTABILITY OF PLANT MATERIAL
- 5. ALL TREES SHALL BE STANDARD IN FORM, UNLESS OTHERWISE SPECIFIED. TREES WITH CENTRAL LEADERS WILL NOT BE ACCEPTED IF LEADER IS DAMAGED OR REMOVED. PRUNE ALL DAMAGED TWIGS
- CALIPER MEASUREMENTS FOR STANDARD (SINGLE TRUNK) TREES SHALL BE AS FOLLOWS: SIX INCHES ABOVE THE ROOT FLARE FOR TREES UP TO AND INCLUDING FOUR INCHES IN CALIPER, AND TWELVE INCHES ABOVE THE ROOT FLARE FOR TREES EXCEEDING FOUR INCHES IN CALIPER. MULTI-TRUNK TREES SHALL BE MEASURED BY THEIR OVERALL HEIGHT, MEASURED FROM THE TOP OF THE ROOT BALL. WHERE CALIPER MEASUREMENTS ARE USED, THE CALIPER SHALL BE CALCULATED
- AS ONE-HALF OF THE SUM OF THE CALIPER OF THE THREE LARGEST TRUNKS. ANY TREE OR SHRUB SHOWN TO HAVE EXCESS SOIL PLACED ON TOP OF THE ROOT BALL, SO THAT THE ROOT FLARE HAS BEEN COMPLETELY COVERED, SHALL BE REJECTED. SOD: PROVIDE WELL-ROOTED SOD OF THE VARIETY NOTED ON THE PLANS. SOD SHALL BE CUT FROM
- HEALTHY, MATURE TURF WITH SOIL THICKNESS OF 3/4" TO 1". EACH PALLET OF SOD SHALL BE ACCOMPANIED BY A CERTIFICATE FROM SUPPLIER STATING THE COMPOSITION OF THE SOD.
- SEED: PROVIDE BLEND OF SPECIES AND VARIETIES AS NOTED ON THE PLANS, WITH MAXIMUM PERCENTAGES OF PURITY, GERMINATION, AND MINIMUM PERCENTAGE OF WEED SEED AS INDICATED ON PLANS. EACH BAG OF SEED SHALL BE ACCOMPANIED BY A TAG FROM THE SUPPLIER INDICATING THE
- TOPSOIL: SANDY TO CLAY LOAM TOPSOIL, FREE OF STONES LARGER THAN ½ INCH, FOREIGN MATTER, PLANTS, ROOTS, AND SEEDS.
- COMPOST: WELL-COMPOSTED, STABLE, AND WEED-FREE ORGANIC MATTER, pH RANGE OF 5.5 TO 8; MOISTURE CONTENT 35 TO 55 PERCENT BY WEIGHT; 100 PERCENT PASSING THROUGH 3/4-INCH SIEVE; SOLUBLE SALT CONTENT OF 5 TO 10 DECISIEMENS/M; NOT EXCEEDING 0.5 PERCENT INERT CONTAMINANTS AND FREE OF SUBSTANCES TOXIC TO PLANTINGS. NO MANURE OR ANIMAL-BASED PRODUCTS SHALL BE
- G. FERTILIZER: GRANULAR FERTILIZER CONSISTING OF NITROGEN, PHOSPHORUS, POTASSIUM, AND OTHER NUTRIENTS IN PROPORTIONS, AMOUNTS, AND RELEASE RATES RECOMMENDED IN A SOIL REPORT FROM A
- QUALIFIED SOIL-TESTING AGENCY (SEE BELOW). H. MULCH: SIZE AND TYPE AS INDICATED ON PLANS, FREE FROM DELETERIOUS MATERIALS AND SUITABLE AS A TOP DRESSING OF TREES AND SHRUBS. TREE STAKING AND GLIVING
- STAKES: 6' LONG GREEN METAL T-POSTS. GUY AND TIE WIRE: ASTM A 641, CLASS 1, GALVANIZED-STEEL WIRE, 2-STRAND, TWISTED, 0.106 INCH
- STRAP CHAFING GUARD: REINFORCED NYLON OR CANVAS AT LEAST 1-1/2 INCH WIDE, WITH GROMMETS TO PROTECT TREE TRUNKS FROM DAMAGE STEEL EDGING: PROFESSIONAL STEEL EDGING. 14 GAUGE THICK X 4 INCHES WIDE. FACTORY PAINTED DARK
- GREEN. ACCEPTABLE MANUFACTURERS INCLUDE COL-MET OR APPROVED EQUAL. M. PRE-EMERGENT HERBICIDES: ANY GRANULAR, NON-STAINING PRE-EMERGENT HERBICIDE THAT IS LABELED FOR THE SPECIFIC ORNAMENTALS OR TURF ON WHICH IT WILL BE UTILIZED. PRE-EMERGENT HERBICIDES SHALL BE APPLIED PER THE MANUFACTURER'S LABELED RATES.

METHODS

- A. SOIL PREPARATION BEFORE STARTING WORK, THE LANDSCAPE CONTRACTOR SHALL VERIFY THAT THE GRADE OF ALL LANDSCAPE AREAS ARE WITHIN +/-0.1' OF FINISH GRADE. THE CONTRACTOR SHALL NOTIFY THE
 - OWNER IMMEDIATELY SHOULD ANY DISCREPANCIES EXIST. a. AFTER FINISH GRADES HAVE BEEN ESTABLISHED, CONTRACTOR SHALL HAVE SOIL SAMPLES
 - FROM THE PROJECT'S LANDSCAPE AREAS TESTED BY AN ESTABLISHED SOIL TESTING LABORATORY. EACH SAMPLE SUBMITTED TO THE LAB SHALL CONTAIN NO LESS THAN ONE QUART OF SOIL, TAKEN FROM BETWEEN THE SOIL SURFACE AND 6" DEPTH. IF NO SAMPLE LOCATIONS ARE INDICATED ON THE PLANS, THE CONTRACTOR SHALL TAKE A MINIMUM OF THREE SAMPLES FROM VARIOUS REPRESENTATIVE LOCATIONS FOR TESTING.
 - THE CONTRACTOR SHALL HAVE THE SOIL TESTING LABORATORY PROVIDE RESULTS FOR THE FOLLOWING: SOIL TEXTURAL CLASS, GENERAL SOIL FERTILITY, pH, ORGANIC MATTER CONTENT, SALT (CEC), LIME, SODIUM ADSORPTION RATIO (SAR) AND BORON CONTENT. c. THE CONTRACTOR SHALL ALSO SUBMIT THE PROJECT'S PLANT LIST TO THE LABORATORY ALONG
 - WITH THE SOIL SAMPLES. d. THE SOIL REPORT PRODUCED BY THE LABORATORY SHALL CONTAIN RECOMMENDATIONS FOR THE FOLLOWING (AS APPROPRIATE): SEPARATE SOIL PREPARATION AND BACKFILL MIX RECOMMENDATIONS FOR GENERAL ORNAMENTAL PLANTS, XERIC PLANTS, TURE, AND NATIVE SEED. AS WELL AS PRE-PLANT FERTILIZER APPLICATIONS AND RECOMMENDATIONS FOR ANY OTHER SOIL RELATED ISSUES. THE REPORT SHALL ALSO PROVIDE A FERTILIZER PROGRAM FOR THE ESTABLISHMENT PERIOD AND FOR LONG-TERM MAINTENANCE.
- THE CONTRACTOR SHALL INSTALL SOIL AMENDMENTS AND FERTILIZERS PER THE SOILS REPORT RECOMMENDATIONS. ANY CHANGE IN COST DUE TO THE SOIL REPORT RECOMMENDATIONS. EITHER INCREASE OR DECREASE. SHALL BE SUBMITTED TO THE OWNER WITH THE REPORT.
- FOR BIDDING PURPOSES ONLY, THE SOIL PREPARATION SHALL CONSIST OF THE FOLLOWING TURF: INCORPORATE THE FOLLOWING AMENDMENTS INTO THE TOP 8" OF SOIL BY MEANS OF ROTOTILLING AFTER CROSS-RIPPING:
- NITROGEN STABILIZED ORGANIC AMENDMENT 4 CU. YDS. PER 1,000 S.F. PREPLANT TURF FERTILIZER (10-20-10 OR SIMILAR, SLOW RELEASE, ORGANIC) - 15 LBS PER 1,000
- iii. "CLAY BUSTER" OR EQUAL USE MANUFACTURER'S RECOMMENDED RATE TREES, SHRUBS, AND PERENNIALS: INCORPORATE THE FOLLOWING AMENDMENTS INTO THE TOP 8" OF SOIL BY MEANS OF ROTOTILLING AFTER CROSS-RIPPING:
- NITROGEN STABILIZED ORGANIC AMENDMENT 4 CU. YDS. PER 1,000 S.F. 12-12-12 FERTILIZER (OR SIMILAR, ORGANIC, SLOW RELEASE) - 10 LBS. PER CU. YD. "CLAY BUSTER" OR EQUAL - USE MANUFACTURER'S RECOMMENDED RATE
- IRON SULPHATE 2 LBS. PER CU. YD. 5. IN THE CONTEXT OF THESE PLANS, NOTES, AND SPECIFICATIONS, "FINISH GRADE" REFERS TO THE FINAL ELEVATION OF THE SOIL SURFACE (NOT TOP OF MULCH) AS INDICATED ON THE GRADING PLANS. a. BEFORE STARTING WORK, THE LANDSCAPE CONTRACTOR SHALL VERIFY THAT THE ROUGH
- GRADES OF ALL LANDSCAPE AREAS ARE WITHIN +/-0.1' OF FINISH GRADE. SEE SPECIFICATIONS FOR MORE DETAILED INSTRUCTION ON TURF AREA AND PLANTING BED PREPARATION. CONSTRUCT AND MAINTAIN FINISH GRADES AS SHOWN ON GRADING PLANS, AND CONSTRUCT AND MAINTAIN SLOPES AS RECOMMENDED BY THE GEOTECHNICAL REPORT. ALL LANDSCAPE AREAS SHALL HAVE POSITIVE DRAINAGE AWAY FROM STRUCTURES AT THE MINIMUM SLOPE SPECIFIED IN THE REPORT AND ON THE GRADING PLANS, AND AREAS OF POTENTIAL PONDING SHALL BE REGRADED TO BLEND IN WITH THE SURROUNDING GRADES AND ELIMINATE PONDING
- c. THE LANDSCAPE CONTRACTOR SHALL DETERMINE WHETHER OR NOT THE EXPORT OF ANY SOIL WILL BE NEEDED. TAKING INTO ACCOUNT THE ROUGH GRADE PROVIDED. THE AMOUNT OF SOIL AMENDMENTS TO BE ADDED (BASED ON A SOIL TEST, PER SPECIFICATIONS), AND THE FINISH GRADES TO BE ESTABLISHED.
- d. ENSURE THAT THE FINISH GRADE IN SHRUB AREAS IMMEDIATELY ADJACENT TO WALKS AND OTHER WALKING SURFACES, AFTER INSTALLING SOIL AMENDMENTS, IS 3" BELOW THE ADJACENT FINISH SURFACE IN ORDER TO ALLOW FOR PROPER MUI CHIDEPTH. TAPER THE SOIL SURFACE TO MEET FINISH GRADE, AS SPECIFIED ON THE GRADING PLANS, AT APPROXIMATELY 18" AWAY FROM THE WALKS
- e. ENSURE THAT THE FINISH GRADE IN TURF AREAS IMMEDIATELY ADJACENT TO WALKS AND OTHER WALKING SURFACES, AFTER INSTALLING SOIL AMENDMENTS, IS 1" BELOW THE FINISH SURFACE OF THE WALKS. TAPER THE SOIL SURFACE TO MEET FINISH GRADE, AS SPECIFIED ON THE GRADING PLANS, AT APPROXIMATELY 18" AWAY FROM THE WALKS.
- SHOULD ANY CONFLICTS AND/OR DISCREPANCIES ARISE BETWEEN THE GRADING PLANS, GEOTECHNICAL REPORT, THESE NOTES AND PLANS, AND ACTUAL CONDITIONS, THE CONTRACTOR SHALL IMMEDIATELY BRING SUCH ITEMS TO THE ATTENTION OF THE LANDSCAPE
- ARCHITECT, GENERAL CONTRACTOR, AND OWNER. ONCE SOIL PREPARATION IS COMPLETE, THE LANDSCAPE CONTRACTOR SHALL ENSURE THAT THERE ARE NO DEBRIS, TRASH, OR STONES LARGER THAN 1" REMAINING IN THE TOP 6" OF SOIL.

- THE CONTRACTOR SHALL PROVIDE SUBMITTALS AND SAMPLES, IF REQUIRED, TO THE LANDSCAPE ARCHITECT, AND RECEIVE APPROVAL IN WRITING FOR SUCH SUBMITTALS BEFORE WORK COMMENCES. SUBMITTALS SHALL INCLUDE PHOTOS OF PLANTS WITH A RULER OR MEASURING STICK FOR SCALE, PHOTOS OR SAMPLES OF ANY REQUIRED MULCHES, AND SOIL TEST RESULTS AND PREPARATION RECOMMENDATIONS FROM THE TESTING LAB (INCLUDING COMPOST AND FERTILIZER RATES AND TYPES, AND OTHER AMENDMENTS FOR TREE/SHRUB, TURF, AND SEED AREAS AS MAY BE
 - APPROPRIATE). 3. SUBMITTALS SHALL ALSO INCLUDE MANUFACTURER CUT SHEETS FOR PLANTING ACCESSORIES SUCH AS TREE STAKES AND TIES EDGING AND LANDSCAPE FABRICS (IF ANY) WHERE MULTIPLE ITEMS ARE SHOWN ON A PAGE, THE CONTRACTOR SHALL CLEARLY INDICATE THE ITEM BEING CONSIDERED.
- C. GENERAL PLANTING REMOVE ALL NURSERY TAGS AND STAKES FROM PLANTS.
- EXCEPT IN AREAS TO BE PLANTED WITH ORNAMENTAL GRASSES, APPLY PRE-EMERGENT HERBICIDES AT THE MANUFACTURER'S RECOMMENDED RATE. TRENCHING NEAR EXISTING TREES:
- CONTRACTOR SHALL NOT DISTURB ROOTS 1-1/2" AND LARGER IN DIAMETER WITHIN THE CRITICAL ROOT ZONE (CRZ) OF EXISTING TREES, AND SHALL EXERCISE ALL POSSIBLE CARE AND PRECAUTIONS TO AVOID INJURY TO TREE ROOTS, TRUNKS, AND BRANCHES. THE CRZ IS DEFINED AS A CIRCULAR AREA EXTENDING OUTWARD FROM THE TREE TRUNK. WITH A RADIUS EQUAL TO 1' FOR EVERY 1" OF TRUNK DIAMETER-AT-BREAST-HEIGHT (4.5' ABOVE THE AVERAGE
- ALL EXCAVATION WITHIN THE CRZ SHALL BE PERFORMED USING HAND TOOLS. NO MACHINE EXCAVATION OR TRENCHING OF ANY KIND SHALL BE ALLOWED WITHIN THE CRZ.
- ALTER ALIGNMENT OF PIPE TO AVOID TREE ROOTS 1-1/2" AND LARGER IN DIAMETER. WHERE TREE ROOTS 1-1/2" AND LARGER IN DIAMETER ARE ENCOUNTERED IN THE FIELD, TUNNEL UNDER SUCH ROOTS. WRAP EXPOSED ROOTS WITH SEVERAL LAYERS OF BURLAP AND KEEP MOIST.
- CLOSE ALL TRENCHES WITHIN THE CANOPY DRIP LINES WITHIN 24 HOURS. ALL SEVERED ROOTS SHALL BE HAND PRUNED WITH SHARP TOOLS AND ALLOWED TO AIR-DRY. DO NOT USE ANY SORT OF SEALERS OR WOUND PAINTS.
- TREE PLANTING HOLES SHALL BE EXCAVATED TO MINIMUM WIDTH OF TWO TIMES THE WIDTH OF THE ROOTBALL. AND TO A DEPTH EQUAL TO THE DEPTH OF THE ROOTBALL LESS TWO TO FOUR INCHES. SCARIFY THE SIDES AND BOTTOM OF THE PLANTING HOLE PRIOR TO THE PLACEMENT OF THE TREE. REMOVE ANY GLAZING THAT MAY HAVE BEEN CAUSED DURING THE EXCAVATION OF THE HOLE.
 - 3. FOR CONTAINER AND BOX TREES, TO REMOVE ANY POTENTIALLY GIRDLING ROOTS AND OTHER ROOT DEFECTS, THE CONTRACTOR SHALL SHAVE A 1" LAYER OFF OF THE SIDES AND BOTTOM OF THE ROOTBALL OF ALL TREES JUST BEFORE PLACING INTO THE PLANTING PIT. DO NOT "TEASE" ROOTS OUT FROM THE ROOTBALL.
 - 4. INSTALL THE TREE ON UNDISTURBED SUBGRADE SO THAT THE TOP OF THE ROOTBALL IS TWO TO FOUR INCHES ABOVE THE SURROUNDING GRADE 5. BACKFILL THE TREE HOLE UTILIZING THE EXISTING TOPSOIL FROM ON-SITE. ROCKS LARGER THAN 1" DIA. AND ALL OTHER DEBRIS SHALL BE REMOVED FROM THE SOIL PRIOR TO THE BACKFILL. SHOULD ADDITIONAL SOIL BE REQUIRED TO ACCOMPLISH THIS TASK. USE STORED TOPSOIL FROM ON-SITE OR
- TOPSOIL SHALL BE OF SIMILAR TEXTURAL CLASS AND COMPOSITION IN THE ON-SITE SOIL. TREES SHALL NOT BE STAKED UNLESS LOCAL CONDITIONS (SUCH AS HEAVY WINDS OR SLOPES) REQUIRE STAKES TO KEEP TREES UPRIGHT. SHOULD STAKING BE REQUIRED. THE TOTAL NUMBER OF TREE STAKES (BEYOND THE MINIMUMS LISTED BELOW) WILL BE LEFT TO THE LANDSCAPE CONTRACTOR'S DISCRETION. SHOULD ANY TREES FALL OR LEAN, THE LANDSCAPE CONTRACTOR SHALL STRAIGHTEN THE TREE, OR REPLACE IT SHOULD IT BECOME DAMAGED. TREE STAKING SHALL ADHERE TO THE FOLLOWING GUIDELINES:

IMPORT ADDITIONAL TOPSOIL FROM OFF-SITE AT NO ADDITIONAL COST TO THE OWNER. IMPORTED

TWO STAKES PER TREE 2-1/2"-4" TREES THREE STAKES PER TREE

TREES OVER 4" CALIPER GUY AS NEEDED

- THREE STAKES PER TREE MINIMUM, QUANTITY AND POSITIONS AS MULTI-TRUNK TREES NEEDED TO STABILIZE THE TREE UPON COMPLETION OF PLANTING, CONSTRUCT AN EARTH WATERING BASIN AROUND THE TREE.
- COVER THE INTERIOR OF THE TREE RING WITH THE WEED BARRIER CLOTH AND TOPDRESS WITH MULCH (TYPE AND DEPTH PER PLANS).
- SHRUB, PERENNIAL, AND GROUNDCOVER PLANTING DIG THE PLANTING HOLES TWICE AS WIDE AND 2" LESS DEEP THAN EACH PLANT'S ROOTBALL. INSTALL THE PLANT IN THE HOLE. BACKFILL AROUND THE PLANT WITH SOIL AMENDED PER SOIL TEST
- RECOMMENDATIONS. INSTALL THE WEED BARRIER CLOTH, OVERLAPPING IT AT THE ENDS. UTILIZE STEEL STAPLES TO KEEP THE WEED BARRIER CLOTH IN PLACE. WHEN PLANTING IS COMPLETE, INSTALL MULCH (TYPE AND DEPTH PER PLANS) OVER ALL PLANTING
- BEDS. COVERING THE ENTIRE PLANTING AREA. F. SODDING SOD VARIETY TO BE AS SPECIFIED ON THE LANDSCAPE PLAN. LAY SOD WITHIN 24 HOURS FROM THE TIME OF STRIPPING. DO NOT LAY IF THE GROUND IS FROZEN. LAY THE SOD TO FORM A SOLID MASS WITH TIGHTLY FITTED JOINTS. BUTT ENDS AND SIDES OF SOD
- 4 ROLL THE SOD TO ENSURE GOOD CONTACT OF THE SOD'S ROOT SYSTEM WITH THE SOIL 5. WATER THE SOD THOROUGHLY WITH A FINE SPRAY IMMEDIATELY AFTER PLANTING TO OBTAIN AT

STRIPS - DO NOT OVERLAP STAGGER STRIPS TO DESET JOINTS IN ADJACENT COLIRSES.

G. HYDROMULCHING 1. TURF HYDROMULCH MIX (PER 1,000 SF) SHALL BE AS FOLLOWS:

LEAST SIX INCHES OF PENETRATION INTO THE SOIL BELOW THE SOD.

- WINTER MIX (OCTOBER 1 MARCH 31) 50# CELLULOSE FIBER MULCH
- P# UNHULLED BERMUDA SEED # ANNUAL RYE SEED
- 15# 15-15-15 WATER SOLUBLE FERTILIZER
- 50# CELLULOSE FIBER MULCH HULLED BERMUDA SEED 15# 15-15-15 WATER SOLUBLE FERTILIZER
- 2. SEED HYDROMULCH MIX (PER 1,000 SF) SHALL BE AS FOLLOWS:
- 50# CELLULOSE FIBER MULCH 15# 15-15-15 WATER SOLUBLE FERTILIZER
- SEED RATE PER LEGEND
- ALL SEED SHALL BE DRILL SEEDED AT THE RATES SHOWN ON THE PLANS, WITH A HYDROMULCH MIX APPLIED AFTER SEEDING. THE HYDROMULCH MIX (PER 1.000 SF) SHALL BE AS FOLLOWS:
- 50# CELLULOSE FIBER MULCH 15# 15-15-15 WATER SOLUBLE FERTILIZER
- 4# ORGANIC BINDER
- MULCH
- 1. INSTALL MULCH TOPDRESSING, TYPE AND DEPTH PER MULCH NOTE, IN ALL PLANTING AREAS AND TREE RINGS. 2. DO NOT INSTALL MULCH WITHIN 6" OF TREE ROOT FLARE AND WITHIN 24" OF HABITABLE STRUCTURES, EXCEPT AS MAY BE NOTED ON THESE PLANS. MULCH COVER WITHIN 6" OF CONCRETE WALKS AND CURBS SHALL NOT PROTRUDE ABOVE THE FINISH SURFACE OF THE WALKS AND CURBS. MULCH
- COVER WITHIN 12" OF WALLS SHALL BE AT LEAST 3" LOWER THAN THE TOP OF WALL. 1. DURING LANDSCAPE PREPARATION AND PLANTING, KEEP ALL PAVEMENT CLEAN AND ALL WORK AREAS
- IN A NEAT, ORDERLY CONDITION. DISPOSED LEGALLY OF ALL EXCAVATED MATERIALS OFF THE PROJECT SITE. K. INSPECTION AND ACCEPTANCE
- 1. UPON COMPLETION OF THE WORK, THE LANDSCAPE CONTRACTOR SHALL PROVIDE THE SITE CLEAN, FREE OF DEBRIS AND TRASH, AND SUITABLE FOR USE AS INTENDED. THE LANDSCAPE CONTRACTOR SHALL THEN REQUEST AN INSPECTION BY THE OWNER TO DETERMINE FINAL ACCEPTABILITY. 2. WHEN THE INSPECTED PLANTING WORK DOES NOT COMPLY WITH THE CONTRACT DOCUMENTS, THE LANDSCAPE CONTRACTOR SHALL REPLACE AND/OR REPAIR THE REJECTED WORK TO THE OWNER'S
- SATISFACTION WITHIN 24 HOURS. THE LANDSCAPE MAINTENANCE PERIOD WILL NOT COMMENCE UNTIL THE LANDSCAPE WORK HAS BEEN RE-INSPECTED BY THE OWNER AND FOUND TO BE ACCEPTABLE. AT THAT TIME, A WRITTEN NOTICE OF FINAL ACCEPTANCE WILL BE ISSUED BY THE OWNER, AND THE MAINTENANCE AND GUARANTEE PERIODS WILL COMMENCE. LANDSCAPE MAINTENANCE
- THE LANDSCAPE CONTRACTOR SHALL BE RESPONSIBLE FOR THE MAINTENANCE OF ALL WORK SHOWN ON THESE PLANS FOR 90 DAYS BEYOND FINAL ACCEPTANCE OF ALL LANDSCAPE WORK BY THE OWNER. LANDSCAPE MAINTENANCE SHALL INCLUDE WEEKLY SITE VISITS FOR THE FOLLOWING ACTIONS (AS APPROPRIATE): PROPER PRUNING, RESTAKING OF TREES, RESETTING OF PLANTS THAT HAVE SETTLED, MOWING AND AERATION OF LAWNS, WEEDING, RESEEDING AREAS WHICH HAVE NOT GERMINATED WELL, TREATING FOR INSECTS AND DISEASES, REPLACEMENT OF MULCH, REMOVAL OF LITTER, REPAIRS TO THE IRRIGATION SYSTEM DUE TO FAULTY PARTS AND/OR WORKMANSHIP, AND THE APPROPRIATE WATERING OF ALL PLANTINGS. THE LANDSCAPE CONTRACTOR SHALL MAINTAIN THE IRRIGATION SYSTEM IN PROPER WORKING ORDER, WITH SCHEDULING ADJUSTMENTS BY SEASON
- TO MAXIMIZE WATER CONSERVATION. SHOULD SEEDED AND/OR SODDED AREAS NOT BE COVERED BY AN AUTOMATIC IRRIGATION SYSTEM. THE LANDSCAPE CONTRACTOR SHALL BE RESPONSIBLE FOR WATERING THESE AREAS AND OBTAINING A FULL HEALTHY STAND OF PLANTS AT NO ADDITIONAL COST TO THE OWNER TO ACHIEVE FINAL ACCEPTANCE AT THE END OF THE MAINTENANCE PERIOD, ALL OF THE FOLLOWING CONDITIONS MUST OCCUR-


INCHES BEFORE FIRST MOWING. HYDROMULCHED AREAS SHALL SHOW ACTIVE, HEALTHY

REPLACE, AT HIS OWN EXPENSE AND TO THE SATISFACTION OF THE OWNER, ANY PLANTS WHICH DIE

IN THAT TIME, OR REPAIR ANY PORTIONS OF THE IRRIGATION SYSTEM WHICH OPERATE IMPROPERLY.

- THE LANDSCAPE SHALL SHOW ACTIVE, HEALTHY GROWTH (WITH EXCEPTIONS MADE FOR SEASONAL DORMANCY). ALL PLANTS NOT MEETING THIS CONDITION SHALL BE REJECTED AND REPLACED BY HEALTHY PLANT MATERIAL PRIOR TO FINAL ACCEPTANCE ALL HARDSCAPE SHALL BE CLEANED PRIOR TO FINAL ACCEPTANCE. SODDED AREAS MUST BE ACTIVELY GROWING AND MUST REACH A MINIMUM HEIGHT OF 1 1/2
- GROWTH. BARE AREAS LARGER THAN TWELVE SQUARE INCHES MUST BE RESODDED OR RESEEDED (AS APPROPRIATE) PRIOR TO FINAL ACCEPTANCE. ALL SODDED TURF SHALL BE NEATLY MOWED. M. WARRANTY PERIOD, PLANT GUARANTEE AND REPLACEMENTS THE LANDSCAPE CONTRACTOR SHALL GUARANTEE ALL TREES, SHRUBS, PERENNIALS, SOD, SEEDED/HYDROMULCHED AREAS, AND IRRIGATION SYSTEMS FOR A PERIOD OF ONE YEAR FROM THE DATE OF THE OWNER'S FINAL ACCEPTANCE (90 DAYS FOR ANNUAL PLANTS). THE CONTRACTOR SHALL
- CONTRACTOR SHALL ONLY BE RESPONSIBLE FOR REPLACEMENT OF PLANTS WHEN PLANT DEATH CANNOT BE ATTRIBUTED DIRECTLY TO OVERWATERING OR OTHER DAMAGE BY HUMAN ACTIONS. PROVIDE A MINIMUM OF (2) COPIES OF RECORD DRAWINGS TO THE OWNER UPON COMPLETION OF WORK. A RECORD DRAWING IS A RECORD OF ALL CHANGES THAT OCCURRED IN THE FIELD AND THAT ARE DOCUMENTED THROUGH CHANGE ORDERS, ADDENDA, OR CONTRACTOR/CONSULTANT DRAWING MARKUPS.

2. AFTER THE INITIAL MAINTENANCE PERIOD AND DURING THE GUARANTEE PERIOD, THE LANDSCAPE

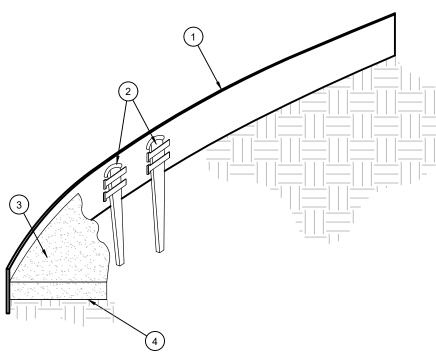

- (1) ROLLED-TOP STEEL EDGING PER PLANS.
- (2) TAPERED STEEL STAKES. (3) MULCH, TYPE AND DEPTH PER PLANS.

(4) FINISH GRADE.

1) INSTALL EDGING SO THAT STAKES WILL BE ON INSIDE OF PLANTING BED. BOTTOM OF EDGING SHALL BE BURIED A MINIMUM OF 1" BELOW FINISH GRADE 3) TOP OF MULCH SHALL BE 1" LOWER THAN TOP OF EDGING.

DISTANCE PER PLAN

(2) MULCH LAYER


(4) TURF (WHERE SHOWN ON PLAN).

(3) PLANT.

24" MIN. TO EDGE

OF MATURE CANOPY



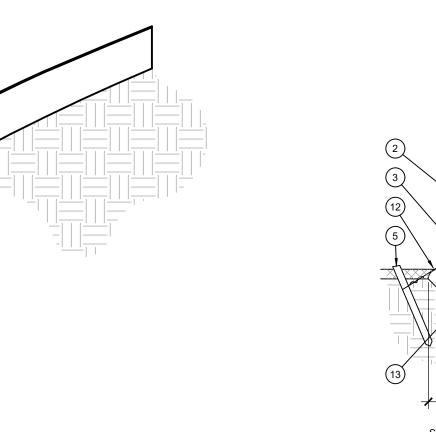

STAKING EXAMPLES (PLAN VIEW) PREVAILING PREVAILING

3X ROOTBALL DIA.


CONIFEROUS

NON-CONIFEROUS

SCALE: NOT TO SCALE


WINDS

- (1) TREE CANOPY. CINCH-TIES (24" BOX/2" CAL. TREES AND SMALLER) OR 12 GAUGE GAI VANIZED WIRE WITH NYI ON TREE STRAPS AT TREE AND STAKE (36" BOX/2.5" CAL. TREES
- AND LARGER). SECURE TIES OR STRAPS TO TRUNK JUST ABOVE LOWEST MAJOR BRANCHES
- (3) 24" X 3/4" P.V.C. MARKERS OVER WIRES.
- (4) GREEN STEEL T-POSTS. EXTEND POSTS 12" MIN. INTO UNDISTURBED SOIL.
- PRESSURE-TREATED WOOD DEADMAN, TWO PER TREE (MIN.). BURY OUTSIDE OF PLANTING PIT AND 18" MIN. INTO UNDISTURBED SOIL.
- (6) TRUNK FLARE
- 7) MULCH, TYPE AND DEPTH PER PLANS. DO NOT PLACE MULCH WITHIN 6" OF TRUNK.
- (8) FINISH GRADE
- 9) ROOT BALL.
- 10) BACKFILL. AMEND AND FERTILIZE ONLY AS RECOMMENDED IN SOIL FERTILITY ANALYSIS.
- (11) UNDISTURBED NATIVE SOIL.
- (12) 4" HIGH EARTHEN WATERING BASIN.
- (13) FINISH GRADE.
- SCARIFY SIDES OF PLANTING PIT PRIOR TO SETTING TREE. REMOVE EXCESS SOIL APPLIED ON TOP OF THE ROOTBALL THAT COVERS THE ROOT FLARE. THE PLANTING HOLE DEPTH SHALL BE SUCH THAT THE ROOTBALL RESTS ON UNDISTURBED SOIL, AND THE
- ROOT FLARE IS 2"-4" ABOVE FINISH GRADE. FOR B&B TREES, CUT OFF BOTTOM 1/3 OF WIRE BASKET BEFORE PLACING TREE IN HOLE, CUT OFF AND REMOVE REMAINDER OF BASKET AFTER TREE IS SET IN HOLE, REMOVE ALL NYLON TIES, TWINE, ROPE, AND OTHER PACKING MATERIAL. REMOVE AS MUCH
- BURLAP FROM AROUND ROOTBALL AS IS PRACTICAL. REMOVE ALL NURSERY STAKES AFTER PLANTING. 5. FOR TREES 36" BOX/2.5" CAL. AND LARGER, USE THREE STAKES OR DEADMEN (AS APPROPRIATE), SPACED EVENLY AROUND TREE.
- 6 STAKING SHALL BE TIGHT ENOUGH TO PREVENT TRUNK FROM BENDING, BUT LOOSE ENOUGH TO ALLOW SOME TRUNK MOVEMENT

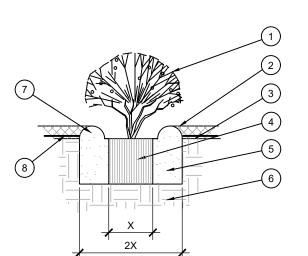


- (1) SHRUB, PERENNIAL, OR ORNAMENTAL GRASS.
- 2) MULCH, TYPE AND DEPTH PER PLANS. PLACE NO MORE THAN 1" OF MULCH WITHIN 6" OF PLANT CENTER.
- (3) FINISH GRADE (4) ROOT BALL.
- (5) BACKFILL, AMEND AND FERTILIZE ONLY AS
- (6) UNDISTURBED NATIVE SOIL.
- (7) 3" HIGH EARTHEN WATERING BASIN.
- (8) WEED FABRIC UNDER MULCH.

PLANTING AT PARKING AREA

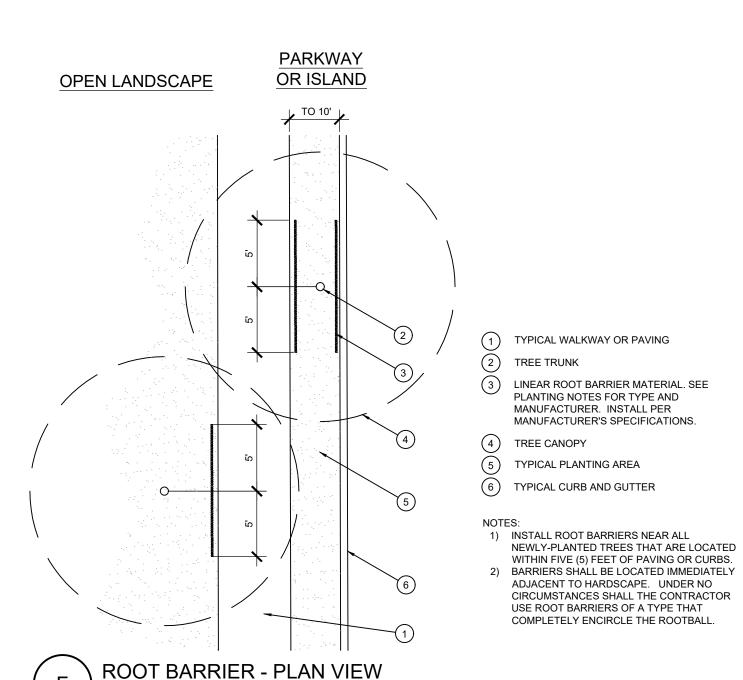

SHRUB AND PERENNIAL PLANTING

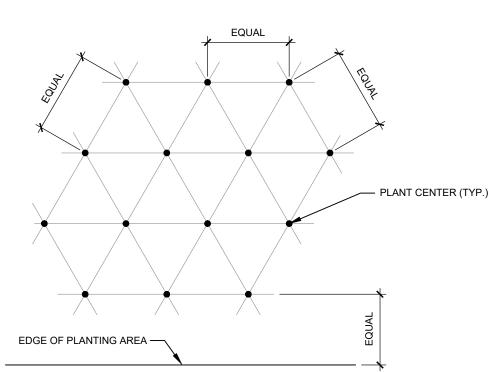

NOTE: ALL PLANTS SHALL BE PLANTED AT EQUAL TRIANGULAR SPACING (EXCEPT WHERE SHOWN ON PLANS AS INFORMAL GROUPINGS). REFER TO PLANT LEGEND FOR SPACING DISTANCE BETWEEN PLANTS.

1) STEP 1: DETERMINE TOTAL PLANTS FOR THE AREA WITH THE FOLLOWING FORMULA: TOTAL AREA / AREA DIVIDER = TOTAL PLANTS PLANT SPACING AREA DIVIDER

2) STEP 2: SUBTRACT THE ROW (S) OF PLANTS THAT WOULD OCCUR AT THE EDGE OF THE PLANTED AREA WITH THE FOLLOWING FORMULA: TOTAL PERIMETER LENGTH / PLANT SPACING = TOTAL PLANT SUBTRACTION

EXAMPLE: PLANTS AT 18" O.C. IN 100 SF PLANTING AREA, 40 LF PERIMETER STEP 1: 100 SF/1.95 = 51 PLANTS STEP 2: 51 PLANTS - (40 LF / 1.95 = 21 PLANTS) = 30 PLANTS TOTAL

ational Presence. Local Expertise **EVERGREEN DESIGN GROUP** 800.680.6630 www.evergreendesigngroup.co

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> MARY N. BATES TEXAS L.A. #3613

ISSUED ON: OCTOBER 04, 2024

CONSTRUCTION, BIDDING

OR PERMITTING PURPOSES.

0 ail kwall

HARDSCAPE PLAN

Date Comment

roject Number 10/04/24 Drawn By

Checked By



CITY OF ROCKWALL

PLANNING AND ZONING COMMISSION MEMORANDUM

PLANNING AND ZONING DEPARTMENT

385 S. GOLIAD STREET • ROCKWALL, TX 75087

PHONE: (972) 771-7745 • EMAIL: PLANNING@ROCKWALL.COM

TO: Planning and Zoning Commission

FROM: Bethany Ross, *Planner*

DATE: May 13, 2025

SUBJECT: SP2025-015; PD Site Plan for the Quail Hollow Subdivision Phase II

The applicant, Chase Finch of Corwin Engineering -- on behalf of John Arnold of Skorburg Company --, is requesting the approval of a <u>Site Plan</u> for Phase II of the Quail Hollow Subdivision. The subject property is a 42.742-acre tract of land (*i.e. Lot 20, Block G, Quail Hollow, Phase 1 Addition*) generally located at the northwest corner of the intersection of E. Quail Run Road and Hays Road. Concurrently with this <u>Site Plan</u>, the applicant has submitted a <u>Final Plat [Case No. P2025-012]</u> for Phase II of the subdivision.

The subject property is zoned Planned Development District 97 (PD-97) [Ordinance No. 22-44] for Single-Family 10 (SF-10) District land uses. Based on this Planned Development District, the proposed subdivision will consist of three (3) lot types (i.e. [Type A Lots] 150, 62' x 120' lots; [Type B Lots] 74, 72' x 120' lots; [Type C Lots] 26, 82' x 125' lots and be subject to the following density and dimensional requirements:

LOT TYPE (SEE CO	ONCEPT PLAN) ► A	В	С
MINIMUM LOT WIDTH (1)	62'	72'	82'
MINIMUM LOT DEPTH	120'	120'	125'
MINIMUM LOT AREA (SF)	7,440 SF	8,640 SF	10,250 SF
MINIMUM FRONT YARD SETBACK (2), (5) & (6)	20'	20'	20'
MINIMUM SIDE YARD SETBACK	6'	6'	6'
MINIMUM SIDE YARD SETBACK (ADJACENT TO A S	TREET) (2), (5) &(7) 20'	20'	20'
MINIMUM LENGTH OF DRIVEWAY PAVEMENT	20'	20'	20'
MAXIMUM HEIGHT (3)	36'	36'	36'
MINIMUM REAR YARD SETBACK (4)	10'	10'	10'
MINIMUM AREA/DWELLING UNIT (SF) [AIR-CONDITI	ONED SPACE] 2,200 SF	2,200 SF	2,800 SF
MAXIMUM LOT COVERAGE	65%	65%	65%

GENERAL NOTES:

- 1: Lots fronting onto curvilinear streets, cul-de-sacs and eyebrows may have the front lot width reduced by 20% as measured at the front property line provided that the lot width will be met at the *Front Yard Building Setback*. Additionally, the lot depth on lots fronting onto curvilinear streets, cul-de-sacs and eyebrows may be reduced by up to ten (10) percent, but shall meet the minimum lot size for each lot type referenced in *Table 1*.
- 2: The location of the Front Yard Building Setback as measured from the front property line.
- 3: The Maximum Height shall be measured to the eave or top plate (whichever is greater) of the single-family home.
- 4: The location of the Rear Yard Building Setback as measured from the rear property line.
- 5: Sunrooms, porches, stoops, bay windows, balconies, masonry clad chimneys, eaves and similar architectural features may encroach beyond the *Front Yard Building Setback* and *Side Yard Building Setback* by up to five (5) feet for any property. A sunroom is an enclosed room no more than 15-feet in width that has glass on at least 50% of each of the encroaching faces.
- 6: J-Swing or Traditional Swing Garages are permitted to encroach into the front yard building setback a minimum of five (5) feet.
- 7: All Corner Lots that back to a lot that fronts onto the same street that the Corner Lot sides to (i.e. A Keystone Lot), shall have a setback that is equal to the front setback of the fronting lot. In addition, no solid fence shall be situated within this setback.

In accordance with the PD Site Plan requirements outlined within the PD Ordinance [Ordinance No. 22-44] the applicant has submitted a site plan, landscape plan, and hardscape plan. The proposed Site Plan appears to conform to all requirements stipulated by Ordinance No. 22-44. The Hardscape Plan shows the required entry monumentation signage, sidewalks, and trails. Since the request generally conforms to the requirements of Planned Development District 97 (PD-97) [Ordinance No.

22-44] and the Unified Development Code (UDC), this case is being placed on the consent agenda Zoning Commission have any questions concerning the applicant's request, staff and the applicant value 13, 2025 Planning and Zoning Commission meeting.	a. Should the Planning and will be available at the <u>May</u>




NOTARY PUBLIC IN AND FOR THE STATE OF TEXAS

DEVELOPMENT APPLICATION

City of Rockwall Planning and Zoning Department 385 S. Goliad Street Rockwall, Texas 75087

PLANNING & ZONING CASE NO.
<u>NOTE:</u> THE APPLICATION IS NOT CONSIDERED ACCEPTED BY THE CITY UNTIL THE PLANNING DIRECTOR AND CITY ENGINEER HAVE SIGNED BELOW.
DIRECTOR OF PLANNING:
CITY ENGINEER:

	Nockwall, Texas 75007	СПУ	ENGINEER:	HER THERE		
PLEASE CHECK THE	APPROPRIATE BOX BELOW TO INDICATE THE TYPE C	OF DEVELOPMENT RE	QUEST [SELECT ONLY ONE BOX]:		
☐ PRELIMINARY ☐ FINAL PLAT (\$3 ☐ REPLAT (\$300.) ☐ AMENDING OR ☐ PLAT REINSTA SITE PLAN APPLI ☑ SITE PLAN (\$25	(\$100.00 + \$15.00 ACRE) 1 PLAT (\$200.00 + \$15.00 ACRE) 1 300.00 + \$20.00 ACRE) 1 00 + \$20.00 ACRE) 1 MINOR PLAT (\$150.00) TEMENT REQUEST (\$100.00)	☐ ZONING CH. ☐ SPECIFIC USE ☐ PD DEVELO OTHER APPLIC ☐ TREE REMO ☐ VARIANCE FOR NOTES: 1: IN DETERMINING PER ACRE AMOUNT. 2: A \$1,000.00 FEE	ZONING APPLICATION FEES: ☐ ZONING CHANGE (\$200.00 + \$15.00 ACRE) 1 ☐ SPECIFIC USE PERMIT (\$200.00 + \$15.00 ACRE) 1 ☐ PD DEVELOPMENT PLANS (\$200.00 + \$15.00 ACRE) 1 OTHER APPLICATION FEES: ☐ TREE REMOVAL (\$75.00) ☐ VARIANCE REQUEST/SPECIAL EXCEPTIONS (\$100.00) 2 NOTES: 1: IN DETERMINING THE FEE, PLEASE USE THE EXACT ACREAGE WHEN MULTIPLYING BY THE PER ACRE AMOUNT. FOR REQUESTS ON LESS THAN ONE ACRE, ROUND UP TO ONE (1) ACRE. 2: A \$1,000.00 FEE WILL BE ADDED TO THE APPLICATION FEE FOR ANY REQUEST THAT INVOLVES CONSTRUCTION WITHOUT OR NOT IN COMPLIANCE TO AN APPROVED BUILDING			
PROPERTY INFO	ORMATION [PLEASE PRINT]					
ADDRES	s was the same of					
SUBDIVISIO	N Quail Hollow Phase 2		LOT	BLOCK		
GENERAL LOCATIO	Northeast Corner of Hays Lane	and Quail Rur	n Road			
ZONING. SITE P	LAN AND PLATTING INFORMATION [PLEAS	SE PRINTI				
CURRENT ZONIN		CURRENT USE				
PROPOSED ZONIN	G	PROPOSED USE				
ACREAG	E 42.742 LOTS [CURRENT	n de en de	LOTS [PROPOSED]	111		
REGARD TO ITS RESULT IN THE	D PLATS: BY CHECKING THIS BOX YOU ACKNOWLEDGE TO APPROVAL PROCESS, AND FAILURE TO ADDRESS ANY OF DENIAL OF YOUR CASE.	STAFF'S COMMENTS B	Y THE DATE PROVIDED ON THE DE	VELOPMENT CALENDAR WILL		
	CANT/AGENT INFORMATION [PLEASE PRINT/CI Quail Hollow SF, LTD.	APPLICANT		REQUIRED		
CONTACT PERSON		CONTACT PERSON	Chase Finch			
	John Arnold 8214 Westchester Drive Ste. 900	ADDRESS	200 W. Belmont S	to E		
	8214 Westchester Dilve Ste. 300		200 W. Deimont O	.e. L		
CITY, STATE & ZIP	Dallas, TX 75202	CITY, STATE & ZIP	Allen, Tx 75013			
PHONE	214-522-4945	PHONE	972-396-1200			
E-MAIL	jarnold@skorburgcompany.com	E-MAIL	cfinch@corwinengir	neering.com		
BEFORE ME, THE UNDE STATED THE INFORMA "I HEREBY CERTIFY THA S 1,110.00 INFORMATION CONTAIN	ERSIGNED AUTHORITY, ON THIS DAY PERSONALLY APPEARITION ON THIS APPLICATION TO BE TRUE AND CERTIFIED THE TIAM THE OWNER FOR THE PURPOSE OF THIS APPLICATION; AND COVER THE COST OF THIS APPLICATION, I AGRED WITHIN THIS APPLICATION TO THE PUBLIC. THE CITY I	IE FOLLOWING: ALL INFORMATION SUBMI IAS BEEN PAID TO THE CI REE THAT THE CITY OF R IS ALSO AUTHORIZED AI	TTED HEREIN IS TRUE AND CORRECT. TY OF ROCKWALL ON THIS THE	DAY OF DAY OF AND PERMITTED TO PROVIDE		
	CTION WITH THIS APPLICATION, IF SUCH REPRODUCTION IS ASS		Brook My C	commission Expires 2/1/2028 ary ID 134742171		
	OWNER'S SIGNATURE		Not	ary 10 10-7-12-77 1		

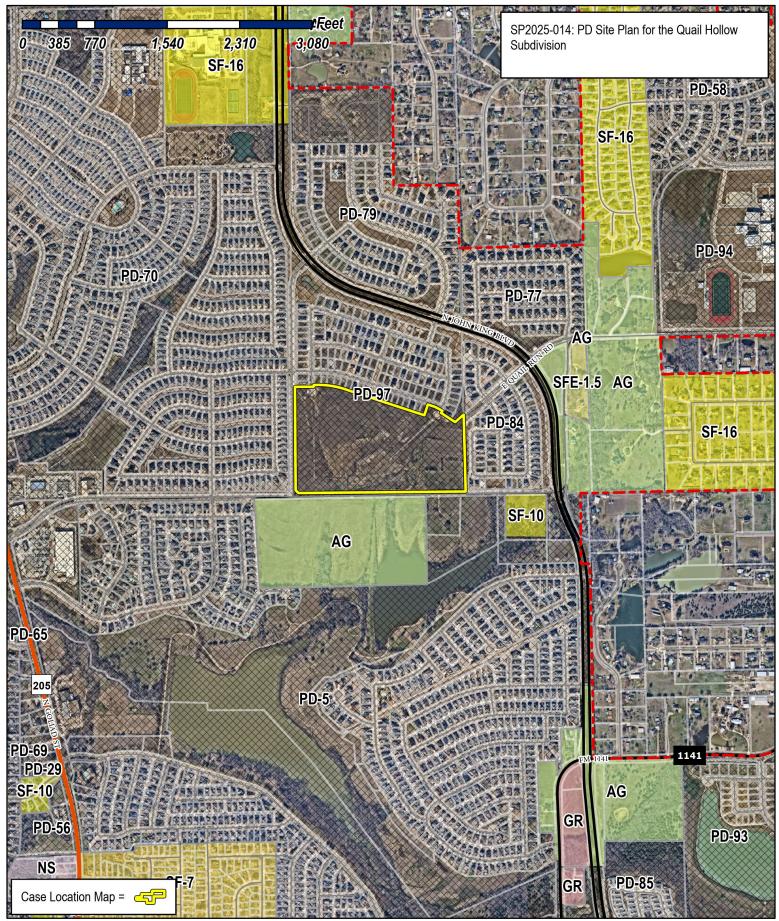





City of Rockwall Planning & Zoning Department 385 S. Goliad Street

Planning & Zoning Department 385 S. Goliad Street Rockwall, Texas 75087 (P): (972) 771-7745 (W): www.rockwall.com The City of Rockwall GIS maps are continually under development and therefore subject to change without notice. While we endeavor to provide timely and accurate information, we make no guarantees. The City of Rockwall makes no warranty, express or implied, including warranties of merchantability and fitness for a particular purpose. Use of the information is the sole responsibility of the user.



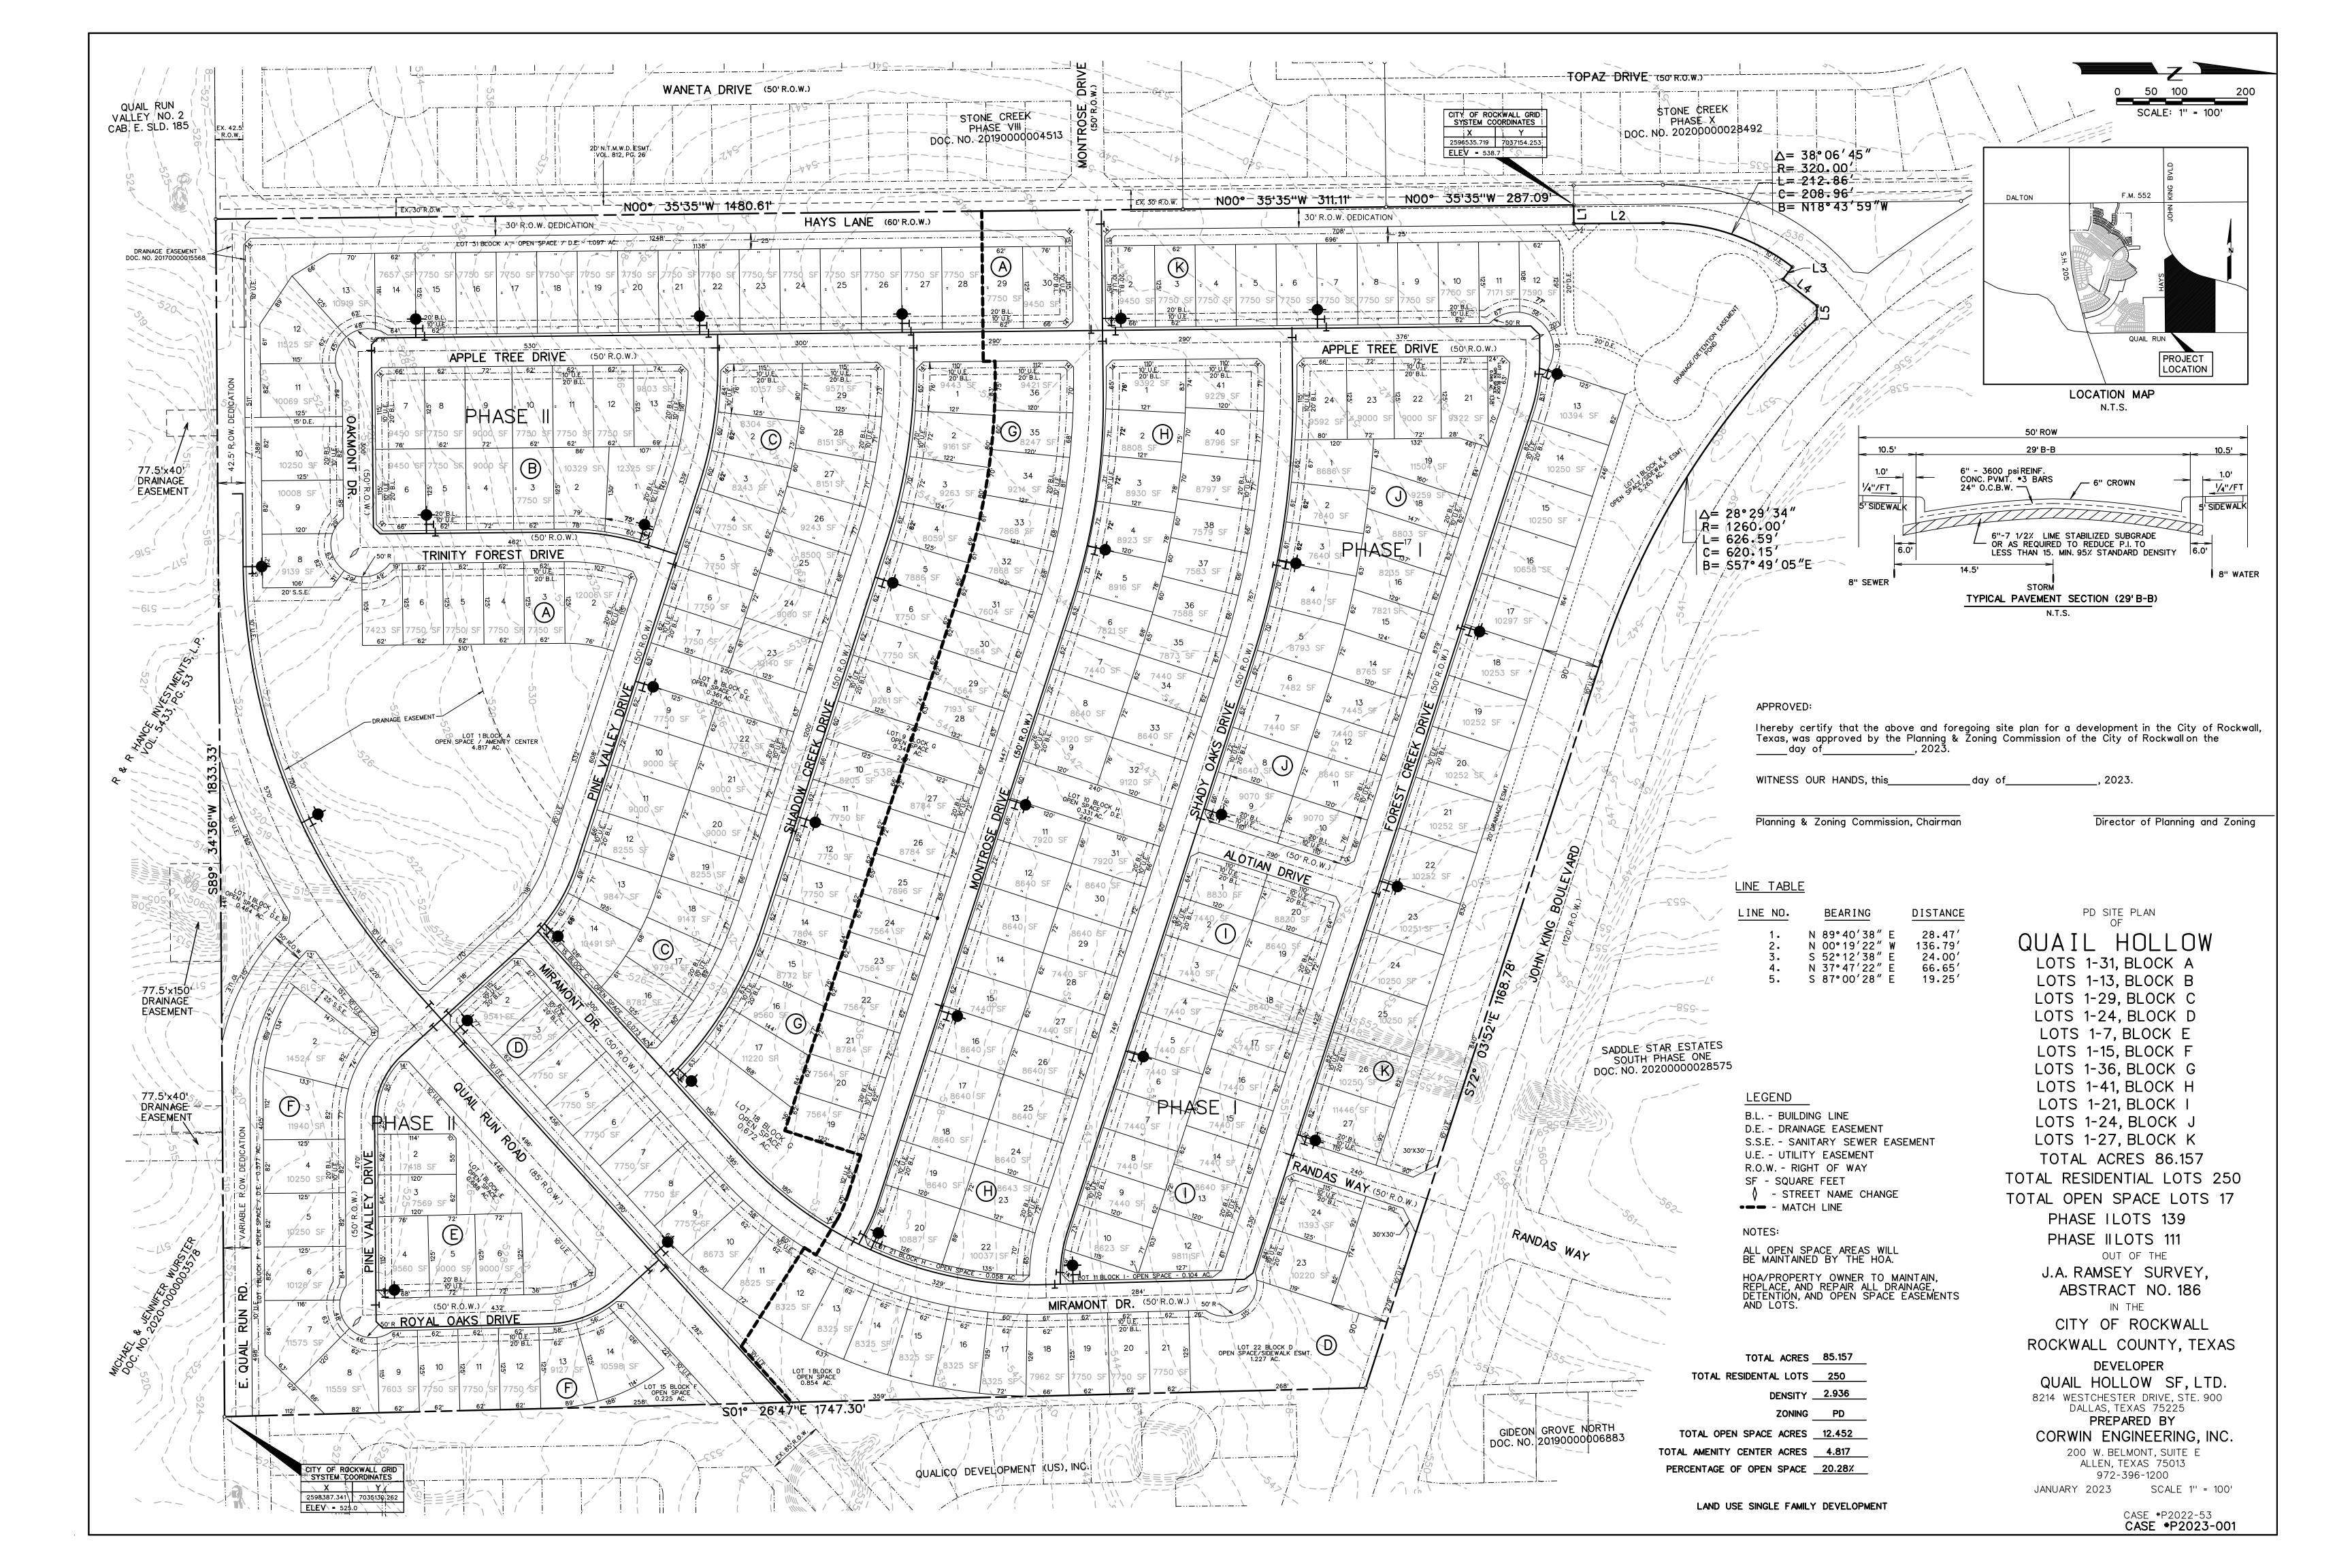

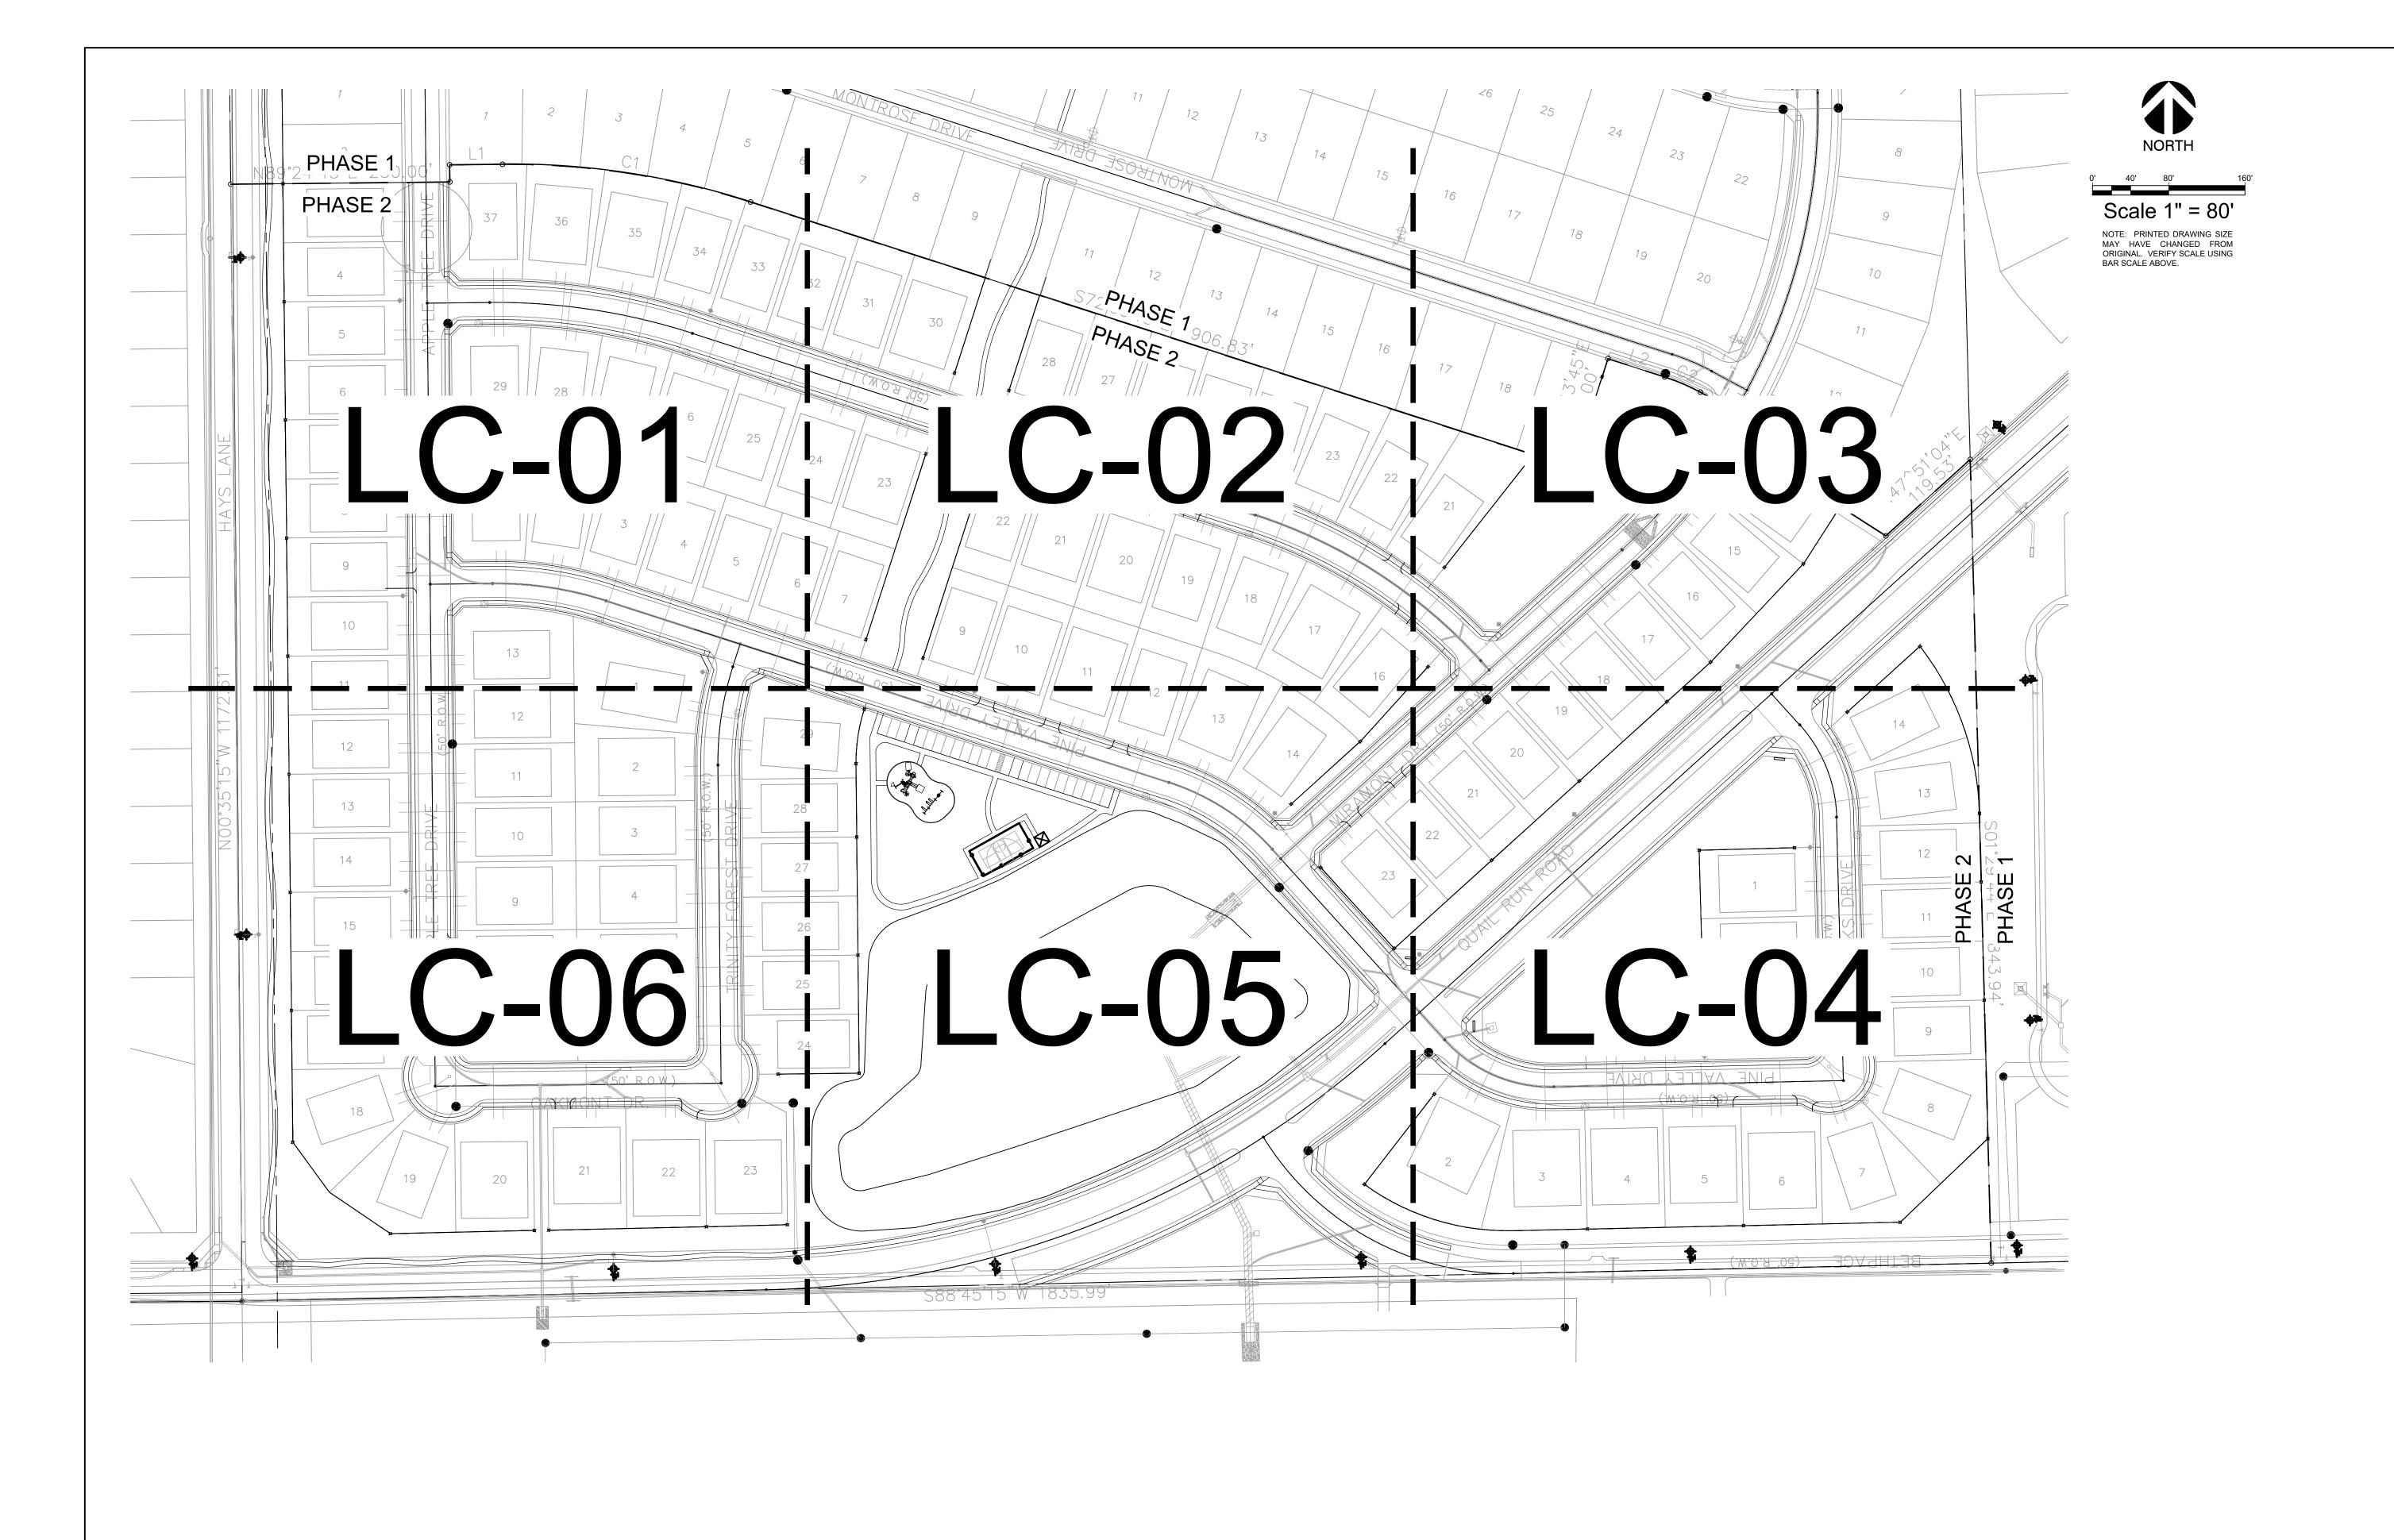



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MARY N. BATES TEXAS L.A. #3613 ISSUED ON: OCTOBER 04, 2024

Company
er Drive, Suite 900

Skorburg (8214 Westchester Dallas, Texas 75225

Quail Hollow Rockwall, TX

OVERALL HARDSCAPE PLAN


Date Comment


Project Number

 Date
 10/04/24

 Drawn By
 KB

I C-00

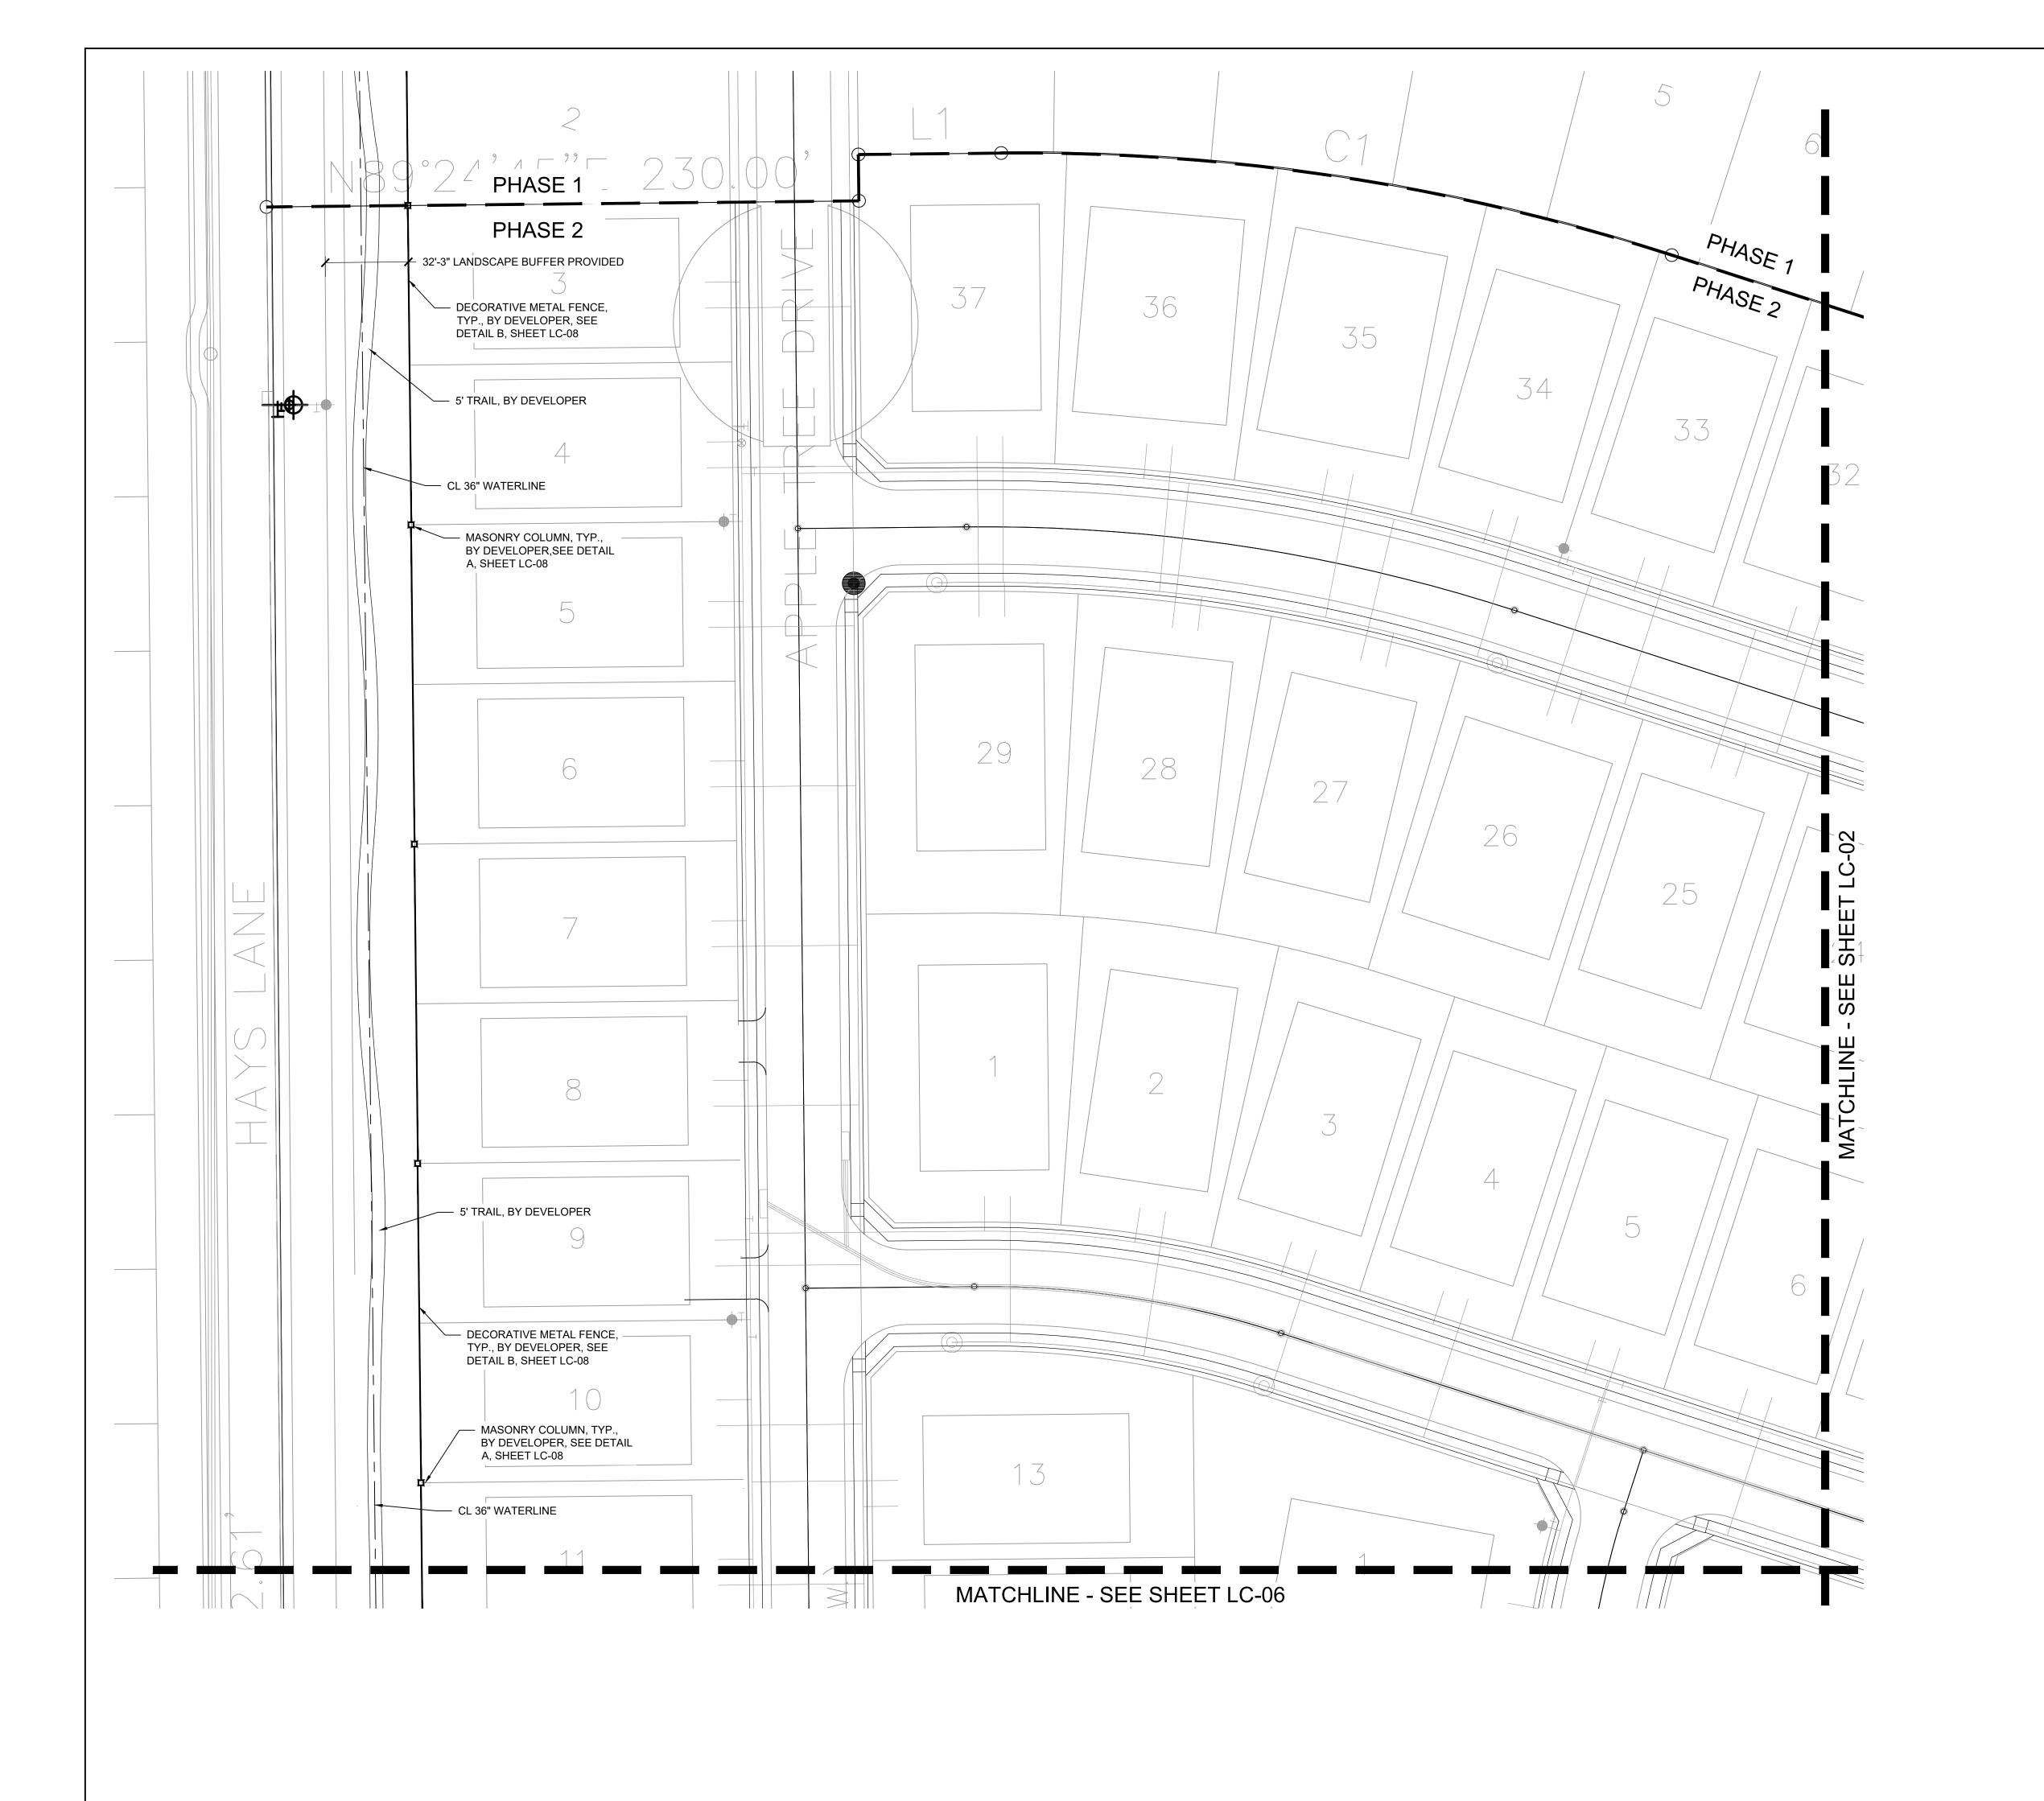

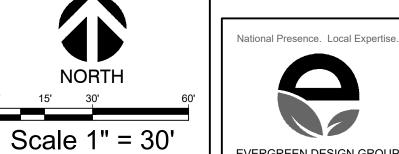

CONSTRUCTION LEGEND

2. EXPANSION JOINT WITH COLOR CAULK TO MATCH ADJACENT PAVEMENT. SEE DETAIL A, SHEET LC-07.

3. 4" CONCRETE PAD, LIGHT BROOM FINISH, NATURAL GRAY

4. PLAYGROUND EQUIPMENT, SEE DETAIL D, SHEET LC-08

5. PLAYGROUND SAFETY SURFACING - ENGINEERED WOOD

(7.) MULTI SPORT COURT. SEE DETAIL D, SHEET LC-07.

9. PRIMARY COLUMN. SEE DETAIL A, SHEET LC-08.

(10.) WROUGHT IRON FENCE W/ MASONRY COLUMN. SEE DETAIL A, SHEET LC-08.

MULCH; SEE DETAIL C, SHEET LC-08.

6.) SWINGS, SEE DETAIL D, SHEET LC-08.

(8.) ADA RAMP. SEE DETAIL C, SHEET LC-07.

COLOR; W/ SAWCUT CONTROL JOINTS; SEE DETAIL B,

(MASTER LIST - NOT ALL ITEMS ARE ON EVERY SHEET)

SHEET LC-07.

EVERGREEN DESIGN GROUP NOTE: PRINTED DRAWING SIZE MAY HAVE CHANGED FROM ORIGINAL. VERIFY SCALE USING BAR SCALE ABOVE. 800.680.6630 www.evergreendesigngroup.com LANDSCAPE ARCHITECTURE LAND PLANNING · IRRIGATION DESIGN

 4-IN THK. CONCRETE WALK, LIGHT BROOM FINISH, NATURAL GRAY COLOR; SEE DETAIL B, SHEET LC-07. THIS DOCUMENT IS ISSUED FOR INTERIM REVIEW AND IS NOT TO BE USED FOR CONSTRUCTION, BIDDING, OR PERMITTING PURPOSES.

> MARY N. BATES TEXAS L.A. #3613

ISSUED ON:


OCTOBER 04, 2024


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Quail Hollow Rockwall, TX

HARDSCAPE PLAN

Date Comment



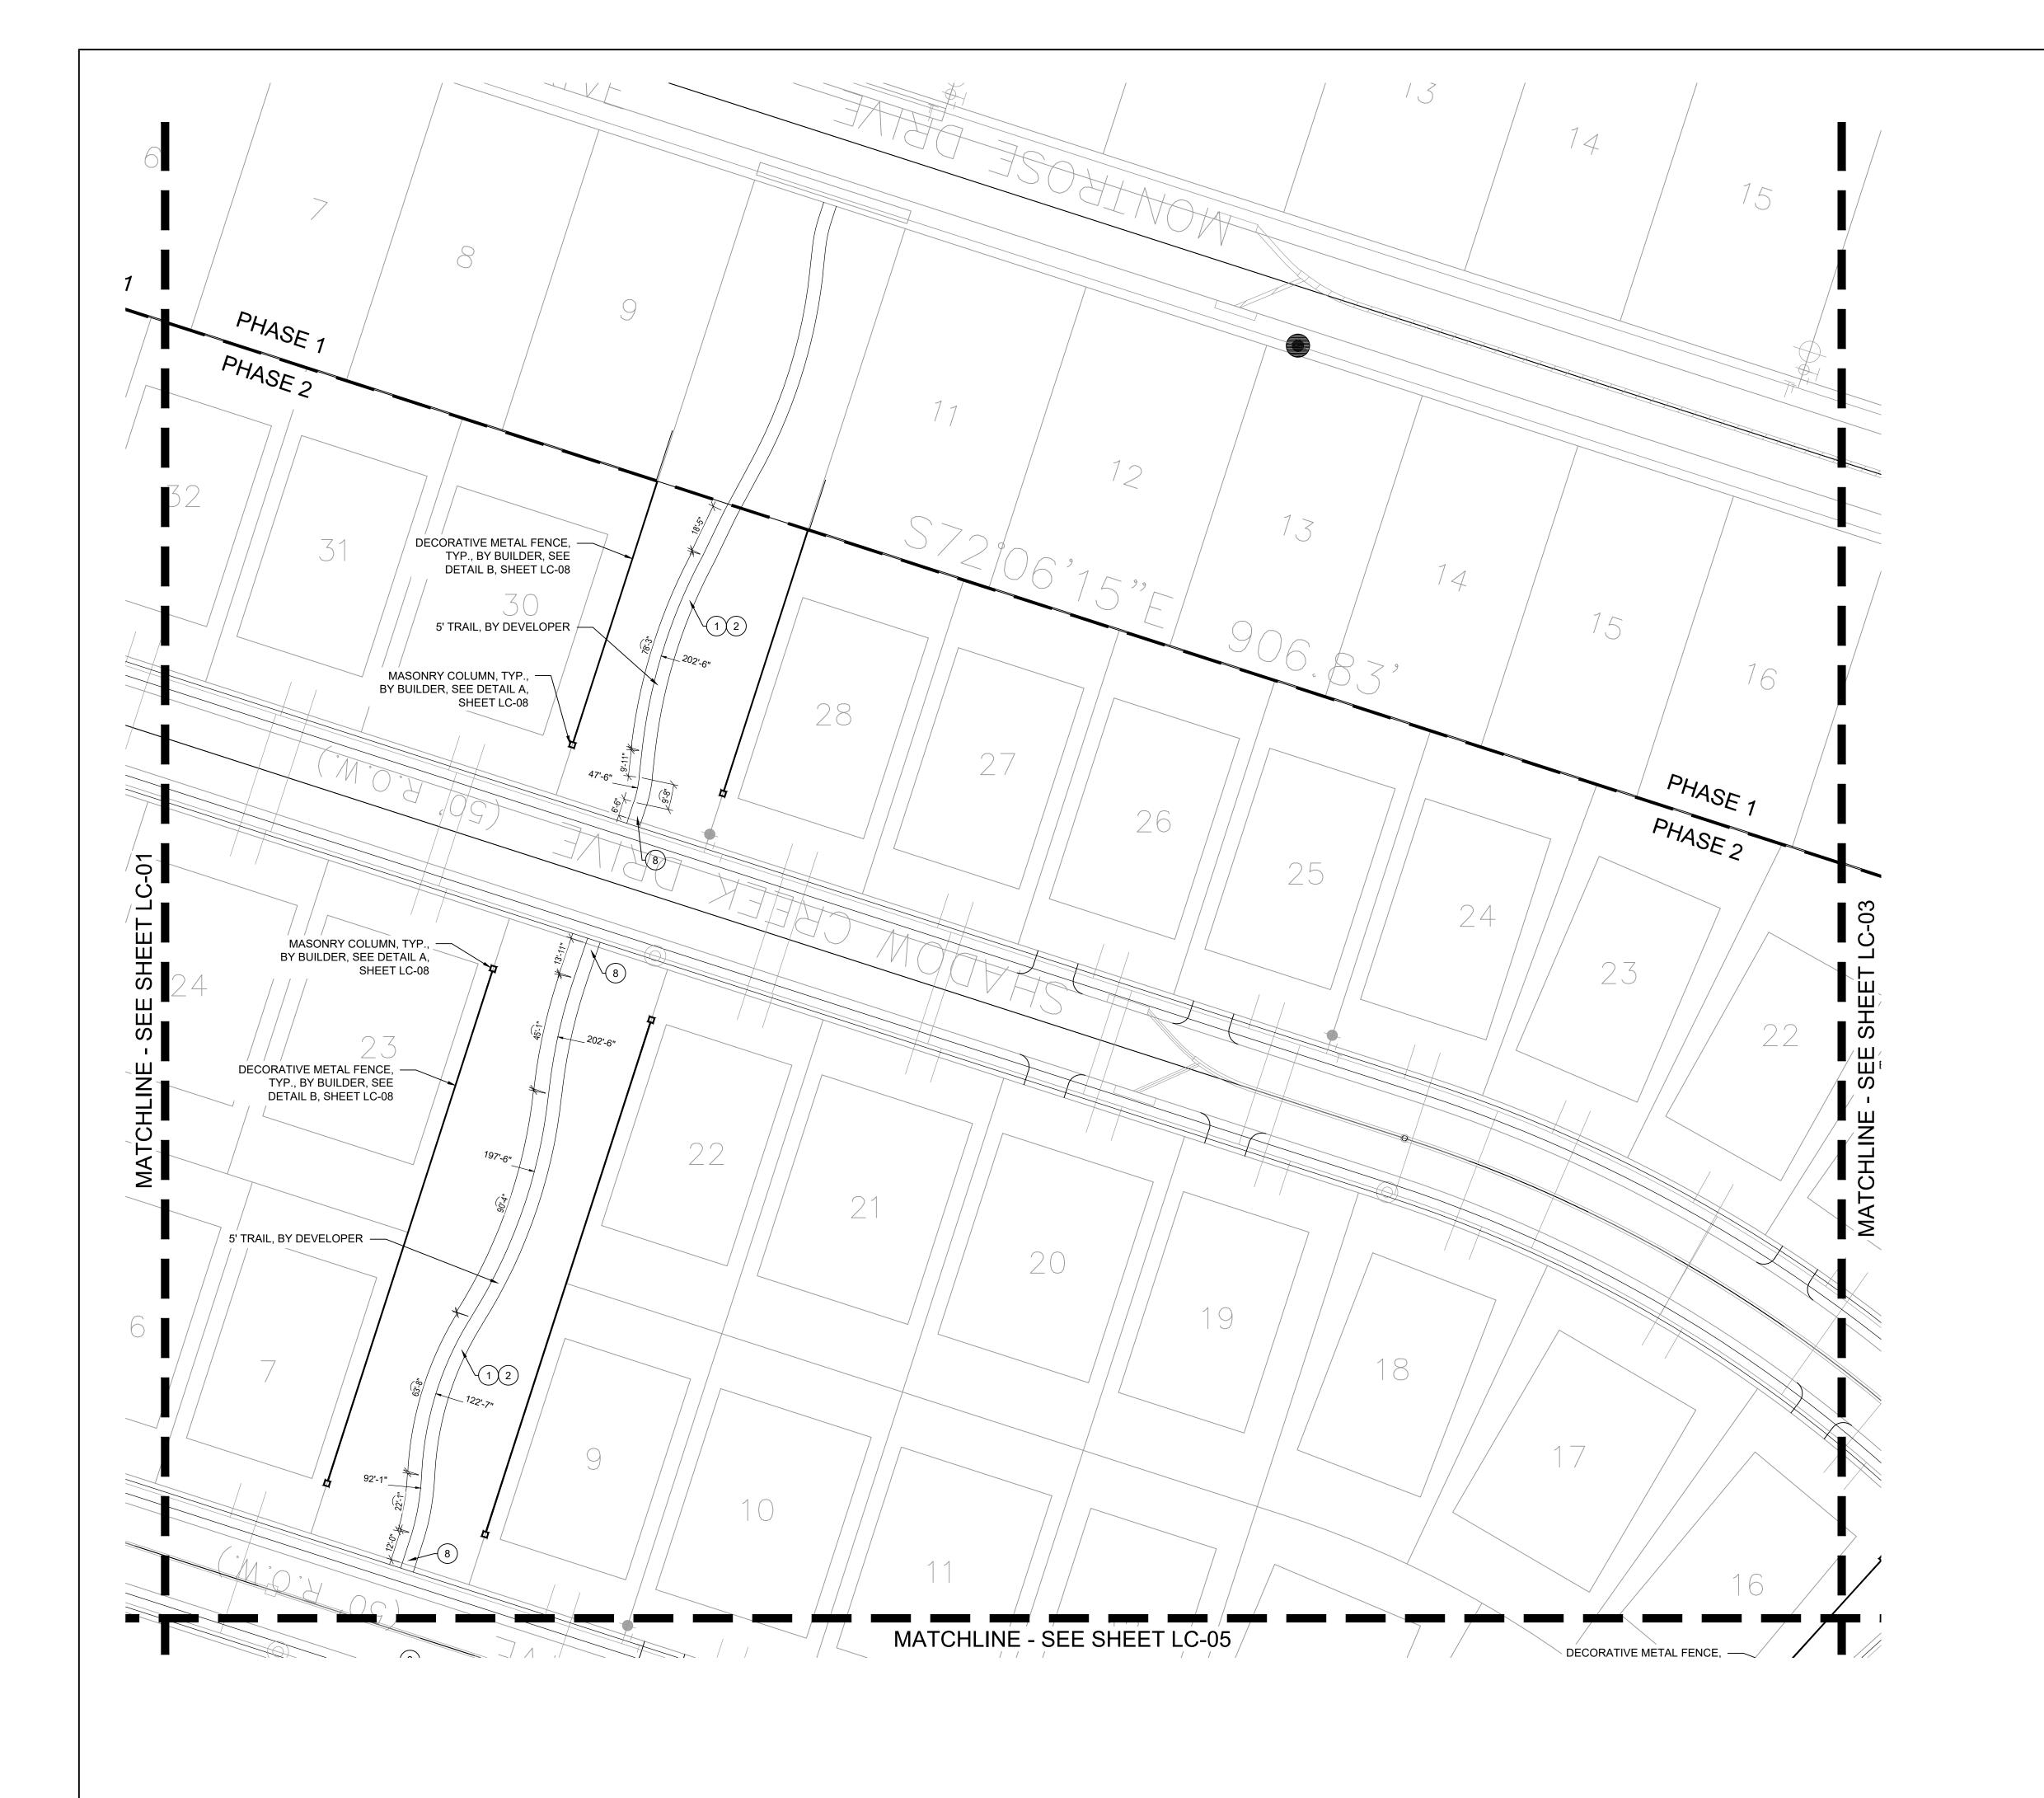

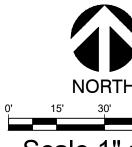Scale 1" = 30'

NOTE: PRINTED DRAWING SIZE MAY HAVE CHANGED FROM ORIGINAL. VERIFY SCALE USING BAR SCALE ABOVE.

CONSTRUCTION LEGEND (MASTER LIST - NOT ALL ITEMS ARE ON EVERY SHEET)

- 4-IN THK. CONCRETE WALK, LIGHT BROOM FINISH, NATURAL GRAY COLOR; SEE DETAIL B, SHEET LC-07.
- EXPANSION JOINT WITH COLOR CAULK TO MATCH ADJACENT PAVEMENT. SEE DETAIL A, SHEET LC-07.
- 3.) 4" CONCRETE PAD, LIGHT BROOM FINISH, NATURAL GRAY COLOR; W/ SAWCUT CONTROL JOINTS; SEE DETAIL B, SHEET LC-07.
- 4. PLAYGROUND EQUIPMENT, SEE DETAIL D, SHEET LC-08
- (5.) PLAYGROUND SAFETY SURFACING ENGINEERED WOOD MULCH; SEE DETAIL C, SHEET LC-08.
- 6. SWINGS, SEE DETAIL D, SHEET LC-08.
- (7.) MULTI SPORT COURT. SEE DETAIL D, SHEET LC-07.
- 8. ADA RAMP. SEE DETAIL C, SHEET LC-07.
- 9. PRIMARY COLUMN. SEE DETAIL A, SHEET LC-08.
- (10.) WROUGHT IRON FENCE W/ MASONRY COLUMN. SEE DETAIL A, SHEET LC-08.



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MARY N. BATES
TEXAS L.A. #3613

ISSUED ON: OCTOBER 04, 2024

skorburg Company 214 Westchester Drive, Suite 900 allas, Texas 75225

Quail Hollow Rockwall, TX

HARDSCAPE PLAN


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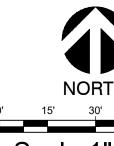
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Date 10/04/2

Date 10/04/24
Drawn By KB

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Scale 1" = 30'

NOTE: PRINTED DRAWING SIZE MAY HAVE CHANGED FROM ORIGINAL. VERIFY SCALE USING BAR SCALE ABOVE.

CONSTRUCTION LEGEND (MASTER LIST - NOT ALL ITEMS ARE ON EVERY SHEET)
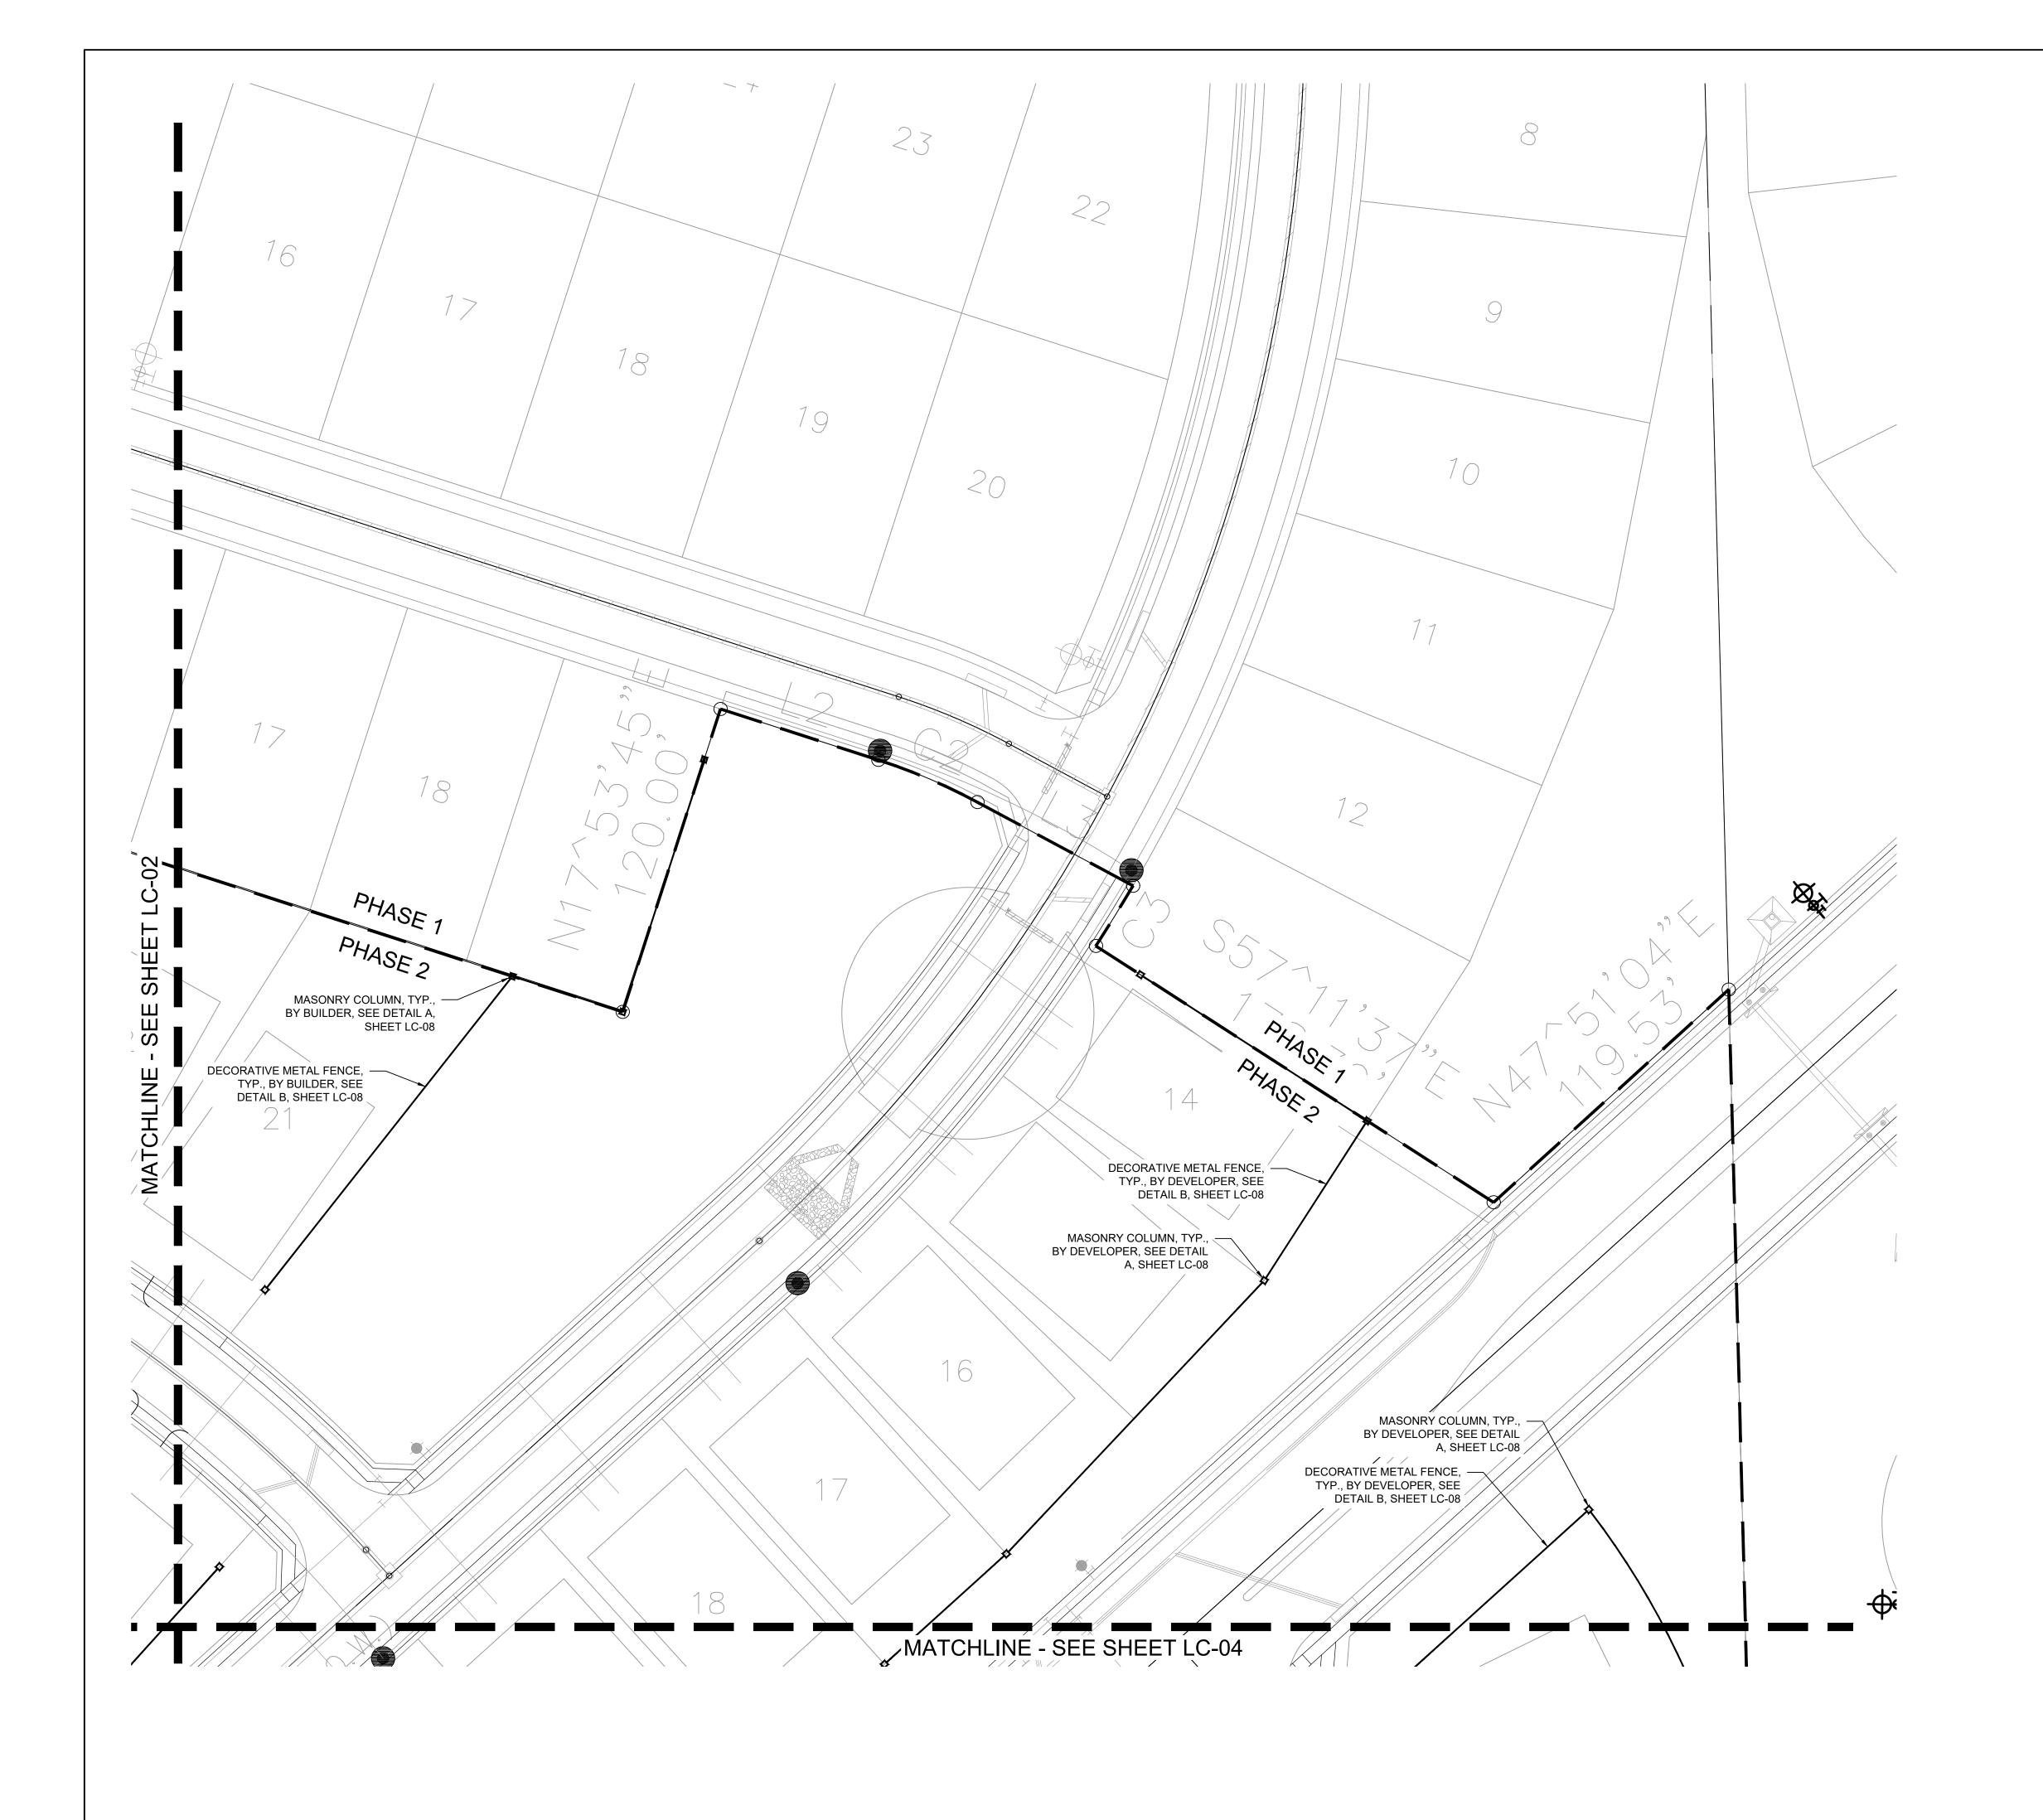
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- 5. PLAYGROUND SAFETY SURFACING ENGINEERED WOOD MULCH; SEE DETAIL C, SHEET LC-08.
- 6. SWINGS, SEE DETAIL D, SHEET LC-08.

SHEET LC-07.

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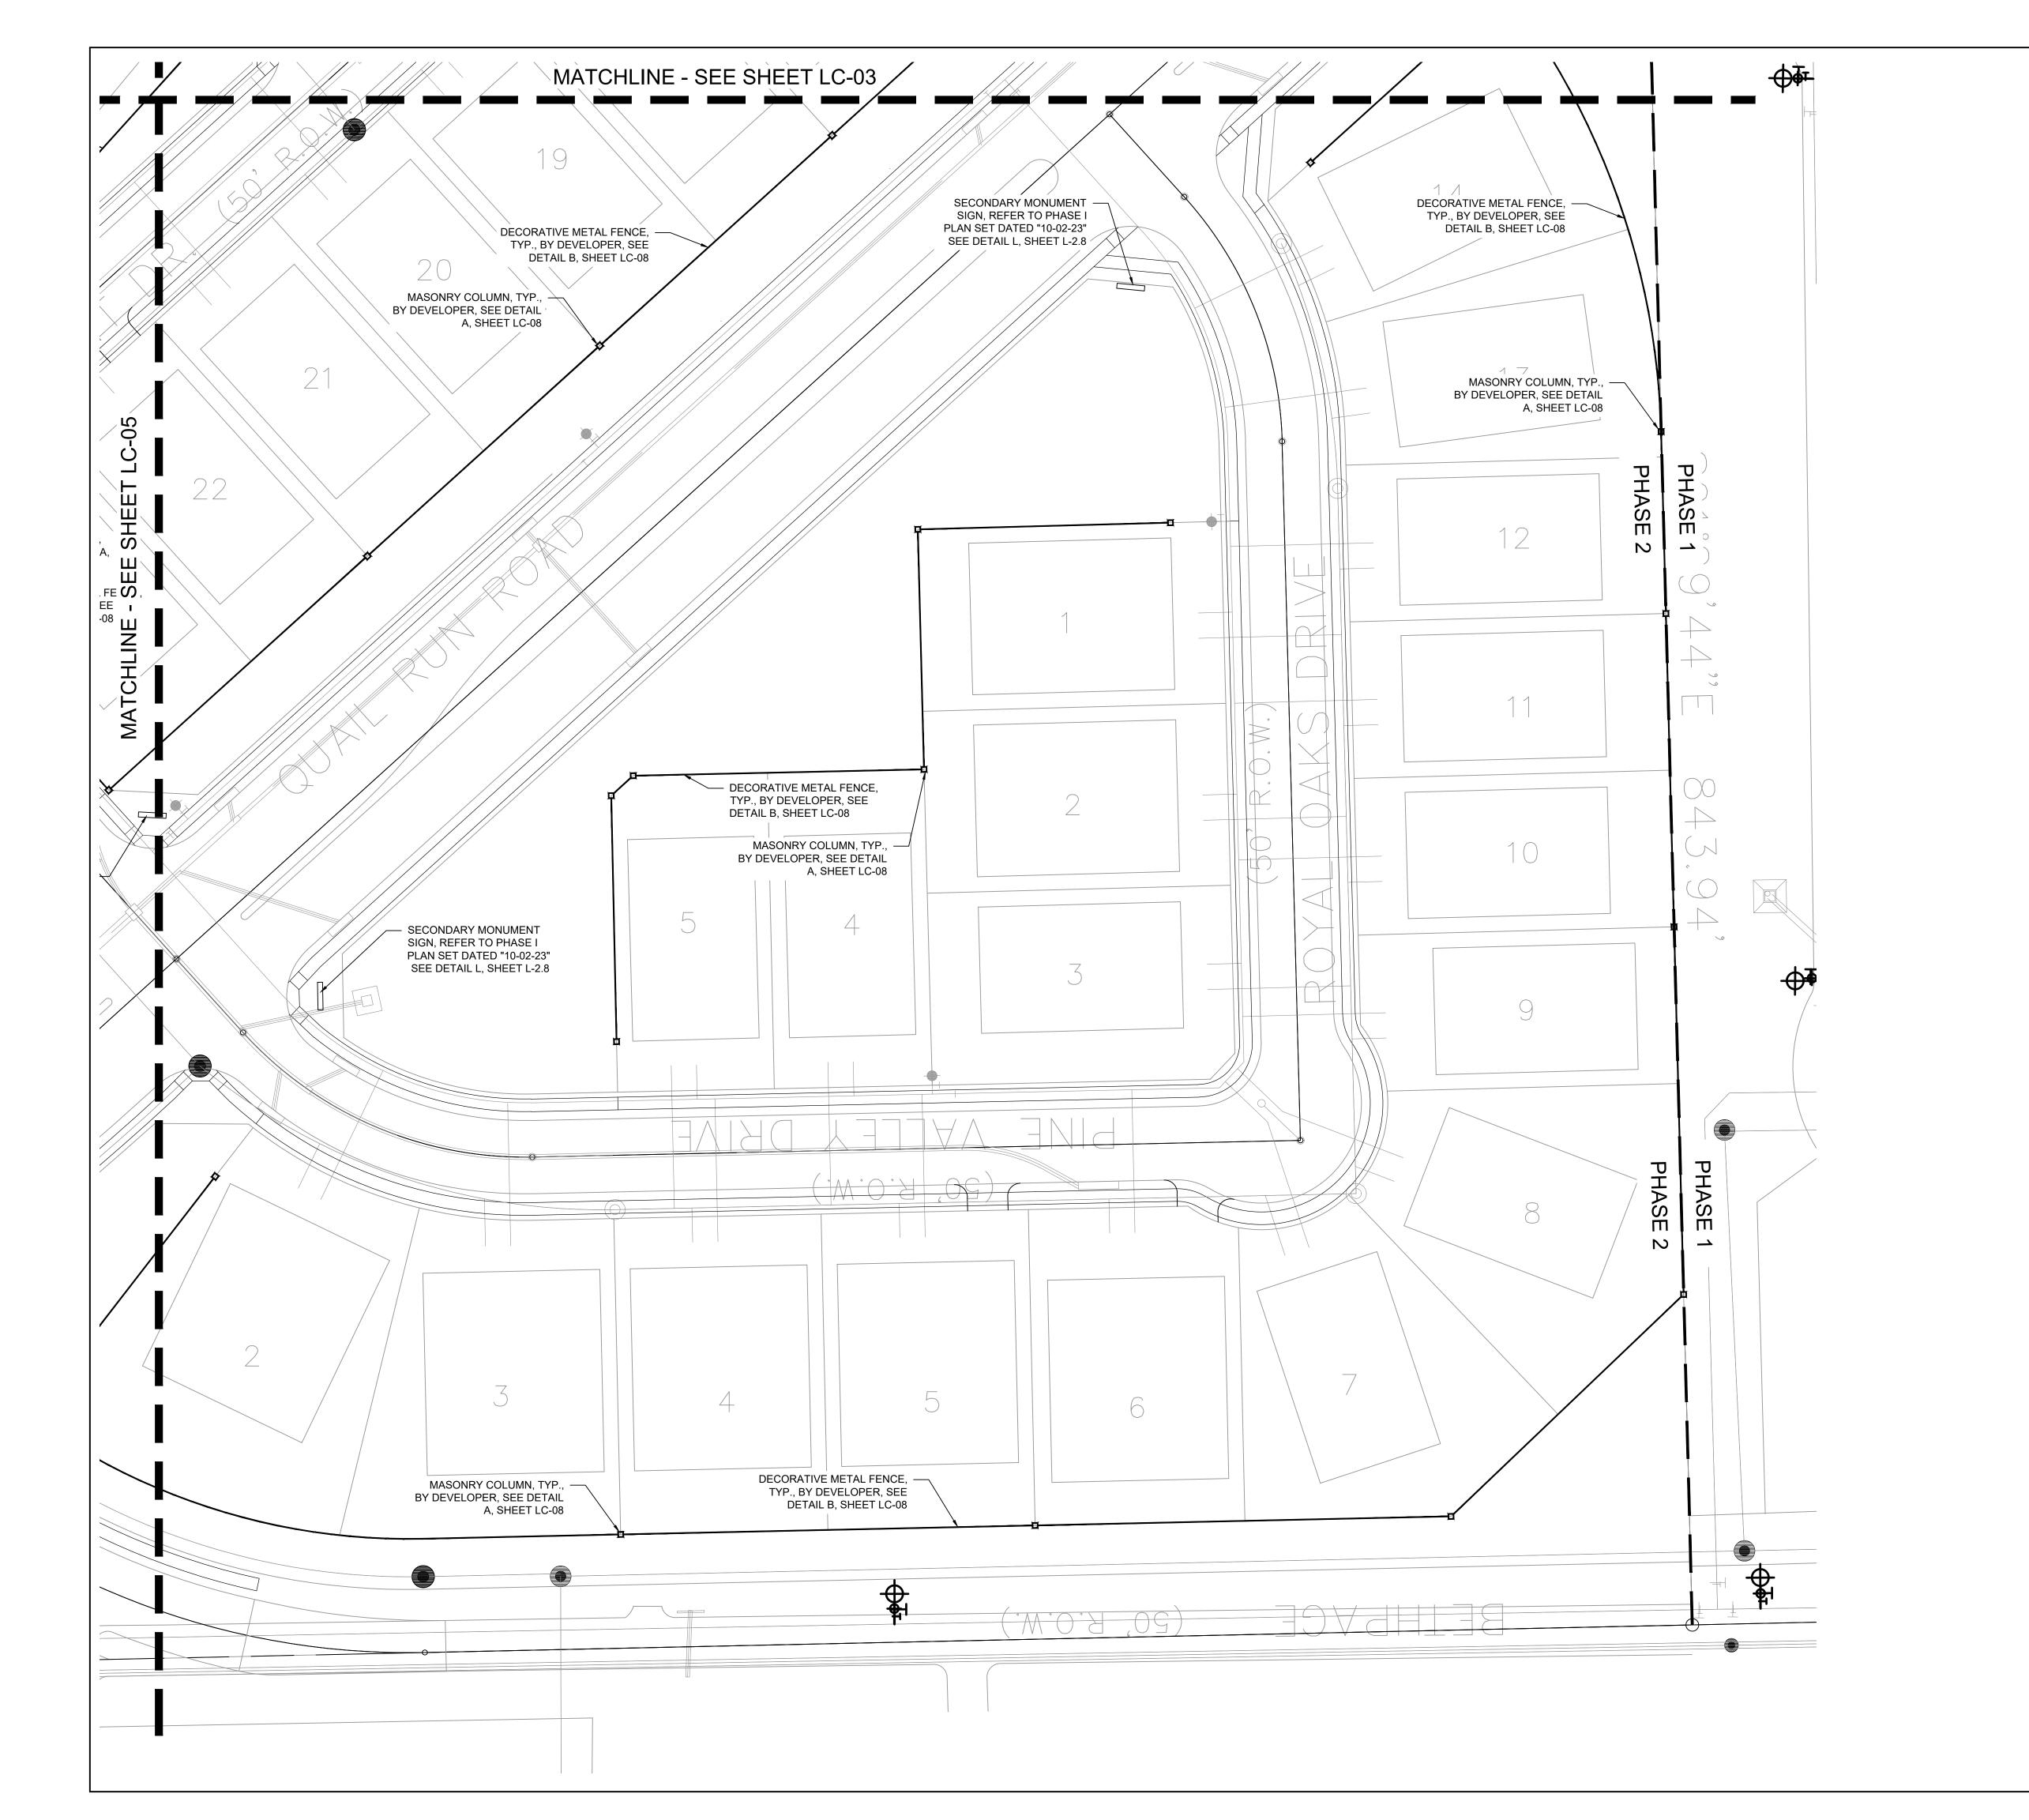
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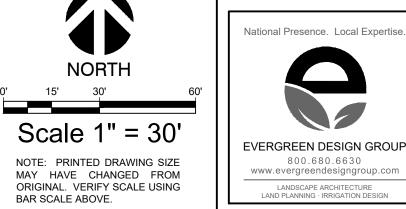
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 Date
 10/04/24

 Drawn By
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> > MARY N. BATES TEXAS L.A. #3613

MULCH; SEE DETAIL C, SHEET LC-08.

CONSTRUCTION LEGEND

4-IN THK. CONCRETE WALK, LIGHT BROOM FINISH, NATURAL GRAY COLOR; SEE DETAIL B, SHEET LC-07.

3. 4" CONCRETE PAD, LIGHT BROOM FINISH, NATURAL GRAY

4.) PLAYGROUND EQUIPMENT, SEE DETAIL D, SHEET LC-08

(5.) PLAYGROUND SAFETY SURFACING - ENGINEERED WOOD

COLOR; W/ SAWCUT CONTROL JOINTS; SEE DETAIL B,

2. EXPANSION JOINT WITH COLOR CAULK TO MATCH ADJACENT PAVEMENT. SEE DETAIL A, SHEET LC-07.

(MASTER LIST - NOT ALL ITEMS ARE ON EVERY SHEET)

6.) SWINGS, SEE DETAIL D, SHEET LC-08. (7.) MULTI SPORT COURT. SEE DETAIL D, SHEET LC-07.

8.) ADA RAMP. SEE DETAIL C, SHEET LC-07.

(9.) PRIMARY COLUMN. SEE DETAIL A, SHEET LC-08.

SHEET LC-07.

(10.) WROUGHT IRON FENCE W/ MASONRY COLUMN. SEE DETAIL A, SHEET LC-08.

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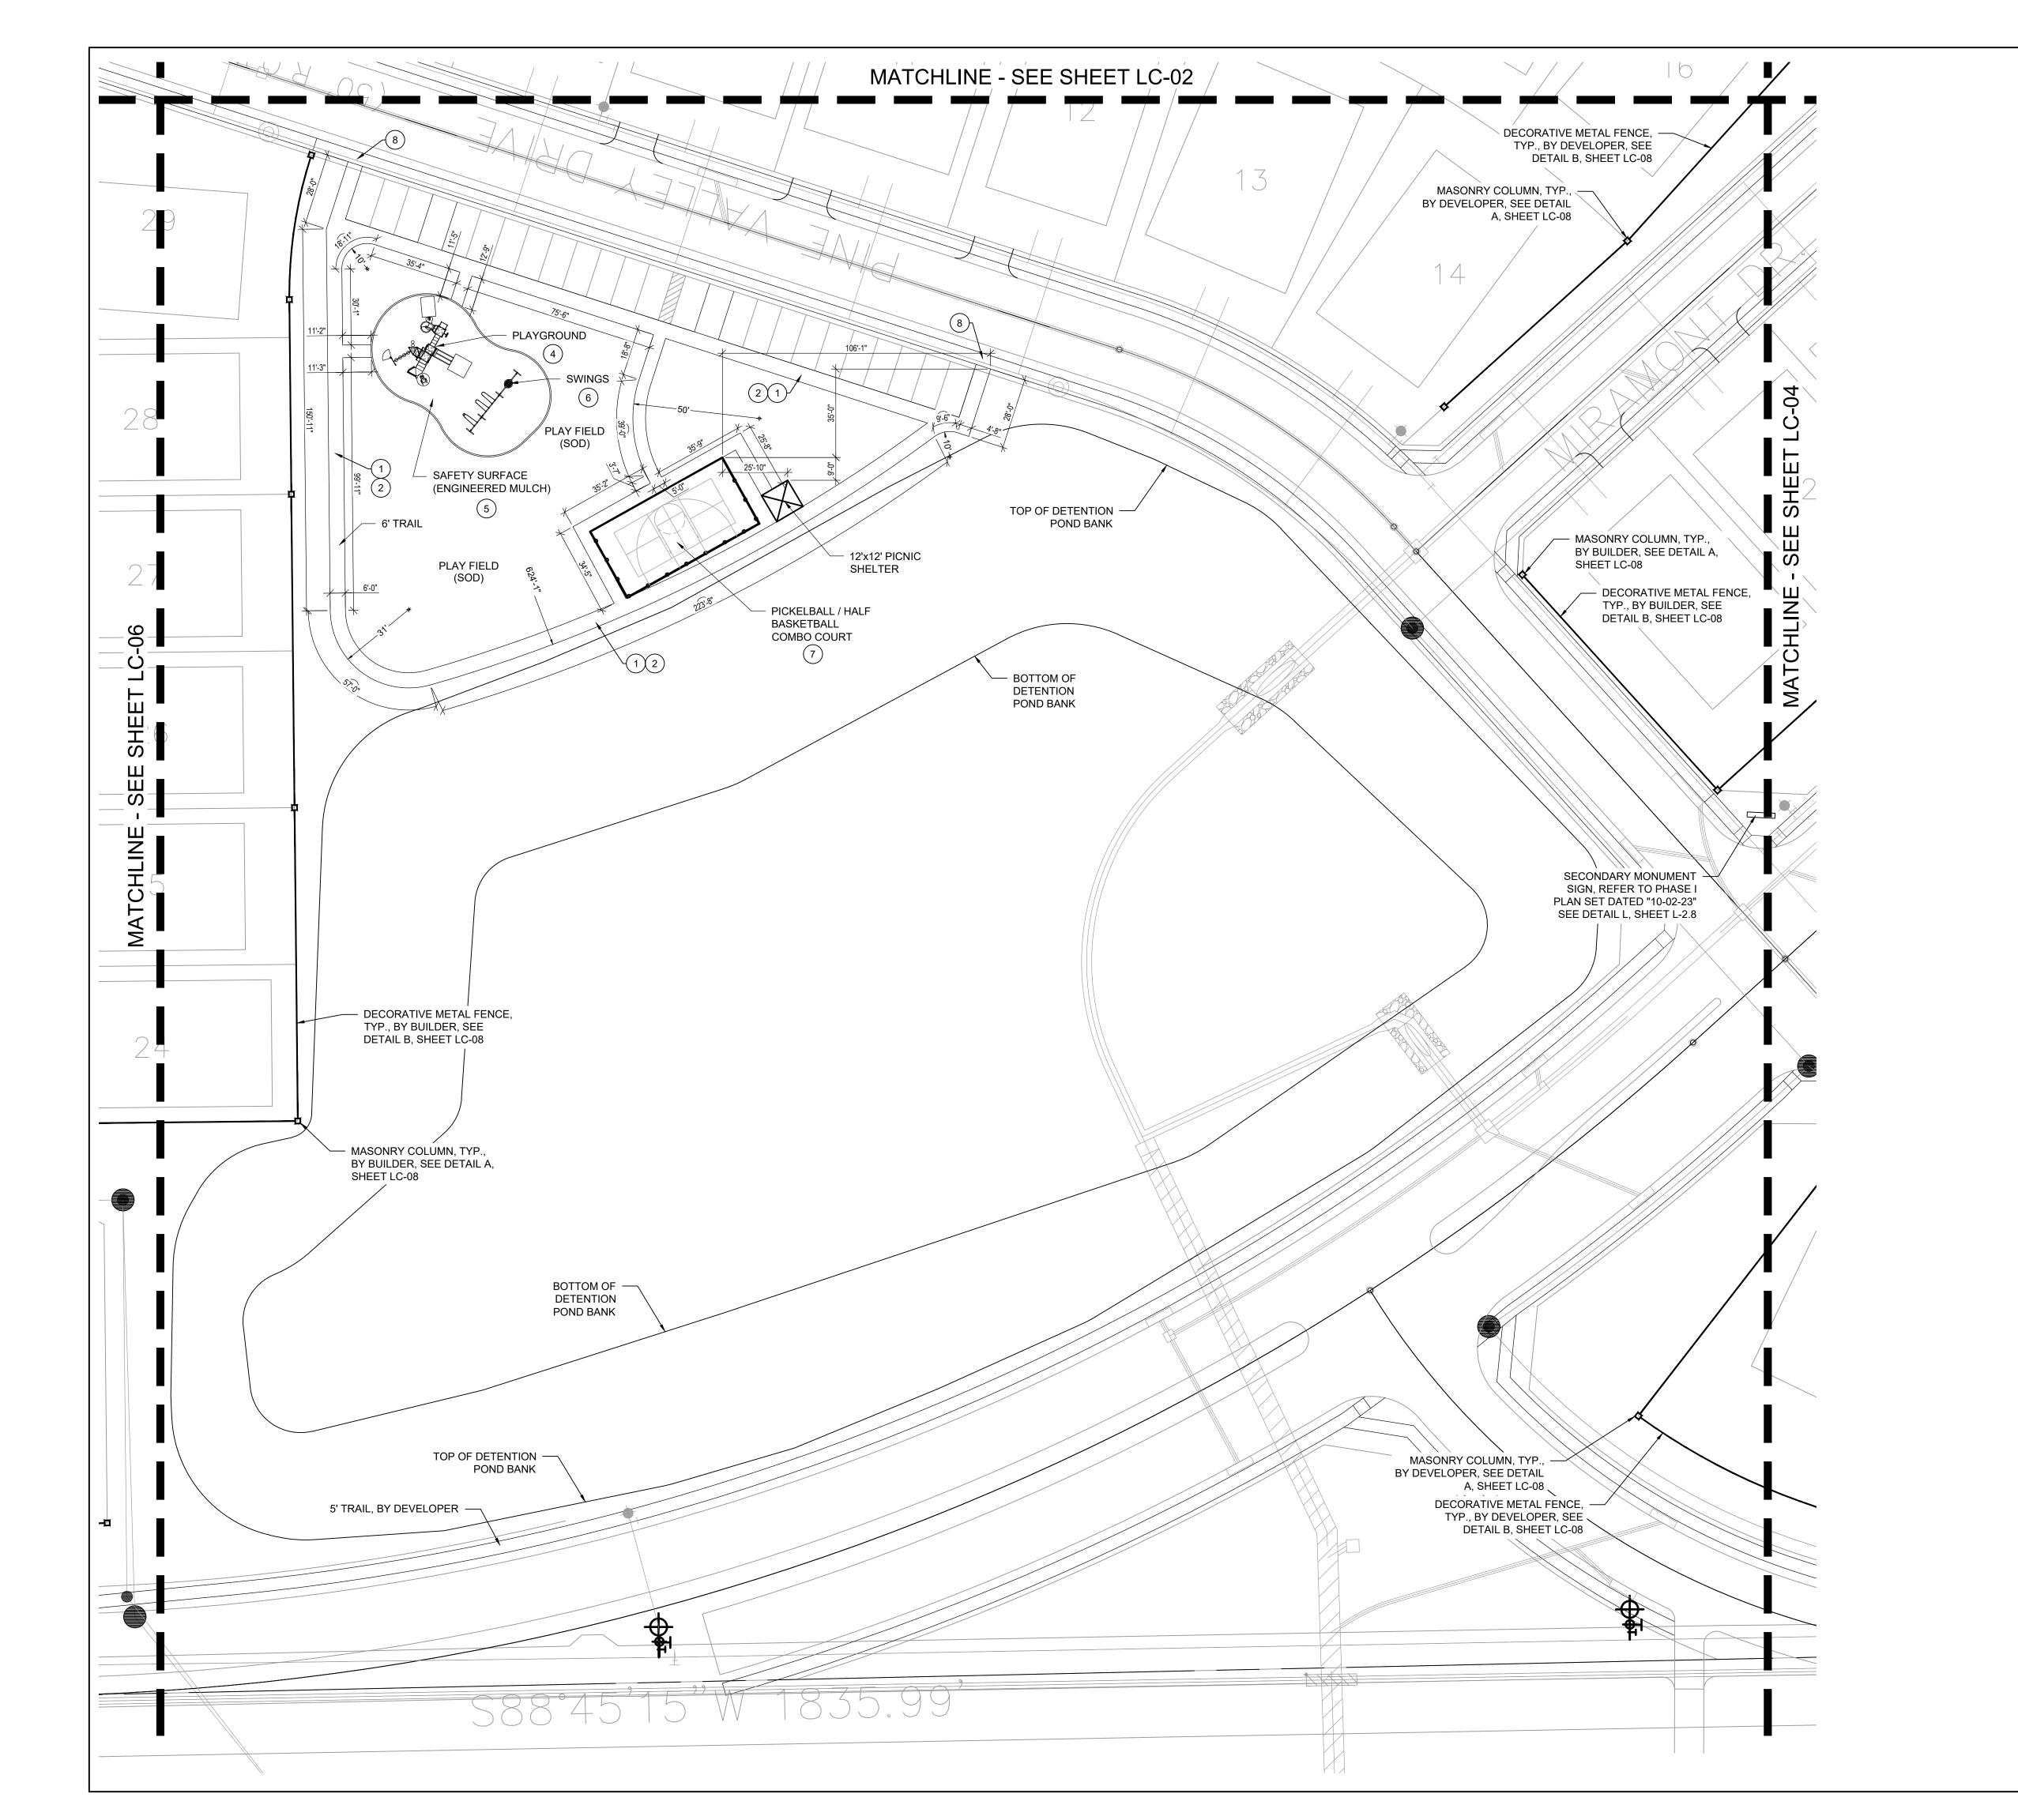
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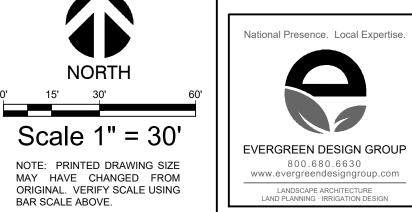
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HARDSCAPE PLAN

Date Comment

10/04/24 Drawn By





CONSTRUCTION LEGEND (MASTER LIST - NOT ALL ITEMS ARE ON EVERY SHEET)

SHEET LC-07.

4-IN THK. CONCRETE WALK, LIGHT BROOM FINISH, NATURAL GRAY COLOR; SEE DETAIL B, SHEET LC-07.

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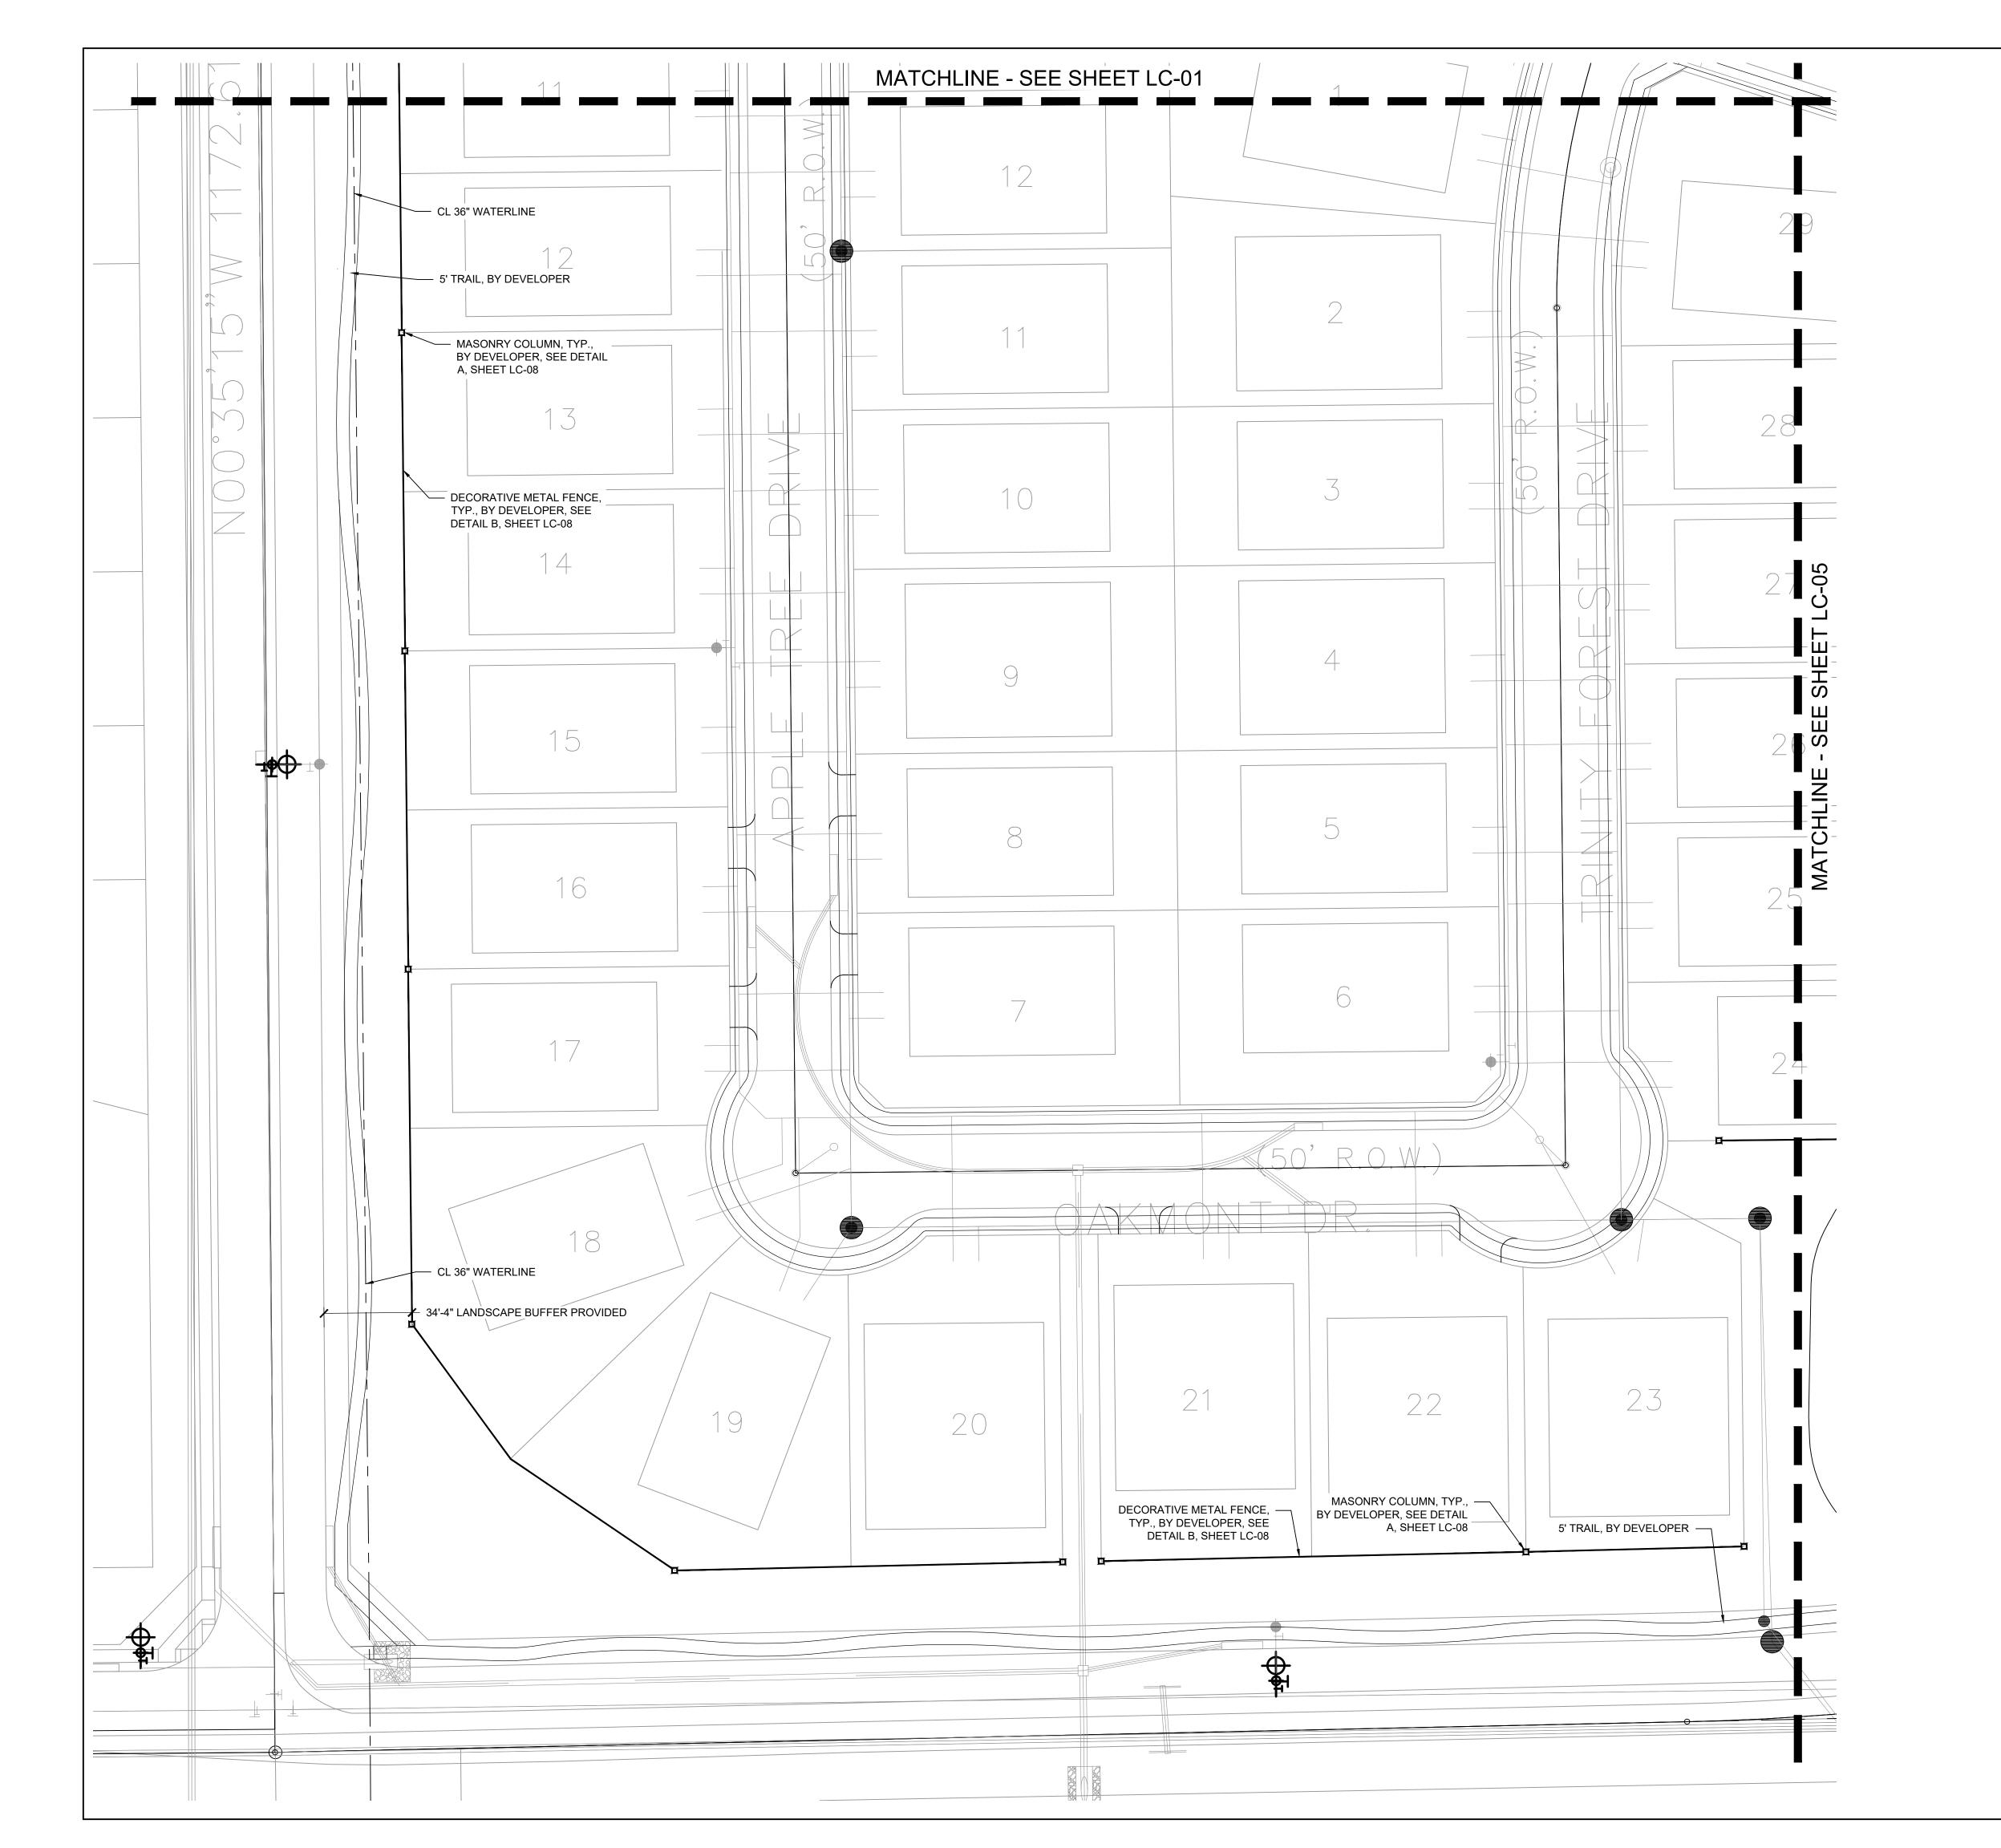
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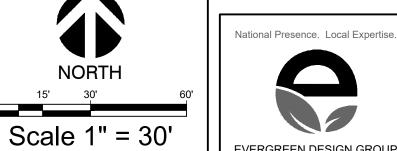
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HARDSCAPE PLAN

Date Comment

10/04/24 Drawn By





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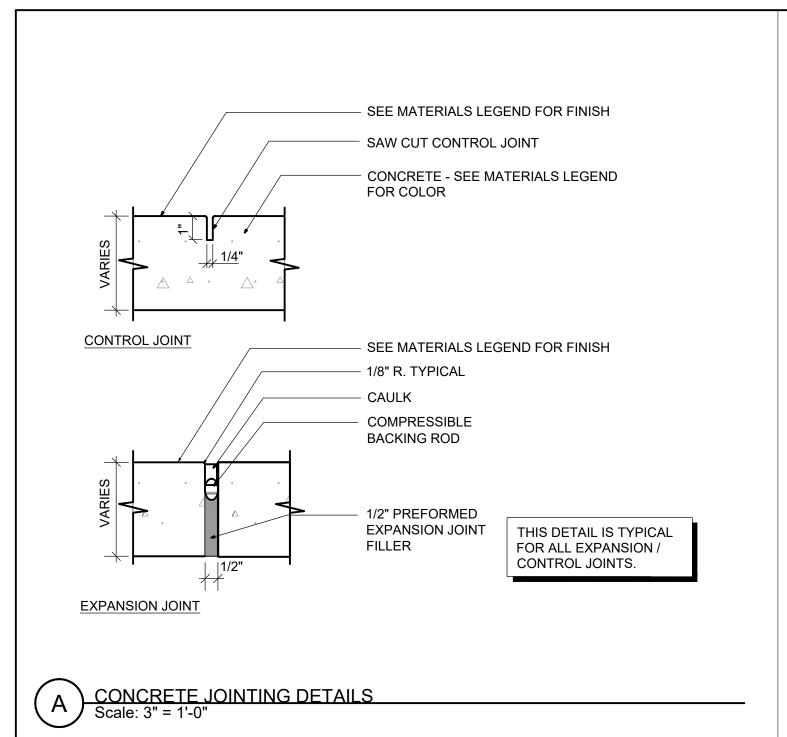
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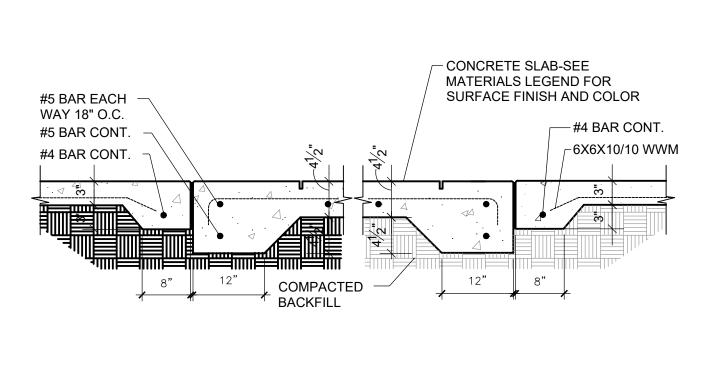
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Quail Hollow Rockwall, TX


HARDSCAPE PLAN

Date Comment





B CONCRETE PAVEMENT - LIGHT DUTY
Scale: 3/4" = 1'-0"

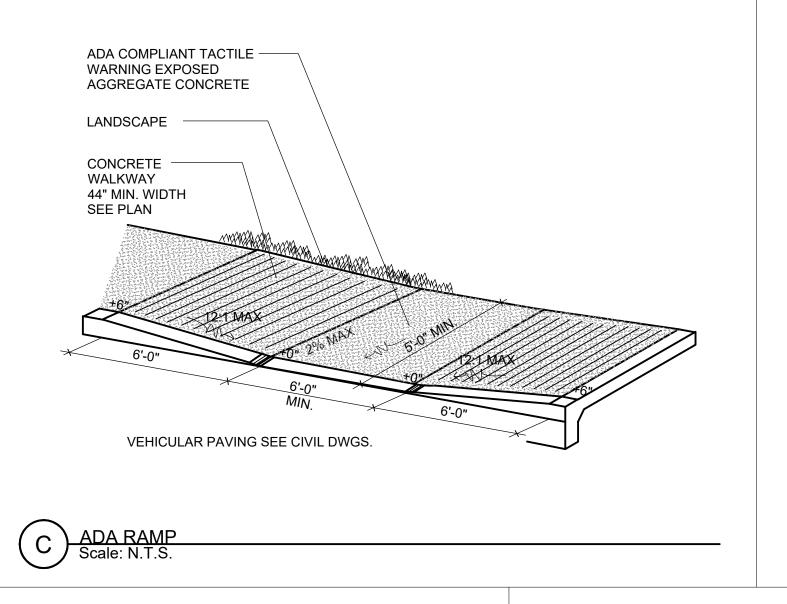



COURT BUILDER "



MANUFACTURER: SPORT COURT SUPPLIER: NEXCOURT CONTACT: CHRIS WALKER PHONE: 972-898-7529 COLORS: TBD OPTIONS: 30'X60' MULTI-SPORT COURT, 1/2 BASKETBALL, PICKLEBALL, 2 SINGLE LIGHTS, FULL 3 SIDES BLACK VINYL COATED CHAIN LINK FENCE BACKSTOP PICKLE BALL COURT FENCE NOTE: 8' HIGH FENCE AT REAR OF COURT. 4' HIGH FENCE AT SIDES OF COURT.



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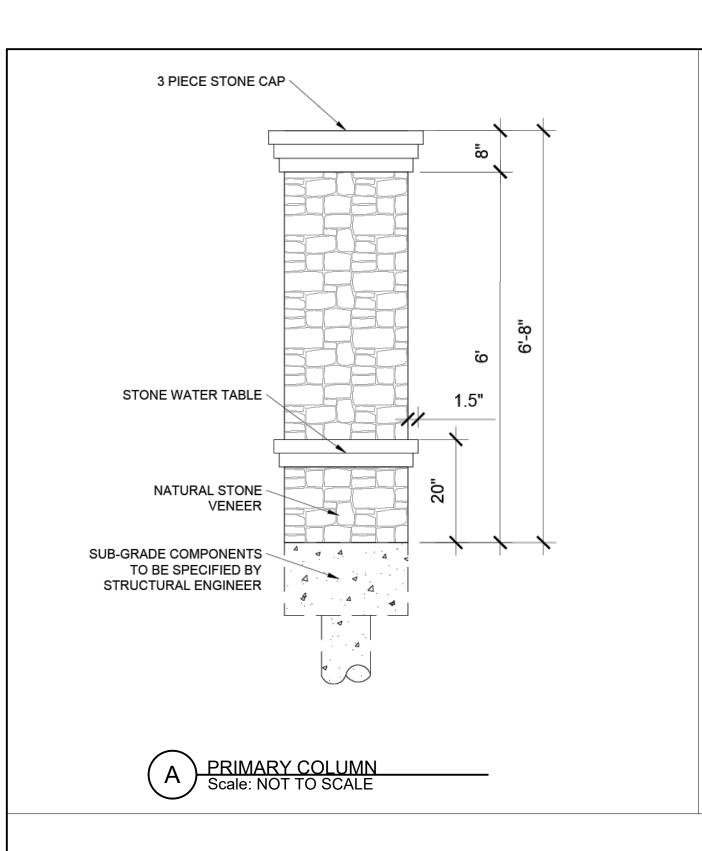
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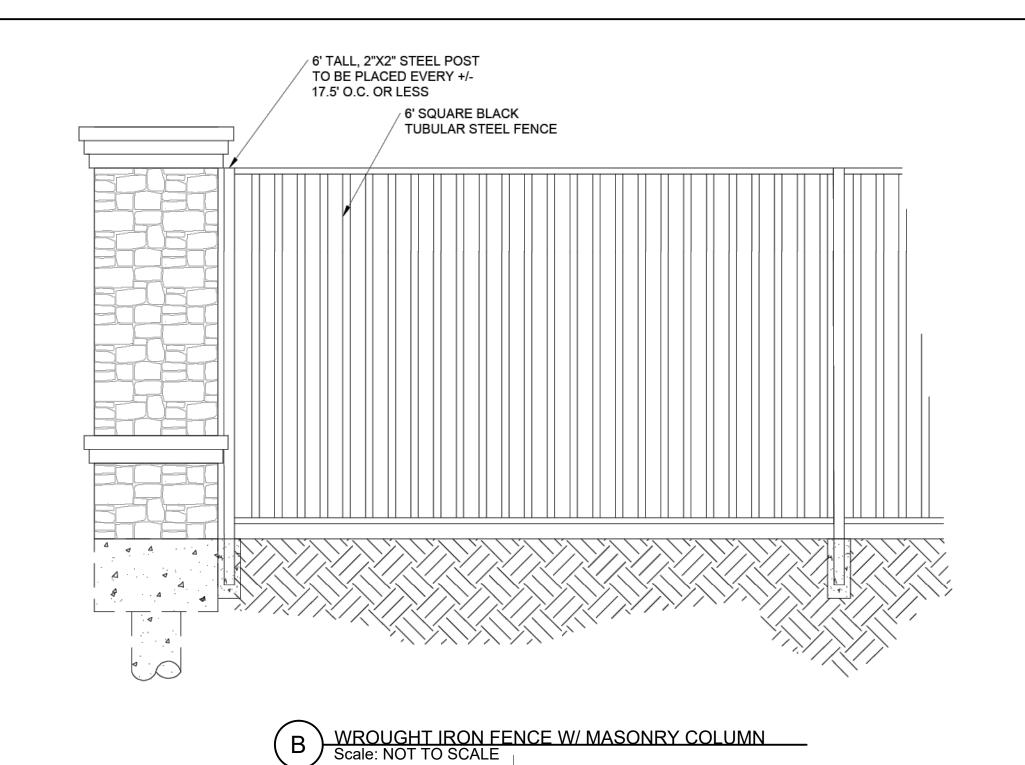
Comparie Drive, Suite Skorburg (8214 Westchester I Dallas, Texas 75225

Hollow LTX Quail Rockwall,

HARDSCAPE DETAILS

Date Comment





— ACCESSIBLE CONCRETE RAMP INSIDE EDGE OF RAMP -----FIBAR® WOOD FIBER MUST FALL OUTSIDE ASTM USE ZONE ← FIBAR® WOOD FIBER SLOPE>1% ABOVE GROUND INSTALLATION ABOVE GROUND INSTALLATION ACCESSIBILITY DETAIL

1. INSTALLATION TO BE COMPLETED IN ACCORDANCE WITH MANUFACTURER'S SPECIFICATIONS.

2. DO NOT SCALE DRAWING. 3. THIS DRAWING IS INTENDED FOR USE BY ARCHITECTS, ENGINEERS, CONTRACTORS, CONSULTANTS AND DESIGN PROFESSIONALS

FOR PLANNING PURPOSES ONLY. THIS DRAWING MAY NOT BE USED FOR CONSTRUCTION. 4. ALL INFORMATION CONTAINED HEREIN WAS CURRENT AT THE TIME OF DEVELOPMENT BUT MUST BE REVIEWED AND APPROVED BY

THE PRODUCT MANUFACTURER TO BE CONSIDERED ACCURATE. 5. CONTRACTOR'S NOTE: FOR PRODUCT AND COMPANY INFORMATION VISIT www.CADdetails.com/info AND ENTER

THE FIBAR GROUP LLC 80 BUSINESS PARK DRIVE, SUITE 300 ARMONK, NY 10504 TOLL FREE: 1-800-342-2721 PHONE: (914) 273-8770 FAX: (914) 273-8659

www.fibar.com

ENGINEERED WOOD FIBER PLAYGROUND SAFETY SURFACING
Scale: NOT TO SCALE



MANUFACTURER: LITTLE TYKES SUPPLIER: LEA PARK & PLAY PHONE: (972) 690-8163 COLORS: TBD MODEL: R0306_45555298831



NOTES:

1. INSTALL ALL SHELTER ELEMENTS PER
MANUFACTURER'S RECOMMENDATIONS.

2. CONTRACTOR TO PROVIDE SIGNED AND SEALED
STRUCTURAL DRAWINGS FOR REVIEW PRIOR TO INSTALLATION. INSTALL WITH 12'X20' (4") CONCRETE SLAB.

MODEL: 12' X 12' NAVAJO SHELTER MANUFACTURER: AMERICANA BUILDING PRODUCTS CONTACT: LEA PARK & PLAY NICK BOLLIG, (940) 205-2761

SHELTER DETAILS



NOTES:

1. SURFACE MOUNT TO SHELTER SLAB

2. SUBMIT COLORS TO MATCH PLAYGROUND EQUIPMENT FOR APPROVAL PRIOR TO ORDERING.

MODEL: 8' RECTANGULAR EXPANDED STEEL ADA TABLE MANUFACTURER: ANOVA CONTACT: LEA PARK & PLAY NICK BOLLIG, (940) 205-2761

PICNIC TABLE



NOTES:

1. SURFACE MOUNT TO 4" CONCRETE SLAB
2. SUBMIT COLORS TO MATCH PLAYGROUND
EQUIPMENT FOR APPROVAL PRIOR TO ORDERING.

SCALE: NOT TO SCALE

NICK BOLLIG, (940) 205-2761

MODEL: 6' LATITUDE CONTOUR BENCH MANUFACTURER: ANOVA CONTACT: LEA PARK & PLAY

National Presence. Local Expertise EVERGREEN DESIGN GROUP 800.680.6630 www.evergreendesigngroup.com

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> MARY N. BATES TEXAS L.A. #3613

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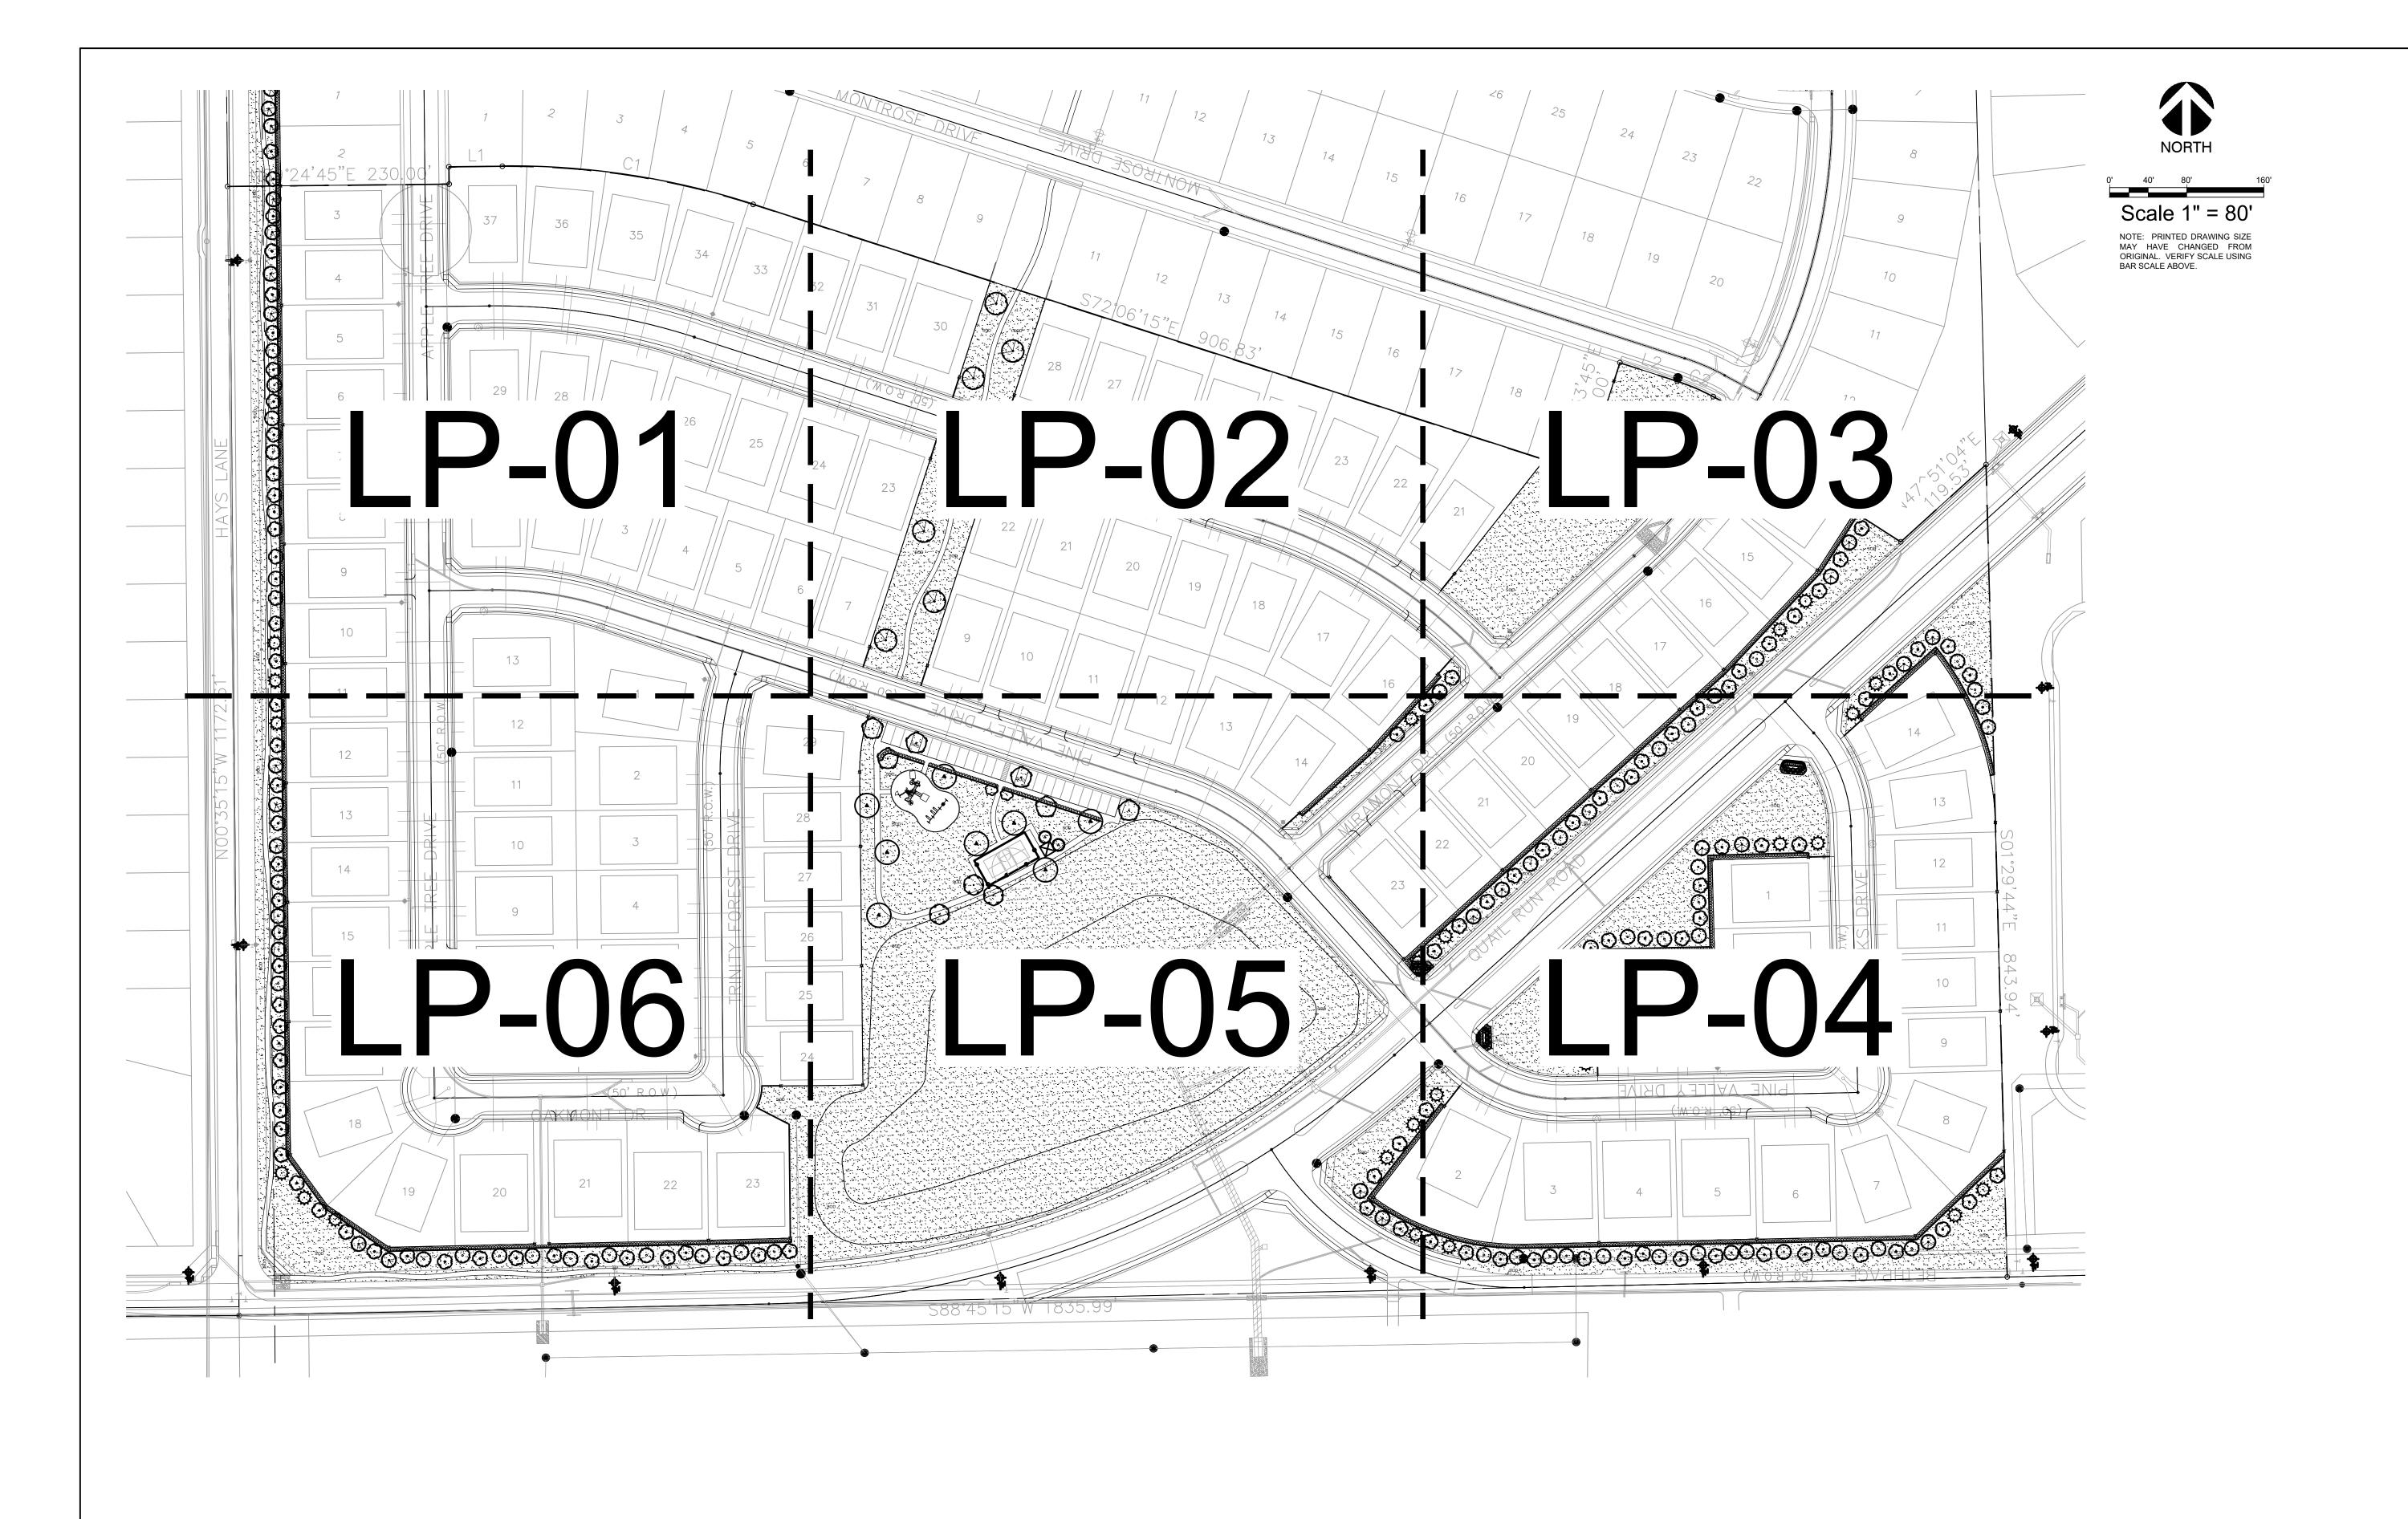
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HARDSCAPE DETAILS

Date Comment

Project Number

10/04/24 Drawn By Checked By





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MARY N. BATES TEXAS L.A. #3613 ISSUED ON: OCTOBER 04, 2024

urg Company tchester Drive, Suite 900 (as 75225

Skorburg (8214 Westchester | Dallas, Texas 75225

Quail Hollow Rockwall, TX

OVERALL HARDSCAPE PLAN


Date Comment

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Date 10/04/24

Drawn By KB

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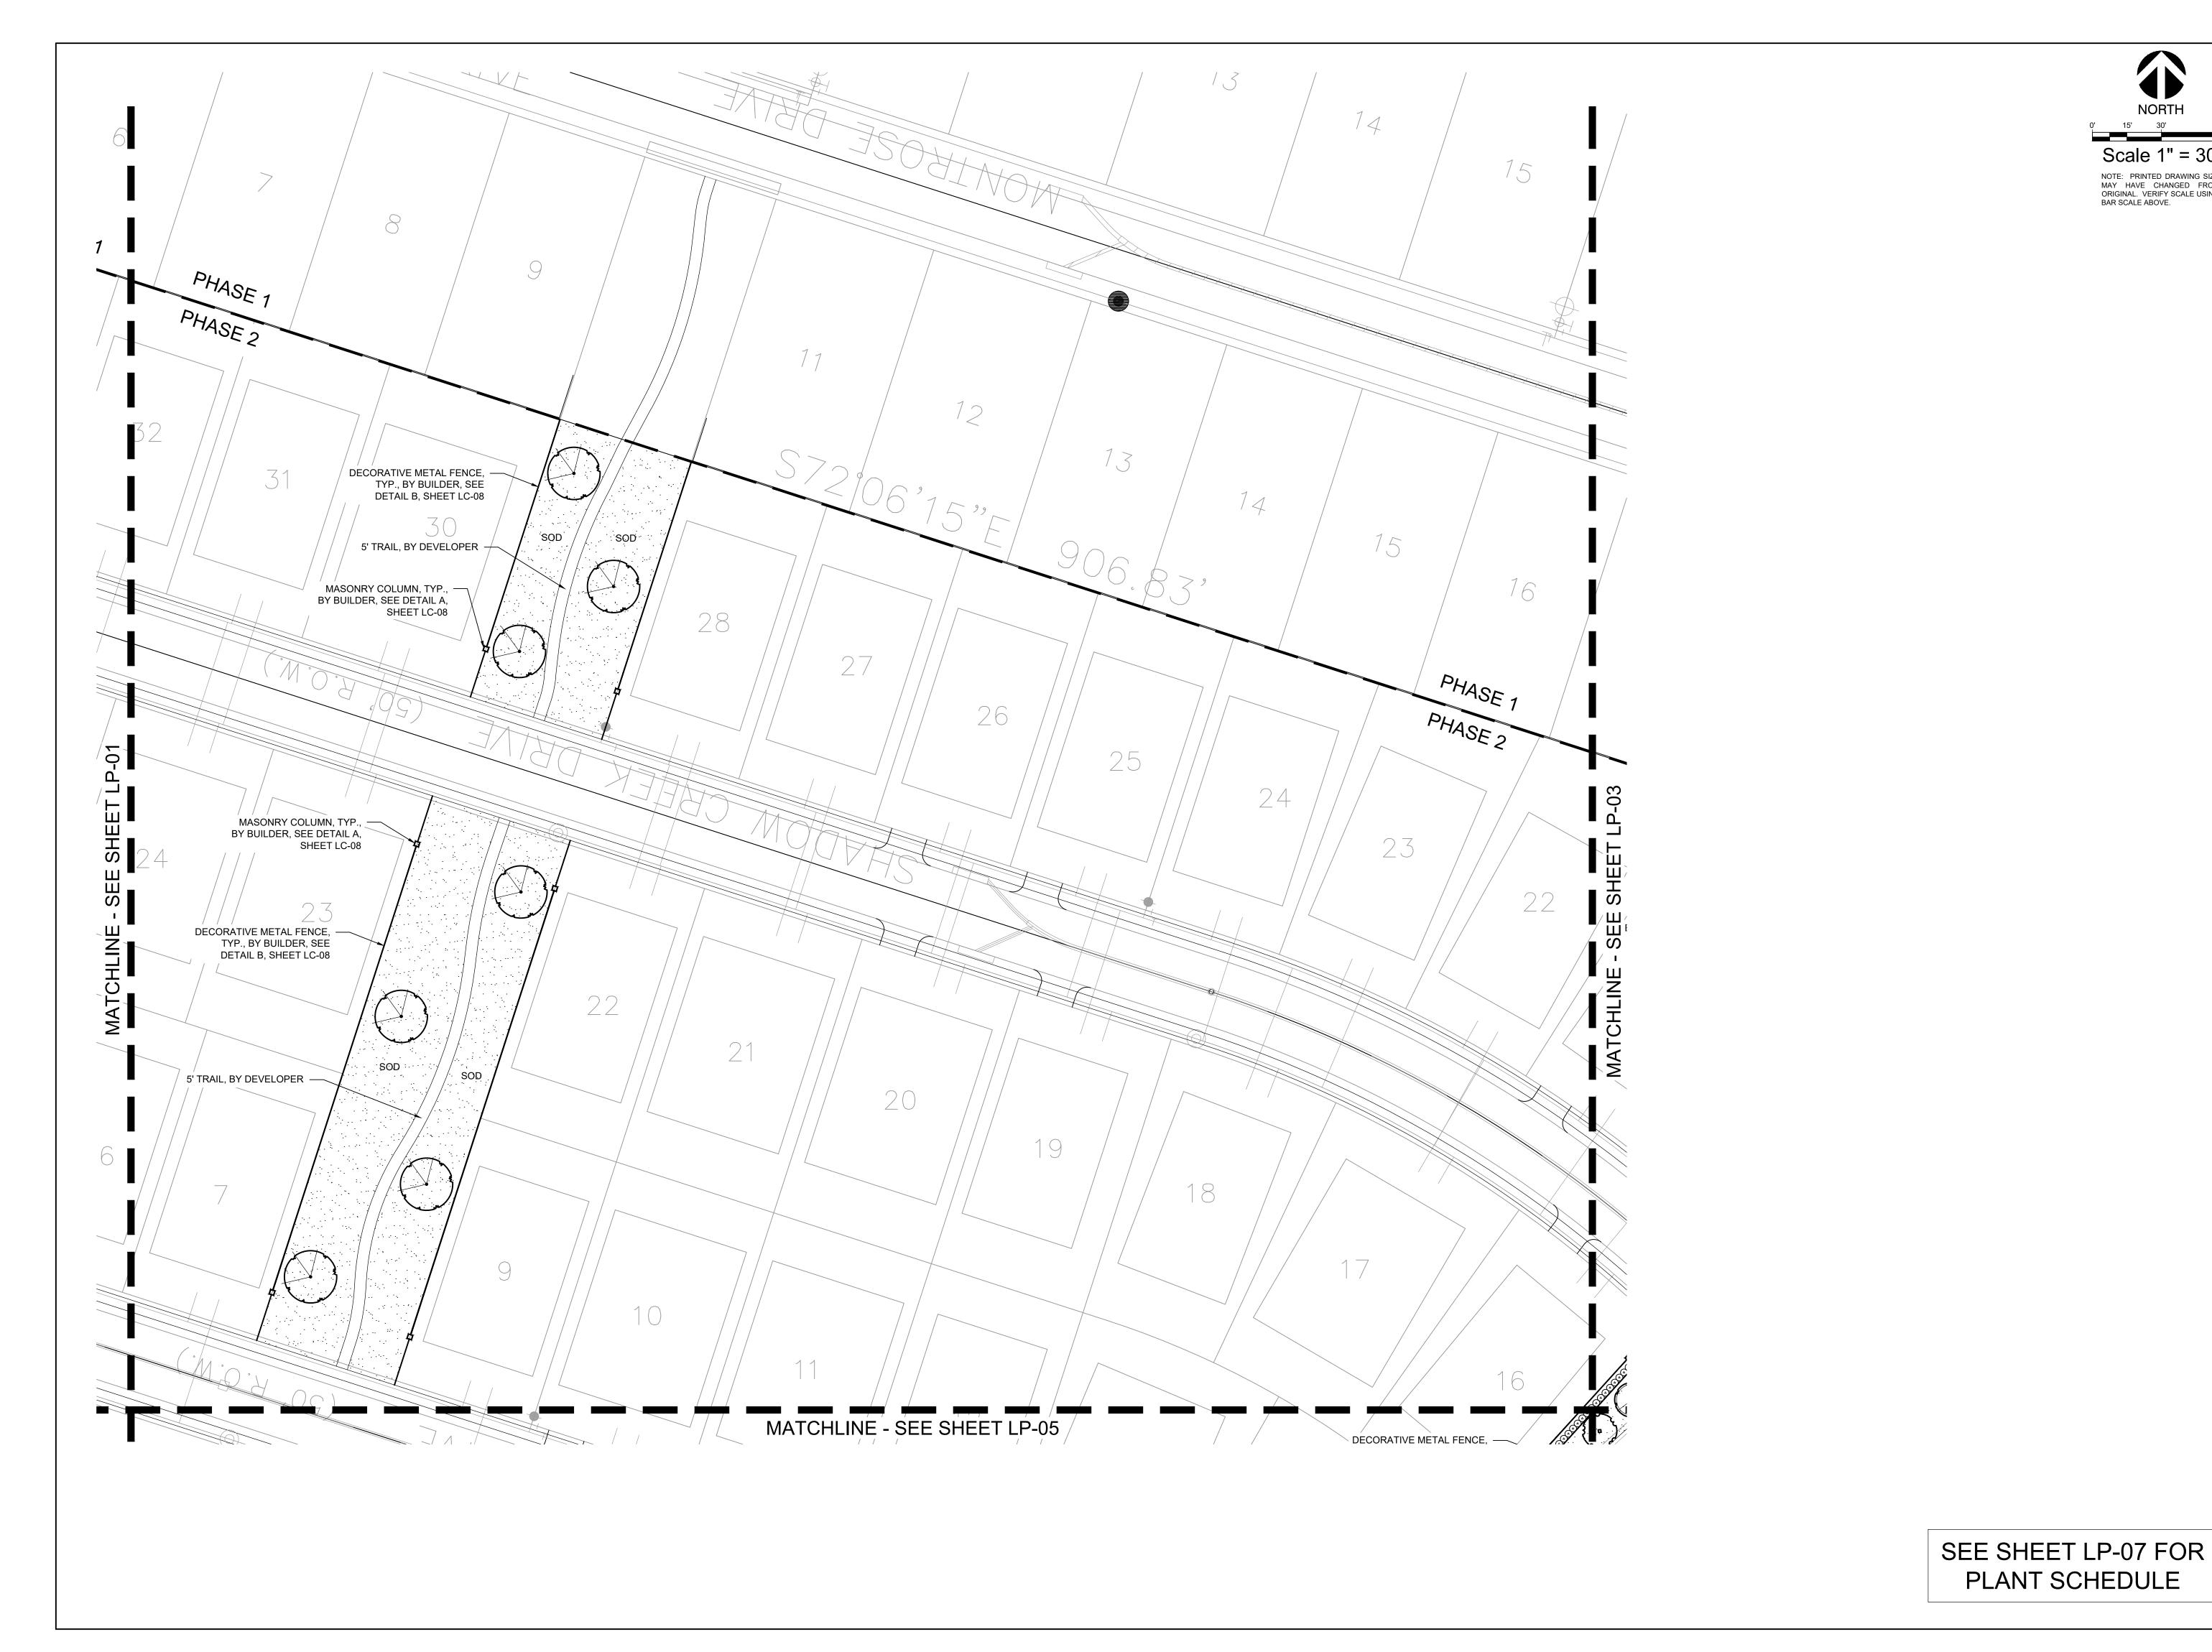
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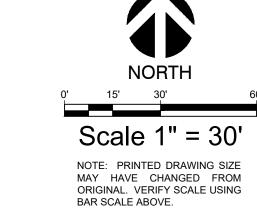
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Quail Hollow Rockwall, TX

HARDSCAPE PLAN

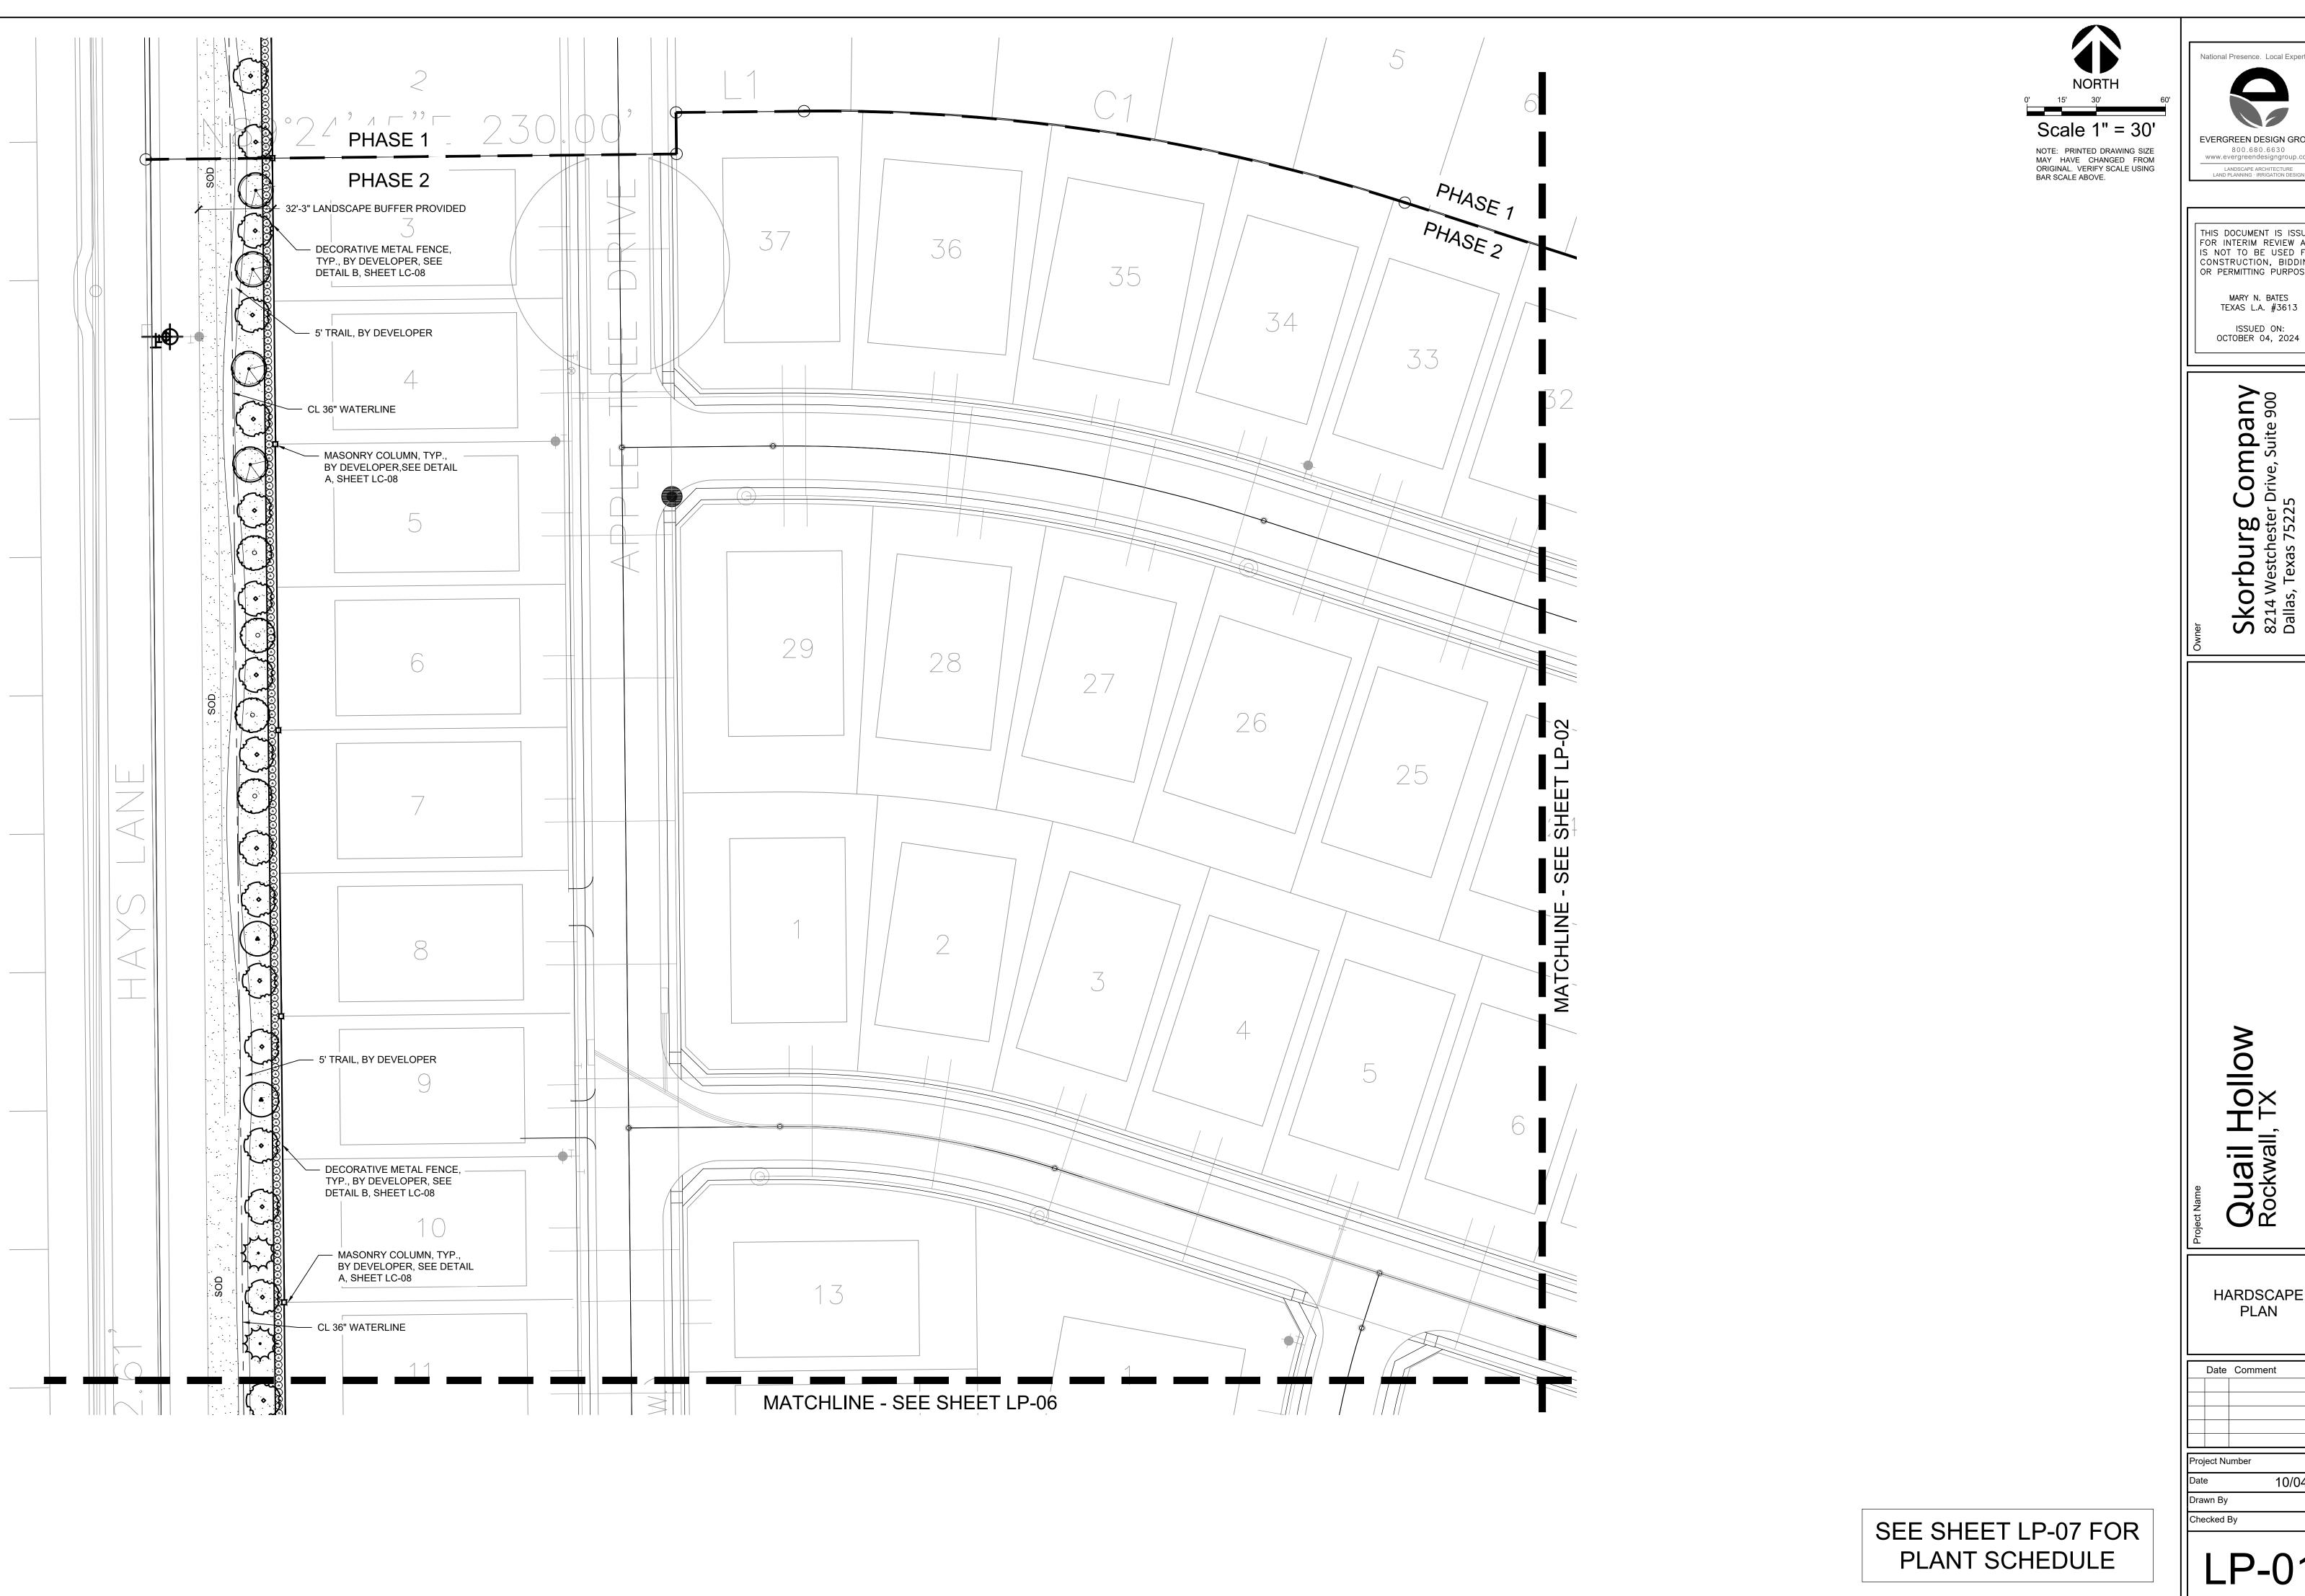Date Comment








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HARDSCAPE PLAN

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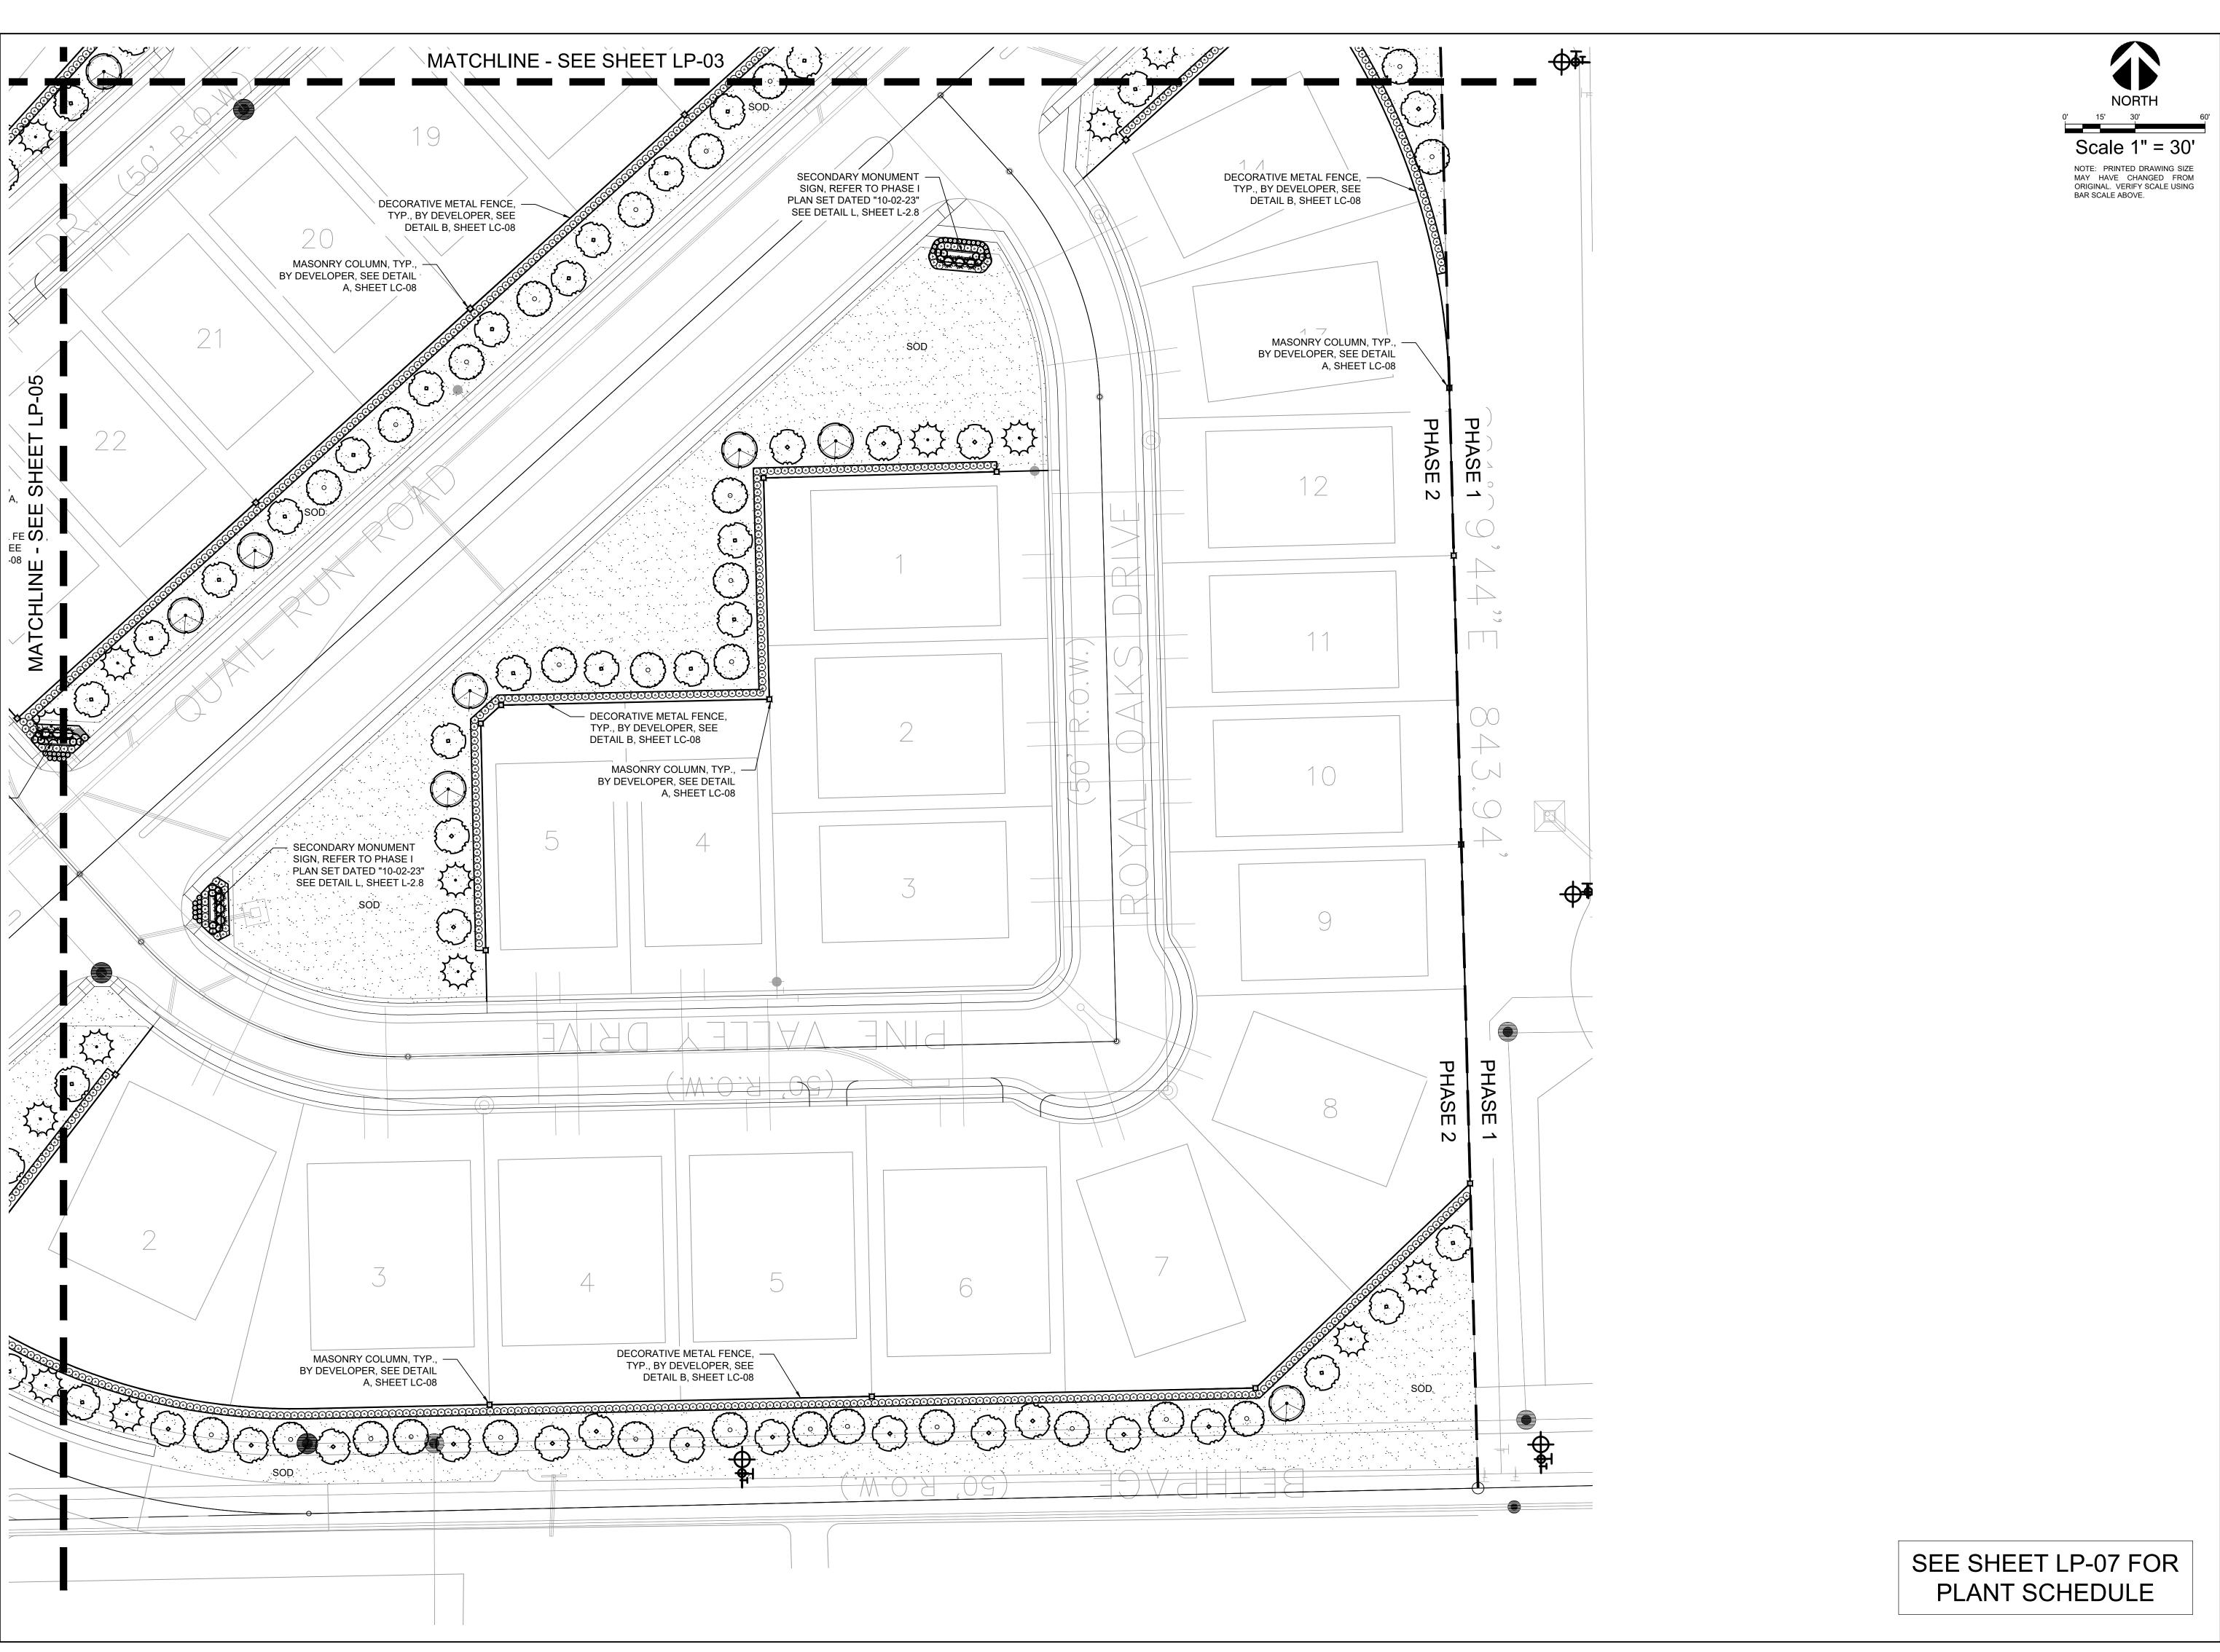
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HARDSCAPE PLAN

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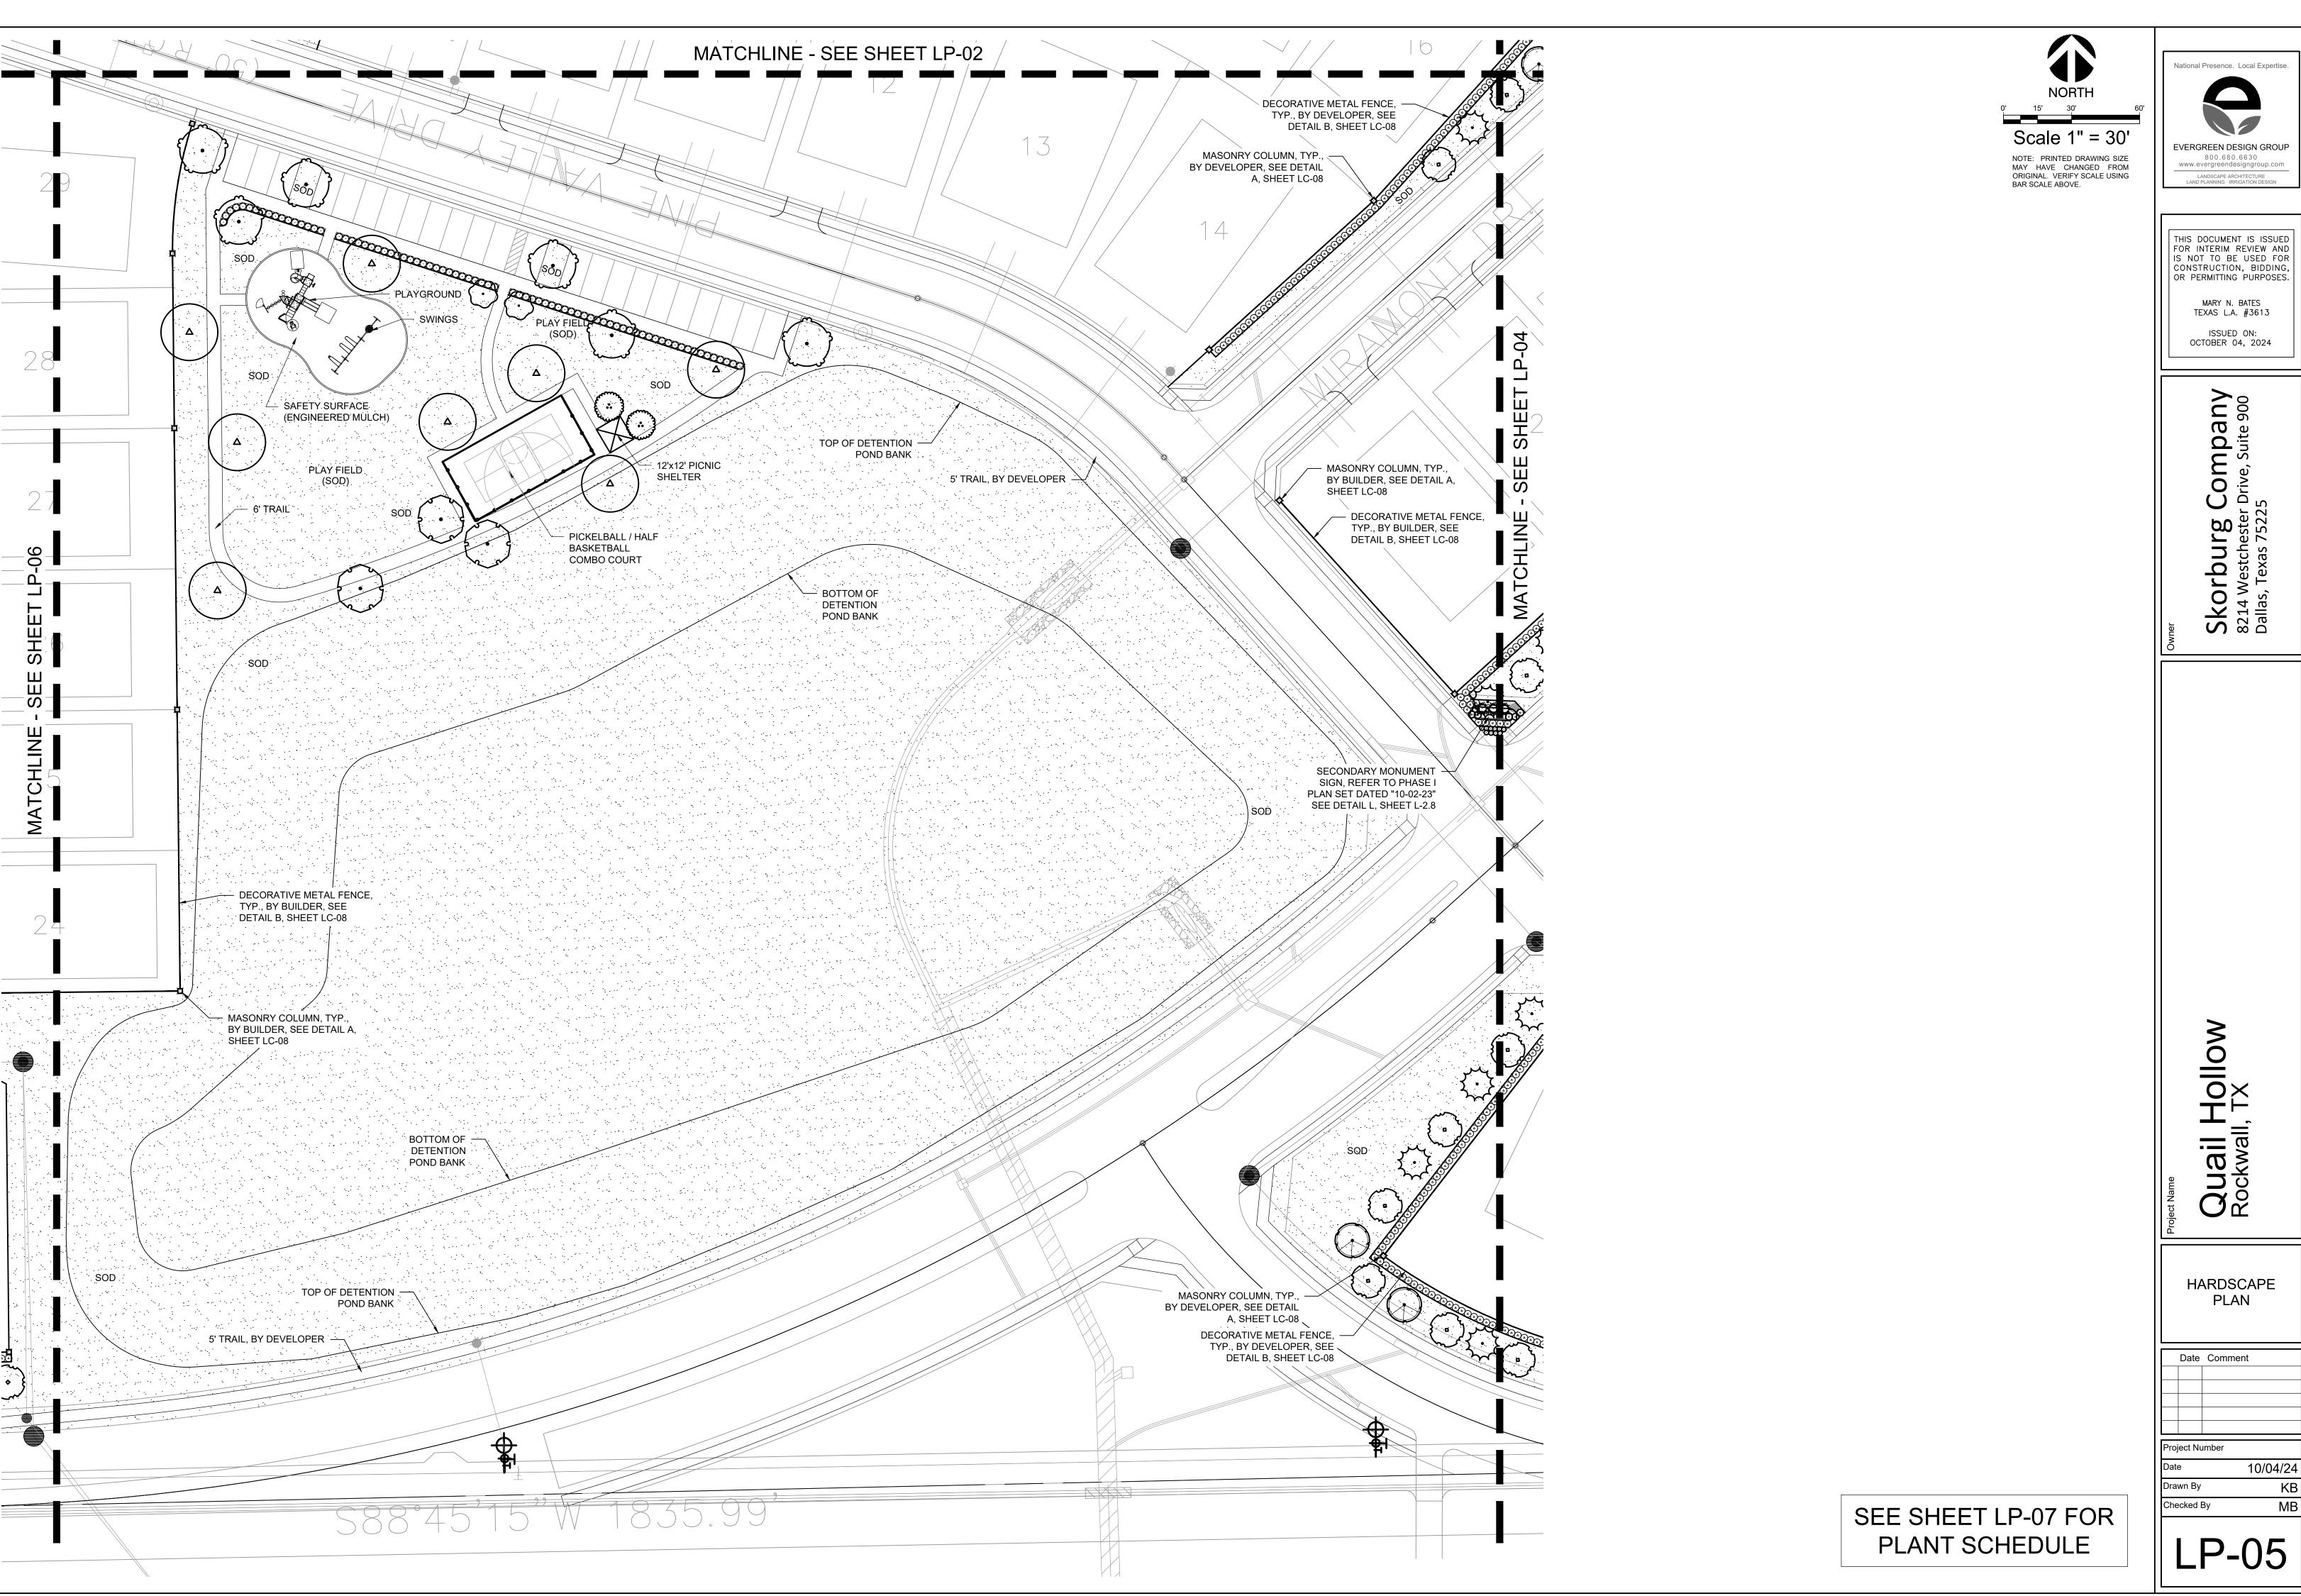
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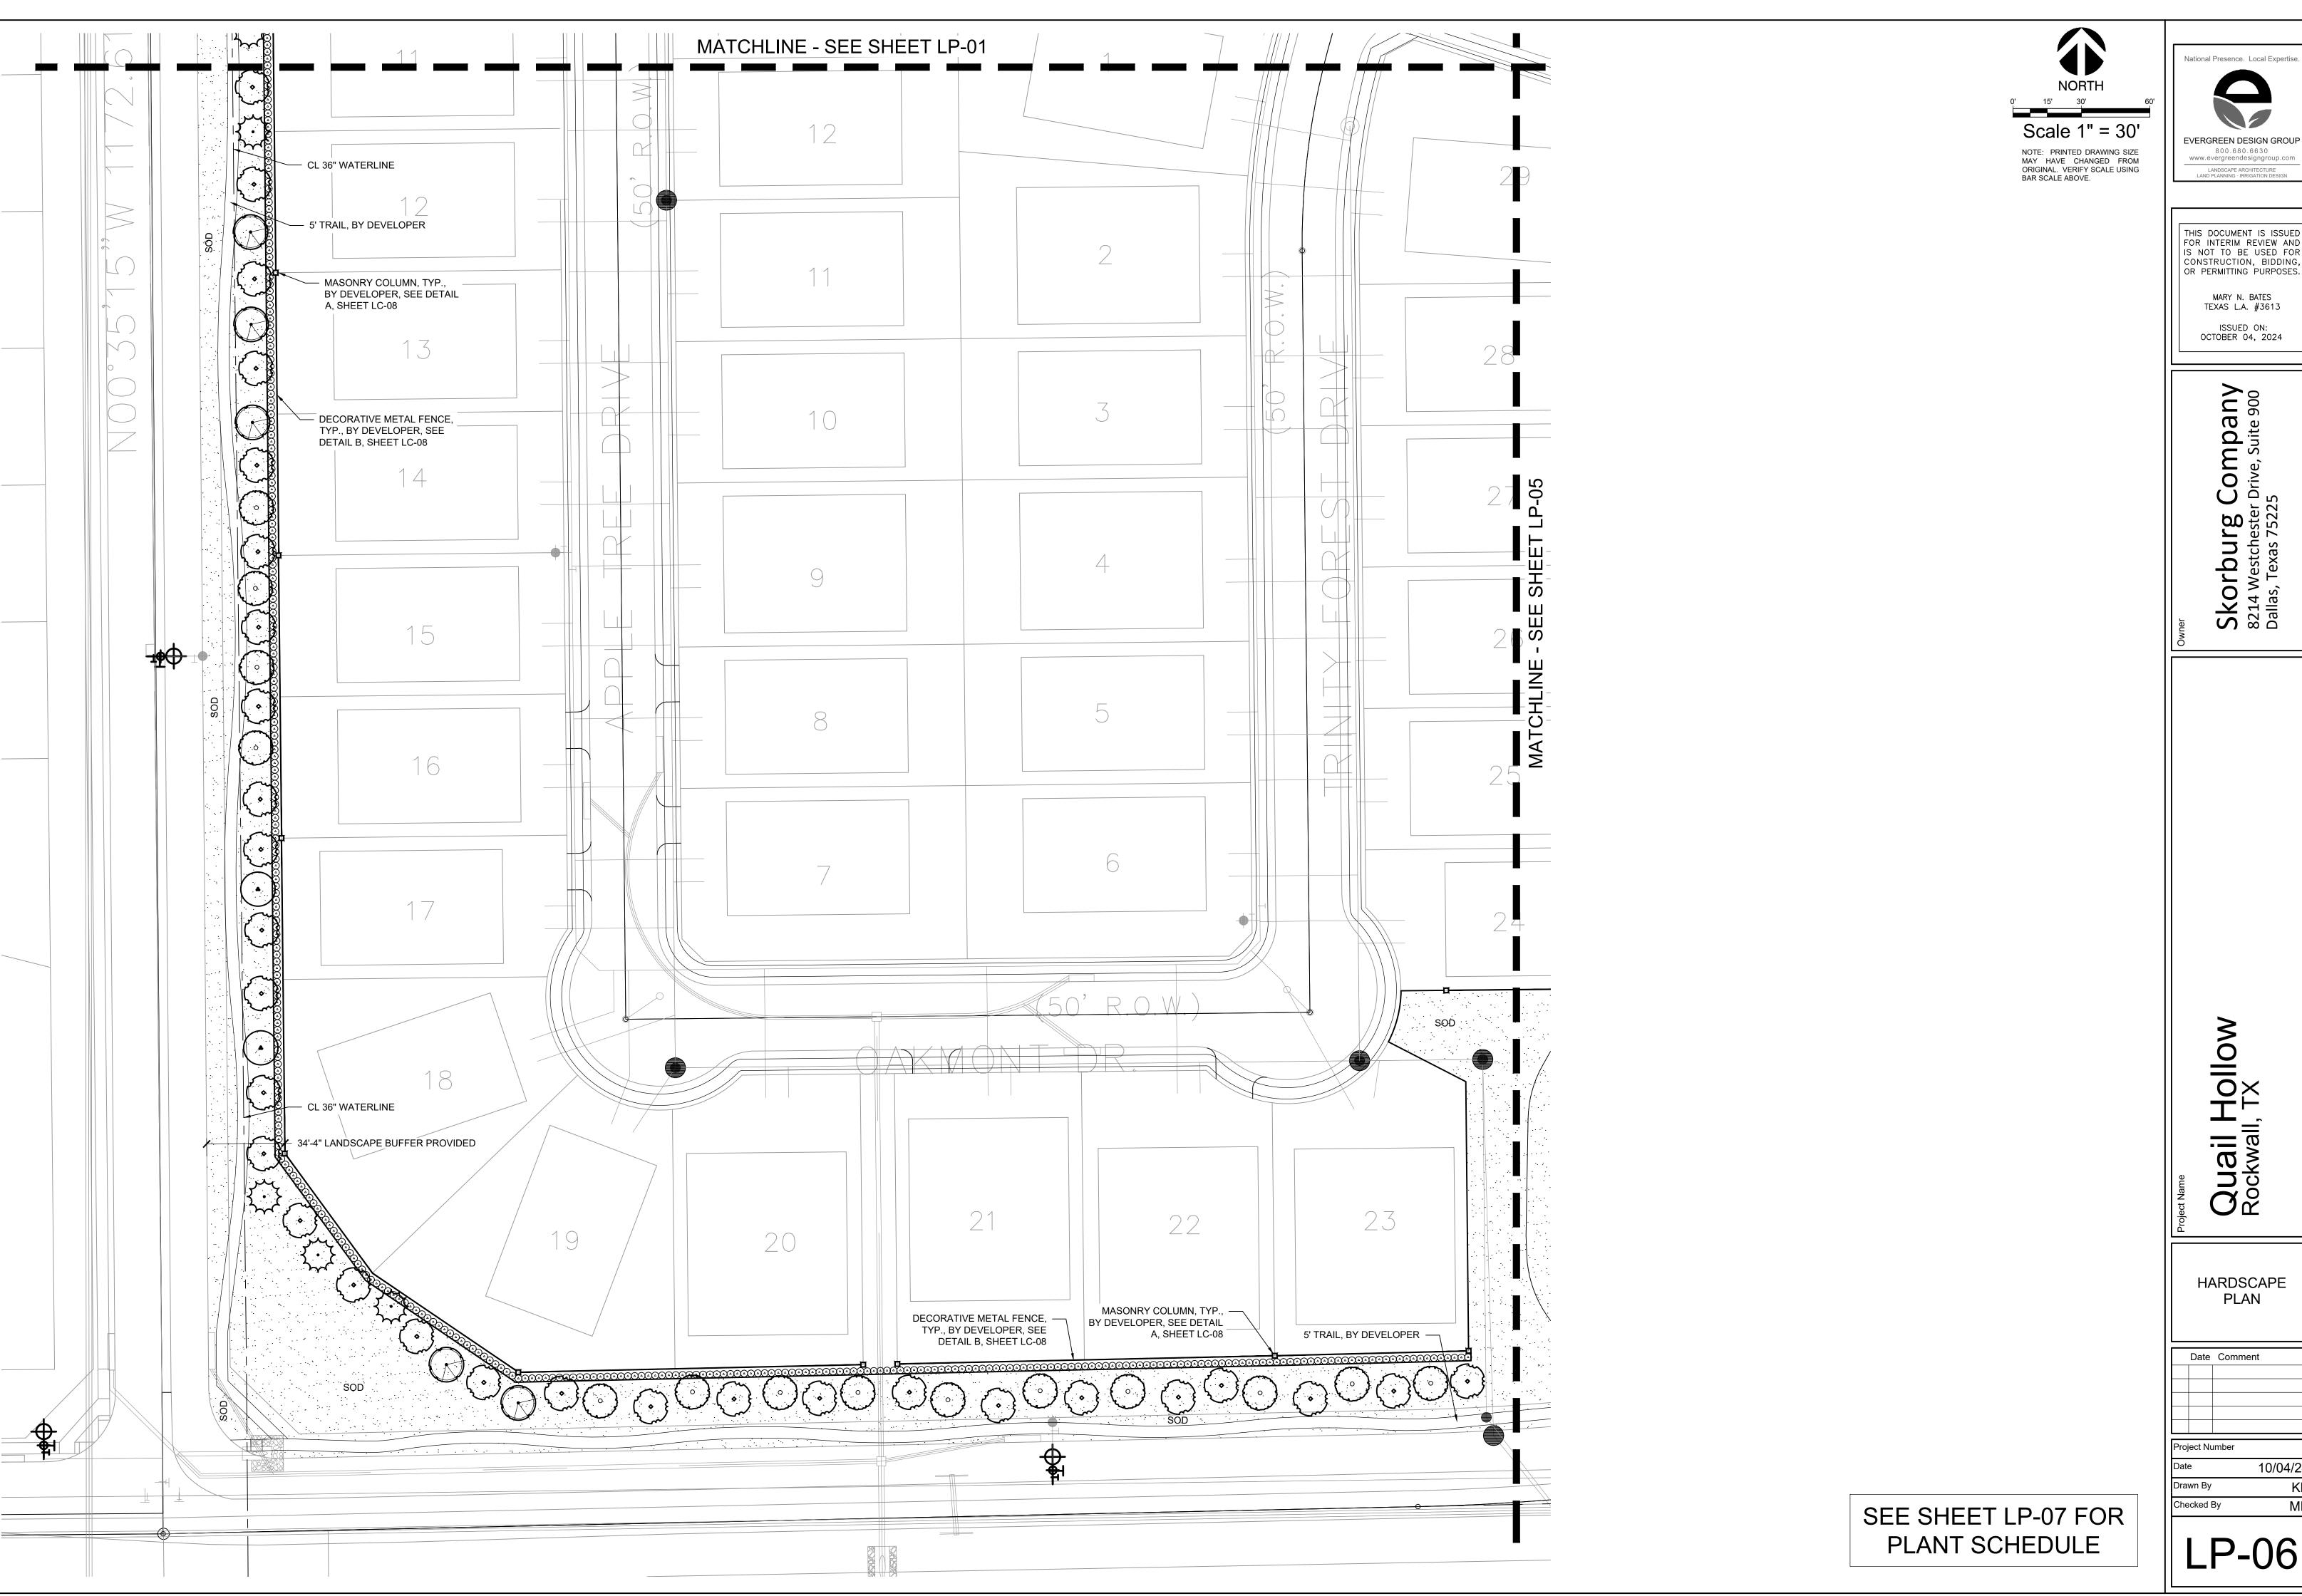
Hollow II, TX Quail F Rockwall,

HARDSCAPE PLAN

Date Comment

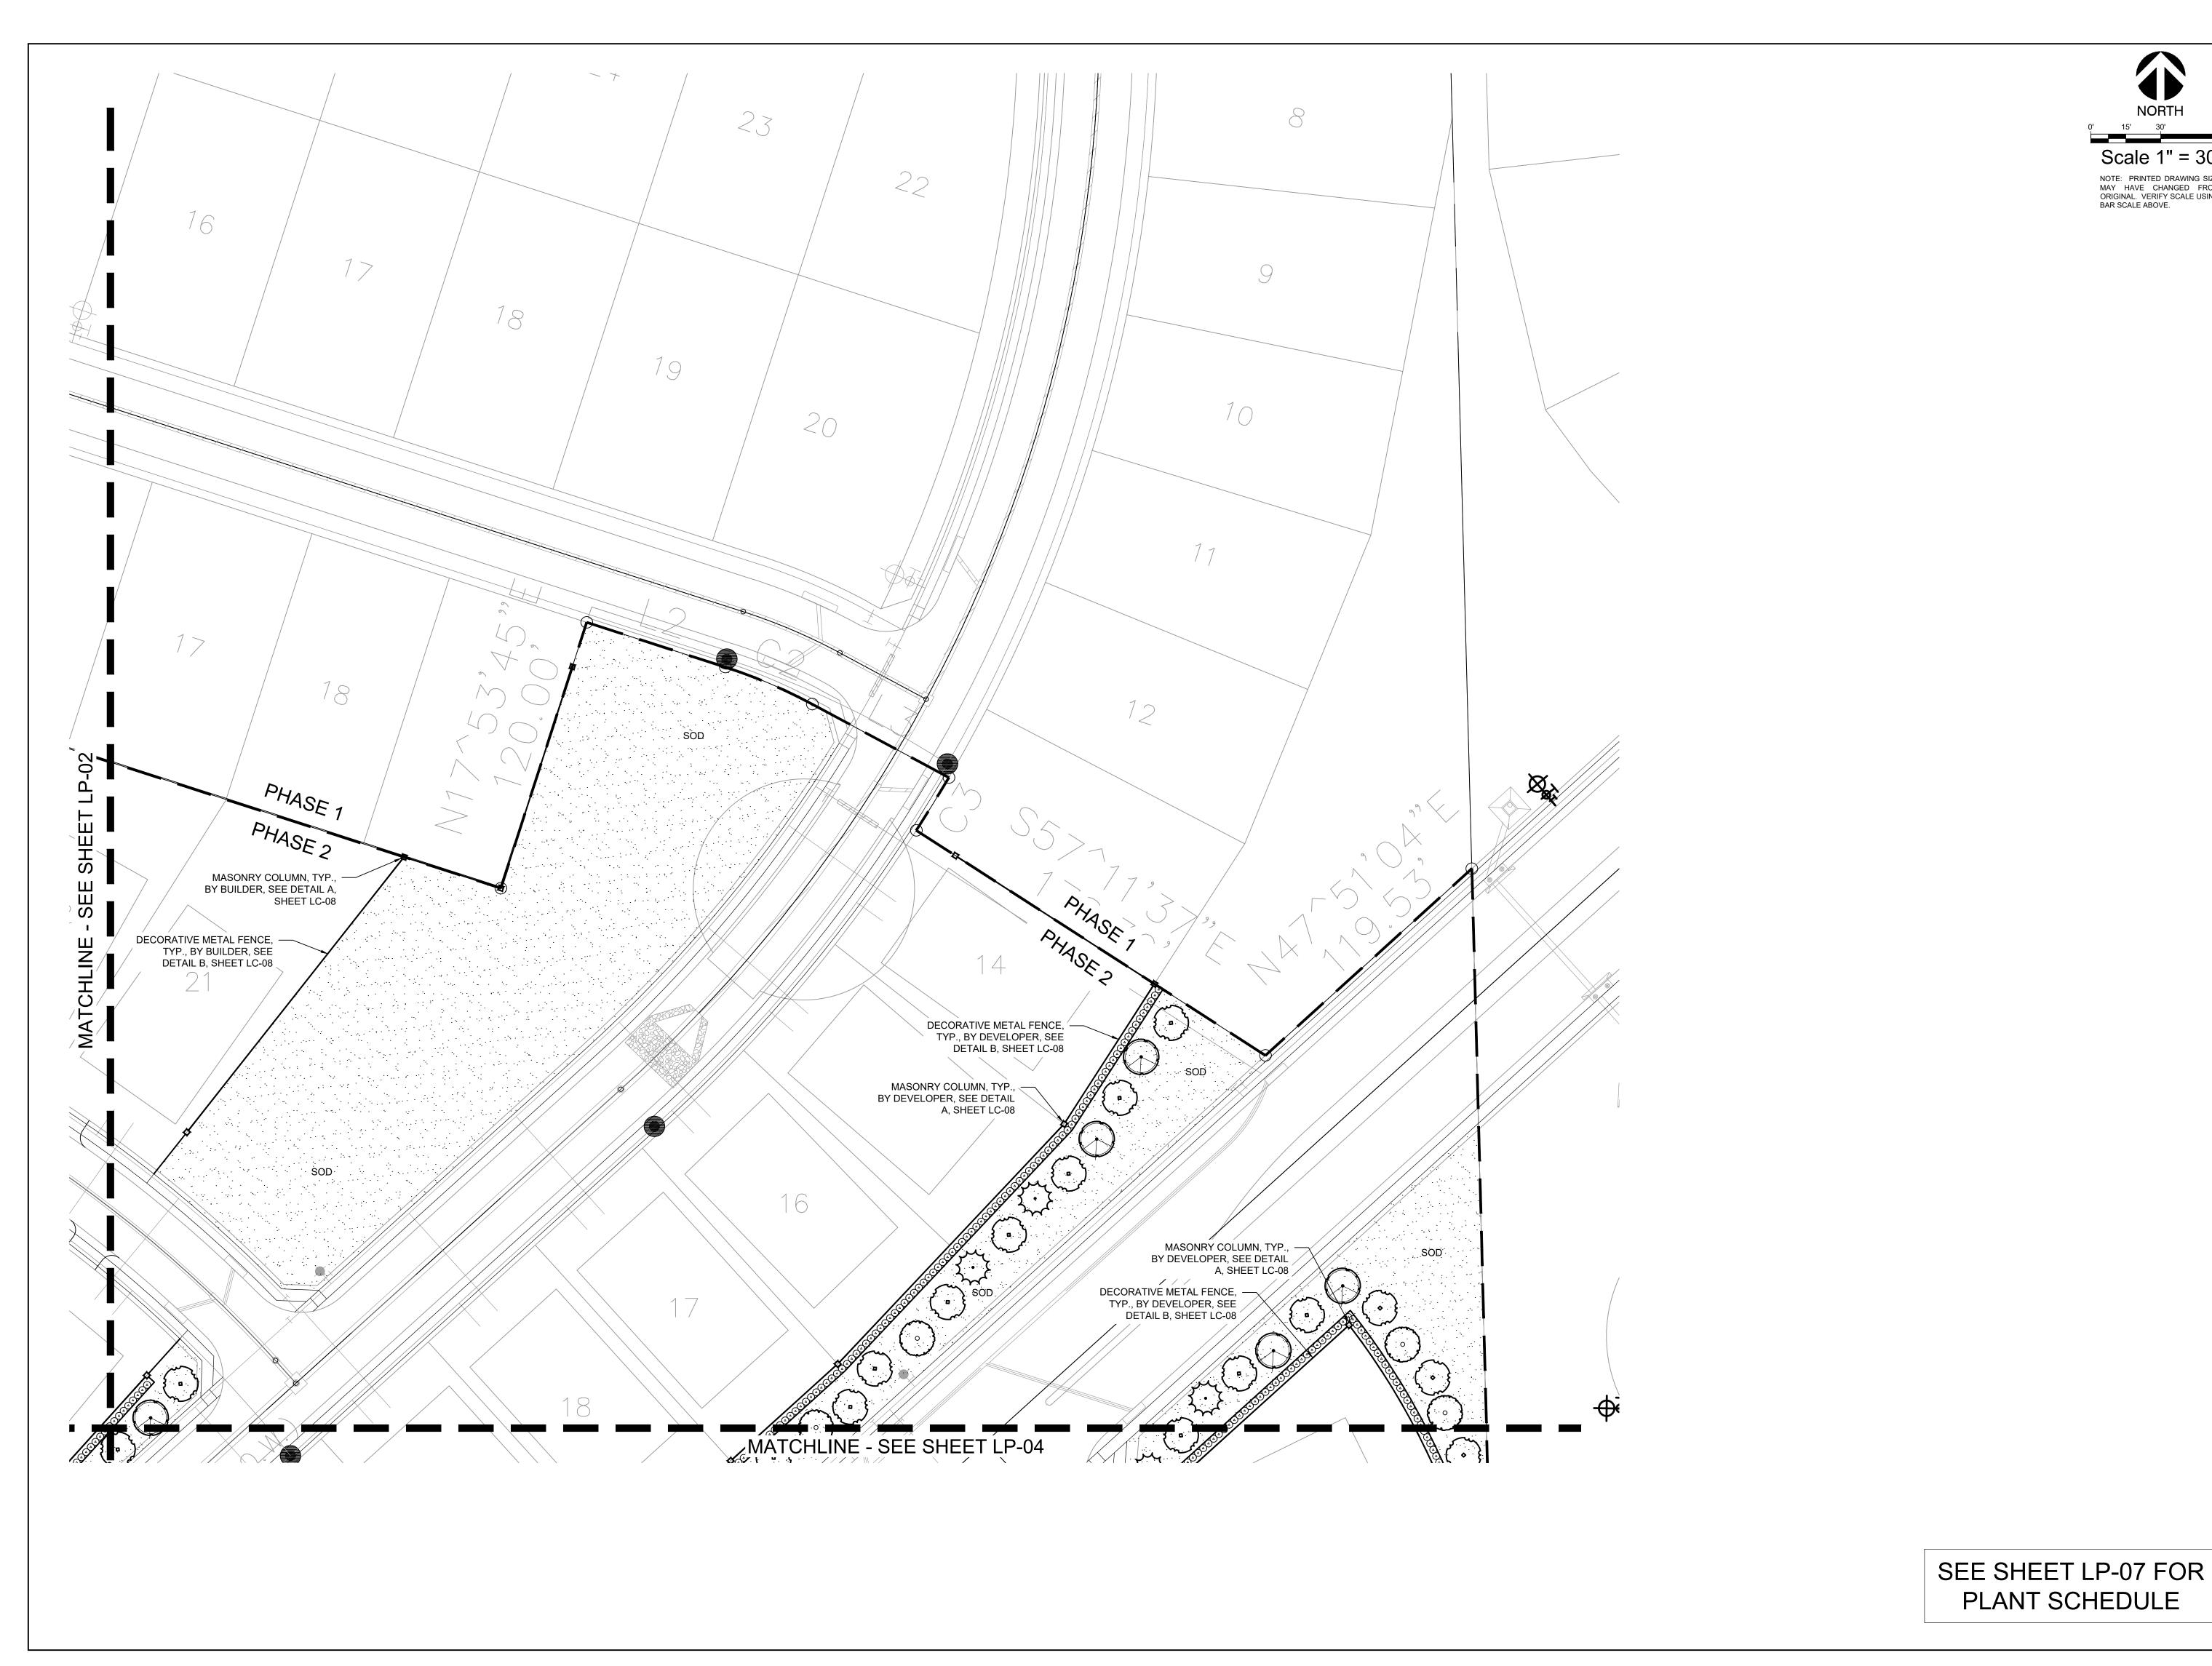


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LANT SCHEDULE								
EES	CODE	QUANTITY	COMMON NAME	BOTANICAL NAME	CONTAINER	CALIPER	SIZE	NOTES
₹·}	CL	24	DESERT WILLOW	CHILOPSIS LINEARIS	CONT OR B & B	4"		FULL, MATCHING, SYMMETRICAL
	ID	23	POSSUMHAW HOLLY	ILEX DECIDUA	CONT OR B & B	4"		FULL, MATCHING, SYMMETRICAL
\odot	IV	47	YAUPON HOLLY	ILEX VOMITORIA	CONT OR B & B	4"		FULL, MATCHING, SYMMETRICAL
	MG	104	DWARF SOUTHERN MAGNOLIA	MAGNOLIA GRANDIFLORA 'LITTLE GEM'	CONT OR B & B	4"		FULL, MATCHING, SYMMETRICAL
	QS	3	SHUMARD OAK	QUERCUS SHUMARDII	CONT OR B & B	4"		FULL, MATCHING, SYMMETRICAL
\odot	QV	8	SOUTHERN LIVE OAK	QUERCUS VIRGINIANA	CONT OR B & B	4"		FULL, MATCHING, SYMMETRICAL
	UC	6	CEDAR ELM	ULMUS CRASSIFOLIA	CONT OR B & B	4"		FULL, MATCHING, SYMMETRICAL
•	US	4	MEXICAN BUCKEYE	UNGNADIA SPECIOSA	CONT OR B & B	4"		FULL, MATCHING, SYMMETRICAL
NAMENTAL TREES	CODE	QUANITITY	COMMON NAME	BOTANICAL NAME	CONTAINER	SIZE	SIZE	NOTES
\bigcirc	CL	2	DESERT WILLOW	CHILOPSIS LINEARIS	CONT OR B & B		4' HT MIN	FULL, MATCHING, SYMMETRICAL
\odot	LI	2	CRAPE MYRTLE	LAGERSTROEMIA INDICA	CONT OR B & B		4' HT MIN	FULL, MATCHING, SYMMETRICAL
RUBS	CODE	QUANITITY	COMMON NAME	BOTANICAL NAME	CONTAINER	SIZE	SPACING	NOTES
	cs	9	PAPAS GRASS	CORTAGERIA SELLOANA	5 GAL.	24" HT.	36" O.C.	FULL, MATCHING, SYMMETRICAL
0	DX	78	DWARF WAX MYRTLE	MYRICA PUSILLA	5 GAL.		36" O.C.	FULL, MATCHING, SYMMETRICAL
0	IC	1345	DWARF BUFORD HOLLY	ILEX CORNUTA 'DWARF BURFORD'	5 GAL.	24" HT.	36" O.C.	FULL, MATCHING, SYMMETRICAL
	MC	18	PINK MUHLY	MUHLENBERGIA CAPILLARIS	5 GAL.	24" HT.	36" O.C.	FULL, MATCHING, SYMMETRICAL
\odot	SG	36	AUTUMN SAGE	SALVIA GREGGII	1 GAL.	12" HT.	24" O.C.	FULL, MATCHING, SYMMETRICAL
)	CODE	QUANITITY	COMMON NAME	BOTANICAL NAME	CONTAINER	SIZE	SPACING	NOTES
SON	SOD	387,179 SF	CYNODON DACTYLON 'TIF 419'	TIF 419 BERMUDAGRASS		SOLID SOD		





Skorburg Company 8214 Westchester Drive, Suite 900 Dallas, Texas 75225

Quail Hollow Rockwall, TX
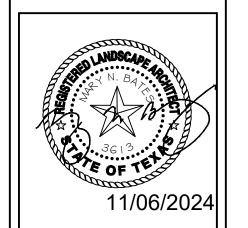
> HARDSCAPE PLAN

Date Comment

Project Number

 Date
 10/04/24

 Drawn By
 KB

 Checked By
 MB

I P-07

PLANTING SPECIFICATIONS

GENERAL

- A. QUALIFICATIONS OF LANDSCAPE CONTRACTOR ALL LANDSCAPE WORK SHOWN ON THESE PLANS SHALL BE PERFORMED BY A SINGLE FIRM
- SPECIALIZING IN LANDSCAPE PLANTING. A LIST OF SUCCESSFULLY COMPLETED PROJECTS OF THIS TYPE, SIZE AND NATURE MAY BE REQUESTED BY THE OWNER FOR FURTHER QUALIFICATION MEASURES.
- THE LANDSCAPE CONTRACTOR SHALL HOLD A VALID NURSERY AND FLORAL CERTIFICATE ISSUED BY THE TEXAS DEPARTMENT OF AGRICULTURE, AS WELL AS OPERATE UNDER A COMMERCIAL PESTICIDE APPLICATOR LICENSE ISSUED BY EITHER THE TEXAS DEPARTMENT OF AGRICULTURE OR THE TEXAS STRUCTURAL PEST CONTROL BOARD.
- WORK COVERED BY THESE SECTIONS INCLUDES THE FURNISHING AND PAYMENT OF ALL MATERIALS, LABOR SERVICES FOUIPMENT LICENSES TAXES AND ANY OTHER ITEMS THAT ARE NECESSARY FOR THE EXECUTION, INSTALLATION AND COMPLETION OF ALL WORK, SPECIFIED HEREIN AND / OR SHOWN
- ON THE LANDSCAPE PLANS, NOTES, AND DETAILS. ALL WORK SHALL BE PERFORMED IN ACCORDANCE WITH ALL APPLICABLE LAWS, CODES AND REGULATIONS REQUIRED BY AUTHORITIES HAVING JURISDICTION OVER SUCH WORK, INCLUDING ALL INSPECTIONS AND PERMITS REQUIRED BY FEDERAL, STATE AND LOCAL AUTHORITIES IN SUPPLY, TRANSPORTATION AND INSTALLATION OF MATERIALS.
- THE LANDSCAPE CONTRACTOR SHALL VERIFY THE LOCATION OF ALL UNDERGROUND UTILITY LINES (WATER, SEWER, ELECTRICAL, TELEPHONE, GAS, CABLE, TELEVISION, ETC.) PRIOR TO THE START OF

PRODUCTS

- ALL MANUFACTURED PRODUCTS SHALL BE NEW. CONTAINER AND BALLED-AND-BURLAPPED PLANTS
- FURNISH NURSERY-GROWN PLANTS COMPLYING WITH ANSI Z60.1-2014. PROVIDE WELL-SHAPED, FULLY BRANCHED, HEALTHY, VIGOROUS STOCK FREE OF DISEASE, INSECTS, EGGS, LARVAE, AND DEFECTS SUCH AS KNOTS, SUN SCALD, INJURIES, ABRASIONS, AND DISFIGUREMENT. ALL PLANTS WITHIN A SPECIES SHALL HAVE SIMILAR SIZE, AND SHALL BE OF A FORM TYPICAL FOR THE SPECIES. ALL TREES SHALL BE OBTAINED FROM SOURCES WITHIN 200 MILES OF THE PROJECT SITE, AND WITH SIMILAR
- CLIMACTIC CONDITIONS. ROOT SYSTEMS SHALL BE HEALTHY, DENSELY BRANCHED ROOT SYSTEMS, NON-POT-BOUND, FREE FROM ENCIRCLING AND/OR GIRDLING ROOTS, AND FREE FROM ANY OTHER ROOT DEFECTS (SUCH AS
- TREES MAY BE PLANTED FROM CONTAINERS OR BALLED-AND-BURLAPPED (B&B), UNLESS SPECIFIED ON THE PLANTING LEGEND. BARE-ROOT TREES ARE NOT ACCEPTABLE. ANY PLANT DEEMED UNACCEPTABLE BY THE LANDSCAPE ARCHITECT OR OWNER SHALL BE IMMEDIATELY REMOVED FROM THE SITE AND SHALL BE REPLACED WITH AN ACCEPTBLE PLANT OF LIKE
- TYPE AND SIZE AT THE CONTRACTOR'S OWN EXPENSE. ANY PLANTS APPEARING TO BE UNHEALTHY EVEN IF DETERMINED TO STILL BE ALIVE. SHALL NOT BE ACCEPTED. THE LANDSCAPE ARCHITECT AND OWNER SHALL BE THE SOLE JUDGES AS TO THE ACCEPTABILITY OF PLANT MATERIAL
- 5. ALL TREES SHALL BE STANDARD IN FORM, UNLESS OTHERWISE SPECIFIED. TREES WITH CENTRAL LEADERS WILL NOT BE ACCEPTED IF LEADER IS DAMAGED OR REMOVED. PRUNE ALL DAMAGED TWIGS
- CALIPER MEASUREMENTS FOR STANDARD (SINGLE TRUNK) TREES SHALL BE AS FOLLOWS: SIX INCHES ABOVE THE ROOT FLARE FOR TREES UP TO AND INCLUDING FOUR INCHES IN CALIPER, AND TWELVE INCHES ABOVE THE ROOT FLARE FOR TREES EXCEEDING FOUR INCHES IN CALIPER. MULTI-TRUNK TREES SHALL BE MEASURED BY THEIR OVERALL HEIGHT, MEASURED FROM THE TOP OF THE ROOT BALL. WHERE CALIPER MEASUREMENTS ARE USED, THE CALIPER SHALL BE CALCULATED
- AS ONE-HALF OF THE SUM OF THE CALIPER OF THE THREE LARGEST TRUNKS. ANY TREE OR SHRUB SHOWN TO HAVE EXCESS SOIL PLACED ON TOP OF THE ROOT BALL, SO THAT THE ROOT FLARE HAS BEEN COMPLETELY COVERED, SHALL BE REJECTED. SOD: PROVIDE WELL-ROOTED SOD OF THE VARIETY NOTED ON THE PLANS. SOD SHALL BE CUT FROM
- HEALTHY, MATURE TURF WITH SOIL THICKNESS OF 3/4" TO 1". EACH PALLET OF SOD SHALL BE ACCOMPANIED BY A CERTIFICATE FROM SUPPLIER STATING THE COMPOSITION OF THE SOD.
- SEED: PROVIDE BLEND OF SPECIES AND VARIETIES AS NOTED ON THE PLANS, WITH MAXIMUM PERCENTAGES OF PURITY, GERMINATION, AND MINIMUM PERCENTAGE OF WEED SEED AS INDICATED ON PLANS. EACH BAG OF SEED SHALL BE ACCOMPANIED BY A TAG FROM THE SUPPLIER INDICATING THE
- TOPSOIL: SANDY TO CLAY LOAM TOPSOIL, FREE OF STONES LARGER THAN ½ INCH, FOREIGN MATTER, PLANTS, ROOTS, AND SEEDS.
- COMPOST: WELL-COMPOSTED, STABLE, AND WEED-FREE ORGANIC MATTER, pH RANGE OF 5.5 TO 8; MOISTURE CONTENT 35 TO 55 PERCENT BY WEIGHT; 100 PERCENT PASSING THROUGH 3/4-INCH SIEVE; SOLUBLE SALT CONTENT OF 5 TO 10 DECISIEMENS/M; NOT EXCEEDING 0.5 PERCENT INERT CONTAMINANTS AND FREE OF SUBSTANCES TOXIC TO PLANTINGS. NO MANURE OR ANIMAL-BASED PRODUCTS SHALL BE
- G. FERTILIZER: GRANULAR FERTILIZER CONSISTING OF NITROGEN, PHOSPHORUS, POTASSIUM, AND OTHER NUTRIENTS IN PROPORTIONS, AMOUNTS, AND RELEASE RATES RECOMMENDED IN A SOIL REPORT FROM A
- QUALIFIED SOIL-TESTING AGENCY (SEE BELOW). H. MULCH: SIZE AND TYPE AS INDICATED ON PLANS, FREE FROM DELETERIOUS MATERIALS AND SUITABLE AS A TOP DRESSING OF TREES AND SHRUBS. TREE STAKING AND GLIVING
- STAKES: 6' LONG GREEN METAL T-POSTS. GUY AND TIE WIRE: ASTM A 641, CLASS 1, GALVANIZED-STEEL WIRE, 2-STRAND, TWISTED, 0.106 INCH
- STRAP CHAFING GUARD: REINFORCED NYLON OR CANVAS AT LEAST 1-1/2 INCH WIDE, WITH GROMMETS TO PROTECT TREE TRUNKS FROM DAMAGE STEEL EDGING: PROFESSIONAL STEEL EDGING. 14 GAUGE THICK X 4 INCHES WIDE. FACTORY PAINTED DARK
- GREEN. ACCEPTABLE MANUFACTURERS INCLUDE COL-MET OR APPROVED EQUAL. M. PRE-EMERGENT HERBICIDES: ANY GRANULAR, NON-STAINING PRE-EMERGENT HERBICIDE THAT IS LABELED FOR THE SPECIFIC ORNAMENTALS OR TURF ON WHICH IT WILL BE UTILIZED. PRE-EMERGENT HERBICIDES SHALL BE APPLIED PER THE MANUFACTURER'S LABELED RATES.

METHODS

 A. SOIL PREPARATION BEFORE STARTING WORK, THE LANDSCAPE CONTRACTOR SHALL VERIFY THAT THE GRADE OF ALL LANDSCAPE AREAS ARE WITHIN +/-0.1' OF FINISH GRADE. THE CONTRACTOR SHALL NOTIFY THE

OWNER IMMEDIATELY SHOULD ANY DISCREPANCIES EXIST.

- a. AFTER FINISH GRADES HAVE BEEN ESTABLISHED, CONTRACTOR SHALL HAVE SOIL SAMPLES FROM THE PROJECT'S LANDSCAPE AREAS TESTED BY AN ESTABLISHED SOIL TESTING LABORATORY. EACH SAMPLE SUBMITTED TO THE LAB SHALL CONTAIN NO LESS THAN ONE QUART OF SOIL, TAKEN FROM BETWEEN THE SOIL SURFACE AND 6" DEPTH. IF NO SAMPLE LOCATIONS ARE INDICATED ON THE PLANS, THE CONTRACTOR SHALL TAKE A MINIMUM OF THREE SAMPLES FROM VARIOUS REPRESENTATIVE LOCATIONS FOR TESTING.
- THE CONTRACTOR SHALL HAVE THE SOIL TESTING LABORATORY PROVIDE RESULTS FOR THE FOLLOWING: SOIL TEXTURAL CLASS, GENERAL SOIL FERTILITY, pH, ORGANIC MATTER CONTENT, SALT (CEC), LIME, SODIUM ADSORPTION RATIO (SAR) AND BORON CONTENT. c. THE CONTRACTOR SHALL ALSO SUBMIT THE PROJECT'S PLANT LIST TO THE LABORATORY ALONG
- WITH THE SOIL SAMPLES. d. THE SOIL REPORT PRODUCED BY THE LABORATORY SHALL CONTAIN RECOMMENDATIONS FOR THE FOLLOWING (AS APPROPRIATE): SEPARATE SOIL PREPARATION AND BACKFILL MIX RECOMMENDATIONS FOR GENERAL ORNAMENTAL PLANTS, XERIC PLANTS, TURE, AND NATIVE SEED. AS WELL AS PRE-PLANT FERTILIZER APPLICATIONS AND RECOMMENDATIONS FOR ANY OTHER SOIL RELATED ISSUES. THE REPORT SHALL ALSO PROVIDE A FERTILIZER PROGRAM FOR
- THE ESTABLISHMENT PERIOD AND FOR LONG-TERM MAINTENANCE. THE CONTRACTOR SHALL INSTALL SOIL AMENDMENTS AND FERTILIZERS PER THE SOILS REPORT RECOMMENDATIONS. ANY CHANGE IN COST DUE TO THE SOIL REPORT RECOMMENDATIONS. EITHER
- INCREASE OR DECREASE. SHALL BE SUBMITTED TO THE OWNER WITH THE REPORT. FOR BIDDING PURPOSES ONLY, THE SOIL PREPARATION SHALL CONSIST OF THE FOLLOWING TURF: INCORPORATE THE FOLLOWING AMENDMENTS INTO THE TOP 8" OF SOIL BY MEANS OF
- ROTOTILLING AFTER CROSS-RIPPING: NITROGEN STABILIZED ORGANIC AMENDMENT - 4 CU. YDS. PER 1,000 S.F. PREPLANT TURF FERTILIZER (10-20-10 OR SIMILAR, SLOW RELEASE, ORGANIC) - 15 LBS PER 1,000
- iii. "CLAY BUSTER" OR EQUAL USE MANUFACTURER'S RECOMMENDED RATE TREES, SHRUBS, AND PERENNIALS: INCORPORATE THE FOLLOWING AMENDMENTS INTO THE TOP 8" OF SOIL BY MEANS OF ROTOTILLING AFTER CROSS-RIPPING:
- NITROGEN STABILIZED ORGANIC AMENDMENT 4 CU. YDS. PER 1,000 S.F. 12-12-12 FERTILIZER (OR SIMILAR, ORGANIC, SLOW RELEASE) - 10 LBS. PER CU. YD.
- "CLAY BUSTER" OR EQUAL USE MANUFACTURER'S RECOMMENDED RATE IRON SULPHATE - 2 LBS. PER CU. YD. 5. IN THE CONTEXT OF THESE PLANS, NOTES, AND SPECIFICATIONS, "FINISH GRADE" REFERS TO THE
- FINAL ELEVATION OF THE SOIL SURFACE (NOT TOP OF MULCH) AS INDICATED ON THE GRADING PLANS. a. BEFORE STARTING WORK, THE LANDSCAPE CONTRACTOR SHALL VERIFY THAT THE ROUGH GRADES OF ALL LANDSCAPE AREAS ARE WITHIN +/-0.1' OF FINISH GRADE. SEE SPECIFICATIONS FOR MORE DETAILED INSTRUCTION ON TURF AREA AND PLANTING BED PREPARATION.
- CONSTRUCT AND MAINTAIN FINISH GRADES AS SHOWN ON GRADING PLANS, AND CONSTRUCT AND MAINTAIN SLOPES AS RECOMMENDED BY THE GEOTECHNICAL REPORT. ALL LANDSCAPE AREAS SHALL HAVE POSITIVE DRAINAGE AWAY FROM STRUCTURES AT THE MINIMUM SLOPE SPECIFIED IN THE REPORT AND ON THE GRADING PLANS, AND AREAS OF POTENTIAL PONDING SHALL BE REGRADED TO BLEND IN WITH THE SURROUNDING GRADES AND ELIMINATE PONDING
- c. THE LANDSCAPE CONTRACTOR SHALL DETERMINE WHETHER OR NOT THE EXPORT OF ANY SOIL WILL BE NEEDED. TAKING INTO ACCOUNT THE ROUGH GRADE PROVIDED. THE AMOUNT OF SOIL AMENDMENTS TO BE ADDED (BASED ON A SOIL TEST, PER SPECIFICATIONS), AND THE FINISH GRADES TO BE ESTABLISHED.
- d. ENSURE THAT THE FINISH GRADE IN SHRUB AREAS IMMEDIATELY ADJACENT TO WALKS AND OTHER WALKING SURFACES, AFTER INSTALLING SOIL AMENDMENTS, IS 3" BELOW THE ADJACENT FINISH SURFACE IN ORDER TO ALLOW FOR PROPER MULCH DEPTH. TAPER THE SOIL SURFACE TO MEET FINISH GRADE, AS SPECIFIED ON THE GRADING PLANS, AT APPROXIMATELY 18" AWAY FROM THE WALKS
- e. ENSURE THAT THE FINISH GRADE IN TURF AREAS IMMEDIATELY ADJACENT TO WALKS AND OTHER WALKING SURFACES, AFTER INSTALLING SOIL AMENDMENTS, IS 1" BELOW THE FINISH SURFACE OF THE WALKS. TAPER THE SOIL SURFACE TO MEET FINISH GRADE, AS SPECIFIED ON THE GRADING PLANS, AT APPROXIMATELY 18" AWAY FROM THE WALKS.
- SHOULD ANY CONFLICTS AND/OR DISCREPANCIES ARISE BETWEEN THE GRADING PLANS, GEOTECHNICAL REPORT, THESE NOTES AND PLANS, AND ACTUAL CONDITIONS, THE CONTRACTOR SHALL IMMEDIATELY BRING SUCH ITEMS TO THE ATTENTION OF THE LANDSCAPE ARCHITECT, GENERAL CONTRACTOR, AND OWNER.
- ONCE SOIL PREPARATION IS COMPLETE, THE LANDSCAPE CONTRACTOR SHALL ENSURE THAT THERE ARE NO DEBRIS, TRASH, OR STONES LARGER THAN 1" REMAINING IN THE TOP 6" OF SOIL.

- THE CONTRACTOR SHALL PROVIDE SUBMITTALS AND SAMPLES, IF REQUIRED, TO THE LANDSCAPE ARCHITECT, AND RECEIVE APPROVAL IN WRITING FOR SUCH SUBMITTALS BEFORE WORK COMMENCES. SUBMITTALS SHALL INCLUDE PHOTOS OF PLANTS WITH A RULER OR MEASURING STICK FOR SCALE, PHOTOS OR SAMPLES OF ANY REQUIRED MULCHES, AND SOIL TEST RESULTS AND PREPARATION RECOMMENDATIONS FROM THE TESTING LAB (INCLUDING COMPOST AND FERTILIZER RATES AND TYPES, AND OTHER AMENDMENTS FOR TREE/SHRUB, TURF, AND SEED AREAS AS MAY BE
- APPROPRIATE). 3. SUBMITTALS SHALL ALSO INCLUDE MANUFACTURER CUT SHEETS FOR PLANTING ACCESSORIES SUCH AS TREE STAKES AND TIES EDGING AND LANDSCAPE FABRICS (IF ANY) WHERE MULTIPLE ITEMS ARE SHOWN ON A PAGE, THE CONTRACTOR SHALL CLEARLY INDICATE THE ITEM BEING CONSIDERED.
- C. GENERAL PLANTING REMOVE ALL NURSERY TAGS AND STAKES FROM PLANTS.
- EXCEPT IN AREAS TO BE PLANTED WITH ORNAMENTAL GRASSES, APPLY PRE-EMERGENT HERBICIDES AT THE MANUFACTURER'S RECOMMENDED RATE. TRENCHING NEAR EXISTING TREES:
- CONTRACTOR SHALL NOT DISTURB ROOTS 1-1/2" AND LARGER IN DIAMETER WITHIN THE CRITICAL ROOT ZONE (CRZ) OF EXISTING TREES, AND SHALL EXERCISE ALL POSSIBLE CARE AND PRECAUTIONS TO AVOID INJURY TO TREE ROOTS, TRUNKS, AND BRANCHES. THE CRZ IS DEFINED AS A CIRCULAR AREA EXTENDING OUTWARD FROM THE TREE TRUNK. WITH A RADIUS EQUAL TO 1' FOR EVERY 1" OF TRUNK DIAMETER-AT-BREAST-HEIGHT (4.5' ABOVE THE AVERAGE
- ALL EXCAVATION WITHIN THE CRZ SHALL BE PERFORMED USING HAND TOOLS. NO MACHINE EXCAVATION OR TRENCHING OF ANY KIND SHALL BE ALLOWED WITHIN THE CRZ.
- ALTER ALIGNMENT OF PIPE TO AVOID TREE ROOTS 1-1/2" AND LARGER IN DIAMETER. WHERE TREE ROOTS 1-1/2" AND LARGER IN DIAMETER ARE ENCOUNTERED IN THE FIELD, TUNNEL UNDER SUCH ROOTS. WRAP EXPOSED ROOTS WITH SEVERAL LAYERS OF BURLAP AND KEEP MOIST.
- CLOSE ALL TRENCHES WITHIN THE CANOPY DRIP LINES WITHIN 24 HOURS. ALL SEVERED ROOTS SHALL BE HAND PRUNED WITH SHARP TOOLS AND ALLOWED TO AIR-DRY. DO NOT USE ANY SORT OF SEALERS OR WOUND PAINTS.
- TREE PLANTING HOLES SHALL BE EXCAVATED TO MINIMUM WIDTH OF TWO TIMES THE WIDTH OF THE ROOTBALL. AND TO A DEPTH EQUAL TO THE DEPTH OF THE ROOTBALL LESS TWO TO FOUR INCHES. SCARIFY THE SIDES AND BOTTOM OF THE PLANTING HOLE PRIOR TO THE PLACEMENT OF THE TREE.
 - REMOVE ANY GLAZING THAT MAY HAVE BEEN CAUSED DURING THE EXCAVATION OF THE HOLE. 3. FOR CONTAINER AND BOX TREES, TO REMOVE ANY POTENTIALLY GIRDLING ROOTS AND OTHER ROOT DEFECTS, THE CONTRACTOR SHALL SHAVE A 1" LAYER OFF OF THE SIDES AND BOTTOM OF THE ROOTBALL OF ALL TREES JUST BEFORE PLACING INTO THE PLANTING PIT. DO NOT "TEASE" ROOTS
 - OUT FROM THE ROOTBALL. 4. INSTALL THE TREE ON UNDISTURBED SUBGRADE SO THAT THE TOP OF THE ROOTBALL IS TWO TO FOUR INCHES ABOVE THE SURROUNDING GRADE 5. BACKFILL THE TREE HOLE UTILIZING THE EXISTING TOPSOIL FROM ON-SITE. ROCKS LARGER THAN 1"

DIA. AND ALL OTHER DEBRIS SHALL BE REMOVED FROM THE SOIL PRIOR TO THE BACKFILL. SHOULD

ADDITIONAL SOIL BE REQUIRED TO ACCOMPLISH THIS TASK. USE STORED TOPSOIL FROM ON-SITE OR


- IMPORT ADDITIONAL TOPSOIL FROM OFF-SITE AT NO ADDITIONAL COST TO THE OWNER. IMPORTED TOPSOIL SHALL BE OF SIMILAR TEXTURAL CLASS AND COMPOSITION IN THE ON-SITE SOIL. TREES SHALL NOT BE STAKED UNLESS LOCAL CONDITIONS (SUCH AS HEAVY WINDS OR SLOPES) REQUIRE STAKES TO KEEP TREES UPRIGHT. SHOULD STAKING BE REQUIRED. THE TOTAL NUMBER OF TREE STAKES (BEYOND THE MINIMUMS LISTED BELOW) WILL BE LEFT TO THE LANDSCAPE CONTRACTOR'S DISCRETION. SHOULD ANY TREES FALL OR LEAN, THE LANDSCAPE CONTRACTOR SHALL STRAIGHTEN THE TREE, OR REPLACE IT SHOULD IT BECOME DAMAGED. TREE STAKING SHALL
- ADHERE TO THE FOLLOWING GUIDELINES: TWO STAKES PER TREE 2-1/2"-4" TREES THREE STAKES PER TREE
- TREES OVER 4" CALIPER GUY AS NEEDED THREE STAKES PER TREE MINIMUM, QUANTITY AND POSITIONS AS MULTI-TRUNK TREES NEEDED TO STABILIZE THE TREE
- UPON COMPLETION OF PLANTING, CONSTRUCT AN EARTH WATERING BASIN AROUND THE TREE. COVER THE INTERIOR OF THE TREE RING WITH THE WEED BARRIER CLOTH AND TOPDRESS WITH
- MULCH (TYPE AND DEPTH PER PLANS). SHRUB, PERENNIAL, AND GROUNDCOVER PLANTING
- DIG THE PLANTING HOLES TWICE AS WIDE AND 2" LESS DEEP THAN EACH PLANT'S ROOTBALL. INSTALL THE PLANT IN THE HOLE. BACKFILL AROUND THE PLANT WITH SOIL AMENDED PER SOIL TEST
- RECOMMENDATIONS. INSTALL THE WEED BARRIER CLOTH, OVERLAPPING IT AT THE ENDS. UTILIZE STEEL STAPLES TO KEEP THE WEED BARRIER CLOTH IN PLACE. WHEN PLANTING IS COMPLETE, INSTALL MULCH (TYPE AND DEPTH PER PLANS) OVER ALL PLANTING
- BEDS. COVERING THE ENTIRE PLANTING AREA. F. SODDING SOD VARIETY TO BE AS SPECIFIED ON THE LANDSCAPE PLAN.
 - LAY SOD WITHIN 24 HOURS FROM THE TIME OF STRIPPING. DO NOT LAY IF THE GROUND IS FROZEN. LAY THE SOD TO FORM A SOLID MASS WITH TIGHTLY FITTED JOINTS. BUTT ENDS AND SIDES OF SOD STRIPS - DO NOT OVERLAP STAGGER STRIPS TO DESET JOINTS IN ADJACENT COLIRSES. 4 ROLL THE SOD TO ENSURE GOOD CONTACT OF THE SOD'S ROOT SYSTEM WITH THE SOIL
 - 5. WATER THE SOD THOROUGHLY WITH A FINE SPRAY IMMEDIATELY AFTER PLANTING TO OBTAIN AT LEAST SIX INCHES OF PENETRATION INTO THE SOIL BELOW THE SOD.
- G. HYDROMULCHING 1. TURF HYDROMULCH MIX (PER 1,000 SF) SHALL BE AS FOLLOWS: WINTER MIX (OCTOBER 1 - MARCH 31)
 - 50# CELLULOSE FIBER MULCH P# UNHULLED BERMUDA SEED
 - # ANNUAL RYE SEED 15# 15-15-15 WATER SOLUBLE FERTILIZER
 - 50# CELLULOSE FIBER MULCH
- HULLED BERMUDA SEED 15# 15-15-15 WATER SOLUBLE FERTILIZER
- 2. SEED HYDROMULCH MIX (PER 1,000 SF) SHALL BE AS FOLLOWS: 50# CELLULOSE FIBER MULCH
- 15# 15-15-15 WATER SOLUBLE FERTILIZER SEED RATE PER LEGEND
- ALL SEED SHALL BE DRILL SEEDED AT THE RATES SHOWN ON THE PLANS, WITH A HYDROMULCH MIX APPLIED AFTER SEEDING.
 - THE HYDROMULCH MIX (PER 1.000 SF) SHALL BE AS FOLLOWS: 50# CELLULOSE FIBER MULCH
- 15# 15-15-15 WATER SOLUBLE FERTILIZER 4# ORGANIC BINDER
- MULCH
- 1. INSTALL MULCH TOPDRESSING, TYPE AND DEPTH PER MULCH NOTE, IN ALL PLANTING AREAS AND TREE RINGS. 2. DO NOT INSTALL MULCH WITHIN 6" OF TREE ROOT FLARE AND WITHIN 24" OF HABITABLE STRUCTURES, EXCEPT AS MAY BE NOTED ON THESE PLANS. MULCH COVER WITHIN 6" OF CONCRETE WALKS AND CURBS SHALL NOT PROTRUDE ABOVE THE FINISH SURFACE OF THE WALKS AND CURBS. MULCH
- COVER WITHIN 12" OF WALLS SHALL BE AT LEAST 3" LOWER THAN THE TOP OF WALL. 1. DURING LANDSCAPE PREPARATION AND PLANTING, KEEP ALL PAVEMENT CLEAN AND ALL WORK AREAS
- IN A NEAT, ORDERLY CONDITION. DISPOSED LEGALLY OF ALL EXCAVATED MATERIALS OFF THE PROJECT SITE. K. INSPECTION AND ACCEPTANCE
- 1. UPON COMPLETION OF THE WORK, THE LANDSCAPE CONTRACTOR SHALL PROVIDE THE SITE CLEAN, FREE OF DEBRIS AND TRASH, AND SUITABLE FOR USE AS INTENDED. THE LANDSCAPE CONTRACTOR SHALL THEN REQUEST AN INSPECTION BY THE OWNER TO DETERMINE FINAL ACCEPTABILITY. 2. WHEN THE INSPECTED PLANTING WORK DOES NOT COMPLY WITH THE CONTRACT DOCUMENTS, THE LANDSCAPE CONTRACTOR SHALL REPLACE AND/OR REPAIR THE REJECTED WORK TO THE OWNER'S
- SATISFACTION WITHIN 24 HOURS. THE LANDSCAPE MAINTENANCE PERIOD WILL NOT COMMENCE UNTIL THE LANDSCAPE WORK HAS BEEN RE-INSPECTED BY THE OWNER AND FOUND TO BE ACCEPTABLE. AT THAT TIME, A WRITTEN NOTICE OF FINAL ACCEPTANCE WILL BE ISSUED BY THE OWNER, AND THE MAINTENANCE AND GUARANTEE PERIODS WILL COMMENCE.
- LANDSCAPE MAINTENANCE THE LANDSCAPE CONTRACTOR SHALL BE RESPONSIBLE FOR THE MAINTENANCE OF ALL WORK SHOWN ON THESE PLANS FOR 90 DAYS BEYOND FINAL ACCEPTANCE OF ALL LANDSCAPE WORK BY THE OWNER. LANDSCAPE MAINTENANCE SHALL INCLUDE WEEKLY SITE VISITS FOR THE FOLLOWING ACTIONS (AS APPROPRIATE): PROPER PRUNING, RESTAKING OF TREES, RESETTING OF PLANTS THAT HAVE SETTLED, MOWING AND AERATION OF LAWNS, WEEDING, RESEEDING AREAS WHICH HAVE NOT GERMINATED WELL, TREATING FOR INSECTS AND DISEASES, REPLACEMENT OF MULCH, REMOVAL OF LITTER, REPAIRS TO THE IRRIGATION SYSTEM DUE TO FAULTY PARTS AND/OR WORKMANSHIP, AND THE APPROPRIATE WATERING OF ALL PLANTINGS. THE LANDSCAPE CONTRACTOR SHALL MAINTAIN THE IRRIGATION SYSTEM IN PROPER WORKING ORDER, WITH SCHEDULING ADJUSTMENTS BY SEASON
- TO MAXIMIZE WATER CONSERVATION. SHOULD SEEDED AND/OR SODDED AREAS NOT BE COVERED BY AN AUTOMATIC IRRIGATION SYSTEM. THE LANDSCAPE CONTRACTOR SHALL BE RESPONSIBLE FOR WATERING THESE AREAS AND OBTAINING A FULL HEALTHY STAND OF PLANTS AT NO ADDITIONAL COST TO THE OWNER TO ACHIEVE FINAL ACCEPTANCE AT THE END OF THE MAINTENANCE PERIOD, ALL OF THE FOLLOWING CONDITIONS MUST OCCUR-

THE LANDSCAPE SHALL SHOW ACTIVE, HEALTHY GROWTH (WITH EXCEPTIONS MADE FOR

GROWTH. BARE AREAS LARGER THAN TWELVE SQUARE INCHES MUST BE RESODDED OR

- SEASONAL DORMANCY). ALL PLANTS NOT MEETING THIS CONDITION SHALL BE REJECTED AND REPLACED BY HEALTHY PLANT MATERIAL PRIOR TO FINAL ACCEPTANCE ALL HARDSCAPE SHALL BE CLEANED PRIOR TO FINAL ACCEPTANCE. SODDED AREAS MUST BE ACTIVELY GROWING AND MUST REACH A MINIMUM HEIGHT OF 1 1/2 INCHES BEFORE FIRST MOWING. HYDROMULCHED AREAS SHALL SHOW ACTIVE, HEALTHY
- RESEEDED (AS APPROPRIATE) PRIOR TO FINAL ACCEPTANCE. ALL SODDED TURF SHALL BE NEATLY MOWED. M. WARRANTY PERIOD, PLANT GUARANTEE AND REPLACEMENTS THE LANDSCAPE CONTRACTOR SHALL GUARANTEE ALL TREES, SHRUBS, PERENNIALS, SOD, SEEDED/HYDROMULCHED AREAS, AND IRRIGATION SYSTEMS FOR A PERIOD OF ONE YEAR FROM THE DATE OF THE OWNER'S FINAL ACCEPTANCE (90 DAYS FOR ANNUAL PLANTS). THE CONTRACTOR SHALL REPLACE, AT HIS OWN EXPENSE AND TO THE SATISFACTION OF THE OWNER, ANY PLANTS WHICH DIE IN THAT TIME, OR REPAIR ANY PORTIONS OF THE IRRIGATION SYSTEM WHICH OPERATE IMPROPERLY. 2. AFTER THE INITIAL MAINTENANCE PERIOD AND DURING THE GUARANTEE PERIOD, THE LANDSCAPE
- CANNOT BE ATTRIBUTED DIRECTLY TO OVERWATERING OR OTHER DAMAGE BY HUMAN ACTIONS. PROVIDE A MINIMUM OF (2) COPIES OF RECORD DRAWINGS TO THE OWNER UPON COMPLETION OF WORK. A RECORD DRAWING IS A RECORD OF ALL CHANGES THAT OCCURRED IN THE FIELD AND THAT ARE DOCUMENTED THROUGH CHANGE ORDERS, ADDENDA, OR CONTRACTOR/CONSULTANT DRAWING MARKUPS.

CONTRACTOR SHALL ONLY BE RESPONSIBLE FOR REPLACEMENT OF PLANTS WHEN PLANT DEATH

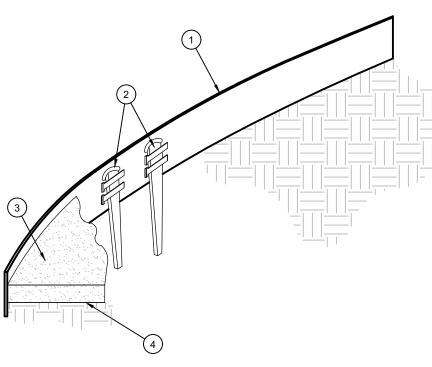

- (1) ROLLED-TOP STEEL EDGING PER PLANS.
- (2) TAPERED STEEL STAKES. (3) MULCH, TYPE AND DEPTH PER PLANS.

(4) FINISH GRADE.


1) INSTALL EDGING SO THAT STAKES WILL BE ON INSIDE OF PLANTING BED. BOTTOM OF EDGING SHALL BE BURIED A MINIMUM OF 1" BELOW FINISH GRADE 3) TOP OF MULCH SHALL BE 1" LOWER THAN TOP OF EDGING.

DISTANCE PER PLAN


24" MIN. TO EDGE


OF MATURE CANOPY




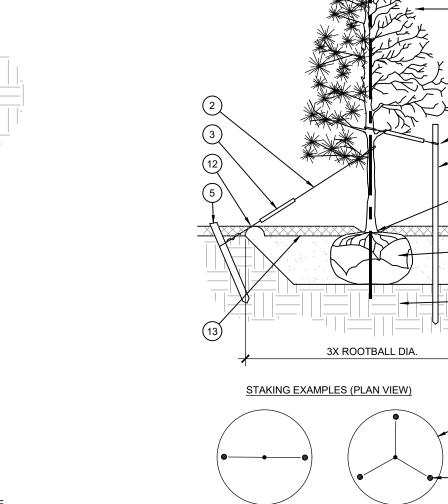

WINDS SCALE: NOT TO SCALE

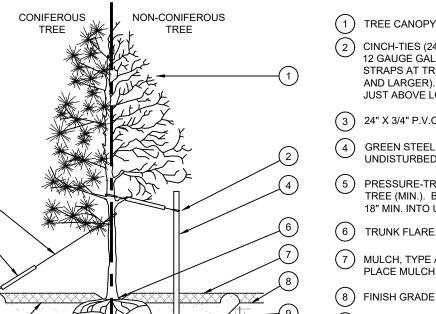

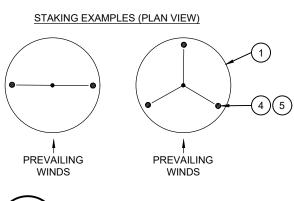

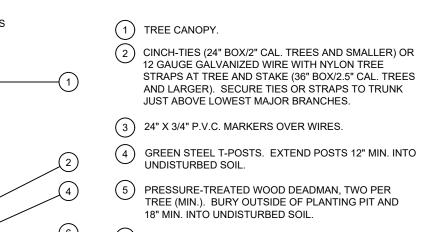

(6) TRUNK FLARE

7) MULCH, TYPE AND DEPTH PER PLANS. DO NOT PLACE MULCH WITHIN 6" OF TRUNK.

9) ROOT BALL.

10) BACKFILL. AMEND AND FERTILIZE ONLY AS RECOMMENDED IN SOIL FERTILITY ANALYSIS.

(11) UNDISTURBED NATIVE SOIL.

(12) 4" HIGH EARTHEN WATERING BASIN.


(13) FINISH GRADE.


SCARIFY SIDES OF PLANTING PIT PRIOR TO SETTING TREE. REMOVE EXCESS SOIL APPLIED ON TOP OF THE ROOTBALL THAT COVERS THE ROOT FLARE. THE PLANTING HOLE DEPTH SHALL BE SUCH THAT THE ROOTBALL RESTS ON UNDISTURBED SOIL, AND THE

ROOT FLARE IS 2"-4" ABOVE FINISH GRADE. FOR B&B TREES, CUT OFF BOTTOM 1/3 OF WIRE BASKET BEFORE PLACING TREE IN HOLE, CUT OFF AND REMOVE REMAINDER OF BASKET AFTER TREE IS SET IN HOLE, REMOVE ALL NYLON TIES, TWINE, ROPE, AND OTHER PACKING MATERIAL. REMOVE AS MUCH BURLAP FROM AROUND ROOTBALL AS IS PRACTICAL.

REMOVE ALL NURSERY STAKES AFTER PLANTING. 5. FOR TREES 36" BOX/2.5" CAL. AND LARGER, USE THREE STAKES OR DEADMEN (AS APPROPRIATE), SPACED EVENLY AROUND TREE.

6 STAKING SHALL BE TIGHT ENOUGH TO PREVENT TRUNK FROM BENDING, BUT LOOSE ENOUGH TO ALLOW SOME TRUNK MOVEMENT

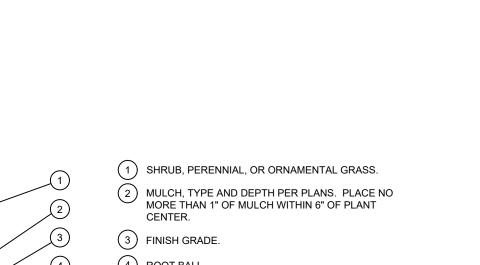

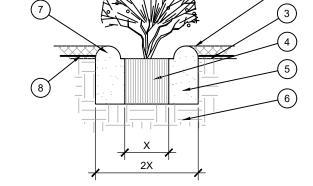


- (4) ROOT BALL.
- (5) BACKFILL, AMEND AND FERTILIZE ONLY AS (6) UNDISTURBED NATIVE SOIL.
- (7) 3" HIGH EARTHEN WATERING BASIN.
- (8) WEED FABRIC UNDER MULCH.

PLANTING AT PARKING AREA


(2) MULCH LAYER

(4) TURF (WHERE SHOWN ON PLAN).

(3) PLANT.

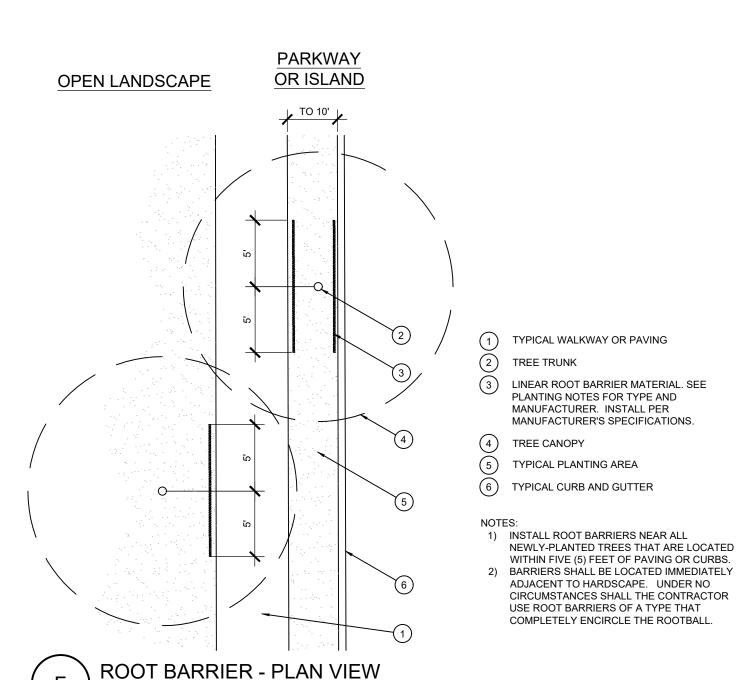

SHRUB AND PERENNIAL PLANTING

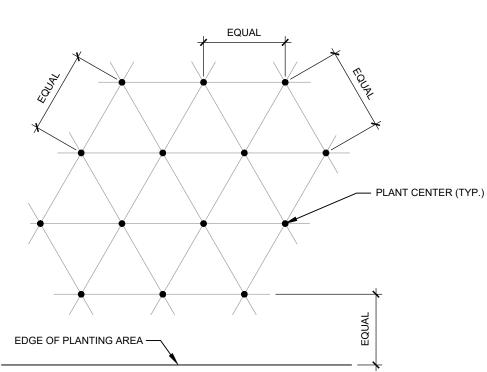

NOTE: ALL PLANTS SHALL BE PLANTED AT EQUAL TRIANGULAR SPACING (EXCEPT WHERE SHOWN ON PLANS AS INFORMAL GROUPINGS). REFER TO PLANT LEGEND FOR SPACING DISTANCE BETWEEN PLANTS.

1) STEP 1: DETERMINE TOTAL PLANTS FOR THE AREA WITH THE FOLLOWING FORMULA: TOTAL AREA / AREA DIVIDER = TOTAL PLANTS PLANT SPACING AREA DIVIDER

2) STEP 2: SUBTRACT THE ROW (S) OF PLANTS THAT WOULD OCCUR AT THE EDGE OF THE PLANTED AREA WITH THE FOLLOWING FORMULA: TOTAL PERIMETER LENGTH / PLANT SPACING = TOTAL PLANT SUBTRACTION **EXAMPLE:** PLANTS AT 18" O.C. IN 100 SF PLANTING AREA, 40 LF PERIMETER

STEP 2: 51 PLANTS - (40 LF / 1.95 = 21 PLANTS) = 30 PLANTS TOTAL

STEP 1: 100 SF/1.95 = 51 PLANTS

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OR PERMITTING PURPOSES.

MARY N. BATES

TEXAS L.A. #3613

ISSUED ON:

OCTOBER 04, 2024

www.evergreendesigngroup.co

HARDSCAPE PLAN

Date Comment

roject Number 10/04/24 Drawn By Checked By



DATE: May 29, 2025

TO: Chase Finch

200 W. Belmont

Suite E

Allen, Texas 75013

CC: John Arnold

8214 Westchester Drive

Suite 900

Dallas, Texas 75202

FROM: Bethany Ross

City of Rockwall Planning and Zoning Department

385 S. Goliad Street Rockwall, TX 75087

SUBJECT: SP2025-015; Site Plan for Phase II for Quail Hollow Subdivision

Chase,

This letter serves to notify you that the above referenced case (*i.e.* Site Plan) that you submitted for consideration by the City of Rockwall was approved by the Planning and Zoning Commission on May 13, 2025. The following is a record of all recommendations, voting records:

Staff Recommendations:

- (1) All technical comments from City Staff (i.e. Engineering, Planning and Fire Department) shall be addressed prior to release of the civil engineering plans; and,
- (2) The development shall adhere to the Parks and Recreation Department's recommendations as outlined above in this case memo; and,
- (3) Any construction resulting from the approval of this <u>Site Plan</u> shall conform to the requirements set forth by the Unified Development Code (UDC), the International Building Code (IBC), the Rockwall Municipal Code of Ordinances, city adopted engineering and fire codes and with all other applicable regulatory requirements administered and/or enforced by the state and federal government.

Planning and Zoning Commission

On May 13, 2025, the Planning and Zoning Commission approved a motion to approve of the Site Plan by a vote of 4-0, with Commissioners Thompson and Hustings absent, and one (1) vacant seat.

Should you have any questions or concerns regarding your site plan case, please feel free to contact me at (972) 772-6488.

Sincerely

Bethany Ross, Planner

City of Rockwall Planning and Zoning Department

From: Ross, Bethany

To: <u>James Murphey</u>; <u>Price, Madelyn</u>; <u>Rice, James</u>

Cc: Chase Finch; Brandon Davidson; John Arnold; Kevin Geyer; Browning, Jonathan; Miller, Ryan

Subject: RE: Quail Hollow 2 - Plans

 Date:
 Wednesday, May 28, 2025 10:29:00 AM

 Attachments:
 Project Comments (05.23.2025).pdf

 Engineering Markung (05.23.2025) pdf

Engineering Markups (05.23.2025).pdf

image003.pnq

James,

Please see attached highlighted comments and engineering markups that still need to be addressed.

On Comment M.7 (3) -- you should have 300 additional trees somewhere in the development for the detention requirement. Required trees for buffers do not count towards this number. A total of 478 trees is required for both buffers and the detention. (178 trees are required for buffers, 300 trees are required for the detention) Currently you are showing 249 total trees within the development of Phase 2.

Thank you,
Bethany Ross
Planner
City of Rockwall
972.772.6488 Office
bross@rockwall.com
City of Rockwall - Planning & Zoning

From: James Murphey < jmurphey@skorburgcompany.com>

Sent: Tuesday, May 27, 2025 12:01 PM

Cc: Chase Finch <cfinch@corwinengineering.com>; Brandon Davidson

<bdavidson@corwinengineering.com>; John Arnold <jarnold@skorburgcompany.com>; Kevin Geyer
<kgeyer@skorburgcompany.com>; Browning, Jonathan <jbrowning@rockwall.com>; Miller, Ryan
<RMiller@rockwall.com>

Subject: RE: Quail Hollow 2 - Plans

Bethany, Johnathan,

Since we have delivered all remaining items to the city and the plat been approved. Can we please receive the stamped plans and be released for construction.

James Murphey

Director of Project Management | Skorburg Company 8214 Westchester Dr Suite 900 | Dallas, TX 75225 jmurphey@skorburgcompany.com

O: 214.888.8850 | C: 210.710.1472

From: James Murphey

Sent: Thursday, May 22, 2025 3:46 PM

To: Price, Madelyn < MPrice@rockwall.com>; Rice, James < jrice@rockwall.com>; Ross, Bethany

<<u>bross@rockwall.com</u>>

Cc: Chase Finch <<u>cfinch@corwinengineering.com</u>>; Brandon Davidson

<<u>bdavidson@corwinengineering.com</u>>; John Arnold <<u>jarnold@skorburgcompany.com</u>>; Kevin Geyer

<<u>kgeyer@skorburgcompany.com</u>>; Browning, Jonathan <<u>ibrowning@rockwall.com</u>>; Miller, Ryan

<RMiller@rockwall.com>

Subject: RE: Quail Hollow 2 - Plans

Bethany,

Below is a link to the revised landscape/site plans

Quail Hollow-P2 Landscape Plans 2025-05-22.pdf

James Murphey

Director of Project Management | Skorburg Company 8214 Westchester Dr Suite 900 | Dallas, TX 75225 imurphev@skorburgcompany.com

O: 214.888.8850 | C: 210.710.1472

From: Price, Madelyn < <u>MPrice@rockwall.com</u>>

Sent: Tuesday, May 20, 2025 8:49 AM

To: Rice, James < <u>irice@rockwall.com</u>>; Joe Winchester < <u>joe@cwyoung.com</u>>; Ross, Bethany < <u>bross@rockwall.com</u>>

Cc: James Murphey < <u>imurphey@skorburgcompany.com</u>>; Chase Finch

<<u>cfinch@corwinengineering.com</u>>; Brandon Davidson <<u>bdavidson@corwinengineering.com</u>>; John

Arnold <<u>jarnold@skorburgcompany.com</u>>; Kevin Geyer <<u>kgeyer@skorburgcompany.com</u>>;

Browning, Jonathan < ibrowning@rockwall.com >; cbonilla@lhlacv.com; Zachary McMahon

<zmcmahon@rwsolutionsinc.com>; Kane Larue <kane@sinksexcavation.com>

Subject: RE: Quail Hollow 2 - Plans

Hi Joe,

I believe the plans have not been released because they needed to go back through the Site Plan process and Planning and Zoning are still waiting on revised plans per their comments. @Ross.
Bethany is waiting on updated plans.

Thank you,

Madelyn Price, P.E. Civil Engineer City of Rockwall 385 S. Goliad Rockwall, TX 75087

972-772-6443

From: Rice, James < jrice@rockwall.com
Sent: Tuesday, May 20, 2025 8:31 AM
To: Joe Winchester < joe@cwyoung.com

Cc: James Murphey < <u>imurphey@skorburgcompany.com</u>>; Chase Finch

<<u>cfinch@corwinengineering.com</u>>; Brandon Davidson <<u>bdavidson@corwinengineering.com</u>>; John

Arnold <<u>jarnold@skorburgcompany.com</u>>; Kevin Geyer <<u>kgeyer@skorburgcompany.com</u>>; Browning, Jonathan <<u>jbrowning@rockwall.com</u>>; Price, Madelyn <<u>MPrice@rockwall.com</u>>;

<u>cbonilla@lhlacy.com</u>; Zachary McMahon <<u>zmcmahon@rwsolutionsinc.com</u>>; Kane Larue

< kane@sinksexcavation.com>

Subject: Re: Quail Hollow 2 - Plans

I do not have a set so I'm assuming they are not released yet for whatever reason. You can call or email Maddy price at mprice@rockwall.com

Thanks,

James Rice Construction Inspector City Of Rockwall 469-925-3597

Sent from my iPhone

On May 20, 2025, at 8:18 AM, Joe Winchester < <u>ioe@cwyoung.com</u>> wrote:

James/Chase,

Do you know if the City still has the stamped plans or if someone picked them up? I never received my copies.

Thanks,

Joe Winchester
<image001.png>
Office: (817) 477-1414
joe@cwyoung.com

From: Joe Winchester

Sent: Wednesday, February 26, 2025 5:07 PM

To: James Murphey < <u>imurphey@skorburgcompany.com</u>>; Chase Finch

<<u>cfinch@corwinengineering.com</u>>; Brandon Davidson

<bdavidson@corwinengineering.com>

Cc: John Arnold <<u>iarnold@skorburgcompany.com</u>>; Kevin Geyer

<kgeyer@skorburgcompany.com>; Browning, Jonathan <jbrowning@rockwall.com>;

Price, Madelyn <mprice@rockwall.com; 'Rice, James' <jrice@rockwall.com;

cbonilla@Ihlacv.com; Zachary McMahon <zmcmahon@rwsolutionsinc.com>; Kane

Larue < kane@sinksexcavation.com >

Subject: RE: Quail Hollow 2 - Plans

For C.W. Young, please give us 3 large and 3 small sets. Also, a pdf with the City stamp when available.

From: James Murphey < <u>imurphey@skorburgcompany.com</u>>

Sent: Wednesday, February 26, 2025 4:55 PM

To: Chase Finch < cfinch@corwinengineering.com >; Brandon Davidson

<<u>bdavidson@corwinengineering.com</u>>

Cc: John Arnold <<u>iarnold@skorburgcompany.com</u>>; Kevin Geyer

<kgeyer@skorburgcompany.com>; Browning, Jonathan <ibrowning@rockwall.com>;

Price, Madelyn <<u>mprice@rockwall.com</u>>; 'Rice, James' <<u>irice@rockwall.com</u>>;

cbonilla@lhlacv.com; Joe Winchester < ioe@cwyoung.com >; Zachary McMahon

<zmcmahon@rwsolutionsinc.com>; Kane Larue <kane@sinksexcavation.com>

Subject: Quail Hollow 2 - Plans

Chase,

Will you please deliver 7 Half Size and 2 Full Size sets of plans to the city.

Kane, Joe, Chris, Zach,

How many sets of plans do you need for the project?

James Murphey

Director of Project Management | Skorburg Company 8214 Westchester Dr Suite 900 | Dallas, TX 75225 jmurphey@skorburgcompany.com

O: 214.888.8850 | C: 210.710.1472

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From: Lee, Henry To: **Chase Finch**

Cc: John Arnold; Ross, Bethany Subject: Project Comments SP2025-015 Date: Friday, April 25, 2025 1:46:17 PM Attachments: Project Comments (04.24.2025).pdf Engineering Mark-Ups (04.25.2025).pdf

Good Afternoon,

Attached are the project comments for your case. Revisions for this case are due May 6, 2025. The meeting schedule for this case is as follows:

Planning and Zoning Commission: April 29, 2025

Parks Board: May 6, 2025

Planning and Zoning Commission: May 13, 2025

Please note that all meetings will be held at 6:00 PM at 385 S. Goliad Street in the City Council Chambers. Please also note that a representative is <u>required</u> to be at all meetings. Should you have any questions please let me know.

Thank you,



Henry Lee, AICP Senior Planner Planning & Zoning Department 972.772.6434 HLee@rockwall.com 385 S. Goliad Street, Rockwall, TX 75087