

PLANNING & ZONING CASE NO.

PLANNING & ZONING FEE

PLATTING APPLICATION

MASTER PLAT PRELIMINARY PLAT FINAL PLAT REPLAT

AMENDING OR MINOR PLAT PLAT REINSTATEMENT REQUEST

SITE PLAN APPLICATION

SITE PLAN

AMENDED SITE PLAN/ELEVATIONS/LANDSCAPING

ZONING APPLICATION

ZONING CHANGE SPECIFIC USE PERMIT PD DEVELOPMENT PLAN

OTHER APPLICATION

TREE REMOVAL

VARIANCE REQUEST/SPECIAL EXCEPTIONS

RECORD OF RECOMMENDATIONS, VOTING RECORDS, AND CONDITIONS OF APPROVAL

ARCHITECTURE REVIEW BOARD	CITY COUNCIL READING #2
PLANNING AND ZONING COMMISSION	CONDITIONS OF APPROVAL
CITY COUNCIL READING #1	NOTES



DEVELOPMENT APPLICATION

City of Rockwall
Planning and Zoning Department
385 S. Goliad Street
Rockwall, Texas 75087

PLANNING & ZONING CASE	NO.
	NOT CONSIDERED ACCEPTED BY THE DIRECTOR AND CITY ENGINEER HAVE
DIRECTOR OF PLANNING:	
CITY ENGINEER:	

	Nochwall, Texas 75007		CITYE	NGINEER:			
PLEASE CHECK THE	APPROPRIATE BOX BELOW TO INDICATE THE TY	PE OF DEVELOPME	NT REQ	JEST [SELECT	ONLY ONE BOX]		
PLATTING APPLIC MASTER PLAT PRELIMINARY F FINAL PLAT (\$300.0 REPLAT (\$300.0 AMENDING OR PLAT REINSTAT	☐ ZONII☐ SPEC ☐ PD DI OTHER A	ZONING APPLICATION FEES: ZONING CHANGE (\$200.00 + \$15.00 ACRE) SPECIFIC USE PERMIT (\$200.00 + \$15.00 ACRE) PD DEVELOPMENT PLANS (\$200.00 + \$15.00 ACRE) OTHER APPLICATION FEES: TREE REMOVAL (\$75.00) VARIANCE REQUEST/SPECIAL EXCEPTIONS (\$100.00) 2					
SITE PLAN APPLICATION FEES: SITE PLAN (\$250.00 + \$20.00 ACRE) 1 AMENDED SITE PLAN/ELEVATIONS/LANDSCAPING PLAN (\$100.00)			AMOUNT. F	OR REQUESTS ON LI LL BE ADDED TO	THE EXACT ACREAGE ESS THAN ONE ACRE, THE APPLICATION FE NOT IN COMPLIANCE	ROUNDUPTO (E FOR ANY RE	ONE (1) ACRE. EQUEST THAT
PROPERTY INFO	PRMATION [PLEASE PRINT]						
ADDRESS	550 La Jolla Pointe Dr, Rockw	all, TX 75087					
SUBDIVISION	La Jolla Pointe Addition			LOT	22 & 23	BLOCK	А
GENERAL LOCATION	Northeast Corner of La Jolla P	ointe Dr & Ca	rmel (Circle			
ZONING, SITE PI	AN AND PLATTING INFORMATION [F	LEASE PRINT]					
CURRENT ZONING	C	CURRE	NT USE	Undevelo	ped		
PROPOSED ZONING	C	PROPOSE	D USE	Office			
ACREAGE	9.94 LOTS [CUR	RENT] 2		LOT	S [PROPOSED]	1	
REGARD TO ITS	D PLATS: BY CHECKING THIS BOX YOU ACKNOWLEE APPROVAL PROCESS, AND FAILURE TO ADDRESS AN DENIAL OF YOUR CASE.	GE THAT DUE TO TH Y OF STAFF'S COMMI	E PASSA ENTS BY	GE OF <u>HB3167</u> THE DATE PROV	THE CITY NO LON IDED ON THE DEV	GER HAS FL ELOPMENT (EXIBILITY WITH CALENDAR WILL
OWNER/APPLIC	ANT/AGENT INFORMATION [PLEASE PRI	NT/CHECK THE PRIMA	RY CONT	ACT/ORIGINAL S	SIGNATURES ARE I	REQUIRED]	
🛛 OWNER	Rockwall EDC	⊠ APPLI	CANT	Kimley-Ho	orn		
CONTACT PERSON	Shannon Foltz	CONTACT PE	RSON	Todd Mar	tin, P.E.		
ADDRESS	2610 Observation Trail	ADD	RESS	203 West	Nash Stree	et	
	Suite 104			Suite 100			
CITY, STATE & ZIP	Rockwall, TX 75032	CITY, STATE		Terrell, T	X 75160		
PHONE			HONE				
E-MAIL			-MAIL		_		V
NOTARY VERIFI BEFORE ME, THE UNDER STATED THE INFORMAT	CATION [REQUIRED] RSIGNED AUTHORITY, ON THIS DAY PERSONALLY APF ION ON THIS APPLICATION TO BE TRUE AND CERTIFIE	EARED Shared THE FOLLOWING:	MO	1 Folts	[OWNER]	THE UNDER	RSIGNED, WHO
INFORMATION CONTAINE	TAM THE OWNER FOR THE PURPOSE OF THIS APPLICATE TO COVER THE COST OF THIS APPLICATION, 20 55 BY SIGNING THIS APPLICATION, ED WITHIN THIS APPLICATION TO THE PUBLIC. THE C	ON, HAS BEEN PAID TO I AGREE THAT THE CIT ITY IS ALSO AUTHORI	THE CITY Y OF ROC ZED AND	OF ROCKWALL OF CKWALL (I.E. "CIT) PERMITTED TO	N THIS THE	AND PERMITI	DAY OF TED TO PROVIDE D INFORMATION
GIVEN UNDER MY HAND	GIVEN UNDER MY HAND AND SEAL OF OFFICE ON THIS THE DAY OF JUNE 20 25 OWNER'S SIGNATURE OWNER'S SIGNATURE OWNER'S SIGNATURE						
NOTARY PUBLIC IN AND	FOR THE STATE OF TEXAS	Project &		MY COM	MISSION EXPIRES		20
	AND CONTROL OF THE CO						

LANDSCAPE CONSTRUCTION PLANS

FOR

LA JOLLA POINTE DRIVE PAD READY DEVELOPMENT 550 LA JOLLA POINTE DR. ROCKWALL, TX 75087 BLOCK A, LOT 22 & 23

PLANS SUBMITTAL/REVIEW LOG

FIRST CITY SUBMITTAL
-NOT FOR CONSTRUCTION

10/09/2024

SECOND CITY SUBMITTA
-NOT FOR CONSTRUCTION

05/16/2025

03/28/2025

-NOT FOR CONSTRUCTION

FOURTH CITY SUBMITTAL -NOT FOR CONSTRUCTION

06/18/2025

IN
THE CITY OF ROCKWALL,
ROCKWALL COUNTY, TEXAS

VICINITY	MAP		N.T.S.
			W YELLOW JACKET LN
	┌ SI		CREETING REST ALSO
	LA JOLLA POINTE DR	ROSE RELATIONS OF THE PARTY OF	
	LA JOL CARME CIR		
		MARKET CENTER OR	
LAGUNA DR	30)//	•	Lerhur dangt

	LANDSCAPE SHEET LIST TABLE
Sheet Number	Sheet Title
LC 0.00	COVER SHEET
TP 1.00	TREE PRESERVATION & REMOVAL PLAN
TP 2.00	TREE PRESERVATION DETAILS & NOTES
LP 0.00	PLANTING SCHEDULE & NOTES
LP 1.00	LANDSCAPE PLAN
LP 2.00	PLANTING DETAILS
LP 2.01	PLANTING DETAILS
LP 2.02	PLANTING DETAILS

OWNER



ROCKWALL ECONOMIC

DEVELOPEMENT CORPORATION

2610 OBSERVATION TRAIL, SUITE 104

ROCKWALL, TX 75032

CONTACT: PHIL WAGNER

Kimley» Horn

2500 PACIFIC AVENUE, SUITE 1100 DALLAS, TEXAS 75240 PHONE: (972) 910 2925 CONTACT: BEN RANKIN, PLA LA JOLLA POINTE ADDITION PH2 JUNE 18, 2025 /ER No. REVISIONS DATE

13455 NOEL RD. TWO GALLERIA OFFICE TOWER SUITE 700 DALLAS, TX 75240
PHONE: 972-770-1300 FAX: 972-239-3820
WWW.KIMLEY-HORN.COM TX F-928
© 2024 KIMLEY-HORN AND ASSOCIATES, INC.

PRELIMINARY

FOR REVIEW ONLY
Not for construction or permit purposes.

Kimley» Horn

R.L.A. BEN L. RANKIN
L.A. No. 2904 Date 06/18/2025

DATE
064584402

DATE
06/18/2025

SCALE AS SHOWN
DESIGNED BY DHL
DRAWN BY DHL

A JOLLA POINTE DRIVE

D READY DEVELOPMEN


PREPARED FOR

ROCKWALL ECONOMIC

DEVELOPMENT COPORATION

SOVER SHEET

SHEET NUMBER

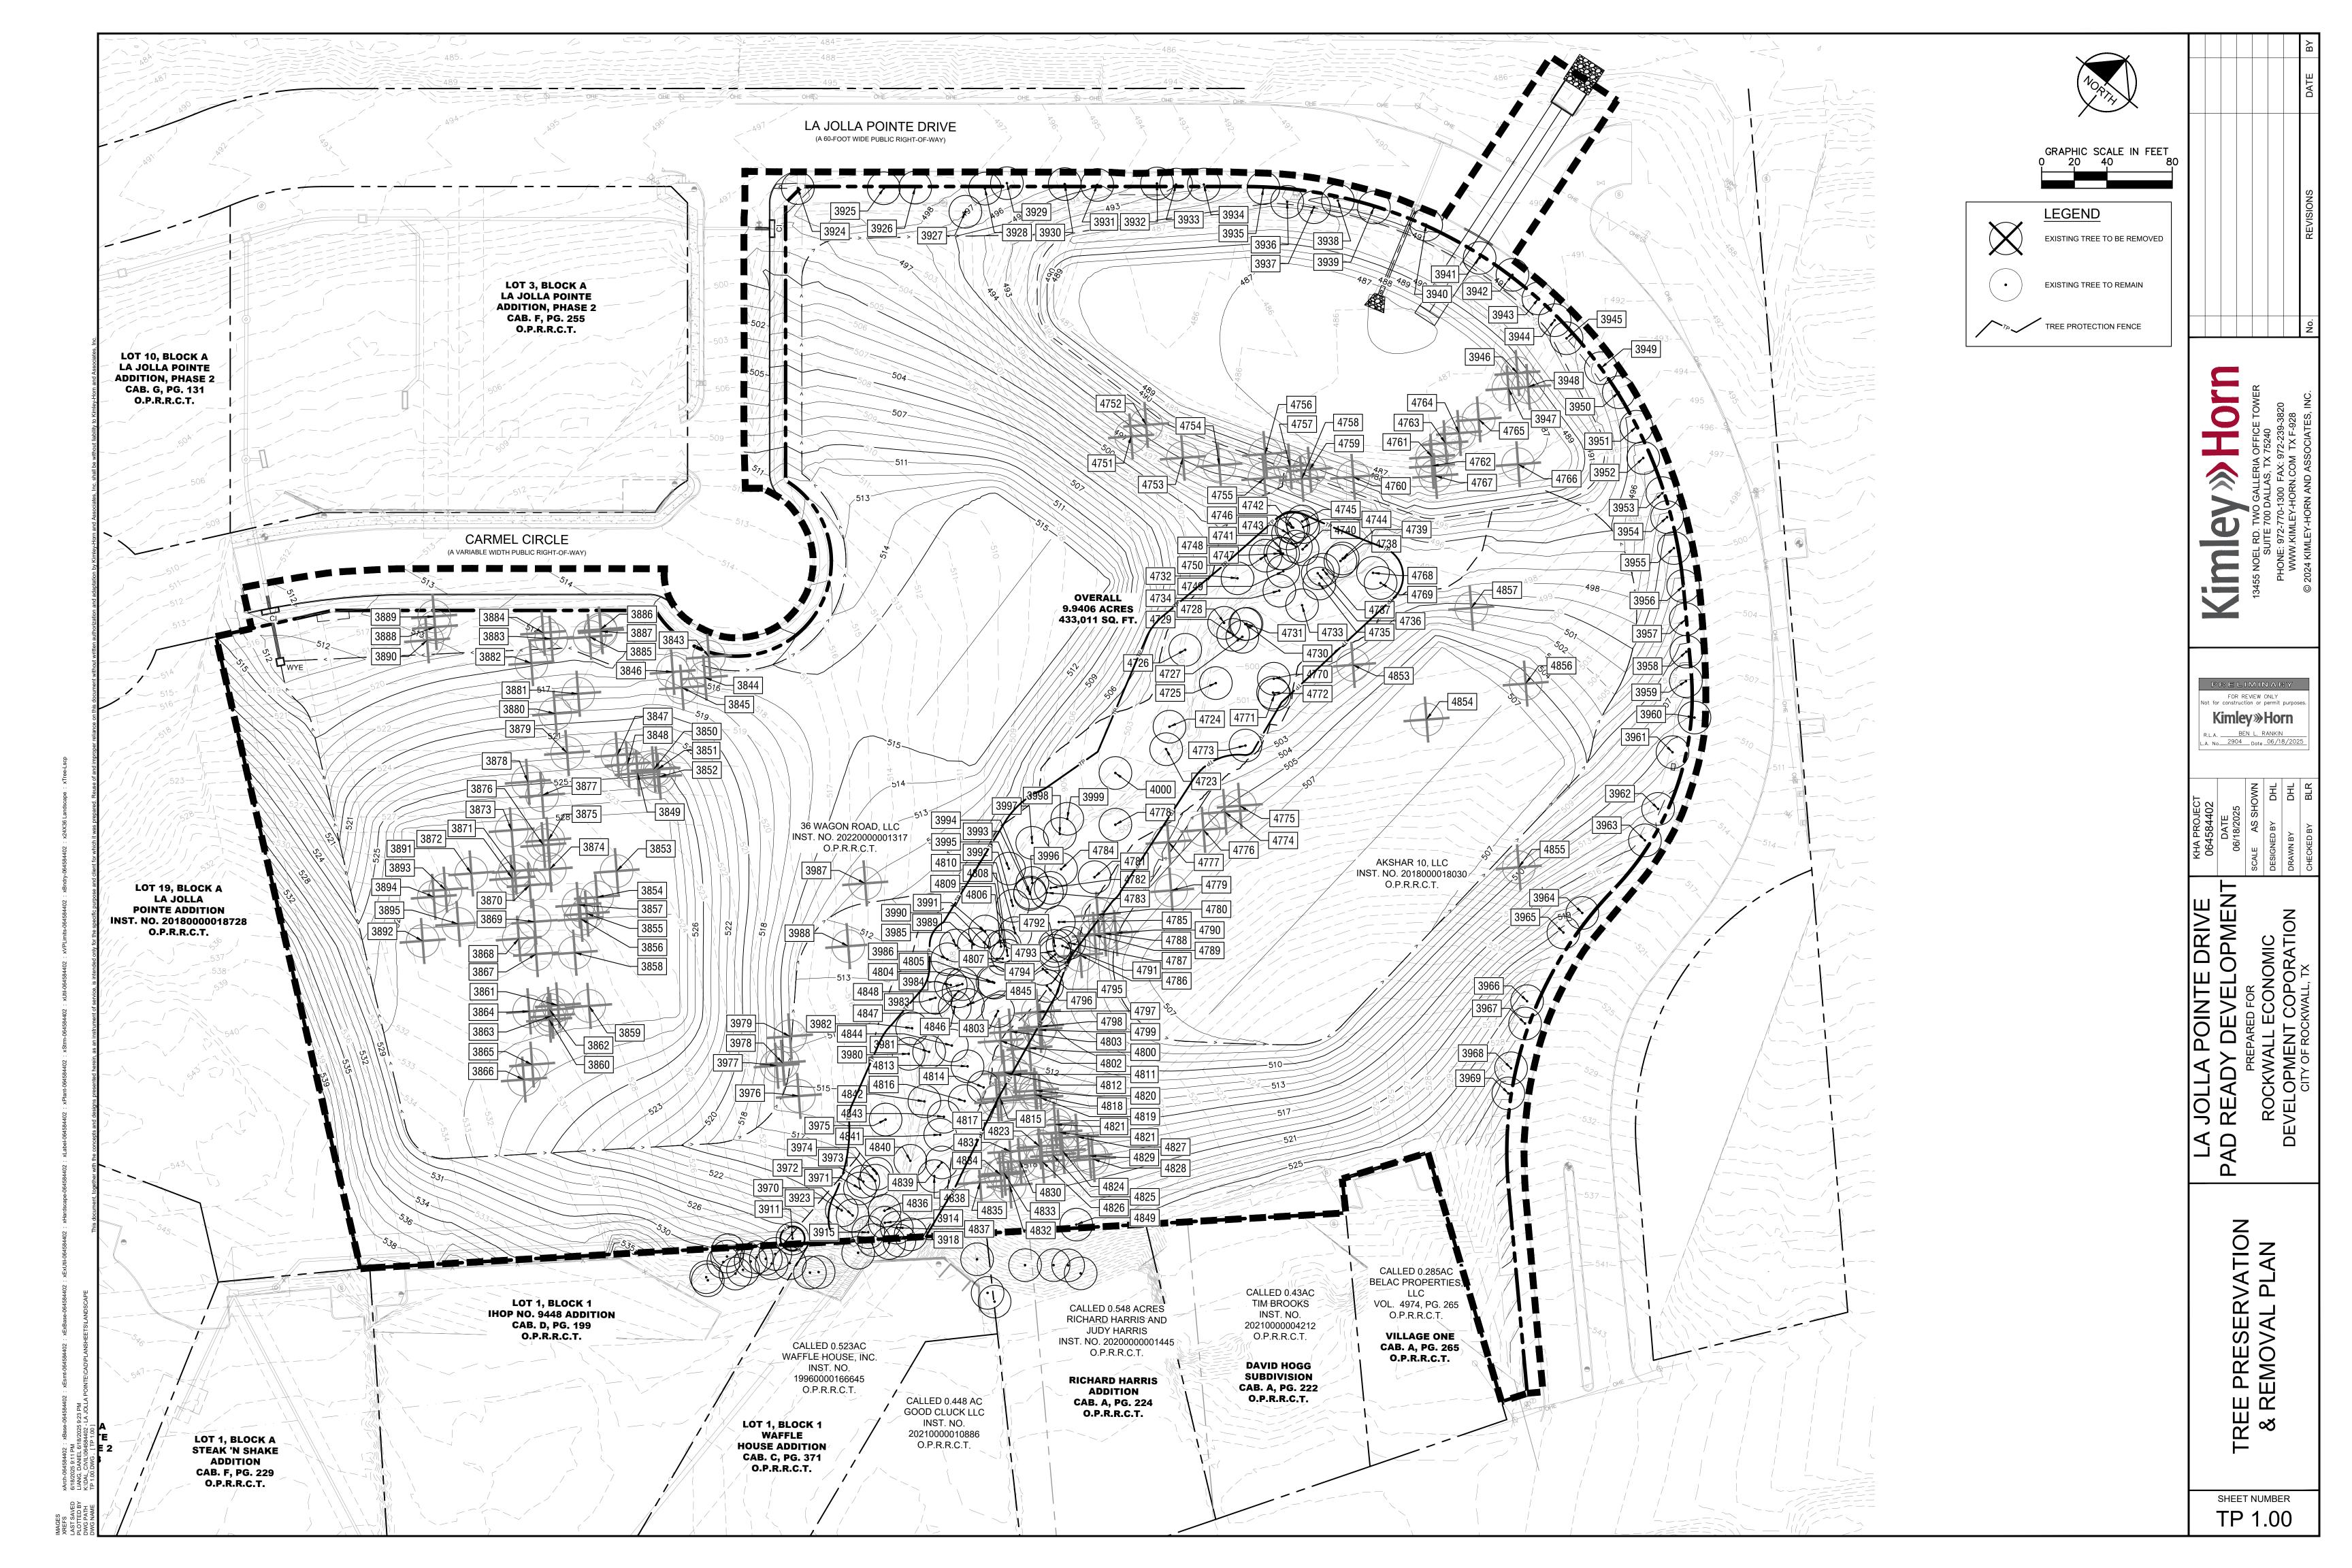


SITE	TREE	S REMOVE	D FOR GRADING	\ \ \	AND TIPLE									MINITED 5	1		
TAG #	DBH 10.2	COMMON NAME	SCIENTIFIC NAME	CONDITION Healthy	MULTIPLE- STEMMED	PROTECTED	STATUS Removed	MITIGATE 10.2	TAG # 4749	DBH 7.5	persimmon	SCIENTIFIC NAME Diospyros virginiana	CONDITION	MULTIPLE- STEMMED Single	Yes Yes	STATUS Remain	MITIGATE 0.0
3843 3844	8.1	green ash green ash	Fraxinus pennsylvanica Fraxinus pennsylvanica	Healthy	Single Single	Yes Yes	Removed	8.1	4750 4751	7.1 4.1	persimmon persimmon live oak	Diospyros virginiana	Healthy Healthy	Single Single	Yes Yes	Remain	0.0
3845 3846	15.8 9.0	green ash green ash	Fraxinus pennsylvanica Fraxinus pennsylvanica	Healthy Healthy	Forked Single	Yes Yes	Removed Removed	15.8 9.0	4752	4.0	live oak	Quercus virginiana Quercus virginiana	Declining	Forked	No	Removed Removed	0.0
3847 3848	5.9 4.2	green ash Hercules-club	Fraxinus pennsylvanica Zanthoxylum clava-herculis	Healthy Declining	Single Single	Yes No	Removed Removed	5.9 0.0	4753 4754	4.2 9.1	cedar elm cedar elm	Ulmus crassifolia Ulmus crassifolia	Declining Healthy	Single Single	No Yes	Removed Removed	0.0 9.1
3849 3850	6.2 4.5	Hercules-club green ash	Zanthoxylum clava-herculis Fraxinus pennsylvanica	Healthy Healthy	Multi Single	Yes Yes	Removed Removed	6.2 4.5	4755 4756	5.8 5.6	cedar elm cedar elm	Ulmus crassifolia Ulmus crassifolia	Healthy Healthy	Multi Forked	Yes Yes	Removed Removed	5.8 5.6
3851 3852	4.3 4.8	black hickory green ash	Carya texana Fraxinus pennsylvanica	Healthy Healthy	Multi Single	Yes Yes	Removed Removed	4.3 4.8	4757 4758	4.5 9.2	cedar elm cedar elm	Ulmus crassifolia Ulmus crassifolia	Healthy Healthy	Forked Forked	Yes Yes	Removed Removed	4.5 9.2
3853 3854	25.8 10.2	green ash	Fraxinus pennsylvanica	Healthy Healthy	Multi Single	Yes Yes	Removed Removed	25.8 10.2	4759 4760	6.8 12.9	cedar elm cedar elm	Ulmus crassifolia Ulmus crassifolia	Healthy Healthy	Single Forked	Yes Yes	Removed Removed	6.8 12.9
3855	9.2	green ash green ash	Fraxinus pennsylvanica Fraxinus pennsylvanica	Healthy	Single	Yes	Removed	9.2	4761 4762	7.9	live oak	Quercus virginiana	Healthy Healthy	Single Multi	Yes Yes	Removed Removed	7.9 12.8
3856 3857	12.9 9.5	green ash green ash	Fraxinus pennsylvanica Fraxinus pennsylvanica	Healthy Healthy	Single Single	Yes Yes	Removed Removed	12.9 9.5	4763	9.6	live oak	Quercus virginiana Quercus virginiana	Healthy	Forked	Yes	Removed	9.6
3858 3859	9.7 13.8	green ash green ash	Fraxinus pennsylvanica Fraxinus pennsylvanica	Healthy Healthy	Single Single	Yes Yes	Removed Removed	9.7 13.8	4764 4765	12.9 10.1	live oak live oak	Quercus virginiana Quercus virginiana	Healthy Healthy	Multi Forked	Yes Yes	Removed Removed	12.9 10.1
3860 3861	4.7 4.6	Hercules-club Hercules-club	Zanthoxylum clava-herculis Zanthoxylum clava-herculis	Healthy Healthy	Forked Single	Yes Yes	Removed Removed	4.7 4.6	4766 4767	32.6 14.2	pecan live oak	Carya illinoinensis Quercus virginiana	Healthy Healthy	Single Single	Yes Yes	Removed Removed	32.6 14.2
3862 3863	7.6 6.9	Hercules-club cedar elm	Zanthoxylum clava-herculis Ulmus crassifolia	Healthy Healthy	Forked Multi	Yes Yes	Removed Removed	7.6 6.9	4768 4769	16.8 12.2	hackberry hackberry	Celtis laevigata Celtis laevigata	Hazard Healthy	Single Forked	No No	Remain Remain	0.0
3864	4.1	Hercules-club	Zanthoxylum clava-herculis	Healthy	Multi	Yes	Removed	4.1	4770 4771	6.8	Hercules-club American elm	Zanthoxylum clava-herculis Ulmus americana	Healthy Healthy	Forked Single	Yes Yes	Remain Remain	0.0
3865 3866	22.1 5.3	hackberry cedar elm	Celtis laevigata Ulmus crassifolia	Declining Healthy	Forked Single	No Yes	Removed Removed	0.0 5.3	4772	4.1	American elm	Ulmus americana	Healthy	Single	Yes	Remain	0.0
3867 3868	6.3 10.2	cedar elm green ash	Ulmus crassifolia Fraxinus pennsylvanica	Healthy Healthy	Single Multi	Yes Yes	Removed Removed	6.3 10.2	4773 4774	5.8 5.1	American elm American elm	Ulmus americana Ulmus americana	Healthy Healthy	Single Single	Yes Yes	Remain Removed	0.0 5.1
3869 3870	19.9 9.3	cedar elm green ash	Ulmus crassifolia Fraxinus pennsylvanica	Healthy Healthy	Multi Single	Yes Yes	Removed Removed	19.9 9.3	4775 4776	4.2 5.4	green ash American elm	Fraxinus pennsylvanica Ulmus americana	Healthy Healthy	Single Single	Yes Yes	Removed Removed	4.2 5.4
3871 3872	11.1 13.8	cedar elm cedar elm	Ulmus crassifolia Ulmus crassifolia	Healthy Hazard	Single Single	Yes No	Removed Removed	11.1 0.0	4777 4778	6.8 6.0	eastern redbud American elm	Cercis canadensis Ulmus americana	Healthy Healthy	Forked Single	Yes Yes	Removed Remain	6.8 0.0
3873 3874	11.4	green ash	Fraxinus pennsylvanica	Healthy	Single	Yes Yes	Removed Removed	11.4 11.8	4779 4780	42.5 4.4	pecan green ash	Carya illinoinensis Fraxinus pennsylvanica	Healthy Healthy	Forked Single	Yes Yes	Removed Removed	42.5 4.4
3875	11.0	green ash green ash	Fraxinus pennsylvanica Fraxinus pennsylvanica	Healthy Healthy	Single Single	Yes	Removed	11.0	4781 4784	18.3	hackberry	Celtis laevigata	Healthy Declining	Single Single	No No	Remain Remain	0.0
3876 3877	6.4 11.2	sweetgum green ash	Liquidambar styraciflua Fraxinus pennsylvanica	Healthy Healthy	Single Single	Yes Yes	Removed Removed	6.4 11.2	4785	4.5	green ash green ash	Fraxinus pennsylvanica Fraxinus pennsylvanica	Healthy	Single	Yes	Remain	0.0
3878 3879	12.9 4.0	cedar elm cedar elm	Ulmus crassifolia Ulmus crassifolia	Hazard Healthy	Single Single	No Yes	Removed Removed	0.0 4.0	4786 4787	4.1 5.0	green ash green ash	Fraxinus pennsylvanica Fraxinus pennsylvanica	Healthy Healthy	Single Single	Yes Yes	Removed Remain	4.1 0.0
3880 3881	4.5 20.7	black hickory green ash	Carya texana Fraxinus pennsylvanica	Healthy Healthy	Multi Forked	Yes Yes	Removed Removed	4.5 20.7	4788 4789	4.6 4.8	green ash green ash	Fraxinus pennsylvanica Fraxinus pennsylvanica	Healthy Healthy	Single Single	Yes Yes	Removed Removed	4.6
3882 3883	9.1 10.9	green ash green ash	Fraxinus pennsylvanica Fraxinus pennsylvanica	Healthy Healthy	Single Single	Yes Yes	Removed Removed	9.1 10.9	4790 4791	5.3 4.3	green ash green ash	Fraxinus pennsylvanica Fraxinus pennsylvanica	Healthy Healthy	Single Single	Yes Yes	Removed Remain	5.3 0.0
3884	8.1	green ash	Fraxinus pennsylvanica	Healthy	Single	Yes	Removed	8.1	4792 4793	5.9 5.6	green ash green ash	Fraxinus pennsylvanica Fraxinus pennsylvanica	Healthy Healthy	Single Single	Yes Yes	Remain Remain	0.0
3885 3886	11.2 7.7	green ash green ash	Fraxinus pennsylvanica Fraxinus pennsylvanica	Healthy Healthy	Single Single	Yes Yes	Removed Removed	11.2 7.7	4794	5.1	green ash	Fraxinus pennsylvanica	Healthy	Single	Yes	Remain	0.0
3887 3888	8.9 14.7	green ash green ash	Fraxinus pennsylvanica Fraxinus pennsylvanica	Healthy Healthy	Single Single	Yes Yes	Removed Removed	8.9 14.7	4795 4796	6.0 7.6	green ash green ash	Fraxinus pennsylvanica Fraxinus pennsylvanica	Healthy Healthy	Single Forked	Yes Yes	Remain Remain	0.0
3889 3890	4.7 4.0	green ash Hercules-club	Fraxinus pennsylvanica Zanthoxylum clava-herculis	Healthy Healthy	Single Single	Yes Yes	Removed Removed	4.7 4.0	4797 4798	4.4	green ash green ash	Fraxinus pennsylvanica Fraxinus pennsylvanica	Healthy Healthy	Single Single	Yes Yes	Removed Removed	4.4
3891 3892	13.3 12.2	green ash hackberry	Fraxinus pennsylvanica Celtis laevigata	Healthy Healthy	Single Multi	Yes No	Removed Removed	13.3	4799 4800	5.1 4.9	Hercules-club green ash	Zanthoxylum clava-herculis Fraxinus pennsylvanica	Healthy Healthy	Forked Single	Yes Yes	Removed Removed	5.1 4.9
3893	6.9	green ash	Fraxinus pennsylvanica	Healthy	Forked	Yes	Removed	6.9	4801 4802	16.4 9.2	pecan pecan	Carya illinoinensis Carya illinoinensis	Declining Healthy	Single Single	No Yes	Removed Removed	0.0 9.2
3894 3895	4.9 10.9	Hercules-club cedar elm	Zanthoxylum clava-herculis Ulmus crassifolia	Healthy Healthy	Forked Forked	Yes Yes	Removed Removed	4.9 10.9	4803	7.4	pecan	Carya illinoinensis	Healthy	Single	Yes	Remain	0.0
3911 3914	5.5 6.2	tree of heaven tree of heaven	Ailanthus altissima Ailanthus altissima	Healthy Healthy	Single Single	Yes Yes	Remain Remain	0.0	4804 4805	7.9 8.5	pecan pecan	Carya illinoinensis Carya illinoinensis	Healthy Healthy	Single Single	Yes Yes	Remain Remain	0.0
3915 3918	6.5 9.3	tree of heaven box elder	Ailanthus altissima Acer negundo	Healthy Healthy	Single Single	Yes Yes	Remain Remain	0.0	4806 4807	11.0 10.7	hackberry pecan	Celtis laevigata Carya illinoinensis	Declining Healthy	Single Single	No Yes	Remain Remain	0.0
3923 3946	7.1 6.4	pecan cedar elm	Carya illinoinensis Ulmus crassifolia	Healthy Healthy	Single Single	Yes Yes	Remain Removed	0.0 6.4	4808 4809	9.3 4.9	pecan pecan	Carya illinoinensis Carya illinoinensis	Healthy Healthy	Single Single	Yes Yes	Remain Remain	0.0
3947 3948	7.2	cedar elm	Ulmus crassifolia	Healthy Healthy	Single Single	Yes Yes	Removed Removed	7.2	4810 4811	13.6 8.9	pecan southern red oak	Carya illinoinensis Quercus falcata	Healthy Healthy	Forked Single	Yes Yes	Remain Removed	0.0 8.9
3970	10.7	pecan	Ulmus crassifolia Carya illinoinensis	Healthy	Single	Yes	Remain	0.0	4818 4819	5.3 6.5	green ash green ash	Fraxinus pennsylvanica	Healthy Healthy	Single Single	Yes Yes	Removed Removed	5.3 6.5
3971 3972	9.1 11.5	pecan hackberry	Carya illinoinensis Celtis laevigata	Healthy Healthy	Single Single	Yes No	Remain Remain	0.0	4820	4.6	green ash	Fraxinus pennsylvanica Fraxinus pennsylvanica	Healthy	Single	Yes	Removed	4.6
3973 3974	17.6 20.9	pecan green ash	Carya illinoinensis Fraxinus pennsylvanica	Healthy Healthy	Multi Single	Yes Yes	Remain Remain	0.0	4821 4822	7.9 7.3	green ash green ash	Fraxinus pennsylvanica Fraxinus pennsylvanica	Healthy Healthy	Single Single	Yes Yes	Removed Removed	7.9 7.3
3975 3976	22.5 4.0	southern red oak green ash	Quercus falcata Fraxinus pennsylvanica	Healthy Healthy	Single Single	Yes Yes	Remain Removed	0.0 4.0	4823 4824	8.7 5.6	American elm green ash	Ulmus americana Fraxinus pennsylvanica	Healthy Healthy	Single Single	Yes Yes	Removed Removed	8.7 5.6
3977 3978	6.6 4.4	green ash green ash	Fraxinus pennsylvanica Fraxinus pennsylvanica	Healthy Healthy	Multi Forked	Yes Yes	Removed Removed	6.6 4.4	4825 4826	10.5 12.2	American elm American elm	Ulmus americana Ulmus americana	Healthy Healthy	Single Single	Yes Yes	Removed Removed	10.5 12.2
3979 3980	6.6	green ash	Fraxinus pennsylvanica	Healthy	Single	Yes Yes	Removed Remain	6.6	4827 4828	5.4 4.5	American elm green ash	Ulmus americana Fraxinus pennsylvanica	Healthy Healthy	Single Single	Yes Yes	Removed Removed	5.4 4.5
3981	21.6	green ash American elm	Fraxinus pennsylvanica Ulmus americana	Healthy Healthy	Single Forked	Yes	Remain	0.0	4829 4830	4.4	green ash	Fraxinus pennsylvanica	Healthy Healthy	Single Single	Yes Yes	Removed Removed	4.4
3982 3983	9.2 9.8	pecan pecan	Carya illinoinensis Carya illinoinensis	Healthy Healthy	Single Single	Yes Yes	Remain Remain	0.0	4831	4.5	green ash American elm	Fraxinus pennsylvanica Ulmus americana	Healthy	Single	Yes	Removed	4.5
3984 3985	5.3 16.1	pecan green ash	Carya illinoinensis Fraxinus pennsylvanica	Healthy Hazard	Single Single	Yes No	Remain Remain	0.0	4832 4833	5.9 8.0	green ash American elm	Fraxinus pennsylvanica Ulmus americana	Healthy Healthy	Single Single	Yes Yes	Removed Removed	5.9 8.0
3986 3987	4.4	American elm green ash	Ulmus americana Fraxinus pennsylvanica	Healthy Healthy	Single Single	Yes Yes	Remain Removed	0.0	4834 4835	11.5 8.4	American elm green ash	Ulmus americana Fraxinus pennsylvanica	Healthy Healthy	Forked Single	Yes Yes	Removed Removed	11.5 8.4
3988 3989	25.0	green ash	Fraxinus pennsylvanica	Healthy	Forked Multi	Yes	Removed Remain	25.0 0.0	4836 4837	6.4 9.7	tree of heaven	Ailanthus altissima Ailanthus altissima	Healthy Healthy	Single Single	Yes Yes	Remain Remain	0.0
3990	13.2	American elm green ash	Ulmus americana Fraxinus pennsylvanica	Healthy Healthy	Single	Yes Yes	Remain	0.0	4838	14.1	pecan American elm	Carya illinoinensis Ulmus americana	Healthy	Single Single	Yes Yes	Remain Remain	0.0
3991 3992	4.9 8.9	American elm pecan	Ulmus americana Carya illinoinensis	Healthy Healthy	Single Single	Yes Yes	Remain Remain	0.0	4840	9.9	green ash	Fraxinus pennsylvanica	Healthy	Single	Yes	Remain	0.0
3993 3994	9.1 4.4	pecan American elm	Carya illinoinensis Ulmus americana	Healthy Healthy	Single Single	Yes Yes	Remain Remain	0.0	4841 4842	12.9 17.2	hackberry green ash	Celtis laevigata Fraxinus pennsylvanica	Healthy Healthy	Single Single	No Yes	Remain Remain	0.0
3996 3997	9.2 20.9	pecan green ash	Carya illinoinensis Fraxinus pennsylvanica	Healthy Healthy	Single Forked	Yes Yes	Remain Remain	0.0	4843 4844	7.8 27.3	American elm pecan	Ulmus americana Carya illinoinensis	Declining Healthy	Single Single	No Yes	Remain Remain	0.0
3998 3999	16.1 21.6	American elm American elm	Ulmus americana Ulmus americana	Healthy Healthy	Single Single	Yes Yes	Remain Remain	0.0	4845 4846	6.4 6.9	pecan pecan	Carya illinoinensis Carya illinoinensis	Healthy Healthy	Single Single	Yes Yes	Remain Remain	0.0
4000	16.9	green ash	Fraxinus pennsylvanica	Healthy	Single	Yes	Remain	0.0	4847 4848	6.5 6.0	pecan	Carya illinoinensis Carya illinoinensis	Declining Declining	Single Single	No No	Remain Remain	0.0
4723	21.2	American elm	Tree tags 4001 - 4722 we Ulmus americana	Healthy	Single	Yes	Remain	0.0	4849 4853	15.7 8.8	American elm eastern redbud	Ulmus americana Cercis canadensis	Healthy Healthy	Single Single Multi	Yes Yes	Remain Removed	0.0
4724 4725	16.2 18.1	American elm green ash	Ulmus americana Fraxinus pennsylvanica	Healthy Healthy	Single Single	Yes Yes	Remain Remain	0.0	4854	21.2	hackberry	Celtis laevigata	Healthy	Forked	No	Removed	0.0
4726 4727	24.6 7.3	American elm green ash	Ulmus americana Fraxinus pennsylvanica	Healthy Healthy	Single Single	Yes Yes	Remain Remain	0.0	4856 4857	17.1 15.5	sweetgum sweetgum	Liquidambar styraciflua Liquidambar styraciflua	Healthy Healthy	Forked Forked	Yes Yes	Removed Removed	17.1 15.5
4728 4729	4.8	green ash Mexican plum	Fraxinus pennsylvanica Prunus mexicana	Healthy Declining	Single Forked	Yes No	Remain Remain	0.0								TOTAL	
4730	4.0	green ash	Fraxinus pennsylvanica	Healthy	Single	Yes	Remain	0.0	3995 4782	11.3 13.8	eastern redcedar eastern redcedar	Juniperus virginiana Juniperus virginiana	Healthy Declining	Single Single	Yes No	Remain Remain	0.0
4731 4732	4.0 18.7	green ash hackberry	Fraxinus pennsylvanica Celtis laevigata	Healthy Declining	Single Forked	Yes No	Remain Remain	0.0	4783 4812	10.2 11.4	eastern redcedar eastern redcedar	Juniperus virginiana Juniperus virginiana	Healthy Healthy	Single Single	Yes Yes	Remain Removed	0.0 4.0
4733 4734	8.4 5.6	persimmon American elm	Diospyros virginiana Ulmus americana	Healthy Healthy	Single Single	Yes Yes	Remain Remain	0.0	4813 4814	11.1	eastern redcedar eastern redcedar	Juniperus virginiana Juniperus virginiana	Declining Declining	Forked Single	No No	Remain Remain	0.0
4735 4736	5.2 4.1	green ash persimmon	Fraxinus pennsylvanica Diospyros virginiana	Healthy Healthy	Single Single	Yes Yes	Remain Remain	0.0	4815	14.3	eastern redcedar	Juniperus virginiana	Healthy	Single	Yes	Removed	4.0
4737 4738	6.7	persimmon black cherry	Diospyros virginiana Prunus serotina	Healthy Healthy	Single Single	Yes Yes	Remain Remain	0.0	4816 4817	12.2 21.9	eastern redcedar eastern redcedar	Juniperus virginiana Juniperus virginiana	Healthy Healthy	Single Single	Yes Yes	Removed	0.0 4.0
4739	4.0	American elm	Ulmus americana	Healthy	Single	Yes	Remain	0.0	4855	11.6	eastern redcedar	Juniperus virginiana	Healthy	Multi	Yes	Removed TOTAL	4.0 16.0
4740 4741	5.7 16.5	persimmon hackberry	Diospyros virginiana Celtis laevigata	Healthy Healthy	Single Single	Yes No	Remain Remain	0.0				TOTAL MITIGATION INCHES T PROPOSED INC		TED			-948.5 +122
4742 4743	5.5 11.6	persimmon pecan	Diospyros virginiana Carya illinoinensis	Declining Healthy	Single Single	No Yes	Remain Remain	0.0				TOTAL INCHI	ES				-867.7 \$173,540.00
4744 4745	6.5 4.3	persimmon persimmon	Diospyros virginiana Diospyros virginiana	Healthy Healthy	Single Single	Yes Yes	Remain Remain	0.0					,-2				
4746 4747	4.8 7.2	persimmon persimmon	Diospyros virginiana Diospyros virginiana	Healthy Healthy	Single Single	Yes Yes	Remain Remain	0.0									
4748	6.9	persimmon	Diospyros virginiana	Healthy	Single	Yes	Remain	0.0									

TAG#	DBH	COMMON NAME	SCIENTIFIC NAME	CONDITION	MULTIPLE- STEMMED	PROTECTED	STATUS	MITIGA.
3924	6.9	live oak	Quercus virginiana	Healthy	Multi	Yes	Remain	0.0
3925	8.6	live oak	Quercus virginiana	Healthy	Multi	Yes	Remain	0.0
3926	4.5	live oak	Quercus virginiana	Healthy	Single	Yes	Remain	0.0
3927	8.9	cedar elm	Ulmus crassifolia	Healthy	Multi	Yes	Remain	0.0
3928	4.6	cedar elm	Ulmus crassifolia	Healthy	Single	Yes	Remain	0.0
3929	6.6	cedar elm	Ulmus crassifolia	Healthy	Single	Yes	Remain	0.0
3930	10.6	cedar elm	Ulmus crassifolia	Healthy	Forked	Yes	Remain	0.0
3931	6.3	cedar elm	Ulmus crassifolia	Healthy	Single	Yes	Remain	0.0
3932	12.6	cedar elm	Ulmus crassifolia	Healthy	Single	Yes	Remain	0.0
3933	7.0	cedar elm	Ulmus crassifolia	Healthy	Single	Yes	Remain	0.0
3934	12.7	cedar elm	Ulmus crassifolia	Healthy	Forked	Yes	Remain	0.0
3935	9.1	live oak	Quercus virginiana	Healthy	Single	Yes	Remain	0.0
3936	8.3	willow oak	Quercus phellos	Healthy	Forked	No	Remain	0.0
3937	12.8	live oak	Quercus virginiana	Healthy	Single	Yes	Remain	0.0
3938	10.1	live oak	Quercus virginiana	Healthy	Single	Yes	Remain	0.0
3939	14.7	live oak	Quercus virginiana	Healthy	Single	Yes	Remain	0.0
3940	5.1	cedar elm	Ulmus crassifolia	Healthy	Multi	Yes	Remain	0.0
3941	13.9	cedar elm	Ulmus crassifolia	Declining	Single	No	Remain	0.0
3942	10.4	cedar elm	Ulmus crassifolia	Healthy	Single	Yes	Remain	0.0
3943	10.4	cedar elm	Ulmus crassifolia	Healthy	Single	Yes	Remain	0.0
3944	7.0	cedar elm	Ulmus crassifolia	Healthy	Single	Yes	Remain	0.0
3945	12.1	cedar elm	Ulmus crassifolia	Healthy	Single	Yes	Remain	0.0
3949	10.9	live oak	Quercus virginiana	Healthy	Multi	Yes	Remain	0.0
3950	18.4	live oak	Quercus virginiana	Healthy	Multi	Yes	Remain	0.0
3951	9.7	cedar elm	Ulmus crassifolia	Healthy	Single	Yes	Remain	0.0
3952	11.6	cedar elm	Ulmus crassifolia	Healthy	Forked	Yes	Remain	0.0
3953	10.1	cedar elm	Ulmus crassifolia	Healthy	Single	Yes	Remain	0.0
3954	12.4	cedar elm	Ulmus crassifolia	Healthy	Forked	Yes	Remain	0.0
3955	9.4	cedar elm	Ulmus crassifolia	Healthy	Single	Yes	Remain	0.0
3956	13.1	cedar elm	Ulmus crassifolia	Healthy	Multi	Yes	Remain	0.0
3957	9.2	cedar elm	Ulmus crassifolia	Healthy	Single	Yes	Remain	0.0
3958	10.4	live oak	Quercus virginiana	Healthy	Single	Yes	Remain	0.0
3959	9.8	live oak	Quercus virginiana	Healthy	Single	Yes	Remain	0.0
3960	12.6	live oak	Quercus virginiana	Healthy	Forked	Yes	Remain	0.0
3961	10.0	cedar elm	Ulmus crassifolia	Healthy	Single	Yes	Remain	0.0
3962	12.9	cedar elm	Ulmus crassifolia	Healthy	Single	Yes	Remain	0.0
3963	11.1	cedar elm	Ulmus crassifolia	Healthy	Single	Yes	Remain	0.0
3964	9.1	live oak	Quercus virginiana	Healthy	Single	Yes	Remain	0.0
3965	11.1	live oak	Quercus virginiana	Healthy	Multi	Yes	Remain	0.0
3966	8.0	cedar elm	Ulmus crassifolia	Healthy	Forked	Yes	Remain	0.0
3967	12.3	cedar elm	Ulmus crassifolia	Healthy	Multi	Yes	Remain	0.0
3968	7.5	cedar elm	Ulmus crassifolia	Healthy	Multi	Yes	Remain	0.0
3969	12.4	cedar elm	Ulmus crassifolia	Healthy	Single	Yes	Remain	0.0
2230		2 2 2 2 1 2 1 1 1	Simus Statement		29.0		TOTAL	0.0
TOTAL MITIGATION INCHES THAT'S PROTECTED								

TREE REMOVAL NOTES:

- A. REMOVE ALL TREES INDICATED BY THE DRAWINGS AND SPECIFICATIONS, AS REQUIRING REMOVAL, IN A MANNER THAT WILL NOT DAMAGE ADJACENT TREES OR STRUCTURES
- . REMOVE TREES THAT ARE ADJACENT TO TREES OR STRUCTURES TO REMAIN, IN SECTIONS, TO LIMIT THE OPPORTUNITY OF DAMAGE TO ADJACENT CROWNS, TRUNKS, GROUND PLANE ELEMENTS AND STRUCTURES.
- DO NOT DROP TREES WITH A SINGLE CUT UNLESS THE TREE WILL FALL IN AN AREA NOT INCLUDED IN THE TREE PROTECTION AREA.
- NO TREE TO BE REMOVED WITHIN 50 FEET OF OR INSIDE THE TREE PROTECTION AREA SHALL BE PUSHED OVER OR UP-ROOTED USING A PIECE OF GRADING EQUIPMENT. NO HEAVY EQUIPMENT IS ALLOWED INSIDE THE TREE PROTECTION AREA.
- PROTECT ADJACENT PAVING, SOIL, TREES, SHRUBS, GROUND COVER PLANTINGS AND UNDERSTORY PLANTS TO REMAIN FROM DAMAGE DURING ALL TREE REMOVAL OPERATIONS, AND FROM CONSTRUCTION OPERATIONS. PROTECTION SHALL INCLUDE THE ROOT SYSTEM, TRUNK, LIMBS, AND CROWN FROM BREAKAGE OR SCARRING, AND THE SOIL FROM COMPACTION.
- REMOVE STUMPS AND IMMEDIATE ROOT PLATE FROM EXISTING TREES TO BE REMOVED. GRIND TRUNK BASES AND LARGE BUTTRESS ROOTS TO A DEPTH OF THE LARGEST BUTTRESS ROOT OR AT LEAST 18 INCHES BELOW THE TOP MOST ROOTS WHICHEVER IS LESS AND OVER THE AREA OF THREE TIMES THE DIAMETER OF THE TRUNK (DBH).
- F.A. FOR TREES WHERE THE STUMP WILL FALL UNDER NEW PAVED AREAS, GRIND ROOTS TO A TOTAL DEPTH OF 18 INCHES BELOW THE EXISTING GRADE. IF THE SIDES OF THE STUMP HOLE STILL HAVE GREATER THAN APPROXIMATELY 20% WOOD VISIBLE, CONTINUE GRINDING OPERATION DEEPER AND OR WIDER UNTIL THE RESULTING HOLE HAS LESS THAN 20% WOOD. REMOVE ALL WOOD CHIPS PRODUCED BY THE GRINDING OPERATION AND BACK FILL IN 8 INCH LAYERS WITH CONTROLLED FILL OF A QUALITY ACCEPTABLE TO THE SITE ENGINEER FOR FILL MATERIAL UNDER STRUCTURES, COMPACTED TO 95% OF THE MAXIMUM DRY DENSITY STANDARD PROCTOR. THE OWNER'S REPRESENTATIVE SHALL APPROVE EACH HOLE AT THE END OF THE GRINDING OPERATION.
- F.B. IN AREAS WHERE THE TREE LOCATION IS TO BE A PLANTING BED OR LAWN, REMOVE ALL WOODCHIPS AND BACKFILL STUMP HOLES WITH PLANTING SOIL AS DEFINED IN SPECIFICATION SECTION PLANTING SOIL, IN MAXIMUM OF 12 INCH LAYERS AND COMPACT TO 80 - 85% OF THE MAXIMUM DRY DENSITY STANDARD PROCTOR.

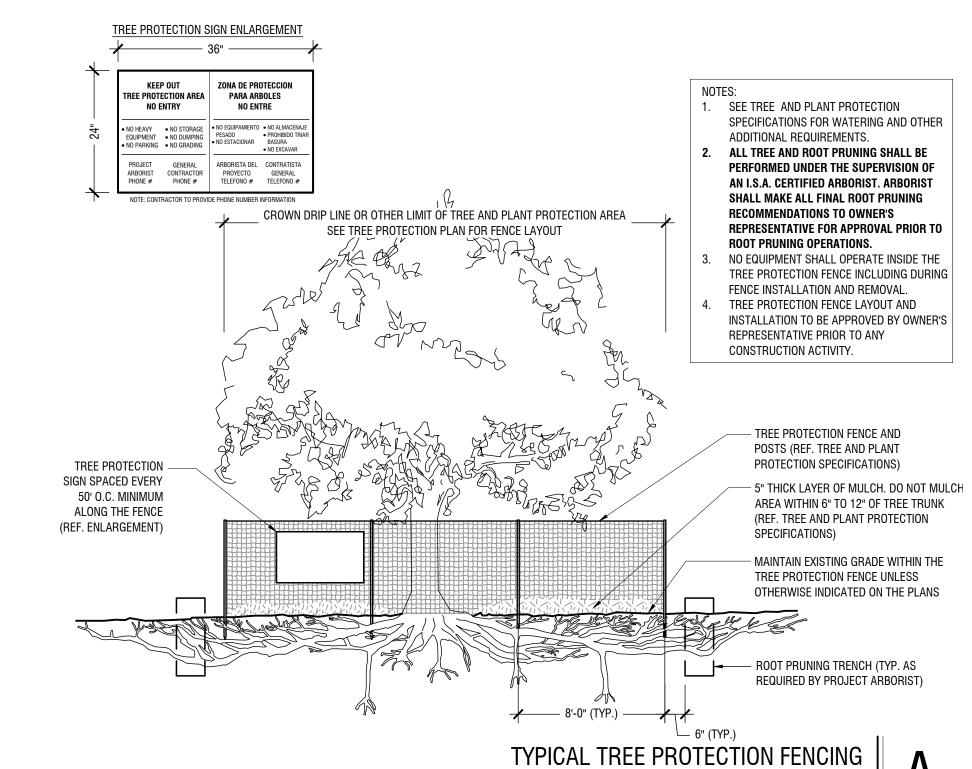

IREE PRES

PRELIMINARY FOR REVIEW ONLY Not for construction or permit purposes

Kimley »Horn

R.L.A. BEN L. RANKIN L.A. No. 2904 Date 06/18/2025

SHEET NUMBER TP 2.00


ERVATION NOTES


SE


Scale: NTS


	PLANTING NOTES:	PLANTING SCHEDULE:	
	1. CONTRACTOR SHALL BE RESPONSIBLE FOR VERIFYING THE LOCATIONS OF ALL UNDERGROUND UTILITIES, PIPES, STRUCTURES, AND LINE RUNS IN THE FIELD PRIOR TO THE INSTALLATION OF ANY PLANT MATERIAL.	SYMBOL CODE QTY BOTANICAL / COMMON NAME ROOT CAL. SIZE REMARKS	
	 IT IS THE RESPONSIBILITY OF THE CONTRACTOR TO ADVISE THE LANDSCAPE ARCHITECT OF ANY CONDITION FOUND ON SITE WHICH PERMITS INSTALLATION AS SHOWN ON THESE DRAWINGS. ALL PLANT MATERIAL SHALL BE MAINTAINED IN A HEALTHY, GROWING CONDITION AND MUST BE REPLACED WITHIN 30 DAYS WITH PLANT MATERIAL 	CANOPY TREES OM 4 QUERCUS MACROCARPA / BUR OAK B & B 4" CAL. 12`-14` HT. STRONG, CENTRAL LEADER, FULL	
	OF THE SAME VARIETY AND SIZE IF DAMAGED, DESTROYED, OR REMOVED. 4. CONTRACTOR SHALL BE RESPONSIBLE FOR FINE GRADING AND REMOVAL OF DEBRIS PRIOR TO PLANTING IN ALL AREAS.		
	5. FINAL FINISH GRADING SHALL BE REVIEWED AND APPROVED BY THE LANDSCAPE ARCHITECT. THE CONTRACTOR SHALL BE RESPONSIBLE FOR ANY ADDITIONAL TOPSOIL REQUIRED TO CREATE A SMOOTH CONDITION PRIOR TO PLANTING.	QC 1 QUERCUS MUEHLENBERGII / CHINKAPIN OAK B & B 4" CAL. 16` - 18` HT. SINGLE STRAIGHT CENTRAL LEADER, FULL AND MATCHING	
	6. CONTRACTOR SHALL VERIFY ALL PLANT QUANTITIES. ALL PLANT QUANTITIES ARE LISTED FOR INFORMATION PURPOSES ONLY. IT IS THE CONTRACTOR'S RESPONSIBILITY TO PROVIDE FULL COVERAGE IN ALL PLANTING AREAS AS SHOWN ON THE PLANS AND SPECIFIED IN THE PLANT SCHEDULE.	QS 2 QUERCUS SHUMARDII / SHUMARD RED OAK B & B 4" CAL. 12` - 14` HT. STRONG, CENTRAL LEADER, FULL	
	7. CONTRACTOR TO PROVIDE STEEL EDGING BETWEEN ALL PLANTING BEDS AND TURF AREAS UNLESS OTHERWISE INDICATED ON THE DRAWINGS. 8. ALL PLANT MATERIAL SHALL CONFORM TO THE SPECIFICATIONS GIVEN IN THE PLANT SCHEDULE, PLANTING DETAILS, AND PLANTING	ORNAMENTAL TREES ORNAMENTAL TREES FINAL SINGLE STRAIGHT CENTRAL LEADER, FULL AND MATCHING	
	SPECIFICATIONS. 9. ALL PLANT MATERIAL SHALL MEET INDUSTRY STANDARDS AS INDICATED IN THE CURRENT EDITION OF THE AMERICAN STANDARD FOR NURSERY STOCK (ANSI Z60.1).	AND MATORING AND MATORING SINGLE STRAIGHT CENTRAL LEADER, FULL	
Si	10. ALL PLANT MATERIAL SUBSTITUTIONS SHALL BE APPROVED BY LANDSCAPE ARCHITECT PRIOR TO PURCHASE. 11. CONTRACTOR IS RESPONSIBLE FOR ALL COORDINATION WITH OTHER CONTRACTORS ON SITE AS REQUIRED TO ACCOMPLISH ALL PLANTING	AND MATCHING	
Associates, Ir	OPERATIONS. 12. ALL PLANTING AREAS SHALL RECEIVE SOIL AMENDMENTS.		
nley-Horn and	 13. PLANT MATERIAL SHALL BE PRUNED PER PLANTING DETAILS UNLESS OTHERWISE NOTED ON DRAWINGS. 14. PLANTING AREAS SHALL BE KEPT FREE OF TRASH, WEEDS, DEBRIS, AND DEAD PLANT MATERIAL. 15. ALL LIME STABILIZED SOIL AND INORGANIC SELECT FILL FOR BUILDING OR PAVING CONSTRUCTION SHALL BE REMOVED FROM ALL PLANTING BEDS 		OWER 20
t liability to Kir	TO A MINIMUM DEPTH OF 24" UNLESS OTHERWISE NOTED. REPLACE MATERIAL REMOVED WITH IMPORTED TOPSOIL. 16. TREES OVERHANGING PEDESTRIAN WALKS AND WITHIN VISIBILITY TRIANGLES AS NOTED ON THE PLANS SHALL BE LIMBED TO A HEIGHT OF SEVEN		FICE TO: (240)
hall be withou	FEET (7'). TREE OVERHANGING PUBLIC STREETS AND FIRELANES SHALL BE LIMBED TO A HEIGHT OF FOURTEEN FEET (14'). 17. TREES PLANTED NEXT TO ACCESSIBLE ROUTES AND ACCESSIBLE AREAS SHALL BE LIMBED TO 7'6" (80" MIN.) AFF.		ERIA OF S, TX 75 AX: 972 COM T.
ociates, Inc. s	18. ALL PROPOSED TREES SHALL BE STAKED WITH AN AT-GRADE ROOT BALL SECURING SYSTEM AS SHOWN IN THE PLANTING DETAILS AND SPECIFICATIONS. NO ABOVE-GROUND STAKING SYSTEMS, GUY WIRES/WIRES, HOSES, STRAPS, POSTS (METAL OR WOOD) SHALL BE ALLOWED UNLESS AUTHORIZED IN WRITING BY THE LANDSCAPE ARCHITECT.		O GALLEF DALLAS, -1300 FA,
Horn and Ass	UNELSS AUTHORIZED IN WAITING DT THE LANDSCAPE ANCHITECT.		RD. TW, JITE 700 972-770 KIMLEY
ion by Kimley-			55 NOEL SL SHONE:
on and adaptal			1345
en authorizatio			
it without writte			
this documer			PRELIMINARY FOR REVIEW ONLY Not for construction or permit purposes
ver reliance on			Kimley» Horn R.L.A. BEN L. RANKIN L.A. No. 2904 Date 06/18/2025
of and improp			
pared. Reuse			CT 2 2 1 1 1 1 1 1 1 1 1 1 1 1 1 1 1 1 1
iich it was pre			14 PROJE 6458440 DATE 06/18/2025 : AS SH NED BY
nd client for wl			SCALE DESIG
ific purpose a			
ly for the spec			PME ATIOI
is intended on			LOI DE COMPANS DE COMP
ent of service,			NT N
as an instrume			PO DE EPARE ALL E
ented herein, 6			LA DY FRW/A
designs prese			JOL REA ROC
concepts and			A D F
ether with the			J A
document, tog			
This			
			HED(
LANDSCAPE			CHI 'ES
LANSHEETS\			S S V
NNTE\CAD\PL			
9:24 PM LA JOLLA PC			
J8 PM EL 6/18/2025 .\064584402 - , [LP 0.00]			l PL
6/18/2025 9:C LIANG, DANI, K:\DAL_CIVIL LP 1.00.DWG			
[SHEET NUMBER

SHEET NUMBER LP 0.00

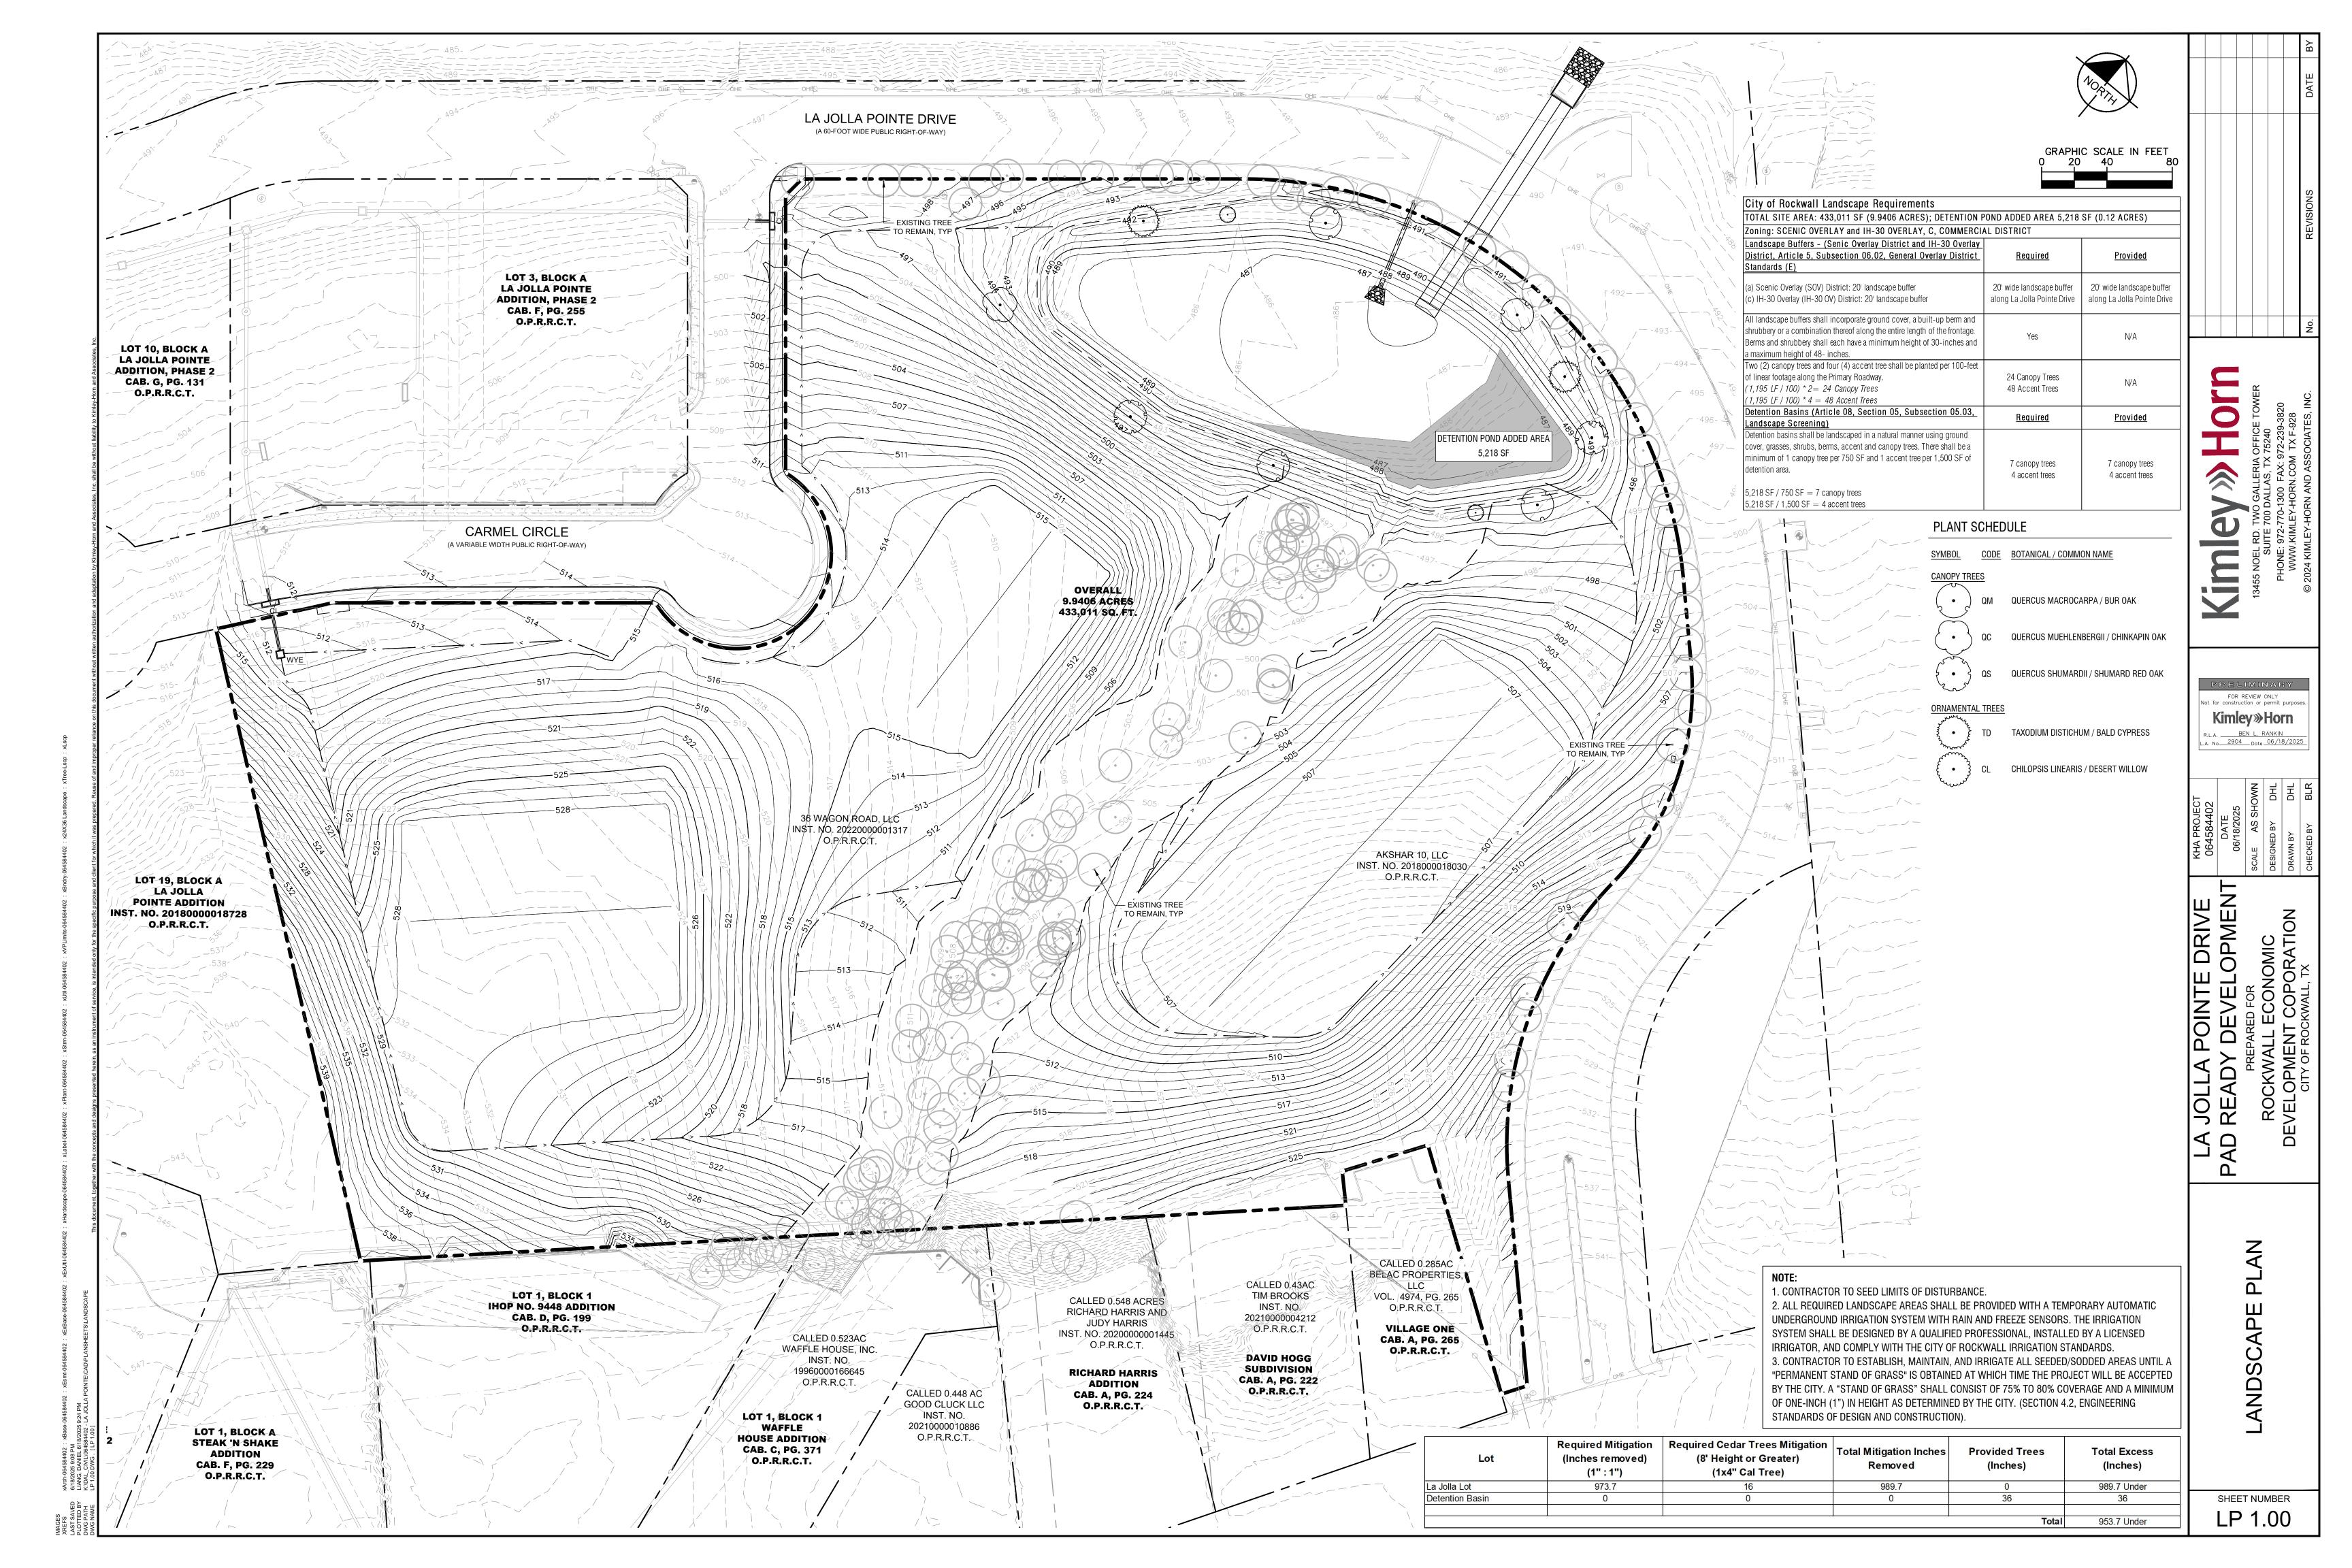

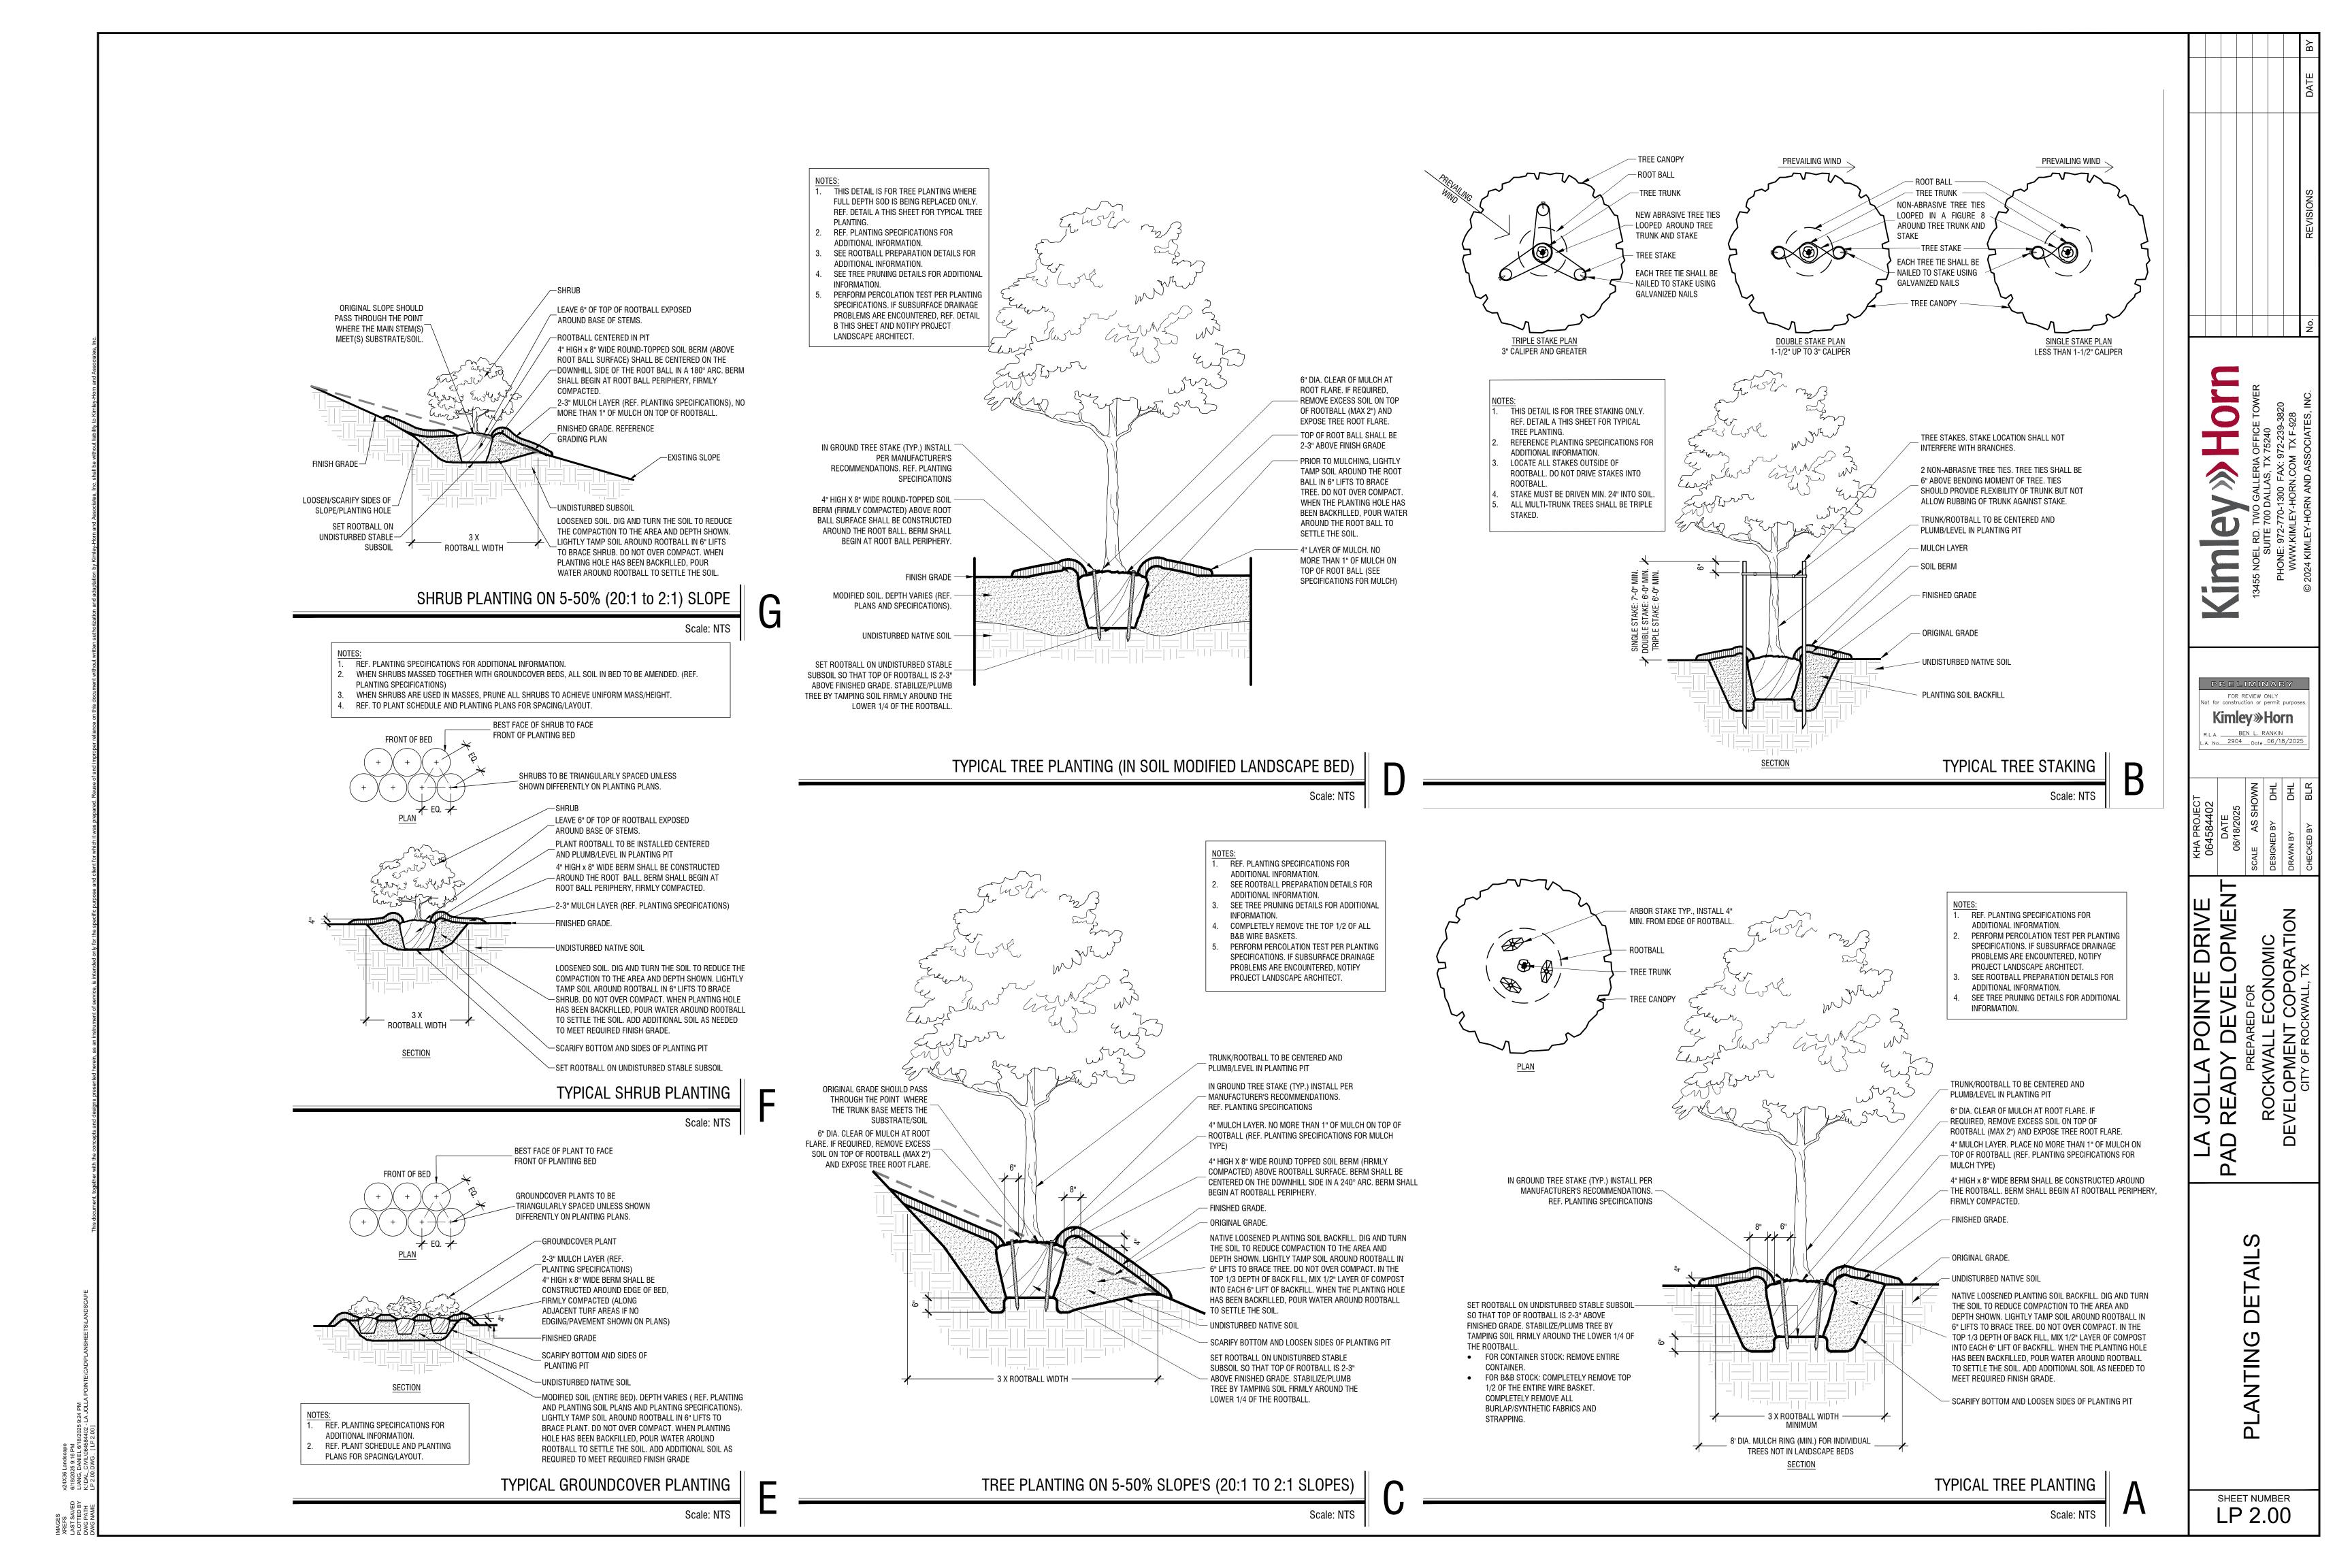

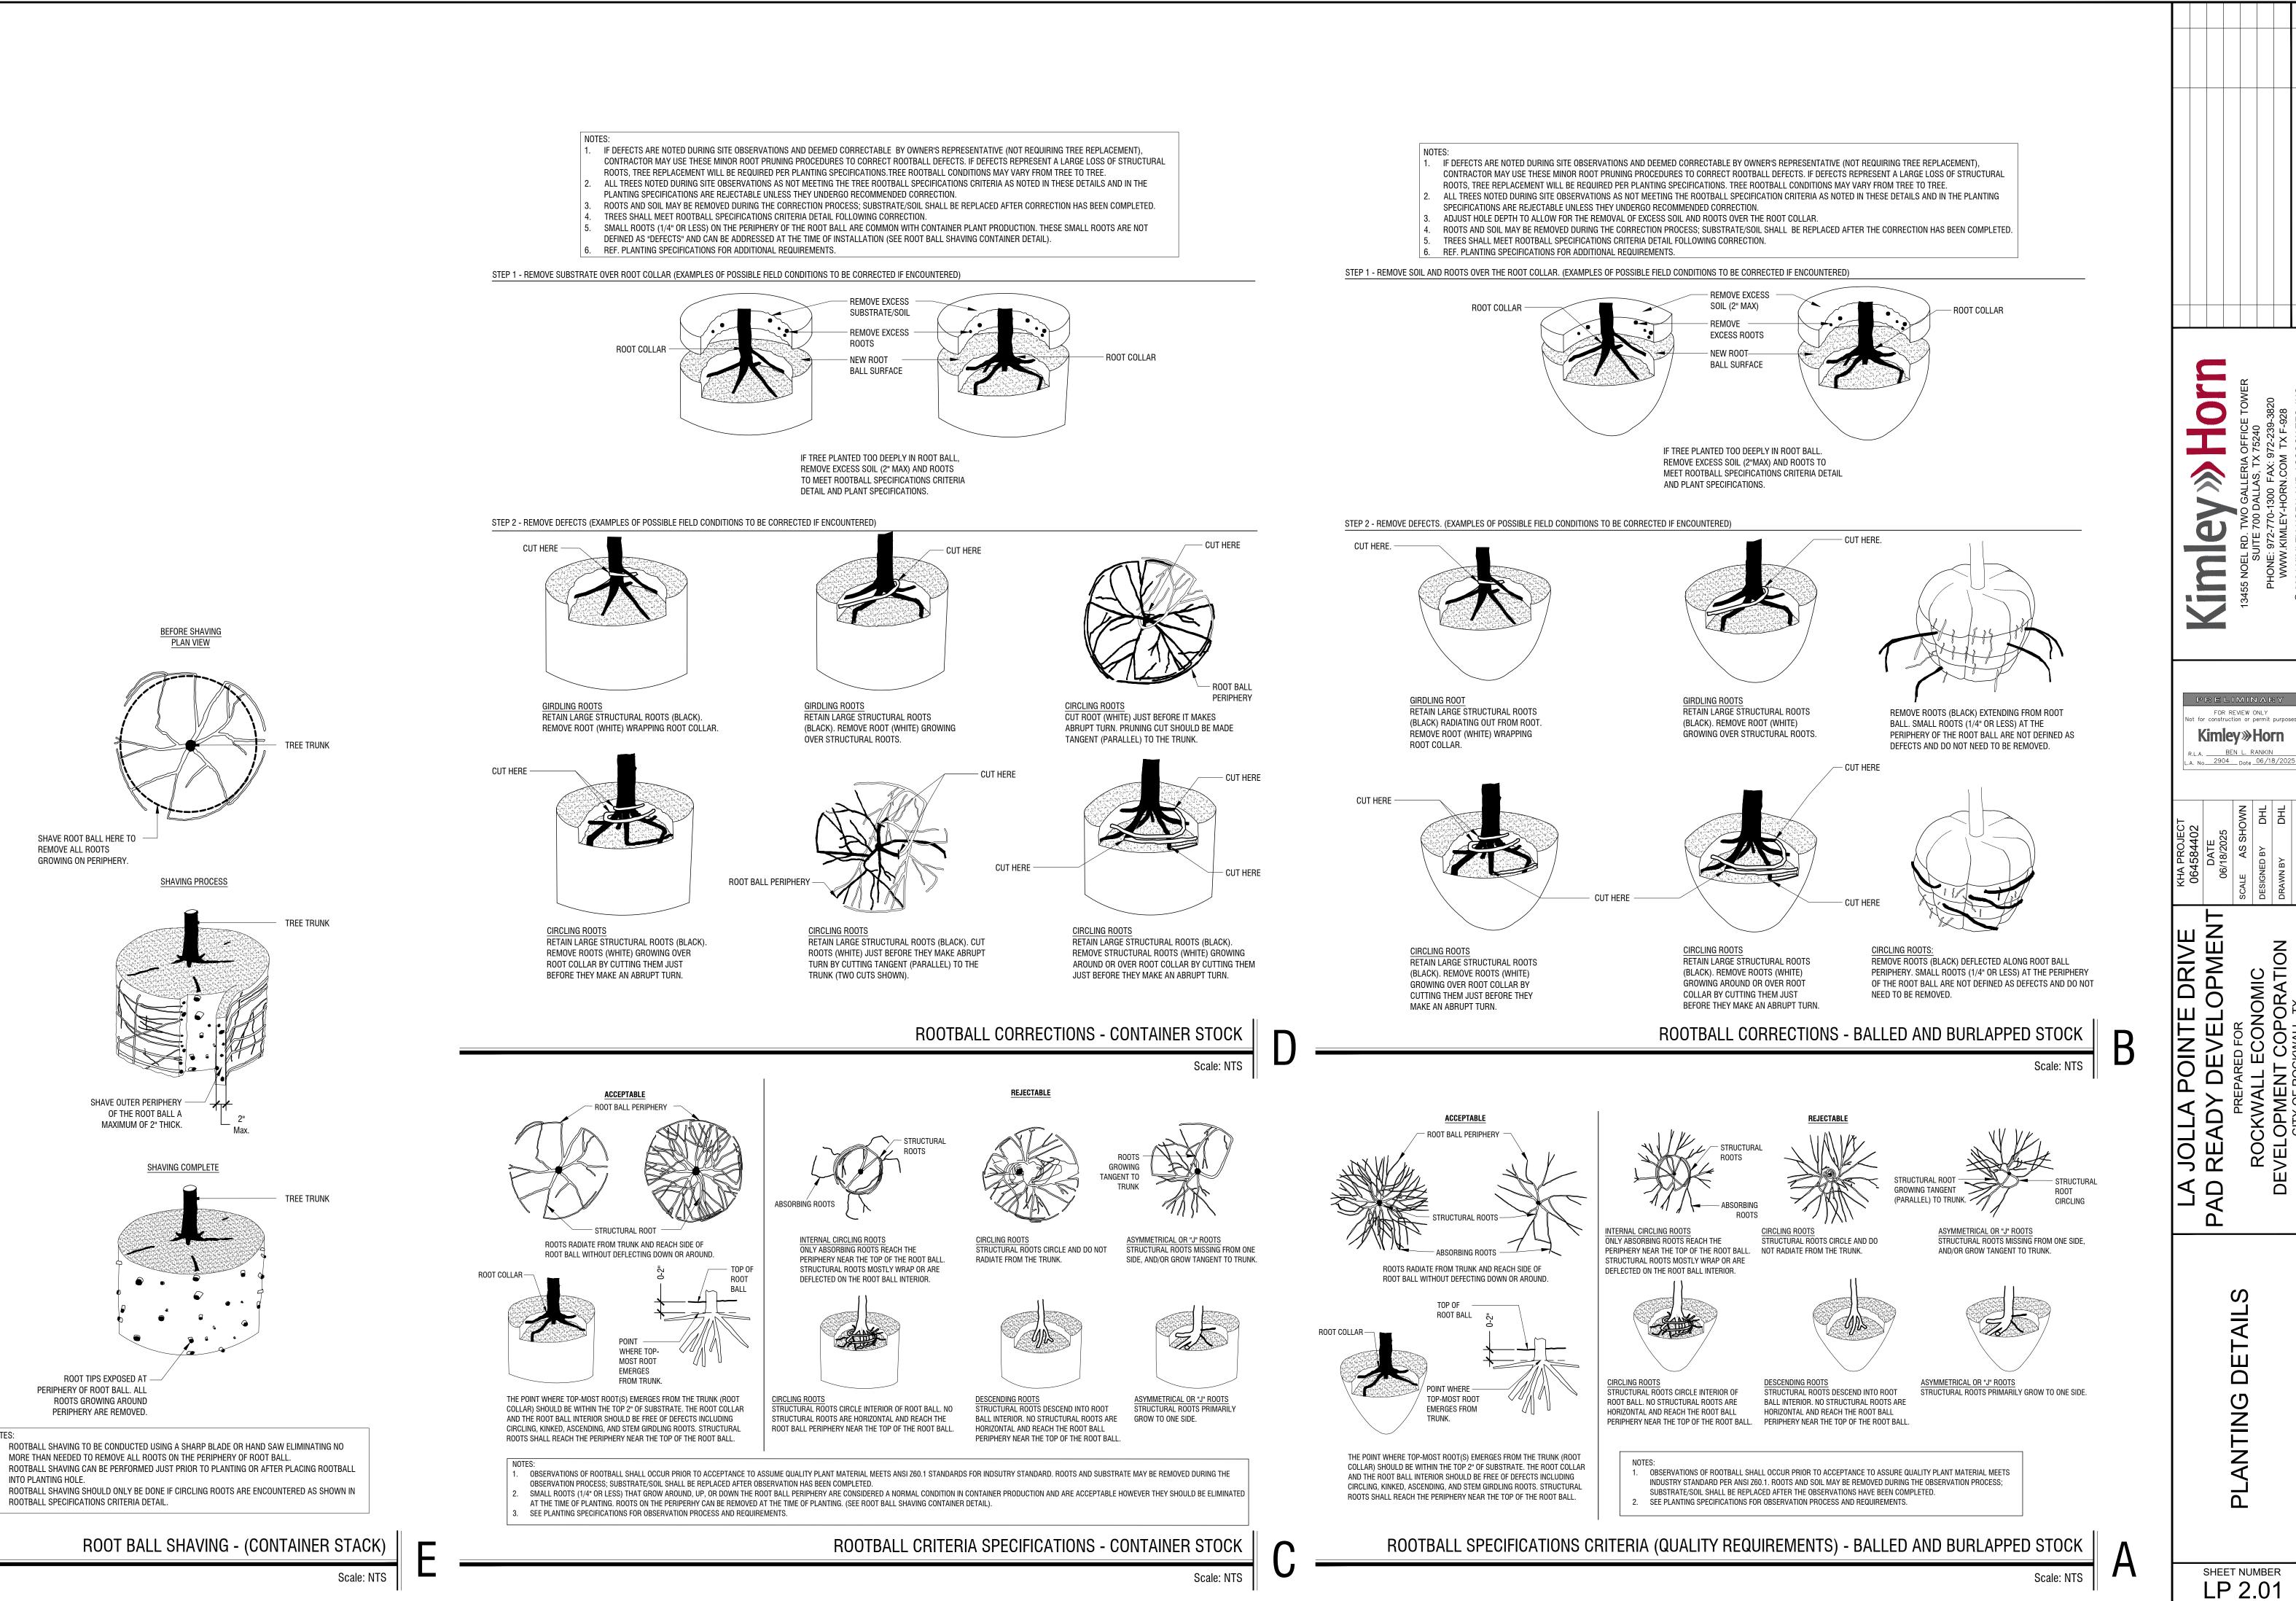

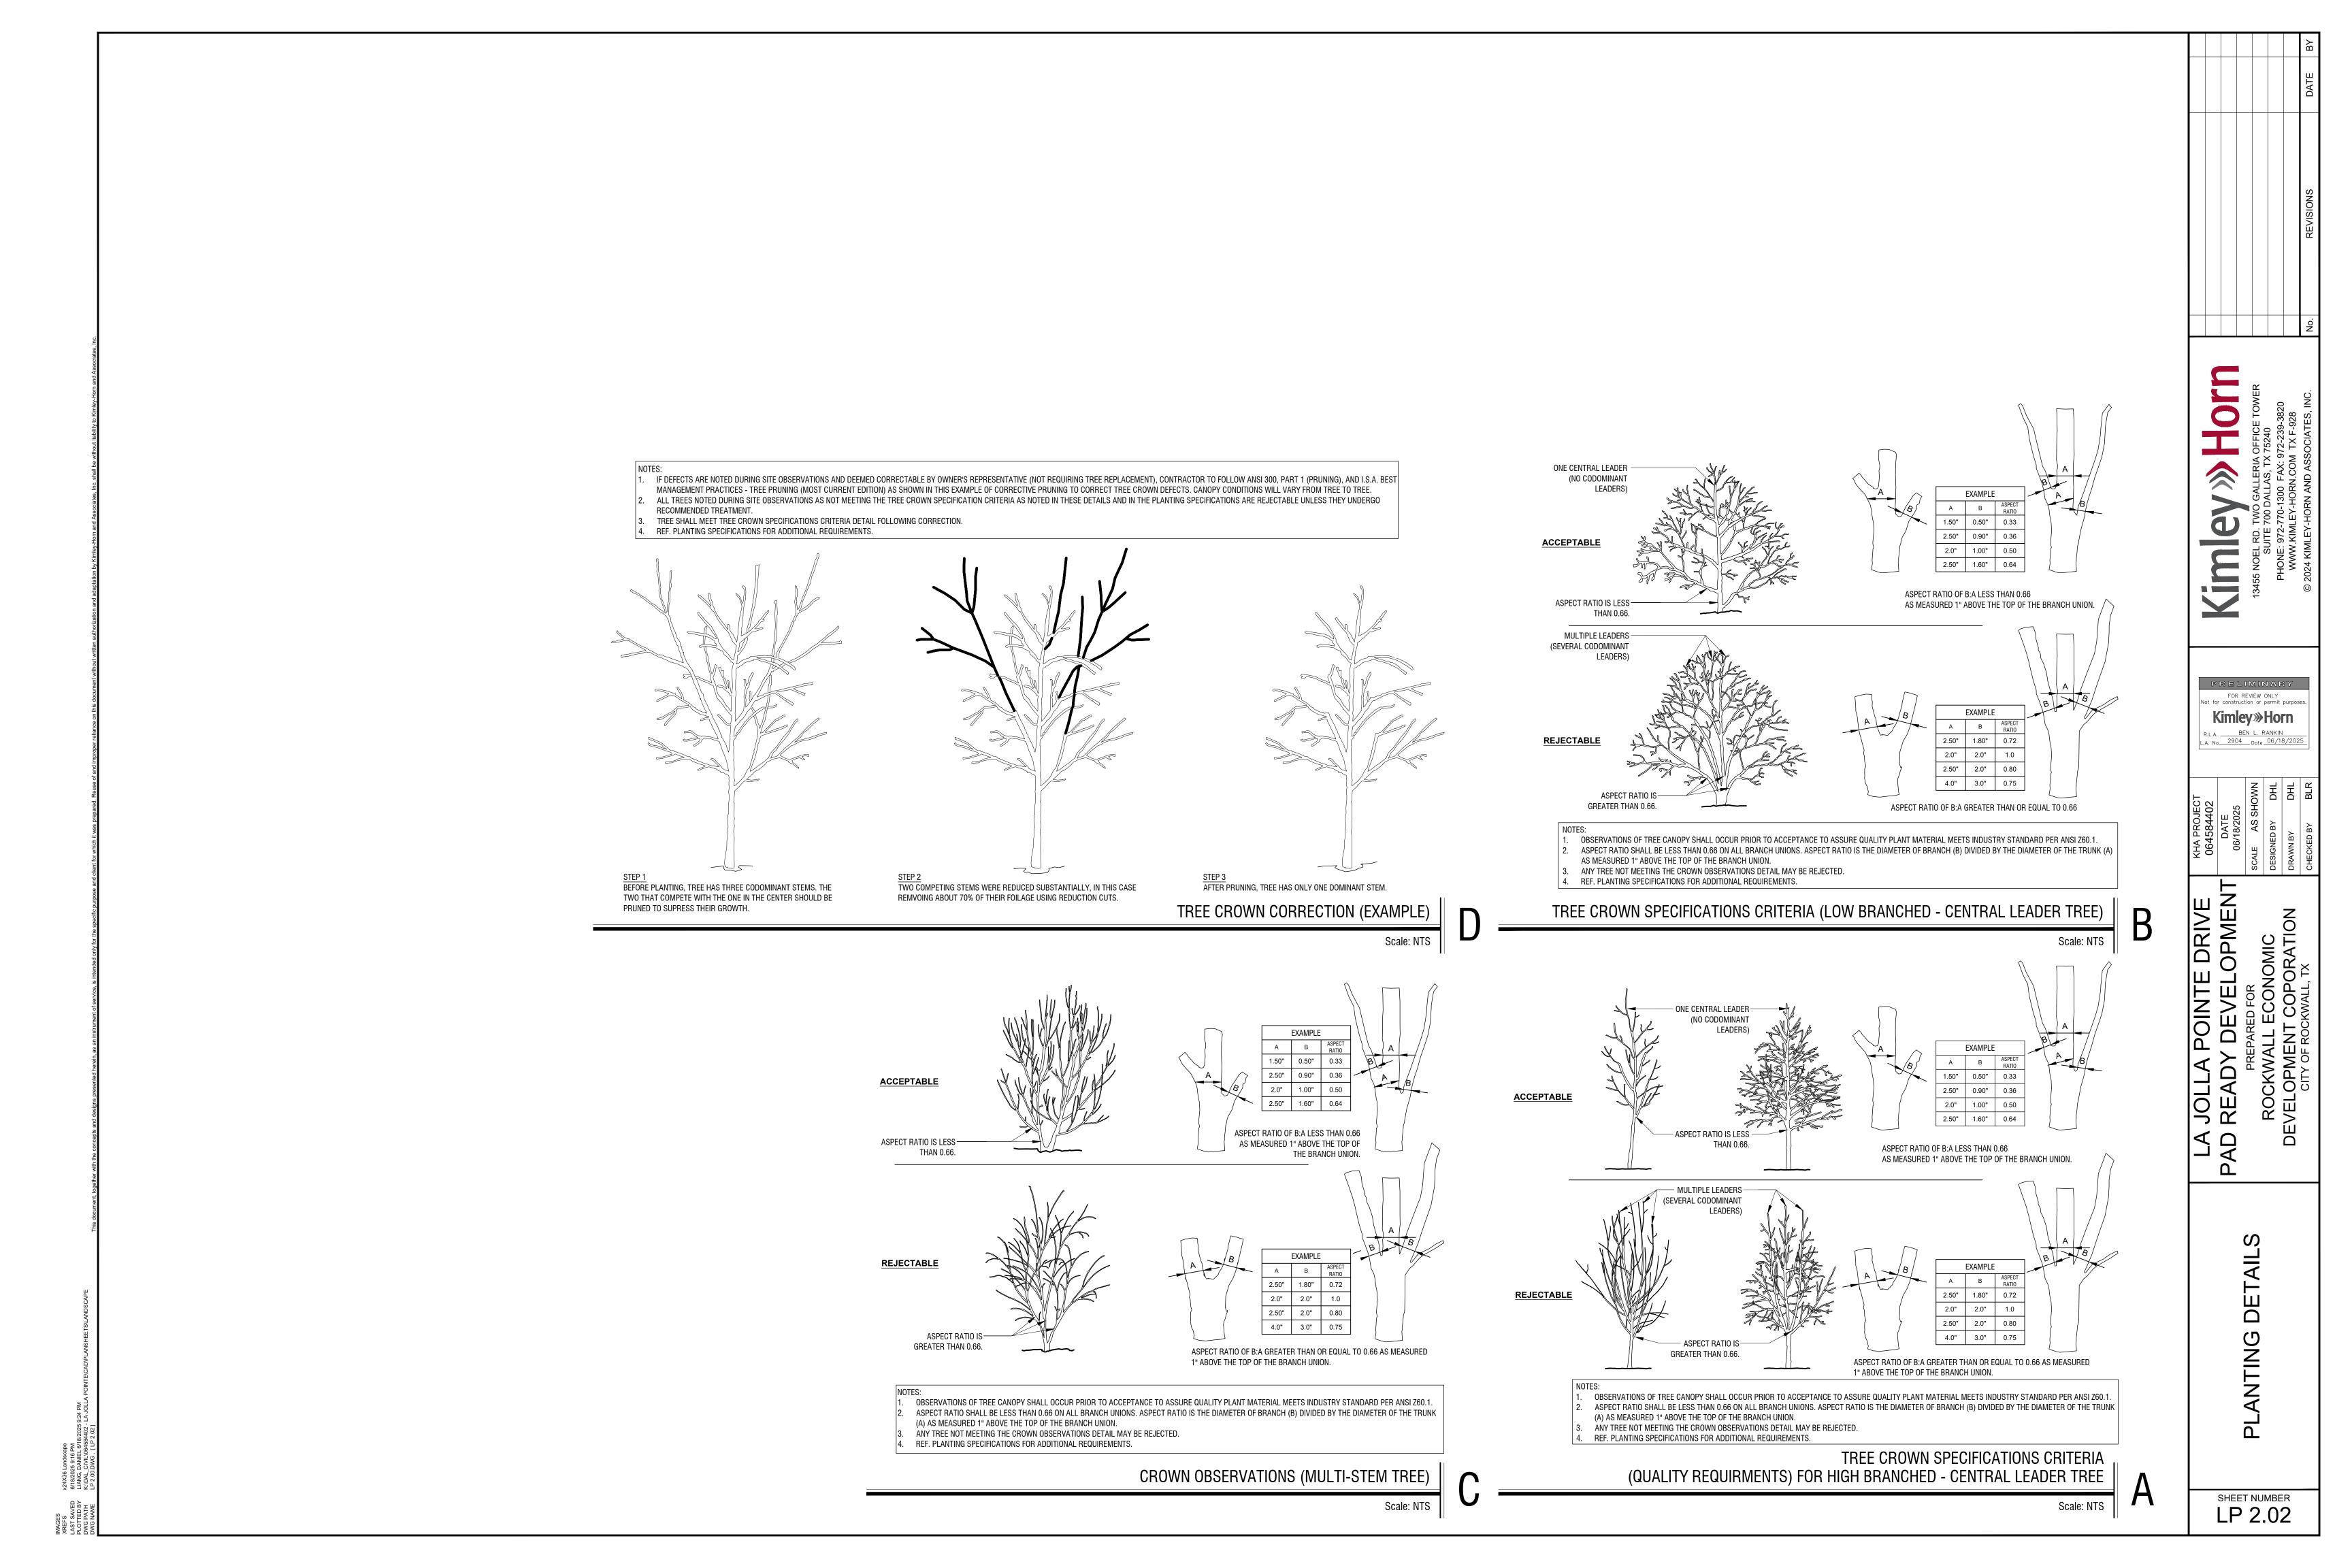



CITY OF ROCKWALL

PLANNING AND ZONING COMMISSION MEMORANDUM

PLANNING AND ZONING DEPARTMENT

385 S. GOLIAD STREET • ROCKWALL, TX 75087 PHONE: (972) 771-7745 • EMAIL: PLANNING@ROCKWALL.COM

TO: Planning and Zoning Commission

FROM: Henry Lee, Senior Planner

DATE: July 15, 2025

SUBJECT: SP2025-026; Treescape Plan for La Jolla Pointe Drive

The applicant -- Todd Martin, P.E. of Kimley-Horn on behalf of the Rockwall Economic Development Corporation (REDC) --, is requesting the approval of a Treescape Plan for the purpose of removing trees and establishing a mitigation balance against the future development on the subject property. The subject property is a 10.241-acre vacant tract of land (i.e. Lots 22 & 23, Block A, La Jolla Pointe Phase 2 Addition) zoned Commercial (C) District, situated within Scenic Overlay (SOV) District and the IH-30 Overlay (IH-30 OV) District, and generally located east of the intersection of La Jolla Pointe and Carmel Circle. On January 2, 2024, the City Council approved a Specific Use Permit (SUP) to allow the maximum permissible building height to be increased in order to facilitate the future construction of multi-story Office Building on the subject property. Following this approval, the REDC is preparing the subject property to be pad ready for development by completing the necessary grading and detention work. As part of this process trees will need to be removed, which is prompting the applicant to submit a Treescape Plan.

According to Section 03, Treescape Plan, of Article 09, Tree Preservation, of the Unified Development Code (UDC), before any trees may be removed from a non-residential property a Treescape Plan must be submitted to the Director of Planning and Zoning or his/her designee and go before the Planning and Zoning Commission for action. According to Subsection 03.01, Treescape Plan, of Article 09, Tree Preservation, of the Unified Development Code (UDC), "(a) treescape plan is a plan showing the exact location, size (i.e. trunk diameter and height), and common name of all trees, four (4) inches and greater and indicating the trees that are proposed to be removed, transplanted or replaced." Based on this, the applicant has submitted a Treescape Plan indicating the location, size, and species for every tree on the subject property. In accordance with the Tree Mitigation Requirements -- outlined in Section 05, of Article 09, of the UDC -- the applicant has indicated that the total mitigation balance is 1.074.40 caliper inches. In addition, the applicant has indicated that the required detention pond landscaping will be provided at this time, for a total of seven (7), four (4) inch caliper canopy trees (i.e. 7 canopy trees x 4 caliper inches = 28 caliper inches). This reduces the mitigation balance to 1,046.4 caliper inches. Since the site is being made pad ready and the REDC does not have a prospect for this property, it is not possible to ascertain what landscaping will be provided in the future. Given this, the outstanding mitigation balance of 1,046.4 caliper inches will remain with the subject property and be applied against the Landscape Plan at the time of Site Plan. Based on future conformance to the requirements -- and the fact that the applicant is not requesting variances, exceptions, or relief from the tree planting requirements -- this item is being placed on the consent agenda. Should the Planning and Zoning Commission have any questions concerning the applicant's request, staff will be available at the July 15, 2025 Planning and Zoning Commission meeting.

PROJECT COMMENTS



DATE: 7/9/2025

PROJECT NUMBER: SP2025-026

PROJECT NAME: Amended Site Plan for 550 La Jolla Pointe Drive

SITE ADDRESS/LOCATIONS: 550 LA JOLLA POINTE DR

CASE CAPTION: Consider a request by Todd Martin, P.E. of Kimley-Horn on behalf of Shannon Foltz of the Rockwall Economic Development

Corporation (REDC) for the approval of a Treescape Plan on a 10.241-acre parcel of land identified as Lots 22 & 23, Block A, La Jolla Pointe, Phase 2 Addition, City of Rockwall, Rockwall County, Texas, situated within the Scenic Overlay (SOV) District and the IH-30 Overlay (IH-30 OV) District, zoned Commercial (C) District, generally located east of the intersection of La Jolla Pointe Drive and

Carmel Circle, and take any action necessary.

DEPARTMENT	REVIEWER	DATE OF REVIEW	STATUS OF PROJECT	
PLANNING	Henry Lee	07/09/2025	Approved w/ Comments	

07/09/2025: Please address the following comments (M= Mandatory Comments; I = Informational Comments)

- I.1 This is a request for the approval of a Treescape Plan on a 10.241-acre parcel of land identified as Lots 22 & 23, Block A, La Jolla Pointe Phase 2 Addition, City of Rockwall, Rockwall County, Texas, situated within the Scenic Overlay (SOV) District and the IH-30 Overlay (IH-30 OV) District, zoned Commercial (C) District, generally located east of the intersection of La Jolla Pointe and Carmel Circle.
- 1.2 For questions or comments concerning this case please contact Henry Lee in the Planning Department at (972) 772-6434 or email hlee@rockwall.com.
- M.3 For reference, include the case number (SP2025-026) in the lower right-hand corner of all pages of all revised plan submittals. (Subsection 01.02(D), Article 11, UDC)
- M.4 Provide the standard signature block with signature space for the Planning and Zoning Chairman and the Planning Director on all pages of the plans. Also remove the red placeholder text from the signature block. (Subsection 03.04. A, of Article 11)

APPROVED:

hereby certify that the above and foregoing site plan for a developm	nent in the City of Rockwall, Texas, was approved by the Planning & Zoning Commission of the City of Rockwall
on the day of,	
WITNESS OUR HANDS, this day of	
·	
Planning & Zoning Commission, Chairman	Director of Planning and Zoning

- I.5 According to Subsection 03.01, Treescape Plan, of Article 09, Tree Preservation, of the Unified Development Code (UDC), "(a) treescape plan is a plan showing the exact location, size (i.e. trunk diameter and height), and common name of all trees, four (4) inches and greater and indicating the trees that are proposed to be removed, transplanted or replaced."
- M.6 Based on the proposed Treescape Plan 1,074.4 caliper inches are being removed from the subject property. This number varies from the total mitigation indicated on the plan

as the trees over 25 caliper inches being removed were not mitigated for double their size. Trees 3853, 3988, 4766, and 4779 require double mitigation given they are over 25-inches in diameter. This requirement is detailed in Section 05(C), of Article 09, of the Unified Development Code (UDC). Please update the Treescape Plan to reflect this.

- I.7 The applicant has indicated that seven (7) canopy trees will be planted with the detention pond, and they are committing to planting the minimum of 24 canopy trees required for the La Jolla Pointe landscape buffer at the time of development. Given this, the applicant will plant seven (7) canopy trees with the development of the detention pond. This reduces the mitigation balance to 1,046.4. The applicant is then deferring this remaining balance until the subject property is developed; at that time the applicant will plant the La Jolla Pointe landscape buffer trees and any additional trees required by Unified Development Code (UDC).
- I.8 Please note the scheduled meetings for this case:
- (1) Planning & Zoning meeting/public hearing meeting will be held on July 15, 2025.
- I.9 All meetings will be held in person and in the City's Council Chambers. All meetings listed above are scheduled to begin at 6:00 p.m. (P&Z). The City requires that a representative(s) be present for these meetings. During the upcoming work session meeting with the Planning and Zoning Commission, representative(s) are required to present their case and answer any questions the Planning Commission may have regarding this request.

DEPARTMENT	REVIEWER	DATE OF REVIEW	STATUS OF PROJECT	
BUILDING	Henry Lee	07/09/2025	N/A	
No Comments				
DEPARTMENT	REVIEWER	DATE OF REVIEW	STATUS OF PROJECT	
FIRE	Henry Lee	07/09/2025	N/A	
No Comments				
DEPARTMENT	REVIEWER	DATE OF REVIEW	STATUS OF PROJECT	
POLICE	Henry Lee	07/09/2025	N/A	
No Comments				
DEPARTMENT	REVIEWER	DATE OF REVIEW	STATUS OF PROJECT	
PARKS	Henry Lee	07/09/2025	N/A	

No Comments




DEVELOPMENT APPLICATION

City of Rockwall
Planning and Zoning Department
385 S. Goliad Street
Rockwall, Texas 75087

PLANNING & ZONING CASE	NO.
	NOT CONSIDERED ACCEPTED BY THE DIRECTOR AND CITY ENGINEER HAVE
DIRECTOR OF PLANNING:	
CITY ENGINEER:	

	Rockwall, Texas / 508/	CITYE	NGINEER:					
PLEASE CHECK THE	APPROPRIATE BOX BELOW TO INDICATE T	HE TYPE OF DEVELOPMENT REQ	UEST [SELECT ONLY ONE BOX]:				
☐ PRELIMINARY FINAL PLAT (\$3 ☐ REPLAT (\$300.0 ☐ AMENDING OR	(\$100.00 + \$15.00 ACRE)	☐ ZONING CHAI ☐ SPECIFIC USI ☐ PD DEVELOP OTHER APPLICA ☐ TREE REMOV	ZONING APPLICATION FEES: ZONING CHANGE (\$200.00 + \$15.00 ACRE) 1 SPECIFIC USE PERMIT (\$200.00 + \$15.00 ACRE) 1 PD DEVELOPMENT PLANS (\$200.00 + \$15.00 ACRE) 1 OTHER APPLICATION FEES: TREE REMOVAL (\$75.00) VARIANCE REQUEST/SPECIAL EXCEPTIONS (\$100.00) 2					
	CATION FEES: 0.00 + \$20.00 ACRE) ¹ PLAN/ELEVATIONS/LANDSCAPING PLAN (\$	PER ACRE AMOUNT. F 2 A \$1,000.00 FEE W	NOTES: IN DETERMINING THE FEE, PLEASE USE THE EXACT ACREAGE WHEN MULTIPLYING BY THE PER ACRE AMOUNT. FOR REQUESTS ON LESS THAN ONE ACRE, ROUND UP TO ONE (1) ACRE. A \$1,000.00 FEE WILL BE ADDED TO THE APPLICATION FEE FOR ANY REQUEST THAT INVOLVES CONSTRUCTION WITHOUT OR NOT IN COMPLIANCE TO AN APPROVED BUILDING					
PROPERTY INFO	ORMATION [PLEASE PRINT]							
ADDRESS	550 La Jolla Pointe Dr, Roo	ckwall, TX 75087						
SUBDIVISION	La Jolla Pointe Addition		LOT 22 & 23	BLOCK A				
GENERAL LOCATION	Northeast Corner of La Jol	la Pointe Dr & Carmel	Circle					
ZONING, SITE PI	AN AND PLATTING INFORMATION	ON [PLEASE PRINT]						
CURRENT ZONING	C	CURRENT USE	Undeveloped					
PROPOSED ZONING	C	PROPOSED USE	Office					
ACREAGE	9.94 LOTS	[CURRENT] 2	LOTS [PROPOSED]	1				
REGARD TO ITS	D PLATS: BY CHECKING THIS BOX YOU ACKNO APPROVAL PROCESS, AND FAILURE TO ADDRE DENIAL OF YOUR CASE.	OWLEDGE THAT DUE TO THE PASSA SS ANY OF STAFF'S COMMENTS BY	AGE OF <u>HB3167</u> THE CITY NO LOI THE DATE PROVIDED ON THE DE	NGER HAS FLEXIBILITY WITH VELOPMENT CALENDAR WILL				
OWNER/APPLIC	ANT/AGENT INFORMATION [PLEAS	SE PRINT/CHECK THE PRIMARY CONT	TACT/ORIGINAL SIGNATURES ARE	REQUIRED]				
☑ OWNER	Rockwall EDC	☑ APPLICANT	Kimley-Horn					
CONTACT PERSON	Shannon Foltz	CONTACT PERSON	Todd Martin, P.E.					
ADDRESS	2610 Observation Trail	ADDRESS	203 West Nash Stre	et				
	Suite 104		Suite 100					
CITY, STATE & ZIP	Rockwall, TX 75032	CITY, STATE & ZIP	Terrell, TX 75160					
PHONE		PHONE						
E-MAIL		E-MAIL		5.0				
BEFORE ME, THE UNDER	CATION [REQUIRED] RSIGNED AUTHORITY, ON THIS DAY PERSONALI ION ON THIS APPLICATION TO BE TRUE AND CE	Y APPEARED Shawn or RTIFIED THE FOLLOWING:	n Foltz jowner	THE UNDERSIGNED, WHO				
S	TO COVER THE PURPOSE OF THIS APP TO COVER THE COST OF THIS APP 20 BY SIGNING THIS APPLICATION TO THE PUBLIC. FION WITH THIS APPLICATION, IF SUCH REPRODUC	LICATION, HAS BEEN PAID TO THE CITY ITION, I AGREE THAT THE CITY OF ROI THE CITY IS ALSO AUTHORIZED AND	OF ROCKWALL ON THIS THE CKWALL (I.E. "CITY") IS AUTHORIZED PERMITTED TO REPRODUCE ANY	DAY OF AND PERMITTED TO PROVIDE COPYRIGHTED INFORMATION				
GIVEN UNDER MY HAND	AND SEAL OF OFFICE ON THIS THE ODAY	of June 20 20	Notary Notary	Public, State of Texas # 13230083-8 nm. Exp. 01-06-2028				
NOTARY PUBLIC IN AND	FOR THE STATE OF TEXAS	inmonds	MY COMMISSION EXPIRE					

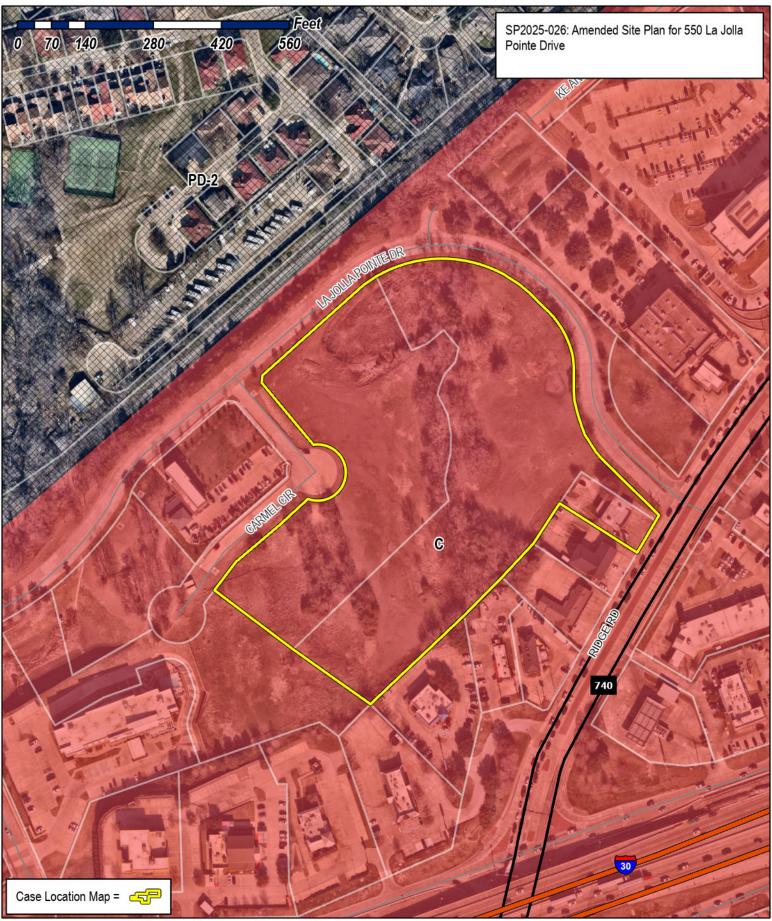



City of Rockwall Planning & Zoning Department 385 S. Goliad Street Rockwall, Texas 75087

(P): (972) 771-7745 (W): www.rockwall.com

The City of Rockwall GIS maps are continually under development and therefore subject to change without notice. While we endeavor to provide timely and accurate information, we make no guarantees. The City of Rockwall makes no warranty, express or implied, including warranties of merchantability and fitness for a particular purpose. Use of the information is the sole responsibility of the user.



LANDSCAPE CONSTRUCTION PLANS

FOR

LA JOLLA POINTE DRIVE PAD READY DEVELOPMENT 550 LA JOLLA POINTE DR. ROCKWALL, TX 75087 BLOCK A, LOT 22 & 23

PLANS SUBMITTAL/REVIEW LOG

FIRST CITY SUBMITTAL
-NOT FOR CONSTRUCTION

10/09/2024

SECOND CITY SUBMITTA
-NOT FOR CONSTRUCTION

05/16/2025

03/28/2025

-NOT FOR CONSTRUCTION

FOURTH CITY SUBMITTAL -NOT FOR CONSTRUCTION

06/18/2025

IN
THE CITY OF ROCKWALL,
ROCKWALL COUNTY, TEXAS

VICINITY	MAP	NC	N.T.S.
		, and the second	YELLOW ACKET LIN
	┌─ SI		CARRIAGAES, QUA
	LA JOLLA POINTE DR	AND THE SOR	
	LA JOL CHEME CIR		
		MARKET CENTER OR	
LAGUNA DR	30)//		H. Haril Society

	LANDSCAPE SHEET LIST TABLE
Sheet Number	Sheet Title
LC 0.00	COVER SHEET
TP 1.00	TREE PRESERVATION & REMOVAL PLAN
TP 2.00	TREE PRESERVATION DETAILS & NOTES
LP 0.00	PLANTING SCHEDULE & NOTES
LP 1.00	LANDSCAPE PLAN
LP 2.00	PLANTING DETAILS
LP 2.01	PLANTING DETAILS
LP 2.02	PLANTING DETAILS

OWNER



ROCKWALL ECONOMIC

DEVELOPEMENT CORPORATION

2610 OBSERVATION TRAIL, SUITE 104

ROCKWALL, TX 75032

CONTACT: PHIL WAGNER

Kimley» Horn

2500 PACIFIC AVENUE, SUITE 1100 DALLAS, TEXAS 75240 PHONE: (972) 910 2925 CONTACT: BEN RANKIN, PLA LA JOLLA POINTE ADDITION PH2 JUNE 18, 2025 /ER No. REVISIONS DATE

13455 NOEL RD. TWO GALLERIA OFFICE TOWER SUITE 700 DALLAS, TX 75240
PHONE: 972-770-1300 FAX: 972-239-3820
WWW.KIMLEY-HORN.COM TX F-928
© 2024 KIMLEY-HORN AND ASSOCIATES, INC.

PRELIMINARY

FOR REVIEW ONLY
Not for construction or permit purposes.

Kimley» Horn

R.L.A. BEN L. RANKIN
L.A. No. 2904 Date 06/18/2025

DATE
064584402

DATE
06/18/2025

SCALE AS SHOWN
DESIGNED BY DHL
DRAWN BY DHL

A JOLLA POINTE DRIVE

D READY DEVELOPMEN


PREPARED FOR

ROCKWALL ECONOMIC

DEVELOPMENT COPORATION

SOVER SHEET

SHEET NUMBER

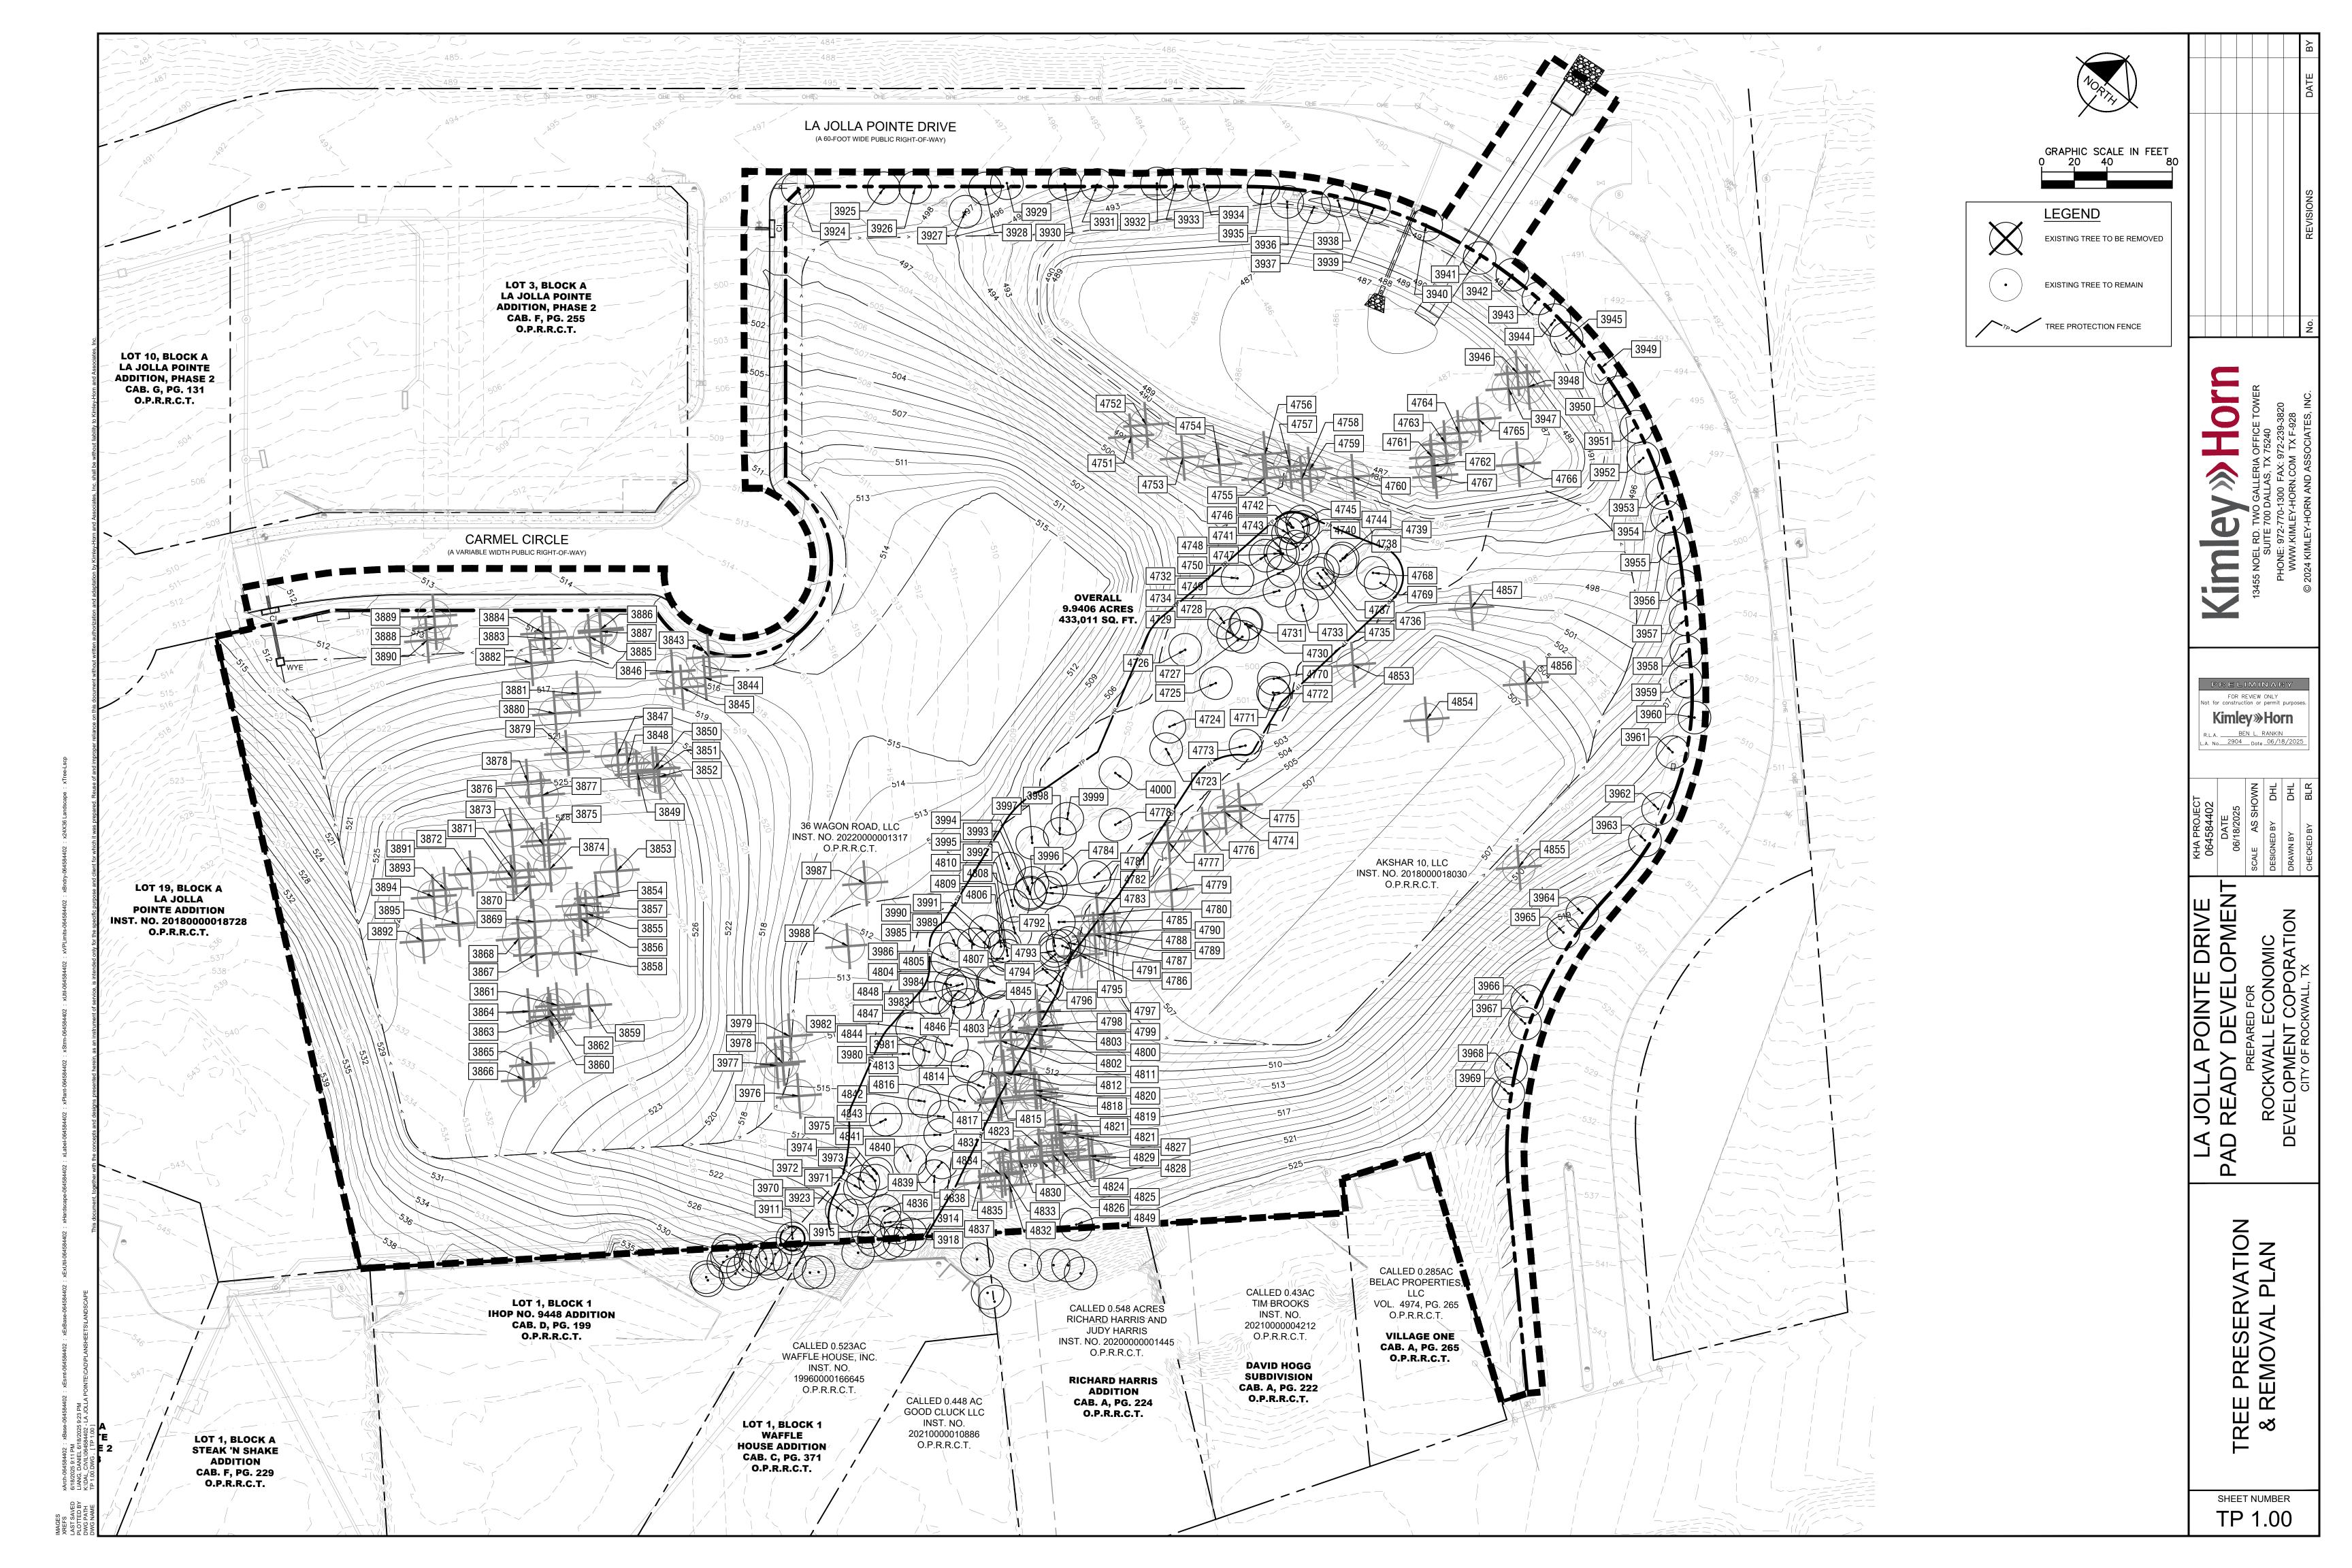


SITE	TREE	S REMOVE	D FOR GRADING	\ \ \	AND TIPLE									MINITED 5	1		
TAG #	DBH 10.2	COMMON NAME	SCIENTIFIC NAME	CONDITION Healthy	MULTIPLE- STEMMED	PROTECTED	STATUS Removed	MITIGATE 10.2	TAG # 4749	DBH 7.5	persimmon	SCIENTIFIC NAME Diospyros virginiana	CONDITION	MULTIPLE- STEMMED Single	Yes Yes	STATUS Remain	MITIGATE 0.0
3843 3844	8.1	green ash green ash	Fraxinus pennsylvanica Fraxinus pennsylvanica	Healthy	Single Single	Yes Yes	Removed	8.1	4750 4751	7.1 4.1	persimmon persimmon live oak	Diospyros virginiana	Healthy Healthy	Single Single	Yes Yes	Remain	0.0
3845 3846	15.8 9.0	green ash green ash	Fraxinus pennsylvanica Fraxinus pennsylvanica	Healthy Healthy	Forked Single	Yes Yes	Removed Removed	15.8 9.0	4752	4.0	live oak	Quercus virginiana Quercus virginiana	Declining	Forked	No	Removed Removed	0.0
3847 3848	5.9 4.2	green ash Hercules-club	Fraxinus pennsylvanica Zanthoxylum clava-herculis	Healthy Declining	Single Single	Yes No	Removed Removed	5.9 0.0	4753 4754	4.2 9.1	cedar elm cedar elm	Ulmus crassifolia Ulmus crassifolia	Declining Healthy	Single Single	No Yes	Removed Removed	0.0 9.1
3849 3850	6.2 4.5	Hercules-club green ash	Zanthoxylum clava-herculis Fraxinus pennsylvanica	Healthy Healthy	Multi Single	Yes Yes	Removed Removed	6.2 4.5	4755 4756	5.8 5.6	cedar elm cedar elm	Ulmus crassifolia Ulmus crassifolia	Healthy Healthy	Multi Forked	Yes Yes	Removed Removed	5.8 5.6
3851 3852	4.3 4.8	black hickory green ash	Carya texana Fraxinus pennsylvanica	Healthy Healthy	Multi Single	Yes Yes	Removed Removed	4.3 4.8	4757 4758	4.5 9.2	cedar elm cedar elm	Ulmus crassifolia Ulmus crassifolia	Healthy Healthy	Forked Forked	Yes Yes	Removed Removed	4.5 9.2
3853 3854	25.8 10.2	green ash	Fraxinus pennsylvanica	Healthy Healthy	Multi Single	Yes Yes	Removed Removed	25.8 10.2	4759 4760	6.8 12.9	cedar elm cedar elm	Ulmus crassifolia Ulmus crassifolia	Healthy Healthy	Single Forked	Yes Yes	Removed Removed	6.8 12.9
3855	9.2	green ash green ash	Fraxinus pennsylvanica Fraxinus pennsylvanica	Healthy	Single	Yes	Removed	9.2	4761 4762	7.9	live oak	Quercus virginiana	Healthy Healthy	Single Multi	Yes Yes	Removed Removed	7.9 12.8
3856 3857	12.9 9.5	green ash green ash	Fraxinus pennsylvanica Fraxinus pennsylvanica	Healthy Healthy	Single Single	Yes Yes	Removed Removed	12.9 9.5	4763	9.6	live oak	Quercus virginiana Quercus virginiana	Healthy	Forked	Yes	Removed	9.6
3858 3859	9.7 13.8	green ash green ash	Fraxinus pennsylvanica Fraxinus pennsylvanica	Healthy Healthy	Single Single	Yes Yes	Removed Removed	9.7 13.8	4764 4765	12.9 10.1	live oak live oak	Quercus virginiana Quercus virginiana	Healthy Healthy	Multi Forked	Yes Yes	Removed Removed	12.9 10.1
3860 3861	4.7 4.6	Hercules-club Hercules-club	Zanthoxylum clava-herculis Zanthoxylum clava-herculis	Healthy Healthy	Forked Single	Yes Yes	Removed Removed	4.7 4.6	4766 4767	32.6 14.2	pecan live oak	Carya illinoinensis Quercus virginiana	Healthy Healthy	Single Single	Yes Yes	Removed Removed	32.6 14.2
3862 3863	7.6 6.9	Hercules-club cedar elm	Zanthoxylum clava-herculis Ulmus crassifolia	Healthy Healthy	Forked Multi	Yes Yes	Removed Removed	7.6 6.9	4768 4769	16.8 12.2	hackberry hackberry	Celtis laevigata Celtis laevigata	Hazard Healthy	Single Forked	No No	Remain Remain	0.0
3864	4.1	Hercules-club	Zanthoxylum clava-herculis	Healthy	Multi	Yes	Removed	4.1	4770 4771	6.8	Hercules-club American elm	Zanthoxylum clava-herculis Ulmus americana	Healthy Healthy	Forked Single	Yes Yes	Remain Remain	0.0
3865 3866	22.1 5.3	hackberry cedar elm	Celtis laevigata Ulmus crassifolia	Declining Healthy	Forked Single	No Yes	Removed Removed	0.0 5.3	4772	4.1	American elm	Ulmus americana	Healthy	Single	Yes	Remain	0.0
3867 3868	6.3 10.2	cedar elm green ash	Ulmus crassifolia Fraxinus pennsylvanica	Healthy Healthy	Single Multi	Yes Yes	Removed Removed	6.3 10.2	4773 4774	5.8 5.1	American elm American elm	Ulmus americana Ulmus americana	Healthy Healthy	Single Single	Yes Yes	Remain Removed	0.0 5.1
3869 3870	19.9 9.3	cedar elm green ash	Ulmus crassifolia Fraxinus pennsylvanica	Healthy Healthy	Multi Single	Yes Yes	Removed Removed	19.9 9.3	4775 4776	4.2 5.4	green ash American elm	Fraxinus pennsylvanica Ulmus americana	Healthy Healthy	Single Single	Yes Yes	Removed Removed	4.2 5.4
3871 3872	11.1 13.8	cedar elm cedar elm	Ulmus crassifolia Ulmus crassifolia	Healthy Hazard	Single Single	Yes No	Removed Removed	11.1 0.0	4777 4778	6.8 6.0	eastern redbud American elm	Cercis canadensis Ulmus americana	Healthy Healthy	Forked Single	Yes Yes	Removed Remain	6.8 0.0
3873 3874	11.4	green ash	Fraxinus pennsylvanica	Healthy	Single	Yes Yes	Removed Removed	11.4 11.8	4779 4780	42.5 4.4	pecan green ash	Carya illinoinensis Fraxinus pennsylvanica	Healthy Healthy	Forked Single	Yes Yes	Removed Removed	42.5 4.4
3875	11.0	green ash green ash	Fraxinus pennsylvanica Fraxinus pennsylvanica	Healthy Healthy	Single Single	Yes	Removed	11.0	4781 4784	18.3	hackberry	Celtis laevigata	Healthy	Single	No	Remain	0.0
3876 3877	6.4 11.2	sweetgum green ash	Liquidambar styraciflua Fraxinus pennsylvanica	Healthy Healthy	Single Single	Yes Yes	Removed Removed	6.4 11.2	4785	4.5	green ash green ash	Fraxinus pennsylvanica Fraxinus pennsylvanica	Declining Healthy	Single Single	No Yes	Remain Remain	0.0
3878 3879	12.9 4.0	cedar elm cedar elm	Ulmus crassifolia Ulmus crassifolia	Hazard Healthy	Single Single	No Yes	Removed Removed	0.0 4.0	4786 4787	4.1 5.0	green ash green ash	Fraxinus pennsylvanica Fraxinus pennsylvanica	Healthy Healthy	Single Single	Yes Yes	Removed Remain	4.1 0.0
3880 3881	4.5 20.7	black hickory green ash	Carya texana Fraxinus pennsylvanica	Healthy Healthy	Multi Forked	Yes Yes	Removed Removed	4.5 20.7	4788 4789	4.6 4.8	green ash green ash	Fraxinus pennsylvanica Fraxinus pennsylvanica	Healthy Healthy	Single Single	Yes Yes	Removed Removed	4.6
3882 3883	9.1 10.9	green ash green ash	Fraxinus pennsylvanica Fraxinus pennsylvanica	Healthy Healthy	Single Single	Yes Yes	Removed Removed	9.1 10.9	4790 4791	5.3 4.3	green ash green ash	Fraxinus pennsylvanica Fraxinus pennsylvanica	Healthy Healthy	Single Single	Yes Yes	Removed Remain	5.3 0.0
3884	8.1	green ash	Fraxinus pennsylvanica	Healthy	Single	Yes	Removed	8.1	4792 4793	5.9 5.6	green ash green ash	Fraxinus pennsylvanica Fraxinus pennsylvanica	Healthy Healthy	Single Single	Yes Yes	Remain Remain	0.0
3885 3886	11.2 7.7	green ash green ash	Fraxinus pennsylvanica Fraxinus pennsylvanica	Healthy Healthy	Single Single	Yes Yes	Removed Removed	11.2 7.7	4794	5.1	green ash	Fraxinus pennsylvanica	Healthy	Single	Yes	Remain	0.0
3887 3888	8.9 14.7	green ash green ash	Fraxinus pennsylvanica Fraxinus pennsylvanica	Healthy Healthy	Single Single	Yes Yes	Removed Removed	8.9 14.7	4795 4796	6.0 7.6	green ash green ash	Fraxinus pennsylvanica Fraxinus pennsylvanica	Healthy Healthy	Single Forked	Yes Yes	Remain Remain	0.0
3889 3890	4.7 4.0	green ash Hercules-club	Fraxinus pennsylvanica Zanthoxylum clava-herculis	Healthy Healthy	Single Single	Yes Yes	Removed Removed	4.7 4.0	4797 4798	4.4	green ash green ash	Fraxinus pennsylvanica Fraxinus pennsylvanica	Healthy Healthy	Single Single	Yes Yes	Removed Removed	4.4
3891 3892	13.3 12.2	green ash hackberry	Fraxinus pennsylvanica Celtis laevigata	Healthy Healthy	Single Multi	Yes No	Removed Removed	13.3	4799 4800	5.1 4.9	Hercules-club green ash	Zanthoxylum clava-herculis Fraxinus pennsylvanica	Healthy Healthy	Forked Single	Yes Yes	Removed Removed	5.1 4.9
3893	6.9	green ash	Fraxinus pennsylvanica	Healthy	Forked	Yes	Removed	6.9	4801 4802	16.4 9.2	pecan pecan	Carya illinoinensis Carya illinoinensis	Declining Healthy	Single Single	No Yes	Removed Removed	0.0 9.2
3894 3895	4.9 10.9	Hercules-club cedar elm	Zanthoxylum clava-herculis Ulmus crassifolia	Healthy Healthy	Forked Forked	Yes Yes	Removed Removed	4.9 10.9	4803	7.4	pecan	Carya illinoinensis	Healthy	Single	Yes	Remain	0.0
3911 3914	5.5 6.2	tree of heaven tree of heaven	Ailanthus altissima Ailanthus altissima	Healthy Healthy	Single Single	Yes Yes	Remain Remain	0.0	4804 4805	7.9 8.5	pecan pecan	Carya illinoinensis Carya illinoinensis	Healthy Healthy	Single Single	Yes Yes	Remain Remain	0.0
3915 3918	6.5 9.3	tree of heaven box elder	Ailanthus altissima Acer negundo	Healthy Healthy	Single Single	Yes Yes	Remain Remain	0.0	4806 4807	11.0 10.7	hackberry pecan	Celtis laevigata Carya illinoinensis	Declining Healthy	Single Single	No Yes	Remain Remain	0.0
3923 3946	7.1 6.4	pecan cedar elm	Carya illinoinensis Ulmus crassifolia	Healthy Healthy	Single Single	Yes Yes	Remain Removed	0.0 6.4	4808 4809	9.3 4.9	pecan pecan	Carya illinoinensis Carya illinoinensis	Healthy Healthy	Single Single	Yes Yes	Remain Remain	0.0
3947 3948	7.2	cedar elm	Ulmus crassifolia	Healthy Healthy	Single Single	Yes Yes	Removed Removed	7.2	4810 4811	13.6 8.9	pecan southern red oak	Carya illinoinensis Quercus falcata	Healthy Healthy	Forked Single	Yes Yes	Remain Removed	0.0 8.9
3970	10.7	pecan	Ulmus crassifolia Carya illinoinensis	Healthy	Single	Yes	Remain	0.0	4818 4819	5.3 6.5	green ash green ash	Fraxinus pennsylvanica	Healthy Healthy	Single Single	Yes Yes	Removed Removed	5.3 6.5
3971 3972	9.1 11.5	pecan hackberry	Carya illinoinensis Celtis laevigata	Healthy Healthy	Single Single	Yes No	Remain Remain	0.0	4820	4.6	green ash	Fraxinus pennsylvanica Fraxinus pennsylvanica	Healthy	Single	Yes	Removed	4.6
3973 3974	17.6 20.9	pecan green ash	Carya illinoinensis Fraxinus pennsylvanica	Healthy Healthy	Multi Single	Yes Yes	Remain Remain	0.0	4821 4822	7.9 7.3	green ash green ash	Fraxinus pennsylvanica Fraxinus pennsylvanica	Healthy Healthy	Single Single	Yes Yes	Removed Removed	7.9 7.3
3975 3976	22.5 4.0	southern red oak green ash	Quercus falcata Fraxinus pennsylvanica	Healthy Healthy	Single Single	Yes Yes	Remain Removed	0.0 4.0	4823 4824	8.7 5.6	American elm green ash	Ulmus americana Fraxinus pennsylvanica	Healthy Healthy	Single Single	Yes Yes	Removed Removed	8.7 5.6
3977 3978	6.6 4.4	green ash green ash	Fraxinus pennsylvanica Fraxinus pennsylvanica	Healthy Healthy	Multi Forked	Yes Yes	Removed Removed	6.6 4.4	4825 4826	10.5 12.2	American elm American elm	Ulmus americana Ulmus americana	Healthy Healthy	Single Single	Yes Yes	Removed Removed	10.5 12.2
3979 3980	6.6	green ash	Fraxinus pennsylvanica	Healthy	Single	Yes Yes	Removed Remain	6.6	4827 4828	5.4 4.5	American elm green ash	Ulmus americana Fraxinus pennsylvanica	Healthy Healthy	Single Single	Yes Yes	Removed Removed	5.4 4.5
3981	21.6	green ash American elm	Fraxinus pennsylvanica Ulmus americana	Healthy Healthy	Single Forked	Yes	Remain	0.0	4829 4830	4.4	green ash	Fraxinus pennsylvanica	Healthy Healthy	Single Single	Yes Yes	Removed Removed	4.4
3982 3983	9.2 9.8	pecan pecan	Carya illinoinensis Carya illinoinensis	Healthy Healthy	Single Single	Yes Yes	Remain Remain	0.0	4831	4.5	green ash American elm	Fraxinus pennsylvanica Ulmus americana	Healthy	Single	Yes	Removed	4.5
3984 3985	5.3 16.1	pecan green ash	Carya illinoinensis Fraxinus pennsylvanica	Healthy Hazard	Single Single	Yes No	Remain Remain	0.0	4832 4833	5.9 8.0	green ash American elm	Fraxinus pennsylvanica Ulmus americana	Healthy Healthy	Single Single	Yes Yes	Removed Removed	5.9 8.0
3986 3987	4.4	American elm green ash	Ulmus americana Fraxinus pennsylvanica	Healthy Healthy	Single Single	Yes Yes	Remain Removed	0.0	4834 4835	11.5 8.4	American elm green ash	Ulmus americana Fraxinus pennsylvanica	Healthy Healthy	Forked Single	Yes Yes	Removed Removed	11.5 8.4
3988 3989	25.0	green ash	Fraxinus pennsylvanica	Healthy	Forked Multi	Yes	Removed Remain	25.0 0.0	4836 4837	6.4 9.7	tree of heaven	Ailanthus altissima Ailanthus altissima	Healthy Healthy	Single Single	Yes Yes	Remain Remain	0.0
3990	13.2	American elm green ash	Ulmus americana Fraxinus pennsylvanica	Healthy Healthy	Single	Yes Yes	Remain	0.0	4838	14.1	pecan American elm	Carya illinoinensis Ulmus americana	Healthy	Single Single	Yes Yes	Remain Remain	0.0
3991 3992	4.9 8.9	American elm pecan	Ulmus americana Carya illinoinensis	Healthy Healthy	Single Single	Yes Yes	Remain Remain	0.0	4840	9.9	green ash	Fraxinus pennsylvanica	Healthy	Single	Yes	Remain	0.0
3993 3994	9.1 4.4	pecan American elm	Carya illinoinensis Ulmus americana	Healthy Healthy	Single Single	Yes Yes	Remain Remain	0.0	4841 4842	12.9 17.2	hackberry green ash	Celtis laevigata Fraxinus pennsylvanica	Healthy Healthy	Single Single	No Yes	Remain Remain	0.0
3996 3997	9.2 20.9	pecan green ash	Carya illinoinensis Fraxinus pennsylvanica	Healthy Healthy	Single Forked	Yes Yes	Remain Remain	0.0	4843 4844	7.8 27.3	American elm pecan	Ulmus americana Carya illinoinensis	Declining Healthy	Single Single	No Yes	Remain Remain	0.0
3998 3999	16.1 21.6	American elm American elm	Ulmus americana Ulmus americana	Healthy Healthy	Single Single	Yes Yes	Remain Remain	0.0	4845 4846	6.4 6.9	pecan pecan	Carya illinoinensis Carya illinoinensis	Healthy Healthy	Single Single	Yes Yes	Remain Remain	0.0
4000	16.9	green ash	Fraxinus pennsylvanica	Healthy	Single	Yes	Remain	0.0	4847 4848	6.5 6.0	pecan	Carya illinoinensis Carya illinoinensis	Declining Declining	Single Single	No No	Remain Remain	0.0
4723	21.2	American elm	Tree tags 4001 - 4722 we Ulmus americana	Healthy	Single	Yes	Remain	0.0	4849 4853	15.7 8.8	American elm eastern redbud	Ulmus americana Cercis canadensis	Healthy Healthy	Single Single Multi	Yes Yes	Remain Removed	0.0
4724 4725	16.2 18.1	American elm green ash	Ulmus americana Fraxinus pennsylvanica	Healthy Healthy	Single Single	Yes Yes	Remain Remain	0.0	4854	21.2	hackberry	Celtis laevigata	Healthy	Forked	No	Removed	0.0
4726 4727	24.6 7.3	American elm green ash	Ulmus americana Fraxinus pennsylvanica	Healthy Healthy	Single Single	Yes Yes	Remain Remain	0.0	4856 4857	17.1 15.5	sweetgum sweetgum	Liquidambar styraciflua Liquidambar styraciflua	Healthy Healthy	Forked Forked	Yes Yes	Removed Removed	17.1 15.5
4728 4729	4.8	green ash Mexican plum	Fraxinus pennsylvanica Prunus mexicana	Healthy Declining	Single Forked	Yes No	Remain Remain	0.0								TOTAL	
4730	4.0	green ash	Fraxinus pennsylvanica	Healthy	Single	Yes	Remain	0.0	3995 4782	11.3 13.8	eastern redcedar eastern redcedar	Juniperus virginiana Juniperus virginiana	Healthy Declining	Single Single	Yes No	Remain Remain	0.0
4731 4732	4.0 18.7	green ash hackberry	Fraxinus pennsylvanica Celtis laevigata	Healthy Declining	Single Forked	Yes No	Remain Remain	0.0	4783 4812	10.2 11.4	eastern redcedar eastern redcedar	Juniperus virginiana Juniperus virginiana	Healthy Healthy	Single Single	Yes Yes	Remain Removed	0.0 4.0
4733 4734	8.4 5.6	persimmon American elm	Diospyros virginiana Ulmus americana	Healthy Healthy	Single Single	Yes Yes	Remain Remain	0.0	4813 4814	11.1	eastern redcedar eastern redcedar	Juniperus virginiana Juniperus virginiana	Declining Declining	Forked Single	No No	Remain Remain	0.0
4735 4736	5.2 4.1	green ash persimmon	Fraxinus pennsylvanica Diospyros virginiana	Healthy Healthy	Single Single	Yes Yes	Remain Remain	0.0	4815	14.3	eastern redcedar	Juniperus virginiana	Healthy	Single	Yes	Removed	4.0
4737 4738	6.7 7.5	persimmon black cherry	Diospyros virginiana Prunus serotina	Healthy Healthy	Single Single	Yes Yes	Remain	0.0	4816 4817	12.2 21.9	eastern redcedar eastern redcedar	Juniperus virginiana Juniperus virginiana	Healthy Healthy	Single Single	Yes Yes	Remain Removed	0.0 4.0
4739 4740	4.0 5.7	American elm	Ulmus americana	Healthy Healthy	Single Single	Yes Yes	Remain Remain	0.0	4855	11.6	eastern redcedar	Juniperus virginiana	Healthy	Multi	Yes	Removed TOTAL	4.0 16.0
4741	16.5	persimmon hackberry	Diospyros virginiana Celtis laevigata	Healthy	Single	No	Remain	0.0				TOTAL MITIGATION INCHES T PROPOSED INC		TED			-948.5 +122
4742 4743	5.5 11.6	persimmon pecan	Diospyros virginiana Carya illinoinensis	Declining Healthy	Single Single	No Yes	Remain Remain	0.0				TOTAL INCHI TOTAL MITIGATION COS					-867.7 \$173,540.00
4744 4745	6.5 4.3	persimmon persimmon	Diospyros virginiana Diospyros virginiana	Healthy Healthy	Single Single	Yes Yes	Remain Remain	0.0					,				
4746 4747	4.8 7.2	persimmon persimmon	Diospyros virginiana Diospyros virginiana	Healthy Healthy	Single Single	Yes Yes	Remain Remain	0.0									
4748	6.9	persimmon	Diospyros virginiana	Healthy	Single	Yes	Remain	0.0									

TAG#	DBH	COMMON NAME	SCIENTIFIC NAME	CONDITION	MULTIPLE- STEMMED	PROTECTED	STATUS	MITIGA.	
3924	6.9	live oak	Quercus virginiana	Healthy	Multi	Yes	Remain	0.0	
3925	8.6	live oak	Quercus virginiana	Healthy	Multi	Yes	Remain	0.0	
3926	4.5	live oak	Quercus virginiana	Healthy	Single	Yes	Remain	0.0	
3927	8.9	cedar elm	Ulmus crassifolia	Healthy	Multi	Yes	Remain	0.0	
3928	4.6	cedar elm	Ulmus crassifolia	Healthy	Single	Yes	Remain	0.0	
3929	6.6	cedar elm	Ulmus crassifolia	Healthy	Single	Yes	Remain	0.0	
3930	10.6	cedar elm	Ulmus crassifolia	Healthy	Forked	Yes	Remain	0.0	
3931	6.3	cedar elm	Ulmus crassifolia	Healthy	Single	Yes	Remain	0.0	
3932	12.6	cedar elm	Ulmus crassifolia	Healthy	Single	Yes	Remain	0.0	
3933	7.0	cedar elm	Ulmus crassifolia	Healthy	Single	Yes	Remain	0.0	
3934	12.7	cedar elm	Ulmus crassifolia	Healthy	Forked	Yes	Remain	0.0	
3935	9.1	live oak	Quercus virginiana	Healthy	Single	Yes	Remain	0.0	
3936	8.3	willow oak	Quercus phellos	Healthy	Forked	No	Remain	0.0	
3937	12.8	live oak	Quercus virginiana	Healthy	Single	Yes	Remain	0.0	
3938	10.1	live oak	Quercus virginiana	Healthy	Single	Yes	Remain	0.0	
3939	14.7	live oak	Quercus virginiana	Healthy	Single	Yes	Remain	0.0	
3940	5.1	cedar elm	Ulmus crassifolia	Healthy	Multi	Yes	Remain	0.0	
3941	13.9	cedar elm	Ulmus crassifolia	Declining	Single	No	Remain	0.0	
3942	10.4	cedar elm	Ulmus crassifolia	Healthy	Single	Yes	Remain	0.0	
3943	10.4	cedar elm	Ulmus crassifolia	Healthy	Single	Yes	Remain	0.0	
3944	7.0	cedar elm	Ulmus crassifolia	Healthy	Single	Yes	Remain	0.0	
3945	12.1	cedar elm	Ulmus crassifolia	Healthy	Single	Yes	Remain	0.0	
3949	10.9	live oak	Quercus virginiana	Healthy	Multi	Yes	Remain	0.0	
3950	18.4	live oak	Quercus virginiana	Healthy	Multi	Yes	Remain	0.0	
3951	9.7	cedar elm	Ulmus crassifolia	Healthy	Single	Yes	Remain	0.0	
3952	11.6	cedar elm	Ulmus crassifolia	Healthy	Forked	Yes	Remain	0.0	
3953	10.1	cedar elm	Ulmus crassifolia	Healthy	Single	Yes	Remain	0.0	
3954	12.4	cedar elm	Ulmus crassifolia	Healthy	Forked	Yes	Remain	0.0	
3955	9.4	cedar elm	Ulmus crassifolia	Healthy	Single	Yes	Remain	0.0	
3956	13.1	cedar elm	Ulmus crassifolia	Healthy	Multi	Yes	Remain	0.0	
3957	9.2	cedar elm	Ulmus crassifolia	Healthy	Single	Yes	Remain	0.0	
3958	10.4	live oak	Quercus virginiana	Healthy	Single	Yes	Remain	0.0	
3959	9.8	live oak	Quercus virginiana	Healthy	Single	Yes	Remain	0.0	
3960	12.6	live oak	Quercus virginiana	Healthy	Forked	Yes	Remain	0.0	
3961	10.0	cedar elm	Ulmus crassifolia	Healthy	Single	Yes	Remain	0.0	
3962	12.9	cedar elm	Ulmus crassifolia	Healthy	Single	Yes	Remain	0.0	
3963	11.1	cedar elm	Ulmus crassifolia	Healthy	Single	Yes	Remain	0.0	
3964	9.1	live oak	Quercus virginiana	Healthy	Single	Yes	Remain	0.0	
3965	11.1	live oak	Quercus virginiana	Healthy	Multi	Yes	Remain	0.0	
3966	8.0	cedar elm	Ulmus crassifolia	Healthy	Forked	Yes	Remain	0.0	
3967	12.3	cedar elm	Ulmus crassifolia	Healthy	Multi	Yes	Remain	0.0	
3968	7.5	cedar elm	Ulmus crassifolia	Healthy	Multi	Yes	Remain	0.0	
3969	12.4	cedar elm	Ulmus crassifolia	Healthy	Single	Yes	Remain	0.0	
2230	. —	2 2 2 2 1 2 1 1 1	Simus Statement		29.0		TOTAL	0.0	
	TOTAL MITIGATION INCHES THAT'S PROTECTED								

TREE REMOVAL NOTES:

- A. REMOVE ALL TREES INDICATED BY THE DRAWINGS AND SPECIFICATIONS, AS REQUIRING REMOVAL, IN A MANNER THAT WILL NOT DAMAGE ADJACENT TREES OR STRUCTURES
- . REMOVE TREES THAT ARE ADJACENT TO TREES OR STRUCTURES TO REMAIN, IN SECTIONS, TO LIMIT THE OPPORTUNITY OF DAMAGE TO ADJACENT CROWNS, TRUNKS, GROUND PLANE ELEMENTS AND STRUCTURES.
- DO NOT DROP TREES WITH A SINGLE CUT UNLESS THE TREE WILL FALL IN AN AREA NOT INCLUDED IN THE TREE PROTECTION AREA.
- NO TREE TO BE REMOVED WITHIN 50 FEET OF OR INSIDE THE TREE PROTECTION AREA SHALL BE PUSHED OVER OR UP-ROOTED USING A PIECE OF GRADING EQUIPMENT. NO HEAVY EQUIPMENT IS ALLOWED INSIDE THE TREE PROTECTION AREA.
- PROTECT ADJACENT PAVING, SOIL, TREES, SHRUBS, GROUND COVER PLANTINGS AND UNDERSTORY PLANTS TO REMAIN FROM DAMAGE DURING ALL TREE REMOVAL OPERATIONS, AND FROM CONSTRUCTION OPERATIONS. PROTECTION SHALL INCLUDE THE ROOT SYSTEM, TRUNK, LIMBS, AND CROWN FROM BREAKAGE OR SCARRING, AND THE SOIL FROM COMPACTION.
- REMOVE STUMPS AND IMMEDIATE ROOT PLATE FROM EXISTING TREES TO BE REMOVED. GRIND TRUNK BASES AND LARGE BUTTRESS ROOTS TO A DEPTH OF THE LARGEST BUTTRESS ROOT OR AT LEAST 18 INCHES BELOW THE TOP MOST ROOTS WHICHEVER IS LESS AND OVER THE AREA OF THREE TIMES THE DIAMETER OF THE TRUNK (DBH).
- F.A. FOR TREES WHERE THE STUMP WILL FALL UNDER NEW PAVED AREAS, GRIND ROOTS TO A TOTAL DEPTH OF 18 INCHES BELOW THE EXISTING GRADE. IF THE SIDES OF THE STUMP HOLE STILL HAVE GREATER THAN APPROXIMATELY 20% WOOD VISIBLE, CONTINUE GRINDING OPERATION DEEPER AND OR WIDER UNTIL THE RESULTING HOLE HAS LESS THAN 20% WOOD. REMOVE ALL WOOD CHIPS PRODUCED BY THE GRINDING OPERATION AND BACK FILL IN 8 INCH LAYERS WITH CONTROLLED FILL OF A QUALITY ACCEPTABLE TO THE SITE ENGINEER FOR FILL MATERIAL UNDER STRUCTURES, COMPACTED TO 95% OF THE MAXIMUM DRY DENSITY STANDARD PROCTOR. THE OWNER'S REPRESENTATIVE SHALL APPROVE EACH HOLE AT THE END OF THE GRINDING OPERATION.
- F.B. IN AREAS WHERE THE TREE LOCATION IS TO BE A PLANTING BED OR LAWN, REMOVE ALL WOODCHIPS AND BACKFILL STUMP HOLES WITH PLANTING SOIL AS DEFINED IN SPECIFICATION SECTION PLANTING SOIL, IN MAXIMUM OF 12 INCH LAYERS AND COMPACT TO 80 - 85% OF THE MAXIMUM DRY DENSITY STANDARD PROCTOR.

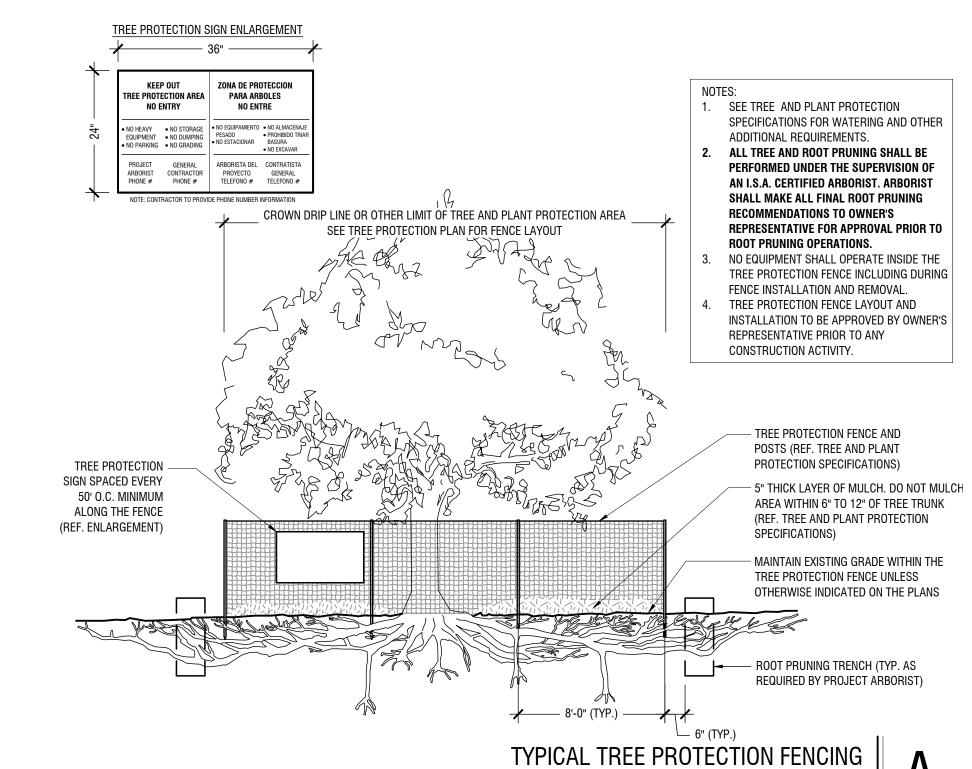

IREE PRES

PRELIMINARY FOR REVIEW ONLY Not for construction or permit purposes

Kimley »Horn

R.L.A. BEN L. RANKIN L.A. No. 2904 Date 06/18/2025

SHEET NUMBER TP 2.00


ERVATION NOTES


SE


Scale: NTS


	PLANTING NOTES:	PLANTING SCHEDULE:	
	1. CONTRACTOR SHALL BE RESPONSIBLE FOR VERIFYING THE LOCATIONS OF ALL UNDERGROUND UTILITIES, PIPES, STRUCTURES, AND LINE RUNS IN THE FIELD PRIOR TO THE INSTALLATION OF ANY PLANT MATERIAL.	SYMBOL CODE QTY BOTANICAL / COMMON NAME ROOT CAL. SIZE REMARKS	=
	 IT IS THE RESPONSIBILITY OF THE CONTRACTOR TO ADVISE THE LANDSCAPE ARCHITECT OF ANY CONDITION FOUND ON SITE WHICH PERMITS INSTALLATION AS SHOWN ON THESE DRAWINGS. ALL PLANT MATERIAL SHALL BE MAINTAINED IN A HEALTHY, GROWING CONDITION AND MUST BE REPLACED WITHIN 30 DAYS WITH PLANT MATERIAL 	CANOPY TREES O QM 4 QUERCUS MACROCARPA / BUR OAK B & B 4" CAL. 12`-14` HT. STRONG, CENTRAL LEADER, FULL	
	OF THE SAME VARIETY AND SIZE IF DAMAGED, DESTROYED, OR REMOVED. 4. CONTRACTOR SHALL BE RESPONSIBLE FOR FINE GRADING AND REMOVAL OF DEBRIS PRIOR TO PLANTING IN ALL AREAS.		
	5. FINAL FINISH GRADING SHALL BE REVIEWED AND APPROVED BY THE LANDSCAPE ARCHITECT. THE CONTRACTOR SHALL BE RESPONSIBLE FOR ANY ADDITIONAL TOPSOIL REQUIRED TO CREATE A SMOOTH CONDITION PRIOR TO PLANTING.	QC 1 QUERCUS MUEHLENBERGII / CHINKAPIN OAK B & B 4" CAL. 16` - 18` HT. SINGLE STRAIGHT CENTRAL LEADER, FULL AND MATCHING	
	6. CONTRACTOR SHALL VERIFY ALL PLANT QUANTITIES. ALL PLANT QUANTITIES ARE LISTED FOR INFORMATION PURPOSES ONLY. IT IS THE CONTRACTOR'S RESPONSIBILITY TO PROVIDE FULL COVERAGE IN ALL PLANTING AREAS AS SHOWN ON THE PLANS AND SPECIFIED IN THE PLANT SCHEDULE.	QS 2 QUERCUS SHUMARDII / SHUMARD RED OAK B & B 4" CAL. 12` - 14` HT. STRONG, CENTRAL LEADER, FULL	
	7. CONTRACTOR TO PROVIDE STEEL EDGING BETWEEN ALL PLANTING BEDS AND TURF AREAS UNLESS OTHERWISE INDICATED ON THE DRAWINGS. 8. ALL PLANT MATERIAL SHALL CONFORM TO THE SPECIFICATIONS GIVEN IN THE PLANT SCHEDULE, PLANTING DETAILS, AND PLANTING	ORNAMENTAL TREES ORNAMENTAL TREES FINAL SINGLE STRAIGHT CENTRAL LEADER, FULL AND MATCHING	
	SPECIFICATIONS. 9. ALL PLANT MATERIAL SHALL MEET INDUSTRY STANDARDS AS INDICATED IN THE CURRENT EDITION OF THE AMERICAN STANDARD FOR NURSERY STOCK (ANSI Z60.1).	AND WATCHING AND WATCHING	
	10. ALL PLANT MATERIAL SUBSTITUTIONS SHALL BE APPROVED BY LANDSCAPE ARCHITECT PRIOR TO PURCHASE. 11. CONTRACTOR IS RESPONSIBLE FOR ALL COORDINATION WITH OTHER CONTRACTORS ON SITE AS REQUIRED TO ACCOMPLISH ALL PLANTING	AND MATCHING	
AAS SO	OPERATIONS. 12. ALL PLANTING AREAS SHALL RECEIVE SOIL AMENDMENTS.		
	 13. PLANT MATERIAL SHALL BE PRUNED PER PLANTING DETAILS UNLESS OTHERWISE NOTED ON DRAWINGS. 14. PLANTING AREAS SHALL BE KEPT FREE OF TRASH, WEEDS, DEBRIS, AND DEAD PLANT MATERIAL. 15. ALL LIME STABILIZED SOIL AND INORGANIC SELECT FILL FOR BUILDING OR PAVING CONSTRUCTION SHALL BE REMOVED FROM ALL PLANTING BEDS 		OWER 20
ut is a special point of the s	TO A MINIMUM DEPTH OF 24" UNLESS OTHERWISE NOTED. REPLACE MATERIAL REMOVED WITH IMPORTED TOPSOIL. 16. TREES OVERHANGING PEDESTRIAN WALKS AND WITHIN VISIBILITY TRIANGLES AS NOTED ON THE PLANS SHALL BE LIMBED TO A HEIGHT OF SEVEN		FFICE TO 5240
shall leds Market Market	FEET (7'). TREE OVERHANGING PUBLIC STREETS AND FIRELANES SHALL BE LIMBED TO A HEIGHT OF FOURTEEN FEET (14'). 17. TREES PLANTED NEXT TO ACCESSIBLE ROUTES AND ACCESSIBLE AREAS SHALL BE LIMBED TO 7'6" (80" MIN.) AFF.		LERIA OI AS, TX 76 FAX: 972 N.COM T
sociales.	18. ALL PROPOSED TREES SHALL BE STAKED WITH AN AT-GRADE ROOT BALL SECURING SYSTEM AS SHOWN IN THE PLANTING DETAILS AND SPECIFICATIONS. NO ABOVE-GROUND STAKING SYSTEMS, GUY WIRES/WIRES, HOSES, STRAPS, POSTS (METAL OR WOOD) SHALL BE ALLOWED UNLESS AUTHORIZED IN WRITING BY THE LANDSCAPE ARCHITECT.		VO GALLA O DALLA VA-HORN
would be a second of the secon			- RD. TW UITE 700
ation of the control			S NOEL S PHONE WWW
ou ada ada ada ada ada ada ada ada ada ad			1348
ten anthorizat			
ut with			PRELIMINARY
			FOR REVIEW ONLY Not for construction or permit purposes Kimley >>> Horn
bet reliance o			R.L.A. BEN L. RANKIN L.A. No. 2904 Date 06/18/2025
out of the control of			
Spansed Spanse			CT 2 CT 1 OWN
which it was provided the control of			HA PROJE 06458440 DATE 06/18/2025 E AS SH GNED BY
and client for			SCAL DESI
Vince the second of the second			PM PM atio
s in the state of			TE LO
or the second se			PC DE REPARE
ese production of the control of the			AD AD W.
			NOC ROC
o out of the control			LA AD
ogether with the state of the s			<u> </u>
is of the control of			Ш
			l ne
			HED!
LSIT AND SO AIL			
			0 S
POINTE(CAD			
25 5 5 5 2 4 PM			V
WINIEL 6/18/20: VILV04/20: VILV04			곱
LANG, DA F 1.00, DA F 1.00, DA			SHEET NUMBER

SHEET NUMBER LP 0.00

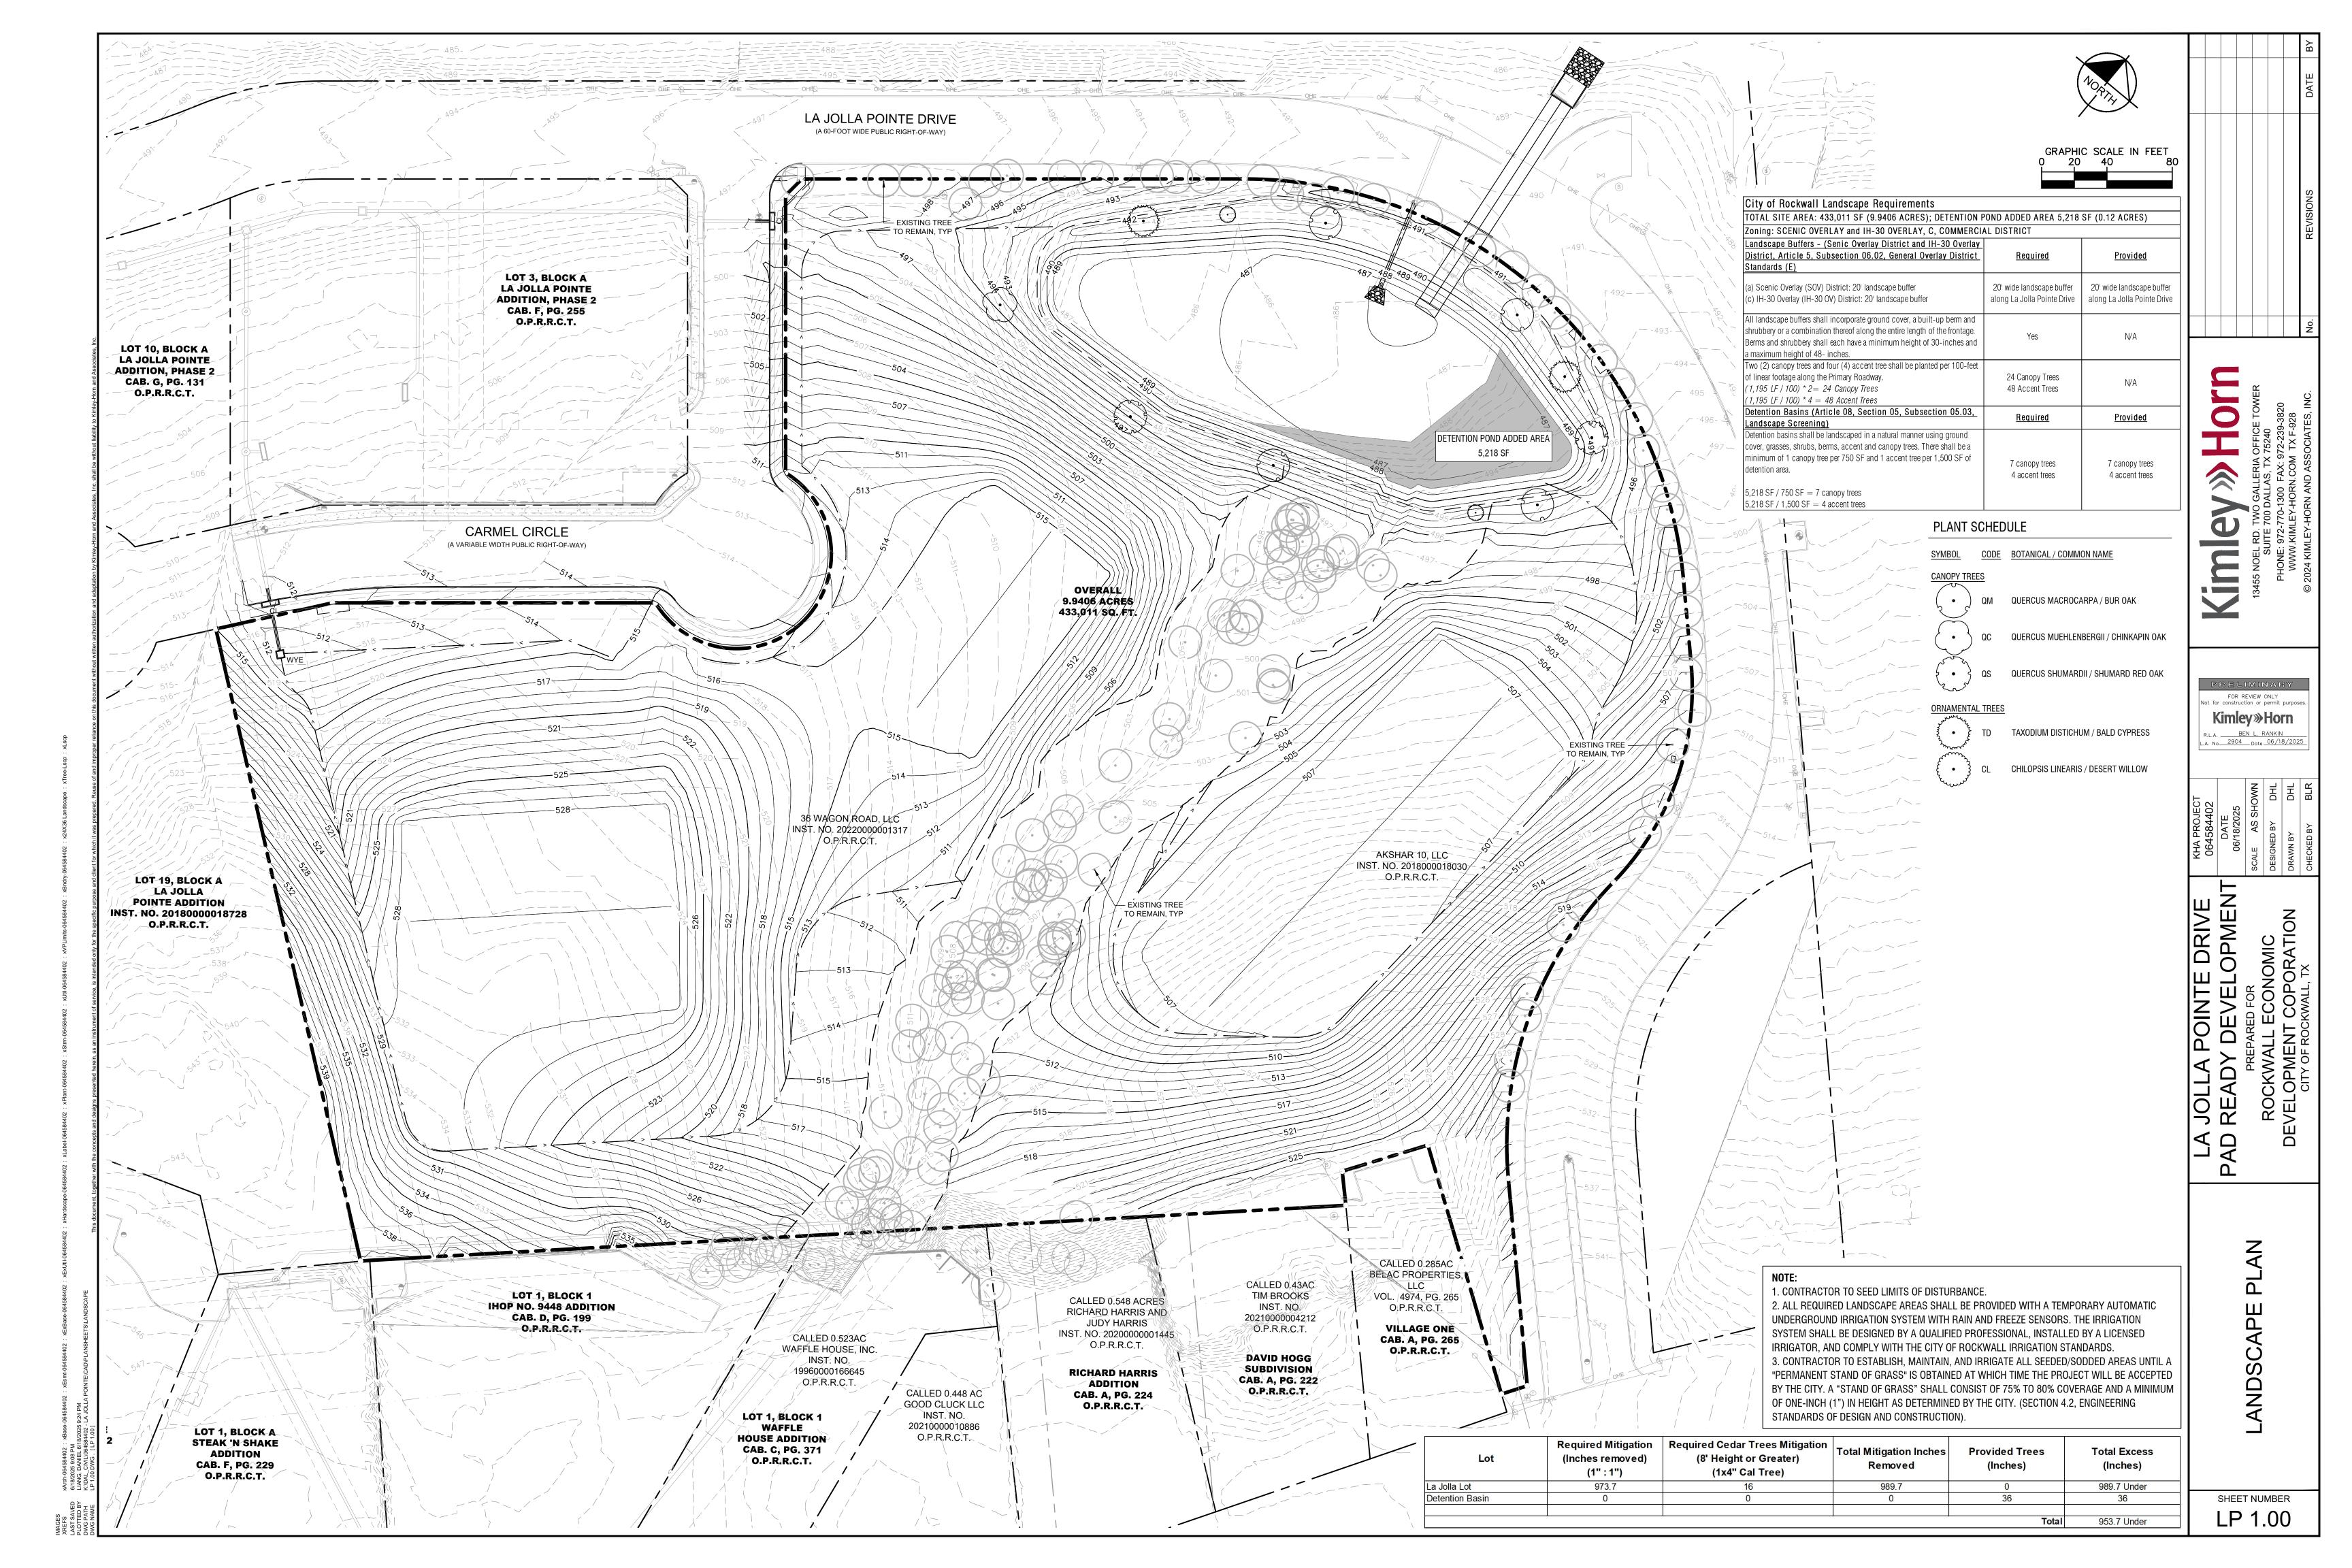

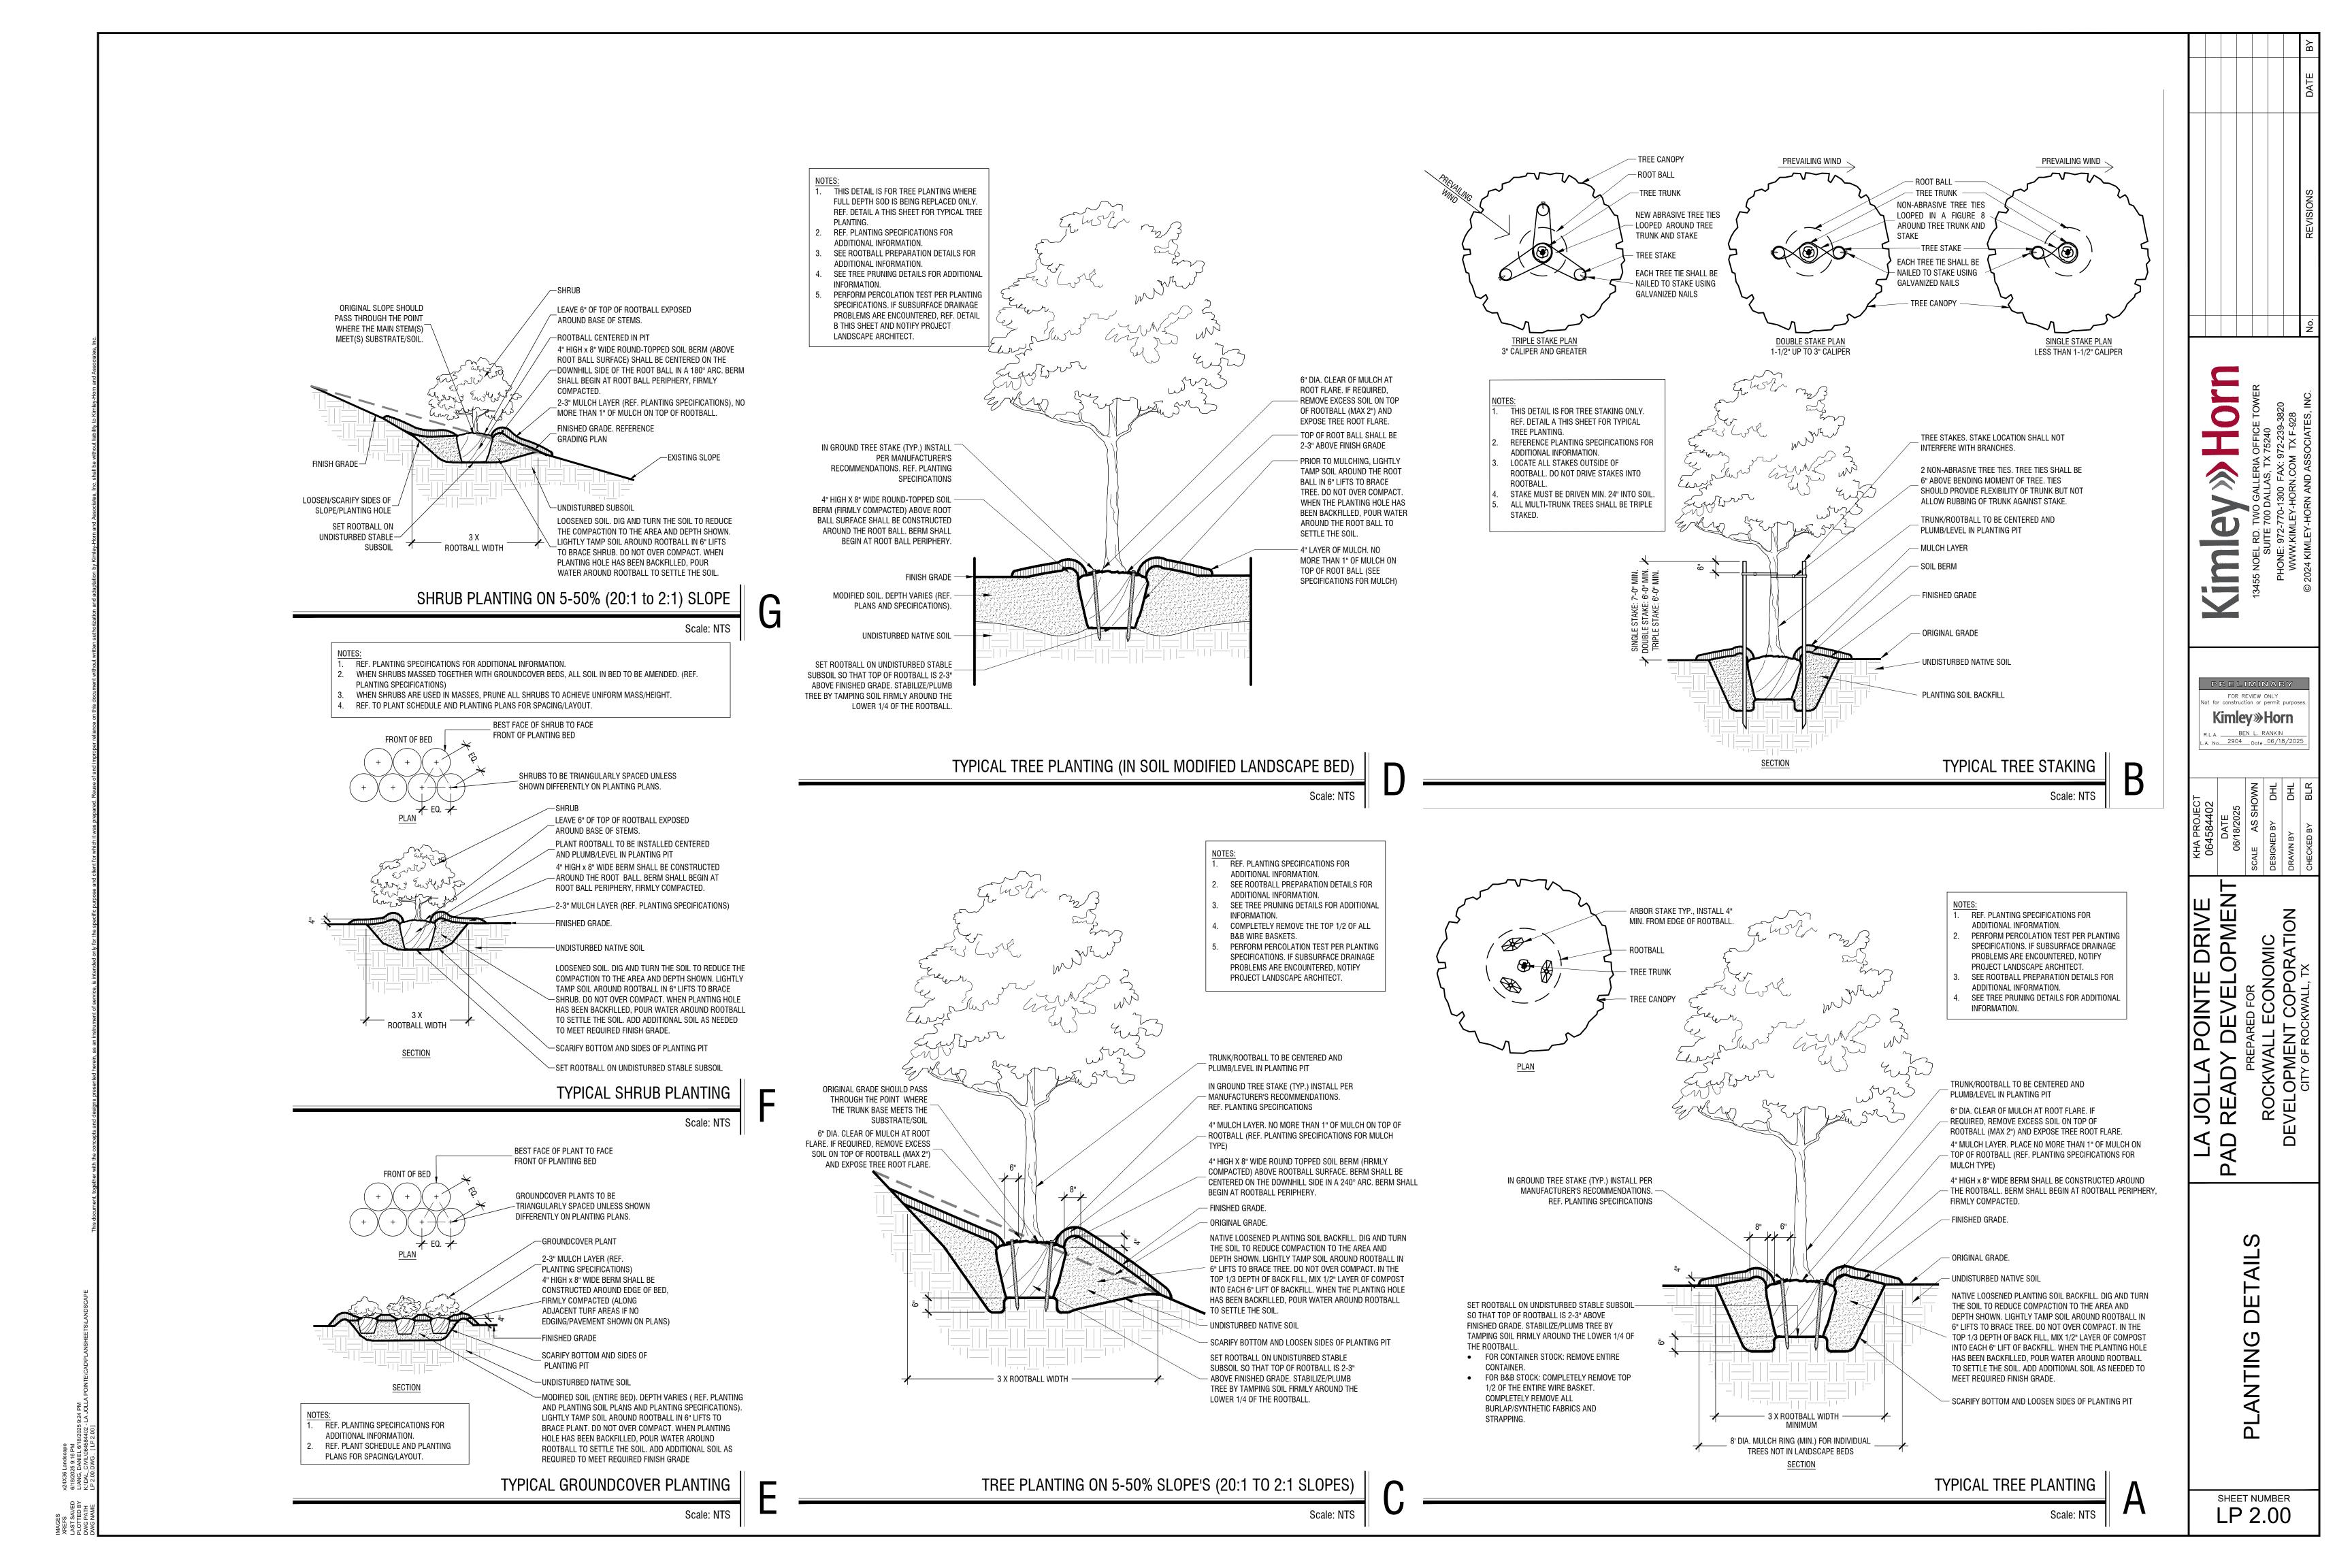

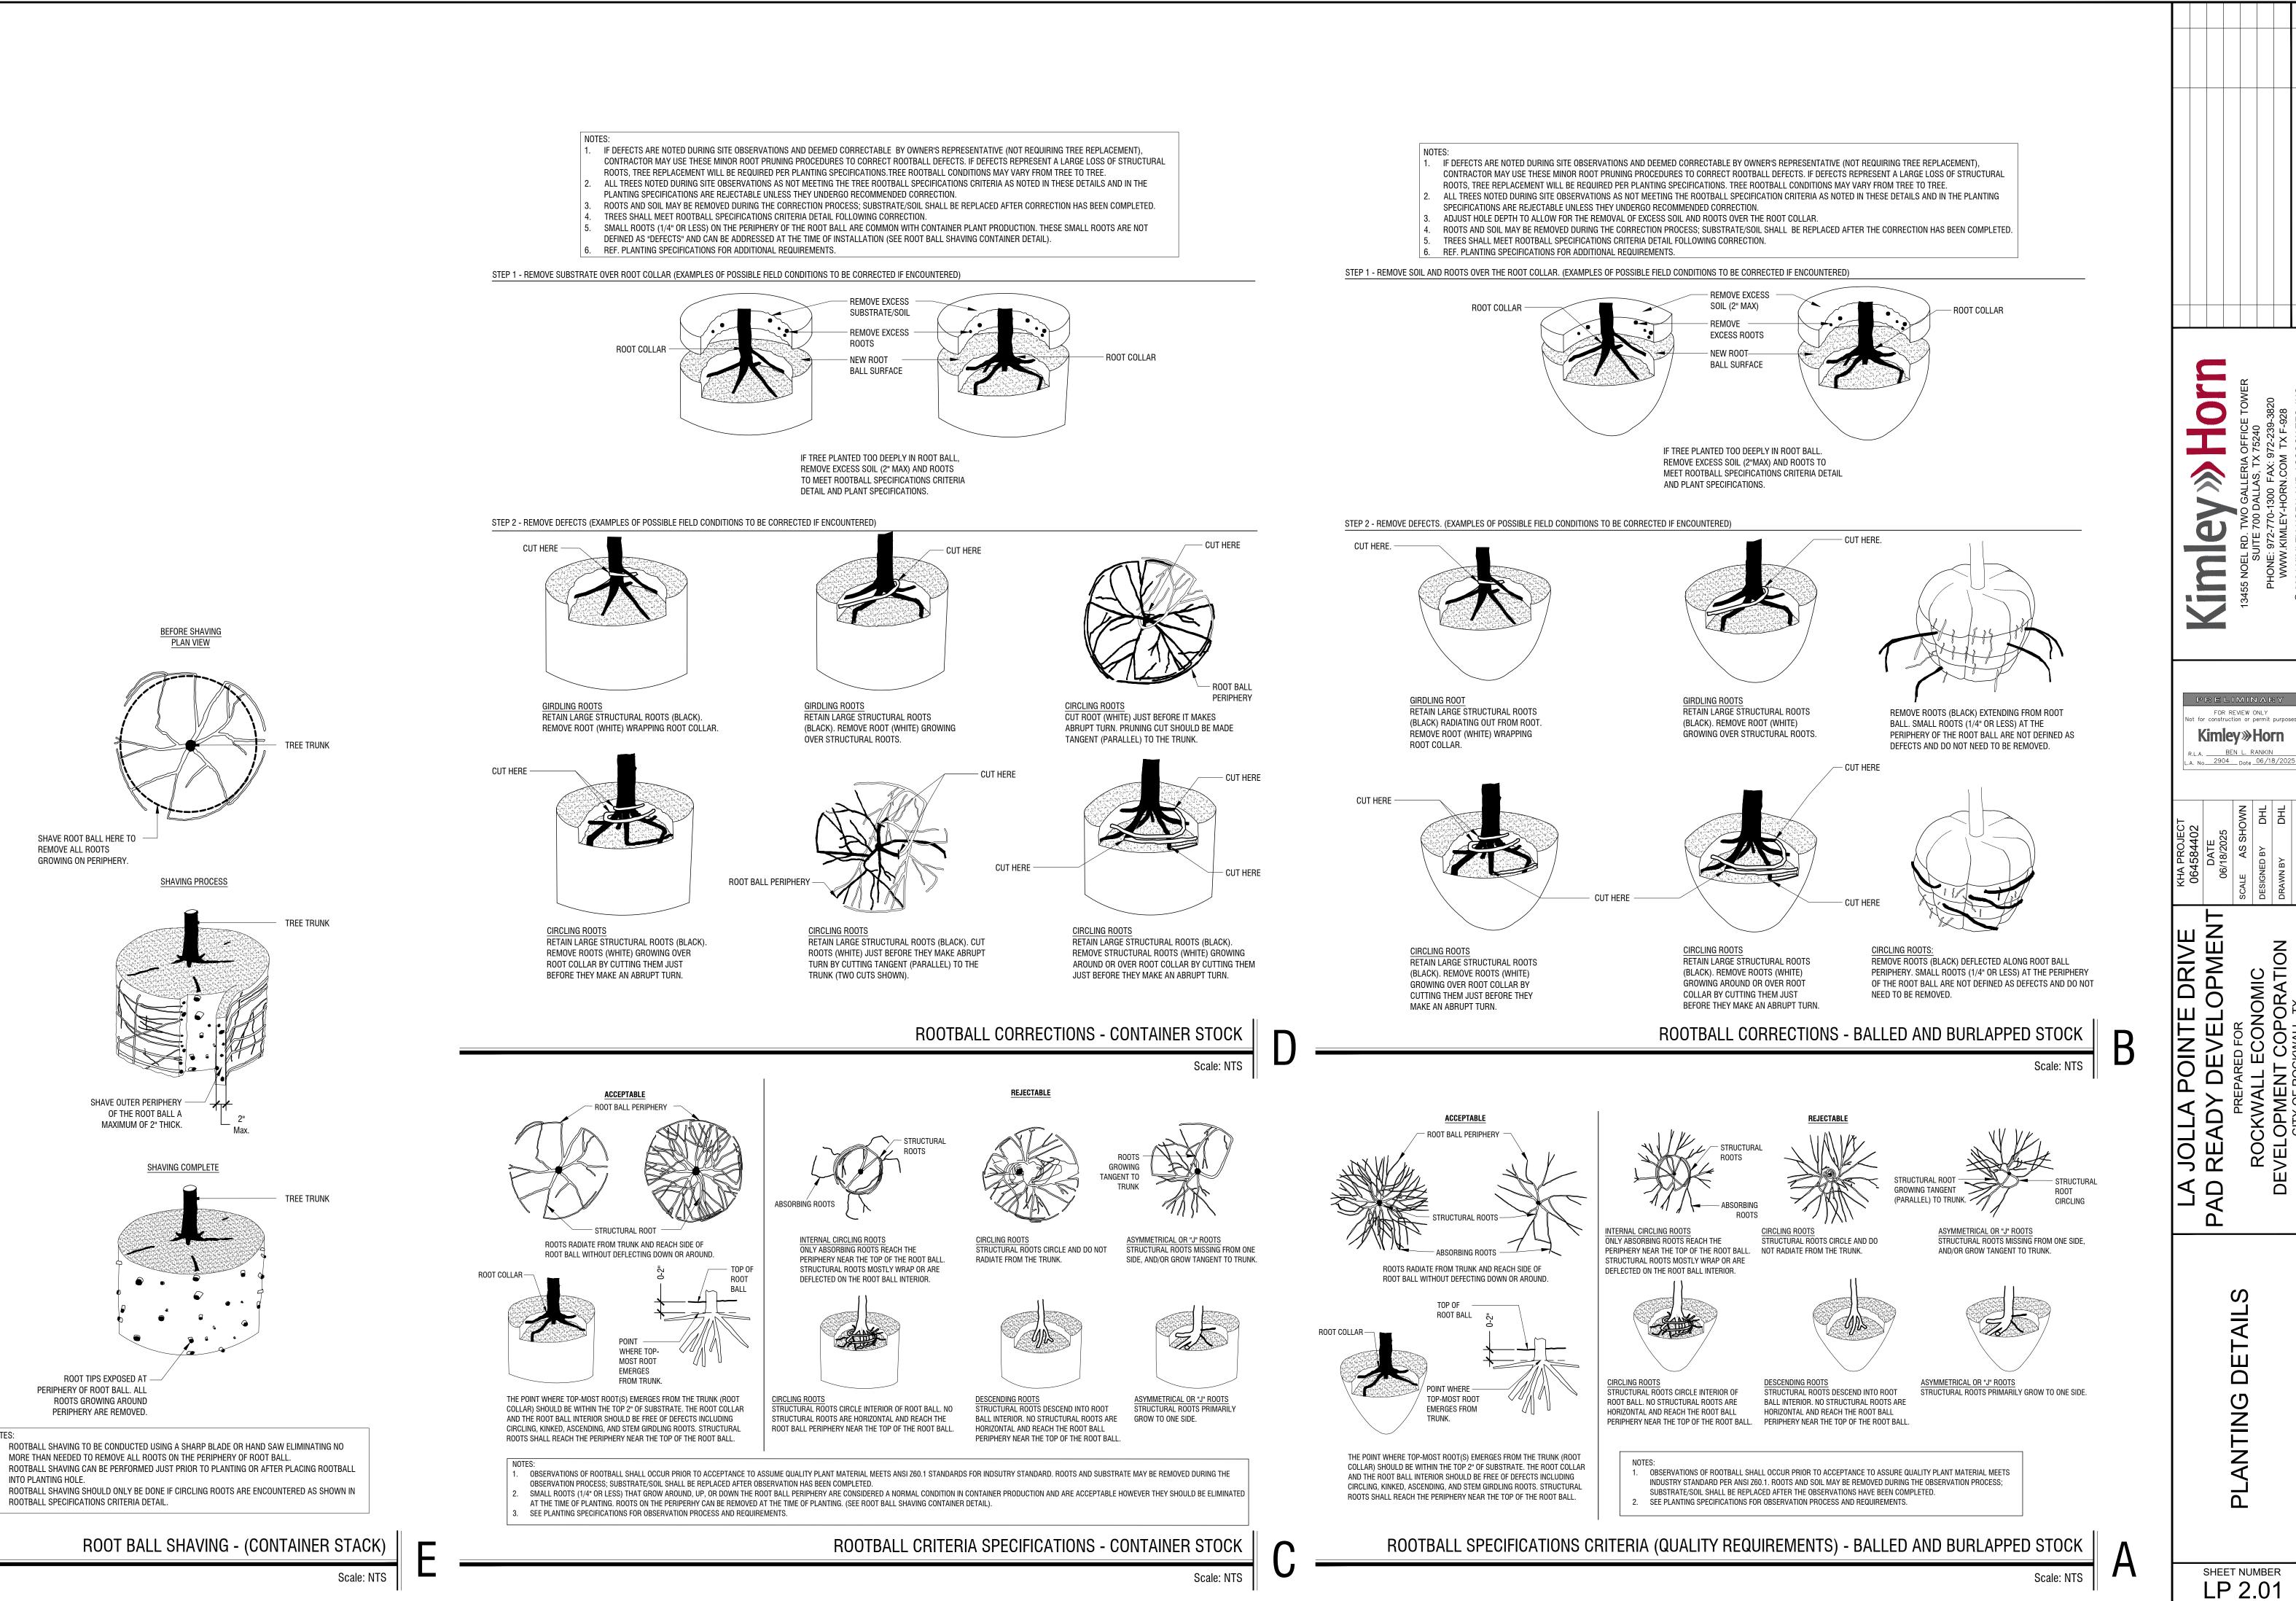

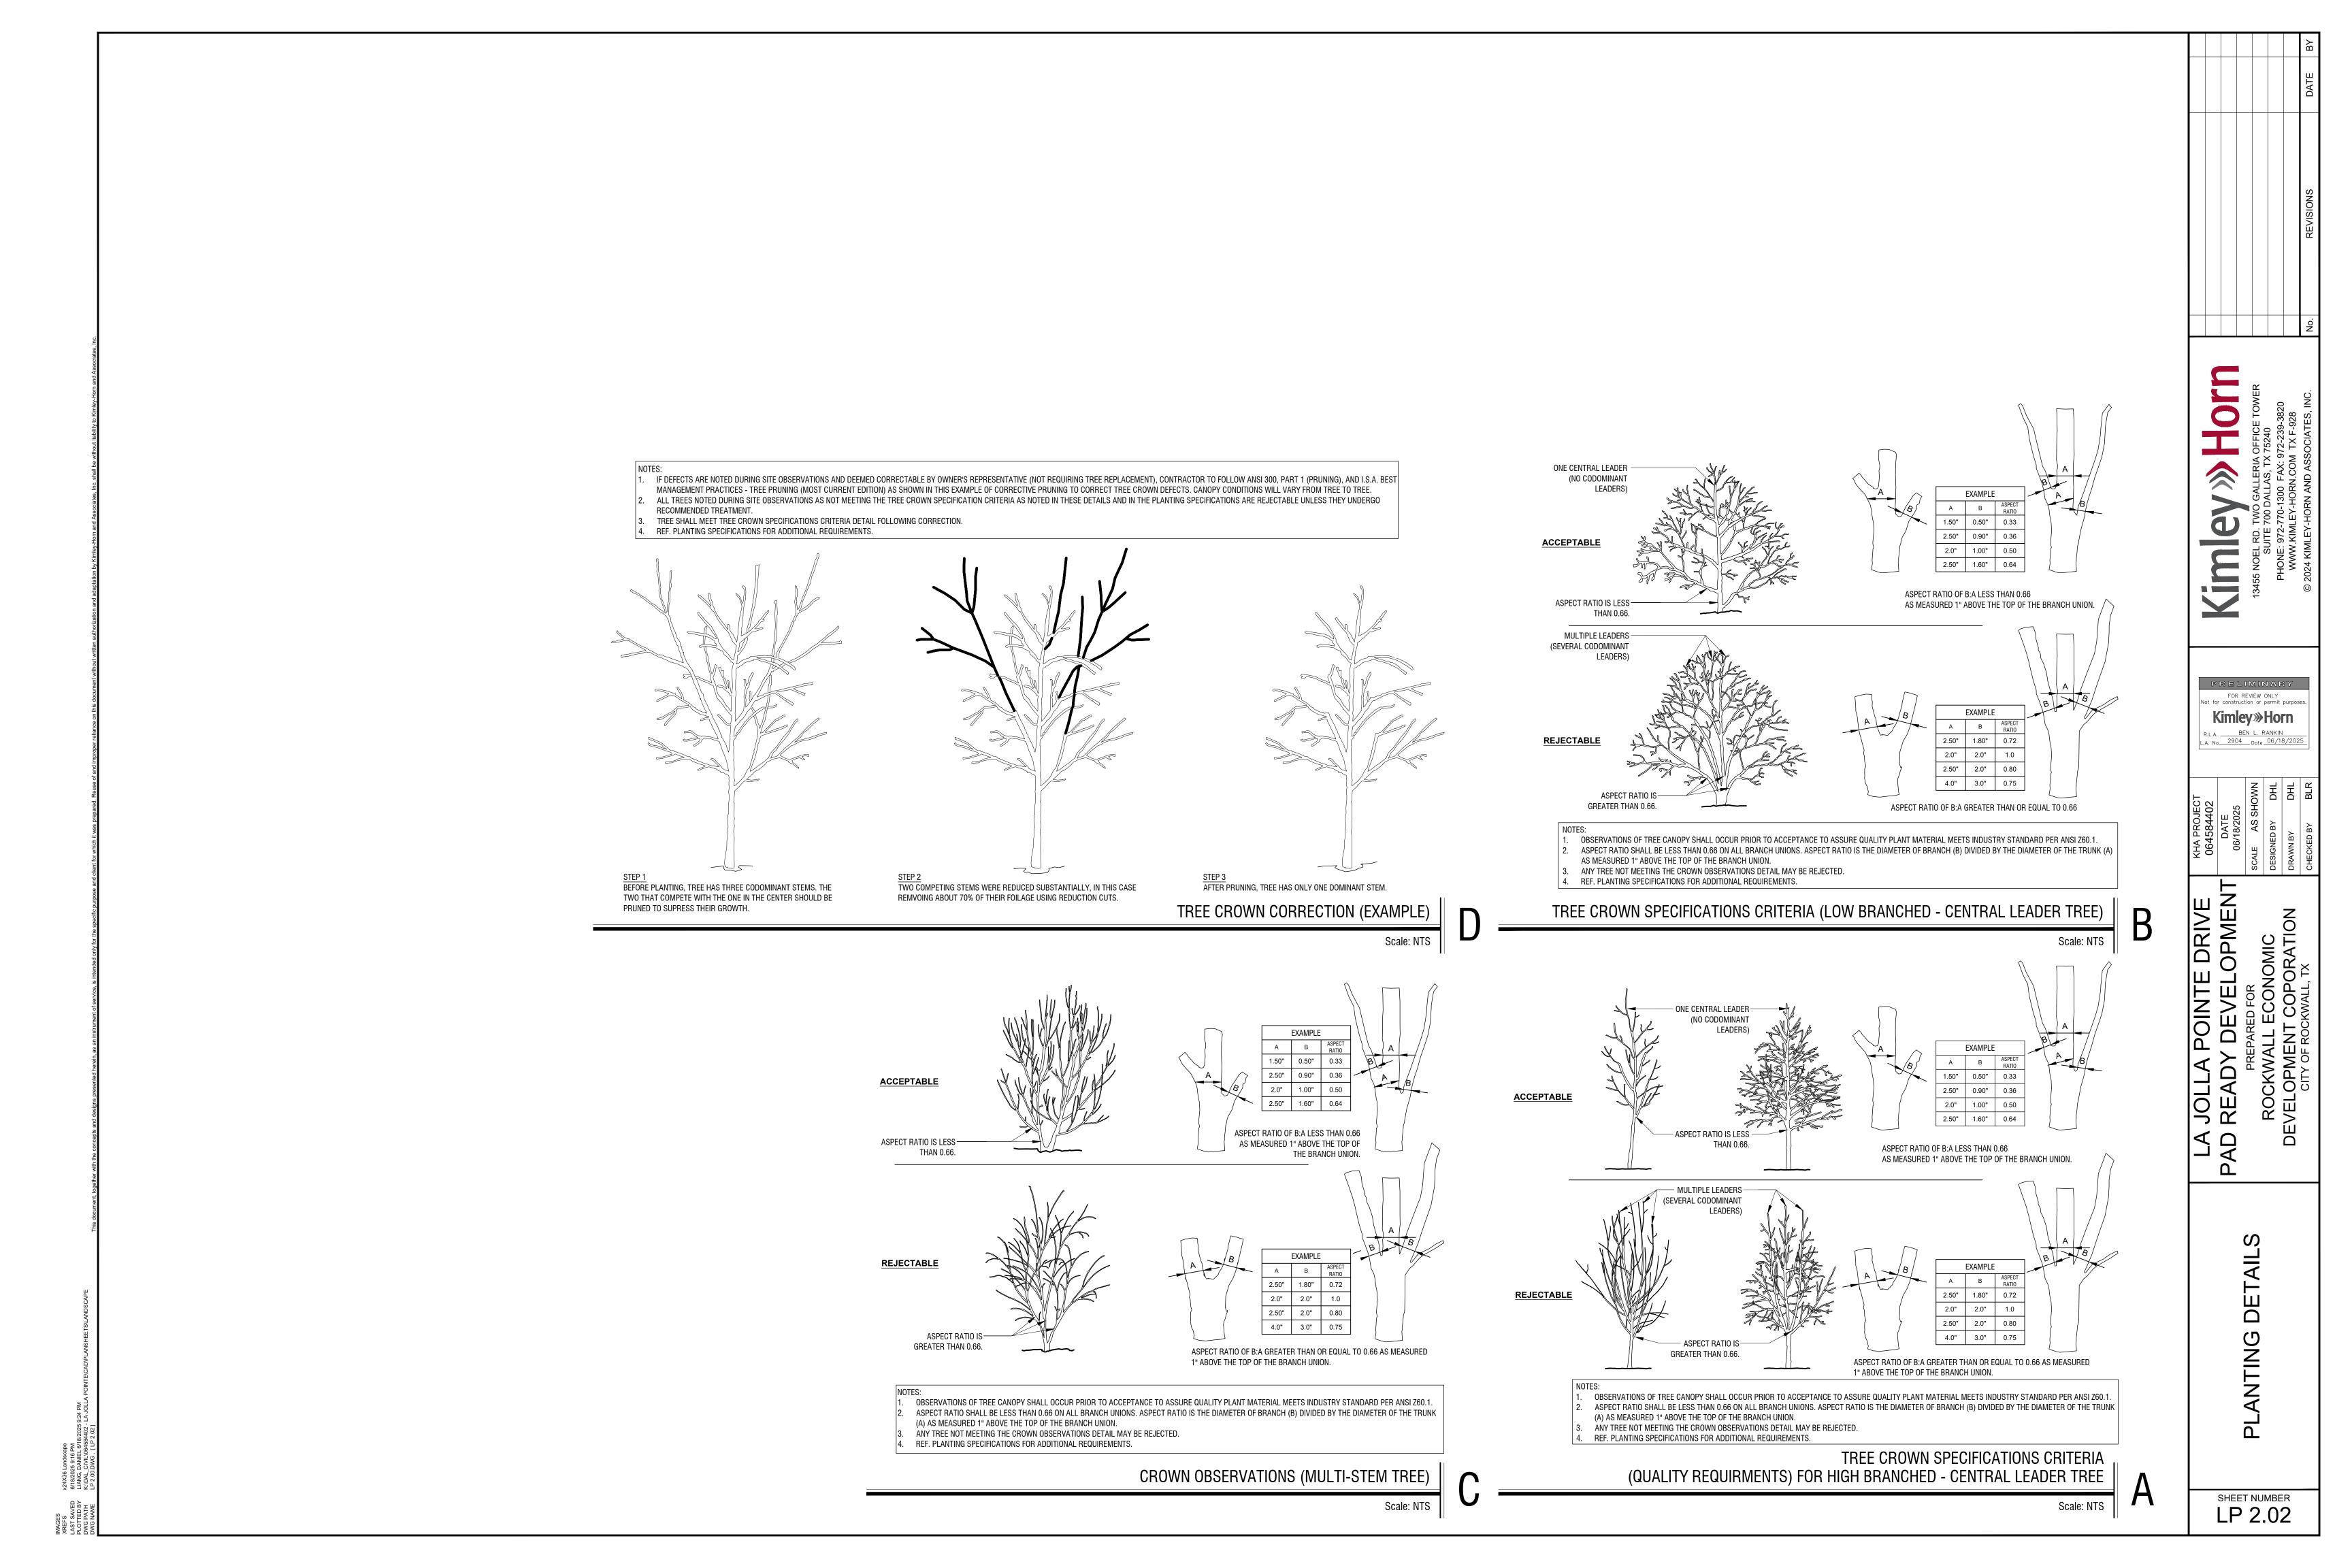



DATE: July 29, 2025

TO: Todd Martin, P.E.

Kimley-Horn & Associates 203 W. Nash Street, Suite 100

Terrell, TX 75160

CC: Shannon Foltz

Rockwall EDC

2610 Observation Trail, Suite 104

Rockwall, TX 75032

FROM: Henry Lee, Senior Planner

City of Rockwall Planning and Zoning Department

385 S. Goliad Street Rockwall, TX 75087

SUBJECT: SP2025-026; Amended Site Plan for La Jolla Pointe

Todd Martin, P.E.,

This letter serves to notify you that the above referenced case (*i.e.* Site Plan) that you submitted for consideration by the City of Rockwall was approved by the Planning and Zoning Commission on July 15, 2025. The following is a record of all recommendations, voting records:

Conditions of Approval:

- (1) All staff comments provided by the Planning, Engineering and Fire Department must be addressed prior to the submittal of engineering plans; and,
- (2) Any construction resulting from the approval of this Site Plan shall conform to the requirements set forth by the Unified Development Code (UDC), the International Building Code (IBC), the Rockwall Municipal Code of Ordinances, city adopted engineering and fire codes and with all other applicable regulatory requirements administered and/or enforced by the state and federal government.

Planning and Zoning Commission

On July 15, 2025, the Planning and Zoning Commission approved a motion to approve the treescape plan by a vote of 7-0.

Should you have any questions or concerns regarding your site plan case, please feel free to contact me at (972) 772-6434.

Sincerely

Henry Lee, AICP, Senior Planner

City of Rockwall Planning and Zoning Department