

PLANNING & ZONING CASE NO.

PLANNING & ZONING FEE

PLATTING APPLICATION

MASTER PLAT PRELIMINARY PLAT FINAL PLAT REPLAT

AMENDING OR MINOR PLAT PLAT REINSTATEMENT REQUEST

SITE PLAN APPLICATION

SITE PLAN

AMENDED SITE PLAN/ELEVATIONS/LANDSCAPING

ZONING APPLICATION

ZONING CHANGE SPECIFIC USE PERMIT PD DEVELOPMENT PLAN

OTHER APPLICATION

TREE REMOVAL

VARIANCE REQUEST/SPECIAL EXCEPTIONS

RECORD OF RECOMMENDATIONS, VOTING RECORDS, AND CONDITIONS OF APPROVAL

| ARCHITECTURE REVIEW BOARD | CITY COUNCIL READING #2 |
|--------------------------------|-------------------------|
| PLANNING AND ZONING COMMISSION | CONDITIONS OF APPROVAL |
| CITY COUNCIL READING #1 | NOTES |
| | |



DEVELOPMENT APPLICATION

City of Rockwall Planning and Zoning Department 385 S. Goliad Street Rockwall, Texas 75087

| PLANNING & ZONING CASE | NO. |
|------------------------|--|
| | NOT CONSIDERED ACCEPTED BY THE DIRECTOR AND CITY ENGINEER HAVE |
| DIRECTOR OF PLANNING: | |
| OTTY ENGINEED. | Description of the later of the |

My Comm. Exp. 01-06-2028

1/4/28

CITY ENGINEER: PLEASE CHECK THE APPROPRIATE BOX BELOW TO INDICATE THE TYPE OF DEVELOPMENT REQUEST [SELECT ONLY ONE BOX]: PLATTING APPLICATION FEES: ZONING APPLICATION FEES: ☐ ZONING CHANGE (\$200.00 + \$15.00 ACRE) 1 ■ MASTER PLAT (\$100.00 + \$15.00 ACRE) 1 ☐ SPECIFIC USE PERMIT (\$200.00 + \$15.00 ACRE) 1 & 2 □ PRELIMINARY PLAT (\$200.00 + \$15.00 ACRE)¹ ☐ PD DEVELOPMENT PLANS (\$200.00 + \$15.00 ACRE) ¹ ☐ FINAL PLAT (\$300.00 + \$20.00 ACRE) ¹ □ REPLAT (\$300.00 + \$20.00 ACRE) ¹ OTHER APPLICATION FEES: ☐ AMENDING OR MINOR PLAT (\$150.00) □ TREE REMOVAL (\$75.00) □ PLAT REINSTATEMENT REQUEST (\$100.00) □ VARIANCE REQUEST/SPECIAL EXCEPTIONS (\$100.00) ² SITE PLAN APPLICATION FEES: IN DETERMINING THE FEE, PLEASE USE THE EXACT ACREAGE WHEN MULTIPLYING BY THE PER ACRE AMOUNT. FOR REQUESTS ON LESS THAN ONE ACRE, ROUND UP TO ONE (1) ACRE.
R. A \$1,000.00 FEE WILL BE ADDED TO THE APPLICATION FEE FOR ANY REQUEST THAT ☐ SITE PLAN (\$250.00 + \$20.00 ACRE)

1 AMENDED SITE PLAN/ELEVATIONS/LANDSCAPING PLAN (\$100.00) INVOLVES CONSTRUCTION WITHOUT OR NOT IN COMPLIANCE TO AN APPROVED BUILDING PERMIT. PROPERTY INFORMATION [PLEASE PRINT] ADDRESS Northwest Corner of State Highway 276 & Corporate Crossing **BLOCK** A SUBDIVISION Rockwall Technology Park GENERAL LOCATION Northwest Corner of State Highway 276 & Corporate Crossing ZONING, SITE PLAN AND PLATTING INFORMATION [PLEASE PRINT] CURRENT USE Undeveloped CURRENT ZONING LI LI PROPOSED USE Office / Detention Pond PROPOSED ZONING 23.16 LOTS [CURRENT] 3 LOTS [PROPOSED] 3 ACREAGE SITE PLANS AND PLATS: BY CHECKING THIS BOX YOU ACKNOWLEDGE THAT DUE TO THE PASSAGE OF HB3167 THE CITY NO LONGER HAS FLEXIBILITY WITH REGARD TO ITS APPROVAL PROCESS, AND FAILURE TO ADDRESS ANY OF STAFF'S COMMENTS BY THE DATE PROVIDED ON THE DEVELOPMENT CALENDAR WILL RESULT IN THE DENIAL OF YOUR CASE. OWNER/APPLICANT/AGENT INFORMATION [PLEASE PRINT/CHECK THE PRIMARY CONTACT/ORIGINAL SIGNATURES ARE REQUIRED] ☑ OWNER Rockwall EDC ☑ APPLICANT Kimley-Horn CONTACT PERSON Todd Martin, P.E. CONTACT PERSON Shannon Foltz **ADDRESS** 203 West Nash Street ADDRESS 2610 Observation Trail Suite 104 Suite 100 CITY, STATE & ZIP Rockwall, TX 75032 Terrell, TX 75160 CITY, STATE & ZIP PHONE PHONE E-MAIL E-MAIL NOTARY VERIFICATION [REQUIRED] ACILINOV BEFORE ME, THE UNDERSIGNED AUTHORITY, ON THIS DAY PERSONALLY APPEARED (OWNER) THE UNDERSIGNED, WHO STATED THE INFORMATION ON THIS APPLICATION TO BE TRUE AND CERTIFIED THE FOLLOWING: 20.35 BY SIGNING THIS APPLICATION, I AGREE THAT THE CITY OF ROCKWALL (I.E. "CITY") IS AUTHORIZED AND PERMITTED TO PROVIDE INFORMATION CONTAINED WITHIN THIS APPLICATION TO THE PUBLIC. THE CITY IS ALSO AUTHORIZED AND PERMITTED TO REPRODUCE ANY COPYRIGHTED INFORMATION SUBMITTED IN CONJUNCTION WITH THIS APPLICATION, IF SUCH REPRODUCTION IS ASSOCIATED OR IN RESPONSE TO A REQUE JENNIFER L. HAMMONDS Notary Public, State of Texas GIVEN UNDER MY HAND AND SEAL OF OFFICE ON THIS THE ID#13230083-8

OWNER'S SIGNATURE

NOTARY PUBLIC IN AND FOR THE STATE OF TEXAS


LANDSCAPE CONSTRUCTION PLANS FOR

TECHNOLOGY PARK POND DESIGN AND ONSITE GRADING IMPROVEMENTS LOT 8, BLOCK A

AT THE
NORTHWEST CORNER OF SH 276 & CORPORATE CROSSING,
ROCKWALL COUNTY, TEXAS

PLANS SUBMITTAL/REVIEW LOG

| FIRST CITY SUBMITTAL -NOT FOR CONSTRUCTION | 10/09/2024 |
|---|------------|
| SECOND CITY SUBMITTAL -NOT FOR CONSTRUCTION | 03/28/2025 |
| THIRD CITY SUBMITTAL -NOT FOR CONSTRUCTION | 05/30/2025 |
| FOURTH CITY SUBMITTAL | 06/18/2025 |

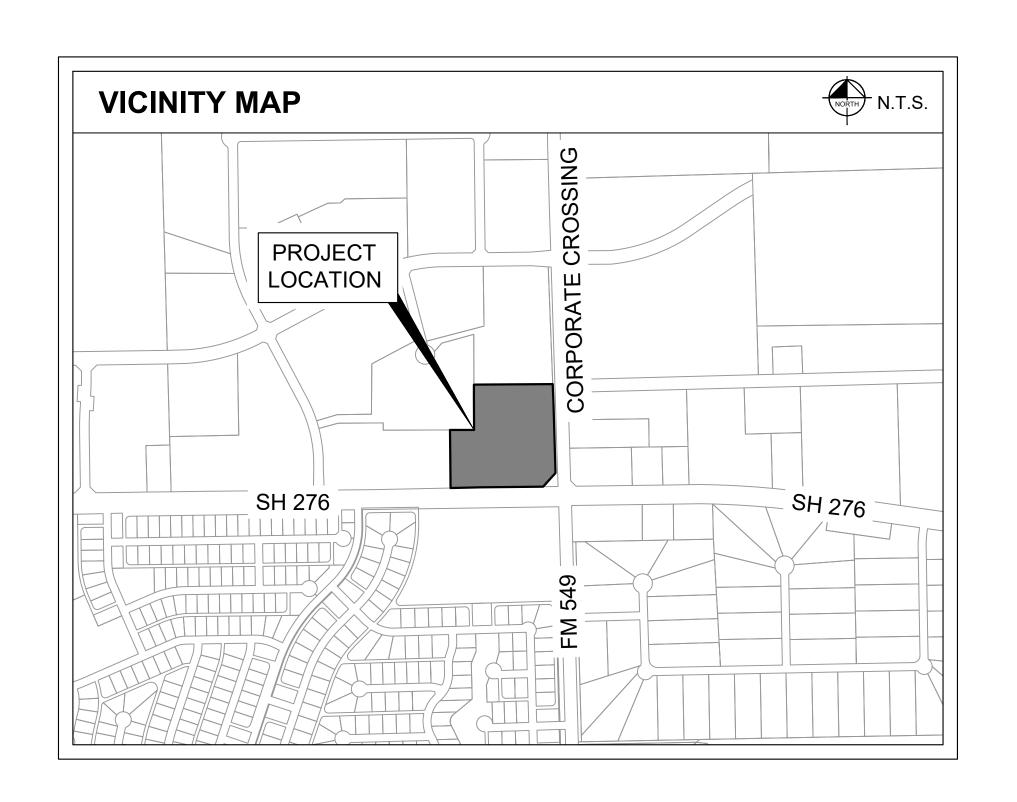

| LANDSCAPE SHEET LIST TABLE | | | | | |
|----------------------------|-----------------------------------|--|--|--|--|
| Sheet Number | Sheet Title | | | | |
| LC 0.00 | COVER SHEET | | | | |
| TP 0.00 | KEY MAP | | | | |
| TP 1.00 | TREE PRESERVATION & REMOVAL PLAN | | | | |
| TP 2.00 | TREE PRESERVATION DETAILS & NOTES | | | | |
| LP 0.00 | PLANTING SCHEDULE & NOTES | | | | |
| LP 1.00 | LANDSCAPE PLAN | | | | |
| LP 2.00 | PLANTING DETAILS | | | | |
| LP 2.01 | PLANTING DETAILS | | | | |
| LP 2.02 | PLANTING DETAILS | | | | |

OWNER

-NOT FOR CONSTRUCTION



ROCKWALL ECONOMIC

DEVELOPEMENT CORPORATION

2610 OBSERVATION TRAIL, SUITE 104

ROCKWALL, TX 75032

CONTACT: MATT WAVERING

Kimley» Horn

2500 PACIFIC AVENUE, SUITE 1100 DALLAS, TX 775226 PHONE: (972) 910 2925 CONTACT: BEN RANKIN, PLA ROCKWALL TECHNOLOGY PARK, BLOCK A, LOT 8

JUNE 2025

No. REVISIONS DATE

13455 NOEL RD. TWO GALLERIA OFFICE TOWER SUITE 700 DALLAS, TX 75240
PHONE: 972-770-1300 FAX: 972-239-3820
www.kimley-horn.com TX F-928
© 2024 KIMLEY-HORN AND ASSOCIATES, INC.

FOR REVIEW ONLY
Not for construction or permit purposes.


Kimley >>> Horn


Engineer BEN RANKIN
RLA No. 2904 Date 06/18/2025

DATE
06/18/2025
SCALE AS SHOWN
DESIGNED BY BLR
CHECKED BY BLR

POND
PREPARED FOR
ROCKWALL ECONOMIC
VELOPMENT CORPORATI

COVERSHEET

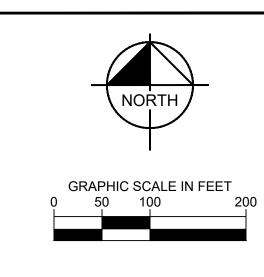

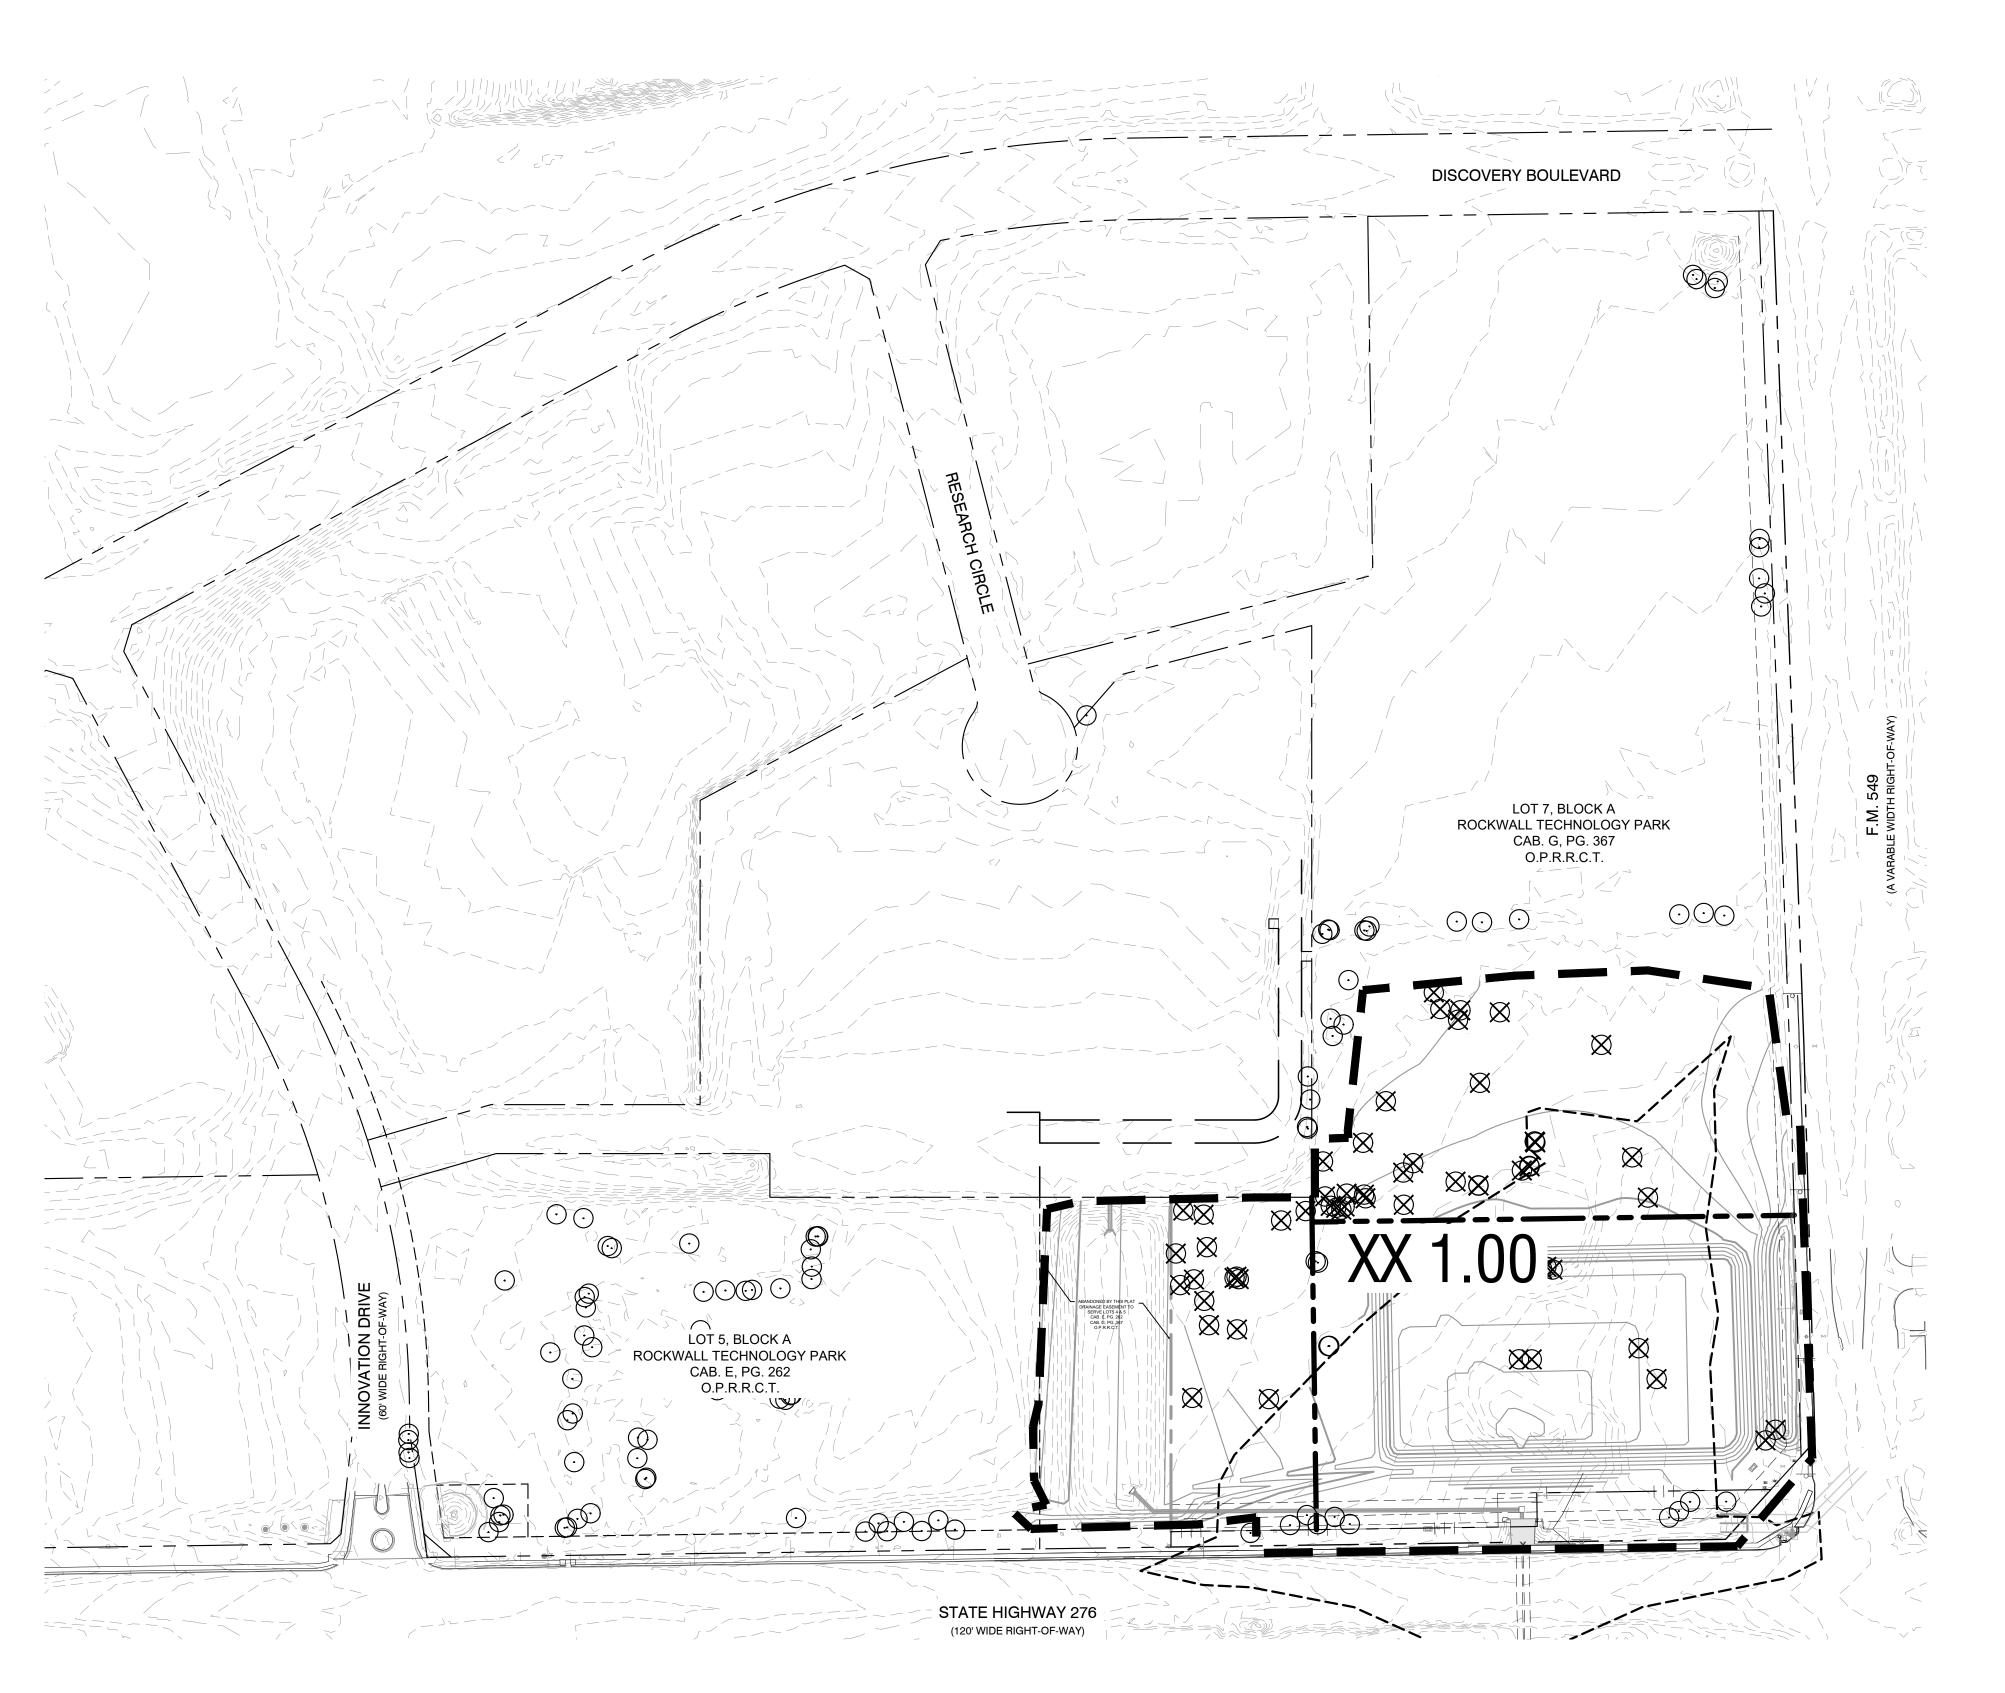


FOR REVIEW ONLY
Not for construction or permit purposes.

Kimley >>>> Horn Engineer BEN RANKIN
RLA No. 2904 Date 06/18/2025

KEY MAP

TP 0.00

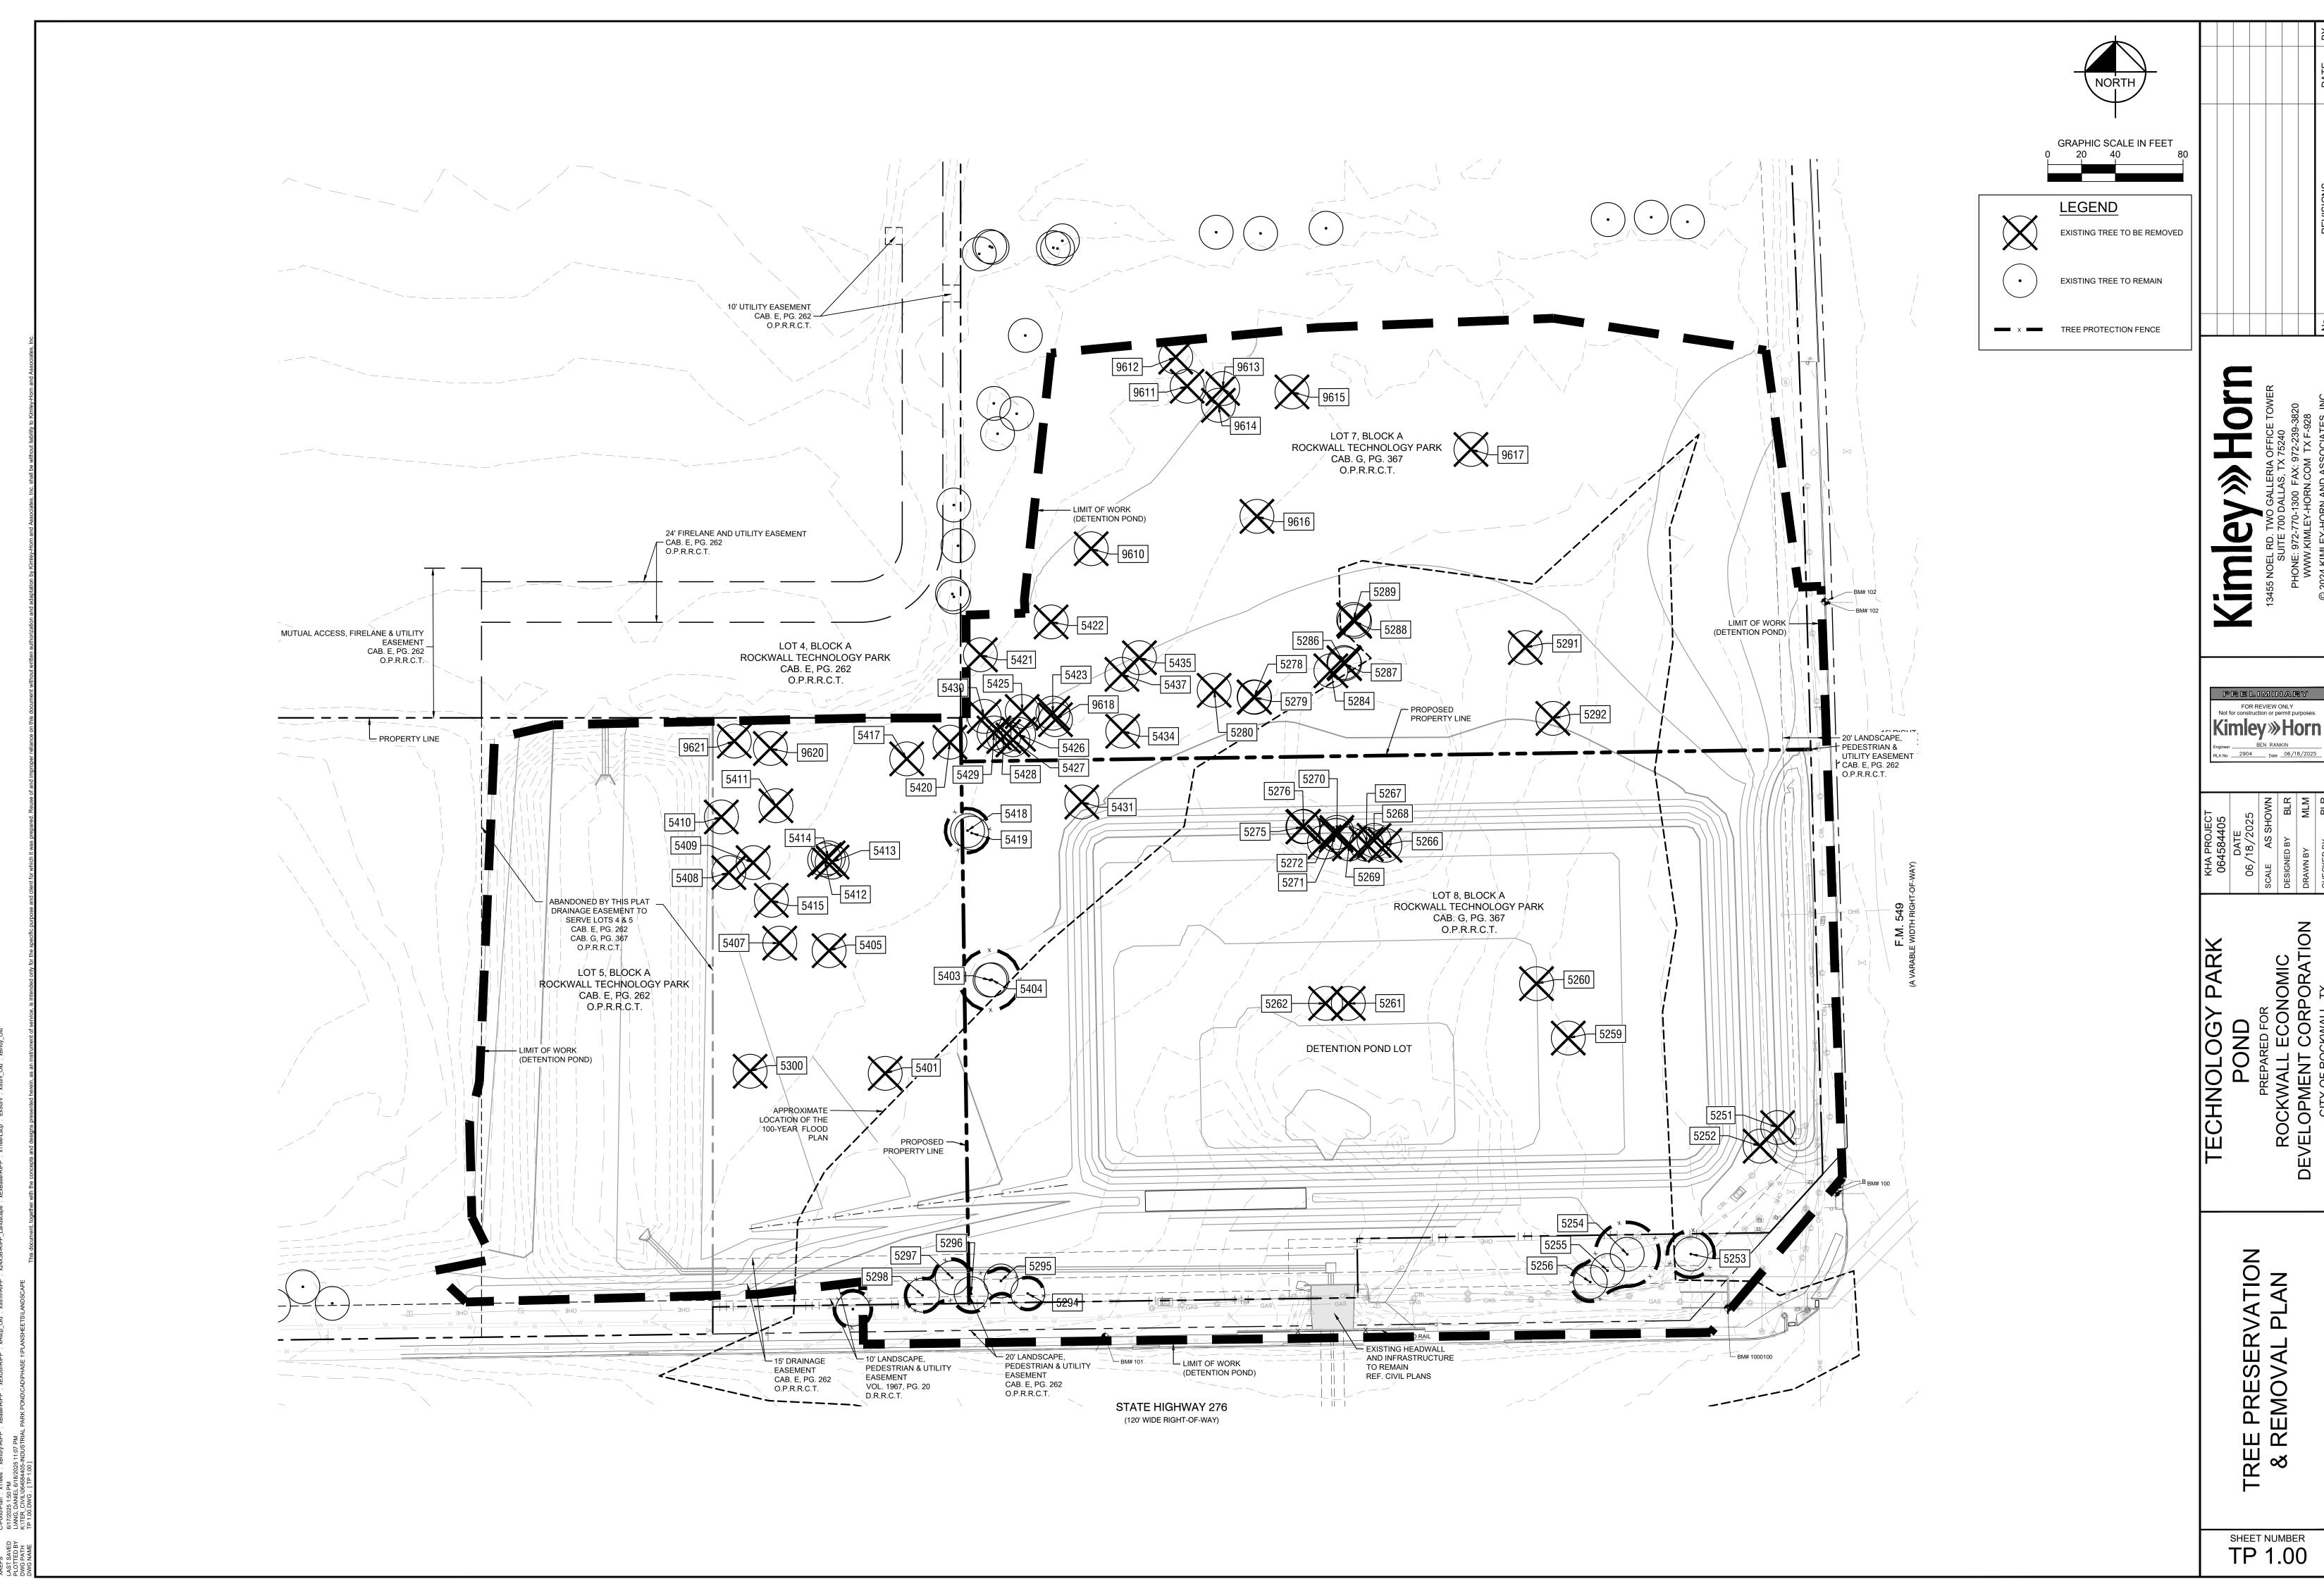

| TAG# | DBH | COMMON NAME | SCIENTIFIC NAME | CONDITION | MULTIPLE- STEMMED | TAG# | DBH | COMMON NAME | SCIENTIFIC NAME |
|--------------|----------------------|--------------------------------------|---|----------------------|----------------------|--------------|--------------|--------------------------------------|---|
| 5251 | 10.2 | live oak | Quercus virginiana | Healthy | Single | 9540 | 11.0 | hackberry | Celtis laevigata |
| 5252 5253 | 8.7 13.7 | live oak live oak | Quercus virginiana Quercus virginiana | Healthy Healthy | Single Single | 9541 9542 | 15.6 4.4 | hackberry Hercules-club | Celtis laevigata Zanthoxylum clava-he |
| 5254 | 18.9 | eastern redcedar | Juniperus virginiana | Healthy | Multi | 9543 | 5.8 | Hercules-club | Zanthoxylum clava-he |
| 5255 5256 | 11.8 11.4 | live oak live oak | Quercus virginiana Quercus virginiana | Healthy Healthy | Single Single | 9544 9545 | 12.8 4.7 | hackberry Hercules-club | Celtis laevigata Zanthoxylum clava-he |
| 3230 | 11.4 | | gs 5257-5258 were not used. | ricaltry | Sirigie | 9546 | 15.8 | hackberry | Celtis laevigata |
| 5259 5260 | 18.2 28.3 | Osage-orange | Maclura pomifera Maclura pomifera | Healthy | Multi Multi | 9547 9548 | 4.2 13.3 | Hercules-club hackberry | Zanthoxylum clava-he Celtis laevigata |
| 5261 | 11.6 | Osage-orange honey locust | Gleditsia triacanthos | Healthy Declining | Multi | 9549 | 15.2 | hackberry | Celtis laevigata |
| 5262 | 9.9 | Osage-orange | Maclura pomifera | Healthy | Multi | 9550 9551 | 14.4 11.6 | hackberry | Celtis laevigata Celtis laevigata |
| 5266 | 10.2 | black willow | gs 5263-5265 were not used. Salix nigra | Declining | Single | 9552 | 11.0 | hackberry hackberry | Celtis laevigata |
| 5267 | 13.0 | hackberry | Celtis laevigata | Healthy | Forked | 9553 | 11.7 | hackberry | Celtis laevigata |
| 5268 5269 | 13.1 15.3 | black willow eastern redcedar | Salix nigra Juniperus virginiana | Hazard Healthy | Single Multi | 9554 9555 | 13.9 14.9 | hackberry hackberry | Celtis laevigata Celtis laevigata |
| 5270 | 11.0 | black willow | Salix nigra | Declining | Single | 9556 | 11.6 | hackberry | Celtis laevigata |
| 5271 5272 | 18.8 7.2 | hackberry | Celtis laevigata | Healthy | Multi | 9557 9558 | 12.3 13.3 | hackberry hackberry | Celtis laevigata Celtis laevigata |
| 3212 | 1.2 | eastern redcedar | Juniperus virginiana gs 5273-5274 were not used. | Healthy | Single | 9559 | 30.6 | hackberry | Celtis laevigata |
| 5275 | 8.3 | eastern redcedar | Juniperus virginiana | Healthy | Multi | 9560 9561 | 16.1 14.8 | hackberry live oak | Celtis laevigata Quercus virginiai |
| 5276 | 6.8 | hackberry | Celtis laevigata | Healthy | Multi | 9562 | 12.1 | live oak | Quercus virginiai |
| 5278 | 9.1 | eastern redcedar | Tag 5277 was not used. Juniperus virginiana | Healthy | Multi | 9563 9564 | 9.6 11.2 | live oak live oak | Quercus virginiai Quercus virginiai |
| 5279 | 6.3 | hackberry | Celtis laevigata | Healthy | Single | 9565 | 11.9 | live oak | Quercus virginiai |
| 5280 | 6.2 | eastern redcedar | Juniperus virginiana gs 5281-5283 were not used. | Healthy | Single | 9566 | 11.7 11.3 | live oak | Quercus virginiai |
| 5284 | 7.4 | hackberry | Celtis laevigata | Healthy | Single | 9567 9568 | 20.1 | live oak hackberry | Quercus virginiai Celtis laevigata |
| 5200 | 0.5 | oactorn acttorness | Tag 5285 was not used. | Health | | 9569 | 13.8 | hackberry | Celtis laevigata |
| 5286 5287 | 9.5 8.1 | eastern cottonwood hackberry | Populus deltoides Celtis laevigata | Healthy Healthy | Single Single | 9570 9571 | 12.2 8.8 | hackberry chittamwood | Celtis laevigata Sideroxylon lanuging |
| 5288 | 20.3 | Osage-orange | Maclura pomifera | Healthy | Multi | 9572 | 13.6 | hackberry | Celtis laevigata |
| 5289 | 8.6 | Osage-orange | Maclura pomifera Tag 5290 was not used. | Healthy | Multi | 9573 | 12.2 | hackberry | Celtis laevigata |
| 5291 | 10.7 | honey locust | Gleditsia triacanthos | Declining | Multi | 9574 9575 | 11.9 11.8 | hackberry eastern redcedar | Celtis laevigata Juniperus virginia |
| 5292 | 14.6 | Osage-orange | Maclura pomifera | Healthy | Multi | 9576 | 14.1 | eastern redcedar | Juniperus virginia |
| 5294 | 8.5 | live oak | Tag 5293 was not used. Quercus virginiana | Healthy | Single | 9577 9578 | 11.6 11.2 | eastern redcedar eastern redcedar | Juniperus virginia Juniperus virginia |
| 5295 | 6.5 | live oak | Quercus virginiana | Healthy | Single | 9579 | 14.4 | eastern redcedar | Juniperus virginia |
| 5296 5297 | 9.9 | live oak live oak | Quercus virginiana Quercus virginiana | Healthy Healthy | Forked Single | 9580 9581 | 16.7 12.7 | eastern redcedar eastern redcedar | Juniperus virginia Juniperus virginia |
| 5298 | 9.0 | live oak | Quercus virginiana | Healthy | Single | 9582 | 12.1 | eastern redcedar | Juniperus virginia |
| 5200 l | 22.6 | Ocago orango | Tag 5299 was not used. | Doolining | NA. II+i | 9583 | 14.2 | eastern redcedar | Juniperus virginia |
| 5300 | 22.6 | Osage-orange Ta | Maclura pomifera gs 5301-5400 were not used. | Declining | Multi | 9584 9585 | 5.8 8.8 | Hercules-club live oak | Zanthoxylum clava-he Quercus virginiai |
| 5401 | 15.8 | Osage-orange | Maclura pomifera | Healthy | Forked | 9586 | 7.7 | live oak | Quercus virginiai |
| 5403 | 17.4 | Ocago orango | Tag 5402 was not used. Maclura pomifera | Healthy | Multi | 9587 9588 | 5.0 6.4 | live oak live oak | Quercus virginiai Quercus virginiai |
| 5404 | 7.5 | Osage-orange honey locust | Gleditsia triacanthos | Healthy | Single | 9589 | 7.7 | live oak | Quercus virginiai |
| 5405 | 16.3 | Osage-orange | Maclura pomifera | Healthy | Multi | 9590 | 12.7 | hackberry | Celtis laevigata |
| 5407 | 14.8 | Osage-orange | Tag 5406 was not used. Maclura pomifera | Healthy | Multi | 9591 9592 | 14.6 11.2 | hackberry hackberry | Celtis laevigata Celtis laevigata |
| 5408 | 22.9 | Osage-orange | Maclura pomifera | Healthy | Multi | 9593 | 14.3 | hackberry | Celtis laevigata |
| 5409 | 16.6 | eastern redcedar | Juniperus virginiana | Healthy | Multi | 9594 9595 | 12.2 13.9 | eastern redcedar hackberry | Juniperus virginia Celtis laevigata |
| 5410 5411 | 27.2 | Osage-orange Osage-orange | Maclura pomifera Maclura pomifera | Healthy Healthy | Multi Multi | 9596 | 8.1 | Hercules-club | Zanthoxylum clava-he |
| 5412 | 19.1 | Osage-orange | Maclura pomifera | Healthy | Multi | 9597 9598 | 8.4 16.3 | chittamwood hackberry | Sideroxylon lanugind Celtis laevigata |
| 5413 5414 | 8.0 10.9 | honey locust Osage-orange | Gleditsia triacanthos Maclura pomifera | Healthy Healthy | Single Multi | 9599 | 11.0 | hackberry | Celtis laevigata |
| 5415 | 9.0 | eastern redcedar | Juniperus virginiana | Healthy | Single | 9600 | 11.1 | hackberry eastern redcedar | Celtis laevigata |
| 5417 | 9.8 | eastern redcedar | Tag 5416 was not used. Juniperus virginiana | Hoolthy | Multi | 9601 9602 | 15.9 12.6 | eastern redcedar | Juniperus virginia Juniperus virginia |
| 5417 | 12.4 | eastern redcedar | Juniperus virginiana | Healthy Healthy | Multi | 9603 | 11.2 | eastern redcedar | Juniperus virginia |
| 5419 | 7.6 | eastern redcedar | Juniperus virginiana | Healthy | Single | 9604 9605 | 13.0 12.4 | eastern redcedar eastern redcedar | Juniperus virginia Juniperus virginia |
| 5420 5421 | 16.3 10.9 | Osage-orange eastern redcedar | Maclura pomifera Juniperus virginiana | Healthy Healthy | Multi Multi | 9606 | 11.1 | eastern redcedar | Juniperus virginia |
| 5422 | 18.9 | eastern redcedar | Juniperus virginiana | Healthy | Multi | 9607 | 12.3 | eastern redcedar | Juniperus virginia |
| 5423 | 8.6 | eastern redcedar | Juniperus virginiana | Healthy | Single | 9608 9609 | 16.3 11.9 | eastern redcedar eastern redcedar | Juniperus virginia Juniperus virginia |
| 5425 | 13.2 | Osage-orange | Tag 5424 was not used. Maclura pomifera | Healthy | Multi | 9610 | 15.2 | eastern redcedar | Juniperus virginia |
| 5426 | 8.0 | hackberry | Celtis laevigata | Healthy | Single | 9611 9612 | 13.8 11.2 | eastern redcedar eastern redcedar | Juniperus virginia Juniperus virginia |
| 5427 5428 | 12.8 7.8 | Osage-orange Osage-orange | Maclura pomifera Maclura pomifera | Healthy Healthy | Multi Single | 9613 | 11.5 | eastern redcedar | Juniperus virginia |
| 5429 | 6.7 | eastern redcedar | Juniperus virginiana | Healthy | Single | 9614 | 11.7 | eastern redcedar | Juniperus virginia |
| 5430 | 5.6 | eastern redcedar | Juniperus virginiana | Healthy | Single | 9615 9616 | 11.1 13.6 | eastern redcedar eastern redcedar | Juniperus virginia Juniperus virginia |
| 5431 | 14.8 | eastern redcedar Ta | Juniperus virginiana gs 5432-5433 were not used. | Healthy | Multi | 9617 | 12.6 | eastern redcedar | Juniperus virginia |
| 5434 | 17.3 | eastern redcedar | Juniperus virginiana | Healthy | Multi | 9618 9619 | 12.2 10.1 | eastern redcedar live oak | Juniperus virginia Quercus virginiai |
| 5435 | 10.6 | eastern redcedar | Juniperus virginiana Tag 5436 was not used. | Healthy | Forked | 9620 | 13.7 | eastern redcedar | Juniperus virginia |
| 5437 | 4.9 | eastern redcedar | Juniperus virginiana | Healthy | Single | 9621 9622 | 11.4 15.3 | eastern redcedar cedar elm | Juniperus virginia Ulmus crassifoli |
| 0540 | 0.0 | | gs 5438-9517 were not used. | 1 11 10 | N 16: | 9022 | 13.3 | cedar eim | Ollilus Classiloli |
| 9518 9519 | 6.3 7.2 | southern magnolia southern magnolia | | Healthy Healthy | Multi Forked | Visal | ov How | wood tag corios: F2F1 | E3E6, E3E0 E363, E366 E |
| 9520 | 7.1 | southern magnolia | Magnolia grandiflora | Healthy | Forked | | - | _ | -5256; 5259-5262; 5266-52 ; 5300; 5401; 5403-5405; 5 |
| 9521 9522 | 4.8 13.9 | southern magnolia eastern redcedar | Magnolia grandiflora Juniperus virginiana | Healthy Healthy | Single Multi | | | | Trees measuring 4-inche |
| 9522 | 4.7 | Hercules-club | Zanthoxylum clava-herculis | Declining | Single | 1 | | | - |
| 9524 | 11.2 | eastern redcedar | Juniperus virginiana | Healthy | Multi | | | | |
| 9525 9526 | 14.2 14.5 | eastern redcedar eastern redcedar | Juniperus virginiana Juniperus virginiana | Healthy Healthy | Single Forked | | | | |
| 9527 | 21.3 | eastern redcedar | Juniperus virginiana | Hazard | Forked | | | | |
| 9528 | 16.2 | hackberry | Celtis laevigata | Healthy | Multi | | | | |
| 9529 9530 | 23.2 | hackberry hackberry | Celtis laevigata Celtis laevigata | Healthy Healthy | Multi Forked | | | | |
| 9531 | 18.8 | hackberry | Celtis laevigata | Healthy | Forked | | | | |
| | 40.7 | hackberry | Celtis laevigata | Healthy | Multi | | | | |
| 9532 | 13.7 | • | | | Single | | | | |
| | 13.7 11.2 16.5 | hackberry hackberry | Celtis laevigata Celtis laevigata | Healthy Healthy | Single Multi | | | | |

Healthy Single
Healthy Single
Healthy Forked
Healthy Single

Celtis laevigata

Zanthoxylum clava-herculis

Zanthoxylum clava-herculis

Celtis laevigata

9536 14.6

hackberry Hercules-club

Hercules-club

hackberry

| | SCIENTIFIC NAME | CONDITION | MULTIPLE- STEMMED |
|---|---|--------------------|----------------------|
| | Celtis laevigata | Healthy | Multi |
| | Celtis laevigata | Healthy | Single |
| | Zanthoxylum clava-herculis | Healthy | Single |
| | Zanthoxylum clava-herculis | Healthy | Single |
| | Celtis laevigata Zanthoxylum clava-herculis | Healthy | Multi |
| | Celtis laevigata | Healthy Healthy | Single |
| | Zanthoxylum clava-herculis | Healthy | Single Single |
| | Celtis laevigata | Healthy | Forked |
| | Celtis laevigata | Healthy | Multi |
| | Celtis laevigata | Healthy | Multi |
| | Celtis laevigata | Healthy | Single |
| | Celtis laevigata | Healthy | Single |
| | Celtis laevigata | Healthy | Single |
| | Celtis laevigata | Healthy | Multi |
| | Celtis laevigata | Healthy | Multi |
| | Celtis laevigata | Declining | Single |
| | Celtis laevigata | Healthy | Forked |
| | Celtis laevigata | Declining | Single |
| | Celtis laevigata | Healthy | Multi |
| | Celtis laevigata | Healthy | Multi |
| | Quercus virginiana | Healthy | Single |
| | Quercus virginiana | Healthy | Single |
| | Quercus virginiana | Healthy | Single |
| | Quercus virginiana | Healthy | Single |
| | Quercus virginiana | Healthy | Single |
| | Quercus virginiana | Healthy | Single |
| | Quercus virginiana | Healthy | Single |
| | Celtis laevigata | Healthy | Forked |
| | Celtis laevigata | Healthy | Multi |
| | Celtis laevigata | Healthy | Forked |
| | Sideroxylon lanuginosum | Declining | Single |
| | Celtis laevigata | Healthy | Single |
| | Celtis laevigata | Healthy | Single |
| | Celtis laevigata Juniperus virginiana | Healthy | Multi Multi |
| _ | Juniperus virginiana Juniperus virginiana | Healthy Healthy | Multi |
| | Juniperus virginiana Juniperus virginiana | Healthy | Multi |
| | Juniperus virginiana | Healthy | Multi |
| | Juniperus virginiana | Healthy | Multi |
| _ | Juniperus virginiana | Healthy | Forked |
| _ | Juniperus virginiana | Healthy | Single |
| | Juniperus virginiana | Healthy | Multi |
| _ | Juniperus virginiana | Declining | Multi |
| | Zanthoxylum clava-herculis | Healthy | Single |
| _ | Quercus virginiana | Healthy | Single |
| _ | Quercus virginiana | Healthy | Single |
| _ | Quercus virginiana | Healthy | Single |
| _ | Quercus virginiana | Healthy | Single |
| _ | Quercus virginiana | Healthy | Single |
| _ | Celtis laevigata | Healthy | Multi |
| _ | Celtis laevigata | Healthy | Multi |
| _ | Celtis laevigata | Healthy | Single |
| _ | Celtis laevigata | Healthy | Forked |
| _ | Juniperus virginiana | Healthy | Single |
| _ | Celtis laevigata | Healthy | Multi |
| | Zanthoxylum clava-herculis | Healthy | Single |
| _ | Sideroxylon lanuginosum | Healthy | Single |
| _ | Celtis laevigata | Healthy | Multi |
| _ | Celtis laevigata | Healthy | Single |
| _ | Celtis laevigata | Healthy | Multi |
| | Juniperus virginiana | Healthy | Multi |
| _ | Juniperus virginiana | Healthy | Multi |
| | Juniperus virginiana | Healthy | Forked |
| _ | Juniperus virginiana | Healthy | Forked |
| _ | Juniperus virginiana | Healthy | Multi |
| _ | Juniperus virginiana | Healthy | Single |
| _ | Juniperus virginiana | Healthy | Forked |
| | Juniperus virginiana | Healthy | Multi |
| | Juniperus virginiana | Healthy | Multi |
| _ | Juniperus virginiana | Healthy | Multi |
| _ | Juniperus virginiana | Healthy | Forked |
| _ | Juniperus virginiana | Healthy | Multi |
| | Juniperus virginiana | Healthy | Multi |
| _ | Juniperus virginiana | Healthy | Multi |
| _ | Juniperus virginiana | Healthy | Multi |
| _ | Juniperus virginiana | Healthy | Forked |
| _ | Juniperus virginiana | Healthy | Multi |
| | Landard many a family flower | Llaaltlav | N A 14: |
| | Juniperus virginiana | Healthy | Multi |

-5272; 5275-5276; 5278-5280; 5284; ; 5407-5415; 5417-5423; 5425-5431; nes and larger DBH were tagg

Healthy Multi
Healthy Single
Healthy Multi
Healthy Single
Healthy Forked

| DETENTION POND LOT (LOT 8) | | | | | | | |
|----------------------------|-----------------------|-------------------|---------------------|---------------|------------------|----------------------|---------------------------|
| Tree Types | | | | TREES REMOVED | | | |
| COMMON NAME | SCIENTIFIC NAME | PRIMARY PROTECTED | SECONDARY PROTECTED | QTY. | CALIPER (Inches) | 8' HEIGHT OR GREATER | MITIGATION INCHES REMOVED |
| BLACK WILLOW | SALIX NIGRA | Х | | 3 | 34.3 | | 34.3 |
| EASTERN REDCEDAR | JUNIPERUS VIRGINIANA | | X | 3 | | 1 | 4 |
| HACKBERRY | CELTIS LAEVIGATA | | | 3 | 38.6 | | |
| HONEY LOCUST | GLEDITSIA TRIACANTHOS | | | 1 | 11.6 | | |
| LIVE OAK | QUERCUS VIRGINIANA | Х | | 2 | 18.9 | | 18.9 |
| OSAGE-ORANGE | MACLURA POMIFERA | | | 3 | 56.4 | | |
| | | | | | | | |
| | | | | | | | |
| | To | | | | | 1 | 57.2 |

| LOT 5 | | | | | | | |
|------------------|-----------------------|-------------------|---------------------|------|------------------|----------------------|---------------------------|
| Tree Types | | | | | | TREES REMOVED | |
| COMMON NAME | SCIENTIFIC NAME | PRIMARY PROTECTED | SECONDARY PROTECTED | QTY. | CALIPER (Inches) | 8' HEIGHT OR GREATER | MITIGATION INCHES REMOVED |
| EASTERN REDCEDAR | JUNIPERUS VIRGINIANA | | X | 5 | | 3 | 12 |
| HONEY LOCUST | GLEDITSIA TRIACANTHOS | | | 1 | 8 | | |
| OSAGE-ORANGE | MACLURA POMIFERA | | | 10 | 186.1 | | |
| | | | | | | | |
| | | | | | | | |
| Total | | | | | 194.1 | 3 | 12 |

| | LOT 7 | | | | | | | |
|--------------------|-----------------------|-------------------|---------------------|------|------------------|----------------------|---------------------------|--|
| Tree Types | | | | | | TREES REMOVED | | |
| COMMON NAME | SCIENTIFIC NAME | PRIMARY PROTECTED | SECONDARY PROTECTED | QTY. | CALIPER (Inches) | 8' HEIGHT OR GREATER | MITIGATION INCHES REMOVED | |
| EASTERN REDCEDAR | JUNIPERUS VIRGINIANA | | Х | 28 | | 21 | 84 | |
| EASTERN COTTONWOOD | POPULUS DELTOIDES | | | 1 | 9.5 | | | |
| HACKBERRY | CELTIS LAEVIGATA | | | 4 | 29.8 | | | |
| HONEY LOCUST | GLEDITSIA TRIACANTHOS | | | 1 | 10.7 | | | |
| OSAGE-ORANGE | MACLURA POMIFERA | | | 6 | 77.3 | | | |
| | | | | | | | | |
| | | | | | | | | |
| | Tota | | | | | 21 | 84 | |

Total Mitigation Inches Removed

Total Inches Provided

Total Excess

-153.2


+390

-236.8

TREE REMOVAL NOTES:

- A. REMOVE ALL TREES INDICATED BY THE DRAWINGS AND SPECIFICATIONS, AS REQUIRING REMOVAL, IN A MANNER THAT WILL NOT DAMAGE ADJACENT TREES OR STRUCTURES OR COMPACTS THE SOIL.
- B. REMOVE TREES THAT ARE ADJACENT TO TREES OR STRUCTURES TO REMAIN, IN SECTIONS, TO LIMIT THE OPPORTUNITY OF DAMAGE TO ADJACENT CROWNS, TRUNKS, GROUND PLANE ELEMENTS AND
- C. DO NOT DROP TREES WITH A SINGLE CUT UNLESS THE TREE WILL FALL IN AN AREA NOT INCLUDED IN THE TREE PROTECTION AREA.
- D. NO TREE TO BE REMOVED WITHIN 50 FEET OF OR INSIDE THE TREE PROTECTION AREA SHALL BE PUSHED OVER OR UP-ROOTED USING A PIECE OF GRADING EQUIPMENT. NO HEAVY EQUIPMENT IS ALLOWED INSIDE THE TREE PROTECTION AREA.
- E. PROTECT ADJACENT PAVING, SOIL, TREES, SHRUBS, GROUND COVER PLANTINGS AND UNDERSTORY PLANTS TO REMAIN FROM DAMAGE DURING ALL TREE REMOVAL OPERATIONS, AND FROM CONSTRUCTION OPERATIONS. PROTECTION SHALL INCLUDE THE ROOT SYSTEM, TRUNK, LIMBS, AND CROWN FROM BREAKAGE OR SCARRING, AND THE SOIL FROM COMPACTION.
- F. REMOVE STUMPS AND IMMEDIATE ROOT PLATE FROM EXISTING TREES TO BE REMOVED. GRIND TRUNK BASES AND LARGE BUTTRESS ROOTS TO A DEPTH OF THE LARGEST BUTTRESS ROOT OR AT LEAST 18 INCHES BELOW THE TOP MOST ROOTS WHICHEVER IS LESS AND OVER THE AREA OF THREE TIMES THE DIAMETER OF THE TRUNK (DBH).
- F.A. FOR TREES WHERE THE STUMP WILL FALL UNDER NEW PAVED AREAS, GRIND ROOTS TO A TOTAL DEPTH OF 18 INCHES BELOW THE EXISTING GRADE. IF THE SIDES OF THE STUMP HOLE STILL HAVE GREATER THAN APPROXIMATELY 20% WOOD VISIBLE, CONTINUE GRINDING OPERATION DEEPER AND OR WIDER UNTIL THE RESULTING HOLE HAS LESS THAN 20% WOOD. REMOVE ALL WOOD CHIPS PRODUCED BY THE GRINDING OPERATION AND BACK FILL IN 8 INCH LAYERS WITH CONTROLLED FILL OF A QUALITY ACCEPTABLE TO THE SITE ENGINEER FOR FILL MATERIAL UNDER STRUCTURES, COMPACTED TO 95% OF THE MAXIMUM DRY DENSITY STANDARD PROCTOR. THE OWNER'S REPRESENTATIVE SHALL APPROVE EACH HOLE AT THE END OF THE GRINDING OPERATION.
- F.B. IN AREAS WHERE THE TREE LOCATION IS TO BE A PLANTING BED OR LAWN, REMOVE ALL WOODCHIPS AND BACKFILL STUMP HOLES WITH PLANTING SOIL AS DEFINED IN SPECIFICATION SECTION PLANTING SOIL, IN MAXIMUM OF 12 INCH LAYERS AND COMPACT TO 80 - 85% OF THE MAXIMUM DRY DENSITY STANDARD PROCTOR.



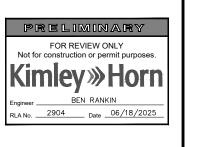

PREPARED FOR


ROCKWALL ECONOMIC


DEVELOPMENT CORPORATIC

ESERVATION S & NOTES TREE PRES


SHEET NUMBER TP 2.00


Scale: NTS

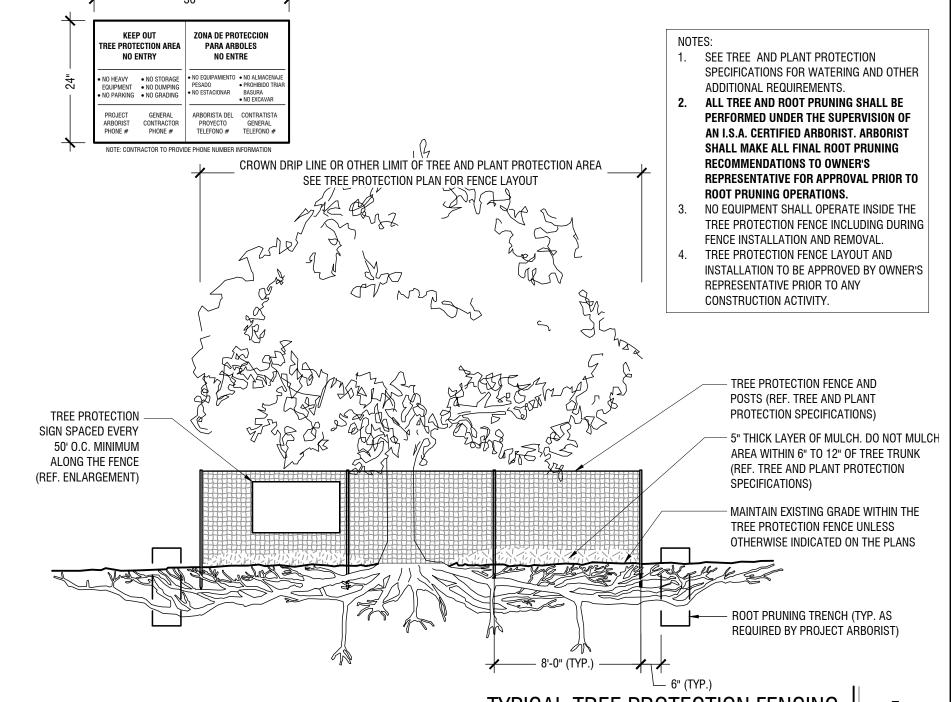


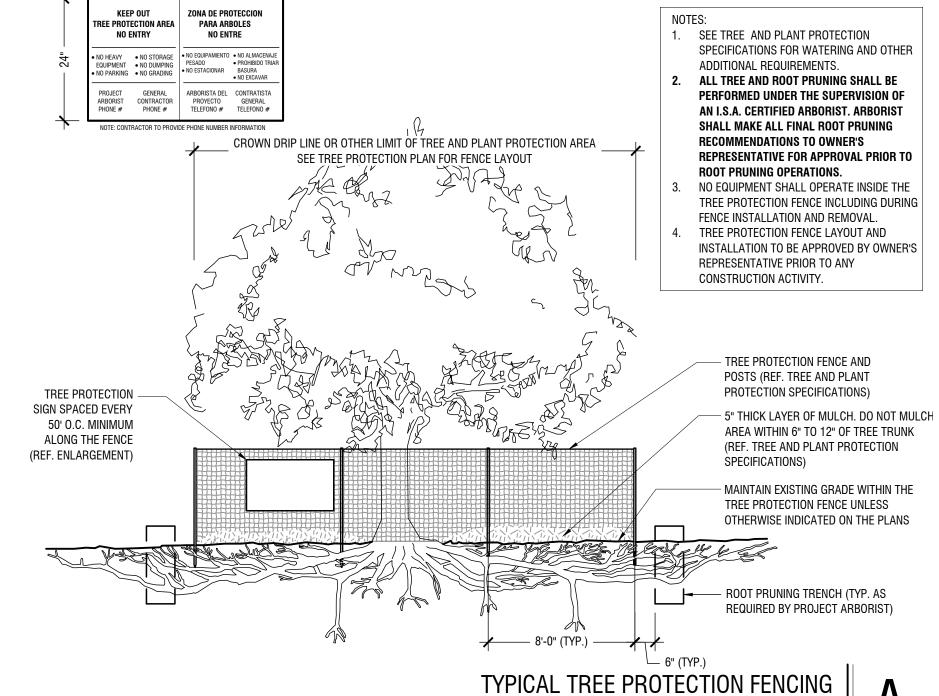

| PLANTING NOTES: | PLANTING SCHEDULE: | | | | | |
|--|--|----------------------------|-------------------------|--------------------------|--|---|
| 1. CONTRACTOR SHALL BE RESPONSIBLE FOR VERIFYING THE LOCATIONS OF ALL UNDERGROUND UTILITIES, PIPES, STRUCTURES, AND LINE RUNS IN THE FIELD PRIOR TO THE INSTALLATION OF ANY PLANT MATERIAL. | DETENTION POND LOT | | | | | |
| IT IS THE RESPONSIBILITY OF THE CONTRACTOR TO ADVISE THE LANDSCAPE ARCHITECT OF ANY CONDITION FOUND ON SITE WHICH PERMITS INSTALLATION AS SHOWN ON THESE DRAWINGS. ALL PLANT MATERIAL SHALL BE MAINTAINED IN A HEALTHY, GROWING CONDITION AND MUST BE REPLACED WITHIN 30 DAYS WITH PLANT MATERIAL OF THE SAME VARIETY AND SIZE IF DAMAGED, DESTROYED, OR REMOVED. | SYMBOL CODE QTY BOTANICAL / COMMON NAME TREES UP 4 ULMUS PARVIFOLIA SEMPERVIRENDS `ATHENA` / ATHENA LACEBARK ELM | <u>R00T</u> // B & B | CAL. SIZE 4" CAI 12" | REMARKS 14` HT STRONG (| | |
| CONTRACTOR SHALL BE RESPONSIBLE FOR FINE GRADING AND REMOVAL OF DEBRIS PRIOR TO PLANTING IN ALL AREAS. FINAL FINISH GRADING SHALL BE REVIEWED AND APPROVED BY THE LANDSCAPE ARCHITECT. THE CONTRACTOR SHALL BE RESPONSIBLE FOR ANY ADDITIONAL TOPSOIL REQUIRED TO CREATE A SMOOTH CONDITION PRIOR TO PLANTING. CONTRACTOR SHALL VERIFY ALL PLANT QUANTITIES. ALL PLANT QUANTITIES ARE LISTED FOR INFORMATION PURPOSES ONLY. IT IS THE | TD 6 TAXODIUM DISTICHUM / BALD CYPRESS | B & B | | | STRAIGHT CENTRAL LEADER, FULL AND MATCHING | |
| CONTRACTOR'S RESPONSIBILITY TO PROVIDE FULL COVERAGE IN ALL PLANTING AREAS AS SHOWN ON THE PLANS AND SPECIFIED IN THE PLANT SCHEDULE. 7. CONTRACTOR TO PROVIDE STEEL EDGING BETWEEN ALL PLANTING BEDS AND TURF AREAS UNLESS OTHERWISE INDICATED ON THE DRAWINGS. | QM 8 QUERCUS MACROCARPA / BUR OAK | B & B | 4" CAL. 12`- | 4` HT. STRONG, | CENTRAL LEADER, FULL | |
| 8. ALL PLANT MATERIAL SHALL CONFORM TO THE SPECIFICATIONS GIVEN IN THE PLANT SCHEDULE, PLANTING DETAILS, AND PLANTING SPECIFICATIONS. 9. ALL PLANT MATERIAL SHALL MEET INDUSTRY STANDARDS AS INDICATED IN THE CURRENT EDITION OF THE AMERICAN STANDARD FOR NURSERY STOCK (ANSI Z60.1). | QC 6 QUERCUS MUEHLENBERGII / CHINKAPIN OAK | B & B | 4" CAL. 16` | 18` HT. SINGLE S | STRAIGHT CENTRAL LEADER, FULL AND MATCHING | |
| 10. ALL PLANT MATERIAL SUBSTITUTIONS SHALL BE APPROVED BY LANDSCAPE ARCHITECT PRIOR TO PURCHASE.11. CONTRACTOR IS RESPONSIBLE FOR ALL COORDINATION WITH OTHER CONTRACTORS ON SITE AS REQUIRED TO ACCOMPLISH ALL PLANTING OPERATIONS. | CL 23 CHILOPSIS LINEARIS / DESERT WILLOW JE 44 JUNIPERUS VIRGINIANA / EASTERN RED CEDAR | CONT. B & B | 2" CAL. 8`-1 | | STRAIGHT CENTRAL LEADER, FULL AND MATCHING STRAIGHT CENTAL LEADER, FULL AND MATCHING | |
| 12. ALL PLANTING AREAS SHALL RECEIVE SOIL AMENDMENTS. 13. PLANT MATERIAL SHALL BE PRUNED PER PLANTING DETAILS UNLESS OTHERWISE NOTED ON DRAWINGS. 14. PLANTING AREAS SHALL BE KEPT FREE OF TRASH, WEEDS, DEBRIS, AND DEAD PLANT MATERIAL. | QS 5 QUERCUS SHUMARDII / SHUMARD RED OAK | В & В | | | STRAIGHT CENTAL LEADER, FOLL AND MATCHING | DWER 20 |
| 15. ALL LIME STABILIZED SOIL AND INORGANIC SELECT FILL FOR BUILDING OR PAVING CONSTRUCTION SHALL BE REMOVED FROM ALL PLANTING BEDS TO A MINIMUM DEPTH OF 24" UNLESS OTHERWISE NOTED. REPLACE MATERIAL REMOVED WITH IMPORTED TOPSOIL. 16. TREES OVERHANGING PEDESTRIAN WALKS AND WITHIN VISIBILITY TRIANGLES AS NOTED ON THE PLANS SHALL BE LIMBED TO A HEIGHT OF SEVEN FEET (7'). TREE OVERHANGING PUBLIC STREETS AND FIRELANES SHALL BE LIMBED TO A HEIGHT OF FOURTEEN FEET (14'). | CC 26 CERCIS CANADENSIS `TEXENSIS` / TEXAS REDBUD | CONT. | 2" CAL. 8`-1 |)` HT. SINGLE S | STEM, FULL | OFFICE TO 75240 372-239-382 1 TX F-928 20 2145 2 1 |
| 17. TREES PLANTED NEXT TO ACCESSIBLE ROUTES AND ACCESSIBLE AREAS SHALL BE LIMBED TO 7'6" (80" MIN.) AFF. 18. ALL PROPOSED TREES SHALL BE STAKED WITH AN AT-GRADE ROOT BALL SECURING SYSTEM AS SHOWN IN THE PLANTING DETAILS AND SPECIFICATIONS. NO ABOVE-GROUND STAKING SYSTEMS, GUY WIRES/WIRES, HOSES, STRAPS, POSTS (METAL OR WOOD) SHALL BE ALLOWED | SYMBOL CODE QTY BOTANICAL / COMMON NAME SHRUBS | CONT. | <u>SIZE</u> <u>SPAC</u> | ING REMARKS | <u>S</u> | GALLERIA DALLAS, TX 1300 FAX: 9 HORN.COM |
| UNLESS AUTHORIZED IN WRITING BY THE LANDSCAPE ARCHITECT. | LC 51 LOROPETALUM CHINENSE / LOROPETALUM LF 49 LEUCOPHYLLUM FRUTESCENS / TEXAS SAGE | 5 GAL. MIN. 5 GAL. MIN. | 36" HT. 60" (| | D MATCHING D MATCHING | EL RD. TWO SUITE 700 E E: 972-770-7 W.KIMLEY-I |
| | | | | | | 13455 NOEL S PHONE WWW |
| | | | | | | Y |
| | | | | | | PRELIMINARY FOR REVIEW ONLY |
| | | | | | | Not for construction or permit purposes. Kimley >>> Horn Engineer BEN RANKIN RIA No. 2904 Date 06/18/2025 |
| | | | | | | KHA PROJECT 064584405 DATE 06/18/2025 SCALE AS SHOWN DESIGNED BY BLR DRAWN BY MLM |
| | | | | | | TECHNOLOGY PARK POND PREPARED FOR ROCKWALL ECONOMIC EVELOPMENT CORPORATION |
| | | | | | | TECHI ROCK DEVELOPI |
| | | | | | | SCHEDULE |
| | | | | | | PLANTING S & NO |
| | | | | | | SHEET NUMBER |

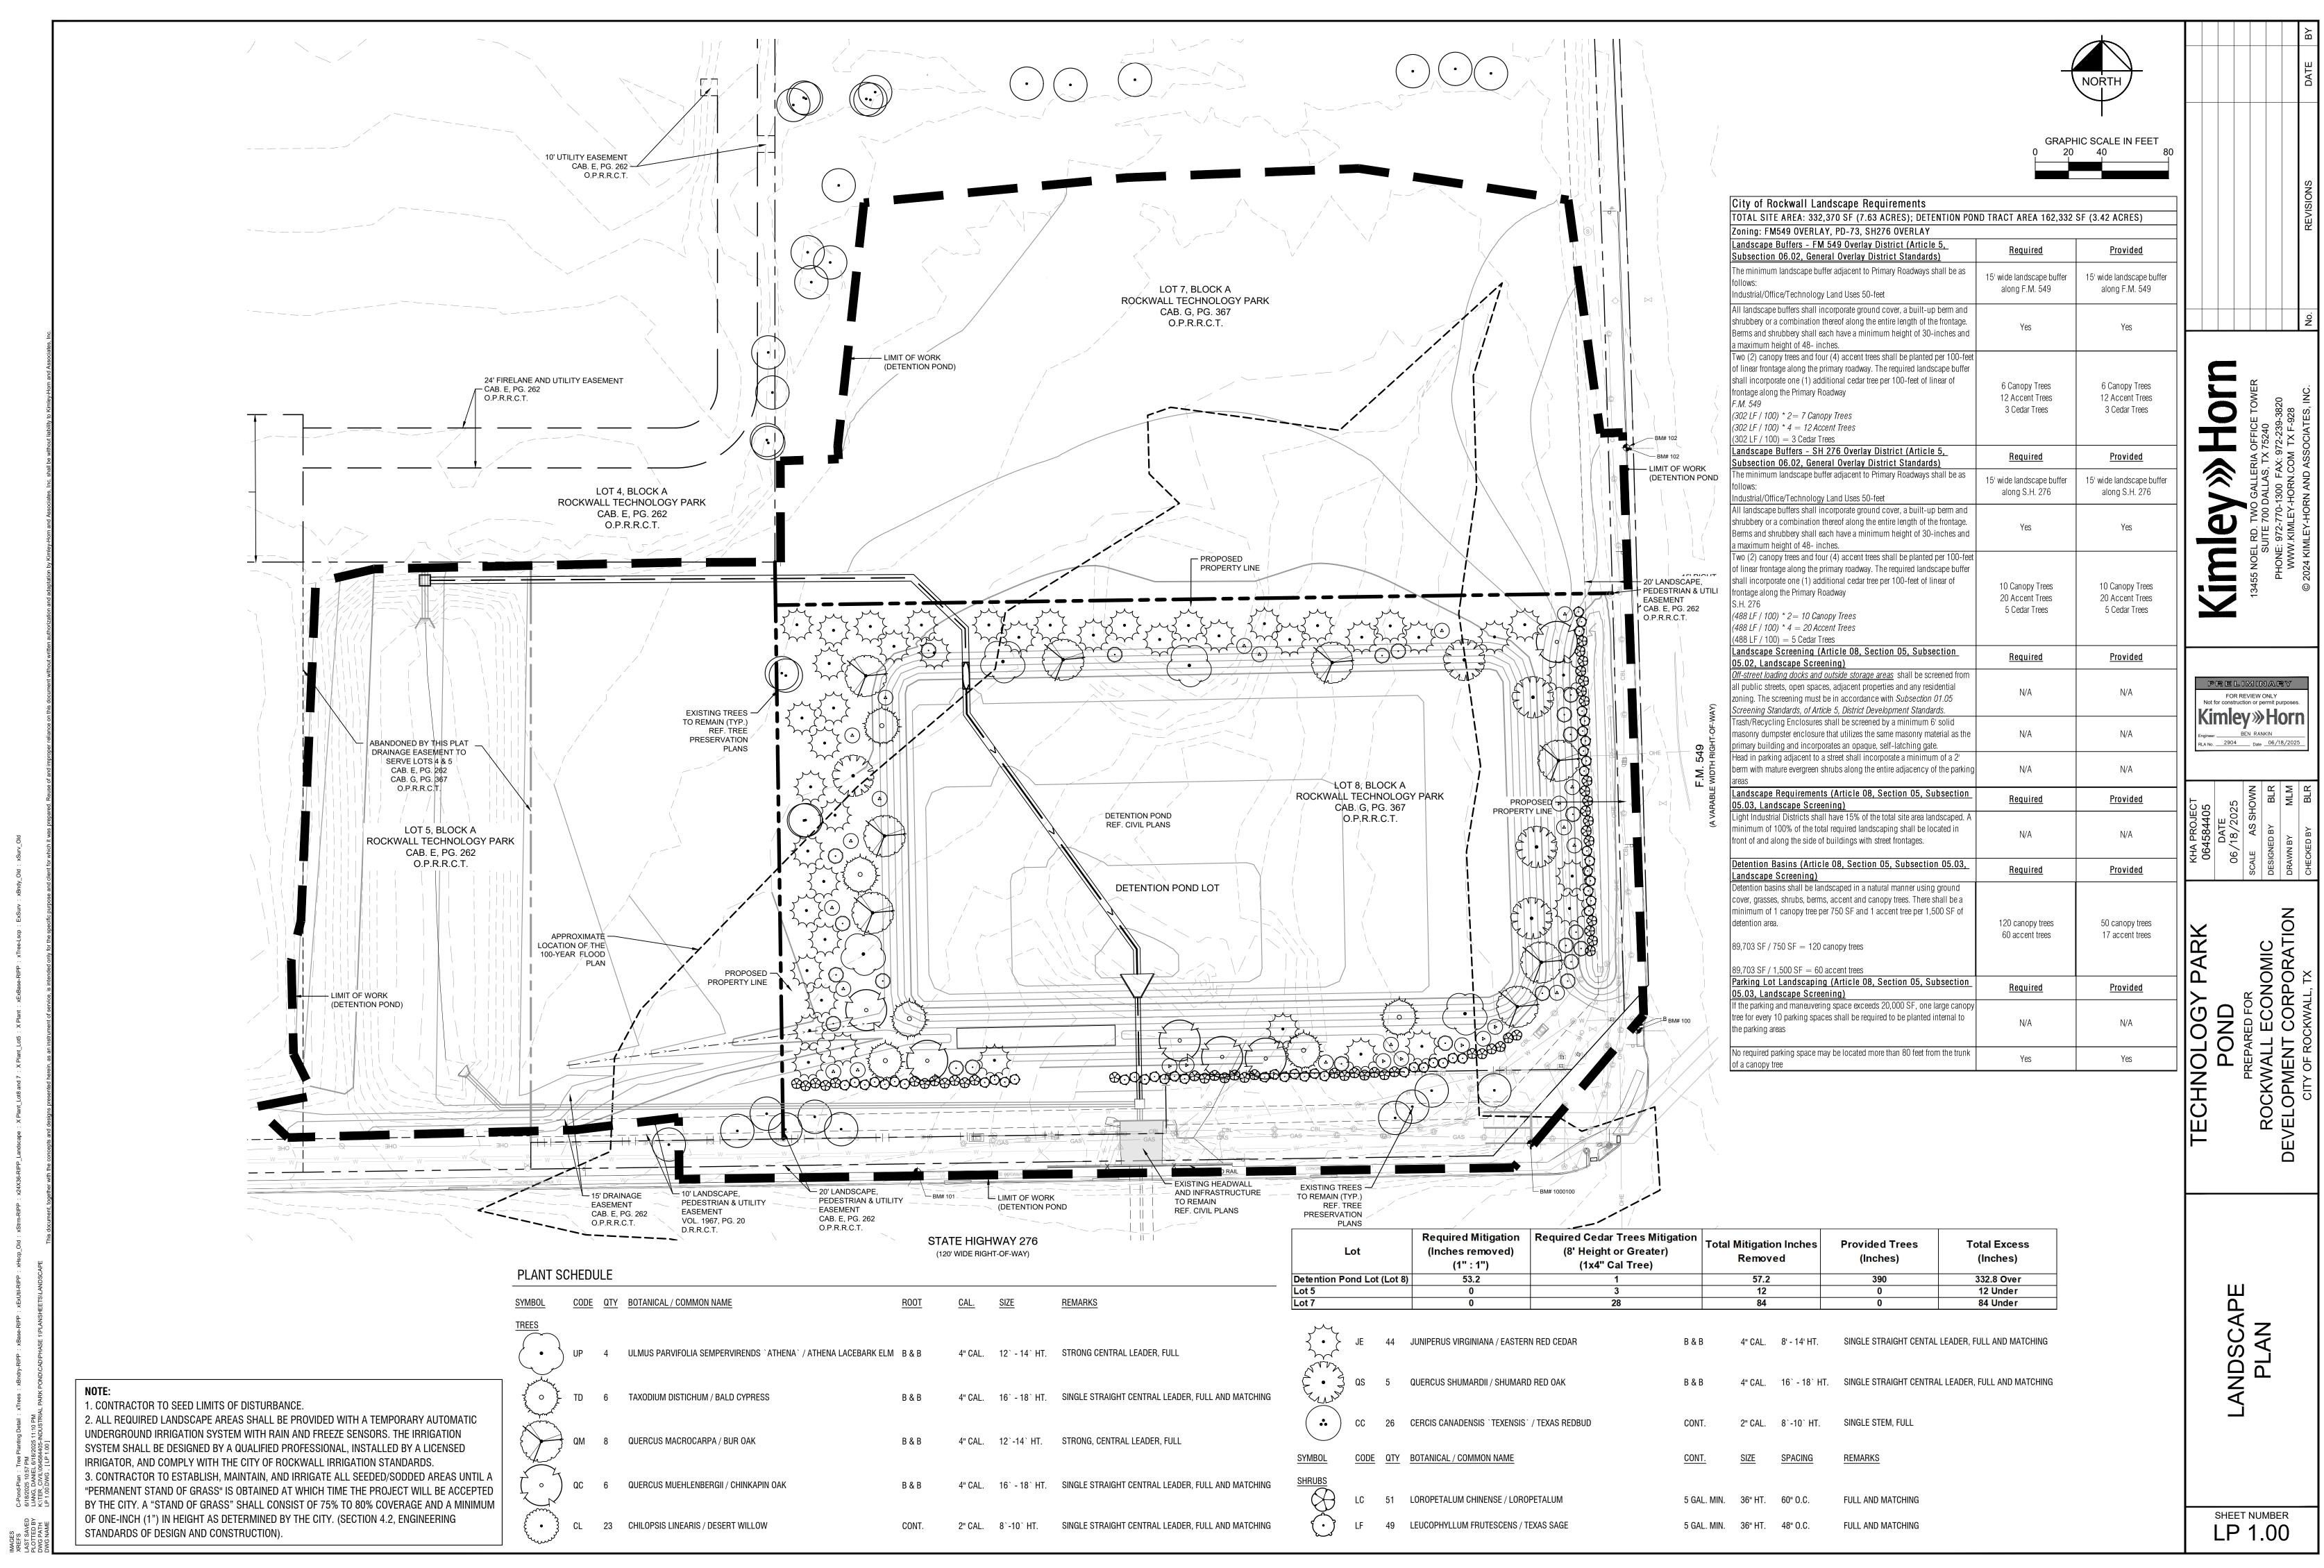

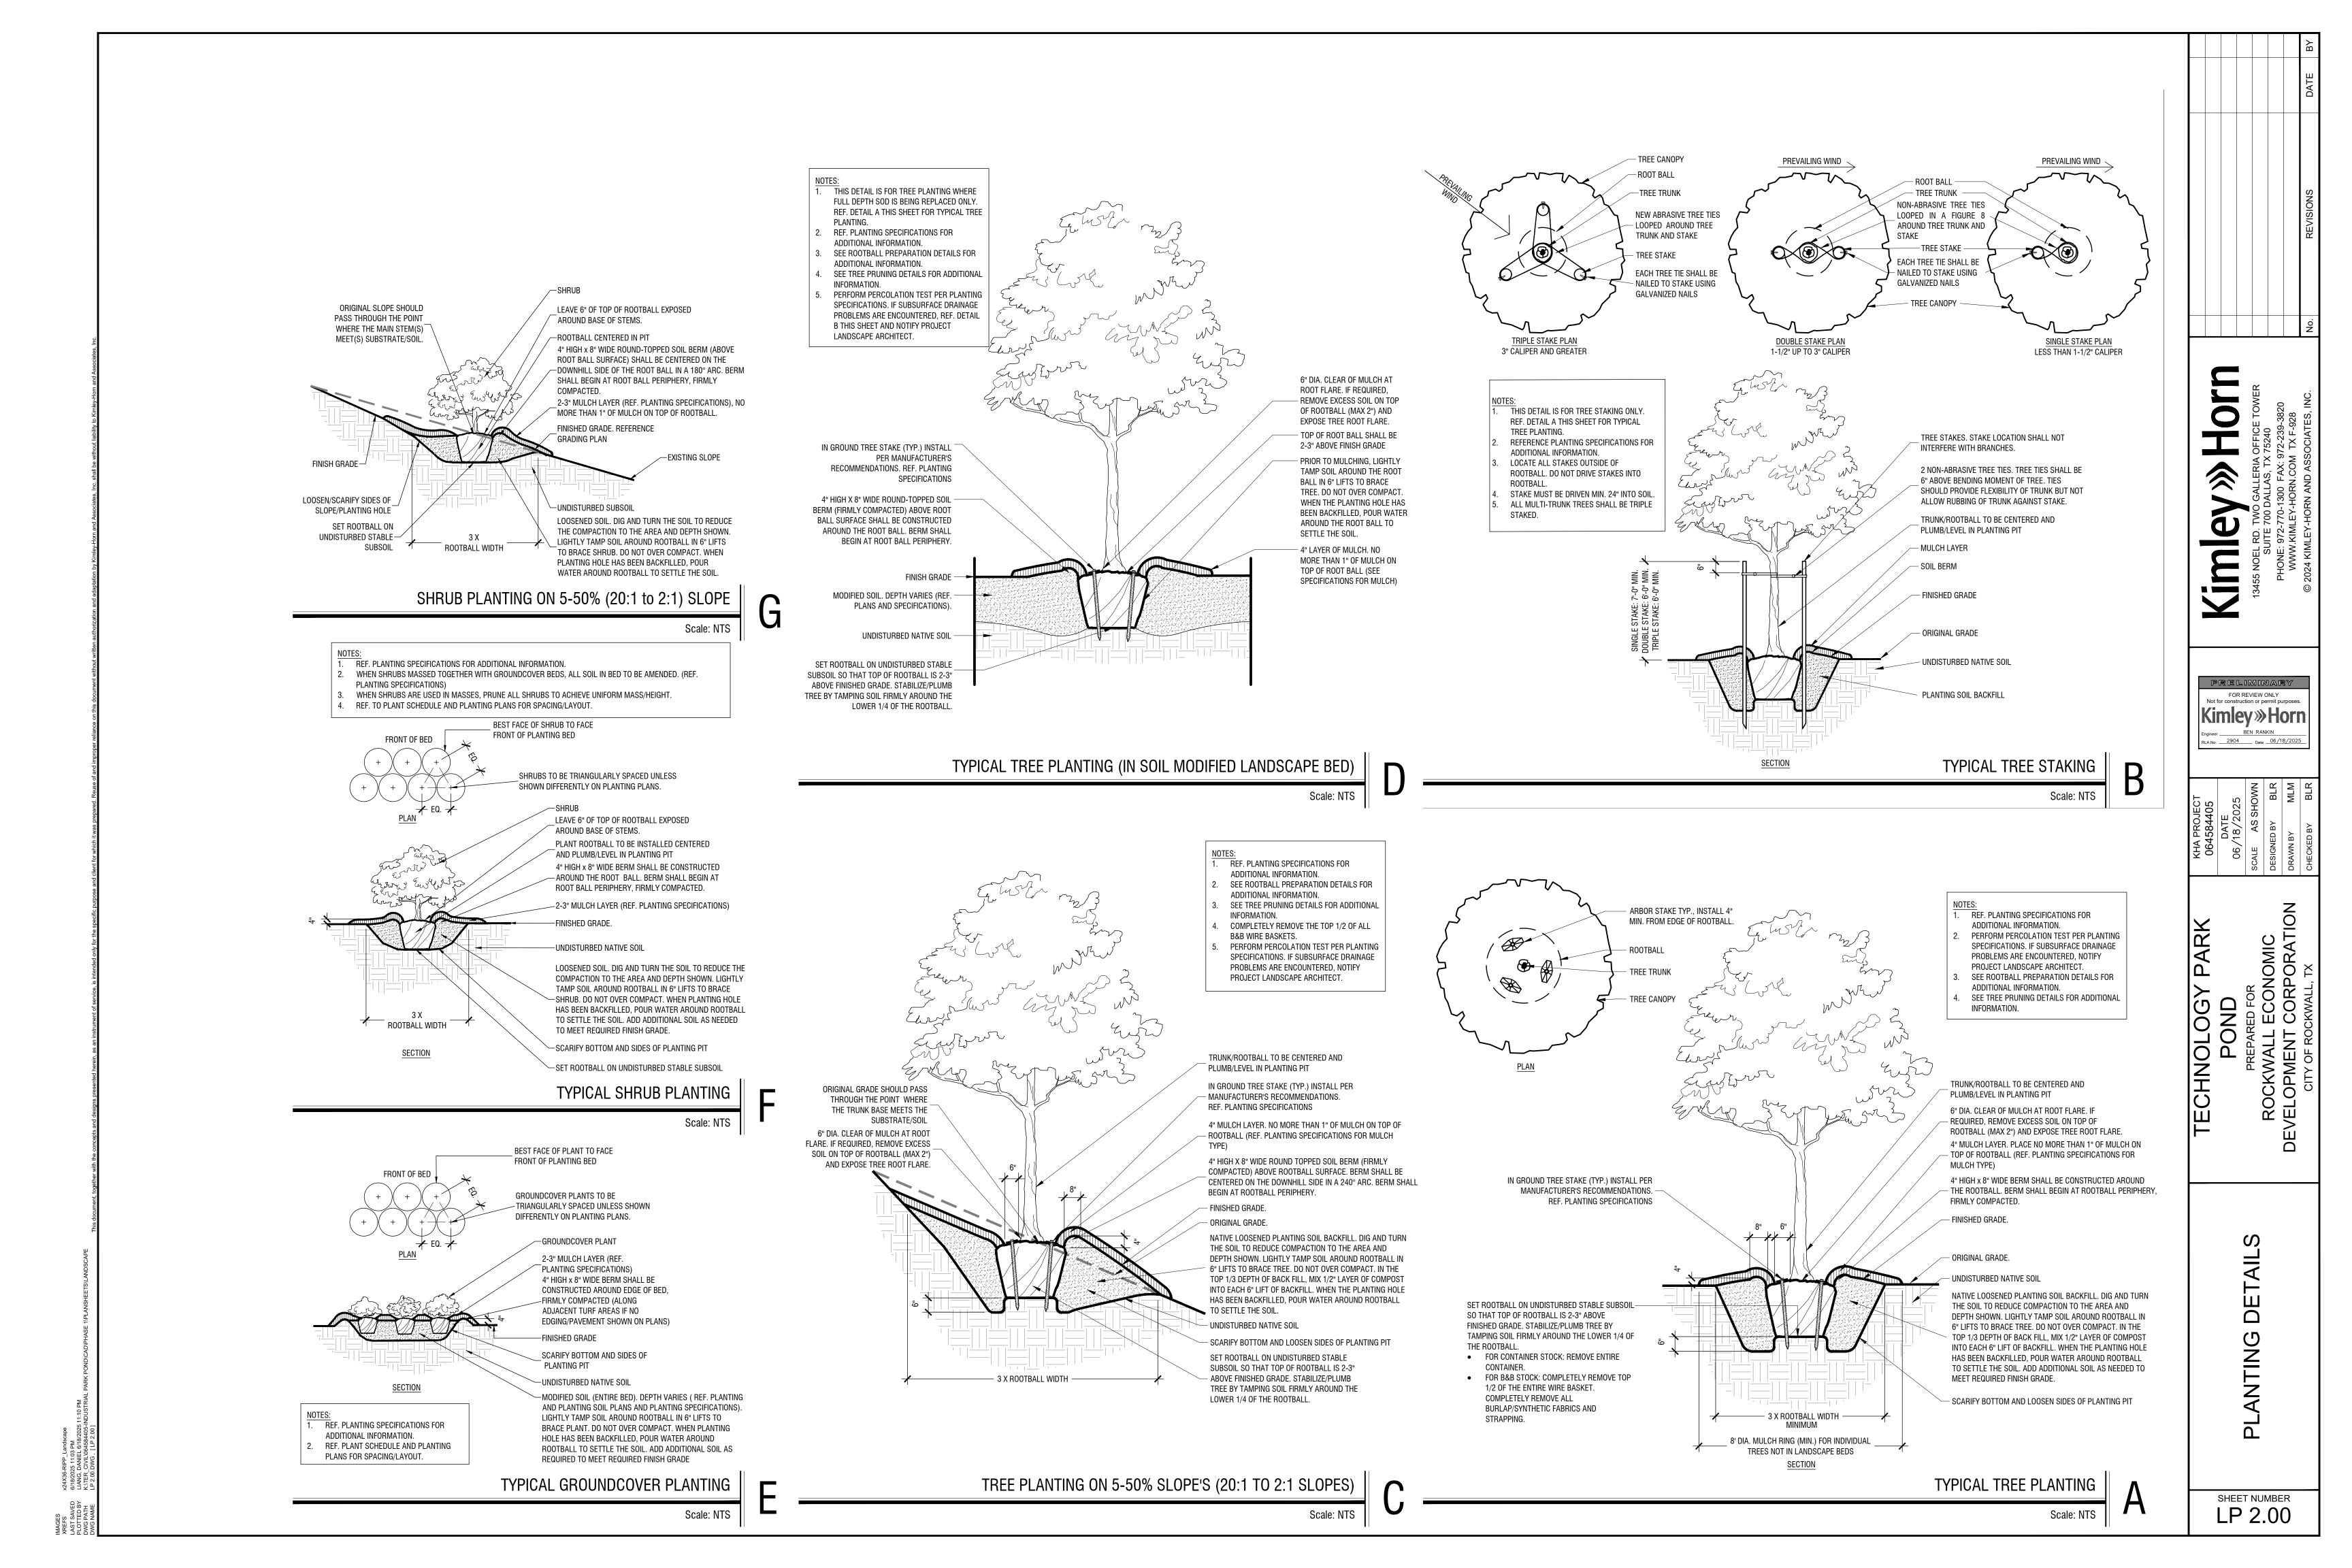

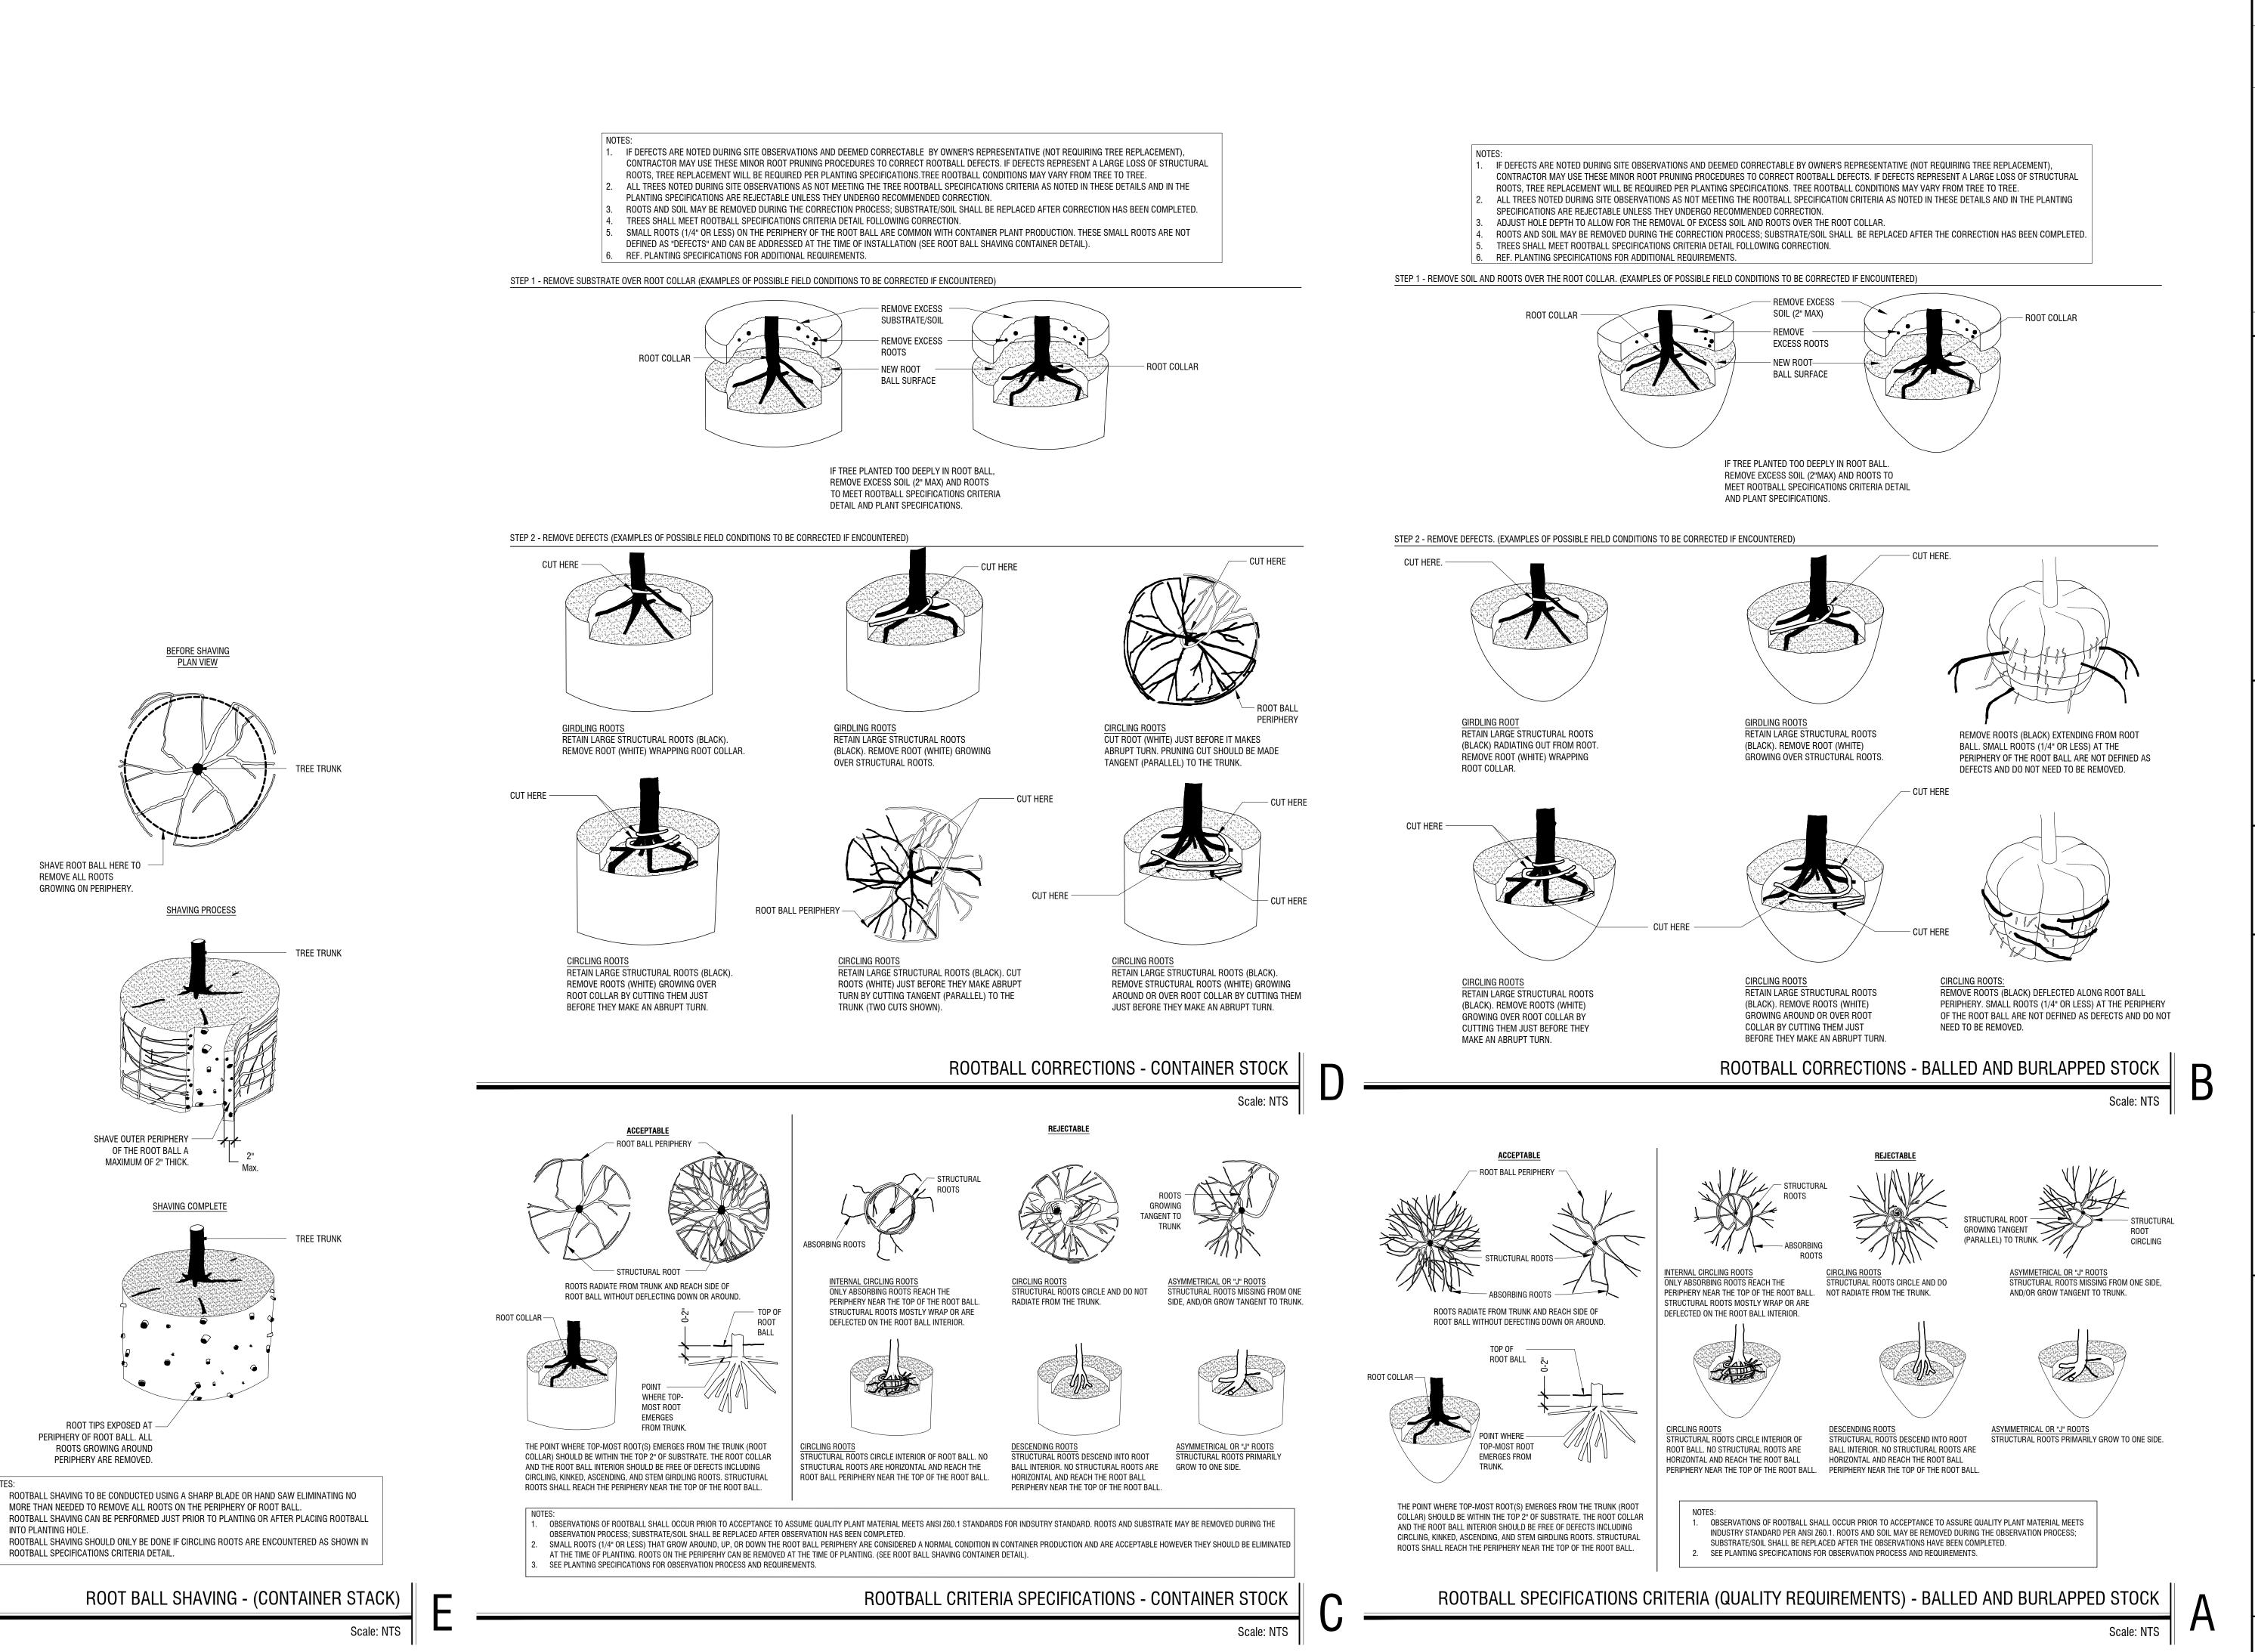

SHEET NUMBER LP 2.01

ANTING


PRELIMINARY

FOR REVIEW ONLY

Not for construction or permit purpose

Kimley»Horn

RLA No. 2904 Date 06/18/2025

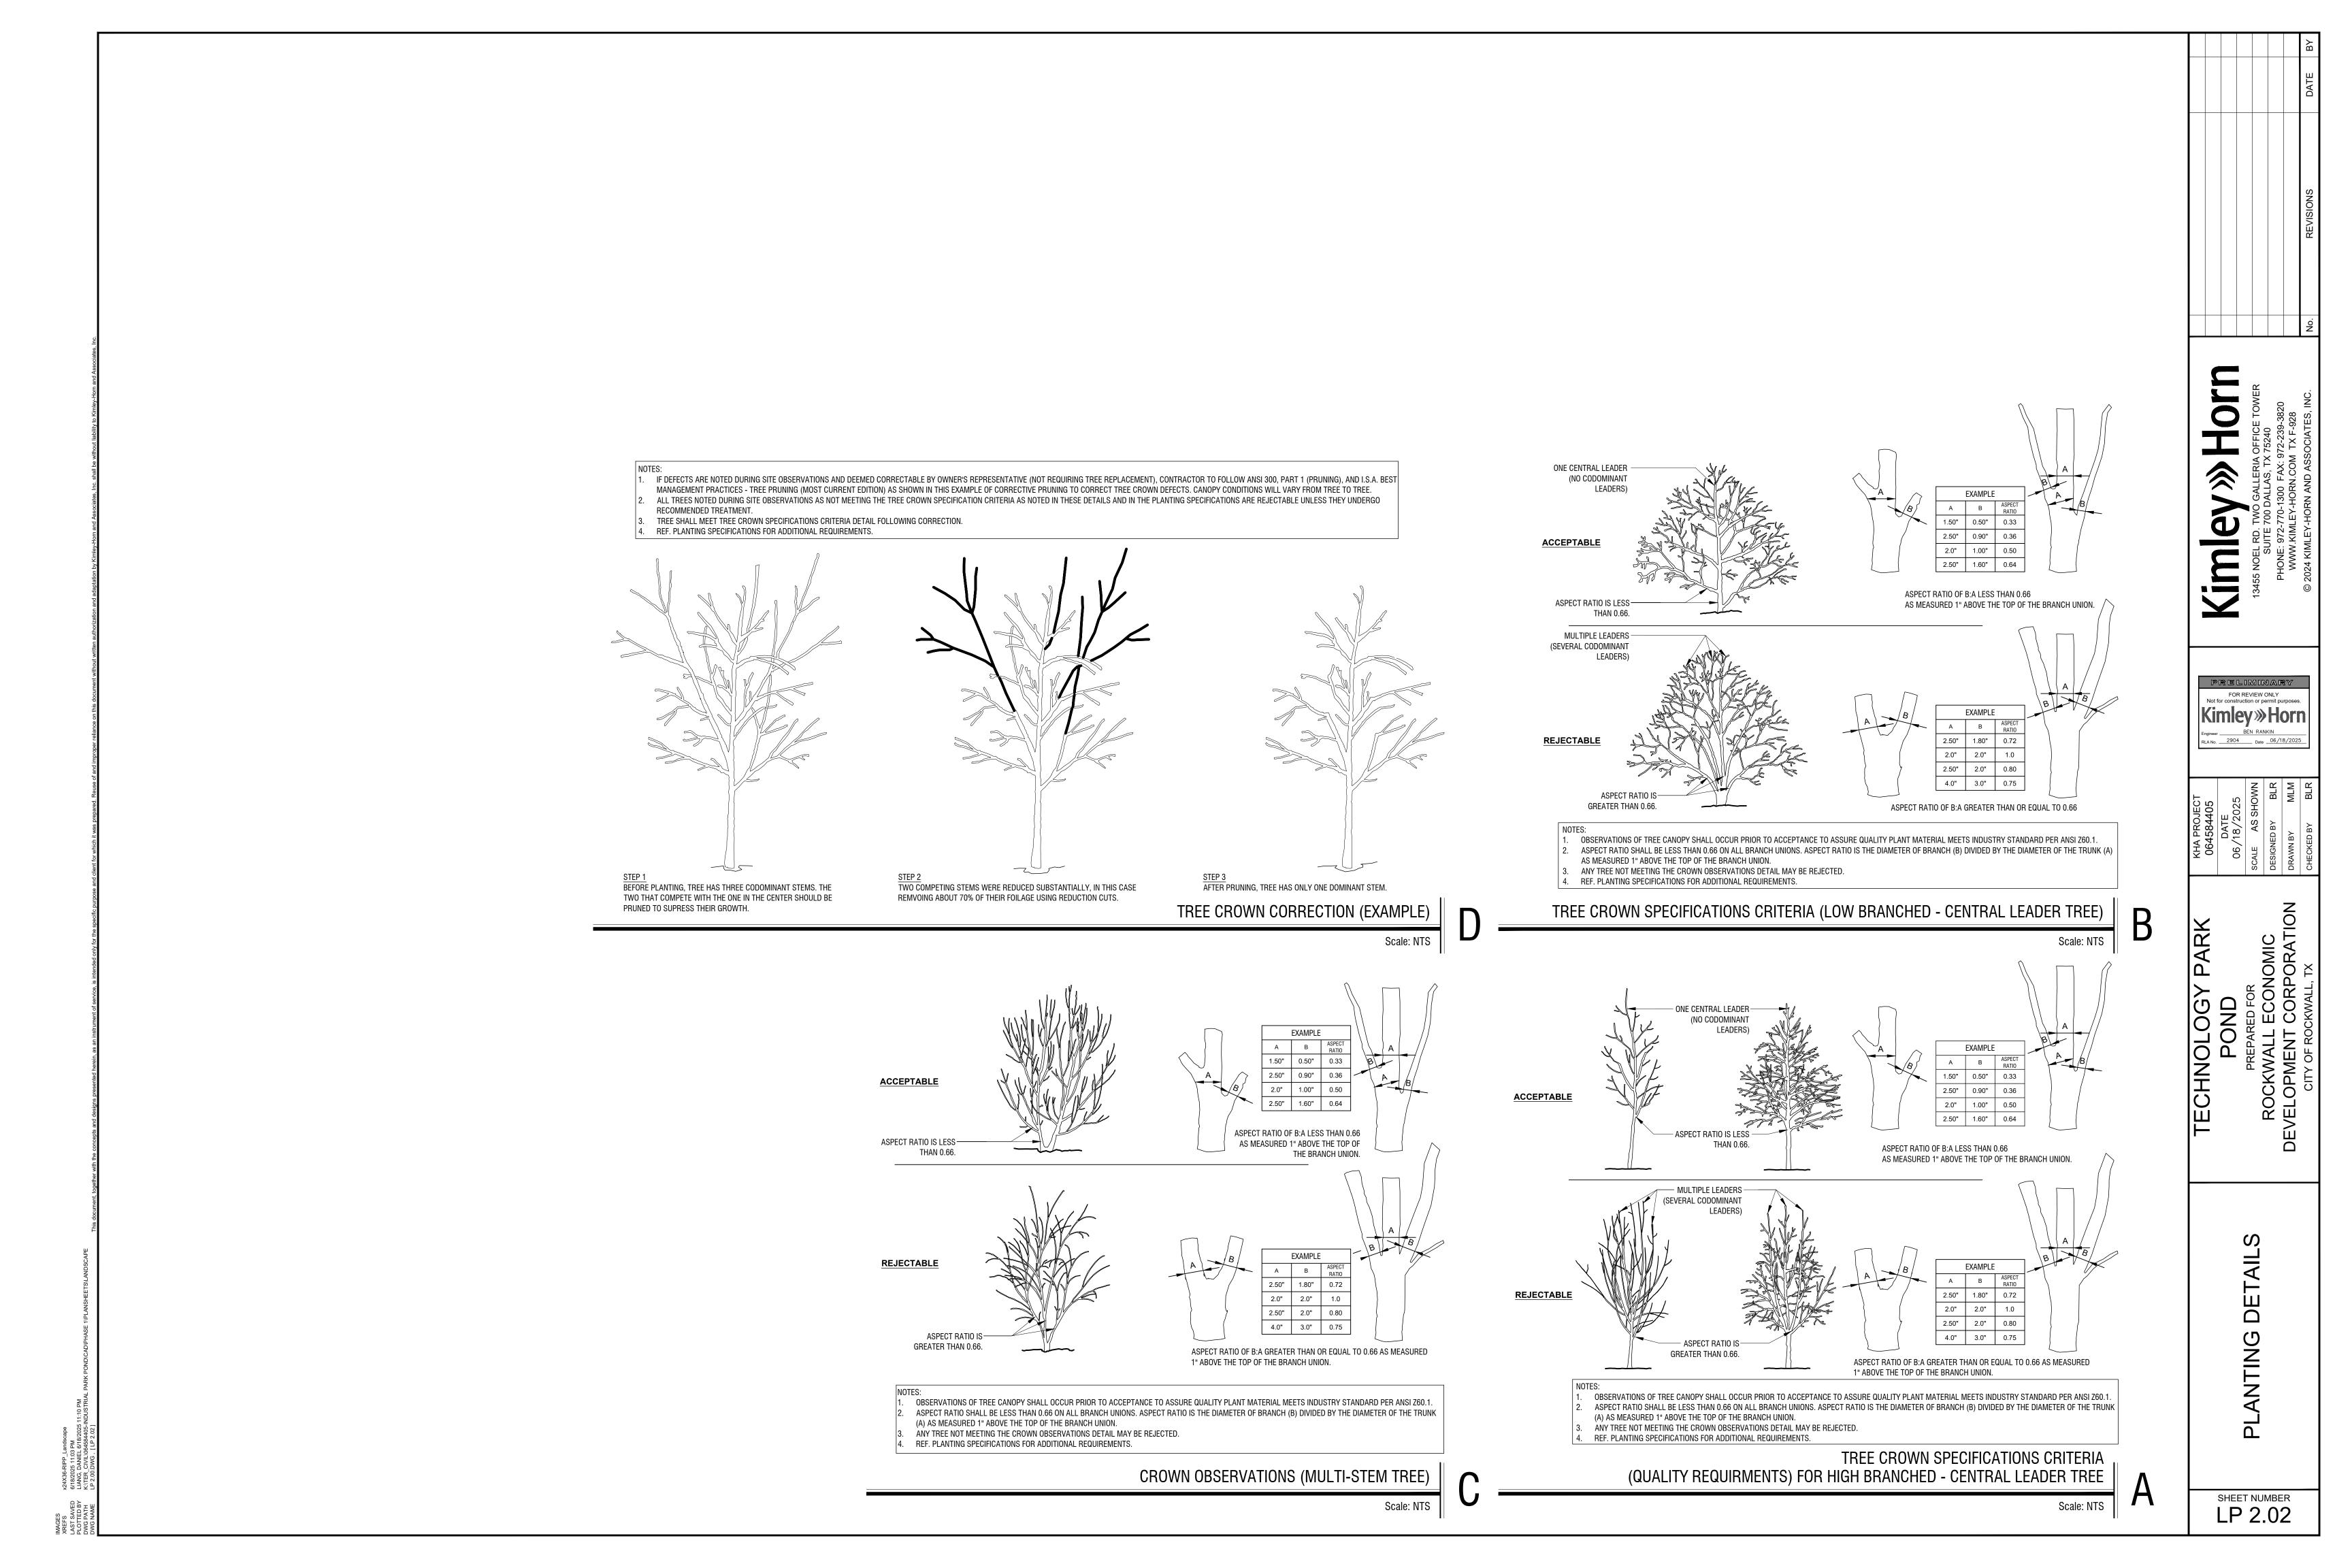



CITY OF ROCKWALL

PLANNING AND ZONING COMMISSION MEMORANDUM

PLANNING AND ZONING DEPARTMENT

385 S. GOLIAD STREET • ROCKWALL, TX 75087 PHONE: (972) 771-7745 • EMAIL: PLANNING@ROCKWALL.COM

TO: Planning and Zoning Commission

FROM: Henry Lee, Senior Planner


DATE: July 15, 2025

SUBJECT: SP2025-028; Treescape Plan for SH-276 & Corporate Crossing [FM-740]

The applicant -- Todd Martin, P.E. of Kimley-Horn on behalf of the Rockwall Economic Development Corporation (REDC) --, is requesting the approval of a Treescape Plan for the purpose of removing trees and providing landscaping on the subject property. The subject property is a 23.16-acre vacant tract of land (i.e. part of Lots 5 & 7, and Lot 8, Block A, Rockwall Technology Park Addition) zoned Light Industrial (LI) District, situated within the SH-276 Overlay (SH-276 OV) District and the FM-549 Overlay (FM-549 OV) District, and generally located at the northwest corner of SH-276 and Corporate Crossing [FM-549]. In order to facilitate the future development of the adjacent properties within the Rockwall Technology Park, the subject property is being developed as a regional detention system. Given this, the applicant has submitted a Treescape Plan for the Planning and Zoning Commission's consideration.

According to Section 03, Treescape Plan, of Article 09, Tree Preservation, of the Unified Development Code (UDC), before any trees may be removed from a non-residential property a Treescape Plan must be submitted to the Director of Planning and Zoning or his/her designee and go before the Planning and Zoning Commission for action. According to Subsection 03.01. Treescape Plan, of Article 09, Tree Preservation, of the Unified Development Code (UDC), "(a) treescape plan is a plan showing the exact location, size (i.e. trunk diameter and height), and common name of all trees, four (4) inches and greater and indicating the trees that are proposed to be removed, transplanted or replaced." Based on this, the applicant has submitted a Treescape Plan indicating the location, size, and species for every tree on the subject property. In accordance with the Tree Mitigation Requirements -- outlined in Section 05. of Article 09. of the UDC -- the applicant has indicated that the total mitigation balance is 130.90 caliper inches. In addition, the applicant has indicated that 292 caliper inches or 73, four (4) inch caliper trees will be planted on the subject property. This satisfies the mitigation balance for the proposed site improvements. That being said, according to Subsection 05.03, Landscape Requirements, of Article 08, Landscape and Fence Standards, of the Unified Development Code (UDC), "(d)etention basins shall be landscaped in a natural manner using ground cover, grasses, shrubs, berms, and accent and canopy trees. There shall be a minimum of one (1) Canopy Tree per 750 SF and one (1) Accent Tree per 1,500 SF of detention area." In this case, the applicant is required 120 canopy trees and 60 accent trees. Based on the provided landscape plan, the applicant is providing 50 canopy trees and 17 accent trees within the detention area. Given this, the applicant is requesting an Exception to detention landscaping requirements. Staff should point out that in this case, the entire property is being developed with a detention pond, and -- due to the subject property's location along two (2) major roadways (i.e. FM-549 & SH-276) -- the landscape buffer and tree planting requirements are substantial. The plan submitted by the applicant shows that the property will have plantings that nearly cover all usable area. In addition, there are several large easements along SH-276 that prohibit the applicant's ability to plant additional trees. Based on this, the applicant's request appears to have merit; however, the approval of an exception is a discretionary decision for the Planning and Zoning Commission. Should the Planning and Zoning Commission have any guestions concerning the applicant's request, staff will be available at the July 15, 2025 Planning and Zoning Commission meeting.

PROJECT COMMENTS

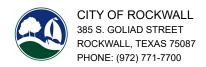

DATE: 7/9/2025

PROJECT NUMBER: SP2025-028

PROJECT NAME: Amedned Site Plan for SH-276 & Corporate Crossing

SITE ADDRESS/LOCATIONS: SH 276 & Corporate Crossing

CASE CAPTION: Consider a request by Todd Martin, P.E. of Kimley-Horn on behalf of Shannon Foltz of the Rockwall Economic Development

Corporation (REDC) for the approval of an Amended Site Plan on a 23.16-acre parcel of land identified as a part of Lots 5 & 7, and Lot 8, Block A, Rockwall Technology Park Addition, City of Rockwall, Rockwall County, Texas, situated within the SH-276 Overlay (SH-276 OV) District and the FM-549 Overlay (FM-549 OV) District, zoned Light Industrial (LI) District, generally located at the

northwest corner of SH-276 and Corporate Crossing [FM-549], and take any action necessary.

| DEPARTMENT | REVIEWER | DATE OF REVIEW | STATUS OF PROJECT | |
|------------|-----------|----------------|----------------------|--|
| PLANNING | Henry Lee | 07/09/2025 | Approved w/ Comments | |

07/09/2025: Please address the following comments (M= Mandatory Comments; I = Informational Comments)

- I.1 This is a request for the approval of a Treescape Plan on a 23.16-acre parcel of land identified as a part of Lots 5 & 7, and Lot 8, Block A, Rockwall Technology Park Addition, City of Rockwall, Rockwall County, Texas, situated within the SH-276 Overlay (SH-276 OV) District and the FM-549 Overlay (FM-549 OV) District, zoned Light Industrial (LI) District, generally located at the northwest corner of SH-276 and Corporate Crossing [FM-549].
- 1.2 For questions or comments concerning this case please contact Henry Lee in the Planning Department at (972) 772-6434 or email hlee@rockwall.com.
- M.3 For reference, include the case number (SP2025-028) in the lower right-hand corner of all pages of all revised plan submittals. (Subsection 01.02(D), Article 11, UDC)
- M.4 Provide the standard signature block with signature space for the Planning and Zoning Chairman and the Planning Director on all pages of the plans. Also remove the red placeholder text from the signature block. (Subsection 03.04. A, of Article 11)

APPROVED:

| hereby certify that the above and foregoing site plan for a development in the | ie City of Rockwall, Texas, was approved by the Planning & Zoning Commission of the City of Rockwa |
|--|--|
| on the day of, | |
| | |
| VITNESS OUR HANDS, this day of | |
| ,,, | |
| Planning & Zoning Commission, Chairman Direct | or of Planning and Zoning |
| Direction of the state of the s | or or raining and zoring |

- I.5 According to Subsection 03.01, Treescape Plan, of Article 09, Tree Preservation, of the Unified Development Code (UDC), "(a) treescape plan is a plan showing the exact location, size (i.e. trunk diameter and height), and common name of all trees, four (4) inches and greater and indicating the trees that are proposed to be removed, transplanted or replaced."
- M.6 Based on the proposed Treescape Plan, 130.9 caliper inches are being removed and 292 caliper inches (i.e. 73, four (4) inch caliper canopy trees) from the subject property.

The mitigation balance varies from Treescape Plan due to error with the mitigation table. Please correct the table to be in conformance with Article 09 of the Unified Development Code (UDC). The number of caliper inches planted varies from what is indicated on the plan as only canopy trees reduce the mitigation balance. This requirement is detailed in Section 05(F), of Article 09, of the Unified Development Code (UDC). Please update the Treescape Plan to reflect this.

- I.7 According to Subsection 05.03, Landscape Requirements, of Article 08, Landscape and Fence Standards, of the Unified Development Code (UDC), "(d)etention basins shall be landscaped in a natural manner using ground cover, grasses, shrubs, berms, and accent and canopy trees. There shall be a minimum of one (1) Canopy Tree per 750 SF and one (1) Accent Tree per 1,500 SF of detention area." In this case, the applicant is required 120 canopy trees and 60 accent trees. Based on the provided landscape plan, the applicant is providing 50 canopy trees and 17 accent trees within the detention area. Given this, the applicant is requesting to plant less than the required number of canopy and accent trees. This will require an exception from the Planning and Zoning Commission.
- I.8 Please note the scheduled meetings for this case:
- (1) Planning & Zoning meeting/public hearing meeting will be held on July 15, 2025.
- I.9 All meetings will be held in person and in the City's Council Chambers. All meetings listed above are scheduled to begin at 6:00 p.m. (P&Z). The City requires that a representative(s) be present for these meetings. During the upcoming work session meeting with the Planning and Zoning Commission, representative(s) are required to present their case and answer any questions the Planning Commission may have regarding this request.

| DEPARTMENT | REVIEWER | DATE OF REVIEW | STATUS OF PROJECT | |
|-------------|-----------|----------------|-------------------|--|
| BUILDING | Henry Lee | 07/09/2025 | N/A | |
| No Comments | | | | |
| DEPARTMENT | REVIEWER | DATE OF REVIEW | STATUS OF PROJECT | |
| FIRE | Henry Lee | 07/09/2025 | N/A | |
| No Comments | | | | |
| | | | | |
| DEPARTMENT | REVIEWER | DATE OF REVIEW | STATUS OF PROJECT | |
| POLICE | Henry Lee | 07/09/2025 | N/A | |
| No Comments | | | | |
| DEPARTMENT | REVIEWER | DATE OF REVIEW | STATUS OF PROJECT | |
| PARKS | Henry Lee | 07/09/2025 | N/A | |

No Comments




NOTARY PUBLIC IN AND FOR THE STATE OF TEXAS

DEVELOPMENT APPLICATION
City of Rockwall
Planning and Zoning Department

| PLANNING & ZONING CASE | NO. |
|------------------------|---|
| | NOT CONSIDERED ACCEPTED BY THE DIRECTOR AND CITY ENGINEER HAVE |
| DIRECTOR OF PLANNING: | |
| CITY ENGINEER: | |

| 385 S. Goliad Street Rockwall, Texas 75087 | | | | | TOR OF PLANNII | NG: | 125-125-1 125-125-1 | |
|--|---|---|--|---------------------------------|---|---|---|---|
| PLEASE CHECK THE A | PPROPRIATE BOX BELOW TO | O INDICATE THE TYPE OF | F DEVELOPME | NT REQ | UEST [SELECT | ONLY ONE BOX | : | |
| PLATTING APPLICATION MASTER PLAT (\$ PRELIMINARY PLAT (\$30 .00 REPLAT (\$300.00 AMENDING OR M. PLAT REINSTATION SITE PLAN APPLICATION AMENDED SITE | TOPUS TOPUS TO SELECT ONLY ONE BOXJ: ZONING APPLICATION FEES: ☐ ZONING CHANGE (\$200.00 + \$15.00 ACRE) 1 ☐ SPECIFIC USE PERMIT (\$200.00 + \$15.00 ACRE) 1 ☐ PD DEVELOPMENT PLANS (\$200.00 + \$15.00 ACRE) 1 OTHER APPLICATION FEES: ☐ TREE REMOVAL (\$75.00) ☐ VARIANCE REQUEST/SPECIAL EXCEPTIONS (\$100.00) 2 NOTES: 1: IN DETERMINING THE FEE, PLEASE USE THE EXACT ACREAGE WHEN MULTIPLYING BY THE PER ACRE AMOUNT. FOR REQUESTS ON LESS THAN ONE ACRE, ROUND UP TO ONE (1) ACRE. 1: A \$1,000.00 FEE WILL BE ADDED TO THE APPLICATION FEE FOR ANY REQUEST THAT INVOLVES CONSTRUCTION WITHOUT OR NOT IN COMPLIANCE TO AN APPROVED BUILDING PERMIT. | | | | | | | |
| PROPERTY INFO | RMATION [PLEASE PRINT] | | | | | | | |
| ADDRESS | Northwest Corner | of State Highwa | y 276 & C | orpor | ate Cross | ing | | |
| SUBDIVISION | Rockwall Technology | ogy Park | | | LOT | 8 | BLOCK | Α |
| GENERAL LOCATION | Northwest Corner | of State Highwa | y 276 & C | orpor | ate Cross | ing | | |
| ZONING, SITE PL | AN AND PLATTING IN | FORMATION [PLEAS | E PRINT) | | | | | |
| CURRENT ZONING | LI | | CURREN | IT USE | Undevelo | pped | | |
| PROPOSED ZONING | U | | PROPOSE | D USE | Office / D | etention Po | ond | |
| ACREAGE | 23.16 | LOTS [CURRENT] | 3 | | LOT | S [PROPOSED] | 3 | |
| REGARD TO ITS A | <u>PLATS</u> : BY CHECKING THIS BO PPROVAL PROCESS, AND FAILU ENIAL OF YOUR CASE. | DX YOU ACKNOWLEDGE TH IRE TO ADDRESS ANY OF S | HAT DUE TO TH STAFF'S COMME | E PASSA ENTS BY | IGE OF <u>HB3167</u> THE DATE PROV | THE CITY NO LON IDED ON THE DEV | IGER HAS FL ELOPMENT (| EXIBILITY WITH CALENDAR WILL |
| | NT/AGENT INFORMA | TION [PLEASE PRINT/CH | | | | | REQUIRED] | |
| | Rockwall EDC | | ⊠ APPLI | - 1 | Kimley-H | | | |
| CONTACT PERSON , | | | CONTACT PER | - 1 | Todd Mar | | | |
| | 2610 Observation T | rail | ADDI | RESS | | Nash Stree | et | |
| | Suite 104 Rockwall, TX 75032 | | CITY, STATE | 2 7ID | Suite 100 Terrell, TX | | | |
| PHONE | Nockwall, 17 75052 | | | ONE I | Terren, 12 | (10100 | | |
| E-MAIL | | | | -MAIL | | | | 24.0 |
| NOTARY VERIFICE BEFORE ME, THE UNDER | CATION [REQUIRED] SIGNED AUTHORITY, ON THIS DA ON ON THIS APPLICATION TO BE | AY PERSONALLY APPEAREI TRUE AND CERTIFIED THE | s Sha | NNO | n Folt | 2_ [OWNER] | THE UNDER | RSIGNED, WHO |
| S 100.00 | AM THE OWNER FOR THE PURPO , TO COVER THE COS , 20 25 BY SIGNING O WITHIN THIS APPLICATION TO ON WITH THIS APPLICATION, IF SU | ST OF THIS APPLICATION, HA G THIS APPLICATION, I AGRE THE PUBLIC. THE CITY IS | S BEEN PAID TO T EE THAT THE CIT ALSO AUTHORIZ | THE CITY Y OF ROO ZED AND | OF ROCKWALL O CKWALL (I.E. "CIT" PERMITTED TO | N THIS THE Y") IS AUTHORIZED REPRODUCE ANY OF PURIC INSORM | AND PERMITT COPYRIGHTE | DAY OF TED TO PROVIDE D INFORMATION |
| GIVEN UNDER MY HAND | AND SEAL OF OFFICE ON THIS TO | HE 19 DAY OF JU | ne | 2021 | | Notary | FER L. HAI Public, Stat #132300 mm. Exp. 0 |)83-8 (; |

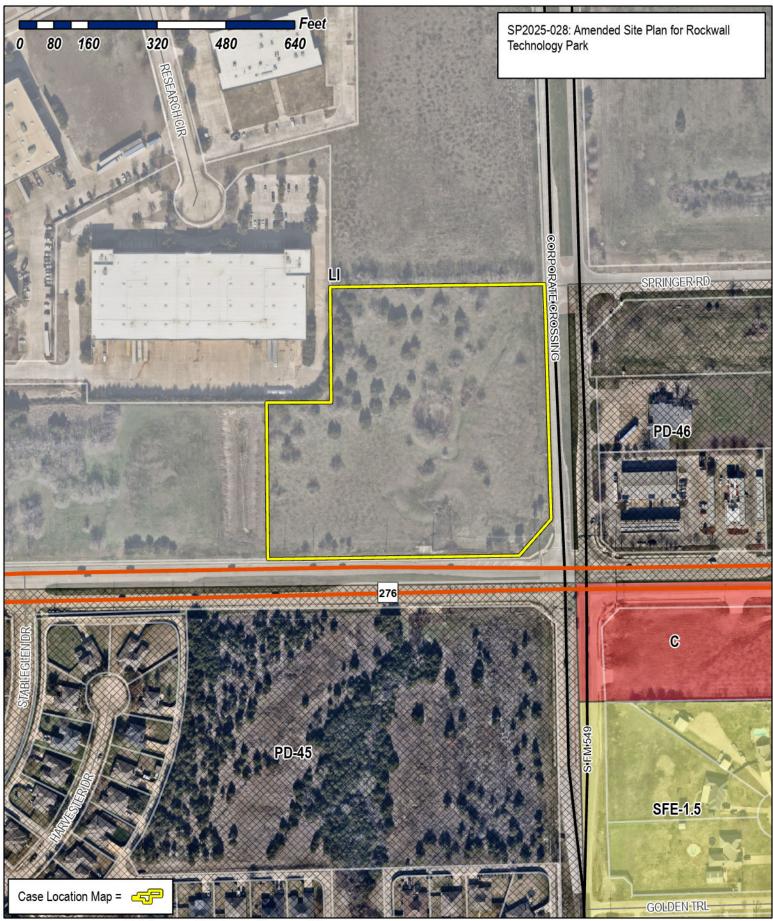




City of Rockwall Planning & Zoning Department 385 S. Goliad Street Rockwall, Texas 75087


(P): (972) 771-7745 (W): www.rockwall.com

The City of Rockwall GIS maps are continually under development and therefore subject to change without notice. While we endeavor to provide timely and accurate information, we make no guarantees. The City of Rockwall makes no warranty, express or implied, including warranties of merchantability and fitness for a particular purpose. Use of the information is the sole responsibility of the user.



| PLANTING NOTES: | PLANTING SCHEDULE: | | | | |
|--|---|----------------------------|---|--|--|
| 1. CONTRACTOR SHALL BE RESPONSIBLE FOR VERIFYING THE LOCATIONS OF ALL UNDERGROUND UTILITIES, PIPES, STRUCTURES, AND LINE RUNS IN THE FIELD PRIOR TO THE INSTALLATION OF ANY PLANT MATERIAL. | DETENTION POND LOT | | | | |
| IT IS THE RESPONSIBILITY OF THE CONTRACTOR TO ADVISE THE LANDSCAPE ARCHITECT OF ANY CONDITION FOUND ON SITE WHICH PERMITS INSTALLATION AS SHOWN ON THESE DRAWINGS. ALL PLANT MATERIAL SHALL BE MAINTAINED IN A HEALTHY, GROWING CONDITION AND MUST BE REPLACED WITHIN 30 DAYS WITH PLANT MATERIAL OF THE SAME VARIETY AND SIZE IF DAMAGED, DESTROYED, OR REMOVED. | SYMBOL CODE QTY BOTANICAL / COMMON NAME TREES UP 4 ULMUS PARVIFOLIA SEMPERVIRENDS `ATHENA` / ATHENA LACEBARK ELM | <u>R00T</u> // B & B | <u>CAL.</u> <u>SIZE</u> 4" CAL 12` - | REMARKS 14` HT STRONG CENTRAL LEADER, FULL | |
| CONTRACTOR SHALL BE RESPONSIBLE FOR FINE GRADING AND REMOVAL OF DEBRIS PRIOR TO PLANTING IN ALL AREAS. FINAL FINISH GRADING SHALL BE REVIEWED AND APPROVED BY THE LANDSCAPE ARCHITECT. THE CONTRACTOR SHALL BE RESPONSIBLE FOR ANY ADDITIONAL TOPSOIL REQUIRED TO CREATE A SMOOTH CONDITION PRIOR TO PLANTING. CONTRACTOR SHALL VERIFY ALL PLANT QUANTITIES. ALL PLANT QUANTITIES ARE LISTED FOR INFORMATION PURPOSES ONLY. IT IS THE | O TO THE THE TO | B & B | | 18` HT. SINGLE STRAIGHT CENTRAL LEADER, FULL AND MATCHING | |
| CONTRACTOR'S RESPONSIBILITY TO PROVIDE FULL COVERAGE IN ALL PLANTING AREAS AS SHOWN ON THE PLANS AND SPECIFIED IN THE PLANT SCHEDULE. 7. CONTRACTOR TO PROVIDE STEEL EDGING BETWEEN ALL PLANTING BEDS AND TURF AREAS UNLESS OTHERWISE INDICATED ON THE DRAWINGS. | QM 8 QUERCUS MACROCARPA / BUR OAK | B & B | 4" CAL. 12`-1 | 4` HT. STRONG, CENTRAL LEADER, FULL | |
| 8. ALL PLANT MATERIAL SHALL CONFORM TO THE SPECIFICATIONS GIVEN IN THE PLANT SCHEDULE, PLANTING DETAILS, AND PLANTING SPECIFICATIONS. 9. ALL PLANT MATERIAL SHALL MEET INDUSTRY STANDARDS AS INDICATED IN THE CURRENT EDITION OF THE AMERICAN STANDARD FOR NURSERY STOCK (ANSI Z60.1). | QC 6 QUERCUS MUEHLENBERGII / CHINKAPIN OAK | B & B | 4" CAL. 16`- | 18` HT. SINGLE STRAIGHT CENTRAL LEADER, FULL AND MATCHING | |
| 10. ALL PLANT MATERIAL SUBSTITUTIONS SHALL BE APPROVED BY LANDSCAPE ARCHITECT PRIOR TO PURCHASE.11. CONTRACTOR IS RESPONSIBLE FOR ALL COORDINATION WITH OTHER CONTRACTORS ON SITE AS REQUIRED TO ACCOMPLISH ALL PLANTING OPERATIONS. | CL 23 CHILOPSIS LINEARIS / DESERT WILLOW JE 44 JUNIPERUS VIRGINIANA / EASTERN RED CEDAR | CONT. B & B | 2" CAL. 8`-10 | HT. SINGLE STRAIGHT CENTRAL LEADER, FULL AND MATCHING 'HT. SINGLE STRAIGHT CENTAL LEADER, FULL AND MATCHING | |
| 12. ALL PLANTING AREAS SHALL RECEIVE SOIL AMENDMENTS. 13. PLANT MATERIAL SHALL BE PRUNED PER PLANTING DETAILS UNLESS OTHERWISE NOTED ON DRAWINGS. 14. PLANTING AREAS SHALL BE KEPT FREE OF TRASH, WEEDS, DEBRIS, AND DEAD PLANT MATERIAL. | QS 5 QUERCUS SHUMARDII / SHUMARD RED OAK | В & В | | 18` HT. SINGLE STRAIGHT CENTAL LEADER, FULL AND MATCHING | OWER 20 |
| 15. ALL LIME STABILIZED SOIL AND INORGANIC SELECT FILL FOR BUILDING OR PAVING CONSTRUCTION SHALL BE REMOVED FROM ALL PLANTING BEDS TO A MINIMUM DEPTH OF 24" UNLESS OTHERWISE NOTED. REPLACE MATERIAL REMOVED WITH IMPORTED TOPSOIL. 16. TREES OVERHANGING PEDESTRIAN WALKS AND WITHIN VISIBILITY TRIANGLES AS NOTED ON THE PLANS SHALL BE LIMBED TO A HEIGHT OF SEVEN FEET (7'). TREE OVERHANGING PUBLIC STREETS AND FIRELANES SHALL BE LIMBED TO A HEIGHT OF FOURTEEN FEET (14'). | CC 26 CERCIS CANADENSIS `TEXENSIS` / TEXAS REDBUD | CONT. | 2" CAL. 8`-10 | `HT. SINGLE STEM, FULL | OFFICE TO (75240) 972-239-382 |
| 17. TREES PLANTED NEXT TO ACCESSIBLE ROUTES AND ACCESSIBLE AREAS SHALL BE LIMBED TO 7'6" (80" MIN.) AFF. 18. ALL PROPOSED TREES SHALL BE STAKED WITH AN AT-GRADE ROOT BALL SECURING SYSTEM AS SHOWN IN THE PLANTING DETAILS AND SPECIFICATIONS. NO ABOVE-GROUND STAKING SYSTEMS, GUY WIRES/WIRES, HOSES, STRAPS, POSTS (METAL OR WOOD) SHALL BE ALLOWED | SYMBOL CODE QTY BOTANICAL / COMMON NAME SHRUBS | CONT. | <u>SIZE</u> <u>SPAC</u> | NG REMARKS | GALLERIA DALLAS, TX 1300 FAX: 9 HORN.COM |
| UNLESS AUTHORIZED IN WRITING BY THE LANDSCAPE ARCHITECT. | LC 51 LOROPETALUM CHINENSE / LOROPETALUM LF 49 LEUCOPHYLLUM FRUTESCENS / TEXAS SAGE | 5 GAL. MIN. 5 GAL. MIN. | 36" HT. 60" 0 36" HT. 48" 0 | | EL RD. TWO SUITE 700 E E: 972-770- |
| | | | | | 13455 NOEL S PHONE WWW |
| | | | | | Y |
| | | | | | PRELIMINARY FOR REVIEW ONLY |
| | | | | | Not for construction or permit purposes. Kimley >>> Horn Engineer BEN RANKIN RLA No. 2904 Date 06/18/2025 |
| | | | | | KHA PROJECT 064584405 DATE 06/18/2025 SCALE AS SHOWN DESIGNED BY BLR DRAWN BY MLM |
| | | | | | PARK |
| | | | | | ND ND ED FOR ECON CORF |
| | | | | | PREPA WAL |
| | | | | | TECHI ROCK DEVELOPI |
| | | | | | |
| | | | | | |
| | | | | | HEDU S |
| | | | | | S SC |
| | | | | | |
| | | | | | PLAN |
| | | | | | CHEET MUNADED |
| | | | | | SHEET NUMBER |

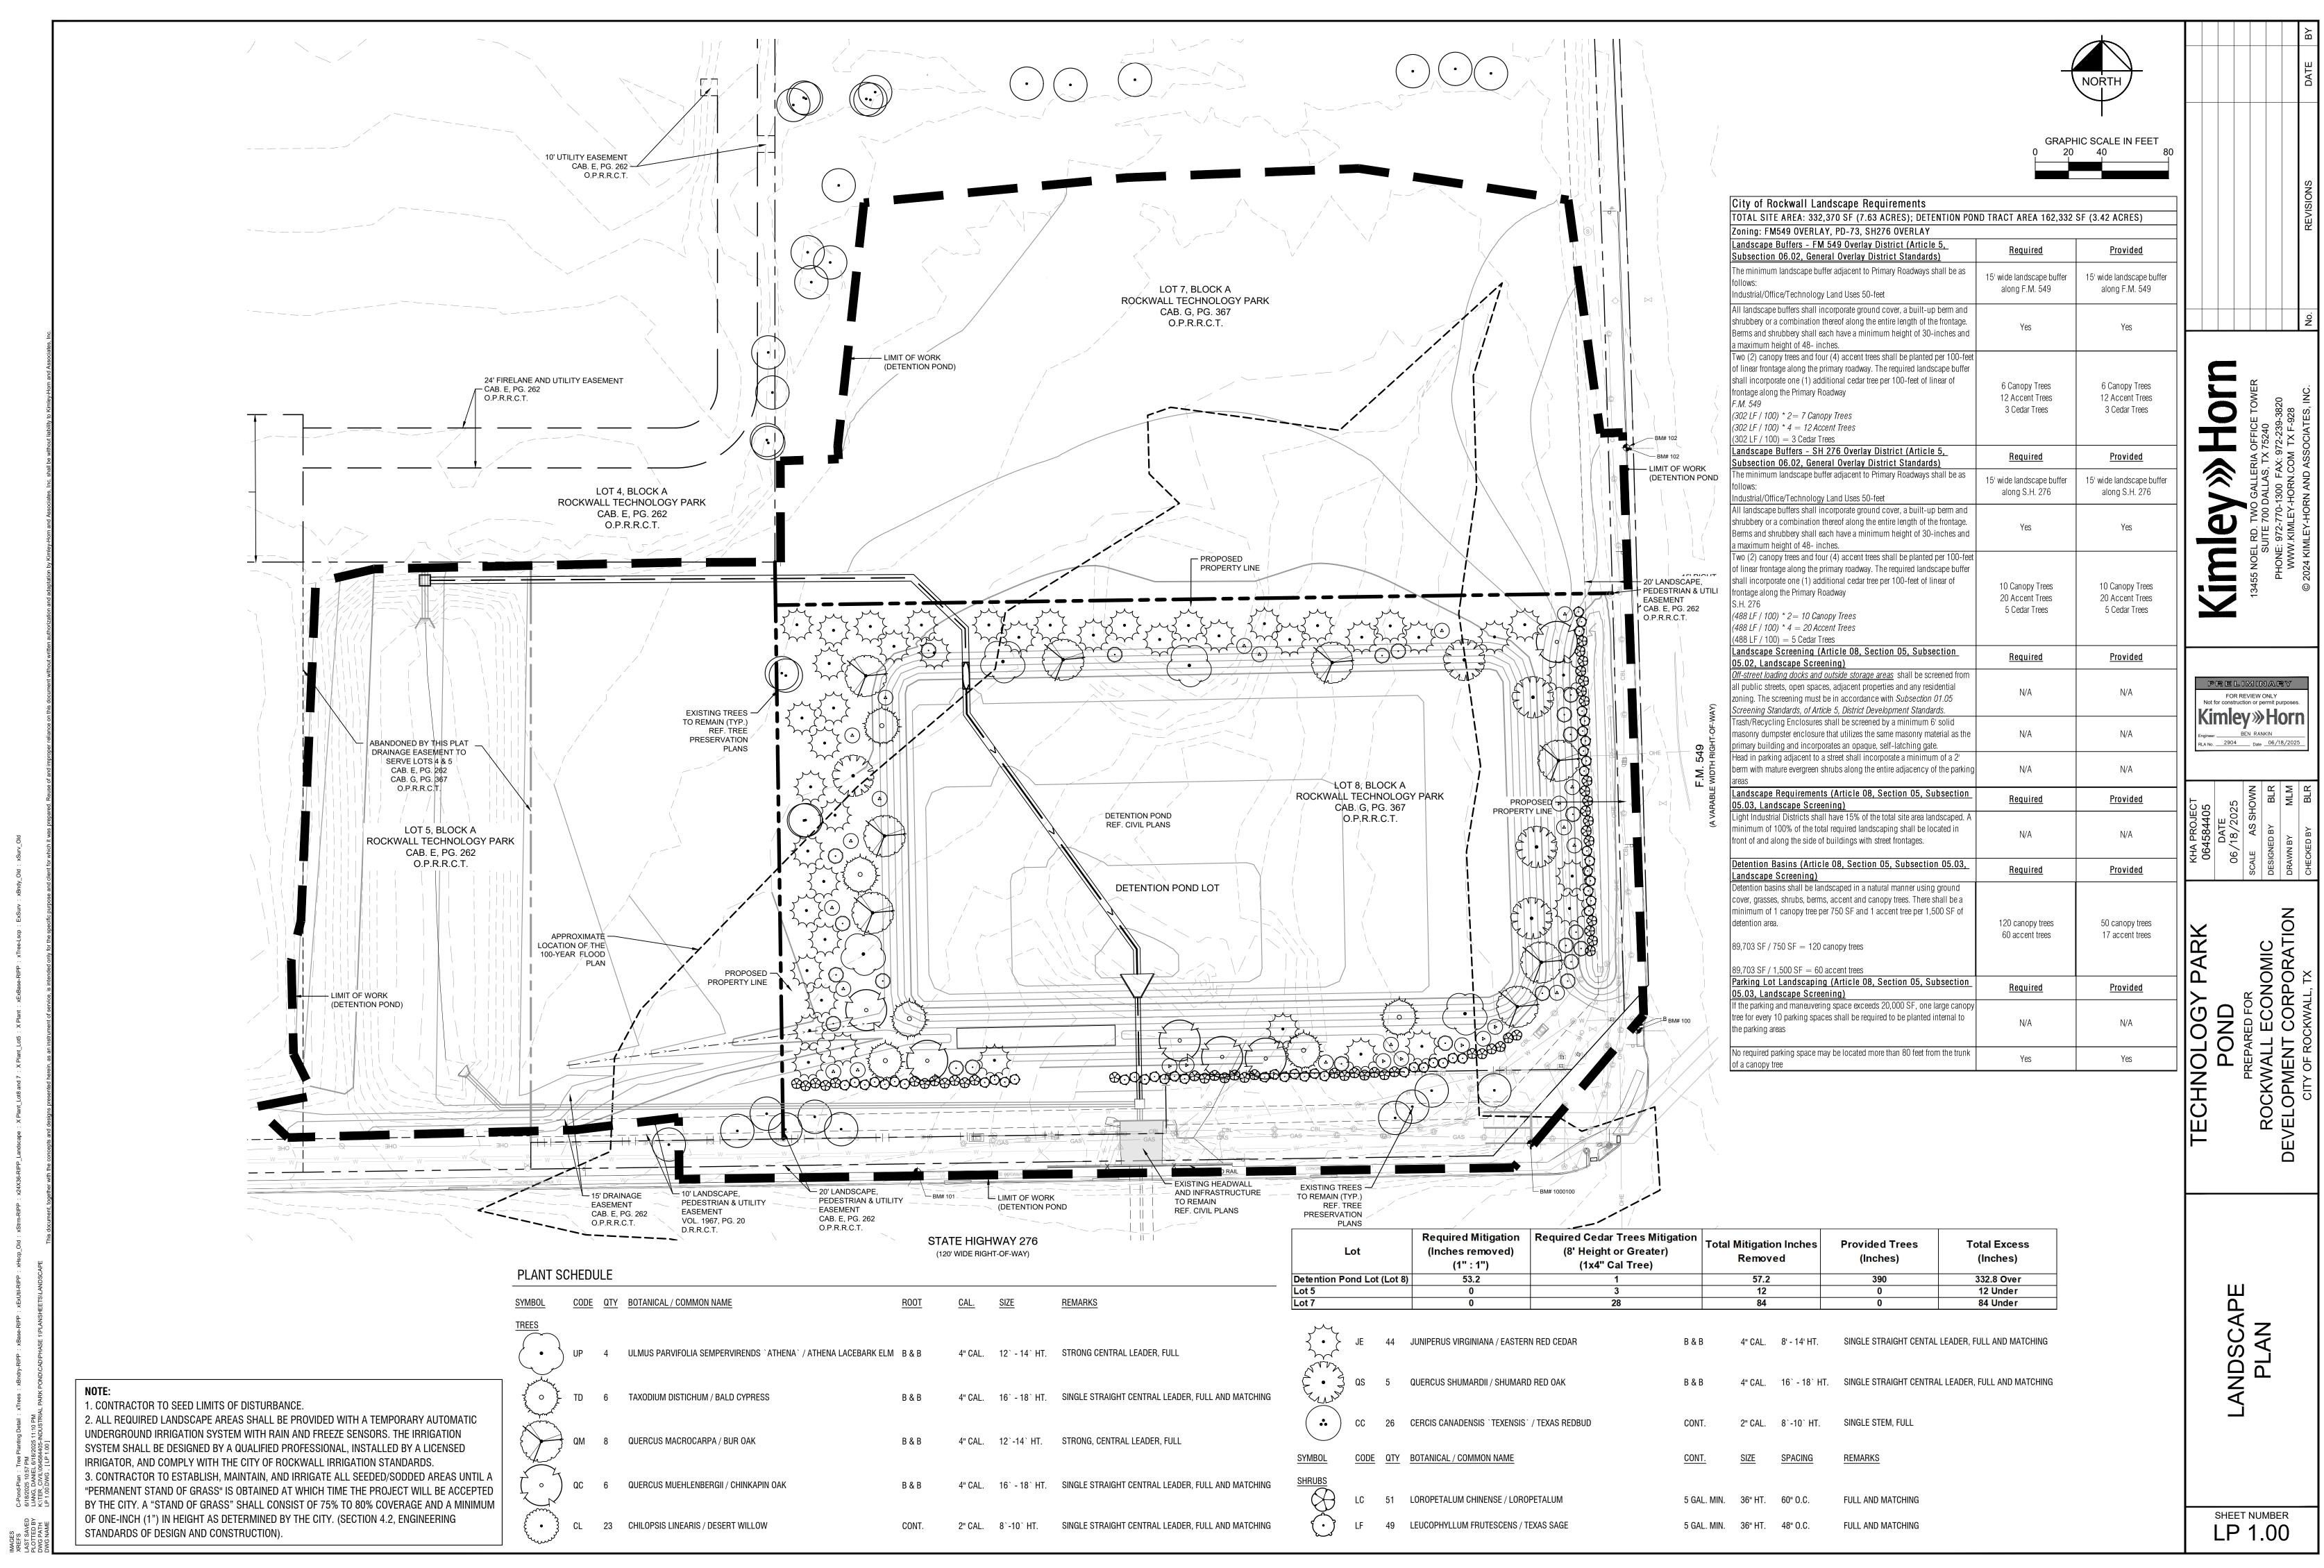

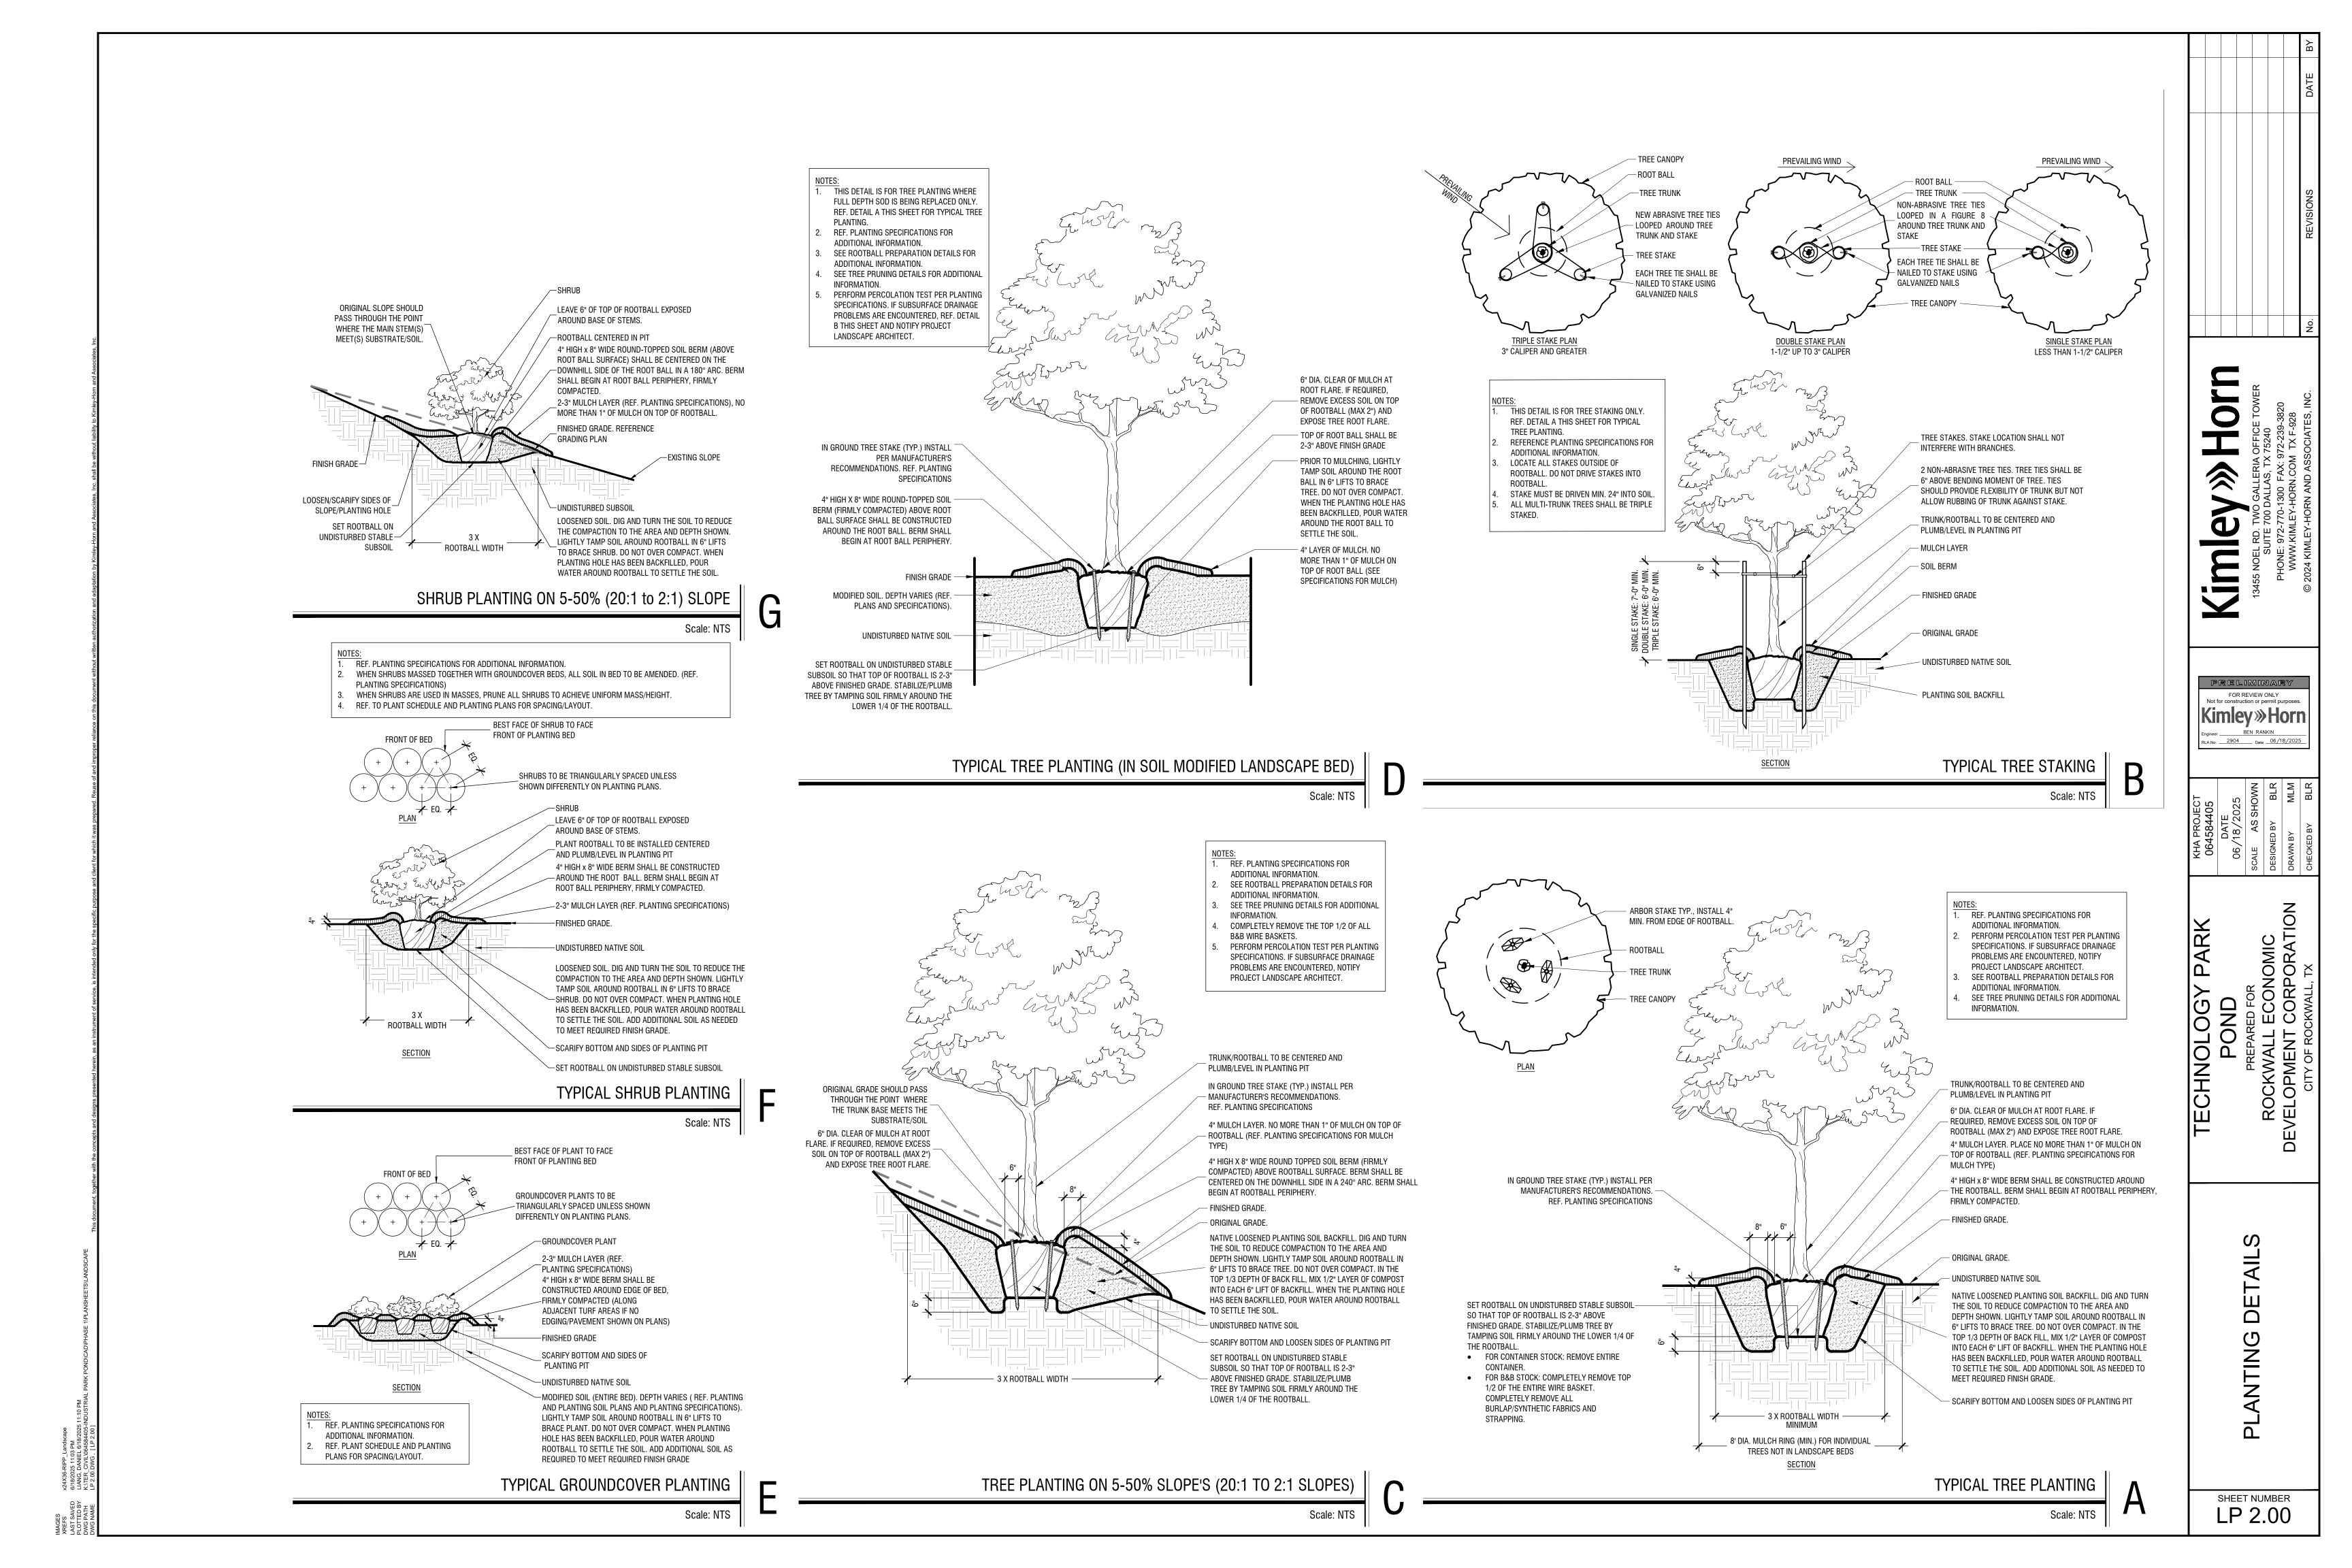


LANDSCAPE CONSTRUCTION PLANS FOR

TECHNOLOGY PARK POND DESIGN AND ONSITE GRADING IMPROVEMENTS LOT 8, BLOCK A

AT THE
NORTHWEST CORNER OF SH 276 & CORPORATE CROSSING,
ROCKWALL COUNTY, TEXAS

PLANS SUBMITTAL/REVIEW LOG

| FIRST CITY SUBMITTAL -NOT FOR CONSTRUCTION | 10/09/2024 |
|---|------------|
| SECOND CITY SUBMITTAL -NOT FOR CONSTRUCTION | 03/28/2025 |
| THIRD CITY SUBMITTAL -NOT FOR CONSTRUCTION | 05/30/2025 |
| FOURTH CITY SUBMITTAL | 06/18/2025 |

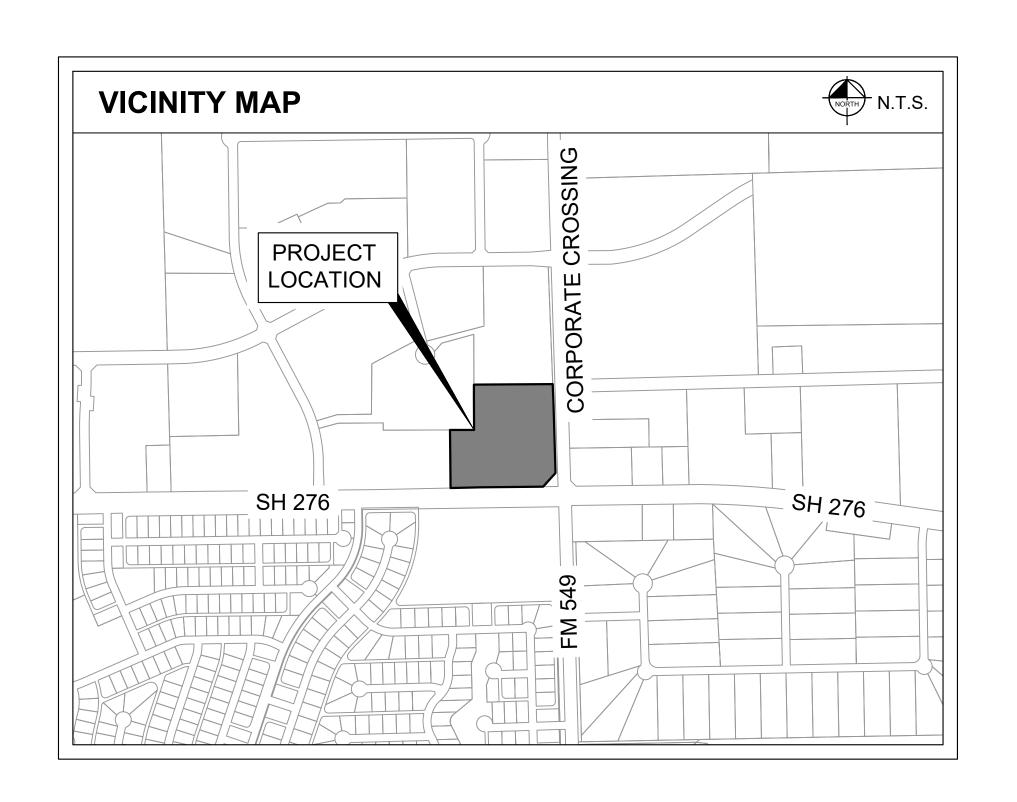

| LANDSCAPE SHEET LIST TABLE | | | | | | | |
|----------------------------|-----------------------------------|--|--|--|--|--|--|
| Sheet Number | Sheet Title | | | | | | |
| LC 0.00 | COVER SHEET | | | | | | |
| TP 0.00 | KEY MAP | | | | | | |
| TP 1.00 | TREE PRESERVATION & REMOVAL PLAN | | | | | | |
| TP 2.00 | TREE PRESERVATION DETAILS & NOTES | | | | | | |
| LP 0.00 | PLANTING SCHEDULE & NOTES | | | | | | |
| LP 1.00 | LANDSCAPE PLAN | | | | | | |
| LP 2.00 | PLANTING DETAILS | | | | | | |
| LP 2.01 PLANTING DETAILS | | | | | | | |
| LP 2.02 | PLANTING DETAILS | | | | | | |

OWNER

-NOT FOR CONSTRUCTION



ROCKWALL ECONOMIC
DEVELOPEMENT CORPORATION
2610 OBSERVATION TRAIL, SUITE 104
ROCKWALL, TX 75032
CONTACT: MATT WAVERING

Kimley» Horn

2500 PACIFIC AVENUE, SUITE 1100 DALLAS, TX 775226 PHONE: (972) 910 2925 CONTACT: BEN RANKIN, PLA ROCKWALL TECHNOLOGY PARK, BLOCK A, LOT 8

JUNE 2025

No. REVISIONS DATE

13455 NOEL RD. TWO GALLERIA OFFICE TOWER SUITE 700 DALLAS, TX 75240 PHONE: 972-770-1300 FAX: 972-239-3820 www.KIMLEY-HORN.COM TX F-928

FOR REVIEW ONLY
Not for construction or permit purposes.


Kimley >>>> Horn


Engineer BEN RANKIN
RLA No. 2904 Date 06/18/2025

U645844U5
DATE
06/18/2025
SCALE AS SHOWN
DESIGNED BY BLR
DRAWN BY MLM
CHECKED BY BLR

POND
PREPARED FOR
ROCKWALL ECONOMIC
/ELOPMENT CORPORATIC

COVERSHEET

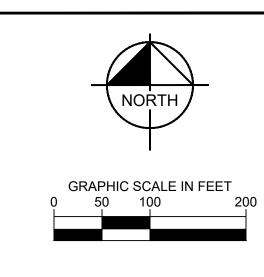

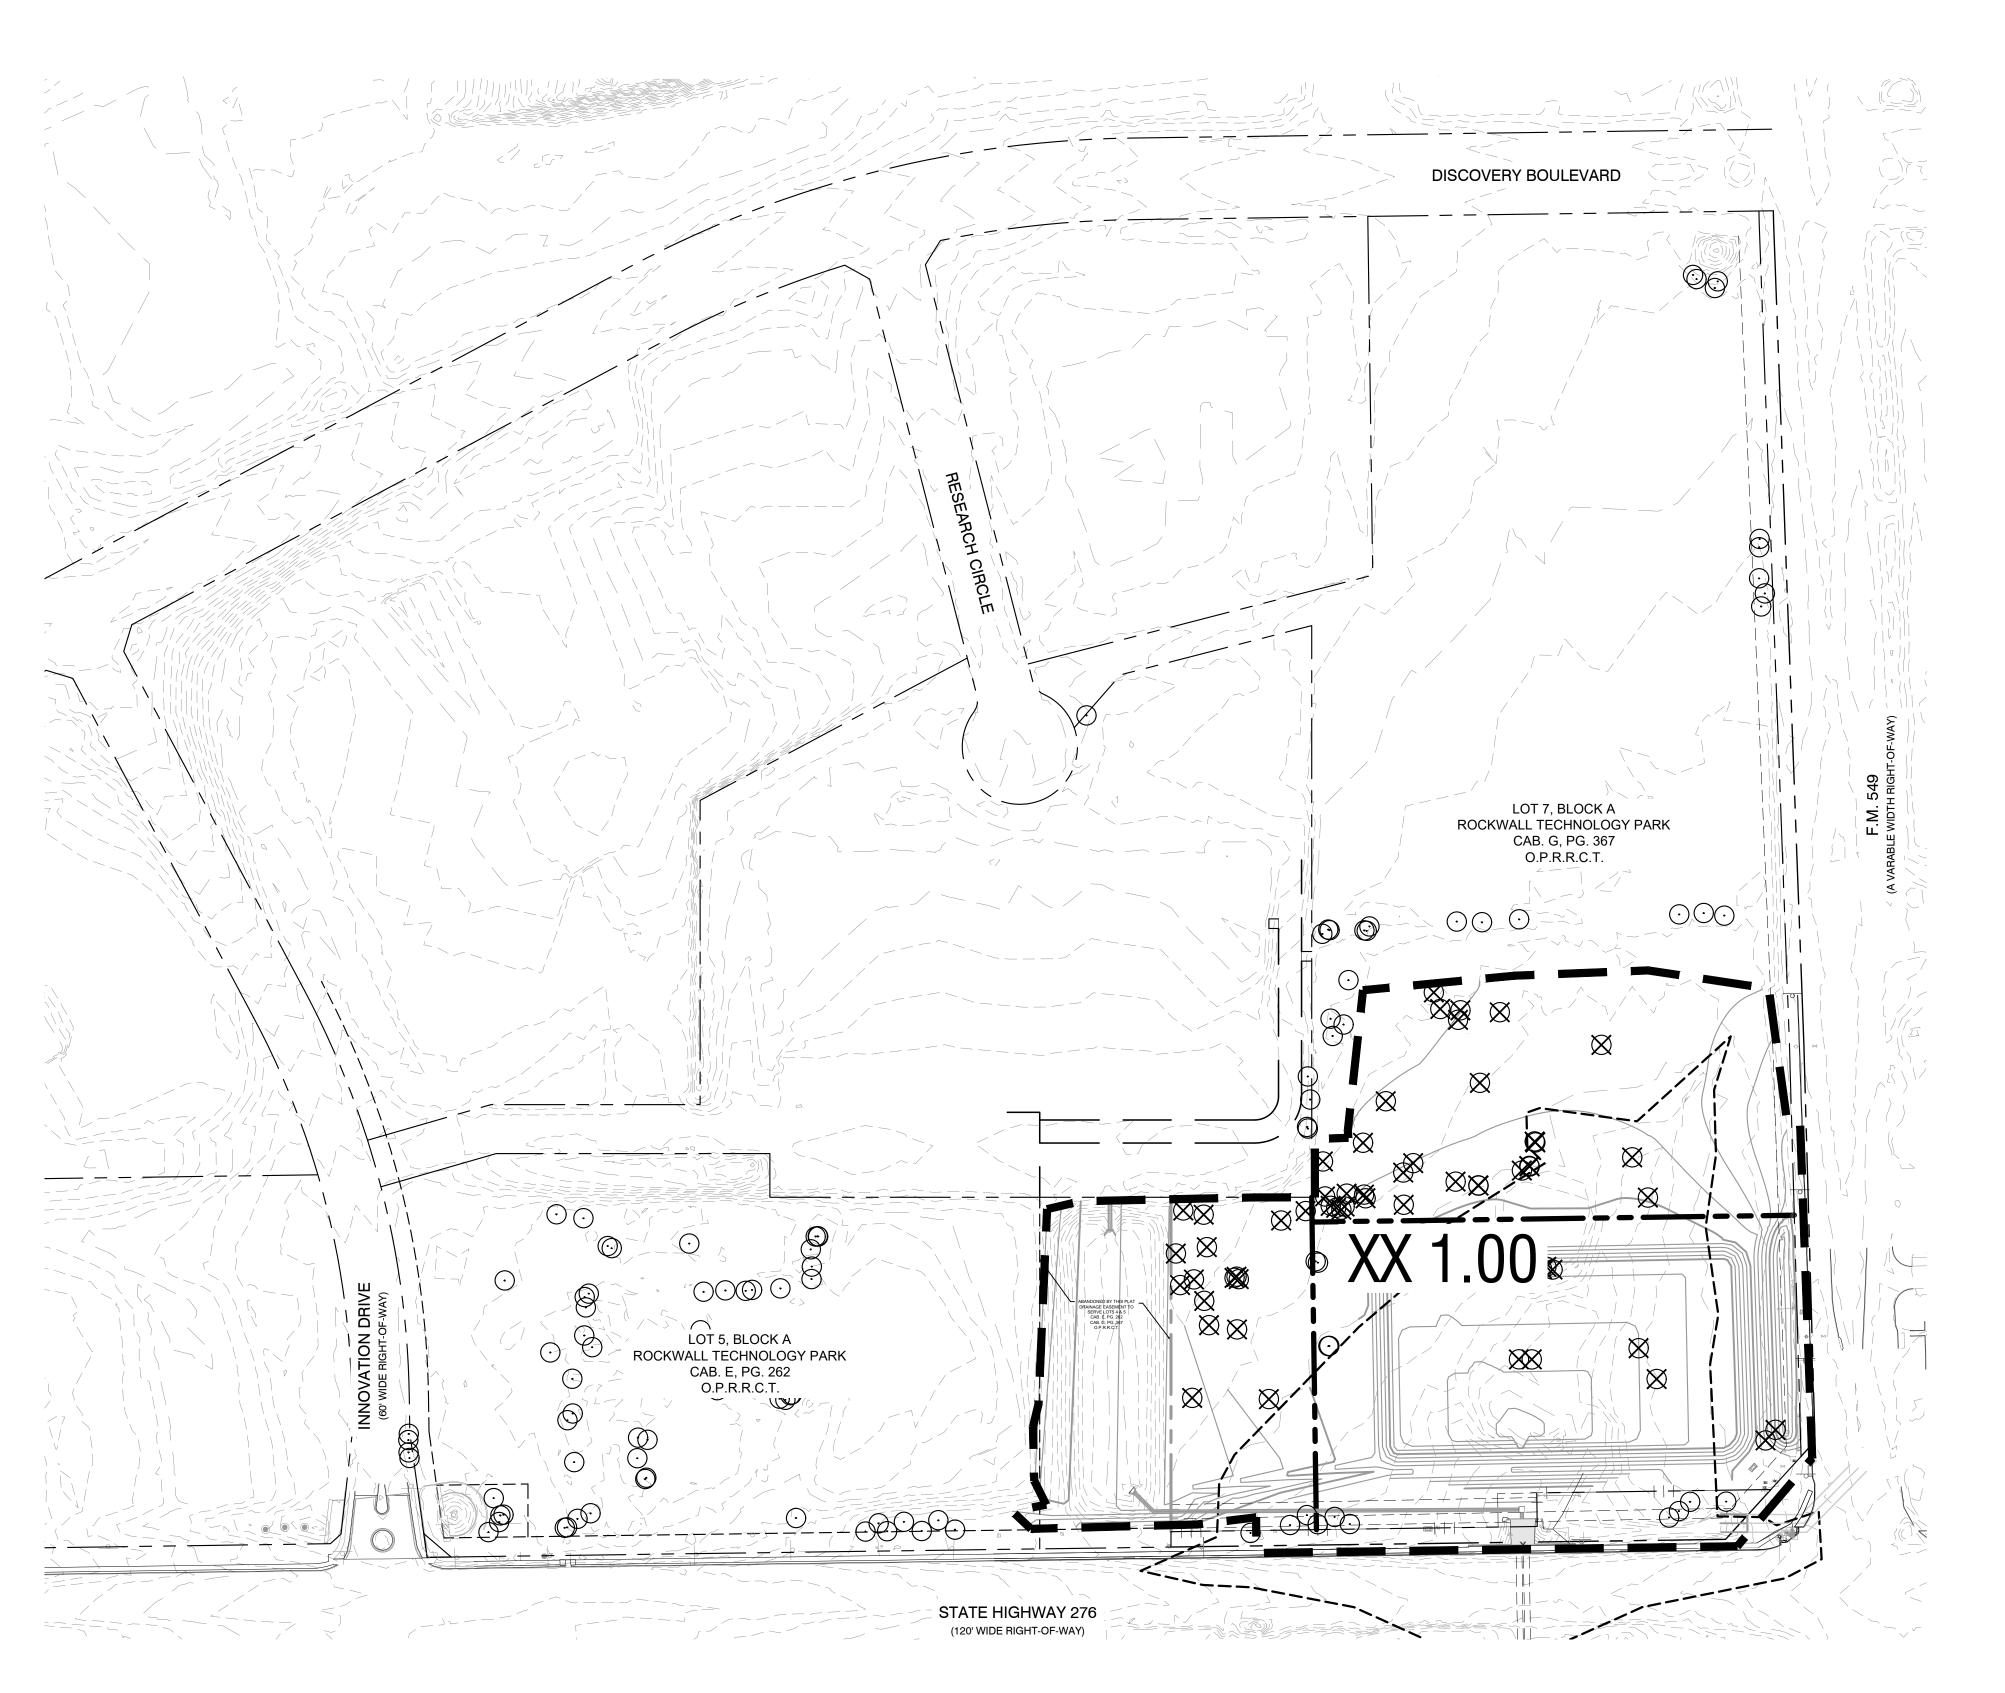


FOR REVIEW ONLY
Not for construction or permit purposes.

Kimley >>>> Horn Engineer BEN RANKIN
RLA No. 2904 Date 06/18/2025

KEY MAP

TP 0.00

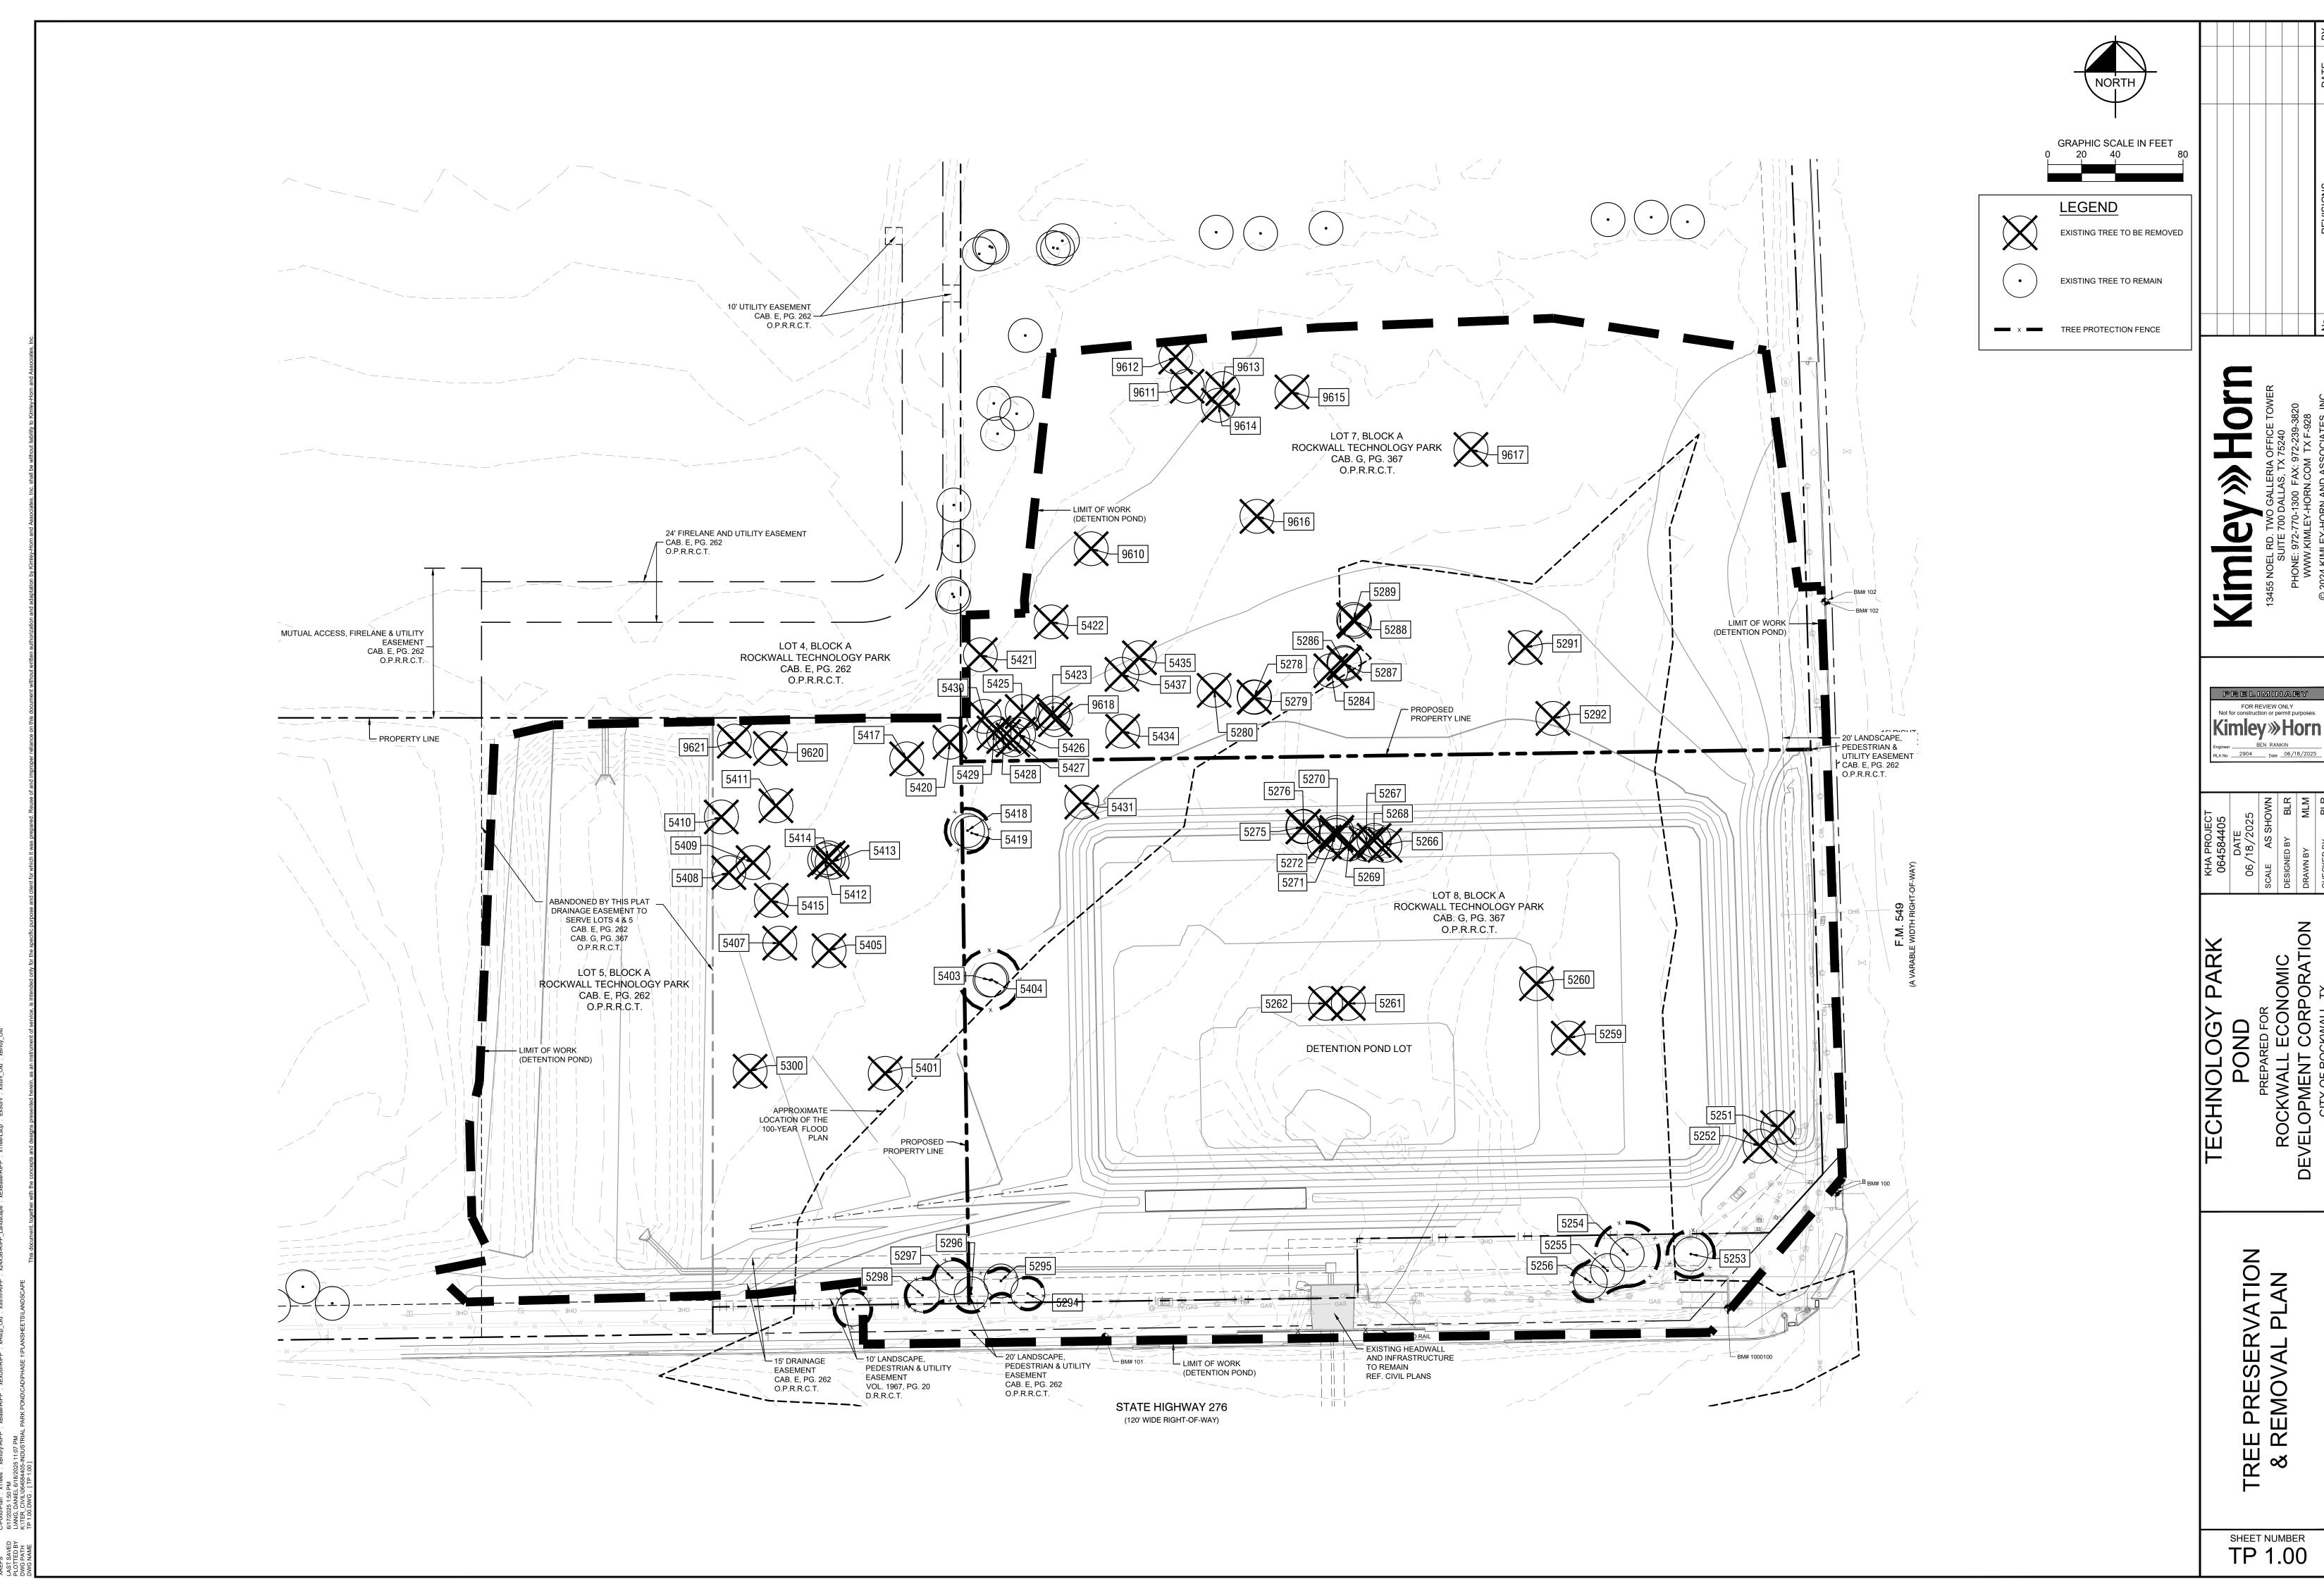

| TAG# | DBH | COMMON NAME | SCIENTIFIC NAME | CONDITION | MULTIPLE- STEMMED | TAG# | DBH | COMMON NAME | SCIENTIFIC NAME |
|----------------------|--------------|--------------------------------------|---|----------------------|----------------------|--------------|--------------|--------------------------------------|---|
| 5251 | 10.2 | live oak | Quercus virginiana | Healthy | Single | 9540 | 11.0 | hackberry | Celtis laevigata |
| 5252 5253 | 8.7 13.7 | live oak live oak | Quercus virginiana Quercus virginiana | Healthy Healthy | Single Single | 9541 9542 | 15.6 4.4 | hackberry Hercules-club | Celtis laevigata Zanthoxylum clava-he |
| 5254 | 18.9 | eastern redcedar | Juniperus virginiana | Healthy | Multi | 9543 | 5.8 | Hercules-club | Zanthoxylum clava-he |
| 5255 5256 | 11.8 11.4 | live oak live oak | Quercus virginiana Quercus virginiana | Healthy Healthy | Single Single | 9544 9545 | 12.8 4.7 | hackberry Hercules-club | Celtis laevigata Zanthoxylum clava-he |
| 3230 | 11.4 | | gs 5257-5258 were not used. | ricaltry | Sirigie | 9546 | 15.8 | hackberry | Celtis laevigata |
| 5259 5260 | 18.2 28.3 | Osage-orange | Maclura pomifera Maclura pomifera | Healthy | Multi Multi | 9547 9548 | 4.2 13.3 | Hercules-club hackberry | Zanthoxylum clava-he Celtis laevigata |
| 5261 | 11.6 | Osage-orange honey locust | Gleditsia triacanthos | Healthy Declining | Multi | 9549 | 15.2 | hackberry | Celtis laevigata |
| 5262 | 9.9 | Osage-orange | Maclura pomifera | Healthy | Multi | 9550 9551 | 14.4 11.6 | hackberry | Celtis laevigata Celtis laevigata |
| 5266 | 10.2 | black willow | gs 5263-5265 were not used. Salix nigra | Declining | Single | 9552 | 11.0 | hackberry hackberry | Celtis laevigata |
| 5267 | 13.0 | hackberry | Celtis laevigata | Healthy | Forked | 9553 | 11.7 | hackberry | Celtis laevigata |
| 5268 5269 | 13.1 15.3 | black willow eastern redcedar | Salix nigra Juniperus virginiana | Hazard Healthy | Single Multi | 9554 9555 | 13.9 14.9 | hackberry hackberry | Celtis laevigata Celtis laevigata |
| 5270 | 11.0 | black willow | Salix nigra | Declining | Single | 9556 | 11.6 | hackberry | Celtis laevigata |
| 5271 5272 | 18.8 7.2 | hackberry | Celtis laevigata | Healthy | Multi | 9557 9558 | 12.3 13.3 | hackberry hackberry | Celtis laevigata Celtis laevigata |
| 3272 | 1.2 | eastern redcedar | Juniperus virginiana gs 5273-5274 were not used. | Healthy | Single | 9559 | 30.6 | hackberry | Celtis laevigata |
| 5275 | 8.3 | eastern redcedar | Juniperus virginiana | Healthy | Multi | 9560 9561 | 16.1 14.8 | hackberry live oak | Celtis laevigata Quercus virginiai |
| 5276 | 6.8 | hackberry | Celtis laevigata | Healthy | Multi | 9562 | 12.1 | live oak | Quercus virginiai |
| 5278 | 9.1 | eastern redcedar | Tag 5277 was not used. Juniperus virginiana | Healthy | Multi | 9563 9564 | 9.6 11.2 | live oak live oak | Quercus virginiai Quercus virginiai |
| 5279 | 6.3 | hackberry | Celtis laevigata | Healthy | Single | 9565 | 11.9 | live oak | Quercus virginiai |
| 5280 | 6.2 | eastern redcedar | Juniperus virginiana gs 5281-5283 were not used. | Healthy | Single | 9566 9567 | 11.7 11.3 | live oak | Quercus virginia |
| 5284 | 7.4 | hackberry | Celtis laevigata | Healthy | Single | 9568 | 20.1 | live oak hackberry | Quercus virginiai Celtis laevigata |
| E000 | 0.5 | | Tag 5285 was not used. | I la altia. | Oin ala | 9569 | 13.8 | hackberry | Celtis laevigata |
| 5286 5287 | 9.5 8.1 | eastern cottonwood hackberry | Populus deltoides Celtis laevigata | Healthy Healthy | Single Single | 9570 9571 | 12.2 8.8 | hackberry chittamwood | Celtis laevigata Sideroxylon lanuging |
| 5288 | 20.3 | Osage-orange | Maclura pomifera | Healthy | Multi | 9572 | 13.6 | hackberry | Celtis laevigata |
| 5289 | 8.6 | Osage-orange | Maclura pomifera Tag 5290 was not used. | Healthy | Multi | 9573 9574 | 12.2 11.9 | hackberry hackberry | Celtis laevigata Celtis laevigata |
| 5291 | 10.7 | honey locust | Gleditsia triacanthos | Declining | Multi | 9574 | 11.8 | eastern redcedar | Juniperus virginia |
| 5292 | 14.6 | Osage-orange | Maclura pomifera | Healthy | Multi | 9576 | 14.1 | eastern redcedar | Juniperus virginia |
| 5294 | 8.5 | live oak | Tag 5293 was not used. Quercus virginiana | Healthy | Single | 9577 9578 | 11.6 11.2 | eastern redcedar eastern redcedar | Juniperus virginia Juniperus virginia |
| 5295 | 6.5 | live oak | Quercus virginiana | Healthy | Single | 9579 | 14.4 | eastern redcedar | Juniperus virginia |
| 5296 5297 | 9.9 | live oak live oak | Quercus virginiana Quercus virginiana | Healthy Healthy | Forked Single | 9580 9581 | 16.7 12.7 | eastern redcedar eastern redcedar | Juniperus virginia Juniperus virginia |
| 5298 | 9.0 | live oak | Quercus virginiana | Healthy | Single | 9582 | 12.1 | eastern redcedar | Juniperus virginia |
| 5200 T | 22.6 | Ocada aranga | Tag 5299 was not used. | Doolining | NA. II+i | 9583 | 14.2 | eastern redcedar | Juniperus virginia |
| 5300 | 22.6 | Osage-orange Ta | Maclura pomifera gs 5301-5400 were not used. | Declining | Multi | 9584 9585 | 5.8 8.8 | Hercules-club live oak | Zanthoxylum clava-he Quercus virginiai |
| 5401 | 15.8 | Osage-orange | Maclura pomifera | Healthy | Forked | 9586 | 7.7 | live oak | Quercus virginiai |
| 5403 | 17.4 | Osago orango | Tag 5402 was not used. Maclura pomifera | Healthy | Multi | 9587 9588 | 5.0 6.4 | live oak live oak | Quercus virginiai Quercus virginiai |
| 5404 | 7.5 | Osage-orange honey locust | Gleditsia triacanthos | Healthy | Single | 9589 | 7.7 | live oak | Quercus virginiai |
| 5405 | 16.3 | Osage-orange | Maclura pomifera | Healthy | Multi | 9590 | 12.7 | hackberry | Celtis laevigata |
| 5407 | 14.8 | Osage-orange | Tag 5406 was not used. Maclura pomifera | Healthy | Multi | 9591 9592 | 14.6 11.2 | hackberry hackberry | Celtis laevigata Celtis laevigata |
| 5408 | 22.9 | Osage-orange | Maclura pomifera | Healthy | Multi | 9593 | 14.3 | hackberry | Celtis laevigata |
| 5409 | 16.6 | eastern redcedar | Juniperus virginiana | Healthy | Multi | 9594 9595 | 12.2 13.9 | eastern redcedar hackberry | Juniperus virginia Celtis laevigata |
| 5410 5411 | 27.2 | Osage-orange Osage-orange | Maclura pomifera Maclura pomifera | Healthy Healthy | Multi Multi | 9596 | 8.1 | Hercules-club | Zanthoxylum clava-he |
| 5412 | 19.1 | Osage-orange | Maclura pomifera | Healthy | Multi | 9597 9598 | 8.4 16.3 | chittamwood hackberry | Sideroxylon lanugind Celtis laevigata |
| 5413 5414 | 8.0 10.9 | honey locust Osage-orange | Gleditsia triacanthos Maclura pomifera | Healthy Healthy | Single Multi | 9599 | 11.0 | hackberry | Celtis laevigata |
| 5415 | 9.0 | eastern redcedar | Juniperus virginiana | Healthy | Single | 9600 | 11.1 | hackberry eastern redcedar | Celtis laevigata |
| 5417 | 9.8 | eastern redcedar | Tag 5416 was not used. Juniperus virginiana | Hoolthy | Multi | 9601 9602 | 15.9 12.6 | eastern redcedar | Juniperus virginia Juniperus virginia |
| 5418 | 12.4 | eastern redcedar | Juniperus virginiana | Healthy Healthy | Multi | 9603 | 11.2 | eastern redcedar | Juniperus virginia |
| 5419 | 7.6 | eastern redcedar | Juniperus virginiana | Healthy | Single | 9604 9605 | 13.0 12.4 | eastern redcedar eastern redcedar | Juniperus virginia Juniperus virginia |
| 5420 5421 | 16.3 10.9 | Osage-orange eastern redcedar | Maclura pomifera Juniperus virginiana | Healthy Healthy | Multi Multi | 9606 | 11.1 | eastern redcedar | Juniperus virginia |
| 5422 | 18.9 | eastern redcedar | Juniperus virginiana | Healthy | Multi | 9607 | 12.3 | eastern redcedar | Juniperus virginia |
| 5423 | 8.6 | eastern redcedar | Juniperus virginiana Tag 5424 was not used. | Healthy | Single | 9608 9609 | 16.3 11.9 | eastern redcedar eastern redcedar | Juniperus virginia Juniperus virginia |
| 5425 | 13.2 | Osage-orange | Maclura pomifera | Healthy | Multi | 9610 | 15.2 | eastern redcedar | Juniperus virginia |
| 5426 | 8.0 | hackberry | Celtis laevigata | Healthy | Single | 9611 9612 | 13.8 11.2 | eastern redcedar eastern redcedar | Juniperus virginia Juniperus virginia |
| 5427 5428 | 12.8 7.8 | Osage-orange Osage-orange | Maclura pomifera Maclura pomifera | Healthy Healthy | Multi Single | 9613 | 11.5 | eastern redcedar | Juniperus virginia |
| 5429 | 6.7 | eastern redcedar | Juniperus virginiana | Healthy | Single | 9614 9615 | 11.7 11.1 | eastern redcedar eastern redcedar | Juniperus virginia Juniperus virginia |
| 5430 5431 | 5.6 14.8 | eastern redcedar eastern redcedar | Juniperus virginiana Juniperus virginiana | Healthy Healthy | Single Multi | 9616 | 13.6 | eastern redcedar | Juniperus virginia |
| 3431 | 14.0 | | gs 5432-5433 were not used. | Неанпу | IVIUITI | 9617 | 12.6 | eastern redcedar | Juniperus virginia |
| 5434 | 17.3 | eastern redcedar | Juniperus virginiana | Healthy | Multi | 9618 9619 | 12.2 10.1 | eastern redcedar live oak | Juniperus virginia Quercus virginiai |
| 5435 | 10.6 | eastern redcedar | Juniperus virginiana Tag 5436 was not used. | Healthy | Forked | 9620 | 13.7 | eastern redcedar | Juniperus virginia |
| 5437 | 4.9 | eastern redcedar | Juniperus virginiana | Healthy | Single | 9621 9622 | 11.4 15.3 | eastern redcedar cedar elm | Juniperus virginia Ulmus crassifoli |
| 9518 | 6.2 | | gs 5438-9517 were not used. Magnolia grandiflora | Lloolthy | NAulti | 3022 | 10.0 | ocdar cim | Cilitae oraconon |
| 9519 | 6.3 7.2 | southern magnolia southern magnolia | | Healthy Healthy | Multi Forked | Kimle | ev-Horn | red tag series: 5251 | -5256; 5259-5262; 5266-52 |
| 9520 | 7.1 | southern magnolia | Magnolia grandiflora | Healthy | Forked | | - | _ | ; 5300; 5401; 5403-5405; 5 |
| 9521 9522 | 4.8 13.9 | southern magnolia eastern redcedar | Magnolia grandiflora Juniperus virginiana | Healthy Healthy | Single Multi | | | | Trees measuring 4-inche |
| 9523 | 4.7 | Hercules-club | Zanthoxylum clava-herculis | Declining | Single | | | | |
| 9524 | 11.2 | eastern redcedar | Juniperus virginiana | Healthy | Multi | | | | |
| 9525 9526 | 14.2 14.5 | eastern redcedar eastern redcedar | Juniperus virginiana Juniperus virginiana | Healthy Healthy | Single Forked | | | | |
| 9527 | 21.3 | eastern redcedar | Juniperus virginiana | Hazard | Forked | | | | |
| 9528 | 16.2 | hackberry | Celtis laevigata | Healthy | Multi | | | | |
| 9529 9530 | 23.2 | hackberry hackberry | Celtis laevigata Celtis laevigata | Healthy Healthy | Multi Forked | | | | |
| 9531 | 18.8 | hackberry | Celtis laevigata | Healthy | Forked | | | | |
| | 13.7 | hackberry | Celtis laevigata | Healthy | Multi | | | | |
| 9532 9533 | | hackherry | Celtis laevinata | Healthy | Single | | | | |
| 9532 9533 9534 | 11.2 16.5 | hackberry hackberry | Celtis laevigata Celtis laevigata | Healthy Healthy | Single Multi | | | | |

Healthy Single
Healthy Single
Healthy Forked
Healthy Single

Celtis laevigata

Zanthoxylum clava-herculis

Zanthoxylum clava-herculis

Celtis laevigata

9536 14.6

hackberry Hercules-club

Hercules-club

hackberry

| | SCIENTIFIC NAME | CONDITION | MULTIPLE STEMMED |
|---|---|--------------------|------------------|
| | Celtis laevigata | Healthy | Multi |
| | Celtis laevigata | Healthy | Single |
| | Zanthoxylum clava-herculis | Healthy | Single |
| | Zanthoxylum clava-herculis | Healthy | Single |
| | Celtis laevigata Zanthoxylum clava-herculis | Healthy | Multi |
| | Celtis laevigata | Healthy Healthy | Single |
| | Zanthoxylum clava-herculis | Healthy | Single Single |
| | Celtis laevigata | Healthy | Forked |
| | Celtis laevigata | Healthy | Multi |
| | Celtis laevigata | Healthy | Multi |
| | Celtis laevigata | Healthy | Single |
| | Celtis laevigata | Healthy | Single |
| | Celtis laevigata | Healthy | Single |
| | Celtis laevigata | Healthy | Multi |
| | Celtis laevigata | Healthy | Multi |
| | Celtis laevigata | Declining | Single |
| | Celtis laevigata | Healthy | Forked |
| | Celtis laevigata | Declining | Single |
| | Celtis laevigata | Healthy | Multi |
| | Celtis laevigata | Healthy | Multi |
| | Quercus virginiana | Healthy | Single |
| | Quercus virginiana | Healthy | Single |
| | Quercus virginiana | Healthy | Single |
| | Quercus virginiana | Healthy | Single |
| | Quercus virginiana | Healthy | Single |
| | Quercus virginiana | Healthy | Single |
| | Quercus virginiana | Healthy | Single |
| | Celtis laevigata | Healthy | Forked |
| | Celtis laevigata | Healthy | Multi |
| | Celtis laevigata | Healthy | Forked |
| | Sideroxylon lanuginosum | Declining | Single |
| | Celtis laevigata | Healthy | Single |
| | Celtis laevigata | Healthy | Single |
| | Celtis laevigata Juniperus virginiana | Healthy | Multi Multi |
| _ | Juniperus virginiana Juniperus virginiana | Healthy Healthy | Multi |
| | Juniperus virginiana Juniperus virginiana | Healthy | Multi |
| | Juniperus virginiana Juniperus virginiana | Healthy | Multi |
| | Juniperus virginiana | Healthy | Multi |
| _ | Juniperus virginiana | Healthy | Forked |
| | Juniperus virginiana | Healthy | Single |
| _ | Juniperus virginiana | Healthy | Multi |
| _ | Juniperus virginiana | Declining | Multi |
| _ | Zanthoxylum clava-herculis | Healthy | Single |
| _ | Quercus virginiana | Healthy | Single |
| _ | Quercus virginiana | Healthy | Single |
| _ | Quercus virginiana | Healthy | Single |
| _ | Quercus virginiana | Healthy | Single |
| _ | Quercus virginiana | Healthy | Single |
| _ | Celtis laevigata | Healthy | Multi |
| | Celtis laevigata | Healthy | Multi |
| | Celtis laevigata | Healthy | Single |
| _ | Celtis laevigata | Healthy | Forked |
| | Juniperus virginiana | Healthy | Single |
| • | Celtis laevigata | Healthy | Multi |
| _ | Zanthoxylum clava-herculis | Healthy | Single |
| _ | Sideroxylon lanuginosum | Healthy | Single |
| _ | Celtis laevigata | Healthy | Multi |
| _ | Celtis laevigata | Healthy | Single |
| _ | Celtis laevigata | Healthy | Multi |
| | Juniperus virginiana | Healthy | Multi |
| _ | Juniperus virginiana | Healthy | Multi |
| _ | Juniperus virginiana | Healthy | Forked |
| | Juniperus virginiana | Healthy | Forked |
| _ | Juniperus virginiana | Healthy | Multi |
| _ | Juniperus virginiana | Healthy | Single |
| • | Juniperus virginiana | Healthy | Forked |
| _ | Juniperus virginiana | Healthy | Multi |
| _ | Juniperus virginiana | Healthy | Multi |
| _ | Juniperus virginiana | Healthy | Multi |
| _ | Juniperus virginiana | Healthy | Forked |
| _ | Juniperus virginiana | Healthy | Multi |
| _ | Juniperus virginiana | Healthy | Multi |
| _ | Juniperus virginiana | Healthy | Multi |
| _ | Juniperus virginiana | Healthy | Multi |
| _ | Juniperus virginiana | Healthy | Forked |
| _ | Juniperus virginiana | Healthy | Multi |
| _ | | Healthy | Multi |
| | Juniperus virginiana | пеанну | Multi |

-5272; 5275-5276; 5278-5280; 5284; ; 5407-5415; 5417-5423; 5425-5431; nes and larger DBH were tagg

Healthy Multi
Healthy Single
Healthy Multi
Healthy Single
Healthy Forked

| DETENTION POND LOT (LOT 8) | | | | | | | | | |
|----------------------------|-----------------------|-------------------|---------------------|------|------------------|----------------------|---------------------------|--|--|
| Tree Types | | | | | | TREES REMOVED | | | |
| COMMON NAME | SCIENTIFIC NAME | PRIMARY PROTECTED | SECONDARY PROTECTED | QTY. | CALIPER (Inches) | 8' HEIGHT OR GREATER | MITIGATION INCHES REMOVED | | |
| BLACK WILLOW | SALIX NIGRA | X | | 3 | 34.3 | | 34.3 | | |
| EASTERN REDCEDAR | JUNIPERUS VIRGINIANA | | X | 3 | | 1 | 4 | | |
| HACKBERRY | CELTIS LAEVIGATA | | | 3 | 38.6 | | | | |
| HONEY LOCUST | GLEDITSIA TRIACANTHOS | | | 1 | 11.6 | | | | |
| LIVE OAK | QUERCUS VIRGINIANA | Х | | 2 | 18.9 | | 18.9 | | |
| OSAGE-ORANGE | MACLURA POMIFERA | | | 3 | 56.4 | | | | |
| | | | | | | | | | |
| | | | | | | | | | |
| | | | Total | 15 | 159.8 | 1 | 57.2 | | |

| LOT 5 | | | | | | | | | | |
|------------------|-----------------------|-------------------|---------------------|------|------------------|----------------------|---------------------------|--|--|--|
| Tree Types | | | | | TREES REMOVED | | | | | |
| COMMON NAME | SCIENTIFIC NAME | PRIMARY PROTECTED | SECONDARY PROTECTED | QTY. | CALIPER (Inches) | 8' HEIGHT OR GREATER | MITIGATION INCHES REMOVED | | | |
| EASTERN REDCEDAR | JUNIPERUS VIRGINIANA | | X | 5 | | 3 | 12 | | | |
| HONEY LOCUST | GLEDITSIA TRIACANTHOS | | | 1 | 8 | | | | | |
| OSAGE-ORANGE | MACLURA POMIFERA | | | 10 | 186.1 | | | | | |
| | | | | | | | | | | |
| | | | | | | | | | | |
| | | | Total | 16 | 194.1 | 3 | 12 | | | |

| LOT 7 | | | | | | | | | | |
|---|-----------------------|--|-------|---------------|------------------|----------------------|---------------------------|--|--|--|
| Tree Types | | | | TREES REMOVED | | | | | | |
| COMMON NAME SCIENTIFIC NAME PRIMARY PROTECTED SECONDARY PROTECTED | | | | QTY. | CALIPER (Inches) | 8' HEIGHT OR GREATER | MITIGATION INCHES REMOVED | | | |
| EASTERN REDCEDAR | JUNIPERUS VIRGINIANA | | X | 28 | | 21 | 84 | | | |
| EASTERN COTTONWOOD | POPULUS DELTOIDES | | | 1 | 9.5 | | | | | |
| HACKBERRY | CELTIS LAEVIGATA | | | 4 | 29.8 | | | | | |
| HONEY LOCUST | GLEDITSIA TRIACANTHOS | | | 1 | 10.7 | | | | | |
| OSAGE-ORANGE | MACLURA POMIFERA | | | 6 | 77.3 | | | | | |
| | | | | | | | | | | |
| | | | | | | | | | | |
| | | | Total | 40 | 127.3 | 21 | 84 | | | |

Total Mitigation Inches Removed

Total Inches Provided

Total Excess

-153.2


+390

-236.8

TREE REMOVAL NOTES:

- A. REMOVE ALL TREES INDICATED BY THE DRAWINGS AND SPECIFICATIONS, AS REQUIRING REMOVAL, IN A MANNER THAT WILL NOT DAMAGE ADJACENT TREES OR STRUCTURES OR COMPACTS THE SOIL.
- B. REMOVE TREES THAT ARE ADJACENT TO TREES OR STRUCTURES TO REMAIN, IN SECTIONS, TO LIMIT THE OPPORTUNITY OF DAMAGE TO ADJACENT CROWNS, TRUNKS, GROUND PLANE ELEMENTS AND
- C. DO NOT DROP TREES WITH A SINGLE CUT UNLESS THE TREE WILL FALL IN AN AREA NOT INCLUDED IN THE TREE PROTECTION AREA.
- D. NO TREE TO BE REMOVED WITHIN 50 FEET OF OR INSIDE THE TREE PROTECTION AREA SHALL BE PUSHED OVER OR UP-ROOTED USING A PIECE OF GRADING EQUIPMENT. NO HEAVY EQUIPMENT IS ALLOWED INSIDE THE TREE PROTECTION AREA.
- E. PROTECT ADJACENT PAVING, SOIL, TREES, SHRUBS, GROUND COVER PLANTINGS AND UNDERSTORY PLANTS TO REMAIN FROM DAMAGE DURING ALL TREE REMOVAL OPERATIONS, AND FROM CONSTRUCTION OPERATIONS. PROTECTION SHALL INCLUDE THE ROOT SYSTEM, TRUNK, LIMBS, AND CROWN FROM BREAKAGE OR SCARRING, AND THE SOIL FROM COMPACTION.
- F. REMOVE STUMPS AND IMMEDIATE ROOT PLATE FROM EXISTING TREES TO BE REMOVED. GRIND TRUNK BASES AND LARGE BUTTRESS ROOTS TO A DEPTH OF THE LARGEST BUTTRESS ROOT OR AT LEAST 18 INCHES BELOW THE TOP MOST ROOTS WHICHEVER IS LESS AND OVER THE AREA OF THREE TIMES THE DIAMETER OF THE TRUNK (DBH).
- F.A. FOR TREES WHERE THE STUMP WILL FALL UNDER NEW PAVED AREAS, GRIND ROOTS TO A TOTAL DEPTH OF 18 INCHES BELOW THE EXISTING GRADE. IF THE SIDES OF THE STUMP HOLE STILL HAVE GREATER THAN APPROXIMATELY 20% WOOD VISIBLE, CONTINUE GRINDING OPERATION DEEPER AND OR WIDER UNTIL THE RESULTING HOLE HAS LESS THAN 20% WOOD. REMOVE ALL WOOD CHIPS PRODUCED BY THE GRINDING OPERATION AND BACK FILL IN 8 INCH LAYERS WITH CONTROLLED FILL OF A QUALITY ACCEPTABLE TO THE SITE ENGINEER FOR FILL MATERIAL UNDER STRUCTURES, COMPACTED TO 95% OF THE MAXIMUM DRY DENSITY STANDARD PROCTOR. THE OWNER'S REPRESENTATIVE SHALL APPROVE EACH HOLE AT THE END OF THE GRINDING OPERATION.
- F.B. IN AREAS WHERE THE TREE LOCATION IS TO BE A PLANTING BED OR LAWN, REMOVE ALL WOODCHIPS AND BACKFILL STUMP HOLES WITH PLANTING SOIL AS DEFINED IN SPECIFICATION SECTION PLANTING SOIL, IN MAXIMUM OF 12 INCH LAYERS AND COMPACT TO 80 - 85% OF THE MAXIMUM DRY DENSITY STANDARD PROCTOR.



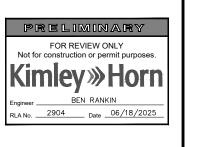

PREPARED FOR


ROCKWALL ECONOMIC


DEVELOPMENT CORPORATIC


ESERVATION S & NOTES TREE PRES

SHEET NUMBER TP 2.00

Scale: NTS

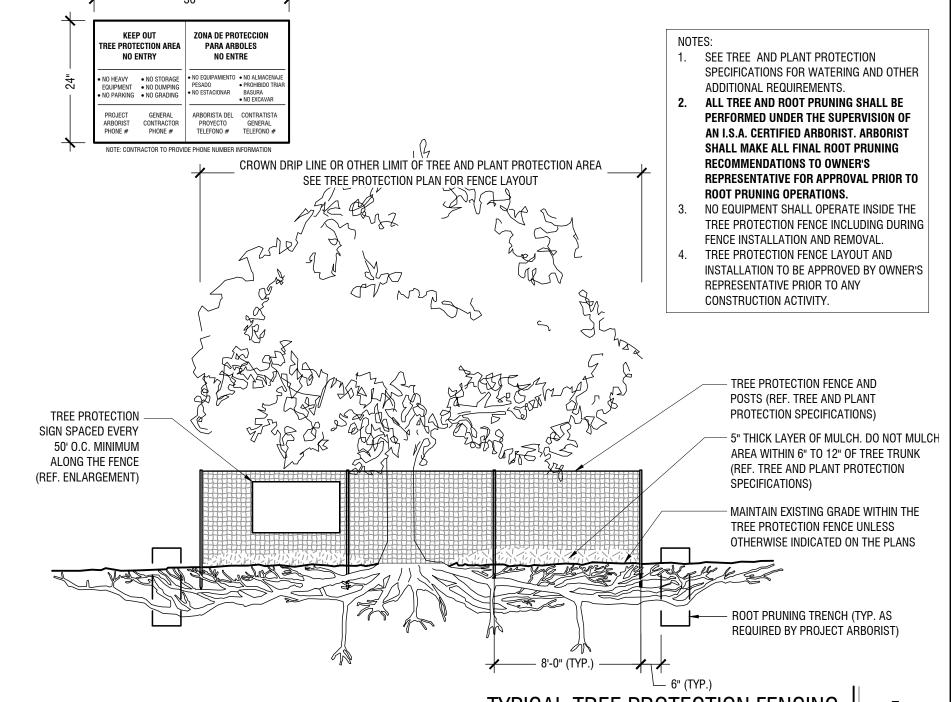

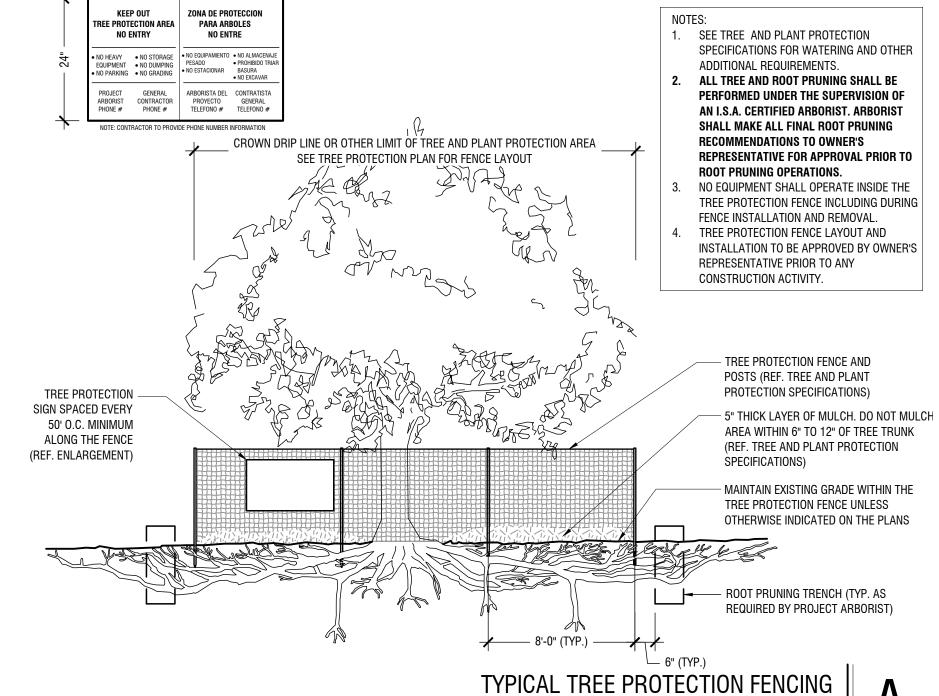

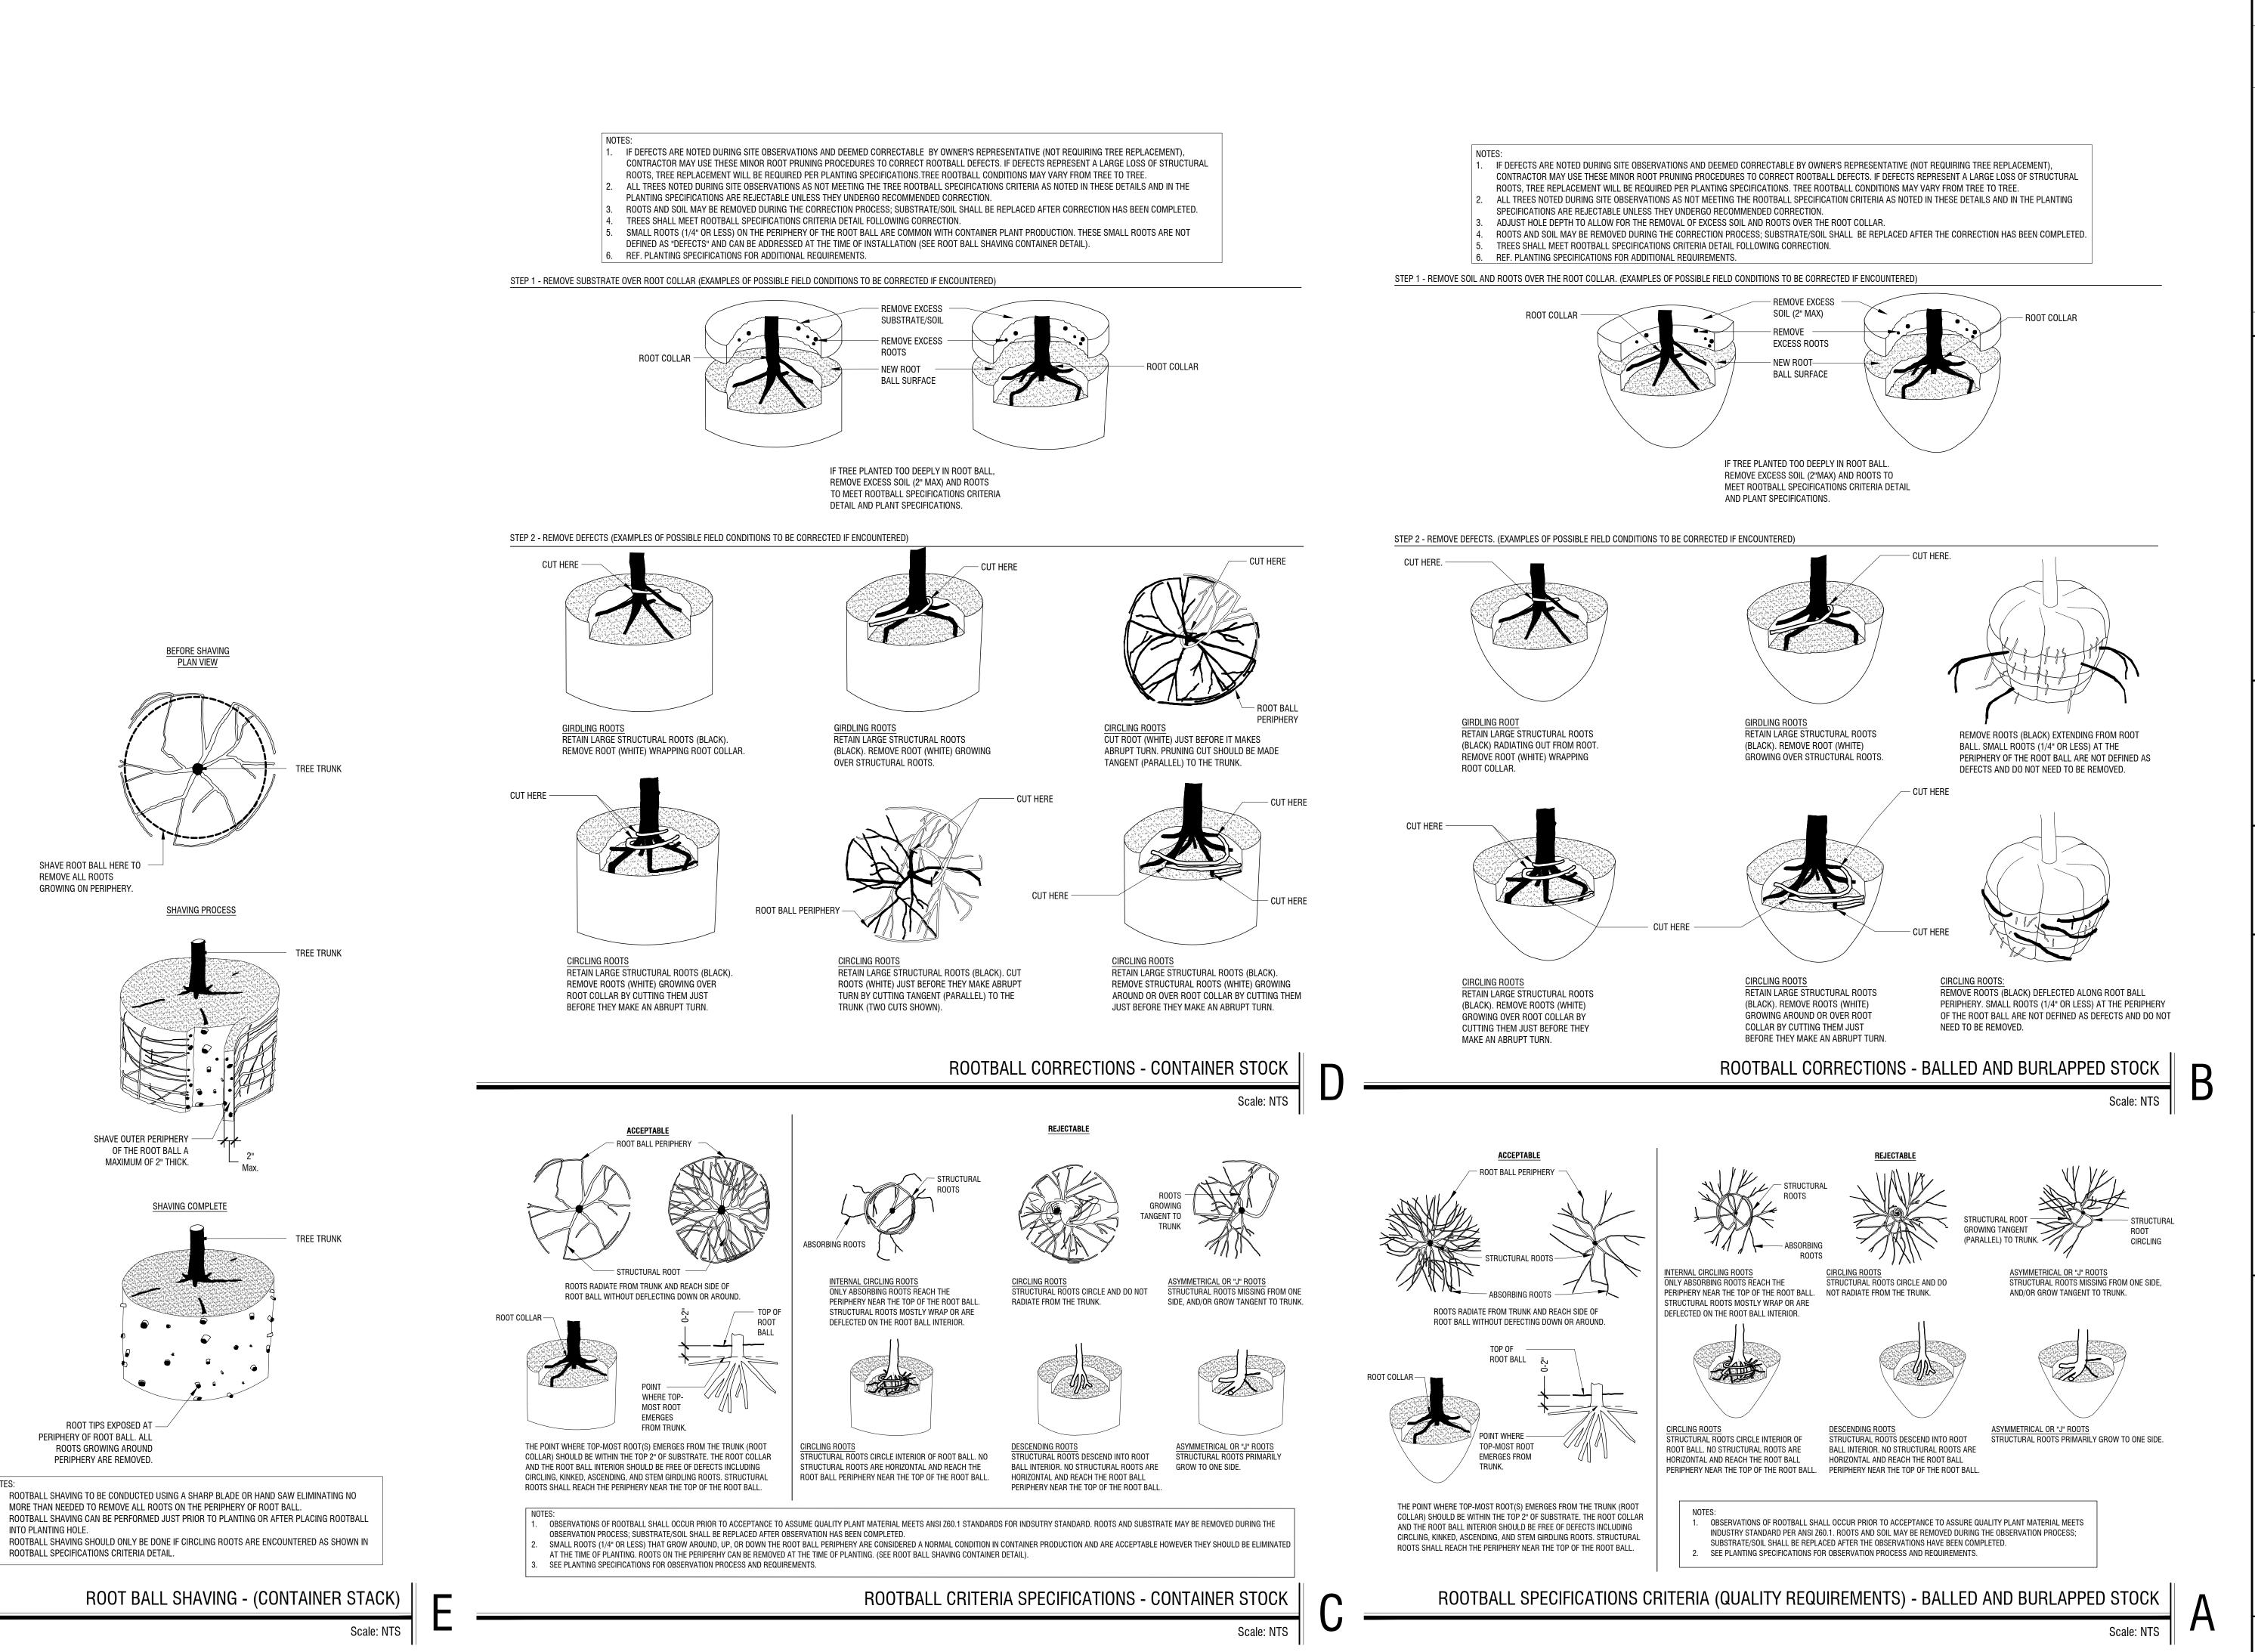

SHEET NUMBER LP 2.01

ANTING


PRELIMINARY

FOR REVIEW ONLY

Not for construction or permit purpose

Kimley»Horn

RLA No. 2904 Date 06/18/2025

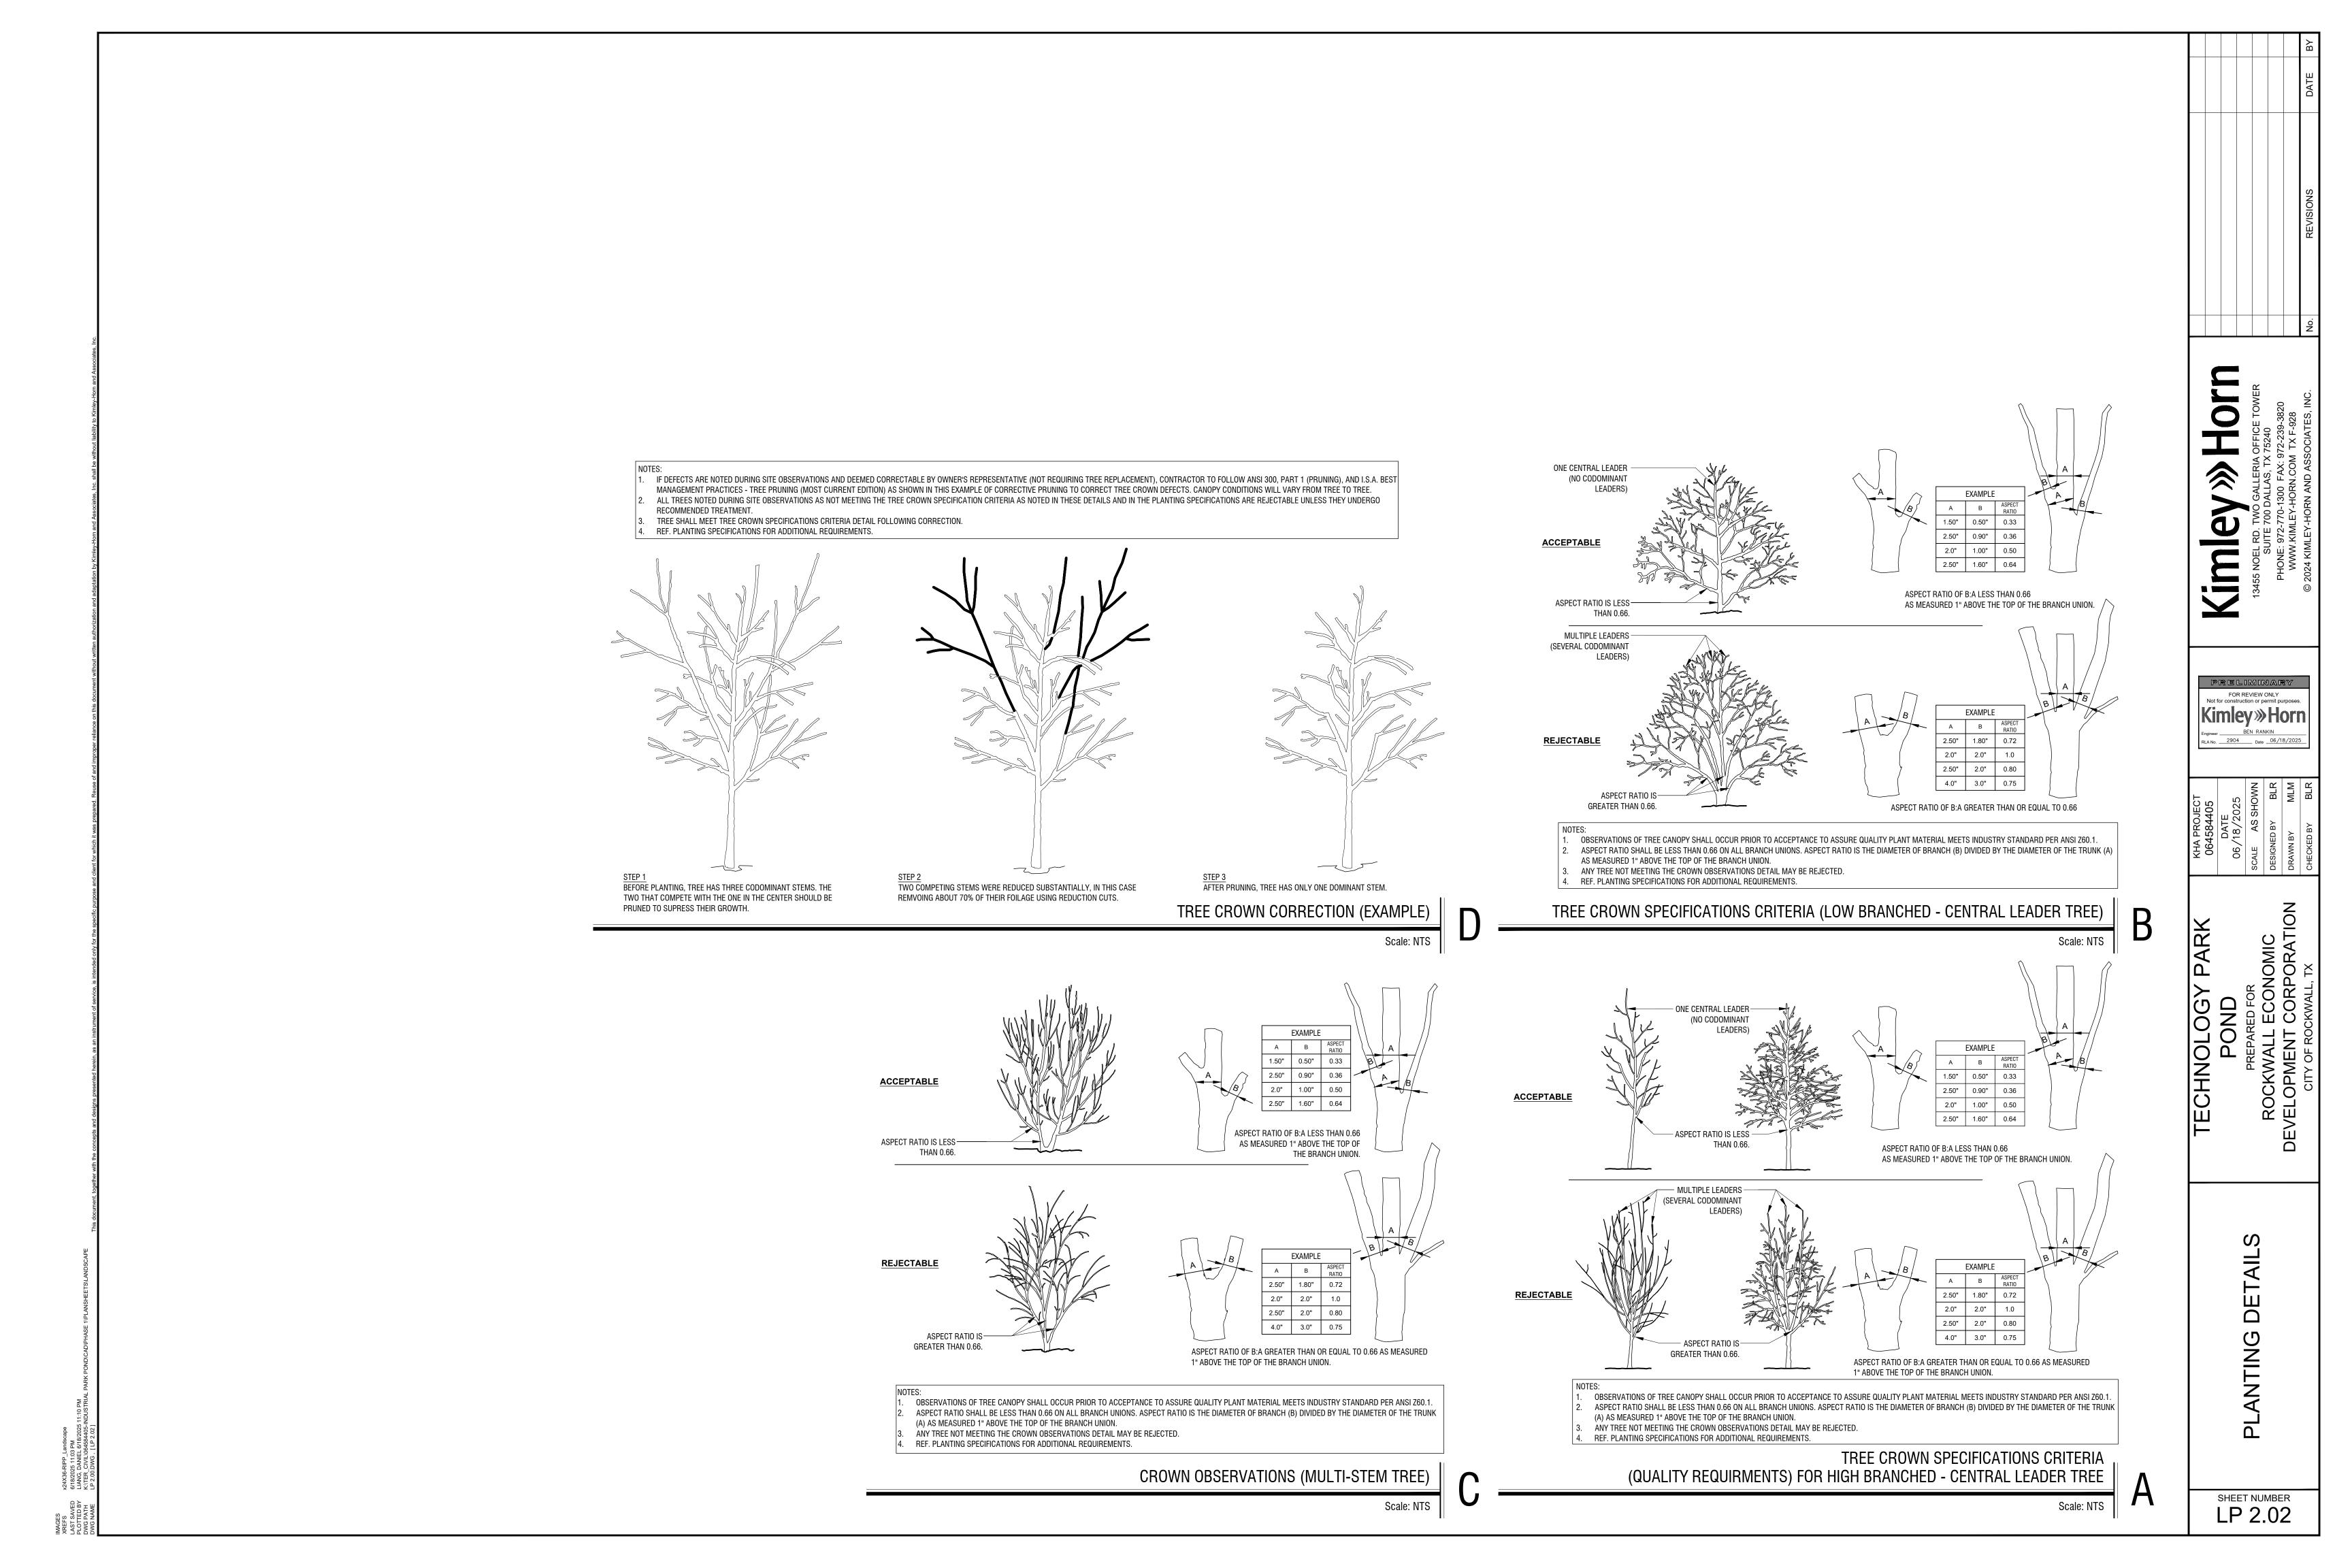



DATE: July 29, 2025

TO: Todd Martin, P.E.

Kimley-Horn & Associates 203 W. Nash Street, Suite 100

Terrell, TX 75160

CC: Shannon Foltz

Rockwall EDC

2610 Observation Trail, Suite 104

Rockwall, TX 75032

FROM: Henry Lee, Senior Planner

City of Rockwall Planning and Zoning Department

385 S. Goliad Street Rockwall, TX 75087

SUBJECT: SP2025-028; Amended Site Plan for SH-276 & Corporate Crossing

Todd Martin, P.E.,

This letter serves to notify you that the above referenced case (*i.e.* Site Plan) that you submitted for consideration by the City of Rockwall was approved by the Planning and Zoning Commission on July 15, 2025. The following is a record of all recommendations, voting records:

Conditions of Approval:

- (1) All staff comments provided by the Planning, Engineering and Fire Department must be addressed prior to the submittal of engineering plans; and,
- (2) Any construction resulting from the approval of this *Site Plan* shall conform to the requirements set forth by the Unified Development Code (UDC), the International Building Code (IBC), the Rockwall Municipal Code of Ordinances, city adopted engineering and fire codes and with all other applicable regulatory requirements administered and/or enforced by the state and federal government.

Planning and Zoning Commission

On July 15, 2025, the Planning and Zoning Commission approved a motion to approve the amended site plan by a vote of 7-0.

Should you have any questions or concerns regarding your site plan case, please feel free to contact me at (972) 772-6434.

Sincerely.

Henry Lee, AICP, Senior Planner

City of Rockwall Planning and Zoning Department