

NOTARY PUBLIC IN AND FOR THE STATE OF TEXAS

### **DEVELOPMENT APPLICATION**

City of Rockwall Planning and Zoning Department 385 S. Goliad Street Rockwall, Texas 75087

PLANNING & ZONING CASE	E NO.
	S NOT CONSIDERED ACCEPTED BY THE DIRECTOR AND CITY ENGINEER HAVE
DIRECTOR OF PLANNING:	

	Rockwall, Texas 75067		CITYEN	IGINEER:			in the state of
PLEASE CHECK THE	APPROPRIATE BOX BELOW TO INDICATE THE TY	PE OF DEVELOPM	ENT REQU	EST [SELECT	ONLY ONE BOX	<u>:</u>	
☐ PRELIMINARY F ☐ FINAL PLAT (\$300.0 ☐ REPLAT (\$300.0 ☐ AMENDING OR ☐ PLAT REINSTAT  SITE PLAN APPLIC ☐ SITE PLAN (\$25	\$100.00 + \$15.00 ACRE) <sup>1</sup> PLAT (\$200.00 + \$15.00 ACRE) <sup>1</sup> 00.00 + \$20.00 ACRE) <sup>1</sup> 0 + \$20.00 ACRE) <sup>1</sup> MINOR PLAT (\$150.00) TEMENT REQUEST (\$100.00)	☐ ZON☐ SPE(☐ PD D  OTHER☐ TREI  WARI  NOTES: 1: IN DETE PER ACRE	ING CHAN' CIFIC USE DEVELOPM APPLICAT E REMOVA IANCE REC RMINING THE AMOUNT. FO 0.00 FEE WIL	PERMIT (\$200 IENT PLANS (\$ FION FEES: LL (\$75.00) QUEST/SPECI/ FEE, PLEASE USE R REQUESTS ON LL L BE ADDED TO	\$15.00 ACRE) 1 0.00 + \$15.00 ACR 200.00 + \$15.00 A AL EXCEPTIONS THE EXACT ACREAGE ESS THAN ONE ACRE, THE APPLICATION FE NOT IN COMPLIANCE	ACRE) 1 (\$100.00) 2 E WHEN MULTIPLYII ROUND UP TO ONE E FOR ANY REQU	(1) ACRE. EST THAT
PROPERTY INFO	RMATION [PLEASE PRINT]						
ADDRESS	Northeast corner of Data Drive and S	Springer Road					
SUBDIVISION	Rockwall Technology Park Phase V			LOT	Part of 1	BLOCK	В
GENERAL LOCATION	Northeast corner of Data Drive and S	pringer Road					
ZONING, SITE PL	AN AND PLATTING INFORMATION [P	LEASE PRINT]					
CURRENT ZONING	Light Industrial - SUP No. S-320	CURRE	NT USE	Undevelo	ped		
PROPOSED ZONING	No Change	PROPOS	ED USE	Heavy Ma	nufacturing		
ACREAGE	E 22 LOTS [CURR	RENT] Part of L	arger Lo	ot LOT	S [PROPOSED]	1 New Lot	
REGARD TO ITS	PLATS: BY CHECKING THIS BOX YOU ACKNOWLEDG APPROVAL PROCESS, AND FAILURE TO ADDRESS ANY ENIAL OF YOUR CASE.	GE THAT DUE TO TO Y OF STAFF'S COMM	HE PASSAG IENTS BY TI	GE OF <u>HB3167</u> HE DATE PROV	THE CITY NO LON IDED ON THE DEV	GER HAS FLEX ELOPMENT CAL	BILITY WITH ENDAR WILL
OWNER/APPLIC	ANT/AGENT INFORMATION [PLEASE PRIN	IT/CHECK THE PRIM.	ARY CONTA	CT/ORIGINAL S	SIGNATURES ARE	REQUIRED]	
□ OWNER	Rockwall EDC	<b>Z</b> APPL	ICANT	Kimley-Hor	n and Associa	ates, Inc.	
CONTACT PERSON	Phil Wagner	CONTACT PE	RSON	Neda Hoss	einy		
ADDRESS	2610 Observation	ADI	DRESS 1	3455 Noel	Road, Two G	Salleria Offic	e Tower
	Suite 104			Suite 700			
CITY, STATE & ZIP	Rockwall, Texas 75032	CITY, STATE	- 1	Dallas, Tex			
PHONE	972.772.0025			972.770.13			
E-MAIL	pwagner@rockwalledc.com		E-MAIL r	neda.hosse	iny@kimley-h	norn.com	
	CATION [REQUIRED] RSIGNED AUTHORITY, ON THIS DAY PERSONALLY APPA ON ON THIS APPLICATION TO BE TRUE AND CERTIFIED		Wyn		[OWNER]	THE UNDERSIG	3NED, WHO
INFORMATION CONTAINE	I AM THE OWNER FOR THE PURPOSE OF THIS APPLICATION. TO COVER THE COST OF THIS APPLICATION, I 2024. BY SIGNING THIS APPLICATION, I D WITHIN THIS APPLICATION TO THE PUBLIC. THE CI TON WITH THIS APPLICATION, IF SUCH REPRODUCTION IS	ON, HAS BEEN PAID TO AGREE THAT THE CI TY IS ALSO AUTHOR	THE CITY O TY OF ROCK SIZED AND R	OF ROCKWALL OF KWALL (I.E. "CIT" PERMITTED TO	N THIS THE Y") IS AUTHORIZED REPRODUCE ANY	AND PERMITTED COPYRIGHTED II	DAY OF
GIVEN UNDER MY HAND	AND SEAL OF OFFICE ON THIS THE THE DAY OF	June	_, 20 <u>24</u> .		ARY PUR	AURA PERE Notary Publ	
	OWNER'S SIGNATURE			3(₹(		State of Texa	15







# City of Rockwall Planning & Zoning Department 385 S. Goliad Street


Rockwall, Texas 75087 (P): (972) 771-7745 (W): www.rockwall.com

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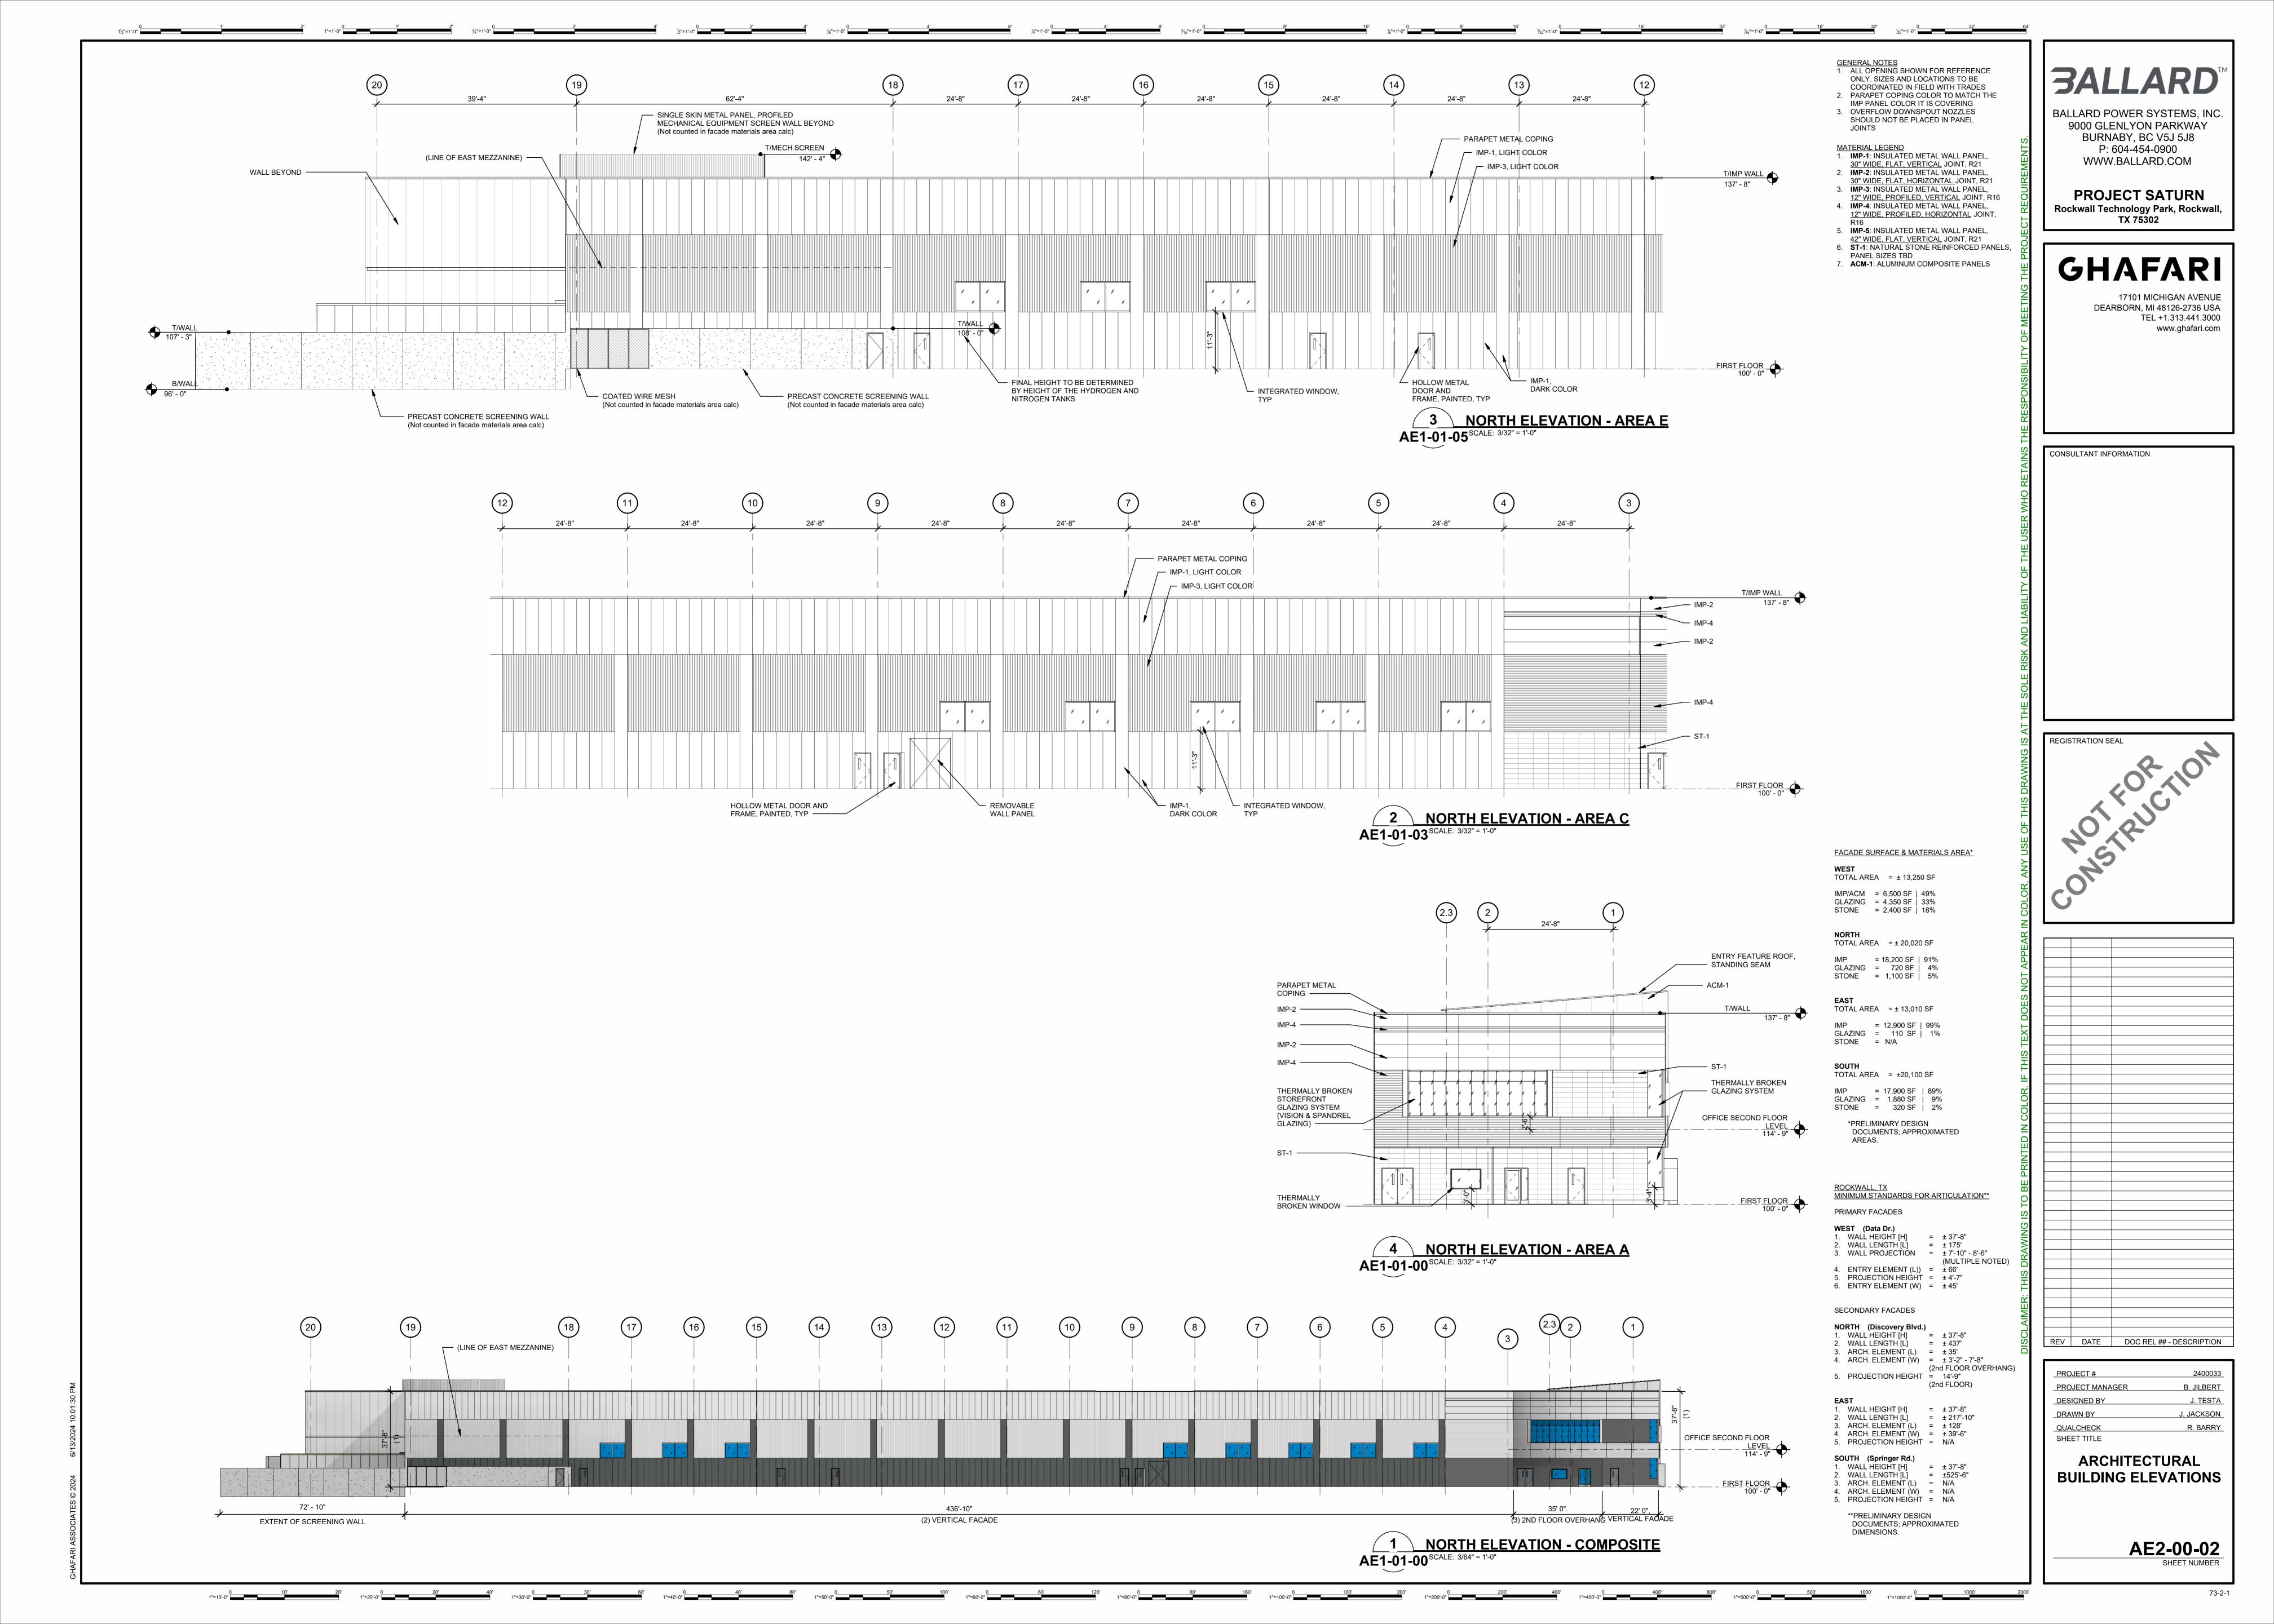





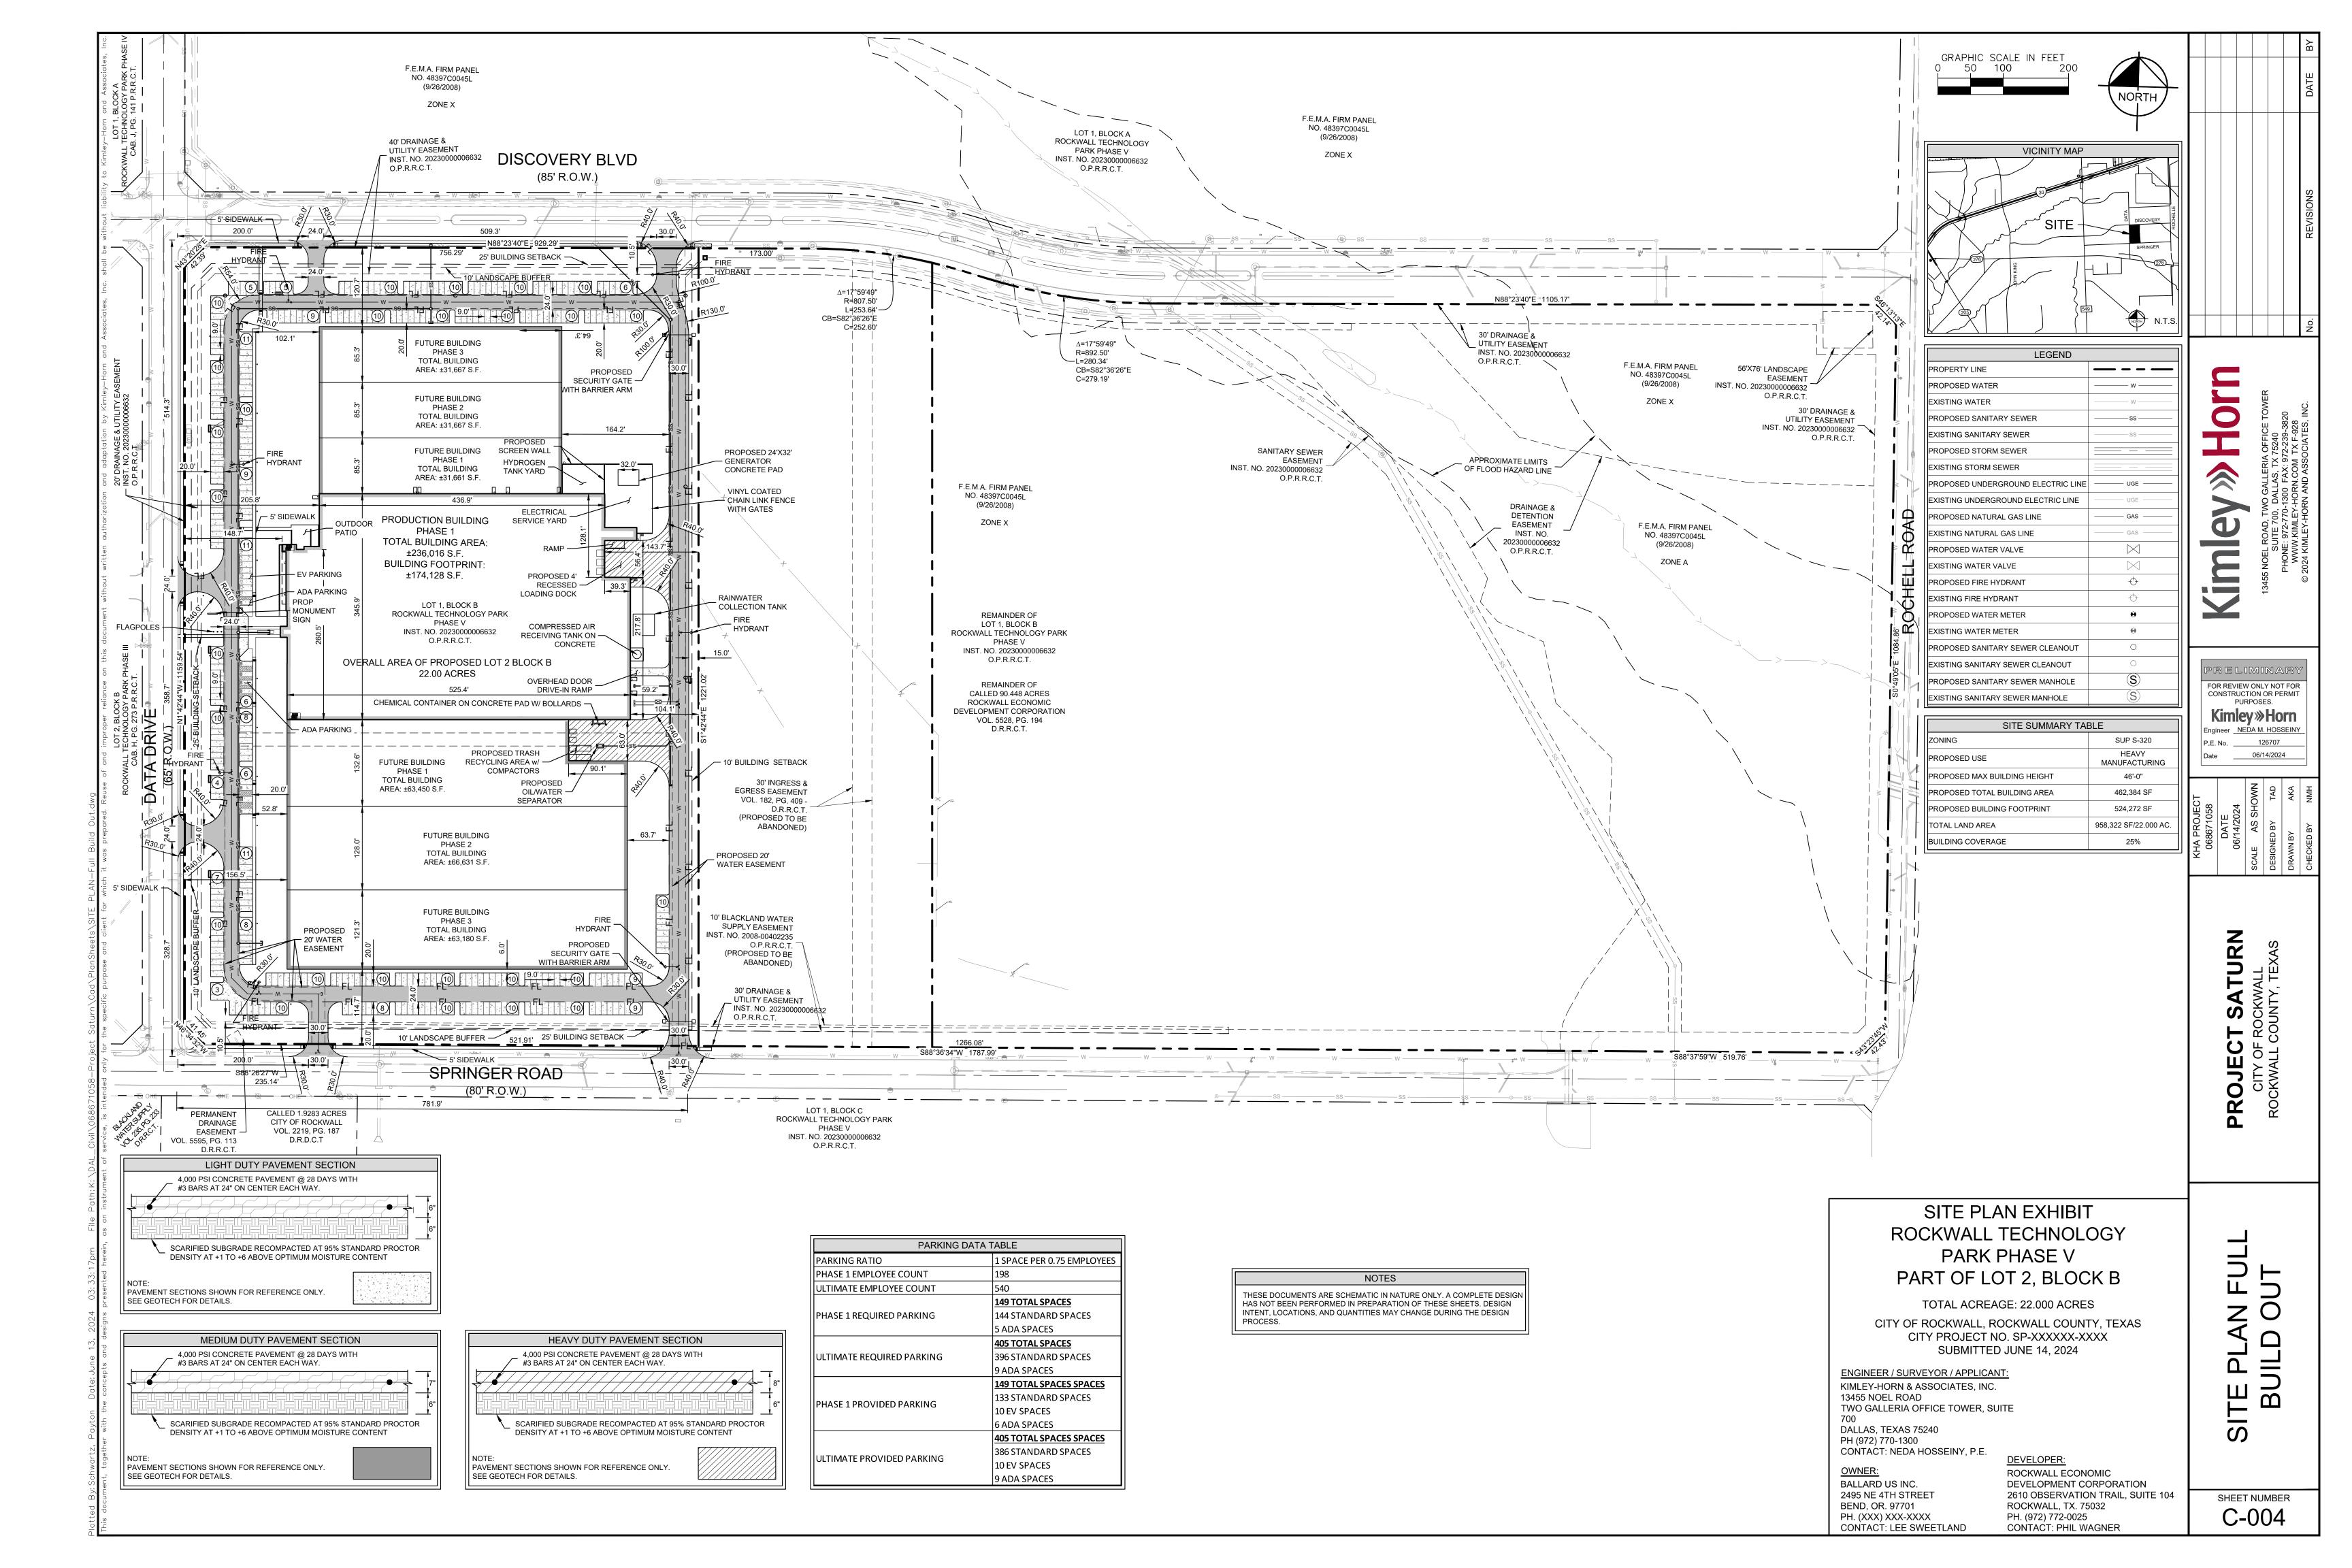


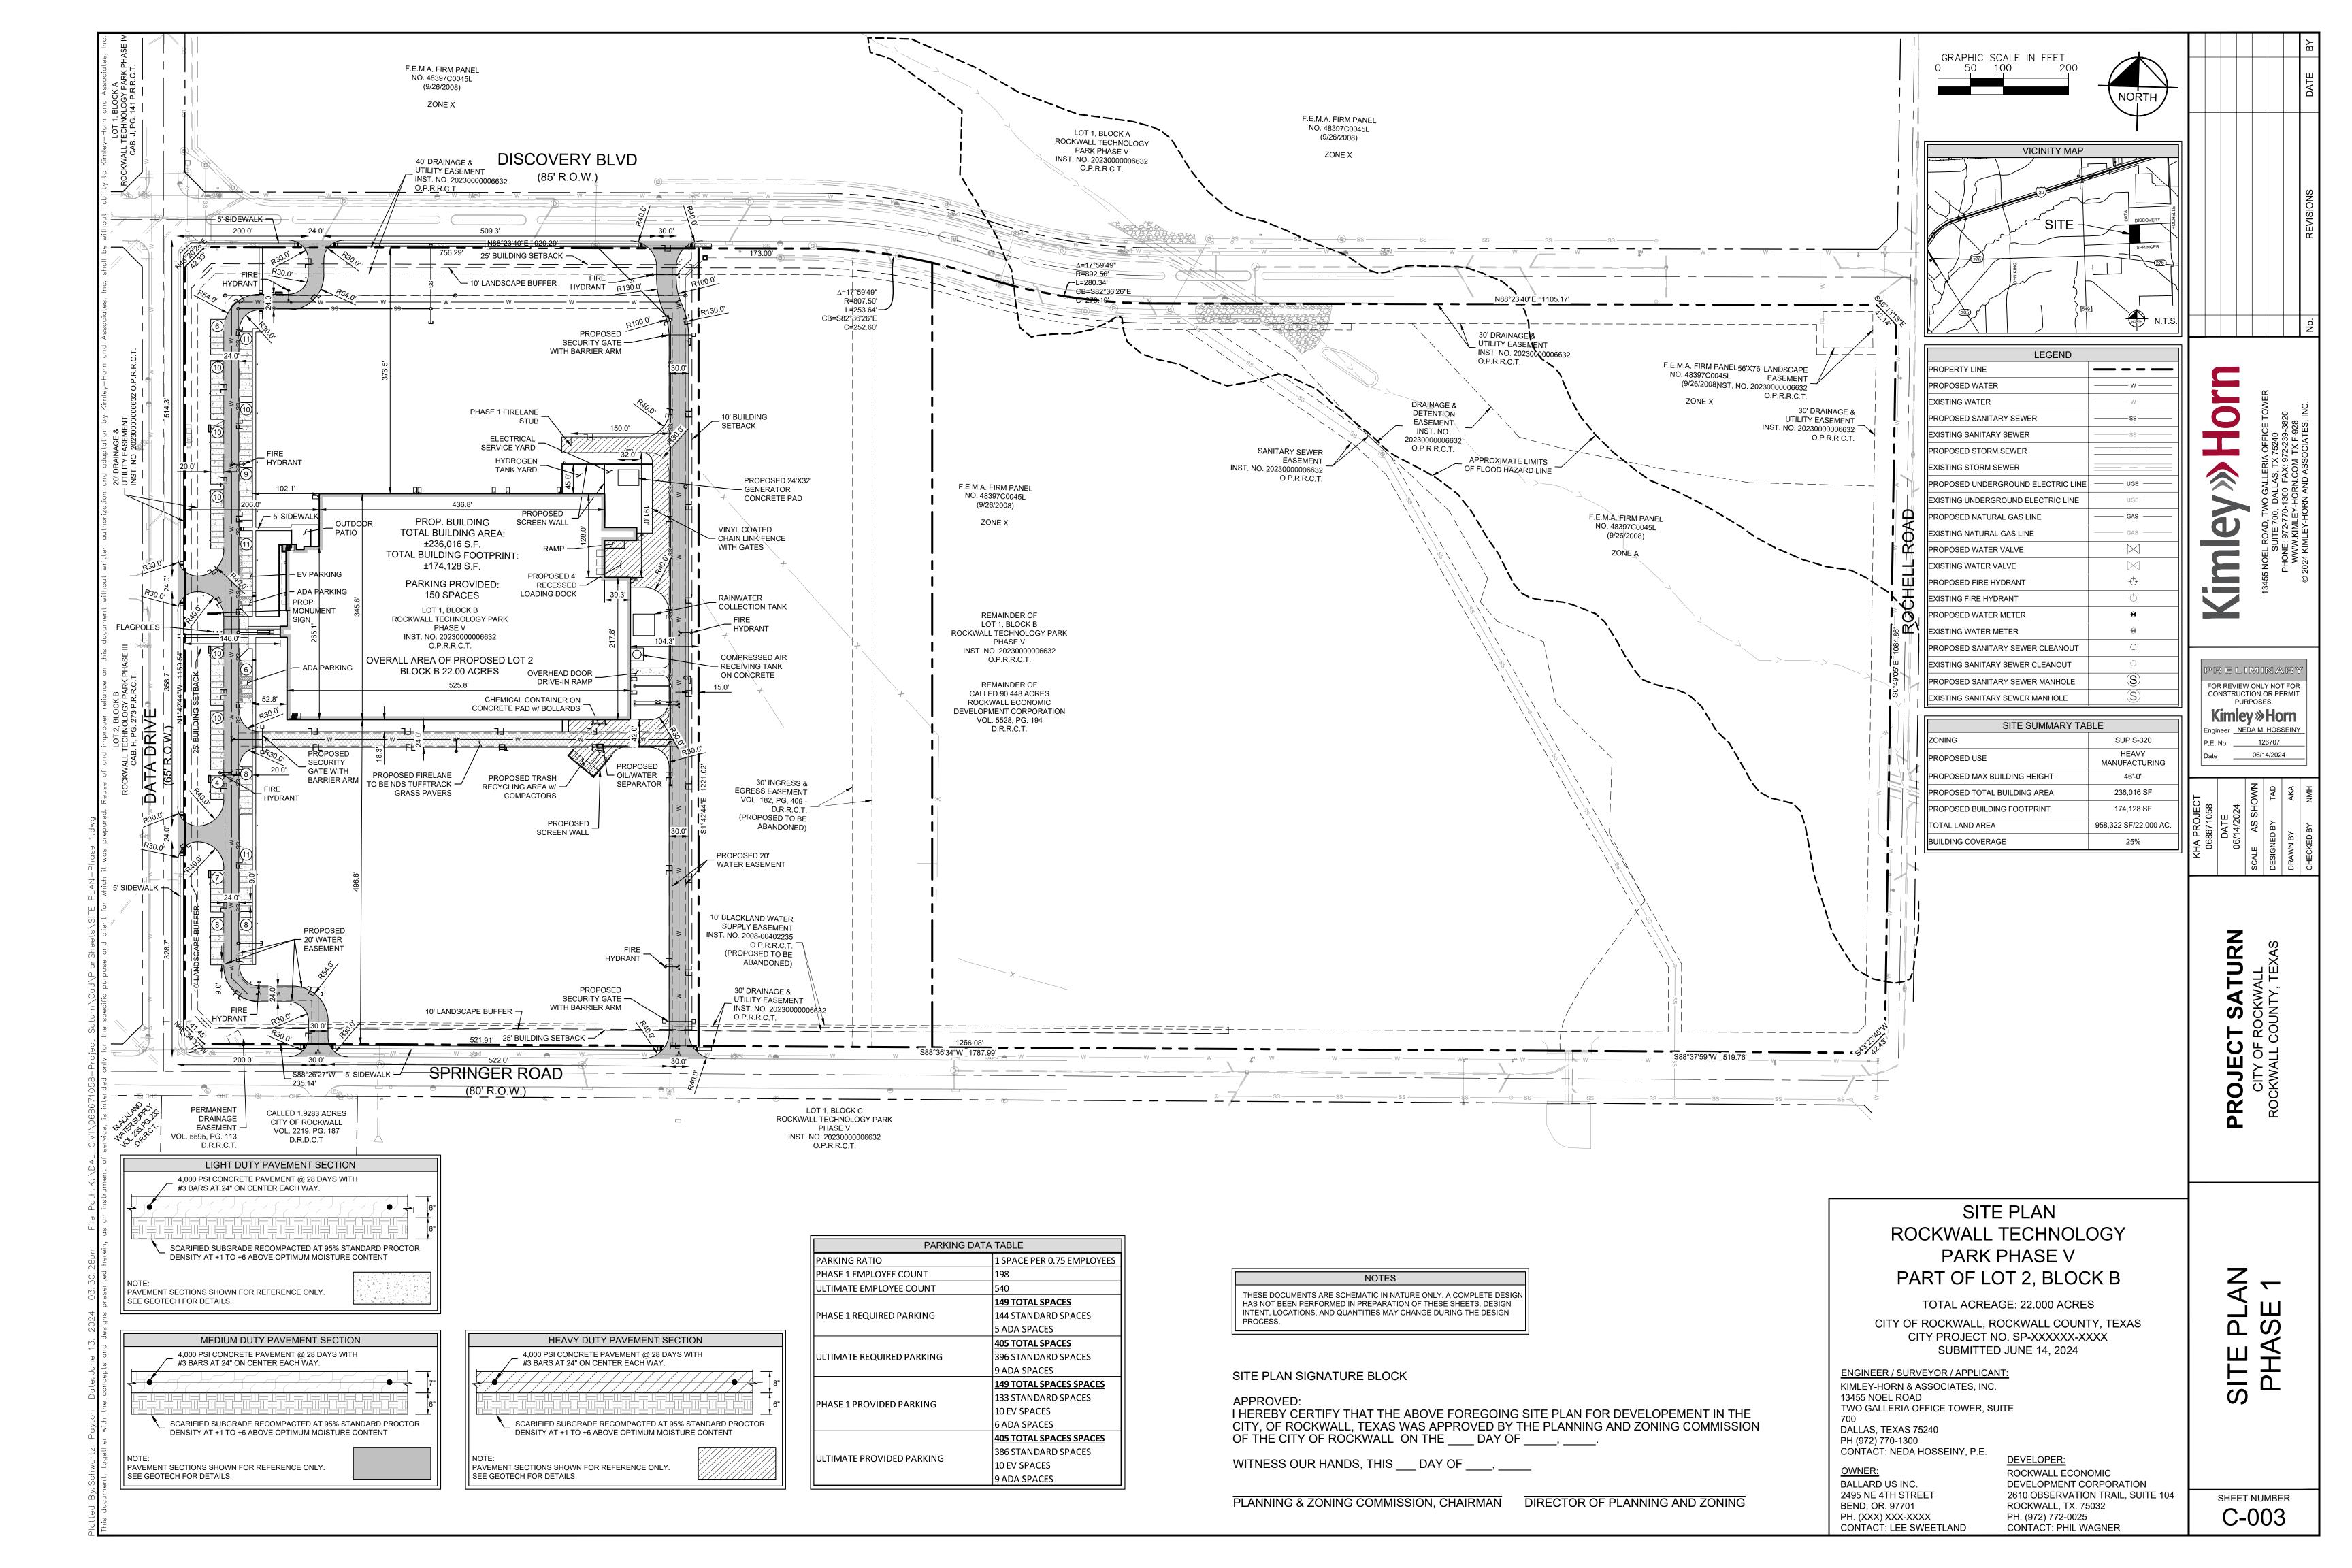

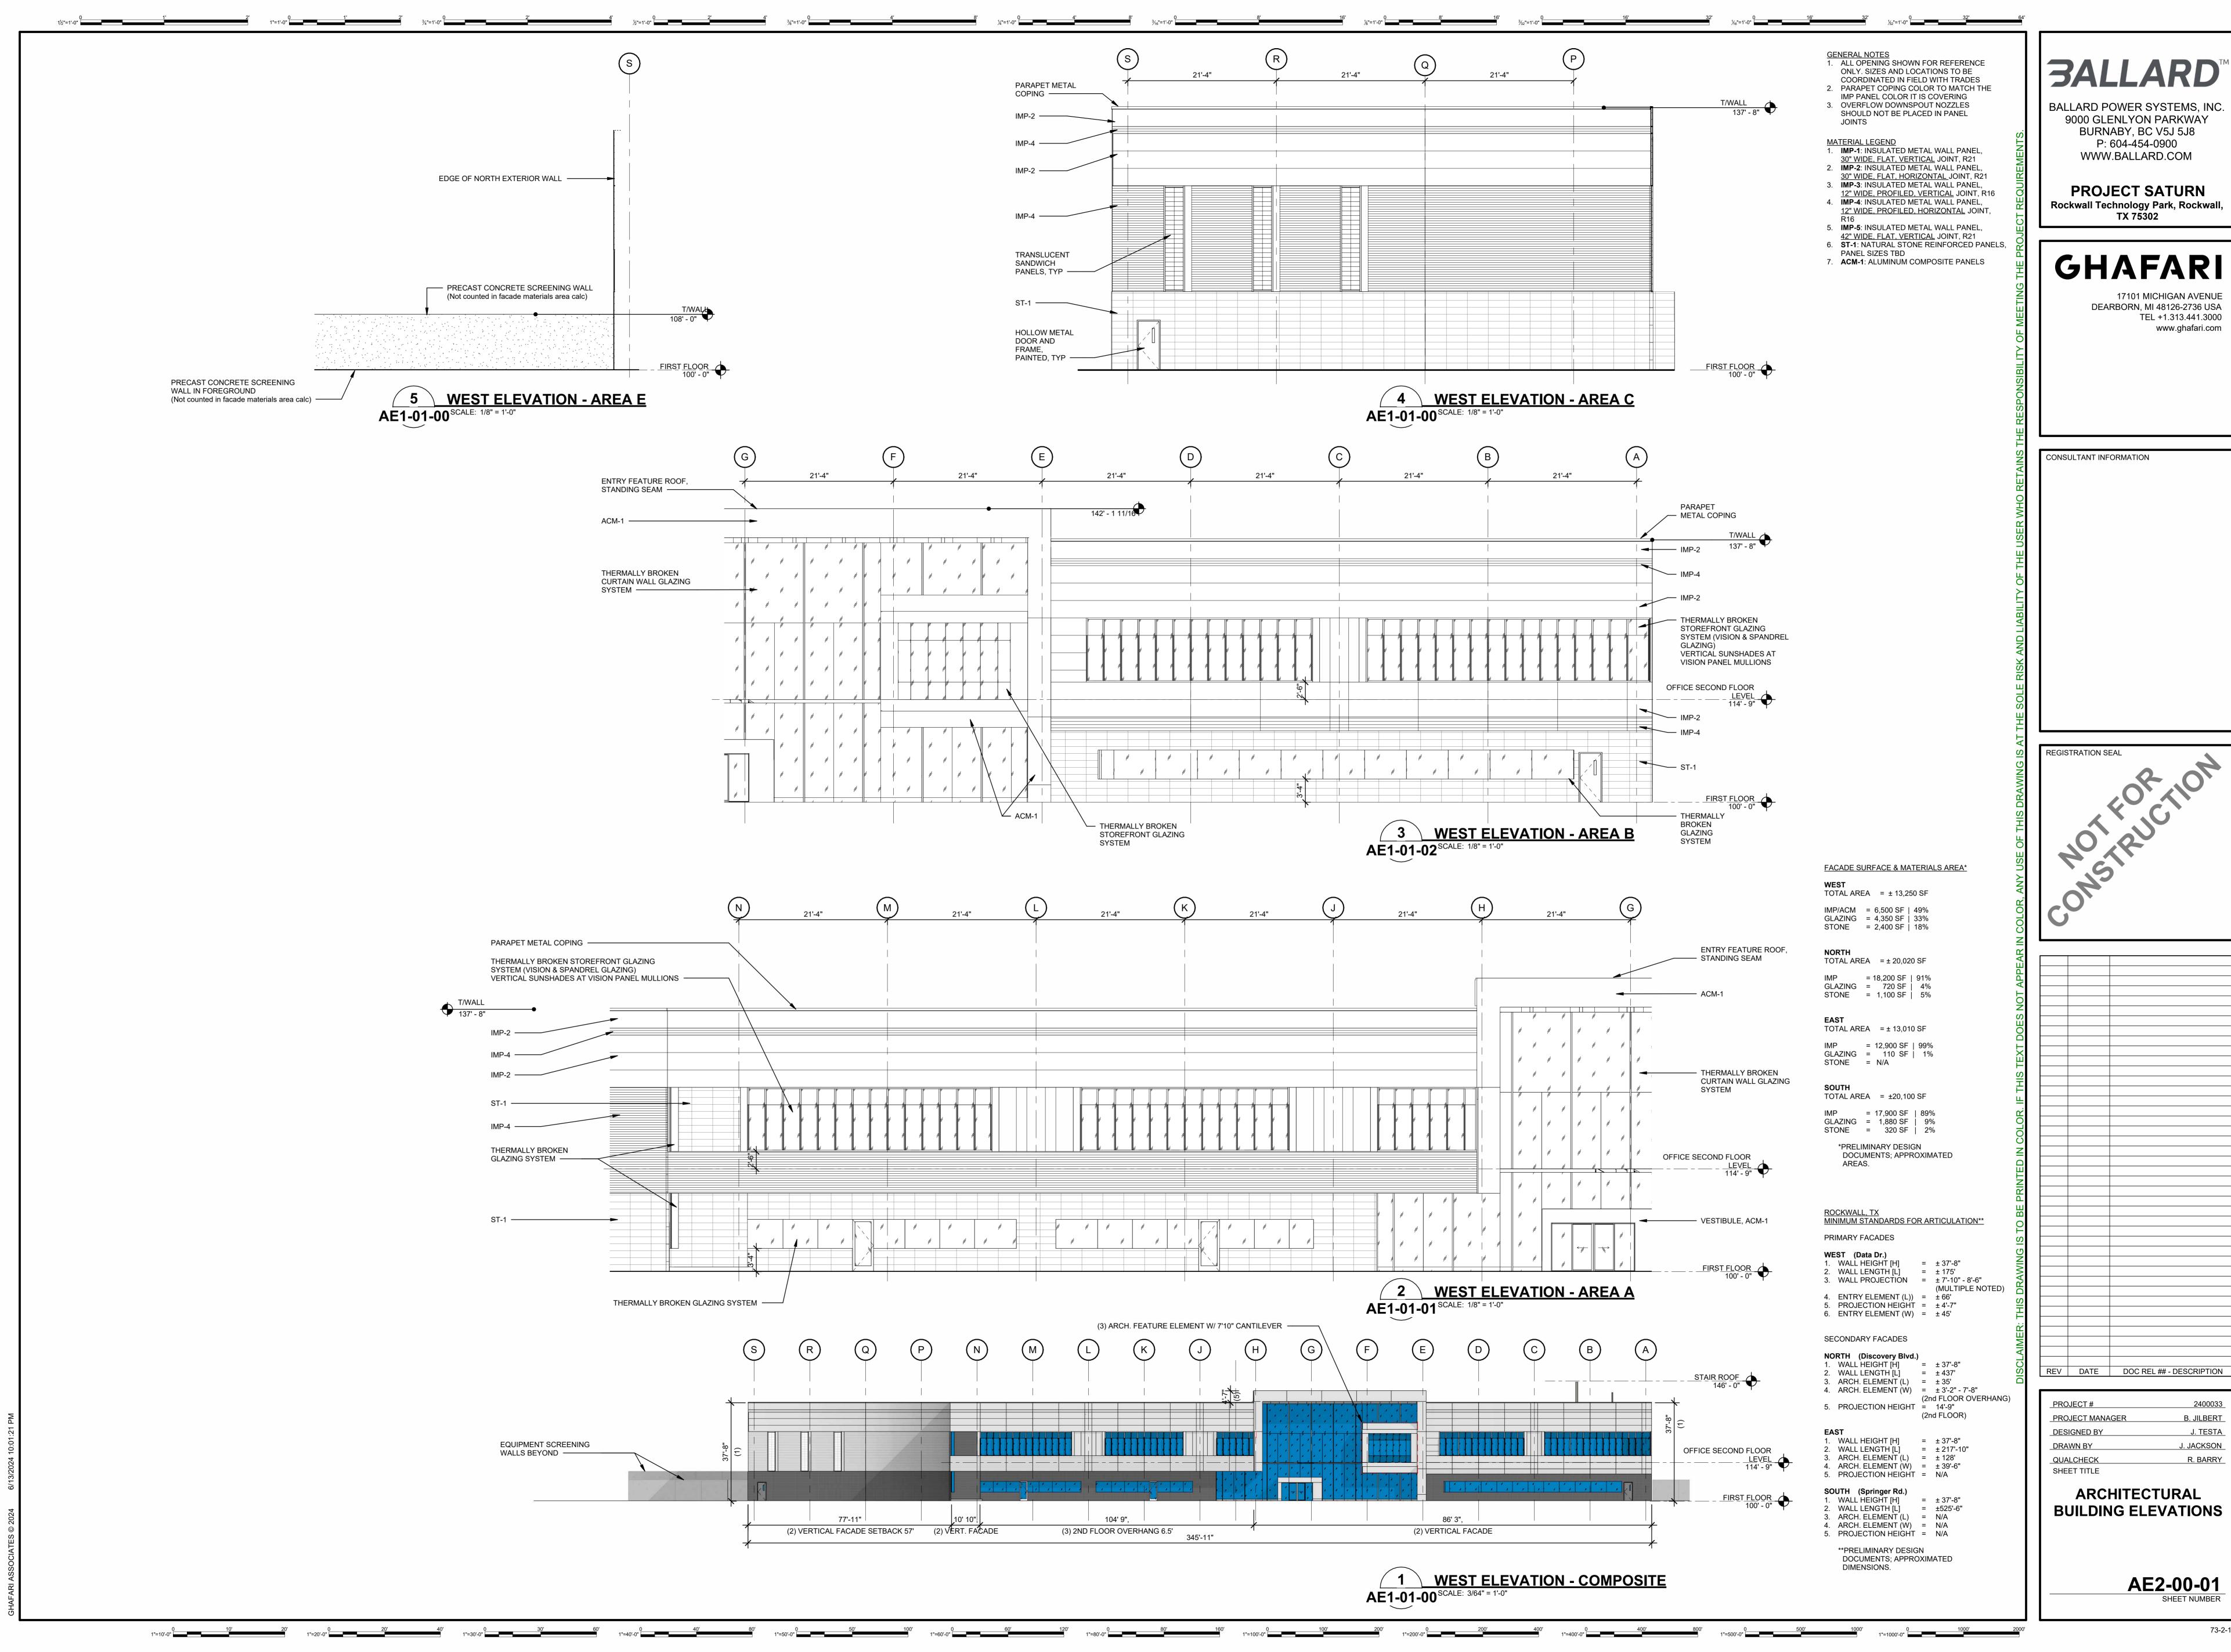DEV	DATE	DOODEL ## DECODIDATION
REV	DATE	DOC REL ## - DESCRIPTION



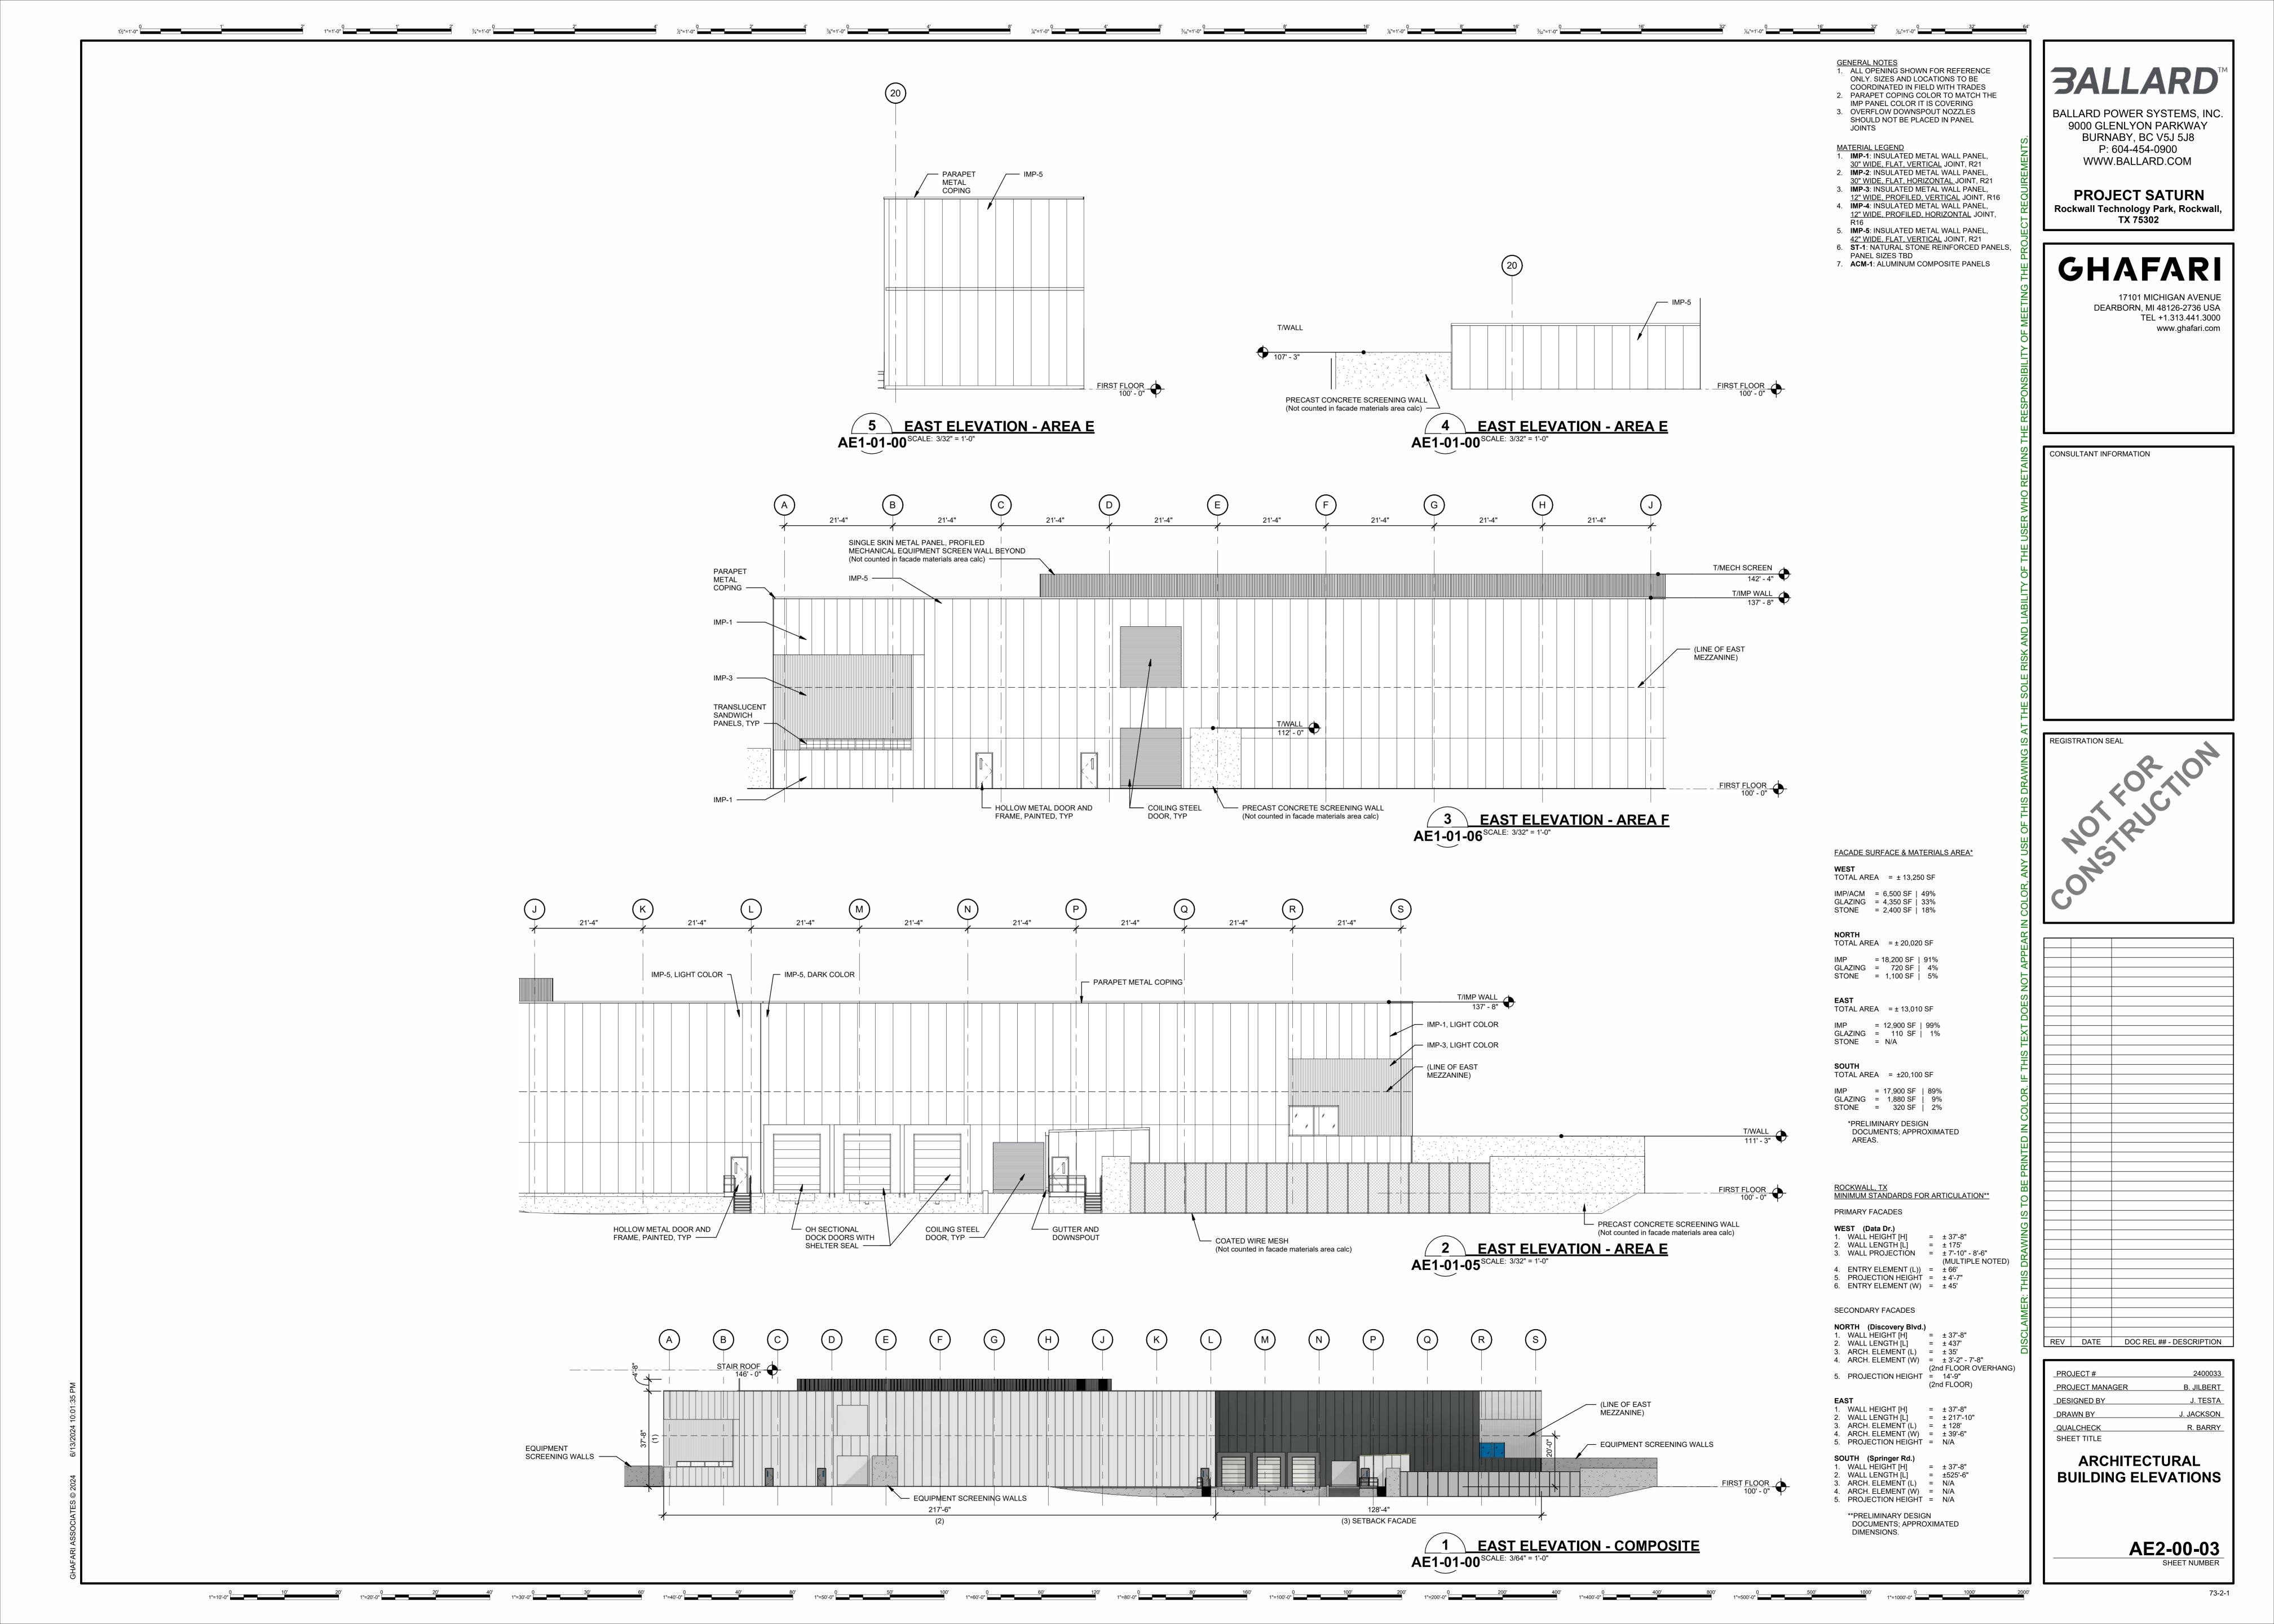

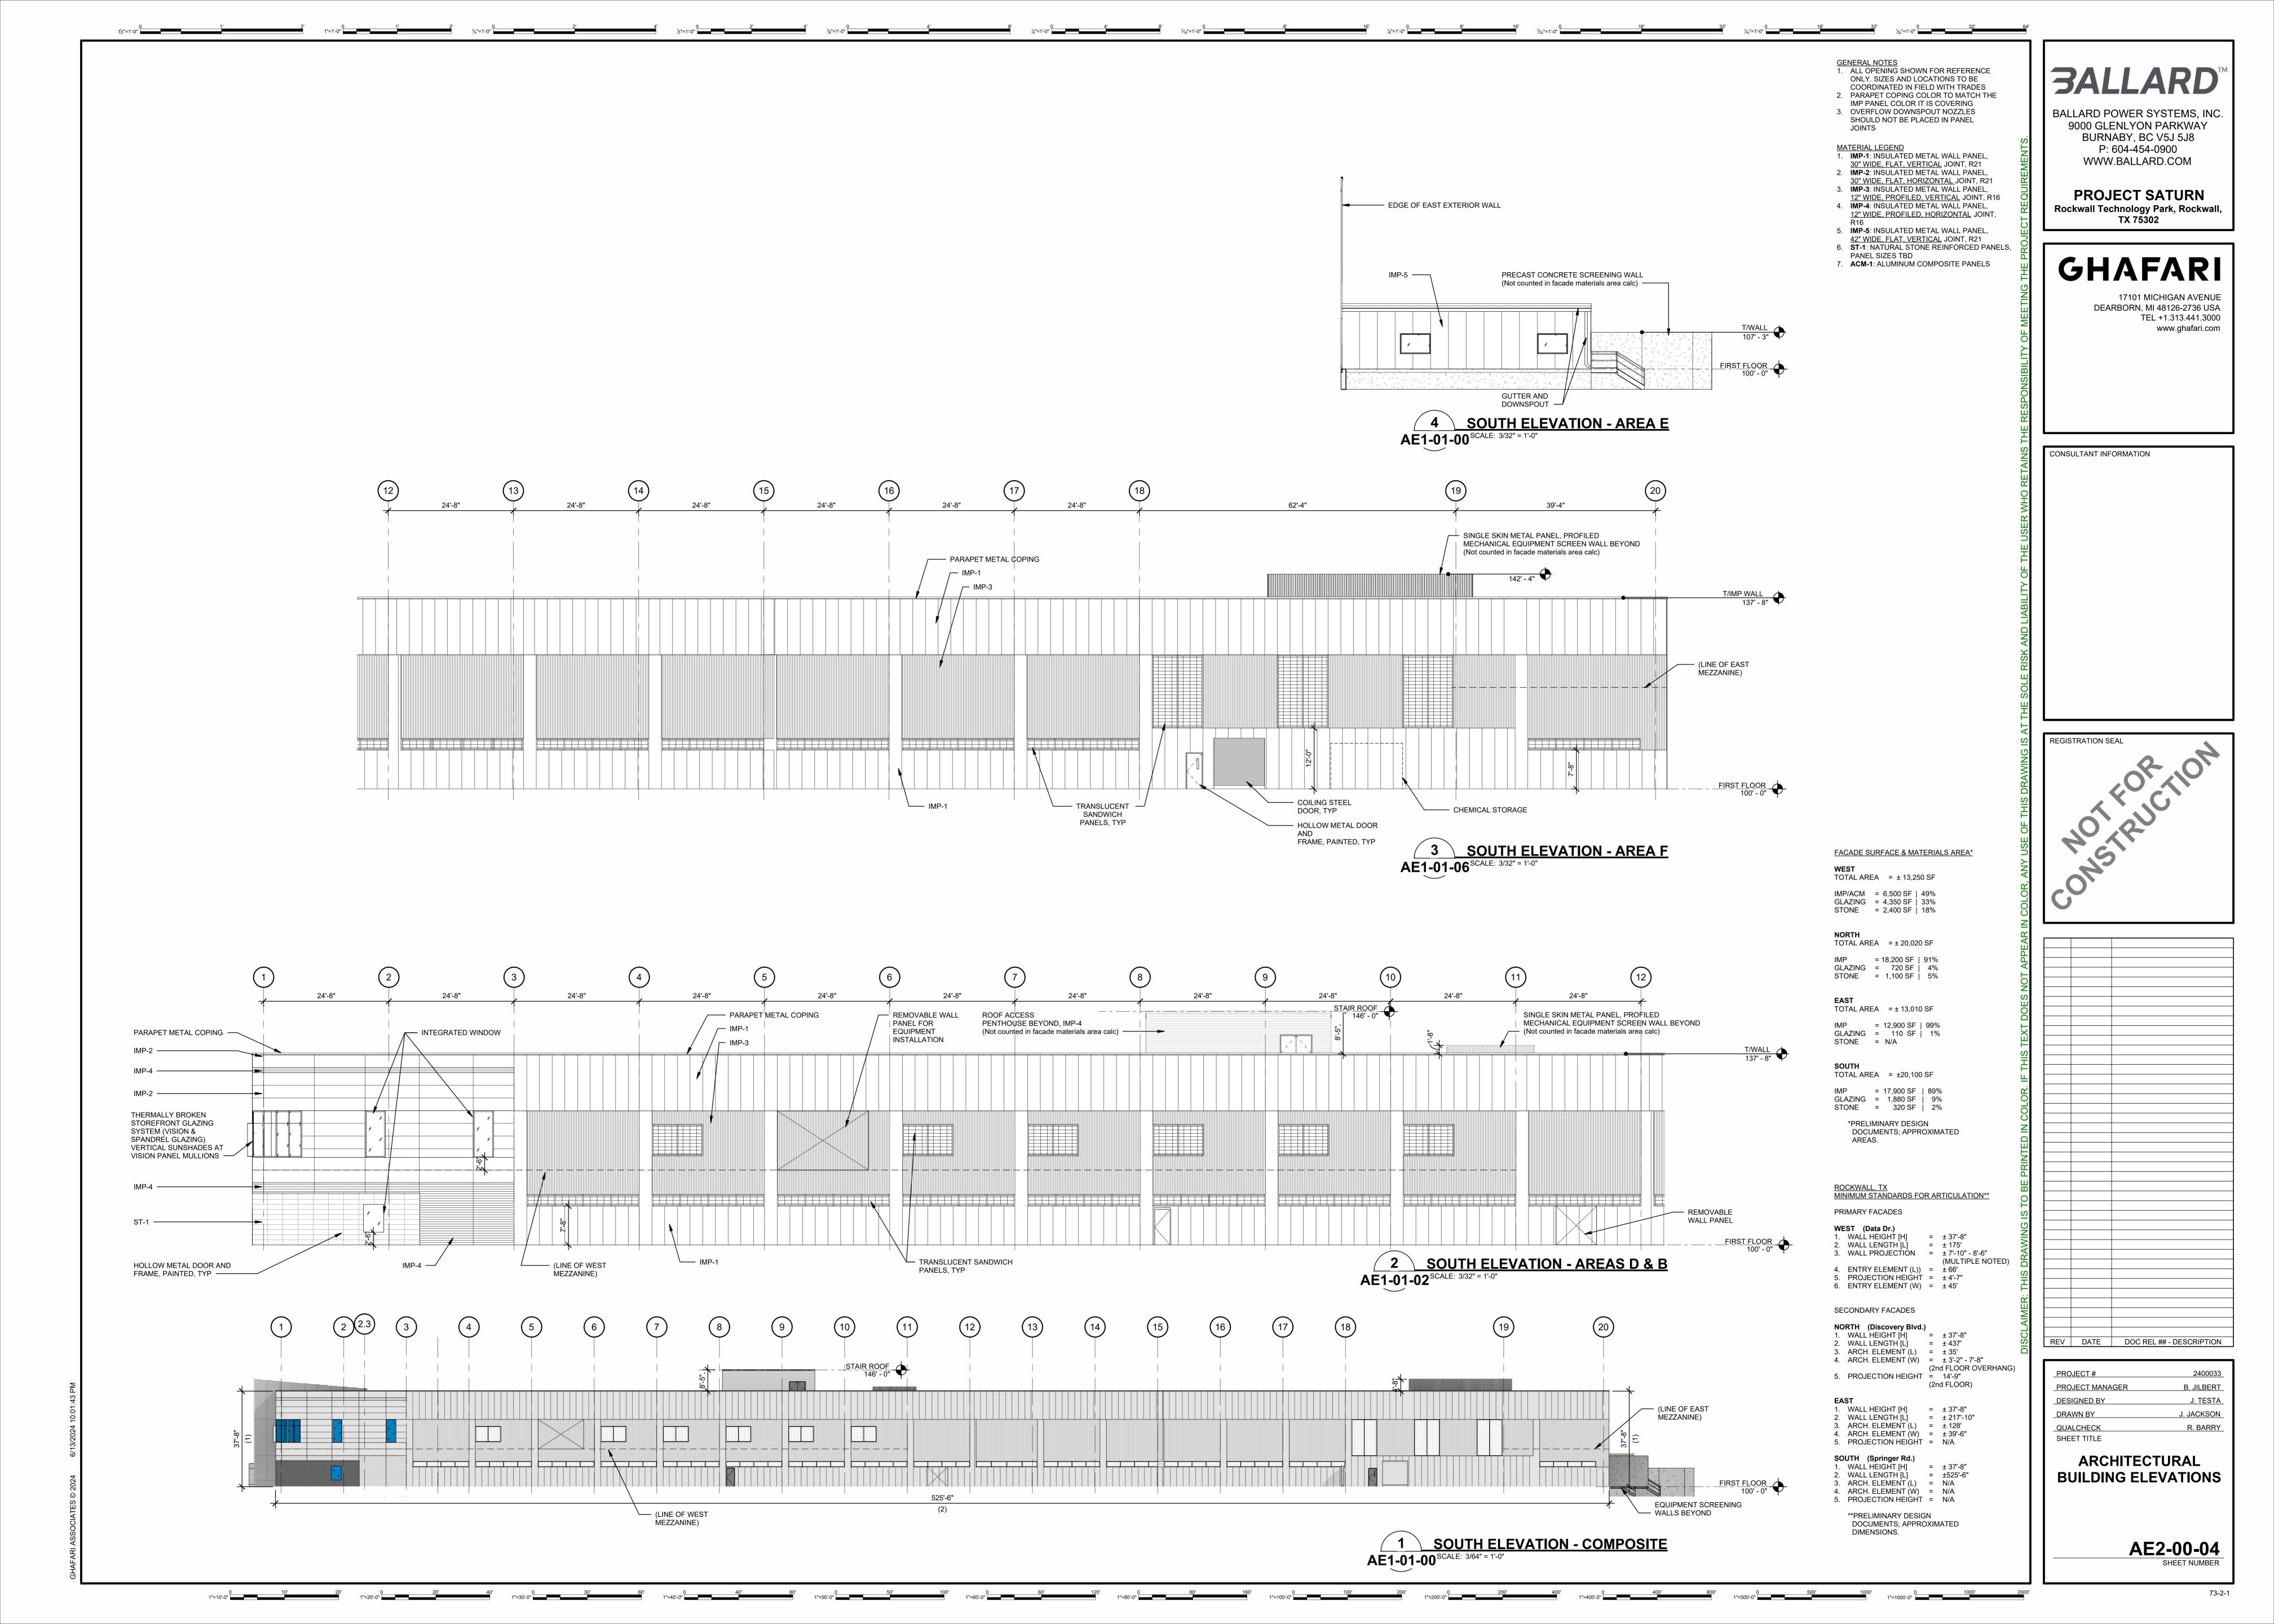



West Facade
\*Landscape design not shown

Materials & Systems

\*Landscape design not shown

### System & Materials

\*Building and equipment validation in-progress.



**Ballard Color Palette** 

**3ALLARD** 

BALLARD POWER SYSTEMS, INC. 9000 GLENLYON PARKWAY BURNABY, BC V5J 5J8 P: 604-454-0900 WWW.BALLARD.COM

PROJECT SATURN
Rockwall Technology Park, Rockwall,
TX 75302

GHAFARI

17101 MICHIGAN AVENUE DEARBORN, MI 48126-2736 USA TEL +1.313.441.3000 www.ghafari.com

CONSULTANT INFORMATION

REGISTRATION SEAL

IS TO BE PRINTED IN COLOR. IF THIS TE

REV DATE DOC REL ## - DESCRIPTION

PROJECT # 2400033

PROJECT MANAGER B. JILBERT

DESIGNED BY J. TESTA

DRAWN BY J. JACKSON

QUALCHECK R. BARRY

SHEET TITLE

ARCHITECTURAL 3D REPRESENTATIONS

AE9-00-91
SHEET NUMBER





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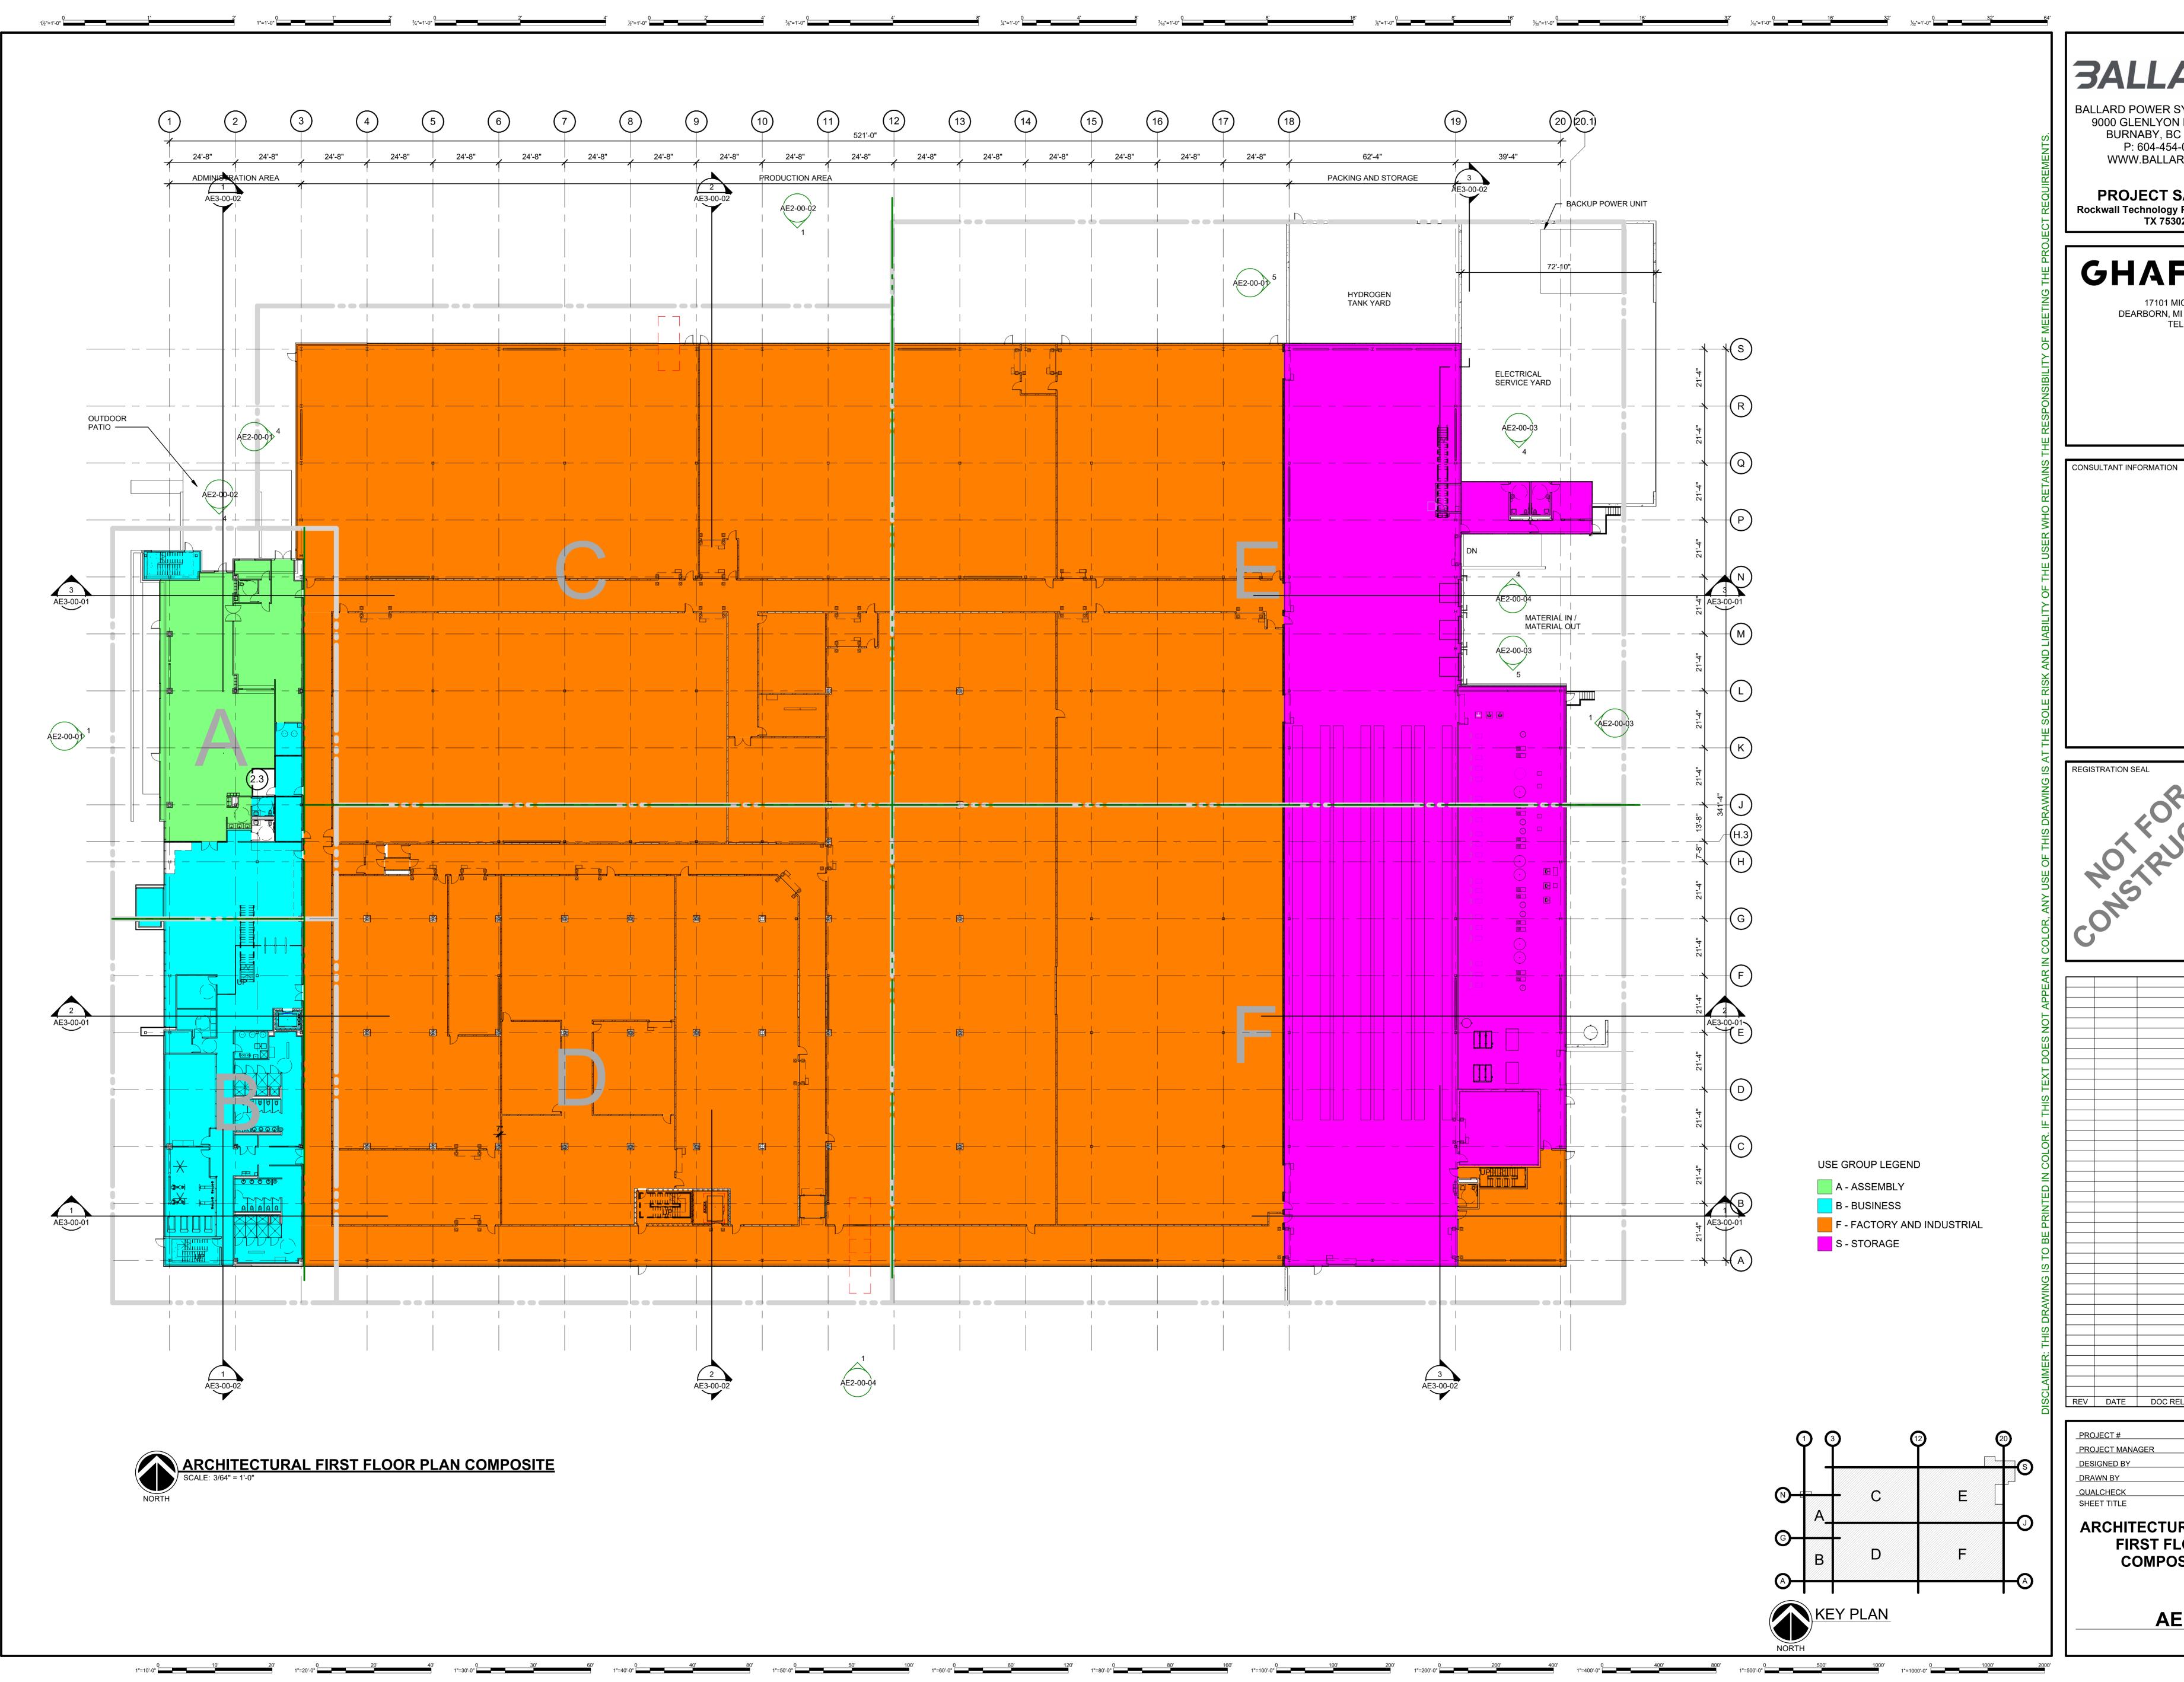
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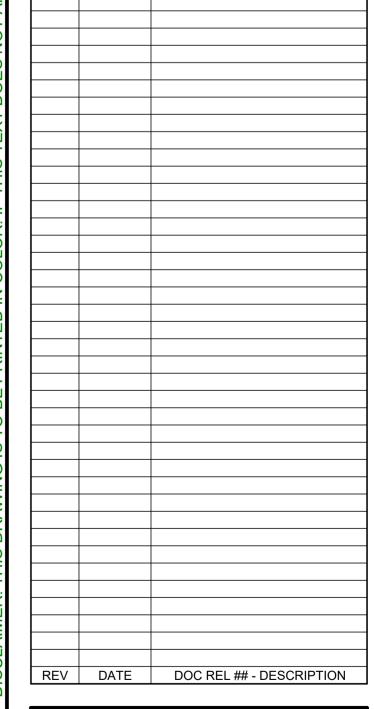
AE9-00-92 SHEET NUMBER



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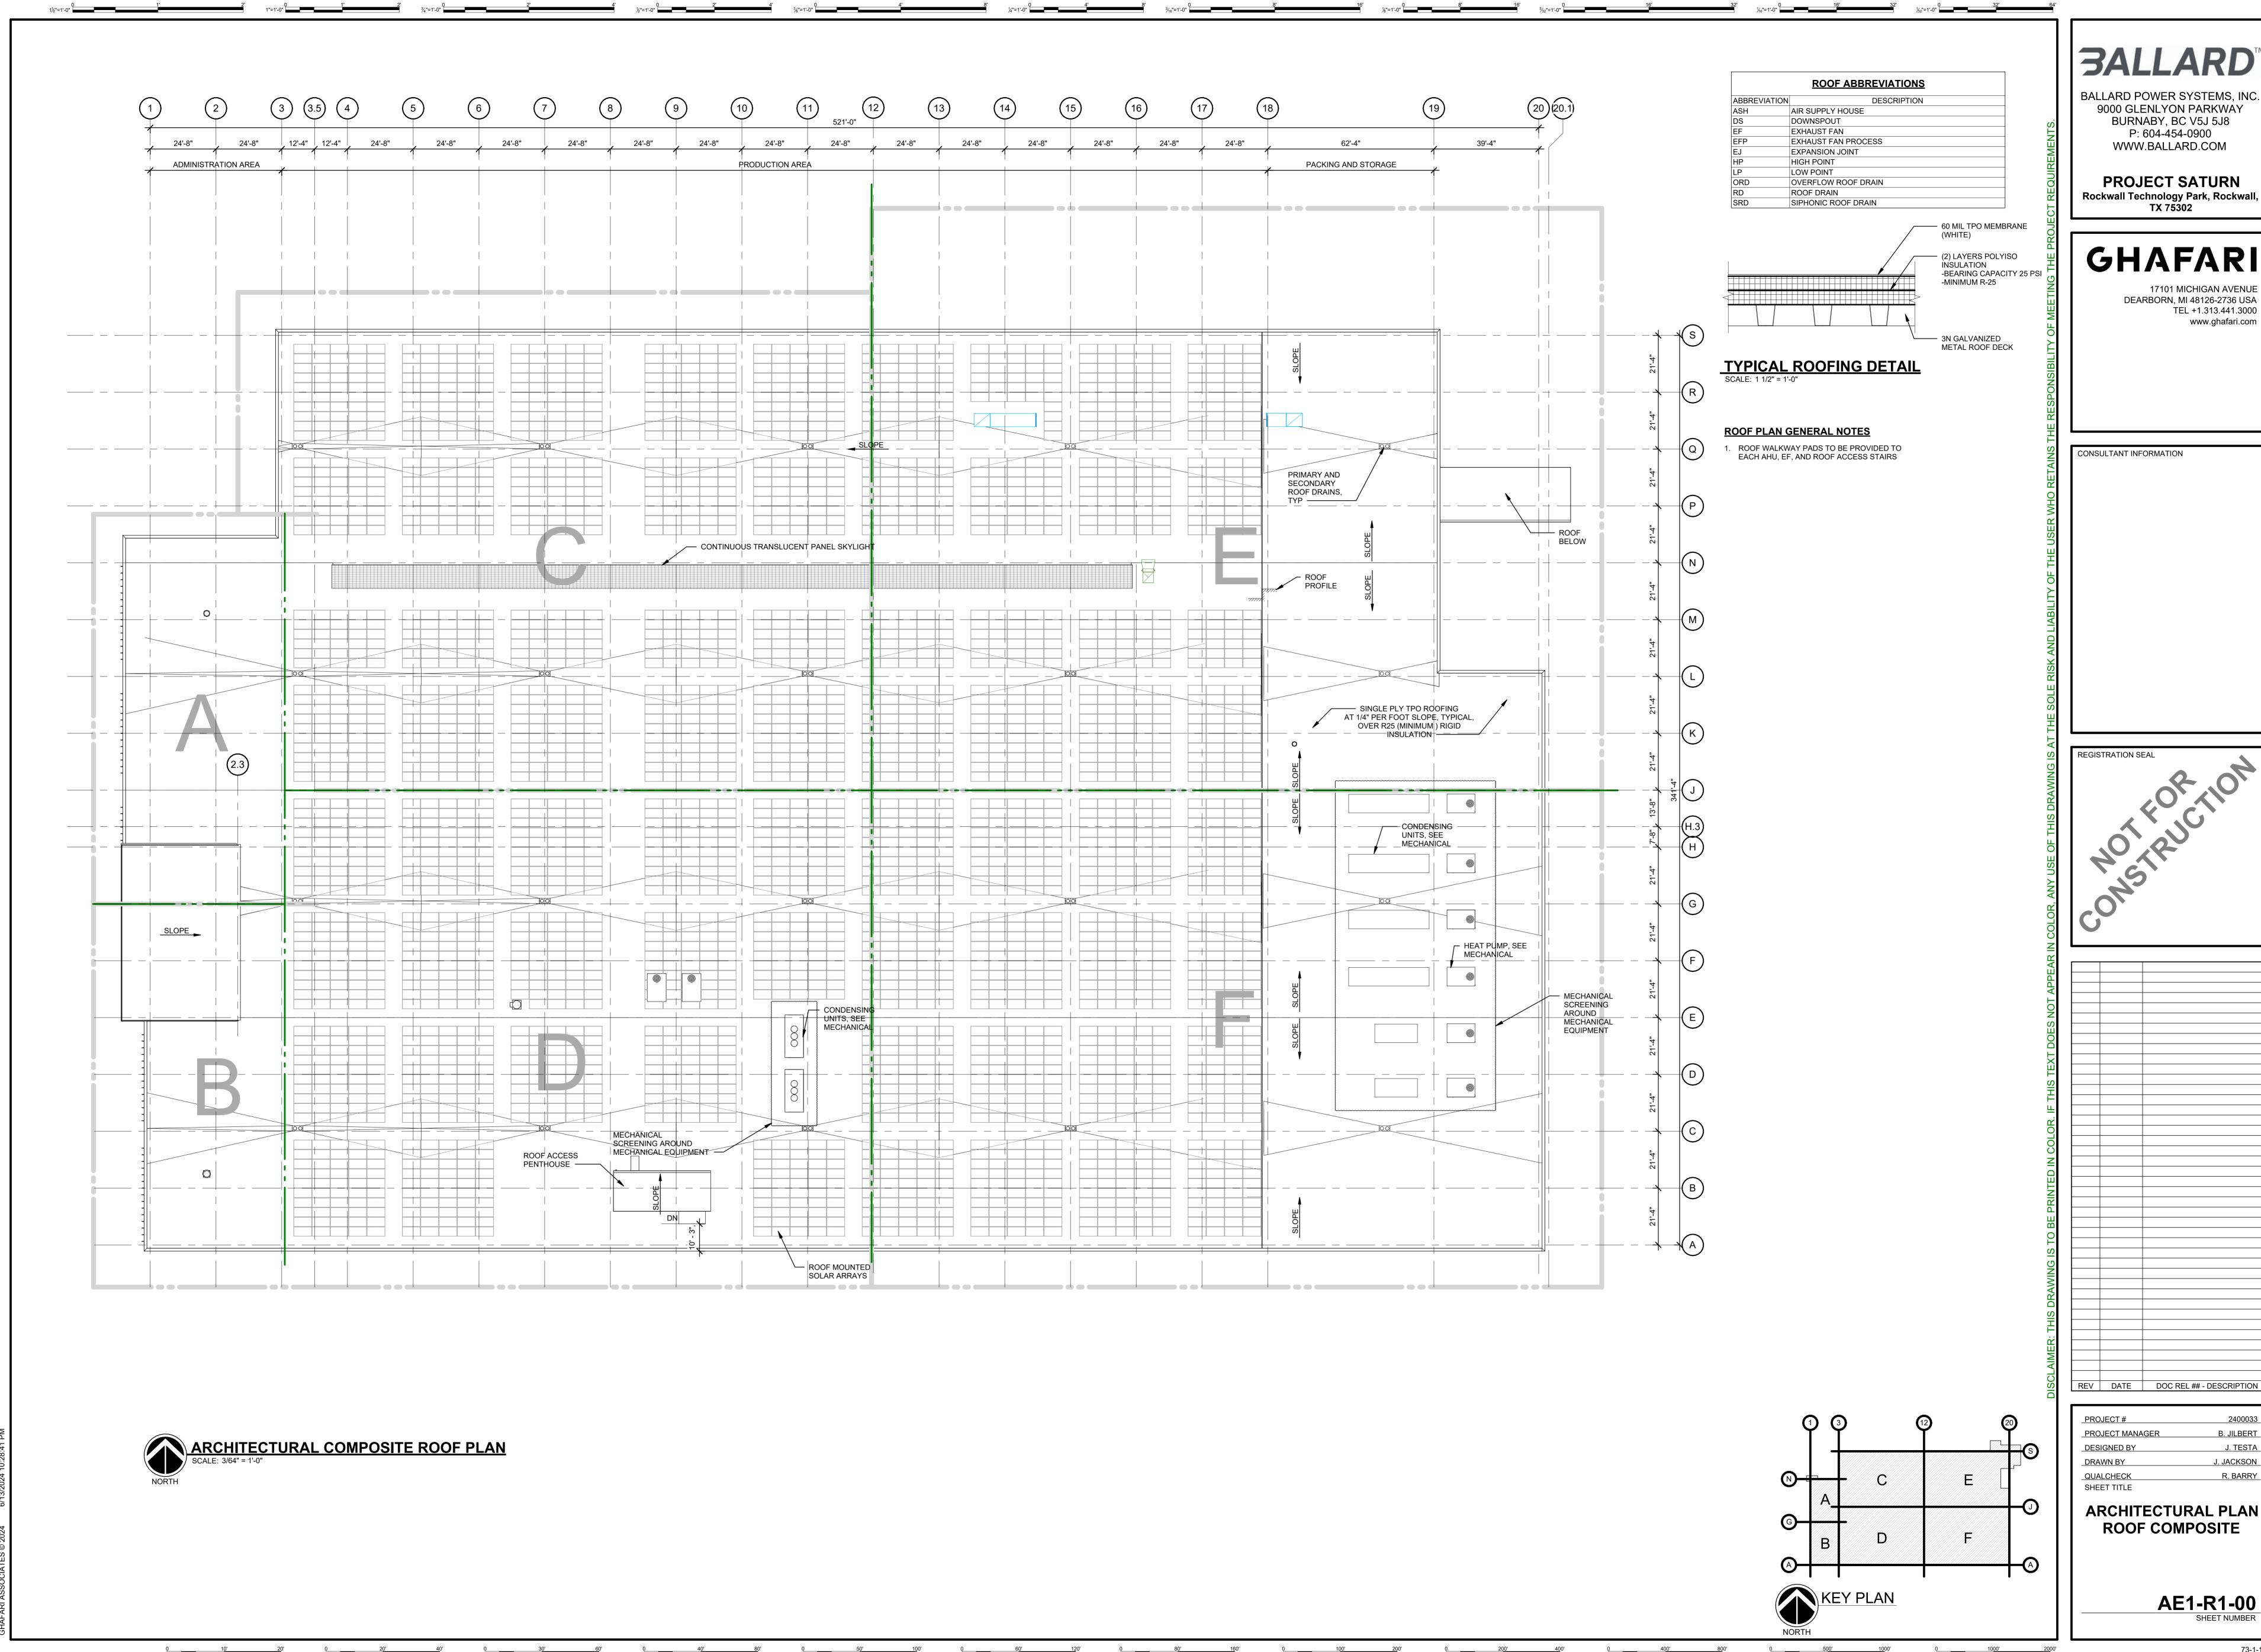
17101 MICHIGAN AVENUE DEARBORN, MI 48126-2736 USA TEL +1.313.441.3000 www.ghafari.com



B. JILBERT J. JACKSON R. BARRY

ARCHITECTURAL PLAN FIRST FLOOR COMPOSITE

AE1-01-00 SHEET NUMBER



17101 MICHIGAN AVENUE TEL +1.313.441.3000

REV DATE DOC REL ## - DESCRIPTION

B. JILBERT J. JACKSON R. BARRY

1. AN UNDERGROUND AUTOMATIC IRRIGATION SYSTEM SHALL BE PROVIDED FOR ALL PLANTING AREAS. OVER

CONTAINER, NURSERY GROWN, MATCHED AND WELL ROOTED

- SPRAY ON STREETS AND WALKS IS PROHIBITED. IRRIGATION SYSTEMS SHALL BE MAINTAINED AND REPLACED AS NECESSARY.
- 3. ALL PLANTING AREAS TO BE FULLY IRRIGATED.
- IRRIGATION SYSTEM TO HAVE A FULLY AUTOMATED CONTROL SYSTEM. IRRIGATION SYSTEM TO HAVE RAIN AND FREEZE SENSORS.
- ANY EXISTING PLANTING DAMAGED DURING CONSTRUCTION IS TO BE REPLACED AT NO COST THE OWNER. IRRIGATION SYSTEM TO BE DESIGNED BY A QUALIFIED PROFESSIONAL AND INSTALLED BY A LICENSED

NOTE: AN IRRIGATION PLAN SHALL BE PREPARED IN ACCORDANCE WITH THE CITY OF **ROCKWALL IRRIGATION REQUIREMENTS** 

- 1. ALL TREES WHICH ARE TO REMAIN ON SITE SHALL BE PROTECTED WITH A (4') TALL BRIGHTLY COLORED PLASTIC FENCE, OR SILT FENCE, PLACED AT THE DRIP LINE OF THE TREES.
  - 2. PRIOR TO THE PRE-CONSTRUCTION MEETING OR OBTAINING A GRADING PERMIT, ALL TREE MARKINGS AND PROTECTIVE FENCING SHALL BE INSTALLED BY THE OWNER AND SHALL BE INSPECTED BY THE DEVELOPMENT SERVICES LANDSCAPE ARCHITECT.
  - 3. NO EQUIPMENT SHALL BE CLEANED, OR HARMFUL LIQUIDS DEPOSITED WITHIN THE LIMITS OF THE ROOT ZONE OF TREES WHICH REMAIN ON SITE.
  - NO SIGNS, WIRES, OR OTHER ATTACHMENTS SHALL BE ATTACHED TO ANY TREE TO REMAIN ON SITE. 5. VEHICULAR AND CONSTRUCTION EQUIPMENT SHALL NOT PARK OR DRIVE WITHIN THE LIMITS OF THE DRIP

  - 6. GRADE CHANGES IN EXCESS OF 3 INCHES (CUT OR FILL) SHALL NOT BE ALLOWED WITHIN A ROOT ZONE, UNLESS ADEQUATE TREE PRESERVATION METHODS ARE APPROVED BY THE CITY.
  - NO TRENCHING SHALL BE ALLOWED WITHIN THE DRIP-LINE OF A TREE, UNLESS APPROVED BY THE CITY. 8. ALL REMOVED TREES SHALL BE CHIPPED AND USED FOR MULCH ON SITE OR HAULED OFF-SITE. 9. ALL TREE MAINTENANCE TECHNIQUES SHALL BE IN CONFORMANCE WITH AMERICAN NATIONAL STANDARDS
  - FOR TREE CARE OPERATIONS, ANSI A300 INDUSTRY IDENTIFIED STANDARDS. IMPROPER OR MALICIOUS PRUNING TECHNIQUES ARE STRICTLY PROHIBITED.

### LANDSCAPE CALCULATIONS CHART:

Project Saturn - Rockwall, TX  Code Calculations Chart				
Site Data	AC	SF		
Total Site Area	22.00	958,318		
Surface Parking Spaces	155			
Site Landscape Area	Required (% / SF)	Provided (% / SF)		
15% of site to be landscaped	15%	27%		
·	143,748	254,749		
Street Frontage	Required	Provided		
Discovery Boulevard (777.82 LF)				
1 Canopy Tree/ 50 LF	16	16*		
1 Accent Tree/ 50LF	16	16*		
Continuous row of shrubs and berming (min. 36" ht.)	YES	YES		
*14 required canopy trees along Discovery Blvd. to be provided in later dev.	phase			
*14 required accent trees along Springer Rd. to be provided in later dev. Pl	·			
Data Drive (1201.46 LF)				
1 Canopy Tree/ 50 LF	24	24		
1 Accent Tree/ 50LF	24	24		
Continuous row of shrubs and berming (min. 36" ht.)	YES	YES		
Springer Road (777.48 LF)				
1 Canopy Tree/ 50LF	16	16*		
1 Accent Tree/ 50LF	16	16*		
Continuous row of shrubs and berming (min. 36" ht.)	YES	YES		
*14 required canopy trees along Discovery Blvd. to be provided in later dev.	phase			
*14 required accent trees along Springer Rd. to be provided in later dev. Pl	nase			
Parking Lot	Required	Provided		
1 Large Canopy Tree/ 10 parking spaces	16	16		
One tree within 80' of each parking space	YES	YES		
Headlight Screening (min. 2' ht. berm with evergreen shrubs)	YES	YES		
	Descrived	Provided		
Detention Basin Screening	Required	rioviutu		

SYMB0	LS L	_EGE	END:

GENERAL	
	CENTER LINE
L.O.W.	LIMIT OF WORK
MATCHLINE L2.XX  MATCHLINE L2.XX	MATCHLINE
BREAKLINE	GRADE BREAKLINE
EJEJ	EXPANSION JOINT
	CONTROL JOINT
P.O.B.	POINT OF BEGINNING
X DETAIL NUM	
	DETAIL ENLARGEMENT REFERENCE
X-1	MATERIAL REFERENCE
X DETAIL NUMBER  X.XX SHEET NUMBER	DETAIL REFERENCE
LX.XX	ELEVATION REFERENCE
LX.XX	SECTION REFERENCE

SITE PLAN

ROCKWALL TECHNOLOGY

PARK PHASE V

PART OF LOT 2, BLOCK B

TOTAL ACREAGE: 22.000 ACRES

CITY OF ROCKWALL, ROCKWALL COUNTY, TEXAS CITY PROJECT NO. SP-XXXXXX-XXXX SUBMITTED JUNE 14, 2024

**DEVELOPER:** 

ROCKWALL ECONOMIC

ROCKWALL, TX. 75032

PH. (972) 772-0025

DEVELOPMENT COUNCIL

2610 OBSERVATION TRAIL, SUITE 104

ENGINEER / SURVEYOR / APPLICANT:

TWO GALLERIA OFFICE TOWER, SUITE 700

CONTACT: LEE SWEETLAND CONTACT: PHIL WAGNER

KIMLEY-HORN & ASSOCIATES, INC.

CONTACT: PAUL FREELAND, P.L.A.

13455 NOEL ROAD

BALLARD US INC.

BEND, OR. 97701

2495 NE 4TH STREET

PH. (XXX) XXX-XXXX

DALLAS, TEXAS 75240 PH (469) 301-2599

### PLANTING SCHEDULE:

Wintercreeper / Euonymus fortunei

CONVENIENCE ONLY. IN THE CASE OF A DISCREPANCY,

NOTE: PLANT QUANTITIES ARE PROVIDED FOR

THE DRAWING SHALL TAKE PRECEDENCE.

1. LANDSCAPE CONTRACTOR SHALL BE RESPONSIBLE FOR VERIFYING THE LOCATION OF ALL UNDERGROUND

CONDITION FOUND ON THE SITE WHICH PROHIBITS INSTALLATION AS SHOWN ON THESE DRAWINGS.

ALL PLANT MATERIAL SHALL BE MAINTAINED IN A HEALTHY AND GROWING CONDITION AND MUST BE

4. LANDSCAPE CONTRACTOR SHALL BE RESPONSIBLE FOR FINE GRADING AND REMOVAL OF DEBRIS PRIOR

5. FINAL FINISH GRADING SHALL BE REVIEWED BY THE LANDSCAPE ARCHITECT. LANDSCAPE CONTRACTOR

6. ALL PLANT QUANTITIES LISTED ARE FOR INFORMATION ONLY. IT IS THE CONTRACTOR'S RESPONSIBILITY

LANDSCAPE CONTRACTOR TO PROVIDE STEEL EDGING (REFER TO MATERIALS PAGE) BETWEEN ALL

SHALL BE APPROVED BY LANDSCAPE ARCHITECT PRIOR TO PURCHASE.

AS REQUIRED TO ACCOMPLISH ALL PLANTING OPERATIONS. 10. ALL NEW PLANTING AREAS TO BE AMENDED PER SPECIFICATIONS.

FIRE LANES SHALL HAVE A 14' MINIMUM CLEAR TRUNK HEIGHT

8. ALL PLANT MATERIAL SHALL CONFORM TO THE SPECIFICATIONS AND SIZES GIVEN IN THE PLANT LIST AND SHALL BE NURSERY GROWN IN ACCORDANCE WITH THE AMERICAN STANDARD FOR NURSERY STOCK. LATEST EDITION AMERICAN ASSOCIATION OF NURSERYMEN STANDARDS. ANY PLANT SUBSTITUTION

9. LANDSCAPE CONTRACTOR IS RESPONSIBLE FOR ANY COORDINATION WITH OTHER CONTRACTORS ON SITE

11. ANY PLANT MATERIAL THAT DOES NOT SURVIVE SHALL BE REPLACED WITH AN EQUIVALENT SIZE AND

12. PLANT MATERIAL SHALL BE PRUNED AS NECESSARY TO CONTROL SIZE BUT NOT TO DISRUPT THE NATURAL GROWTH PATTERN OR CHARACTERISTIC FORM OF THE PLANT EXCEPT AS NECESSARY TO ACHIEVE HEIGHT CLEARANCE FOR VISIBILITY AND PEDESTRIAN PASSAGE OR TO ACHIEVE A CONTINUOUS

13. LANDSCAPED AREAS SHALL BE KEPT FREE OF TRASH, WEEDS, DEBRIS, AND DEAD PLANT MATERIAL. 14. ALL LIME STABILIZED SOIL & INORGANIC SELECT FILL FOR BUILDING SHOULD BE REMOVED FROM PLANTING AREAS TO A DEPTH OF 24" & REPLACED WITH ORGANIC IMPORTED TOPSOIL FILL. 15. TREES OVERHANGING PEDESTRIAN WALKWAYS AND PARKING SHALL HAVE A 7' MINIMUM CLEAR TRUNK HEIGHT TO MEET ACCESSIBILITY STANDARDS. TREES OVERHANGING PUBLIC STREETS, DRIVE AISLES, AND

17. ALL AREAS DISTURBED BY CONSTRUCTION ACTIVITY (NOT ALREADY INCLUDED IN PLANTING PLANS) TO BE FINE GRADED, AND PLANTED WITH PLANTED WITH PLANTS OR SOD TO MATCH EXISTING CONDITIONS.

CONTRACTOR TO PROVIDE 18 MONTH WARRANTY AFTER ALL CONSTRUCTION IS COMPLETE.

SHALL BE RESPONSIBLE FOR ANY ADDITIONAL TOPSOIL REQUIRED TO CREATE A SMOOTH CONDITION

TO PROVIDE FULL COVERAGE IN ALL PLANTING AREAS AS SPECIFIED IN THE PLANT SCHEDULE AND VERIFY

REPLACED WITH PLANT MATERIAL OF SAME VARIETY AND SIZE IF DAMAGED, DESTROYED, OR REMOVED.

2. IT IS THE RESPONSIBILITY OF THE CONTRACTOR TO ADVISE THE LANDSCAPE ARCHITECT OF ANY

TO PLANTING IN ALL AREAS.

PLANTING BEDS AND LAWN AREAS.

SPECIES WITHIN THIRTY (30) DAYS.

PRIOR TO PLANTING.

UTILITIES, PIPES, STRUCTURES, AND LINE RUNS IN THE FIELD PRIOR TO THE INSTALLATION OF ANY PLANT

SYMBOL	COMMON / BOTANICAL NAME	CONT.	SIZE	<u>SPACING</u>		<u>QTY</u>	REMARKS
TREES							
	Bald Cypress / Taxodium distichum	4" cal	12`-14` ht			8	
	Cedar Elm / Ulmus crassifolia	4" cal	12`-14` ht			12	B&B, NURSERY GROWN, MATCHED, FULL, WELL-BRANCHED, STRONG CENTRAL LEADER
0	Live Oak / Quercus virginana	4" cal	12`-14` ht			11	B&B, NURSERY GROWN, MATCHED, FULL, WELL-BRANCHED, STRONG CENTRAL LEADER
	Texas Red Oak / Quercus buckleyi	4" cal	12`-14` ht			24	B&B, NURSERY GROWN, MATCHED, FULL, WELL-BRANCHED, STRONG CENTRAL LEADER
FLOWERIN	NG TREES						
	Mexican Buckeye / Ungnadia speciosa	45 gal	8`-10` ht			14	CONTAINER, NURSERY GROWN, MATCHED, FULL, WELL-BRANCHED, MULTI-TRUNK (3 MIN.), TREE FORM
	Possumhaw Holly / Ilex decidua	45 Gal.	7`-8`			8	CONTAINER, NURSERY GROWN, MATCHED, FULL, WELL-BRANCHED, MULTI-TRUNK (3 MIN.), TREE FORM
2	Yaupon Holly / Ilex vomitoria	45 Gal.	8`-10`			12	CONTAINER, NURSERY GROWN, MATCHED, FULL, WELL-BRANCHED, MULTI-TRUNK (3 MIN.), TREE FORM
SHRUBS							
<u>OTITOBO</u>	Brakelights Red Yucca / Hesperaloe parviflora `Brakelights` TM	3 gal	12" h X 12" w	18" OC		54	CONTAINER, NURSERY GROWN, MATCHED AND WELL ROOTED
80	Emerald Snow Loropetalum / Loropetalum chinense `Emerald Snow`	3 gal	18" h x 24" w	36" OC		70	CONTAINER, NURSERY GROWN, MATCHED AND WELL ROOTED
	Glossy Abelia / Abelia x grandiflora	3 gal	24" h x 18" w	36" OC		60	CONTAINER, NURSERY GROWN, MATCHED AND WELL ROOTED
	Green Cloud Texas Ranger / Leucophyllum frutescens `Green Cloud` TM	5 gal	24" h x 24" w	36" OC		42	CONTAINER, NURSERY GROWN, MATCHED AND WELL ROOTED
	Whale`s Tongue Agave / Agave ovatifolia `Frosty Blue`	3 gal	18" h X 18" w	IN POTS		20	CONTAINER, NURSERY GROWN, MATCHED AND WELL ROOTED
SYMBOL	COMMON / BOTANICAL NAME	CONT.	SIZE		SPACING	QTY	<u>REMARKS</u>
GROUND (	COVERS						
	Asian Jasmine / Trachelospermum asiaticum	1 gal	12" h x 12" w		18" o.c.	374	CONTAINER, NURSERY GROWN, MATCHED AND WELL ROOTED
	Berkeley Sedge / Carex divulsa	1 gal	6" h X 12" w		12" o.c.	575	CONTAINER, NURSERY GROWN, MATCHED AND WELL ROOTED
	Bermuda Grass / Cynodon dactylon	sod				135,421 sf	REFER TO SPECIFICATIONS
	Giant Liriope / Liriope gigantea	1 gal	12" h x 12" w		12" o.c.	635	CONTAINER, NURSERY GROWN, MATCHED AND WELL ROOTED
	Wintergrouper / Eugnymus fortunei	1 aal	0.01-		100	100	CONTAINED NUDCEDY CROWN, MATCHED AND WELL DOOTED

1 gal 8"h x 8"w

NOTE: PLANTS ARE SPECIFIED BY HEIGHT, SPREAD, AND CONTAINER SIZE. ALL PLANTINGS ARE EXPECTED

TO MEET ALL SPECIFICATIONS PROVIDED.

Tree Inches Being Removed	Tree Inches	Mitigation Inches
Total tree inches being removed - Primary - 1:1	0	0
Total tree inches being removed - Secondary - 0.5:1	307.3	153.7
Total tree inches being removed - Feature - 2:1	0	0.0
Total tree inches being removed	307.3 153.65	
Mitigation Inches		153.65
Proposed Tree Inches Per Planting Plan		332
NET TOTAL		-178.35

\*No detention basins on site

REQUIRED				
COMMON NAME	SCIENTIFIC NAME	QTY	CAL.	MITIGATION
Bald Cypress	Taxodium distichum	18	4	72
Cedar Elm	Ulmus crassifolia	20	4	80
Live Oak	Quercus virginiana	21	4	84
Texas Red Oak	Quercus buckleyi	24	4	96
		TOTAL MITIGAT	ION REQUIRED:	153.7
		TOTAL MITIGATI	ON PROVIDED:	332.0
		TOTAL MITIGATION (	DITCTANDING:	-178.4

### SITE DATA TABLE:

TREE MITIGATION:

SITE SUMMARY TABLE				
ZONING	LIGHT INDUSTRIAL			
PROPOSED USE	HEAVY MANUFACTURING			
PROPOSED MAX BUILDING HEIGHT	46'-0"			
PROPOSED TOTAL BUILDING AREA	236,016 SF			
PROPOSED BUILDING FOOTPRINT	174,128 SF			
TOTAL LAND AREA	958,322 SF/22.000 AC.			
BUILDING COVERAGE	25%			

PARKING DATA TABLE				
PARKING RATIO	1 SPACE PER 0.75 EMPLOYEES			
PHASE 1 EMPLOYEE COUNT (PER SHIFT)	198			
ULTIMATE EMPLOYEE COUNT (PER SHIFT)	540			
	149 TOTAL SPACES			
PHASE 1 REQUIRED PARKING	144 STANDARD SPACES			
	5 ADA SPACES			
	405 TOTAL SPACES			
ULTIMATE REQUIRED PARKING	396 STANDARD SPACES			
	9 ADA SPACES			
	149 TOTAL SPACES SPACES			
PHASE 1 PROVIDED PARKING	133 STANDARD SPACES			
	10 EV SPACES			
	6 ADA SPACES			
	405 TOTAL SPACES SPACES			
ULTIMATE PROVIDED PARKING	386 STANDARD SPACES			
OLITIVIATE PROVIDED PARKING	10 EV SPACES			
	9 ADA SPACES			


		mit purposes
P.L.A L.A. No	Paul D. Fro	


KHA PROJECT 068671058	DATE JUNE 2024	SCALE AS SHOWN	DESIGNED BY PDF	DRAWN BY NJF	700


PROJECT SATURN
CITY OF ROCKWALL
ROCKWALL COUNTY, TEXAS


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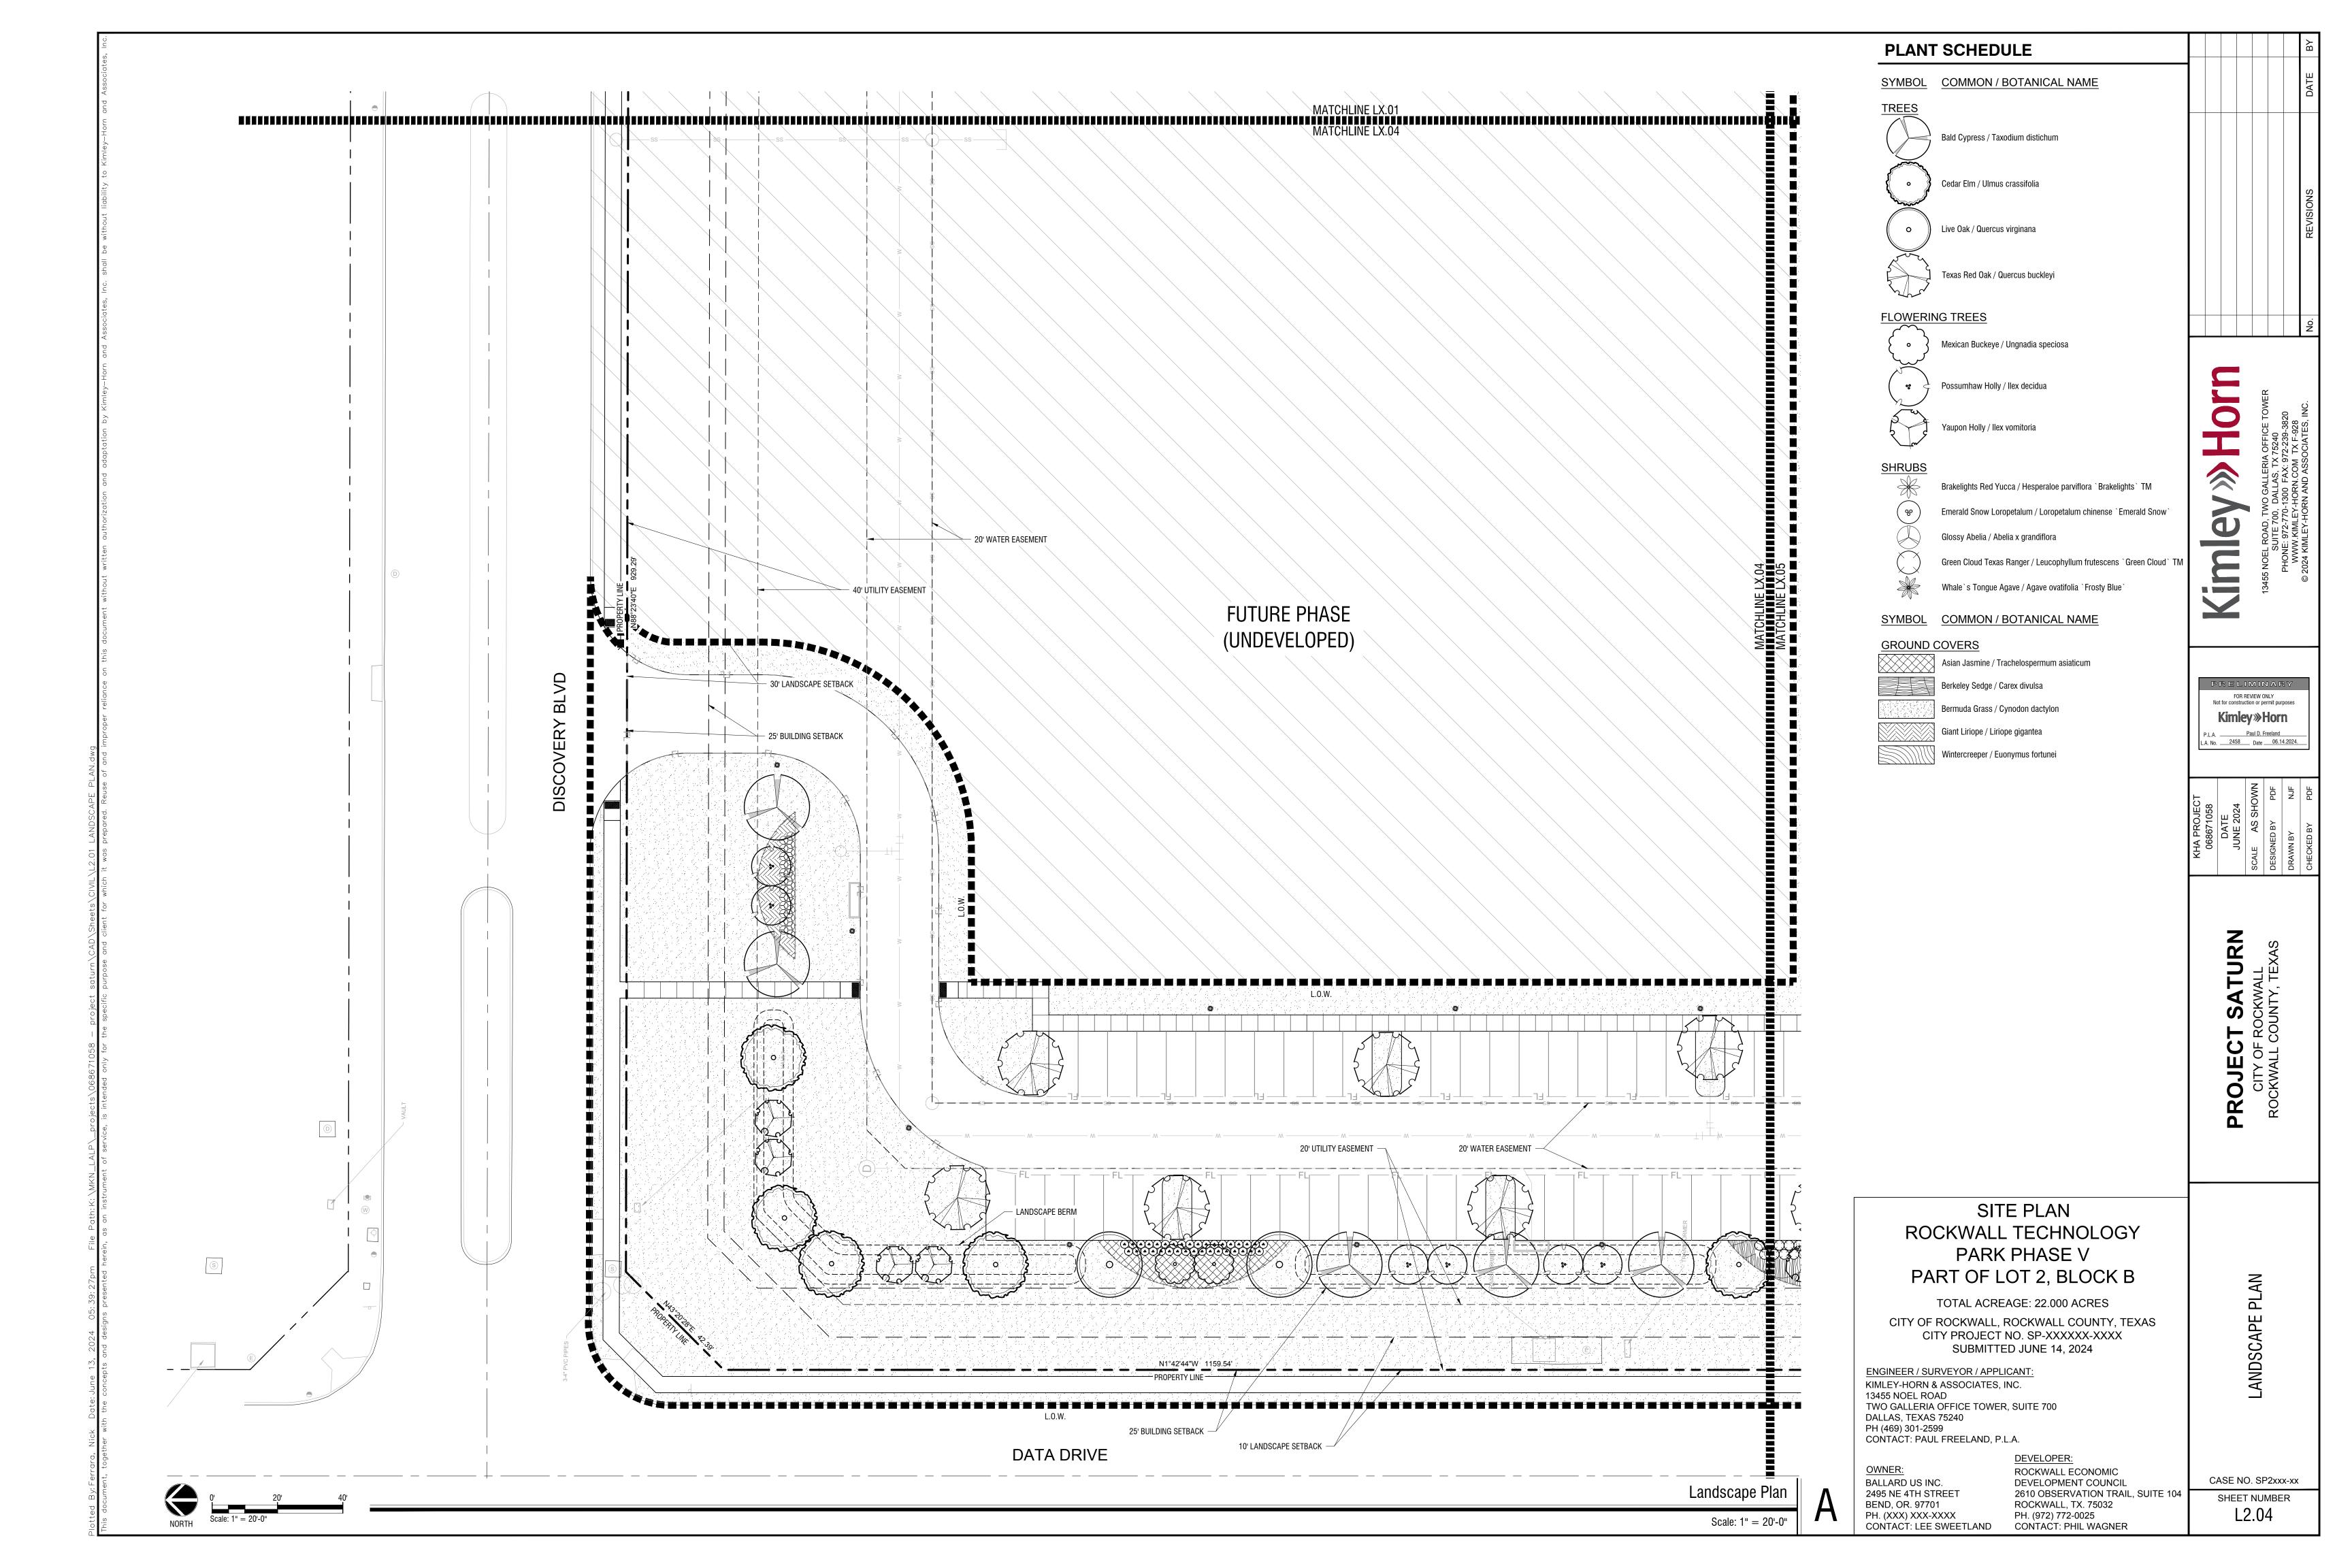
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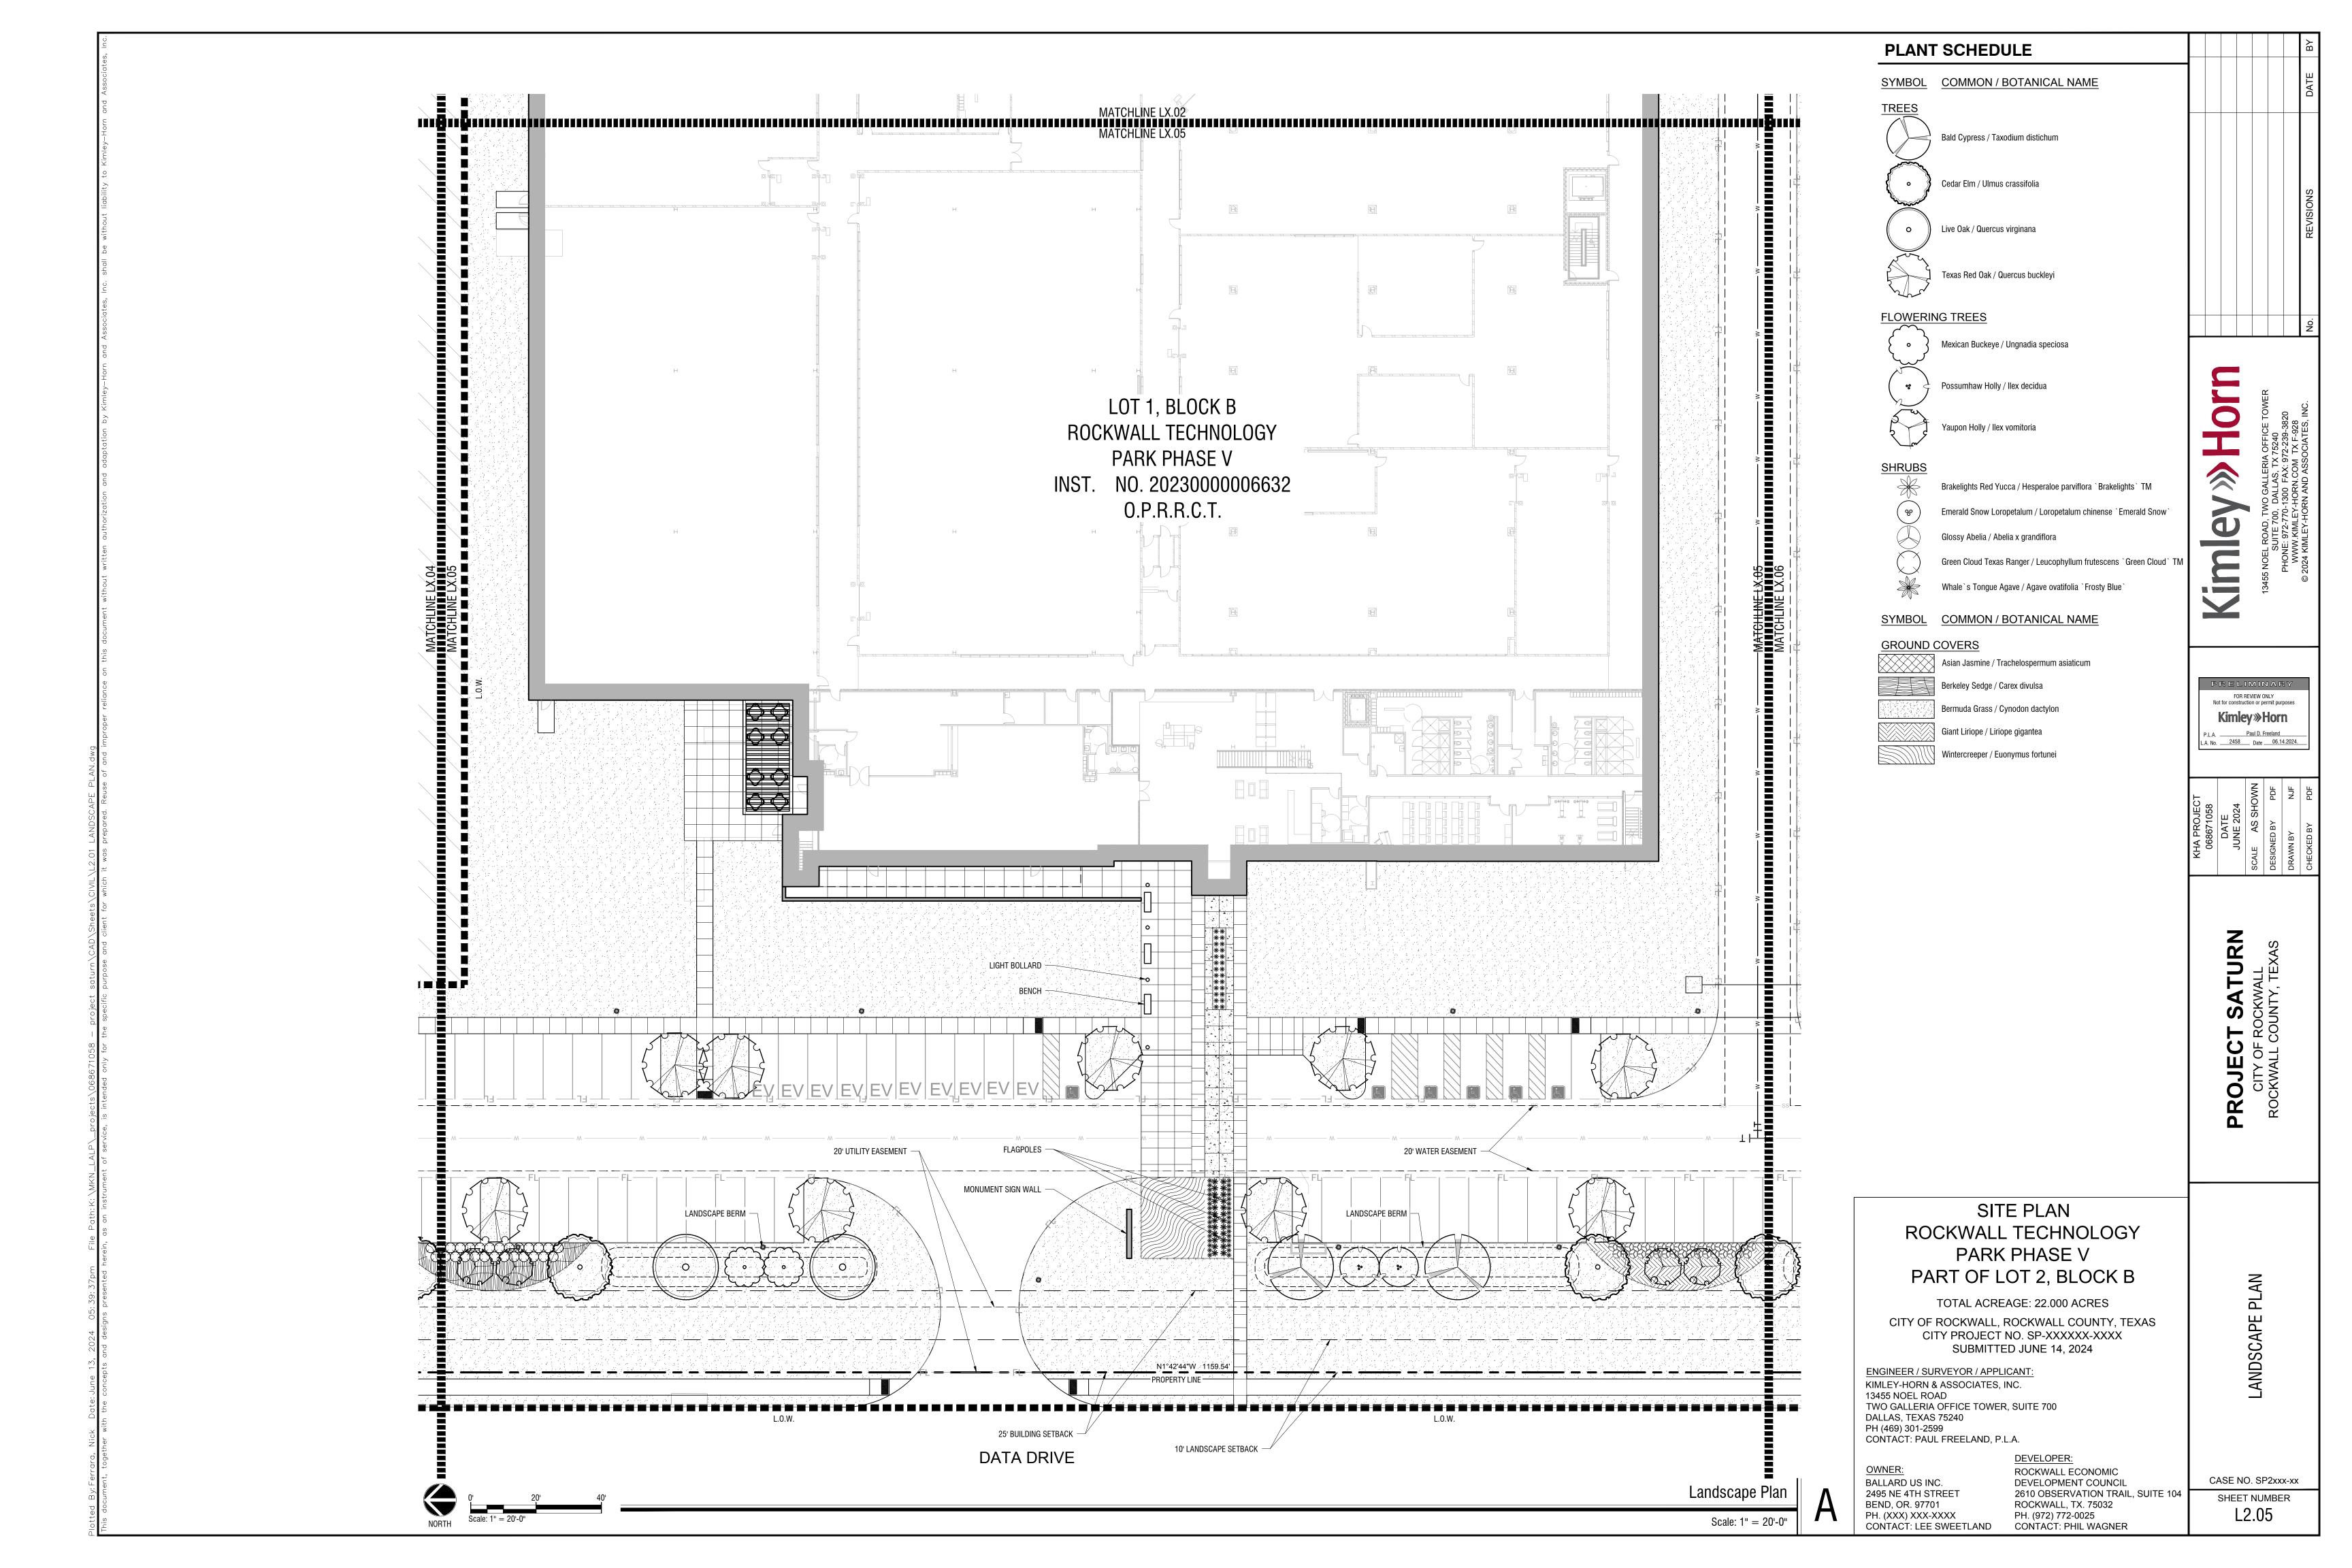





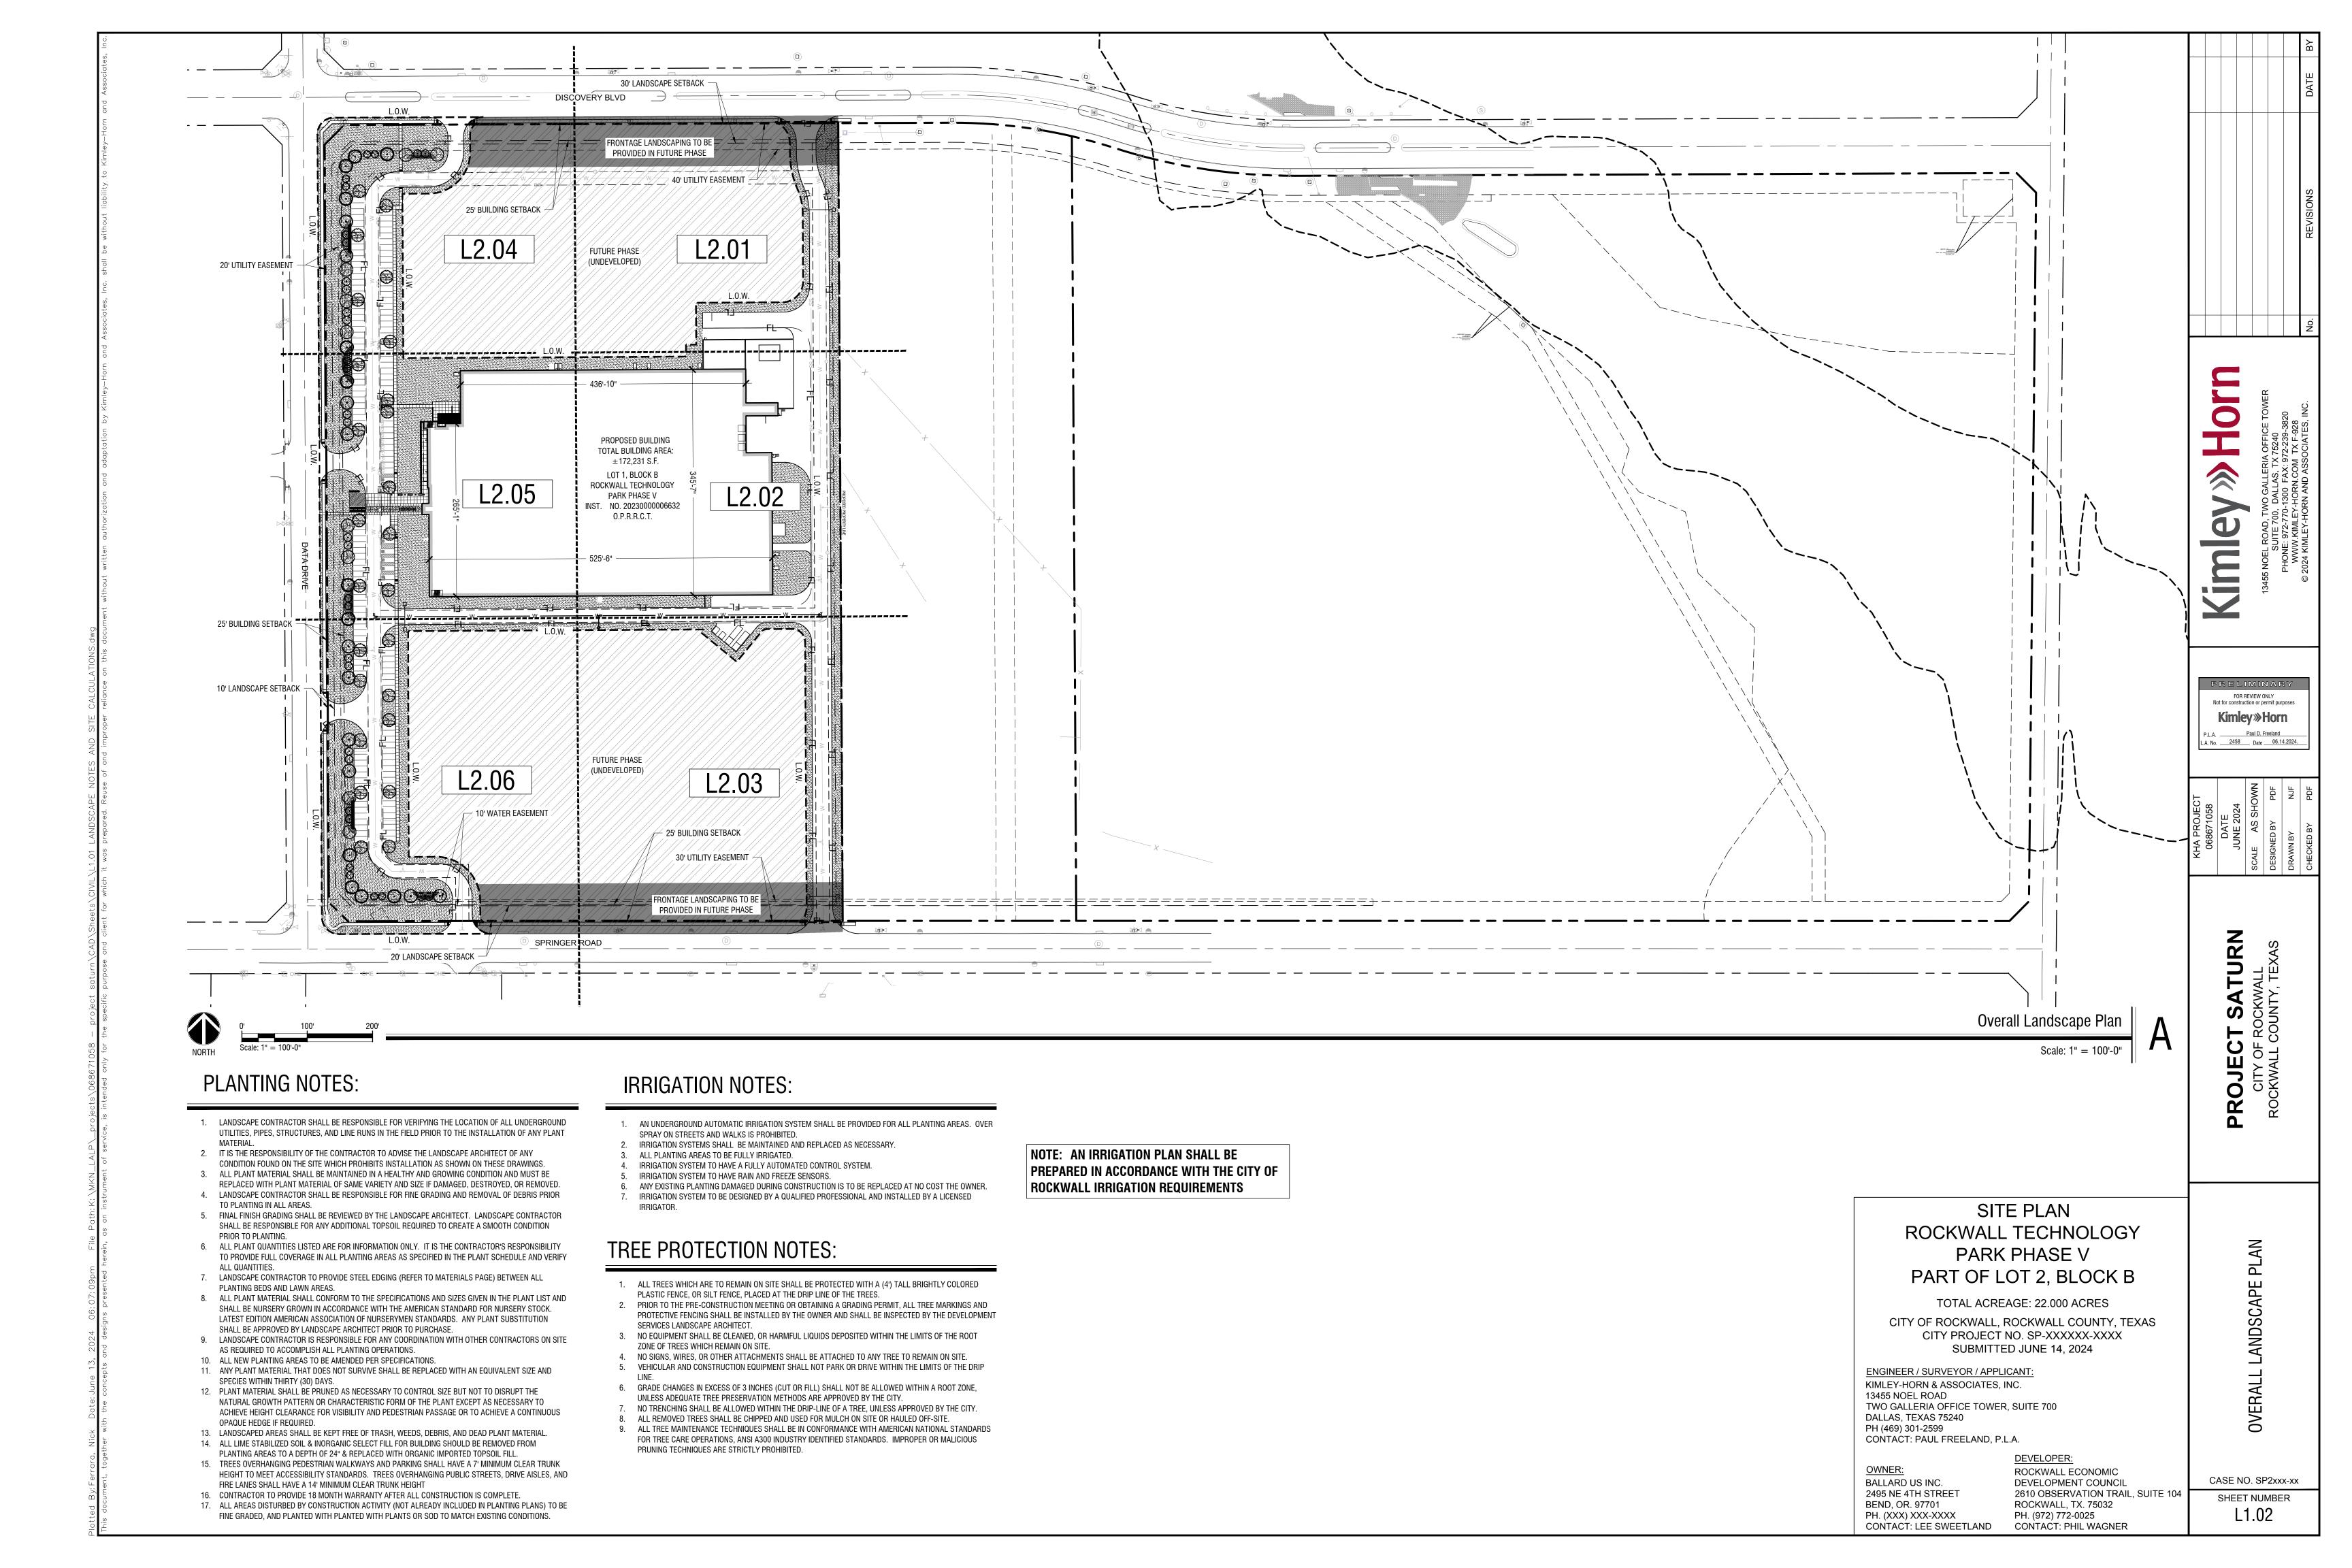


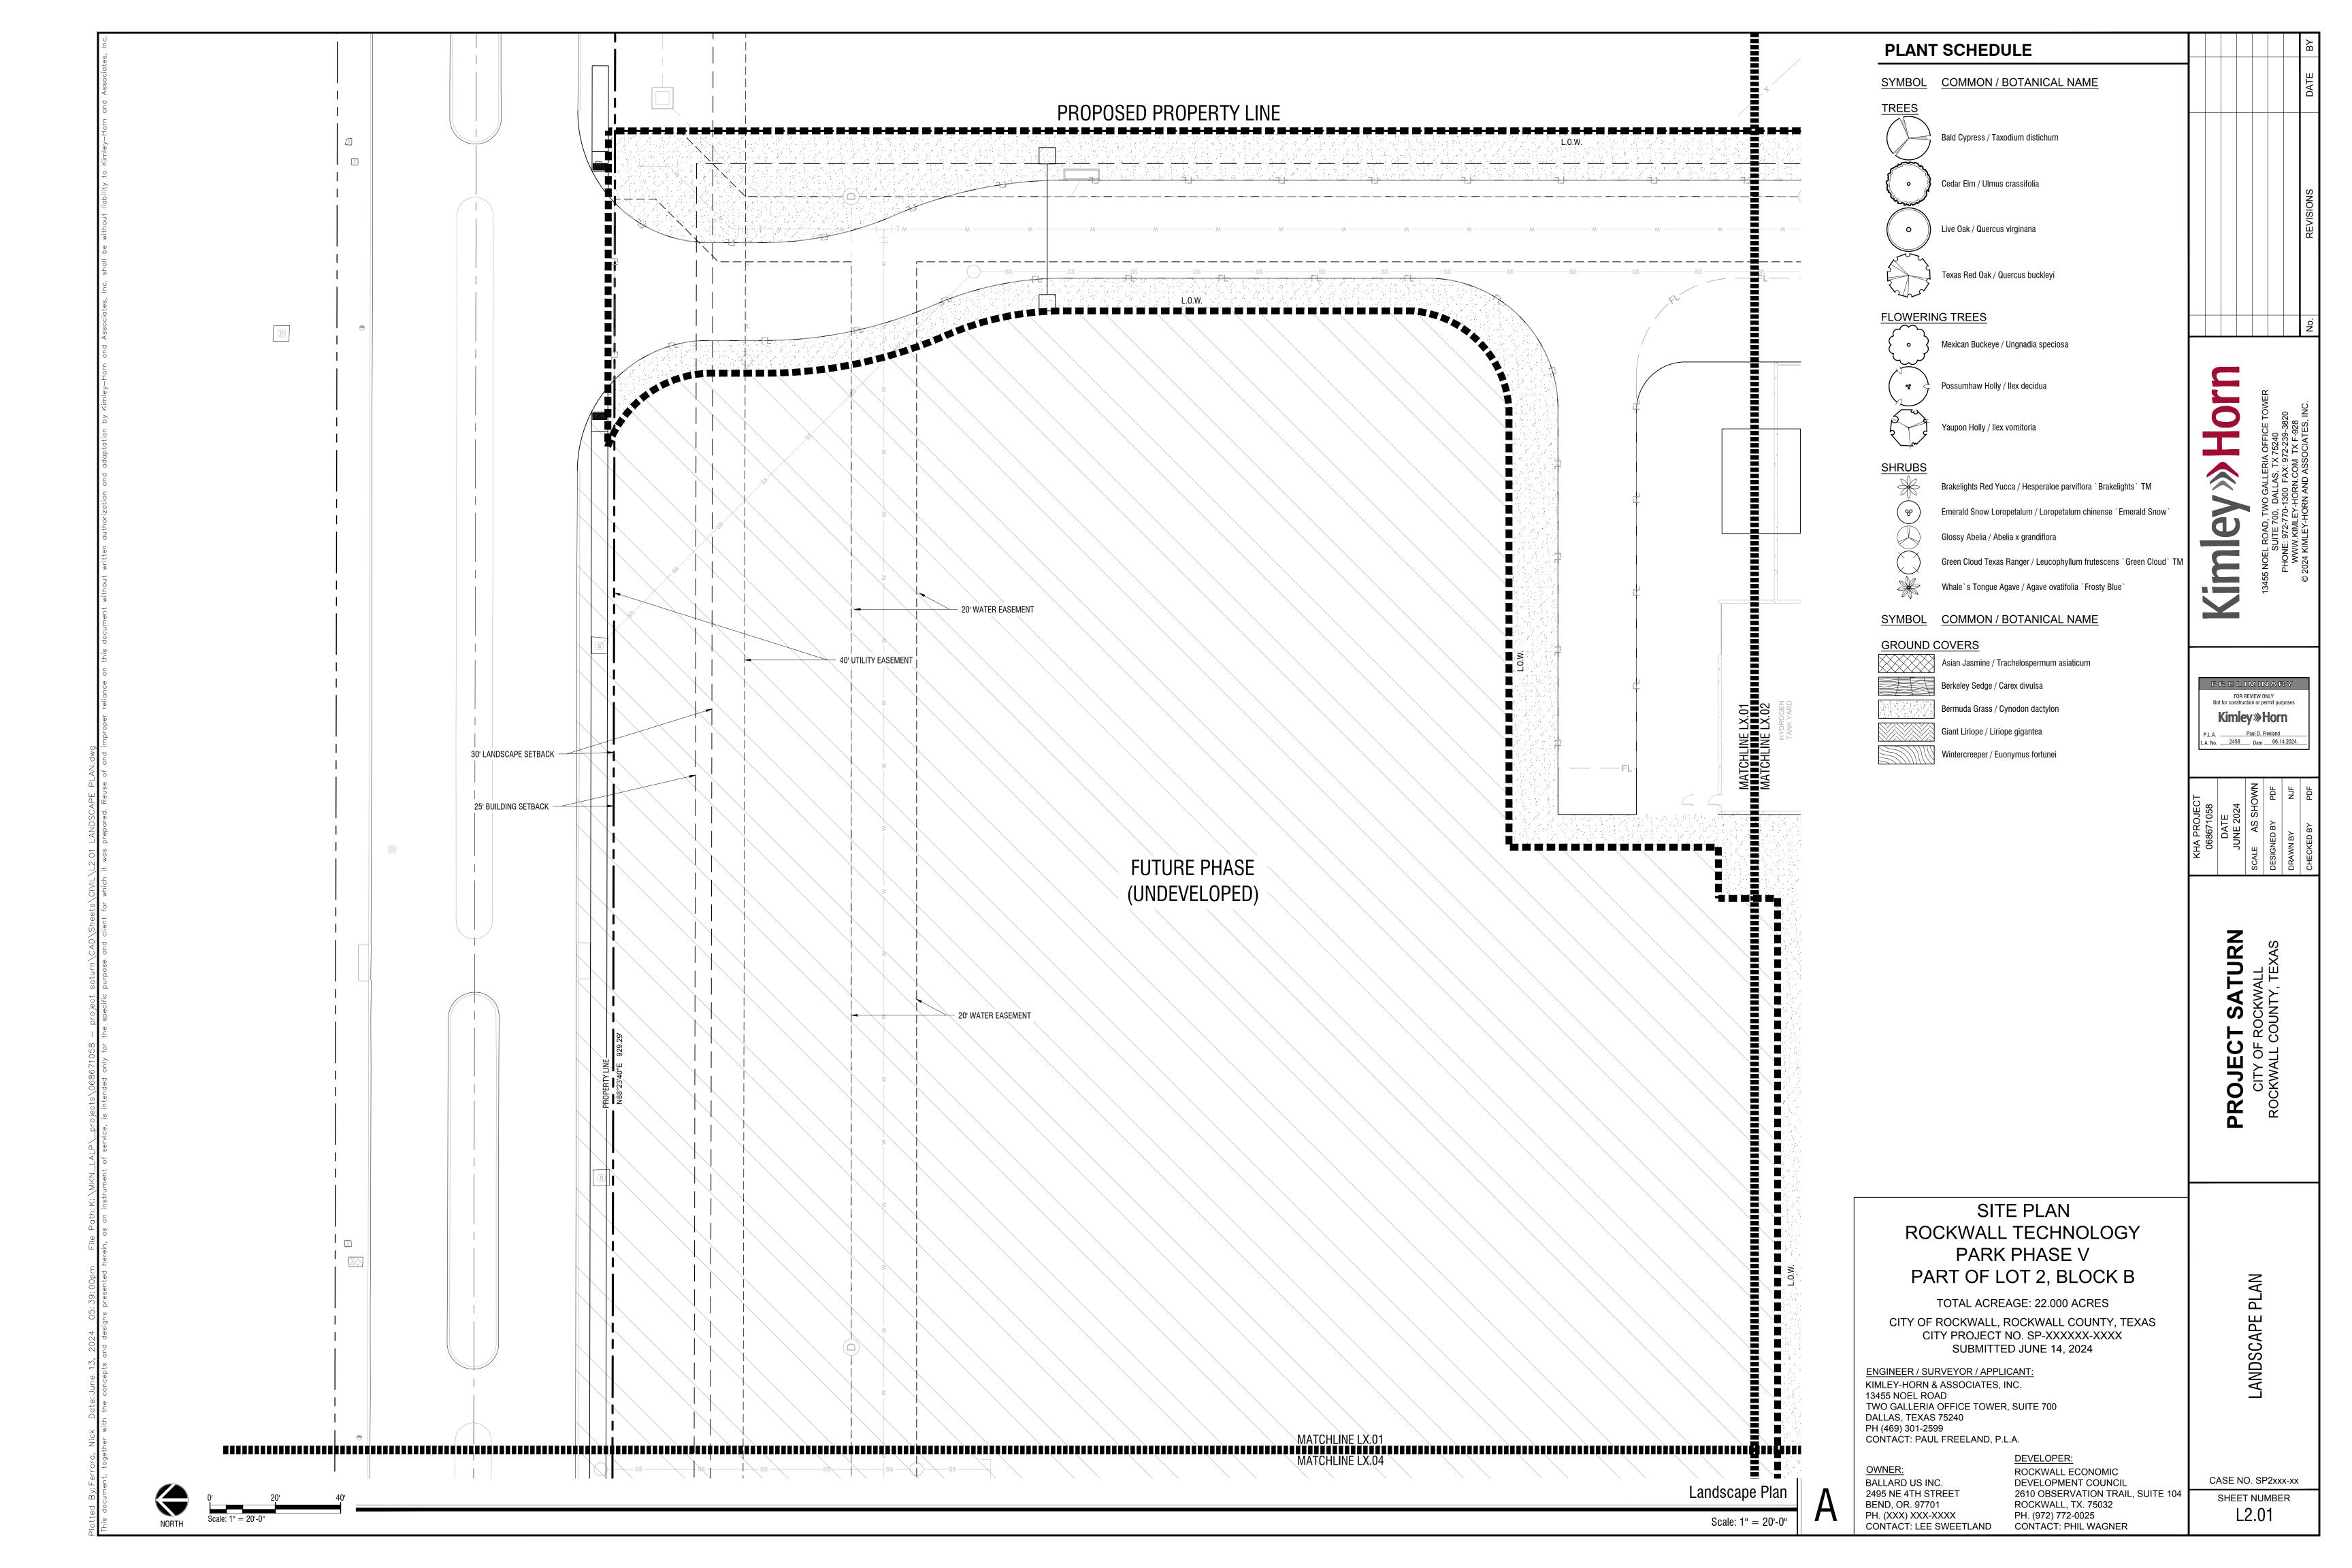


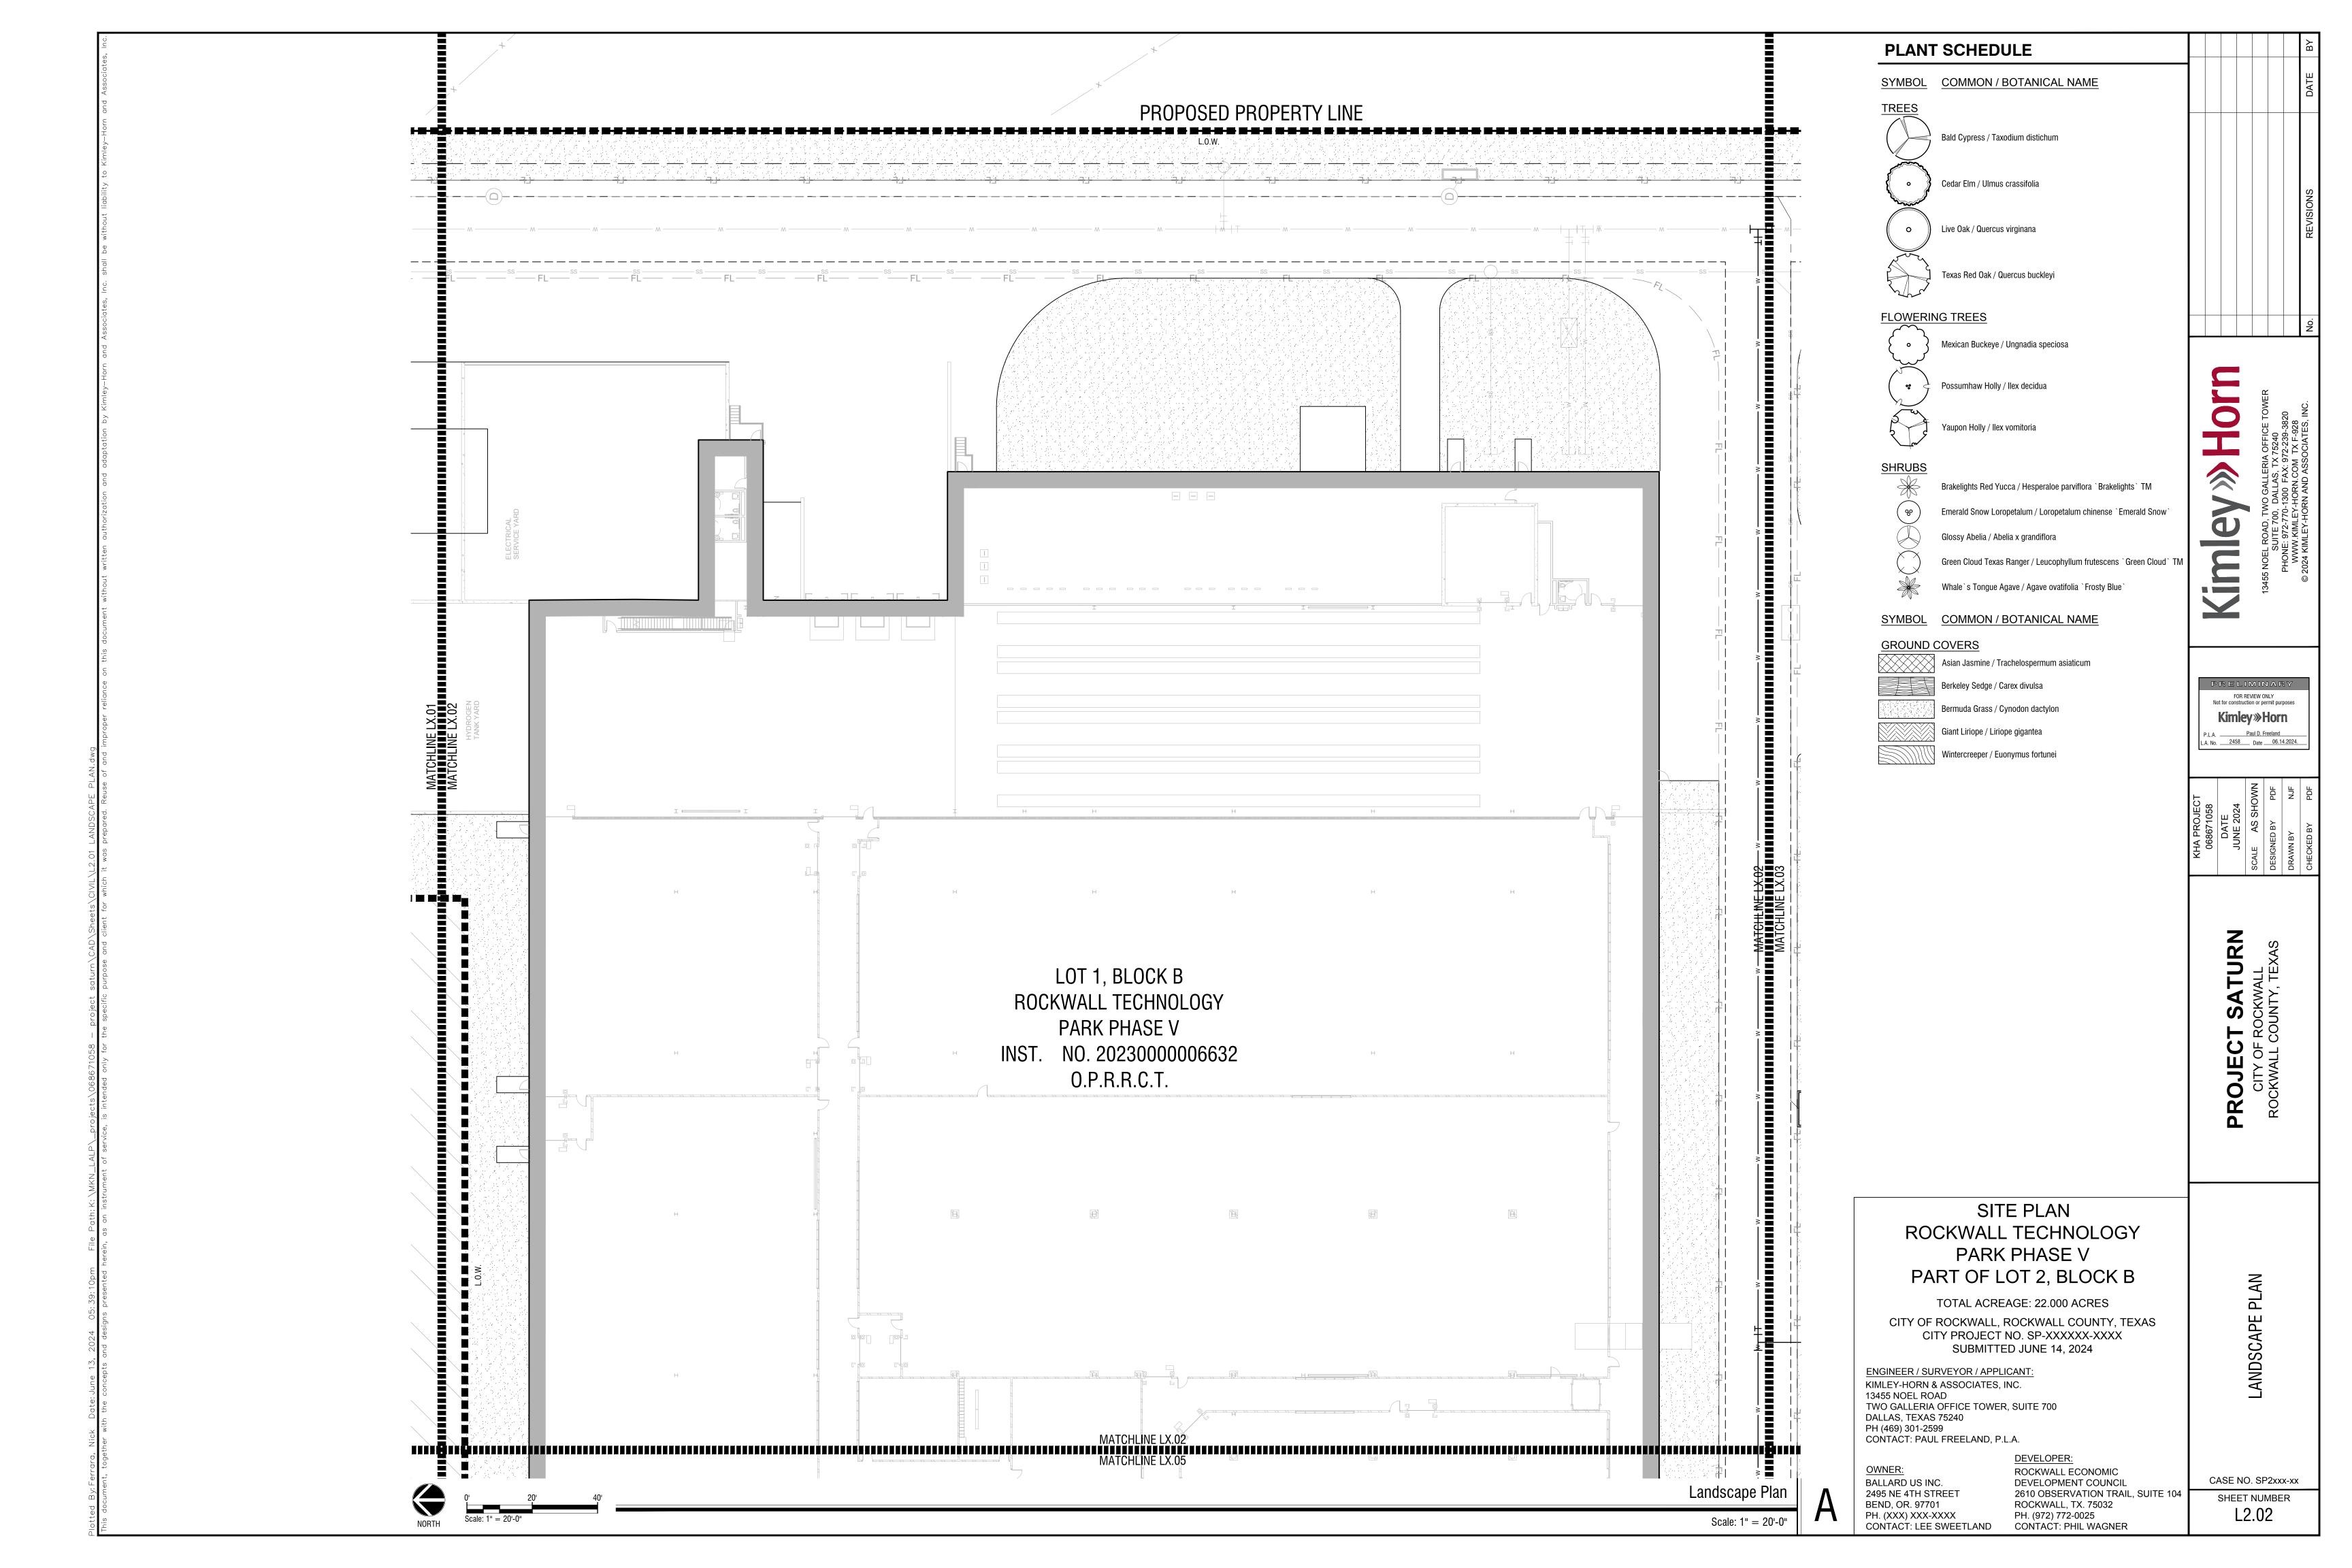

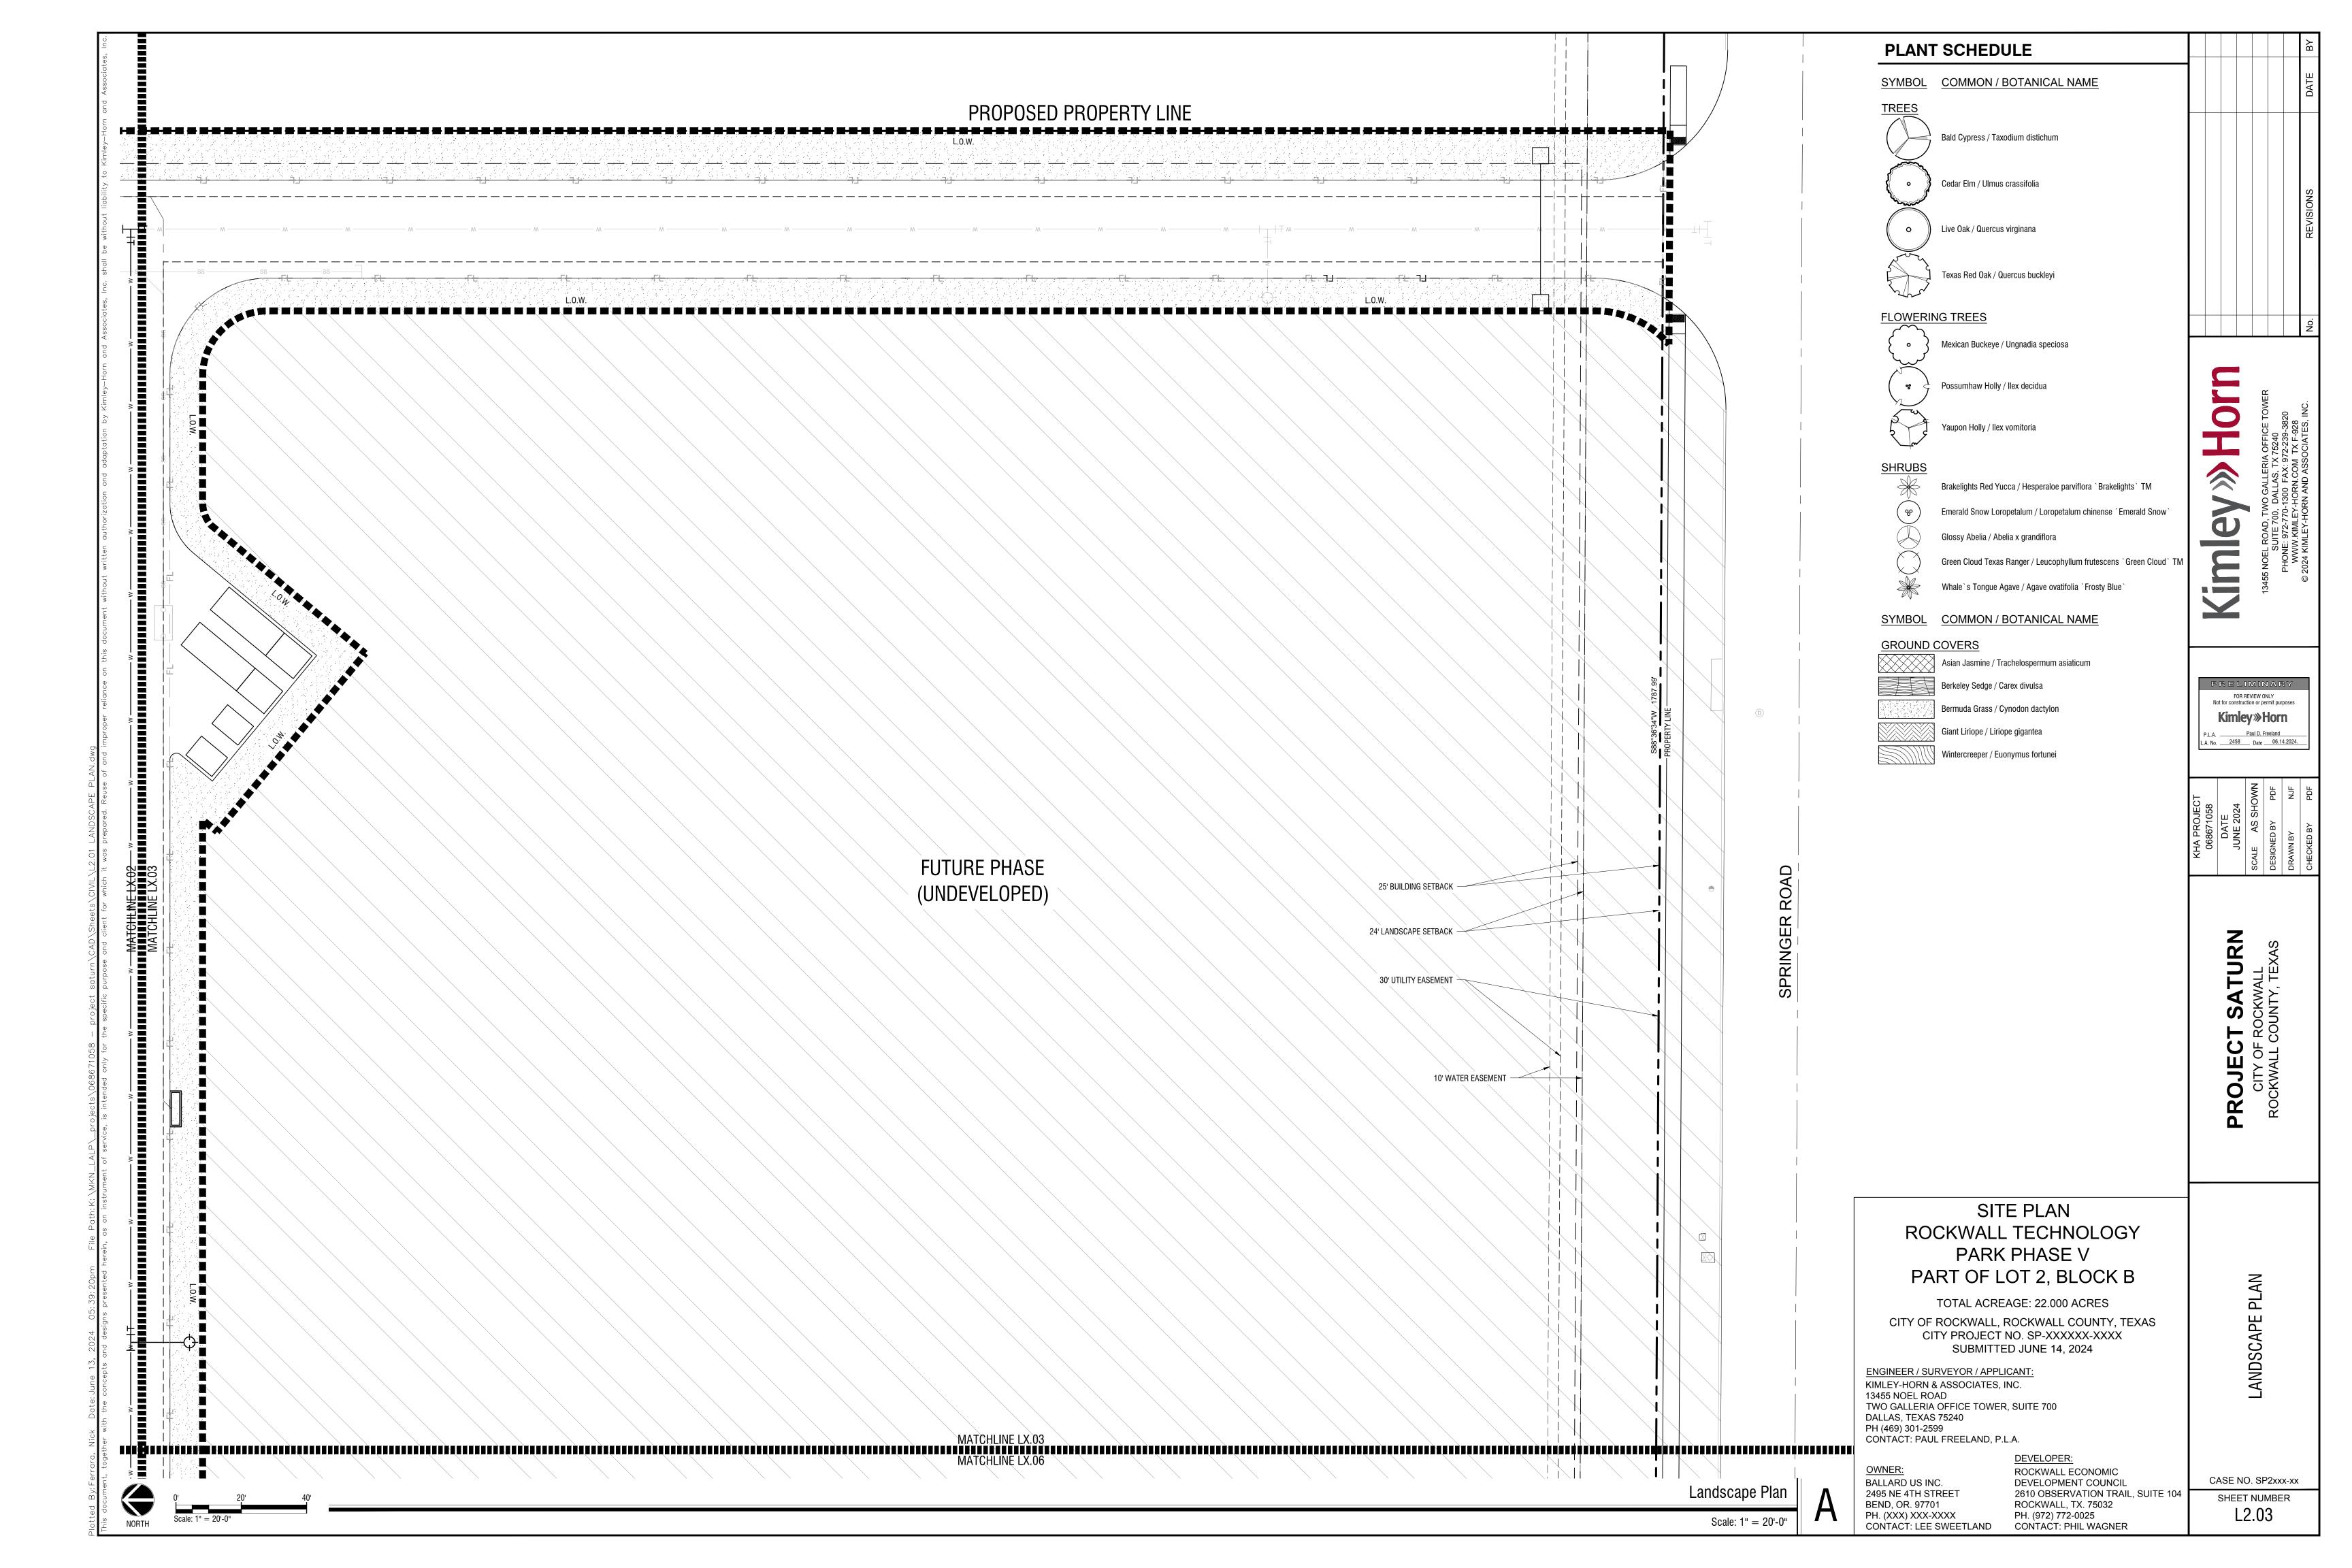

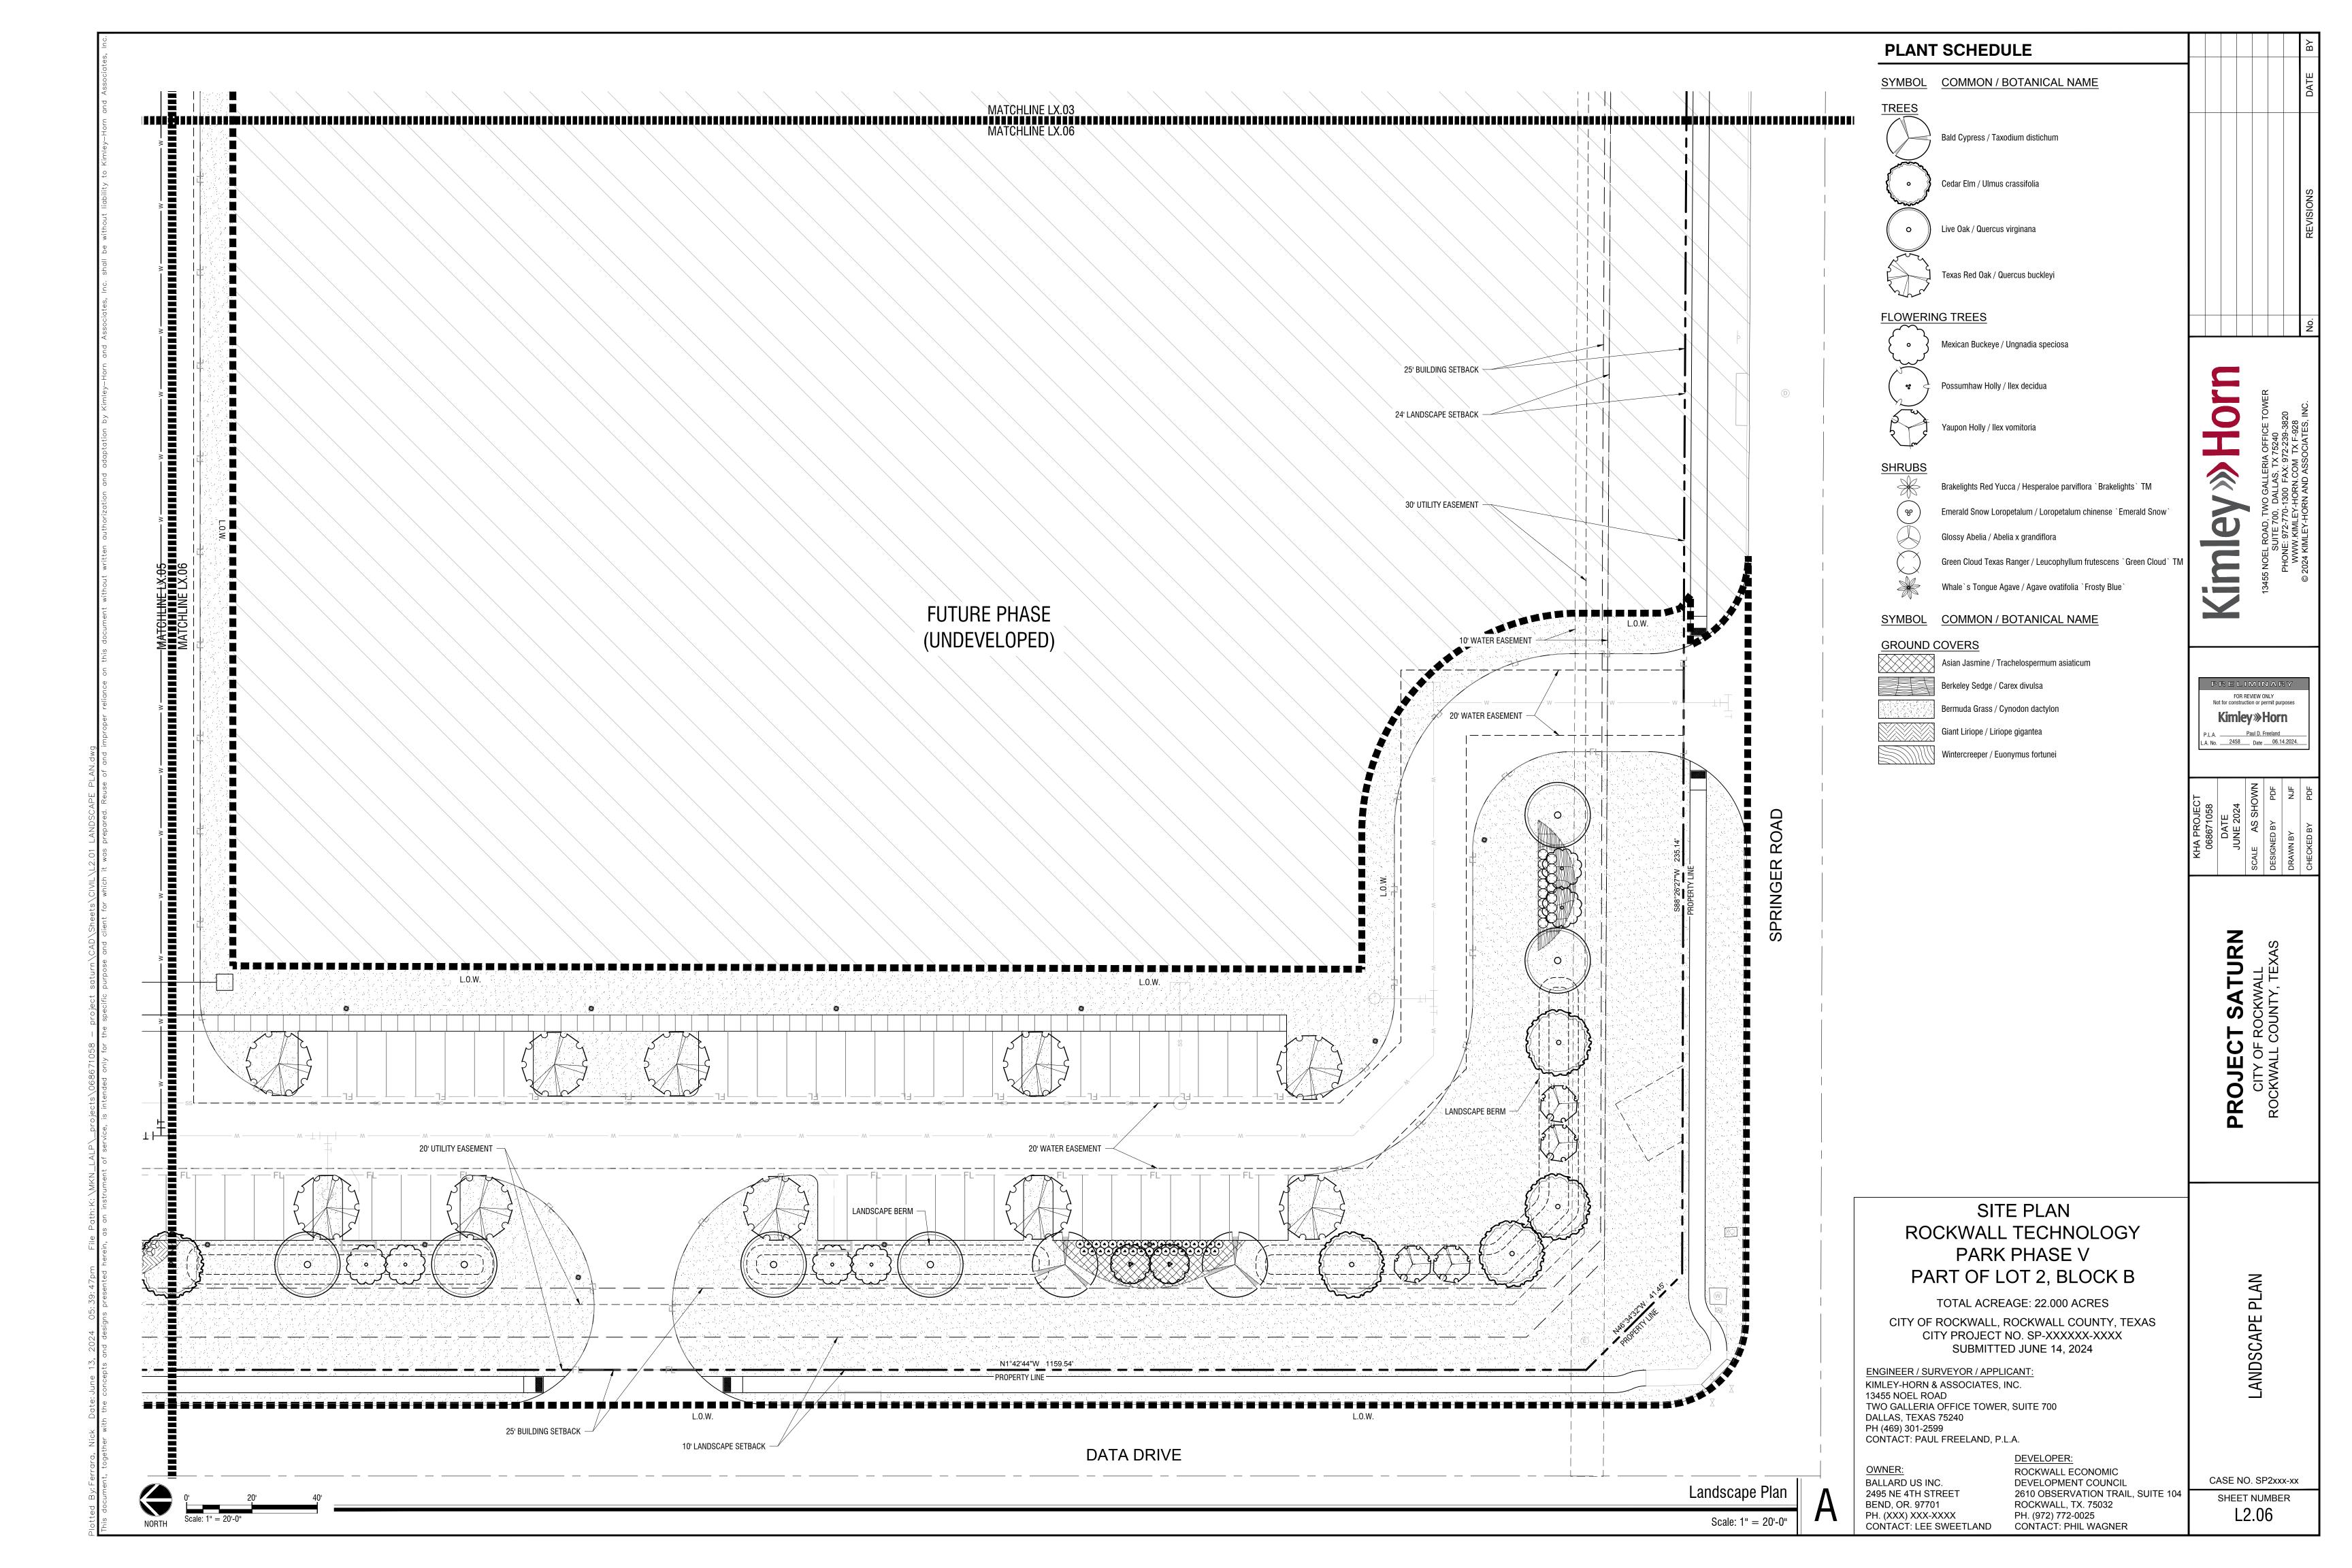

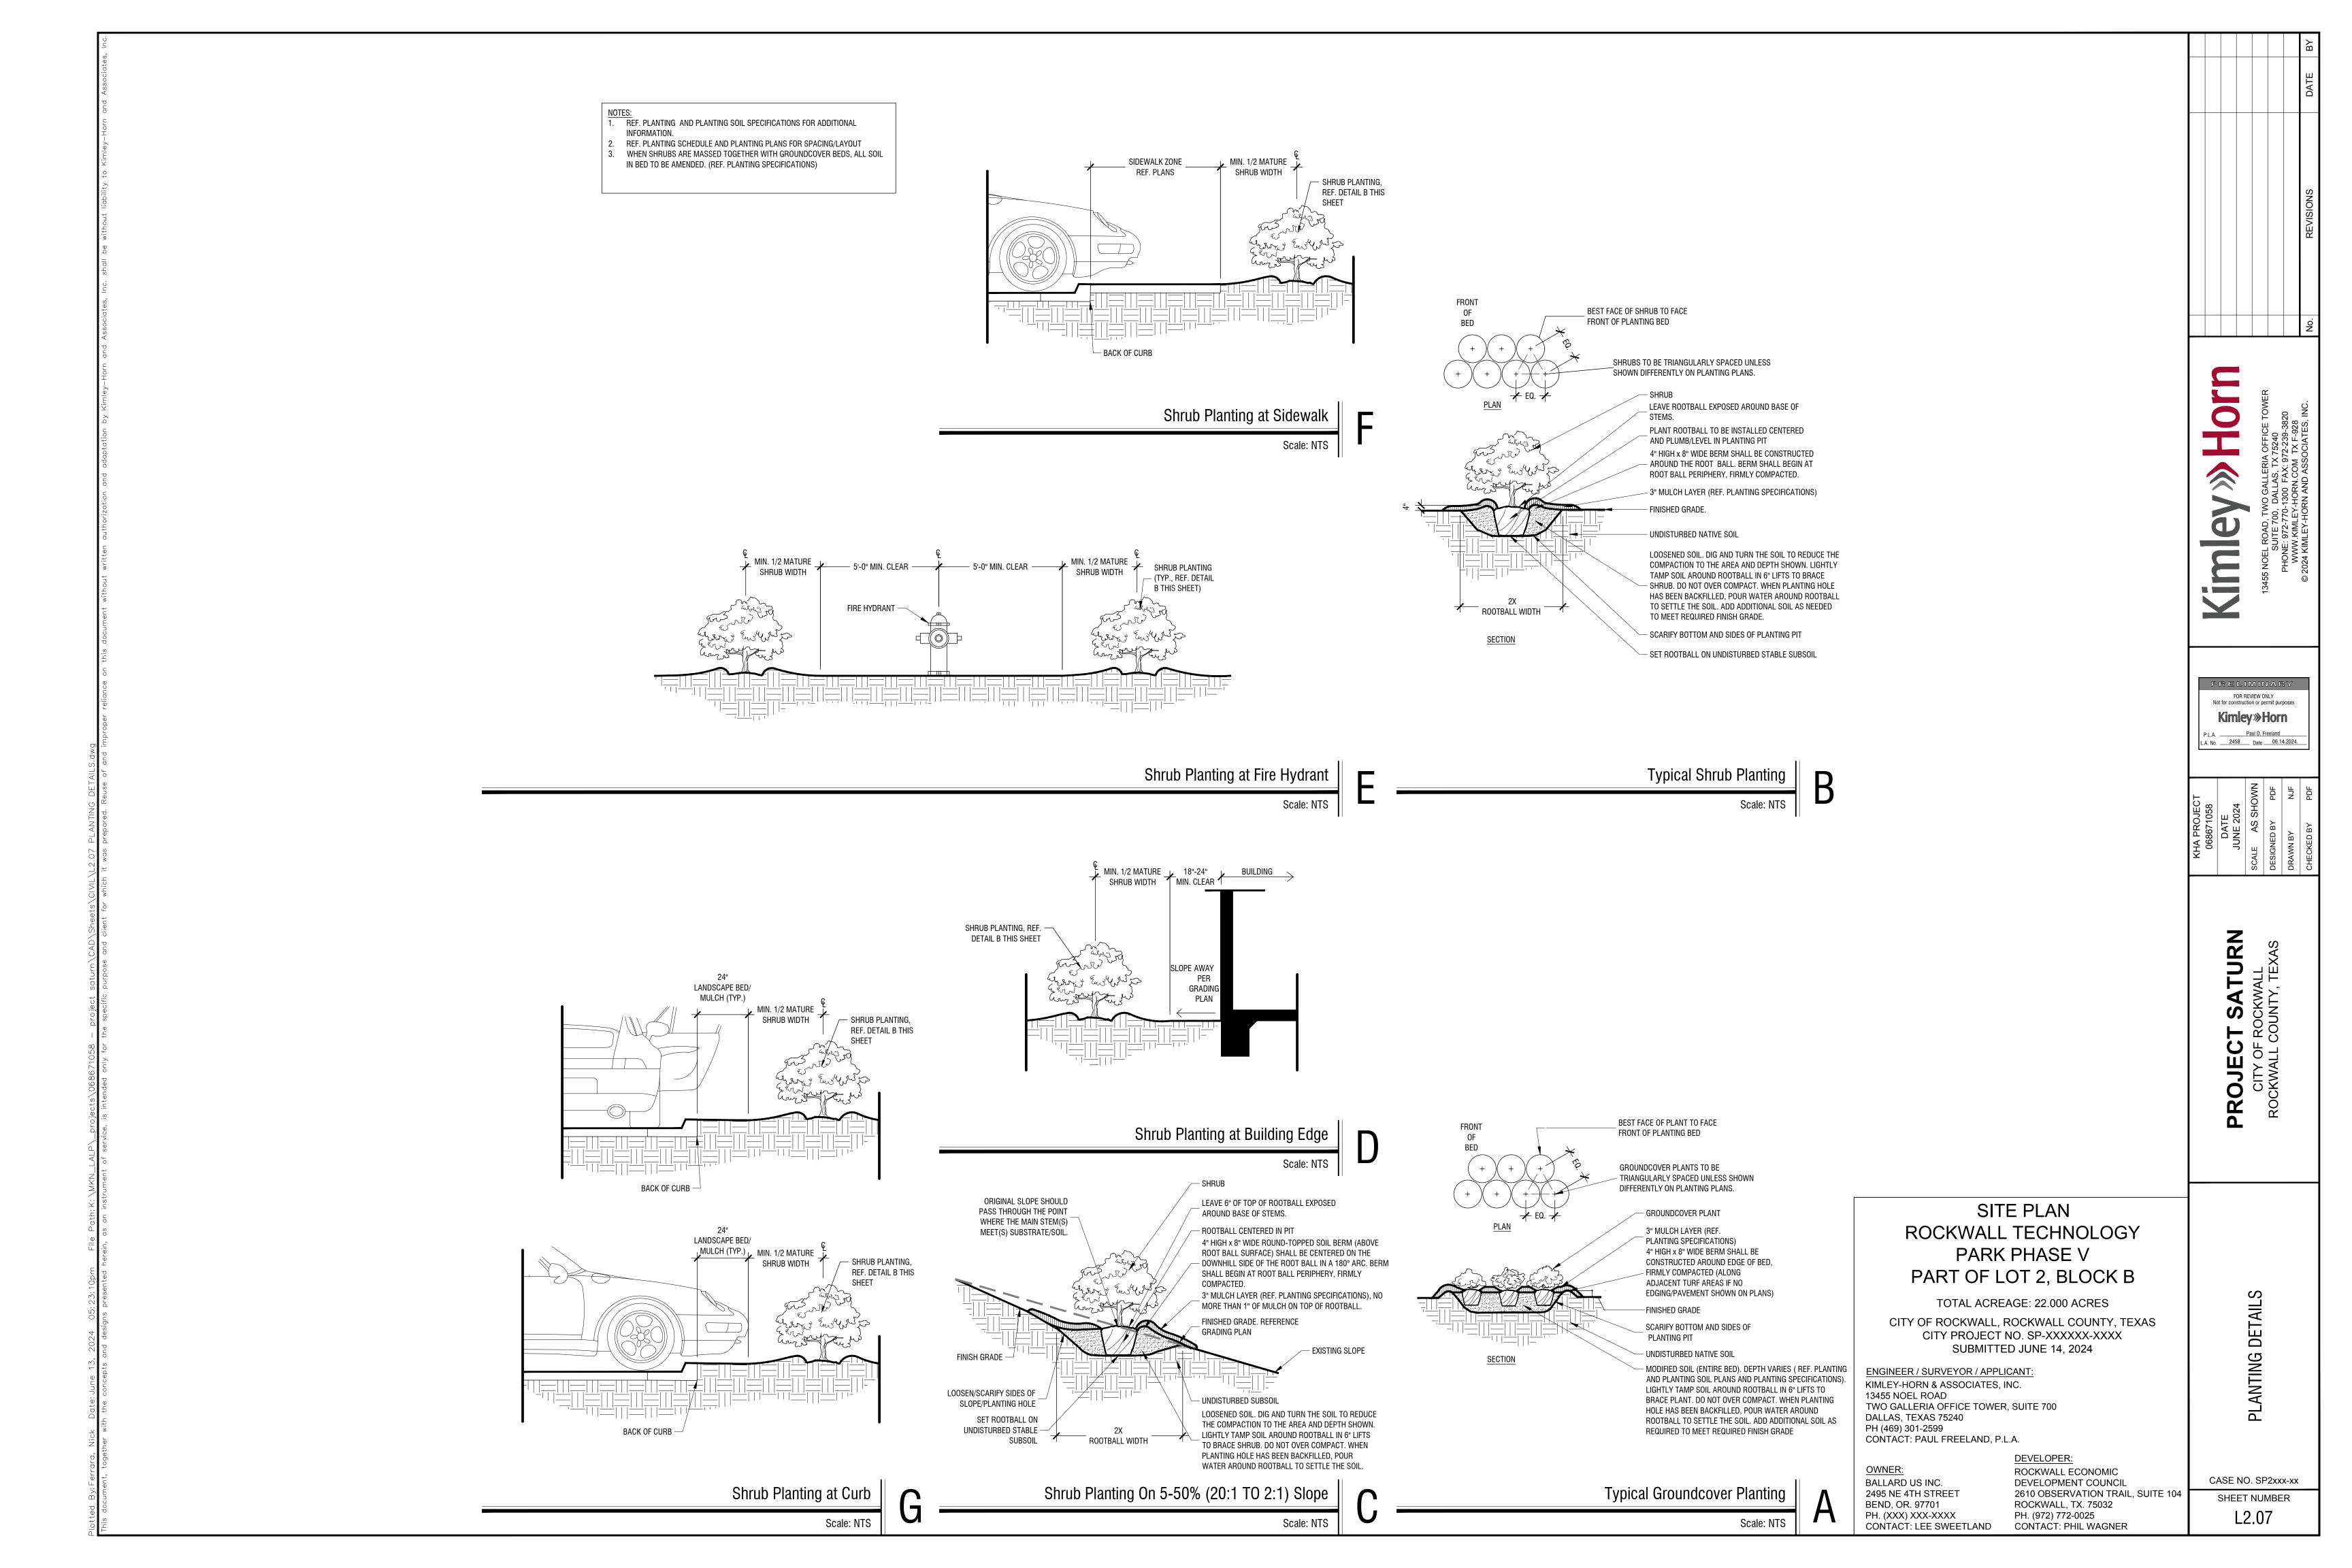

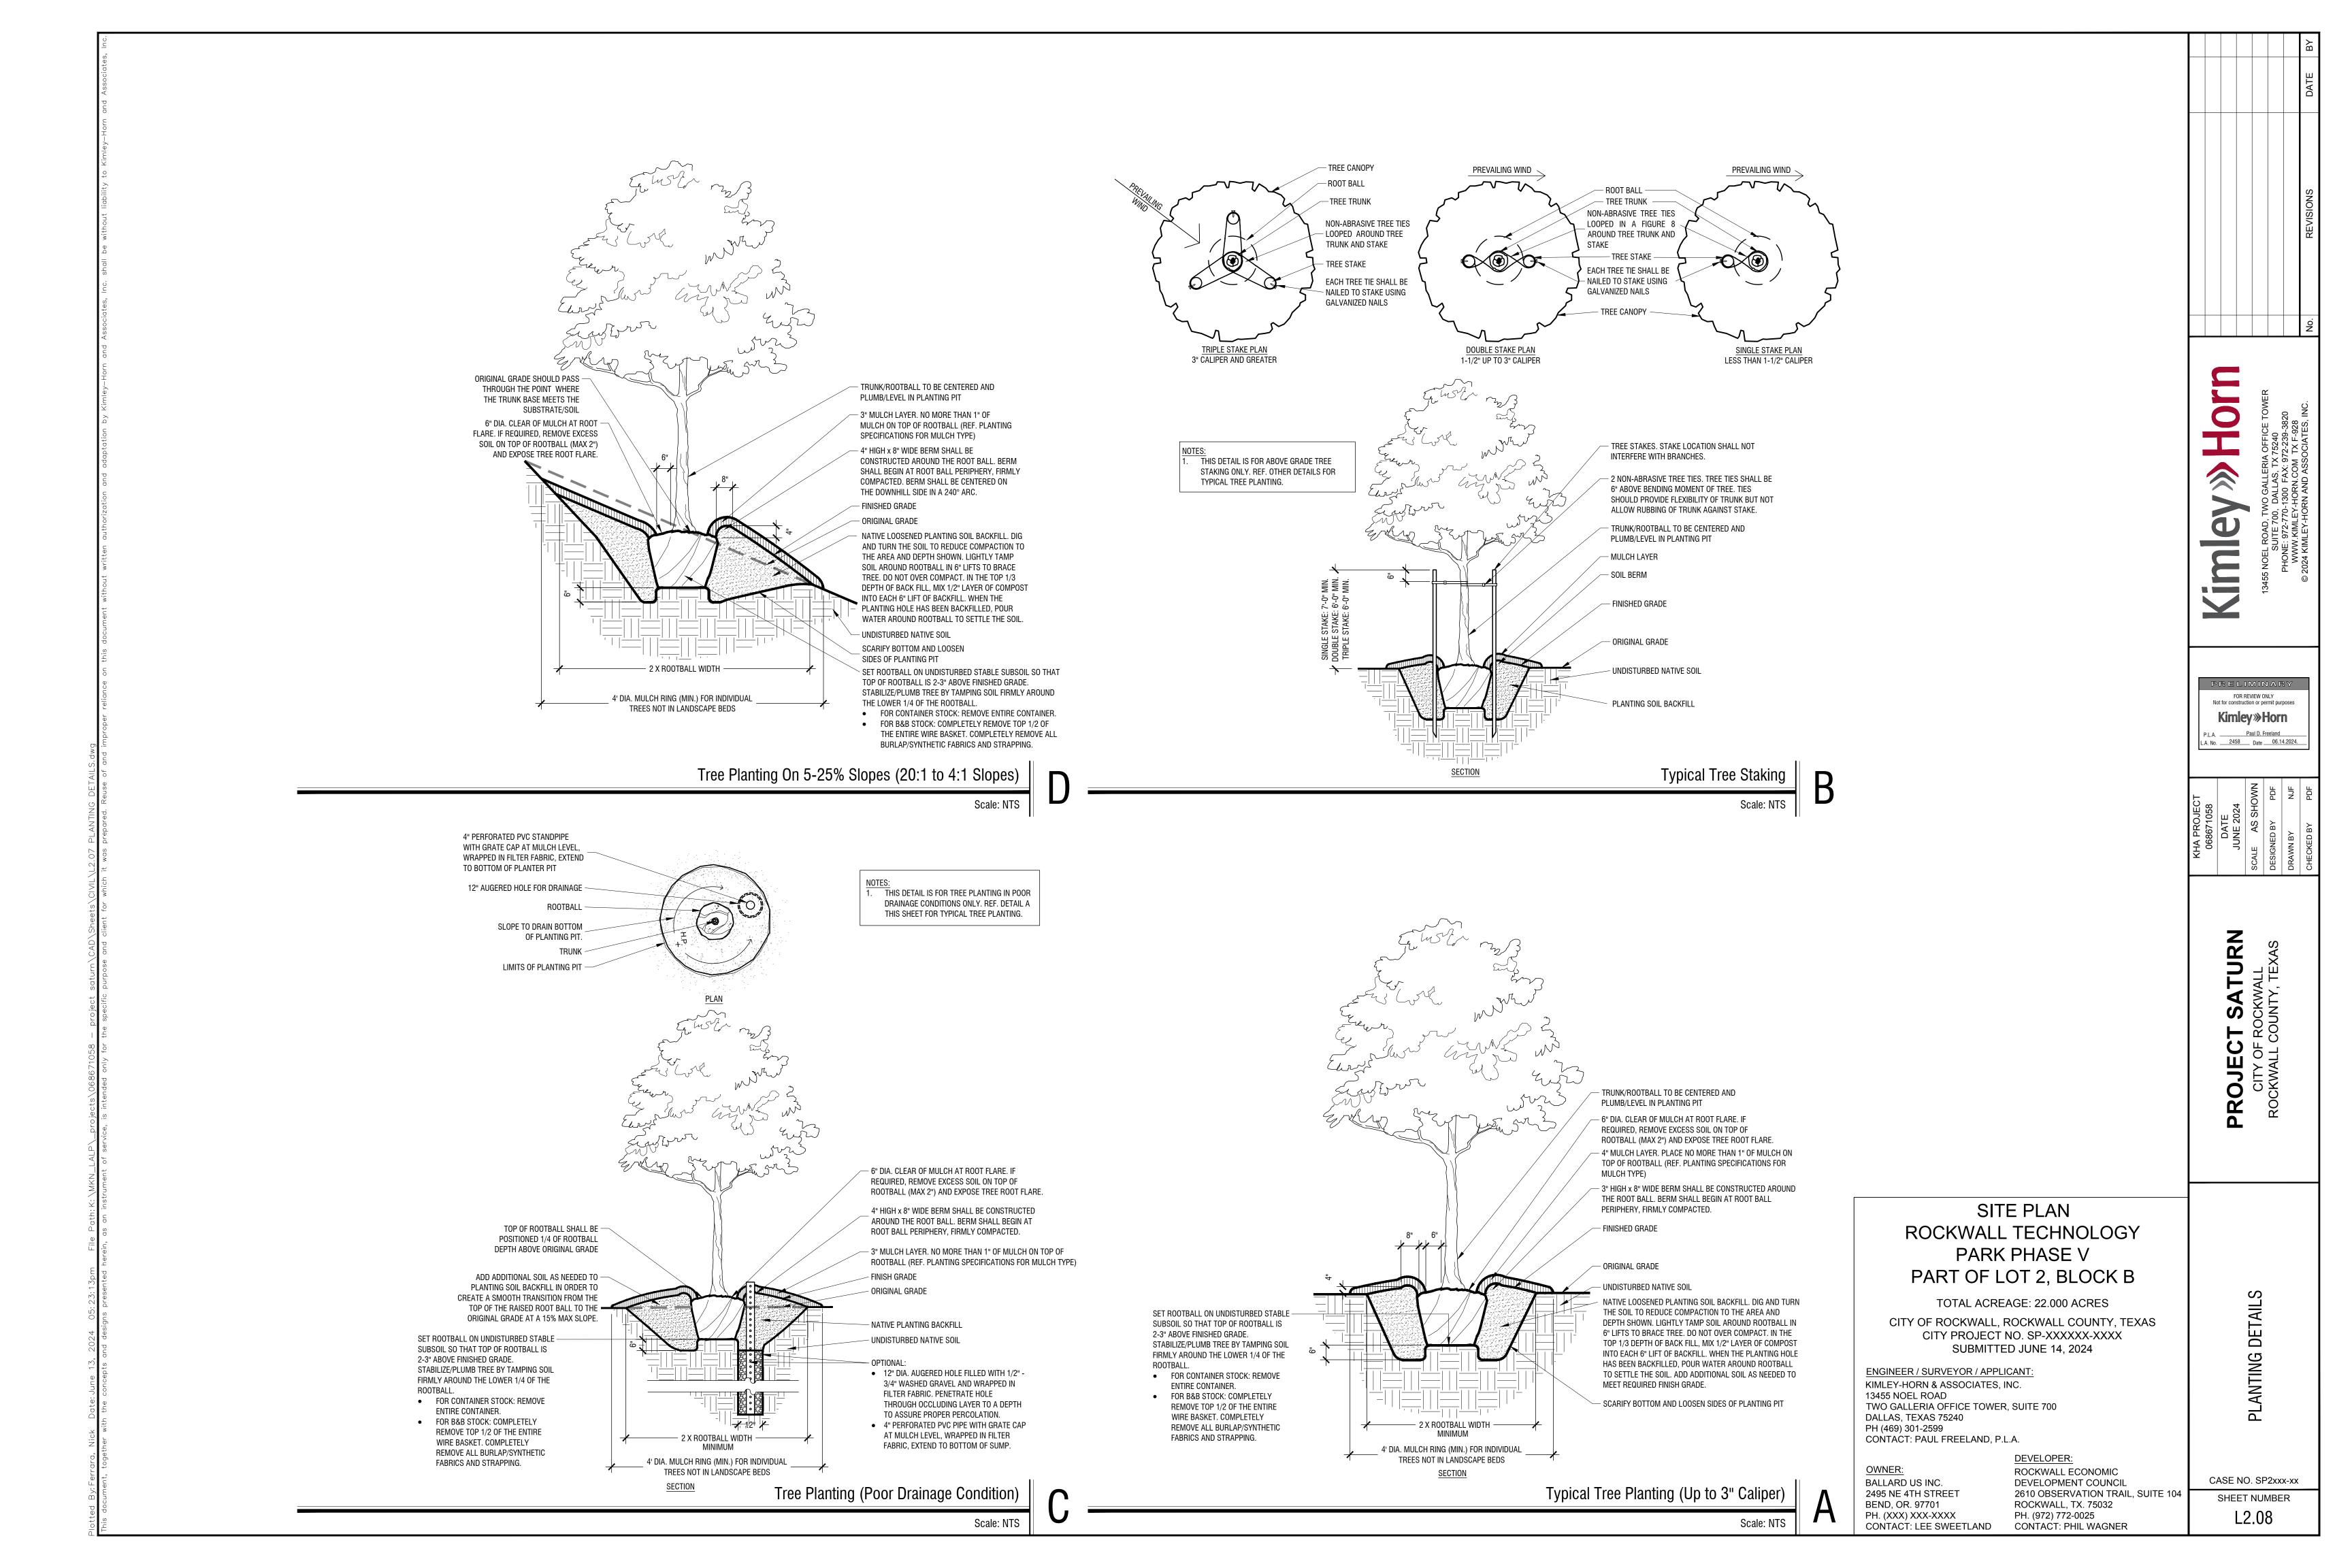

GENERAL LANDSCAPE SPECIFICATIONS AND NOTES

1. THE WORK CONSISTS OF FURNISHING ALL LABOR, MATERIALS, EQUIPMENT, TOOLS, TRANSPORTATION, AND ANY OTHER APPURTENANCES NECESSARY FOR THE COMPLETION OF THIS PROJECT AS SHOWN ON THE DRAWINGS AS INCLUDED IN THE PLANT LIST, AND AS HEREIN SPECIFIED

2. WORK SHALL INCLUDE MAINTENANCE AND WATERING OF ALL PLANTING AREAS OF THIS CONTRACT UNTIL CERTIFICATION OF ACCEPTABILITY BY THE OWNER.

ALL EXISTING BUILDINGS, WALKS, WALLS, PAVING, PIPING, AND OTHER ITEMS OF CONSTRUCTION AND PLANTING ALREADY COMPLETED OR ESTABLISHED SHALL BE PROTECTED FROM DAMAGE BY THIS CONTRACTOR UNLESS OTHERWISE SPECIFIED. ALL DAMAGE RESULTING FROM NEGLIGENCE SHALL BE REPAIRED OR REPLACED TO THE SATISFACTION OF THE OWNER.

C. PROTECTION OF EXISTING PLANT MATERIALS OUTSIDE LIMIT OF WORK

THE CONTRACTOR SHALL BE RESPONSIBLE FOR ALL UNAUTHORIZED CUTTING OR DAMAGE TO TREES AND SHRUBS EXISTING OR OTHERWISE, CAUSED BY CARELESS OPERATION OF EQUIPMENT, STOCKPILING OF MATERIALS, ETC. THIS SHALL INCLUDE COMPACTION BY DRIVING OR PARKING INSIDE THE DRIP-LINE OR THE SPILLING OF OIL, GASOLINE, OR OTHER DELETERIOUS MATERIALS WITHIN THE DRIP-LINE NO MATERIALS SHALL BE BURNED WHERE THE HEAT WILL DAMAGE ANY PLANT. TREES KILLED OR DAMAGED SO THAT THEY ARE MISSHAPEN AND/ OR UNSIGHTLY SHALL BE REPLACED AT THE COST TO THE CONTRACTOR OF ONE HUNDRED DOLLARS (\$100) PER CALIPER INCH ON AN ESCALATING SCALE WHICH ADDS AN ADDITIONAL TWENTY (20) PER CENT PER INCH OVER FOUR (4) INCHES CALIPER AS FIXED AND AGREED LIQUIDATED DAMAGES. CALIPER SHALL BE MEASURED SIX (6) INCHES ABOVE GROUND LEVEL FOR TREES UP TO AND INCLUDING FOUR (4) INCHES IN CALIPER AND TWELVE (12) INCHES ABOVE GROUND LEVEL FOR TREES OVER FOUR (4) INCHES IN CALIPER.

SAMPLES OF MATERIALS AS LISTED BELOW SHALL BE SUBMITTED FOR APPROVAL, ON THE SITE OR

AS OTHERWISE DETERMINED BY THE OWNER. UPON APPROVAL OF SAMPLES, DELIVERY OF MATERIALS MAY BEGIN

TOPSOIL ONE (1) CUBIC YARD PLANTS ONE (1) OF EACH VARIETY

A PLANT SPECIES AND SIZE SHALL CONFORM TO THOSE INDICATED ON THE DRAWINGS NOMENCI ATURE SHALL CONFORM TO STANDARDIZED PLANT NAMES 1942 EDITION. ALL NURSERY STOCK SHALL BE IN ACCORDANCE WITH GRADES AND STANDARDS AS STATED IN THE LATEST EDITION OF "AMERICAN STANDARD FOR NURSERY STOCK" BY THE AMERICAN ASSOCIATION OF NURSERYMEN. ALL PLANTS SHALL BE FRESHLY DUG. SOUND. HEALTHY. VIGOROUS. WELL-BRANCHED AND FREE OF DISEASE AND INSECTS. INSECT EGGS AND LARVAE AND SHALL HAVE ADEQUATE ROOT SYSTEMS. TREES FOR

PLANTING IN ROWS SHALL BE UNIFORM IN SIZE AND SHAPE. ALL MATERIALS SHALL BE SUBJECT TO APPROVAL BY THE OWNER. WHERE ANY REQUIREMENTS ARE OMITTED FROM THE PLANT LIST, THE PLANTS FURNISHED SHALL BE NORMAL FOR THE VARIETY. PLANTS SHALL BE PRUNED PRIOR TO DELIVERY ONLY UPON THE APPROVAL OF THE OWNER. B. MEASUREMENTS: THE HEIGHT AND/OR WIDTH OF TREES SHALL BE MEASURED FROM THE GROUND OR ACROSS THE NORMAL SPREAD OF BRANCHES WITH THE PLANTS IN THEIR NORMAL POSITION. THIS MEASUREMENT SHALL NOT INCLUDE THE IMMEDIATE TERMINAL GROWTH. PLANTS LARGER IN SIZE THAN

C. INSPECTION: PLANTS SHALL BE SUBJECT TO INSPECTION AND APPROVAL AT THE PLACE OF GROWTH OR UPON DELIVERY TO THE SITE AS DETERMINED BY THE OWNER FOR QUALITY SIZE ANI VARIETY; SUCH APPROVAL SHALL NOT IMPAIR THE RIGHT OF INSPECTION AND REJECTION AT THE SITE DURING PROGRESS OF THE WORK OR AFTER COMPLETION FOR SIZE AND CONDITION OF BALLS OR ROOTS, LATENT DEFECTS OR INJURIES. REJECTED PLANTS SHALL BE REMOVED IMMEDIATELY FROM THE SITE. NOTICE REQUESTING INSPECTION SHALL BE SUBMITTED IN WRITING BY THE CONTRACTOR AT LEAST ONE

1 ASTM D5268 NATURAL FRIABLE FERTILE, FINE LOAMY SOIL POSSESSING CHARACTERISTICS OF REPRESENTATIVE TOPSOIL IN THE VICINITY THAT PRODUCES HEAVY GROWTH. TOPSOIL SHALL HAVE A PH RANGE OF 5.5 TO 7.4 PERCENT, FREE FROM SUBSOIL, OBJECTIONABLE WEEDS, LITTER, SODS, STIFF CLAY STONES LARGER THAN 1-INCH IN DIAMETER, STUMPS, ROOTS, TRASH, HERBICIDES, TOXIC SUBSTANCES, OR ANY OTHER MATERIAL WHICH MAY BE HARMFUL TO PLANT GROWTH OR HINDER PLANTING OPERATIONS. TOP SOIL SHALL CONTAIN A MINIMUM OF THREE PERCENT ORGANIC MATERIAL

2. SALVAGED OR EXISTING TOPSOIL: REUSE SUITABLE TOPSOIL STOCKPILED ON-SITE OR EXISTING TOPSOIL LINDISTURBED BY GRADING OR EXCAVATION OPERATIONS. CLEAN TOPSOIL OF ROOTS, PLANTS, SOD, STONES, CLAY LUMPS, AND OTHER EXTRANEOUS MATERIALS HARMFUL TO PLANT GROWTH

3 VERIEY AMOUNT OF SUITABLE TOPSOIL STOCKPILED IF ANY AND SUPPLY ADDITIONAL IMPORTED TOPSOIL AS NEEDED. FOUR (4) INCHES OF TOPSOIL TO BE PROVIDED FOR ALL TURF AREAS. TWENTY FOUR (24) INCHES OF TOPSOIL TO BE PROVIDED FOR ALL PLANTING AREAS WITHIN INTERIOR LANDSCAPE ISLANDS AND FOUNDATION PLANTINGS. FOR ALL OTHER PLANTING AREAS, TWELVE (12) INCHES OF TOPSOIL MINIMUM TO

4. IMPORTED TOPSOIL: SUPPLEMENT SALVAGED TOPSOIL WITH IMPORTED TOPSOIL FROM OFF-SITE SOURCES WHEN EXISTING QUANTITIES ARE INSUFFICIENT 5. OBTAIN TOPSOIL DISPLACED FROM NATURALLY WELL-DRAINED SITES WHERE TOPSOIL OCCURS AT LEAST 6

NCHES DEEP; DO NOT OBTAIN FROM AGRICULTURAL LAND, BOGS, OR MARSHES 6. VERIFY BORROW AND DISPOSAL SITES ARE PERMITTED AS REQUIRED BY STATE AND LOCAL REGULATIONS.

OBTAIN WRITTEN CONFIRMATION THAT PERMITS ARE CURRENT AND ACTIVE 7. OBTAIN PERMITS REQUIRED BY STATE AND LOCAL REGULATIONS FOR TRANSPORTING TOPSOIL. PERMITS

SHALL BE CURRENT AND ACTIVE 8 AMEND EXISTING AND IMPORTED TOPSOIL AS INDICATED BELOW.

> 1. MANURE: WELL-ROTTED, UNLEACHED, STABLE OR CATTLE MANURE CONTAINING NOT MORE OF TOXIC SUBSTANCES, STONES, STICKS, SOIL, WEED SEED, AND MATERIAL HARMFUL TO

2. BACK TO NATURE COTTON BURR COMPOST OR APPROVED EQUIVALENT. 3. COMPOST: DECOMPOSED ORGANIC MATERIAL INCLUDING LEAF LITTER, MANURE, SAWDUST,

PLANT TRIMMINGS AND/OR HAY, MIXED WITH SOIL. 4. PECAN HULLS: COMPOSTED PECAN HULLS FOR LOCAL SOURCE.

5. BIOSOLIDS: USE GRADE 1 CONTAINING LOWER PATHOGEN LEVELS. WORM CASTINGS: EARTHWORMS.

b. INORGANIC SOIL AMENDMENTS

1. LIME: ASTM C602, CLASS O AGRICULTURAL LIMESTONE CONTAINING A MINIMUM OF 80 PERCENT CALCIUM CARBONATE EQUIVALENT WITH A MINIMUM OF 95 PERCENT PASSING NO. 8

SIEVE AND MINIMUM OF 55 PERCENT PASSING NO. 60 SIEVE. 2. SULFUR: GRANULAR, BIODEGRADABLE, CONTAINING A MINIMUM OF 90 PERCENT SULFUR, WITH A MINIMUM OF 99 PERCENT PASSING NO. 6 SIEVE AND A MAXIMUM OF 10 PERCENT

PASSING NO. 40 SIEVE. 3. IRON SULFATE: GRANULATED FERROUS SULFATE CONTAINING A MINIMUM OF 20 PERCENT

IRON AND 10 PERCENT SULFUR.

4. AGRICULTURAL GYPSUM: FINELY GROUND, CONTAINING A MINIMUM OF 90 PERCENT CALCIUM

5. SAND: CLEAN, WASHED, NATURAL OR MANUFACTURED, FREE OF TOXIC MATERIALS.

1. PLANTING MIX MAY BE PROVIDED BY LIVING EARTH OR MINICK MATERIALS OR APPROVED

2. PLANTING MEDIUM CONTAINING 75 PERCENT SPECIFIED TOPSOIL MIXED WITH 15 PERCENT ORGANIC SOIL AMENDMENTS AND 10 PERCENT SHARP WASHED SAND. INSTALL TO DEPTHS PFR PI ANTING DETAILS (12" MIN.) FINISHED GRADES OF PLANTING BEDS TO BE 2" BELOW FINISHED GRADE OF ADJACENT PAVING OR AS SHOWN ON GRADING PLAN.

ALL SOD AREAS TO RECEIVE 4" DEPTH (MIN) TOPSOIL PRIOR TO INSTALLATION. TOPSOIL SHALL BE NATURAL, FRIABLE, FERTILE, WITH 25% (MIN.) ORGANIC MATERIAL, AND FREE OF TRASH, DEBRIS, STONES, WEEDS, AND TWIGS/BRANCHES. THE PARTICLE SIZES SHALL BE SUCH THAT 98.5% OF THE TOPSOIL WILL PASS THROUGH A 1/2 INCH SCREEN, AND 99% MORE SHALL PASS THROUGH A 3/4 INCH SCREEN. TOPSOIL SHALL BE REVIEWED/APPROVED BY OWNER/LANDSCAPE ARCHITECT PRIOR TO INSTALLATION. CONTRACTOR TO SUBMIT SAMPLES IN 1 GAL (MIN.) CONTAINER.

WATER NECESSARY FOR PLANTING AND MAINTENANCE SHALL BE OF SATISFACTORY QUALITY TO SUSTAIN

AN ADEQUATE GROWTH OF PLANTS AND SHALL NOT CONTAIN HARMFUL. NATURAL OR MAN-MADE ELEMENTS DETRIMENTAL TO PLANTS. WATER MEETING THE ABOVE STANDARD SHALL BE OBTAINED ON THE SITE FROM THE OWNER, IF AVAILABLE, AND THE CONTRACTOR SHALL BE RESPONSIBLE TO MAKE ARRANGEMENTS FOR ITS USE BY HIS TANKS, HOSES, SPRINKLERS, ETC. IF SUCH WATER IS NOT AVAILABLE AT THE SITE. THE CONTRACTOR SHALL PROVIDE SUCH SATISFACTORY WATER FROM SOURCES OFF THE SITE AT NO ADDITIONAL COST TO THE OWNER.

COMMERCIAL FERTILIZER SHALL BE A COMPLETE FORMULA: IT SHALL BE UNIFORM IN COMPOSITION, DRY AND FREE FLOWING. THIS FERTILIZER SHALL BE DELIVERED TO THE SITE IN THE ORIGINAL UNOPENED CONTAINERS, EACH BEARING THE MANUFACTURER'S GUARANTEED STATEMENT OF ANALYSIS FIFTY PERCENT (50%) OF THE NITROGEN SHALL BE DERIVED FROM NATURAL ORGANIC SOURCES. THE FOLLOWING FERTILIZERS SHALL BE USED AND APPLIED AT RATES AS SUGGESTED BY MANUFACTURER'S

1. SHRUBS AND TREES - MILORGANITE, OR APPROVED EQUAL 2. ANNUALS AND GROUNDCOVERS - OSMOCOTE/SIERRA BLEND 14-14-14 3. SOD - 8-8-8 FERTILIZER

IN ADDITION TO SURFACE APPLIED FERTILIZERS, ALL CONTAINER GROWN AND FIELD GROWN PLANT MATERIAL SHALL RECEIVE "AGRIFORM" PLANTING TABLETS 24-10-5 FORMULA, 21 GRAM OR EQUAL. THESE TABLETS SHALL BE PLACED AT A DEPTH OF ROOT BALL AT THE RATE AS SPECIFIED BY

MULCH MATERIAL SHALL BE MOISTENED AT THE TIME OF APPLICATION TO PREVENT WIND DISPLACEMENT, AND APPLIED AT A DEPTH OF 3 INCHES. SEE PLANT LIST FOR TYPE OF MATERIAL L. DIGGING AND HANDLING

1. PROTECT ROOTS OR BALLS OF PLANTS AT ALL TIMES FROM SUN AND DRYING WINDS, WATER AND FREEZING, AS NECESSARY UNTIL PLANTING. PLANT MATERIALS SHALL BE ADEQUATELY PACKED TO PREVENT BREAKAGE AND DRYING OUT DURING TRANSIT. TREES TRANSPORTED MORE THAN TEN (10) MILES OR WHICH ARE NOT PLANTED WITHIN THREE (3) DAYS OF DELIVERY TO SITE SHALL BE SPRAYED WITH AN ANTI-TRANSPIRANT PRODUCT ("WILTPRUF" OR EQUAL) TO MINIMIZE TRANSPIRATIONAL WATER LOSS.

2. BALLED AND BURLAPPED PLANTS (B&B) SHALL BE DUG WITH FIRM. NATURAL BALLS OF SOIL OF SUFFICIENT SIZE TO ENCOMPASS THE FIBROUS AND FEEDING ROOTS OF THE PLANTS. NO PLANTS MOVED WITH A BALL SHALL BE PLANTED IF THE BALL IS CRACKED OR BROKEN. PLANTS BALLED AND BURLAPPED OR CONTAINER GROWN SHALL NOT BE HANDLED BY STEMS.

3. PLANTS MARKED "BR" IN THE PLANT LIST SHALL BE DUG WITH BARE ROOTS. THE ROOTS SHALL NOT BE CUT WITHIN THE MINIMUM SPREAD SPECIFIED IN THE PLANT LIST. CARE SHALL BE EXERCISED THAT THE ROOTS DO NOT DRY OUT IN MOVING AND PRIOR TO PLANTING

4. PROTECTION OF PALMS (IF APPLICABLE): ONLY A MINIMUM OF FRONDS SHALL BE REMOVED FROM THE CROWN OF THE PALM TREES TO FACILITATE MOVING AND HANDLING. CLEAR TRUNK (CT) SHALL BE AS SPECIFIED AFTER THE MINIMUM OF FRONDS HAVE BEEN REMOVED. ALL PALMS SHALL BE BRACED

5. EXCAVATION OF TREE PITS SHALL BE DONE USING EXTREME CARE TO AVOID DAMAGE TO SURFACE AND SUBSURFACE ELEMENTS SUCH AS UTILITIES OR HARDSCAPE ELEMENTS, FOOTERS AND PREPARED SUB- BASES.

M. CONTAINER GROWN STOCK

1. ALL CONTAINER GROWN MATERIAL SHALL BE HEALTHY, VIGOROUS, WELL-ROOTED PLANTS AND ESTABLISHED IN THE CONTAINER IN WHICH THEY ARE SOLD. THE PLANTS SHALL HAVE TOPS WHICH ARE OF GOOD QUALITY AND ARE IN A HEALTHY GROWING CONDITION. 2. AN ESTABLISHED CONTAINER GROWN PLANT SHALL BE TRANSPLANTED INTO A CONTAINER AND GROWN IN THAT CONTAINER SUFFICIENTLY LONG FOR THE NEW FIBROUS ROOTS TO HAVE DEVELOPED SO THAT THE ROOT MASS WILL RETAIN ITS SHAPE AND HOLD TOGETHER WHEN REMOVED FROM THE CONTAINER.

CONTAINER GROWN STOCK SHALL NOT BE HANDLED BY THEIR STEMS 3. PLANT ROOTS BOUND IN CONTAINERS SHALL NOT BE ACCEPTABLE

4. SUBSTITUTION OF NON-CONTAINER GROWN MATERIAL FOR MATERIAL EXPLICITLY SPECIFIED TO BE CONTAINER GROWN WILL NOT BE PERMITTED UNLESS WRITTEN APPROVAL IS OBTAINED FROM THE OWNER AND LANDSCAPE ARCHITECT. N. COLLECTED STOCK

WHEN THE USE OF COLLECTED STOCK IS PERMITTED AS INDICATED ON THE PLANT LIST SCHEDULE. THE MINIMUM SIZES OF ROOTBALLS SHALL BE EQUAL TO THAT SPECIFIED FOR THE NEXT LARGER SIZE OF NURSERY GROWN STOCK OF THE SAME VARIETY. O. NATIVE STOCK

PLANTS COLLECTED FROM WILD OR NATIVE STANDS SHALL BE CONSIDERED NURSERY GROWN WHEN THEY HAVE BEEN SUCCESSFULLY REESTABLISHED IN A NURSERY ROW AND GROWN UNDER REGULAR NURSERY CULTURAL PRACTICES FOR A MINIMUM OF TWO (2) GROWING SEASONS AND HAVE ATTAINED ADEQUATE ROOT AND TOP GROWTH TO INDICATE FULL RECOVERY FROM TRANSPLANTING INTO THE NURSERY ROW P. MATERIALS LIST

QUANTITIES NECESSARY TO COMPLETE THE WORK ON THE DRAWINGS SHALL BE FURNISHED BY THE CONTRACTOR. QUANTITY ESTIMATES HAVE BEEN MADE CAREFULLY, BUT THE LANDSCAPE ARCHITECT OR OWNER ASSUMES NO LIABILITY FOR OMISSIONS OR ERRORS. SHOULD A DISCREPANCY OCCUR BETWEEN THE BIDDERS TAKE OFF AND THE PLANT LIST QUANTITY. THE LANDSCAPE ARCHITECT SHALL BE NOTIFIED FOR CLARIFICATION PRIOR TO THE SUBMISSIONS OF BIDS. ALL DIMENSIONS AND/OR SIZES SPECIFIED SHALL BE THE MINIMUM ACCEPTABLE SIZE

1. FINE GRADING UNDER THIS CONTRACT SHALL CONSIST OF FINAL FINISHED GRADING OF LAWN AND PLANTING AREAS THAT HAVE BEEN ROUGH GRADED BY OTHERS. BERMING AS SHOWN ON THE DRAWINGS SHALL BE THE RESPONSIBILITY OF THE LANDSCAPE CONTRACTOR, UNLESS OTHERWISE NOTED. 2. THE LANDSCAPE CONTRACTOR SHALL FINE GRADE THE LAWN AND PLANTING AREAS TO BRING THE

ROUGH GRADE UP TO FINAL FINISHED GRADE ALLOWING FOR THICKNESS OF SOD AND/OR MULCH DEPTH. THIS CONTRACTOR SHALL FINE GRADE BY HAND AND/OR WITH ALL EQUIPMENT NECESSARY INCLUDING A GRADING TRACTOR WITH FRONT-END LOADER FOR TRANSPORTING SOIL WITHIN THE SITE 3. ALL PLANTING AREAS SHALL BE GRADED AND MAINTAINED TO ALLOW FREE FLOW OF SURFACE WATER.

R. PLANTING PROCEDURES

Q. FINE GRADING

1. CLEANING UP BEFORE COMMENCING WORK: THE CONTRACTOR SHALL CLEAN UP WORK AND SURROUNDING AREAS OF ALL RUBBISH OR OBJECTIONABLE MATTER. ALL MORTAR, CEMENT, AND TOXIC MATERIAL SHALL BE REMOVED FROM THE SURFACE OF ALL PLANT BEDS. THESE MATERIALS SHALL NOT BE MIXED WITH THE SOIL. SHOULD THE CONTRACTOR FIND SUCH SOIL CONDITIONS BENEATH THE SOIL WHICH WILL IN ANY WAY ADVERSELY AFFECT THE PLANT GROWTH, HE SHALL IMMEDIATELY CALL IT TO THE ATTENTION OF THE LANDSCAPE ARCHITECT OR OWNER. FAILURE TO DO SO BEFORE PLANTING SHALL MAKE THE CORRECTIVE MEASURES THE RESPONSIBILITY OF THE CONTRACTOR.

AREAS ADJACENT TO BUILDINGS SHALL SLOPE AWAY FROM THE BUILDINGS.

2. VERIFY LOCATIONS OF ALL UTILITIES, CONDUITS, SUPPLY LINES AND CABLES, INCLUDING BUT NOT LIMITED TO: ELECTRIC, GAS (LINES AND TANKS), WATER, SANITARY SEWER, STORMWATER LINES, CABLE AND TELEPHONE. PROPERLY MAINTAIN AND PROTECT EXISTING UTILITIES.

3. SUBGRADE EXCAVATION: SITE CONTRACTOR IS RESPONSIBLE TO REMOVE ALL EXISTING AND IMPORTED LIMEROCK AND LIMEROCK SUB-BASE FROM ALL LANDSCAPE PLANTING AREAS TO A MINIMUM DEPTH OF 36". SITE CONTRACTOR IS RESPONSIBLE TO BACKFILL THESE PLANTING AREAS TO ROUGH FINISHED GRADE WITH CLEAN TOPSOIL FROM AN ON-SITE SOURCE OR AN IMPORTED SOURCE. IF LIMEROCK OR OTHER ADVERSE CONDITIONS OCCUR IN PLANTED AREAS AFTER 36" DEEP EXCAVATION BY SITE CONTRACTOR, AND POSITIVE DRAINAGE CAN NOT BE ACHIEVED, LANDSCAPE CONTRACTOR SHALL CONTACT LANDSCAPE ARCHITECT OR OWNER.

4. FURNISH NURSERY'S CERTIFICATE OF COMPLIANCE WITH ALL REQUIREMENTS AS HEREIN SPECIFIED AND REQUIRED. INSPECT AND SELECT PLANT MATERIALS BEFORE PLANTS ARE DUG AT NURSERY OR GROWING

5. GENERAL: COMPLY WITH APPLICABLE FEDERAL, STATE, COUNTY, AND LOCAL REGULATIONS GOVERNING LANDSCAPE MATERIALS AND WORK. CONFORM TO ACCEPTED HORTICULTURAL PRACTICES AS USED IN THE TRADE. PLANTS SHALL BE PROTECTED UPON ARRIVAL AT THE SITE BY BEING THOROUGHLY WATERED AND PROPERLY MAINTAINED UNTIL PLANTED. PLANTS SHALL NOT REMAIN UNPROTECTED FOR A PERIOD EXCEEDING TWENTY-FOUR (24) HOURS. AT ALL TIMES WORKMANLIKE METHODS CUSTOMARY IN GOOD HORTICULTURAL PRACTICES SHALL BE EXERCISED

6. THE WORK SHALL BE COORDINATED WITH OTHER TRADES TO PREVENT CONFLICTS. COORDINATE THE PLANTING WITH THE IRRIGATION WORK TO ASSURE AVAILABILITY OF WATER AND PROPER LOCATION OF IRRIGATION ITEMS AND PLANTS

7. ALL PLANTING PITS SHALL BE EXCAVATED TO SIZE AND DEPTH IN ACCORDANCE WITH THE USA STANDARD FOR NURSERY STOCK 260.1, UNLESS SHOWN OTHERWISE ON THE DRAWINGS, AND BACKFILLED WITH THE PREPARED PLANTING SOIL AS SPECIFIED HEREIN BEFORE (SECTION H). TEST ALL TREE PITS WITH WATER BEFORE PLANTING TO ASSURE PROPER DRAINAGE PERCOLATION IS AVAILABLE. NO ALLOWANCE WILL BE MADE FOR LOST PLANTS DUE TO IMPROPER DRAINAGE. IF POOR DRAINAGE EXISTS UTILIZE PLANTING DETAIL THAT ADDRESSES THIS CONDITION. TREES SHALL BE SET PLUMB AND HELD IN POSITION LINTIL THE PLANTING MIXTURE HAS BEEN FLUSHED INTO PLACE WITH A SLOW FULL HOSE STREAM ALL PLANTING SHALL BE PERFORMED BY PERSONNEL FAMILIAR WITH PLANTING PROCEDURE AND UNDER THE SUPERVISION OF A QUALIFIED PLANTING FOREMAN. PROPER "JETTING IN" SHALL BE ASSURED TO ELIMINATE AIR POCKETS AROUND THE ROOTS. "JET STICK" OR EQUAL IS RECOMMENDED

8. TAKE ALL NECESSARY PRECAUTIONS TO AVOID DAMAGE TO BUILDINGS AND BUILDING STRUCTURES WHILE INSTALLING TREES.

9. SOIL MIXTURE SHALL BE AS SPECIFIED IN SECTION H OF THESE SPECIFICATIONS. IN ADDITION, EACH PLANTING PIT SHALL RECEIVE 21-GRAM "AGRIFORM" PLANTING TABLETS PER MANUFACTURER'S SPECIFICATIONS OR AS FOLLOWS

THREE (3) TABLETS PER 3 GAL. PLANT FOUR (4) TABLETS PER 10 GAL. PLAN

PROPERTY

- LARGER MATERIAL - TWO (2) TABLETS PER 1/2" OF TRUNK CALIPER

10. TREES AND SHRUBS SHALL BE SET STRAIGHT AND AT SUCH A LEVEL THAT AFTER SETTLEMENT, THE PLANT CROWN WILL STAND ONE (1) TO TWO (2) INCHES ABOVE GRADE. EACH PLANT SHALL BE SET IN THE CENTER OF THE PIT. PLANTING SOIL MIXTURE SHALL BE BACKFILLED AND THOROUGHLY TAMPED AROUND THE BALL AND SHALL BE SETTLED BY WATER AFTER TAMPING

WATER AND ALLOW TO SOAK MINIMUM TWENTY (20) MINUTES, STIRRING IF NECESSARY TO GET SOIL THOROUGHLY WET. PACK LIGHTLY WITH FEET. ADD MORE WET SOIL MIXTURE. DO NOT COVER TOP OF BALL WITH SOIL MIXTURE, ONLY WITH MULCH. ALL BURLAP, ROPE, WIRES, ETC., SHALL BE REMOVED FROM THE SIDES AND TOPS OF BALLS, BUT NO BURLAP SHALL BE PULLED FROM UNDERNEATH

11. FILL HOLE WITH SOIL MIXTURE, MAKING CERTAIN ALL SOIL IS SATURATED. TO DO THIS, FILL HOLE WITH

12. PRUNING: EACH TREE SHALL BE PRUNED TO PRESERVE THE NATURAL CHARACTER OF THE PLANT AS SHOWN ON THE DRAWINGS. ALL SOFT WOOD OR SUCKER GROWTH AND ALL BROKEN OR BADLY DAMAGED BRANCHES SHALL BE REMOVED WITH A CLEAN CUT 13. SHRUBS AND GROUND COVER PLANTS SHALL BE EVENLY SPACED IN ACCORDANCE WITH THE

DEPTH OF 6". REMOVE AND DISPOSE ALL DEBRIS. TILL INTO TOP 4" THE PLANTING SOIL MIX AS SPECIFIED IN SECTION E. THOROUGHLY WATER ALL PLANTS AFTER INSTALLATION 14. TREE GUYING AND BRACING SHALL BE INSTALLED BY THE LANDSCAPE CONTRACTOR IN ACCORDANCE WITH THE PLANS TO INSURE STABILITY AND MAINTAIN TREES IN AN UPRIGHT POSITION. IF THE LANDSCAPE CONTRACTOR AND OWNER DECIDE TO WAIVE THE TREE GUYING AND BRACING, THE

OWNER SHALL NOTIFY THE LANDSCAPE ARCHITECT IN WRITING OF THEIR INTENTIONS AND AGREE TO HOLD

HARMLESS THE LANDSCAPE ARCHITECT IN THE EVENT ANY TREES FALL DOWN AND DAMAGE PERSON OR

DRAWINGS AND AS INDICATED ON THE PLANT LIST. CULTIVATE ALL PLANTING AREAS TO A MINIMUM

15. MULCHING: PROVIDE A THREE (3) INCH MINIMUM LAYER OF SPECIFIED MULCH OVER THE ENTIRE AREA OF EACH SHRUB BED, GROUND COVER AND VINE BED AND TREE PI

16. HERBICIDE WEED CONTROL: ALL PLANT BEDS SHALL BE KEPT FREE OF NOXIOUS WEEDS UNTIL FINAL ACCEPTANCE OF WORK. IF DIRECTED BY THE OWNER, "ROUND-UP" SHALL BE APPLIED FOR WEED CONTROL BY QUALIFIED PERSONNEL TO ALL PLANTING AREAS IN SPOT APPLICATIONS PER MANUFACTURER'S PRECAUTIONS AND SPECIFICATIONS. PRIOR TO FINAL INSPECTION. TREAT ALL PLANTING BEDS WITH AN APPROVED PRE-EMERGENT HERBICIDE AT AN APPLICATION RATE RECOMMENDED BY THE MANUFACTURER.

S. LAWN SODDING

1. THE WORK CONSISTS OF LAWN BED PREPARATION, SOIL PREPARATION, AND SODDING COMPLETE, IN STRICT ACCORDANCE WITH THE SPECIFICATIONS AND THE APPLICABLE DRAWINGS TO PRODUCE A GRASS LAWN ACCEPTABLE TO THE OWNER.

2. LAWN BED PREPARATION: ALL AREAS THAT ARE TO BE SODDED SHALL BE CLEARED OF ANY ROUGH GRASS, WEEDS, AND DEBRIS, AND THE GROUND BROUGHT TO AN EVEN GRADE. THE WHOLE SURFACE SHALL BE ROLLED WITH A ROLLER WEIGHING NOT MORE THAN ONE-HUNDRED (100) POUNDS PER FOOT OF WIDTH. DURING THE ROLLING. ALL DEPRESSIONS CAUSED BY SETTLEMENT OF ROLLING SHALL BE FILLED WITH ADDITIONAL SOIL. AND THE SURFACE SHALL BE REGRADED AND ROLLED UNTIL PRESENTING A SMOOTH AND EVEN FINISH THAT IS UP TO THE REQUIRED GRADE.

3. SOIL PREPARATION: PREPARE LOOSE BED FOUR (4) INCHES DEEP. APPLY FERTILIZER AT RATE OF TWENTY (20) POUNDS PER ONE THOUSAND (1000) SQUARE FEET. APPLICATION SHALL BE UNIFORM. UTILIZING APPROVED MECHANICAL SPREADERS. MIX FERTILIZER THOROUGHLY WITH THE SOIL TO A DEPTH OF THREE (3) INCHES. HAND RAKE UNTIL ALL BUMPS AND DEPRESSIONS ARE REMOVED. WET PREPARED AREA THOROUGHLY.

A. THE CONTRACTOR SHALL SOD ALL AREAS THAT ARE NOT PAVED OR PLANTED AS DESIGNATED ON THE DRAWINGS WITHIN THE CONTRACT LIMITS. UNLESS SPECIFICALLY NOTED OTHERWISE B. THE SOD SHALL BE CERTIFIED TO MEET THE STATE PLANT BOARD SPECIFICATIONS. ARSOLLITELY TRUE TO VARIETAL TYPE, AND FREE FROM WEEDS, FUNGUS, INSECTS AND DISEASE OF ANY KIND. C. SOD PANELS SHALL BE LAID TIGHTLY TOGETHER SO AS TO MAKE A SOLID SODDED LAWN AREA SOD SHALL BE LAID UNIFORMLY AGAINST THE EDGES OF ALL CURBS AND OTHER HARDSCAPE ELEMENTS. PAVED AND PLANTED AREAS. ADJACENT TO BUILDINGS, A FOUR INCH MULCH STRIP SHALL BE PROVIDED. IMMEDIATELY FOLLOWING SOD LAYING, THE LAWN AREAS SHALL BE ROLLED WITH A LAWN ROLLER CUSTOMARILY USED FOR SUCH PURPOSES, AND THEN THOROUGHLY IRRIGATED. IF, IN THE OPINION OF THE OWNER, TOP-DRESSING IS NECESSARY AFTER ROLLING TO FILL THE VOIDS BETWEEN THE SOD PANELS AND TO EVEN OUT INCONSISTENCIES IN THE SOD, CLEAN SAND AS APPROVED BY THE LANDSCAPE ARCHITECT OR OWNER SHALL BE UNIFORMLY SPREAD OVER THE ENTIRE SURFACE OF THE

D. DURING DELIVERY, PRIOR TO AND DURING THE PLANTING OF THE LAWN AREAS, THE SOD PANELS SHALL AT ALL TIMES BE PROTECTED FROM EXCESSIVE DRYING AND UNNECESSARY EXPOSURE OF THE ROOTS TO THE SUN. ALL SOD SHALL BE STACKED SO AS NOT TO BE DAMAGED BY SWEATING OR EXCESSIVE HEAT AND MOISTURE

A. PROVIDE FRESH, CLEAN, NEW CROP LAWN SEED MIXTURE. FURNISH TO OWNER DEALERS GUARANTEED STATEMENT OF COMPOSITION OF MIXTURE AND PERCENTAGE OF PURITY AND GERMINATION OF EACH VARIETY

B. SEED MIXTURE: PROVIDE SEED OF GRASS SPECIES AND VARIETIES, PROPORTIONS BY WEIGHT AND MINIMUM PERCENTAGES OF PURITY, GERMINATION, AND MAXIMUM PERCENTAGE OF WEED SEED. SEED MIXTURES VARY BY REGION AND SEASON AND SHALL COMPLY WITH STATE DO AND LOCAL SOIL CONSERVATION SERVICE

C. DO NOT PERFORM SEEDING IN WINDY CONDITIONS.

SOD AND THOROUGHLY WATERED IN.

D. SEEDING SHALL BE DISPERSED IN 2 DIRECTIONS AT RIGHT ANGLES TO EACH OTHER.

E PERMANENTI Y SEED AND MUI CHICUT AND FILL SLOPES AS CONSTRUCTION PROCEEDS TO EXTENT CONSIDERED DESIRABLE AND PRACTICAL. IN THE EVENT IT IS NOT PRACTICAL TO SEED AREAS, SLOPES SHALL BE STABILIZED WITH STRAW MULCH AND TACKIFIER, BONDED FIBER MATRIX, NETTING, BLANKETS OR OTHER MEANS TO REDUCE THE EROSIVE POTENTIAL OF THE AREA.

F. SEED LAWN AREAS BY SOWING EVENLY WITH APPROVED MECHANICAL SEEDER AT RATE OF MINIMUM OF 6 POUNDS PER 1,000 SQUARE FEET. AMOUNT WILL VARY BASED ON VARIETY AND/OR SPECIES. CULTI-PACKER OR APPROVED SIMILAR EQUIPMENT MAY BE USED TO COVER SEED AND TO FORM SEEDBED IN ONE OPERATION. IN AREAS INACCESSIBLE TO CUTI-PACKER LIGHTLY RAKE SEEDED GROUND WITH FLEXIBLE RAKES AD ROLL WITH WATER BALLAST ROLLER. AFTER ROLLING. MULCH WITH STRAW MULCH AT THE RATE OF 2 TONS PER ACRE.

G. SURFACE LAYER OF SOIL FOR SEEDED AREAS SHALL BE KEPT MOIST DURING GERMINATION PERIOD. WATER SEEDED AREAS TWICE FIRST WEEK TO MINIMUM DEPTH OF 6 INCHES WITH FINE SPRAY AND ONCE PER WEEK THEREAFTER AS NECESSARY TO SUPPLEMENT NATURAL RAIN TO EQUIVALENT OF 6 INCHES DEPTH.

H. CONTRACTOR TO REAPPLY SEED AS NECESSARY IN ORDER TO GET ALL SEEDED AREAS ESTABLISHED AS

6. LAWN MAINTENANCE

A. WITHIN THE CONTRACT LIMITS, THE CONTRACTOR SHALL PRODUCE A DENSE, WELL ESTABLISHED LAWN. THE CONTRACTOR SHALL BE RESPONSIBLE FOR THE REPAIR AND RE-SODDING OF ALL ERODED. SUNKEN OR BARE SPOTS UNTIL CERTIFICATION OF ACCEPTABILITY BY THE LANDSCAPE ARCHITECT OR OWNER. REPAIRED SODDING SHALL BE ACCOMPLISHED AS IN THE ORIGINAL WORK (INCLUDING REGRADING IF

B. WATER EVERY DAY FOR TEN (10) SUCCESSIVE DAYS, THEN WATER THREE (3) TIMES PER WEEK (AT EVEN INTERVALS) FOR TWO (2) ADDITIONAL WEEKS. ALL WATERING SHALL BE OF SUFFICIENT QUANTITY TO WET OR RESTORE WATER TO DEPTH OF FOUR (4) INCHES. CONTRACTOR TO DETERMINE IF SITE IS IN A DROUGHT RESTRICTION AREA AND MUST FOLLOW CITY/ COUNTY PROTOCOL IF ANY ARE IN PLACE.

T. CLEAN-UP UPON COMPLETION OF ALL PLANTING WORK AND BEFORE FINAL ACCEPTANCE. THE CONTRACTOR SHALL REMOVE ALL MATERIAL, EQUIPMENT, AND DEBRIS RESULTING FROM HIS WORK. ALL PAVED AREAS SHALL BE BROOM CLEANED AND THE SITE LEFT IN A NEAT AND ACCEPTABLE CONDITION AS APPROVED BY

THE OWNER'S AUTHORIZED REPRESENTATIVE U. PLANT MATERIAL MAINTENANCE

X. FINAL INSPECTION AND ACCEPTANCE OF WORK

SAME INSPECTION AND ACCEPTANCE HEREIN DESCRIBED

ALL PLANTS AND PLANTING INCLUDED UNDER THIS CONTRACT SHALL BE MAINTAINED BY WATERING, ULTIVATING, SPRAYING, AND ALL OTHER OPERATIONS (SUCH AS RE-STAKING OR REPAIRING GU SUPPORTS) NECESSARY TO INSURE A HEALTHY CONDITION BY THE CONTRACTOR UNTIL CERTIFICATION OF ACCEPTABILITY BY THE LANDSCAPE ARCHITECT OR OWNER MAINTENANCE AFTER THE CERTIFICATION OF ACCEPTABILITY SHALL BE IN ACCORDANCE WITH THE SPECIFICATIONS IN THIS SECTION. CONTRACTORS ARE REQUESTED TO PROVIDE A BID ESTIMATE TO COVER LANDSCAPE AND IRRIGATION MAINTENANCE FOR A PERIOD OF 90 CALENDAR DAYS COMMENCING AFTER ACCEPTANCE.

V MAINTENANCE (ALTERNATE BID ITEM) 1. CONTRACTORS ARE REQUESTED TO PROVIDE A BID ESTIMATE FOR MAINTENANCE FOLLOWING THE INITIAL 90-DAY MAINTENANCE PERIOD ON A COST PER MONTH BASIS. W. GUARANTEE

1 THE LIFE AND SATISFACTORY CONDITION OF ALL PLANT MATERIAL INSTALLED BY THE LANDSCAPE CONTRACTOR SHALL BE GUARANTEED BY THE CONTRACTOR FOR A MINIMUM OF ONE (1) CALENDAR YEAR COMMENCING AT THE TIME OF CERTIFICATION OF ACCEPTABILITY BY THE LANDSCAPE ARCHITECT OR OWNER.

2. THE LIFE AND SATISFACTORY CONDITION OF ALL OTHER PLANT MATERIAL (INCLUDING SOD) INSTALLED BY THE LANDSCAPE CONTRACTOR SHALL BE GUARANTEED BY THE CONTRACTOR FOR A MINIMUM OF 90 CALENDAR DAYS, COMMENCING AT THE TIME OF CERTIFICATION OF ACCEPTABILITY BY THE LANDSCAPE ARCHITECT OR OWNER.

3. REPLACEMENT: ANY PLANT NOT FOUND IN A HEALTHY GROWING CONDITION AT THE END OF THE GUARANTEE PERIOD SHALL BE REMOVED FROM THE SITE AND REPLACED AS SOON AS WEATHER CONDITIONS PERMIT. ALL REPLACEMENTS SHALL BE PLANTS OF THE SAME KIND AND SIZE AS SPECIFIED IN THE PLANT LIST. THEY SHALL BE FURNISHED PLANTED AND MULCHED AS SPECIFIED UNDER "PLANTING", AT NO ADDITIONAL COST TO THE OWNER.

4. IN THE EVENT THE OWNER DOES NOT CONTRACT WITH THE CONTRACTOR FOR LANDSCAPE (AND IRRIGATION) MAINTENANCE, THE CONTRACTOR IS ENCOURAGED TO VISIT THE PROJECT SITE PERIODICALLY DURING THE ONE YEAR WARRANTY PERIOD TO EVALUATE MAINTENANCE PROCEDURES BEING PERFORMED BY THE OWNER, AND SHALL NOTIFY THE OWNER IN WRITING OF MAINTENANCE PROCEDURES OR CONDITIONS WHICH THREATEN VIGOROUS AND HEALTH PLANT GROWTH. IT IS SUGGESTED SUCH SITE VISITS SHALL BE CONDUCTED A MINIMUM OF ONCE PER MONTH FOR A PERIOD OF TWELVE (12) MONTHS FROM THE DATE OF ACCEPTANCE.

FINAL INSPECTION AT THE END OF THE GUARANTEE PERIOD SHALL BE ON PLANTING, CONSTRUCTION

SHALL BE SUBJECT TO THE SAME ONE (1) YEAR GUARANTEE (OR AS SPECIFIED BY THE LANDSCAPE

AND ALL OTHER INCIDENTAL WORK PERTAINING TO THIS CONTRACT. ANY REPLACEMENT AT THIS TIME

ARCHITECT OR OWNER IN WRITING) BEGINNING WITH THE TIME OF REPLACEMENT AND ENDING WITH THE

SITE PLAN ROCKWALL TECHNOLOGY PARK PHASE V PART OF LOT 2, BLOCK B

**TOTAL ACREAGE: 22.000 ACRES** 

CITY OF ROCKWALL, ROCKWALL COUNTY, TEXAS CITY PROJECT NO. SP-XXXXXX-XXXX SUBMITTED JUNE 14, 2024

**ENGINEER / SURVEYOR / APPLICANT:** KIMLEY-HORN & ASSOCIATES, INC. 13455 NOEL ROAD TWO GALLERIA OFFICE TOWER, SUITE 700 DALLAS, TEXAS 75240 PH (469) 301-2599 CONTACT: PAUL FREELAND, P.L.A.

BALLARD US INC. 2495 NE 4TH STREET BEND, OR. 97701 PH. (XXX) XXX-XXXX

DEVELOPER: ROCKWALL ECONOMIC **DEVELOPMENT COUNCIL** 2610 OBSERVATION TRAIL, SUITE 104 ROCKWALL, TX. 75032 PH. (972) 772-0025 CONTACT: LEE SWEETLAND CONTACT: PHIL WAGNER

FOR REVIEW ONLY Not for construction or permit purposes Kimley » Horn Paul D. Freeland L.A. No. 2458 Date 06.14.2024.

PRELIMINARY

ATIONS S CD

CASE NO. SP2xxx-xx SHEET NUMBER L2.09

## TREE PROTECTION NOTES:

ZONE OF TREES WHICH REMAIN ON SITE.

PRUNING TECHNIQUES ARE STRICTLY PROHIBITED.

- TREE SURVEY:
- 1. ALL TREES WHICH ARE TO REMAIN ON SITE SHALL BE PROTECTED WITH A (4') TALL BRIGHTLY COLORED PLASTIC FENCE, OR SILT FENCE, PLACED AT THE DRIP LINE OF THE TREES. 2. PRIOR TO THE PRE-CONSTRUCTION MEETING OR OBTAINING A GRADING PERMIT, ALL TREE MARKINGS AND PROTECTIVE FENCING SHALL BE INSTALLED BY THE OWNER AND SHALL BE INSPECTED BY THE DEVELOPMENT
- SERVICES LANDSCAPE ARCHITECT. 3. NO EQUIPMENT SHALL BE CLEANED, OR HARMFUL LIQUIDS DEPOSITED WITHIN THE LIMITS OF THE ROOT
- 4. NO SIGNS, WIRES, OR OTHER ATTACHMENTS SHALL BE ATTACHED TO ANY TREE TO REMAIN ON SITE. 5. VEHICULAR AND CONSTRUCTION EQUIPMENT SHALL NOT PARK OR DRIVE WITHIN THE LIMITS OF THE DRIP
- 6. GRADE CHANGES IN EXCESS OF 3 INCHES (CUT OR FILL) SHALL NOT BE ALLOWED WITHIN A ROOT ZONE, UNLESS ADEQUATE TREE PRESERVATION METHODS ARE APPROVED BY THE CITY.
- NO TRENCHING SHALL BE ALLOWED WITHIN THE DRIP-LINE OF A TREE, UNLESS APPROVED BY THE CITY. ALL REMOVED TREES SHALL BE CHIPPED AND USED FOR MULCH ON SITE OR HAULED OFF-SITE. ALL TREE MAINTENANCE TECHNIQUES SHALL BE IN CONFORMANCE WITH AMERICAN NATIONAL STANDARDS FOR TREE CARE OPERATIONS, ANSI A300 INDUSTRY IDENTIFIED STANDARDS. IMPROPER OR MALICIOUS

TAG#	DBH	COMMON NAME	SCIENTIFIC NAME	CONDITION	MULTIPLE- STEMMED	ACTION	CLASS	REPLACEMENT RATIO	MITIGATION REQUIRED
6070	12.2	Eastern Redcedar	Juniperus virginiana	Healthy	Multi	Remove	Secondary	0.5:1	6.1
6071	15.9	Eastern Redcedar	Juniperus virginiana	Healthy	Multi	Remove	Secondary	0.5:1	7.95
6072	12.3	Eastern Redcedar	Juniperus virginiana	Healthy	Multi	Remove	Secondary	0.5:1	6.15
6073	13.0	Eastern Redcedar	Juniperus virginiana	Healthy	Multi	Remove	Secondary	0.5:1	6.5
6074	11.2	Eastern Redcedar	Juniperus virginiana	Healthy	Multi	Remove	Secondary	0.5:1	5.6
6075	12.2	Eastern Redcedar	Juniperus virginiana	Healthy	Multi	Remove	Secondary	0.5:1	6.1
6076	11.0	Eastern Redcedar	Juniperus virginiana	Healthy	Multi	Remove	Secondary	0.5:1	5.5
6077	11.1	Eastern Redcedar	Juniperus virginiana	Healthy	Multi	Remove	Secondary	0.5:1	5.55
6078	12.2	Eastern Redcedar	Juniperus virginiana	Healthy	Multi	Remove	Secondary	0.5:1	6.1
6079	12.5	Eastern Redcedar	Juniperus virginiana	Healthy	Multi	Remove	Secondary	0.5:1	6.25
6080	16.6	Eastern Redcedar	Juniperus virginiana	Healthy	Multi	Remove	Secondary	0.5:1	8.3
6081	14.7	Eastern Redcedar	Juniperus virginiana	Healthy	Multi	Remove	Secondary	0.5:1	7.35
6082	13.3	Eastern Redcedar	Juniperus virginiana	Healthy	Multi	Remove	Secondary	0.5:1	6.65
6083	16.5	Eastern Redcedar	Juniperus virginiana	Healthy	Multi	Remove	Secondary	0.5:1	8.25
6084	16.2	Eastern Redcedar	Juniperus virginiana	Healthy	Multi	Preserve	Secondary	0.5:1	
6085	4.6	Hercules-club	Zanthoxylum clava-herculis	Healthy	Single	Preserve	Unprotected		
6086	14.9	Eastern Redcedar	Juniperus virginiana	Healthy	Multi	Preserve	Secondary	0.5:1	
6087	15.2	Eastern Redcedar	Juniperus virginiana	Healthy	Multi	Preserve	Secondary	0.5:1	
6088	13.7	Eastern Redcedar	Juniperus virginiana	Healthy	Multi	Preserve	Secondary	0.5:1	
6089	17.9	Eastern Redcedar	Juniperus virginiana	Healthy	Multi	Remove	Secondary	0.5:1	8.95
6090	21.2	Eastern Redcedar	Juniperus virginiana	Healthy	Multi	Remove	Secondary	0.5:1	10.6
6091	11.0	Eastern Redcedar	Juniperus virginiana	Healthy	Single	Remove	Secondary	0.5:1	5.5
6092	13.2	Eastern Redcedar	Juniperus virginiana	Healthy	Multi	Remove	Secondary	0.5:1	6.6
6093	17.6	Eastern Redcedar	Juniperus virginiana	Healthy	Multi	Remove	Secondary	0.5:1	8.8
6094	17.8	Eastern Redcedar	Juniperus virginiana	Healthy	Multi	Remove	Secondary	0.5:1	8.9
6095	12.7	Eastern Redcedar	Juniperus virginiana	Healthy	Multi	Remove	Secondary	0.5:1	6.35
6096	13.3	Eastern Redcedar	Juniperus virginiana	Healthy	Multi	Preserve	Secondary	0.5:1	
6097	12.9	Eastern Redcedar	Juniperus virginiana	Healthy	Multi	Preserve	Secondary	0.5:1	
6098	13.8	Eastern Redcedar	Juniperus virginiana	Healthy	Single	Preserve	Secondary	0.5:1	
6099	11.2	Eastern Redcedar	Juniperus virginiana	Healthy	Multi	Remove	Secondary	0.5:1	5.6
6100	11.8	Eastern Redcedar	Juniperus virginiana	Healthy	Multi	Preserve	Secondary	0.5:1	
6101	11.9	Eastern Redcedar	Juniperus virginiana	Healthy	Single	Preserve	Secondary	0.5:1	
6102	14.5	Eastern Redcedar	Juniperus virginiana	Healthy	Multi	Preserve	Secondary	0.5:1	
6103	12.7	Eastern Redcedar	Juniperus virginiana	Healthy	Multi	Preserve	Secondary	0.5:1	
6104	18.2	Eastern Redcedar	Juniperus virginiana	Healthy	Multi	Preserve	Secondary	0.5:1	
6105	13.8	Eastern Redcedar	Juniperus virginiana	Healthy	Single	Preserve	Secondary	0.5:1	
6106	11.0	Eastern Redcedar	Juniperus virginiana	Healthy	Multi	Preserve	Secondary	0.5:1	
6107	12.1	Eastern Redcedar	Juniperus virginiana	Healthy	Multi	Preserve	Secondary	0.5:1	
6108	12.8	Eastern Redcedar	Juniperus virginiana	Healthy	Multi	Preserve	Secondary	0.5:1	
6109	13.9	Eastern Redcedar	Juniperus virginiana	Healthy	Multi	Preserve	Secondary	0.5:1	
6110	11.0	Eastern Redcedar	Juniperus virginiana	Healthy	Multi	Preserve	Secondary	0.5:1	
	_	_							

Healthy Forked Preserve

Secondary


Kimley-Horn red tree tag series: 6070-6111. Protected trees measuring 4-inches or larger at DBH were tagged, in accordance with the City of Rockwall Ordinance.

6111 12.9 Eastern Redcedar

Juniperus virginiana

Tree Inches	Mitigation Inches	
0	0	
307.3	153.7	
0	0.0	
307.3	153.65	
	153.65	
332		
332 -178.35		
Tree Inches	Mitigation Inches	
0	0	
0	0	
U	U	
0	0	
• • • • • • • •	0 307.3 0 307.3 Tree Inches	

Total tree inches being relocated

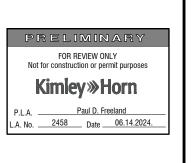

PROJECT SATURN
CITY OF ROCKWALL
ROCKWALL COUNTY, TEXAS

SITE PLAN ROCKWALL TECHNOLOGY PARK PHASE V PART OF LOT 2, BLOCK B

TOTAL ACREAGE: 22.000 ACRES

CITY OF ROCKWALL, ROCKWALL COUNTY, TEXAS CITY PROJECT NO. SP-XXXXXX-XXXX SUBMITTED JUNE 14, 2024

ENGINEER / SURVEYOR / APPLICANT: KIMLEY-HORN & ASSOCIATES, INC. 13455 NOEL ROAD TWO GALLERIA OFFICE TOWER, SUITE 700 DALLAS, TEXAS 75240 PH (469) 301-2599 CONTACT: PAUL FREELAND, P.L.A.


BALLARD US INC. 2495 NE 4TH STREET BEND, OR. 97701


DEVELOPER: ROCKWALL ECONOMIC DEVELOPMENT COUNCIL 2610 OBSERVATION TRAIL, SUITE 104 ROCKWALL, TX. 75032 PH. (XXX) XXX-XXXX PH. (972) 772-0025 CONTACT: LEE SWEETLAND CONTACT: PHIL WAGNER


CASE NO. SP2xxx-xx SHEET NUMBER


L3.01

SURVEY AND TREESCAPE CALCULATIONS

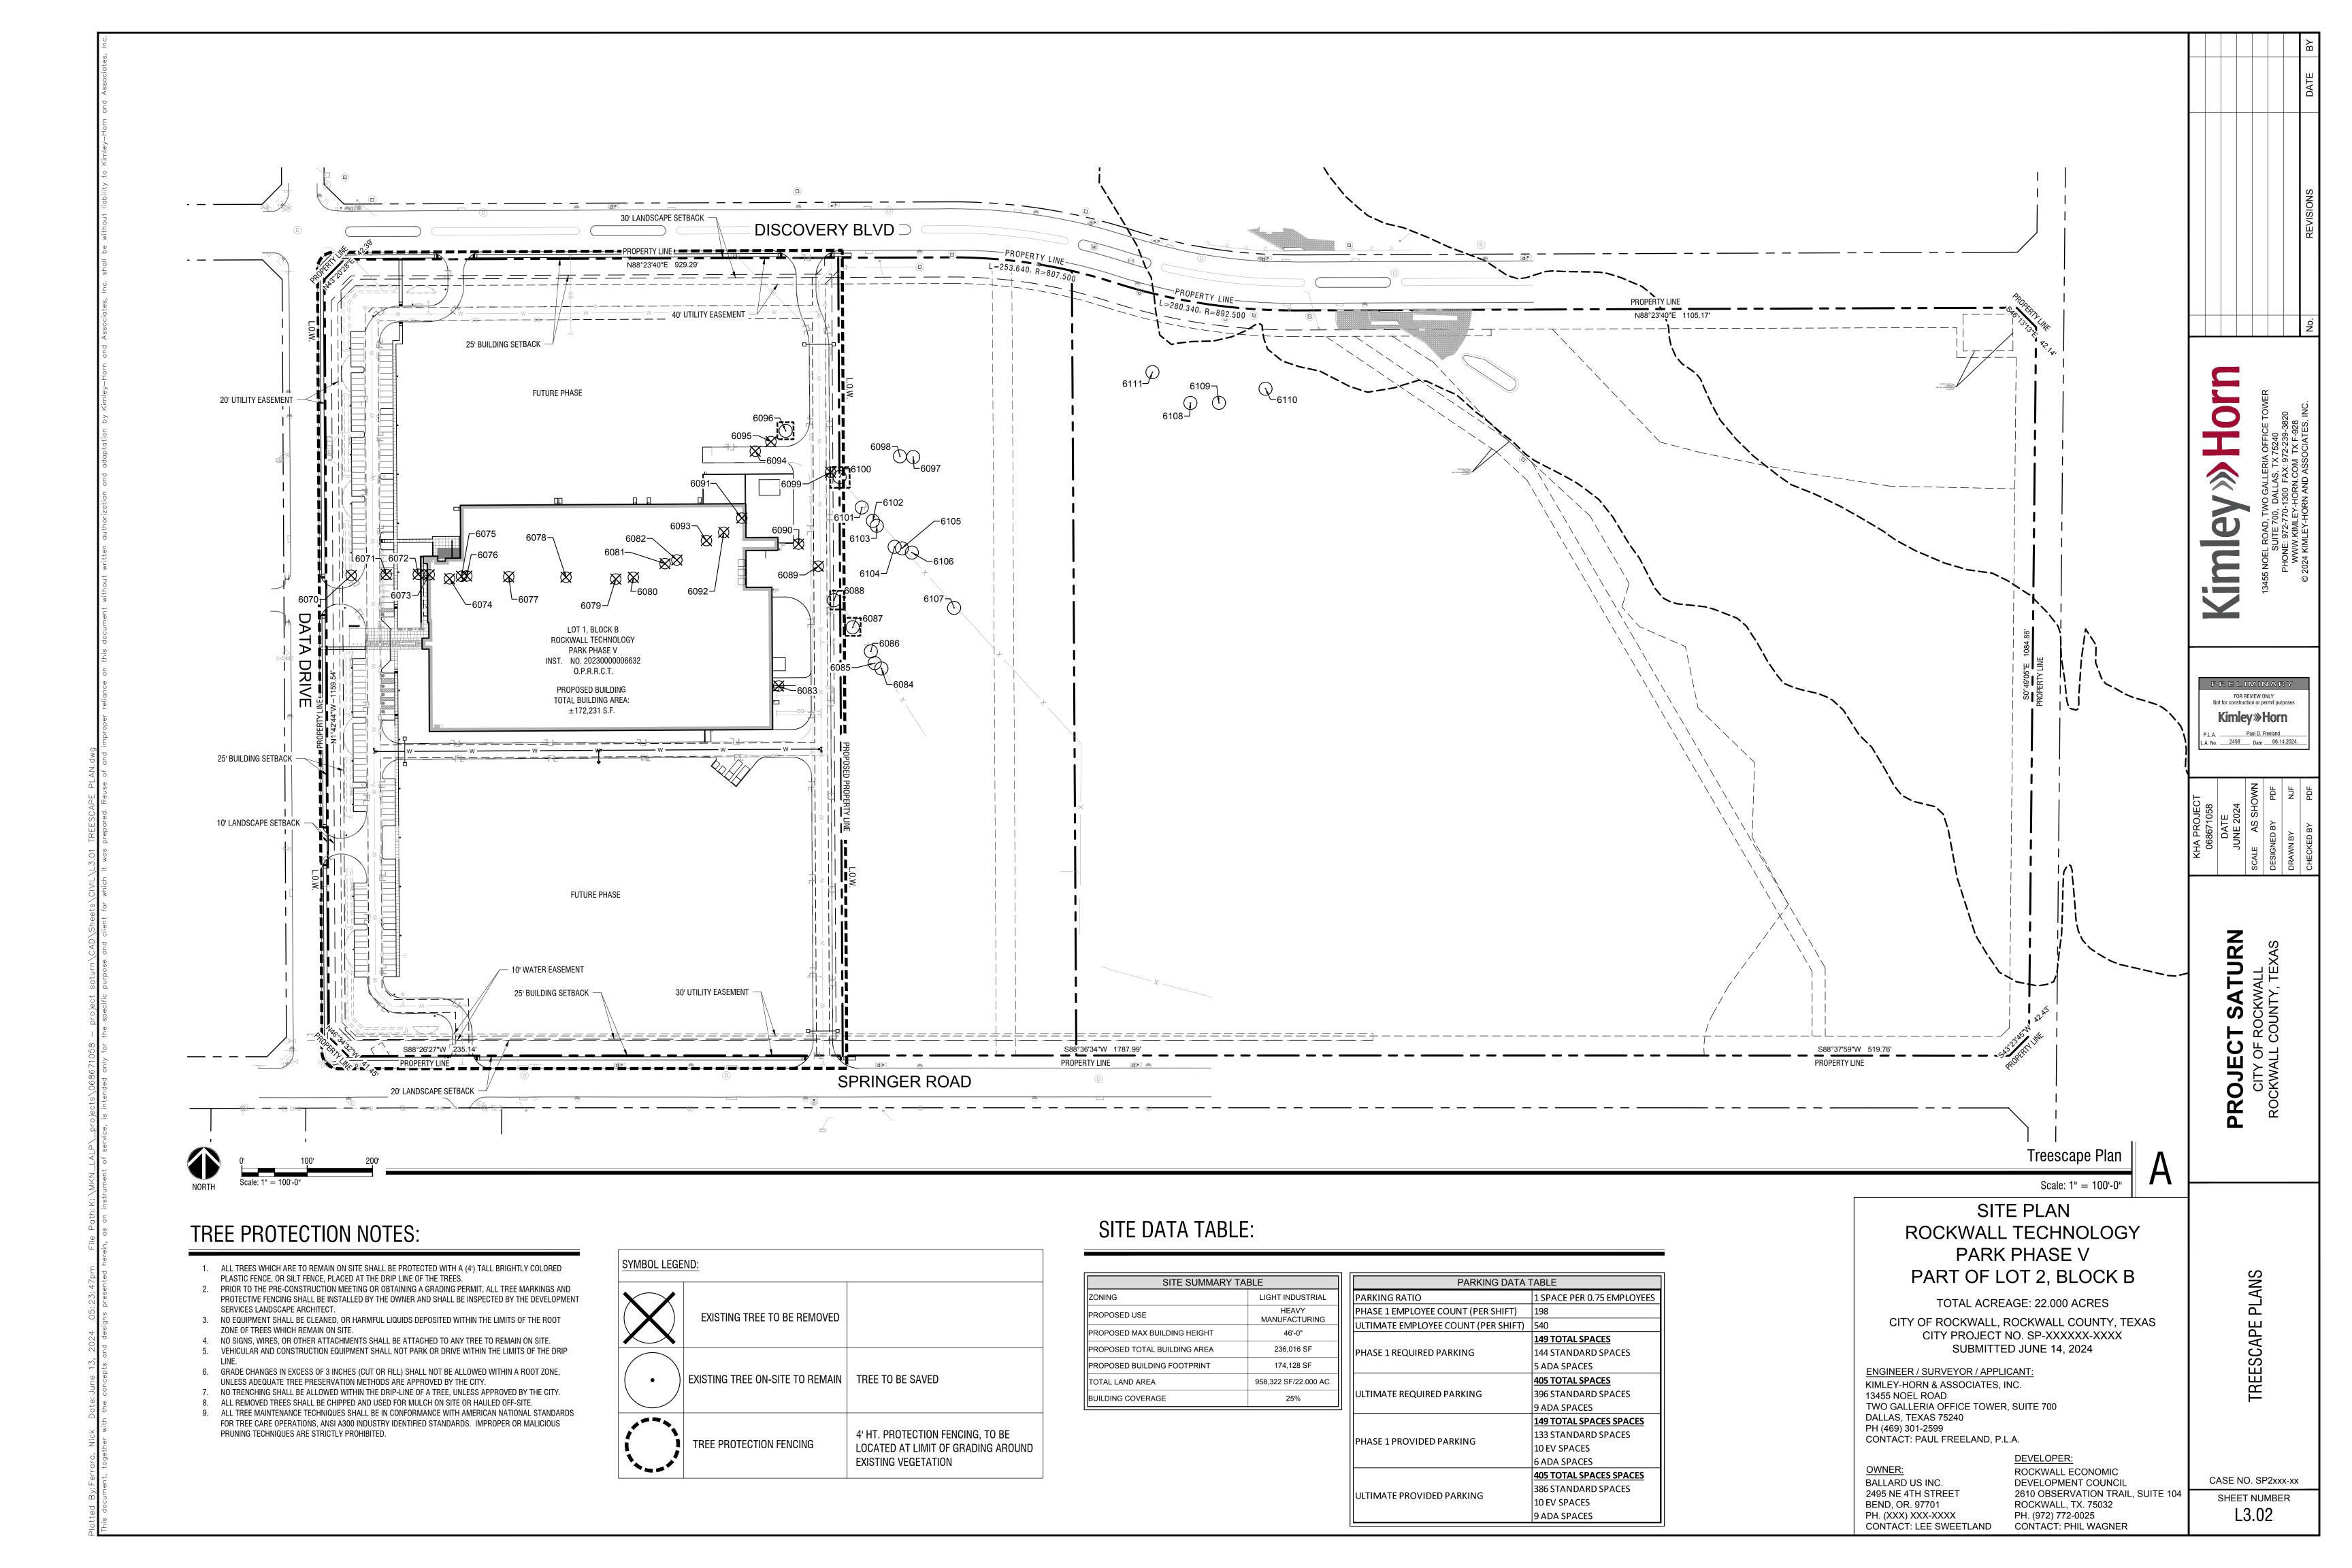


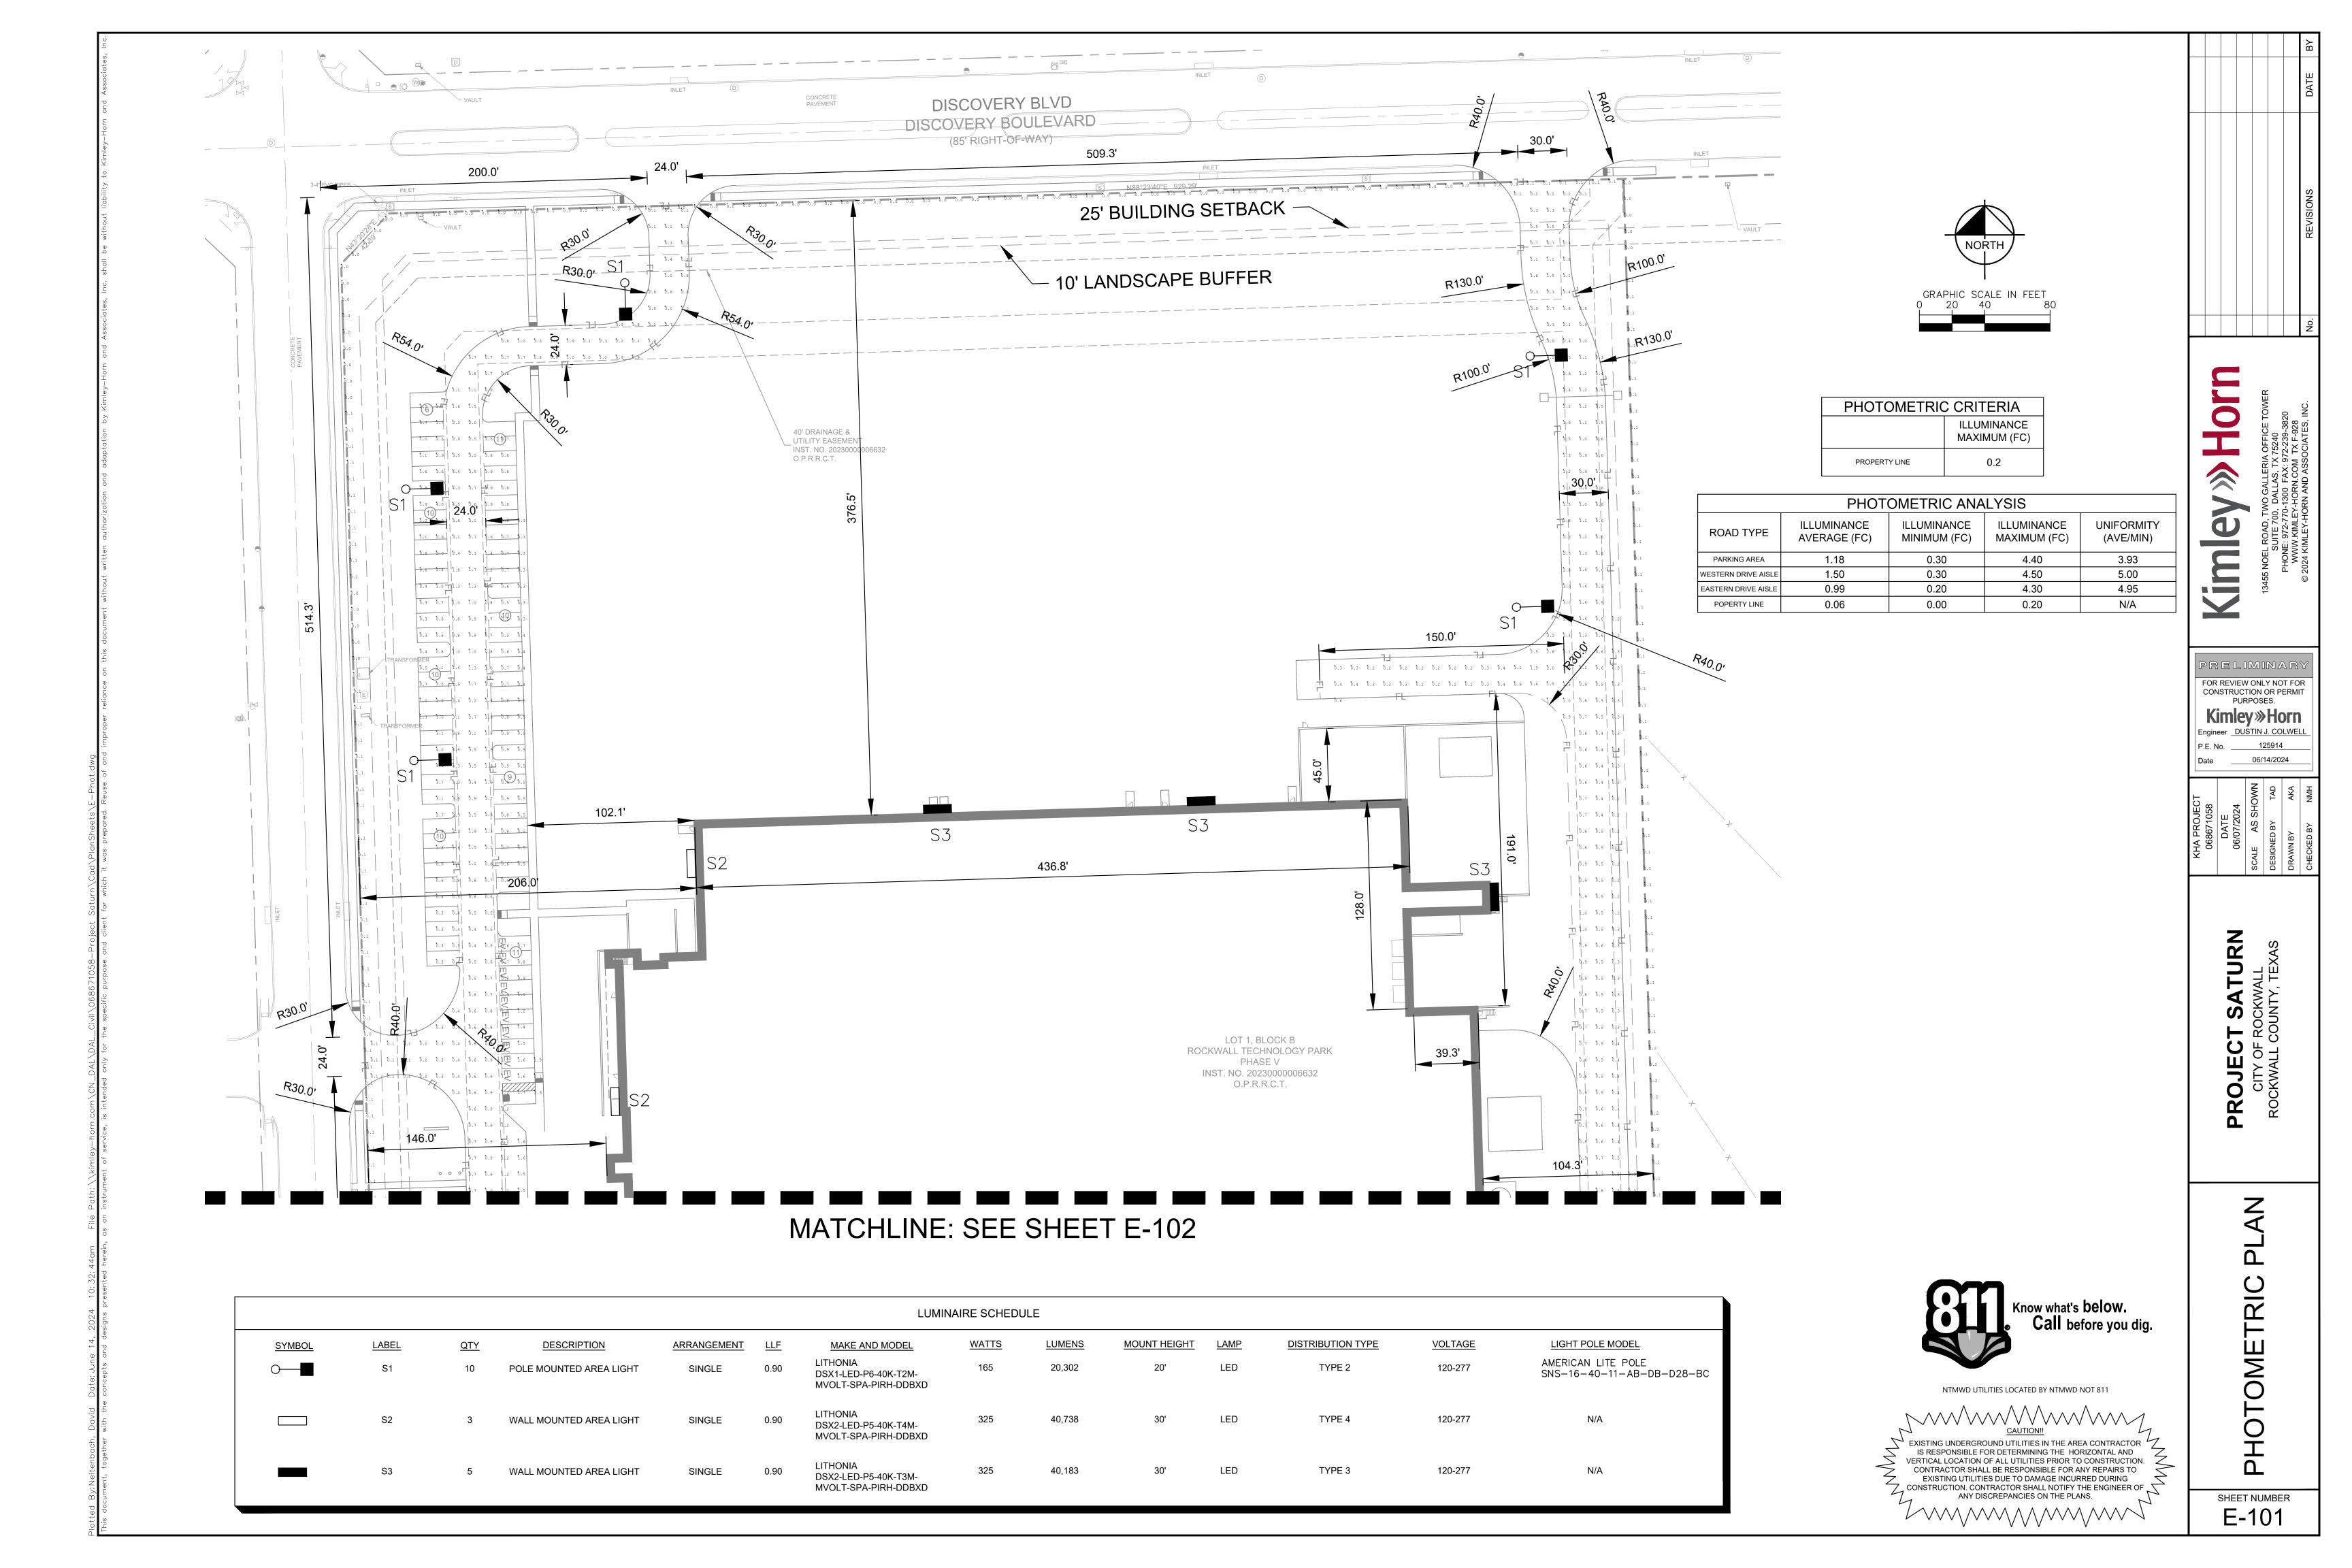


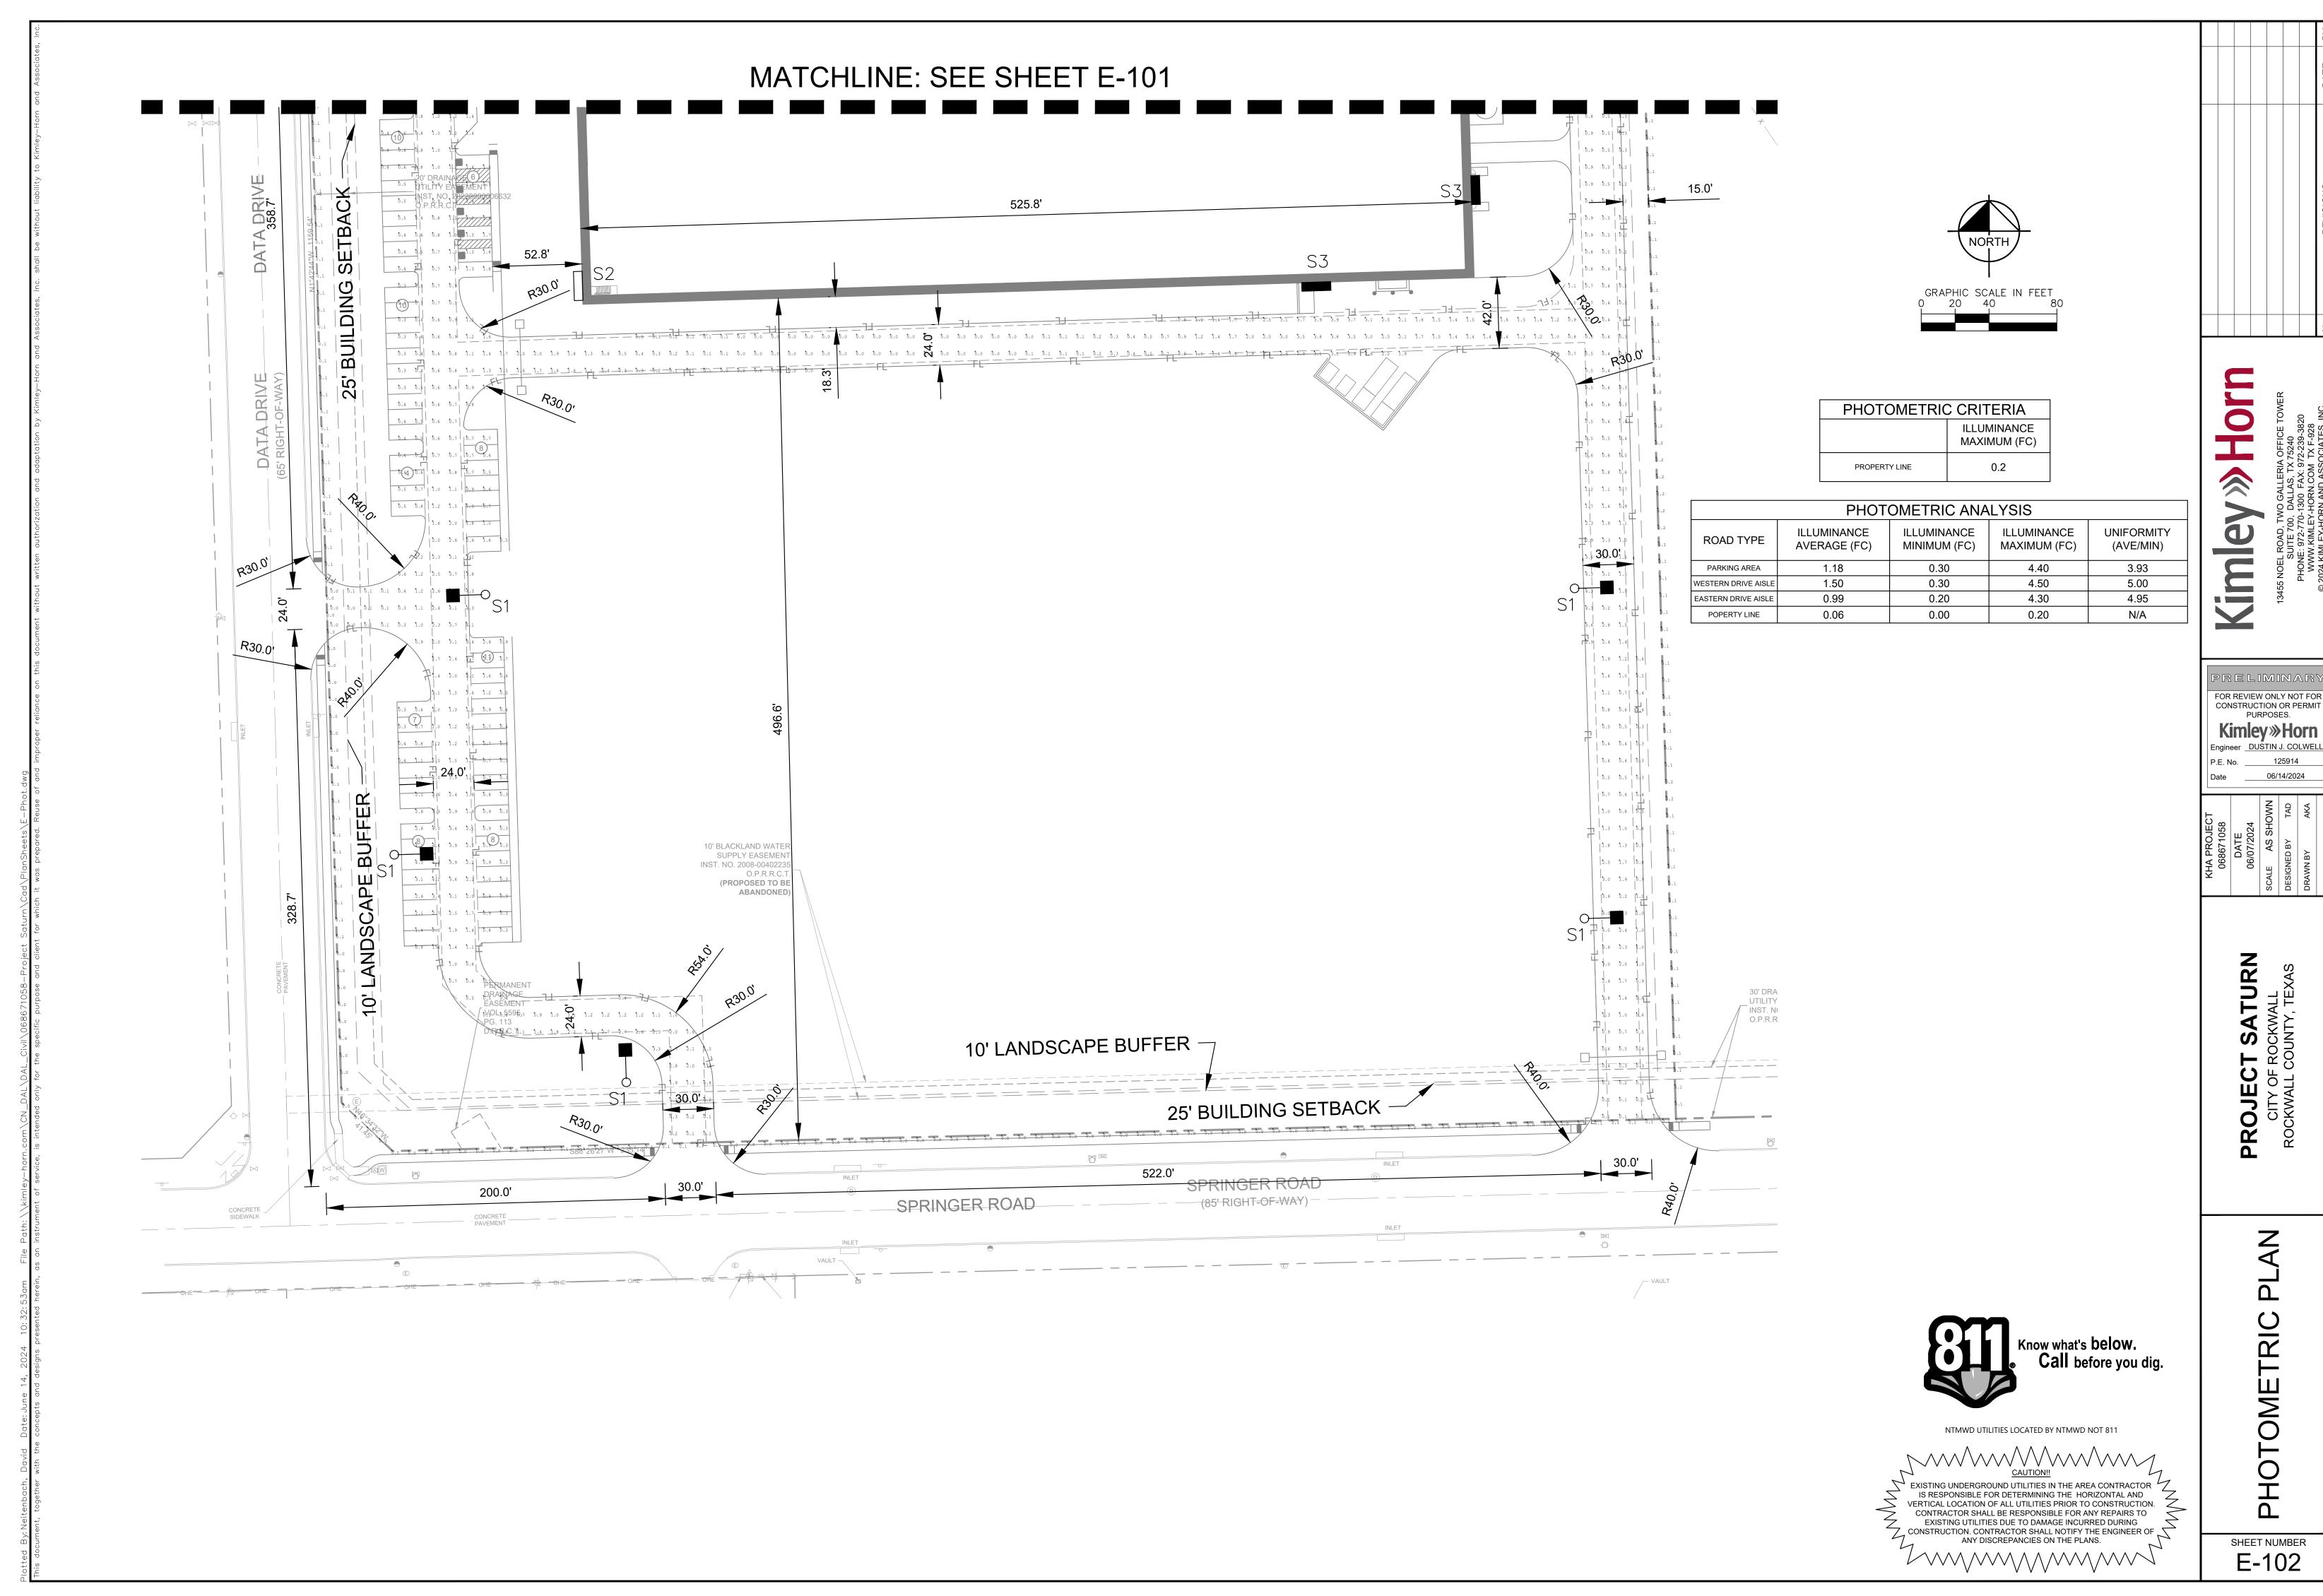

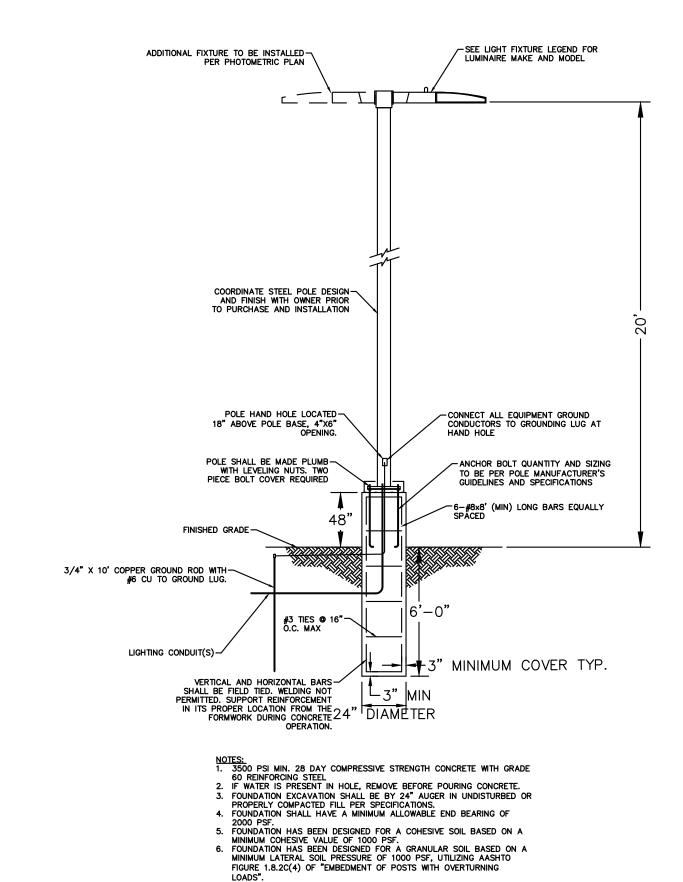


POLE FOUNDATION DETAIL

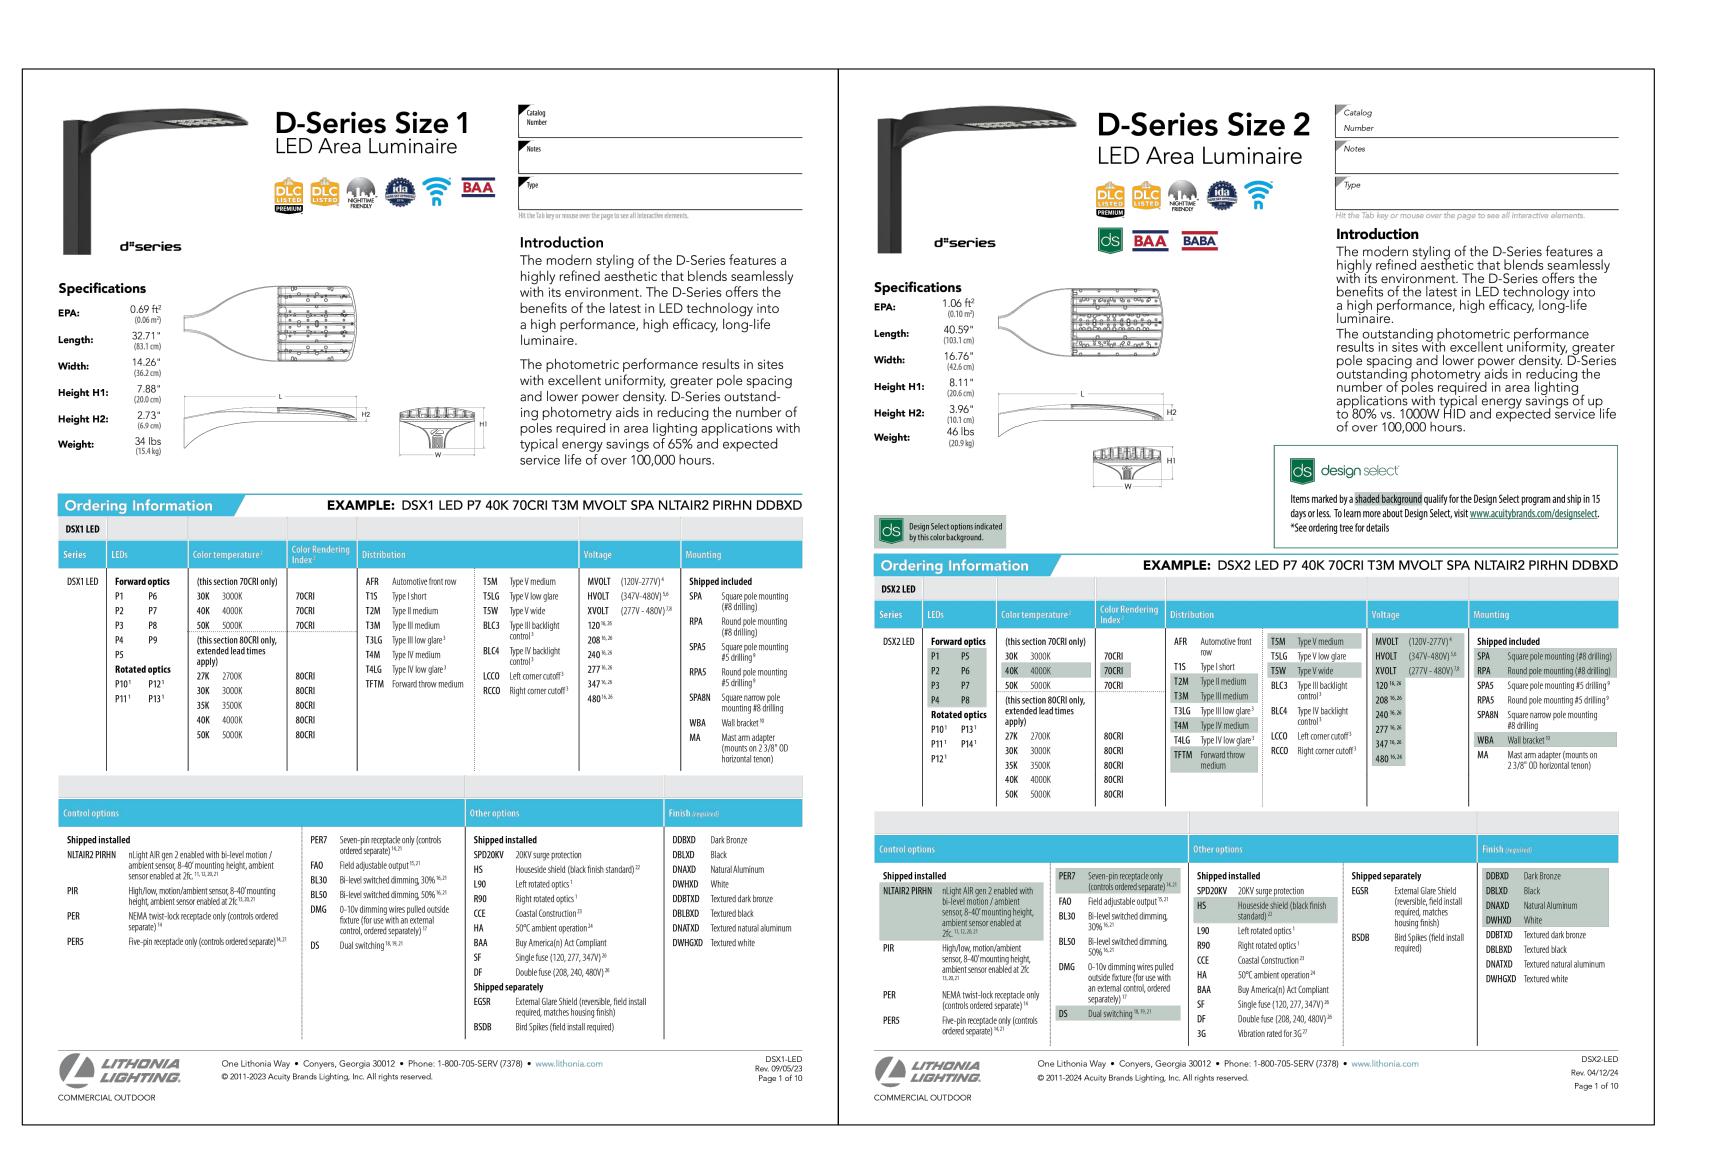

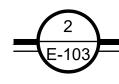



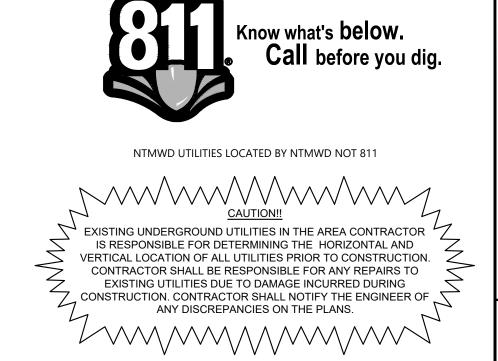

3455 NOEL ROAD, TWO GALLERIA OFFICE TOWER SUITE 700, DALLAS, TX 75240 PHONE: 972-770-1300 FAX: 972-239-3820 WWW.KIMLEY-HORN.COM TX F-928 WWW.KIMLEY-PORT WWW.KIMLEY-PORT WWW.KIMLEY-PORT WWW.KIMLEY-PORT WWW.KIMLEY-PORT WWW.KIMLEY-PORT WWW.KIMLEY-PORT WWW.KIMLEY-PORT WWW.KIMLEY-P

FOR REVIEW ONLY NOT FOR CONSTRUCTION OR PERMIT PURPOSES.

Kimley >>> Horn
Engineer DUSTIN J. COLWELL
P.E. No. 125914
Date 06/14/2024

DATE
06/07/2024
SCALE AS SHOWN
DESIGNED BY TAD
DRAWN BY AKA

PROJECT SATURN
CITY OF ROCKWALL
ROCKWALL COUNTY, TEXAS

METRIC AILS

PHOTOMETR DETAILS

E-103