


DEVELOPMENT APPLICATION

City of Rockwall Planning and Zoning Department 385 S. Goliad Street Rockwall, Texas 75087

PLANNING & ZONING CASE NO.							
NOTE: THE APPLICATION IS NOT CONSIDERED ACCEPTED BY THE CITY UNTIL THE PLANNING DIRECTOR AND CITY ENGINEER HAVE SIGNED BELOW.							
DIRECTOR OF PLANNING:							
CITY ENGINEED.							

		Loni	ENGINEER:			
PLEASE CHECK THE	APPROPRIATE BOX BELOW TO INDICATE THE TYPE (OF DEVELOPMENT RE	QUEST [SELECT ONLY ONE BOX]:			
☐ PRELIMINARY ☐ FINAL PLAT (\$3 ☐ REPLAT (\$300.) ☐ AMENDING OR ☐ PLAT REINSTA SITE PLAN APPLI ☒ SITE PLAN (\$25	(\$100.00 + \$15.00 ACRE) 1 PLAT (\$200.00 + \$15.00 ACRE) 1 300.00 + \$20.00 ACRE) 1 00 + \$20.00 ACRE) 1 MINOR PLAT (\$150.00) TEMENT REQUEST (\$100.00)	☐ ZONING CH. ☐ SPECIFIC U: ☐ PD DEVELO OTHER APPLIC ☐ TREE REMO ☐ VARIANCE F. NOTES: ¹; IN DETERMINING PER ACRE AMOUNT. ²; A \$1,000.00 FEE	ZONING APPLICATION FEES: ☐ ZONING CHANGE (\$200.00 + \$15.00 ACRE) ☐ SPECIFIC USE PERMIT (\$200.00 + \$15.00 ACRE) ☐ PD DEVELOPMENT PLANS (\$200.00 + \$15.00 ACRE) ☐ OTHER APPLICATION FEES: ☐ TREE REMOVAL (\$75.00) ☐ VARIANCE REQUEST/SPECIAL EXCEPTIONS (\$100.00) ☐ VARIANCE REQUEST/SPECIAL EXCEPTIONS (\$100.00) ☐ NOTES: ☐: IN DETERMINING THE FEE, PLEASE USE THE EXACT ACREAGE WHEN MULTIPLYING BY THE PER ACRE AMOUNT. FOR REQUESTS ON LESS THAN ONE ACRE, ROUND UP TO ONE (1) ACRE. ②: A \$1,000.00 FEE WILL BE ADDED TO THE APPLICATION FEE FOR ANY REQUEST THAT INVOLVES CONSTRUCTION WITHOUT OR NOT IN COMPLIANCE TO AN APPROVED BUILDING			
PROPERTY INFO	ORMATION [PLEASE PRINT]					
ADDRES						
SUBDIVISIO	N Quail Hollow Phase 2		LOT	BLOCK		
GENERAL LOCATIO	Northeast Corner of Hays Lane	Road				
ZONING SITE P	LAN AND PLATTING INFORMATION [PLEA	SF PRINT				
CURRENT ZONIN		CURRENT USE				
PROPOSED ZONIN	G C	PROPOSED USE				
ACREAG	E 42.742 LOTS [CURREN]	т) под воде	LOTS [PROPOSED]	111		
REGARD TO ITS RESULT IN THE	<u>D PLATS</u> : BY CHECKING THIS BOX YOU ACKNOWLEDGE APPROVAL PROCESS, AND FAILURE TO ADDRESS ANY OF DENIAL OF YOUR CASE.	F STAFF'S COMMENTS B	Y THE DATE PROVIDED ON THE DEV	ELOPMENT CALENDAR WILL		
	CANT/AGENT INFORMATION PLEASE PRINT/C			REQUIRED]		
	Quail Hollow SF, LTD.		Corwin Engineering			
CONTACT PERSON	John Arnold	CONTACT PERSON ADDRESS	Chase Finch			
AUURE55	8214 Westchester Drive Ste. 900	ADDRESS	200 W. Belmont St	e. E		
CITY, STATE & ZIP	Dallas, TX 75202	CITY, STATE & ZIP	Allen, Tx 75013			
PHONE	214-522-4945	PHONE	972-396-1200			
E-MAIL	jarnold@skorburgcompany.com	E-MAIL	cfinch@corwinengin	eering.com		
BEFORE ME, THE UNDE	ICATION [REQUIRED] ERSIGNED AUTHORITY, ON THIS DAY PERSONALLY APPEAR TION ON THIS APPLICATION TO BE TRUE AND CERTIFIED TH		ld [OWNER]	THE UNDERSIGNED, WHO		
S 1,110.00 INFORMATION CONTAIN SUBMITTED IN CONJUNC	TIAM THE OWNER FOR THE PURPOSE OF THIS APPLICATION; TO COVER THE COST OF THIS APPLICATION, I 20 2 2 3 2 BY SIGNING THIS APPLICATION, I AG IED WITHIN THIS APPLICATION TO THE PUBLIC. THE CITY OTHER WITH THIS APPLICATION, IF SUCH REPRODUCTION IS ASS D AND SEAL OF OFFICE ON THIS THE 17 OWNER'S SIGNATURE D FOR THE STATE OF TEXAS	HAS BEEN PAID TO THE CI REE THAT THE CITY OF R IS ALSO AUTHORIZED AI SOCIATED OR IN RESPONS	TY OF ROCKWALL ON THIS THE // OCKWALL (I.E. "CITY") IS AUTHORIZED NO PERMITTED TO REPRODUCE ANY SE TO A REQUEST FOR EURICITATION MY CO.	DAY OF AND PERMITTED TO PROVIDE COPYRIGHTED INFORMATION ATION. Ashtey-Ven Veerhis ommission Expires 2/1/2028 ry ID 134742171		
NOTARY PUBLIC IN AN	D FOR THE STATE OF TEXAS BULL	· vu	MY COMMISSION EXPIRES	2/1/2028		

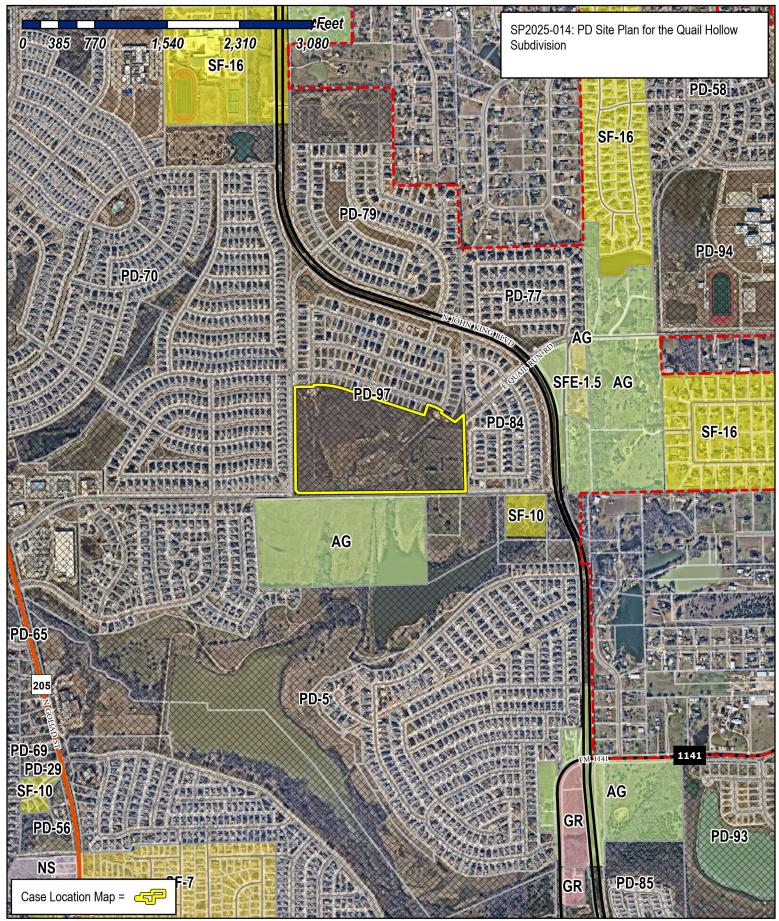





City of Rockwall Planning & Zoning Department 385 S. Goliad Street

Planning & Zoning Department 385 S. Goliad Street Rockwall, Texas 75087 (P): (972) 771-7745 (W): www.rockwall.com The City of Rockwall GIS maps are continually under development and therefore subject to change without notice. While we endeavor to provide timely and accurate information, we make no guarantees. The City of Rockwall makes no warranty, express or implied, including warranties of merchantability and fitness for a particular purpose. Use of the information is the sole responsibility of the user.



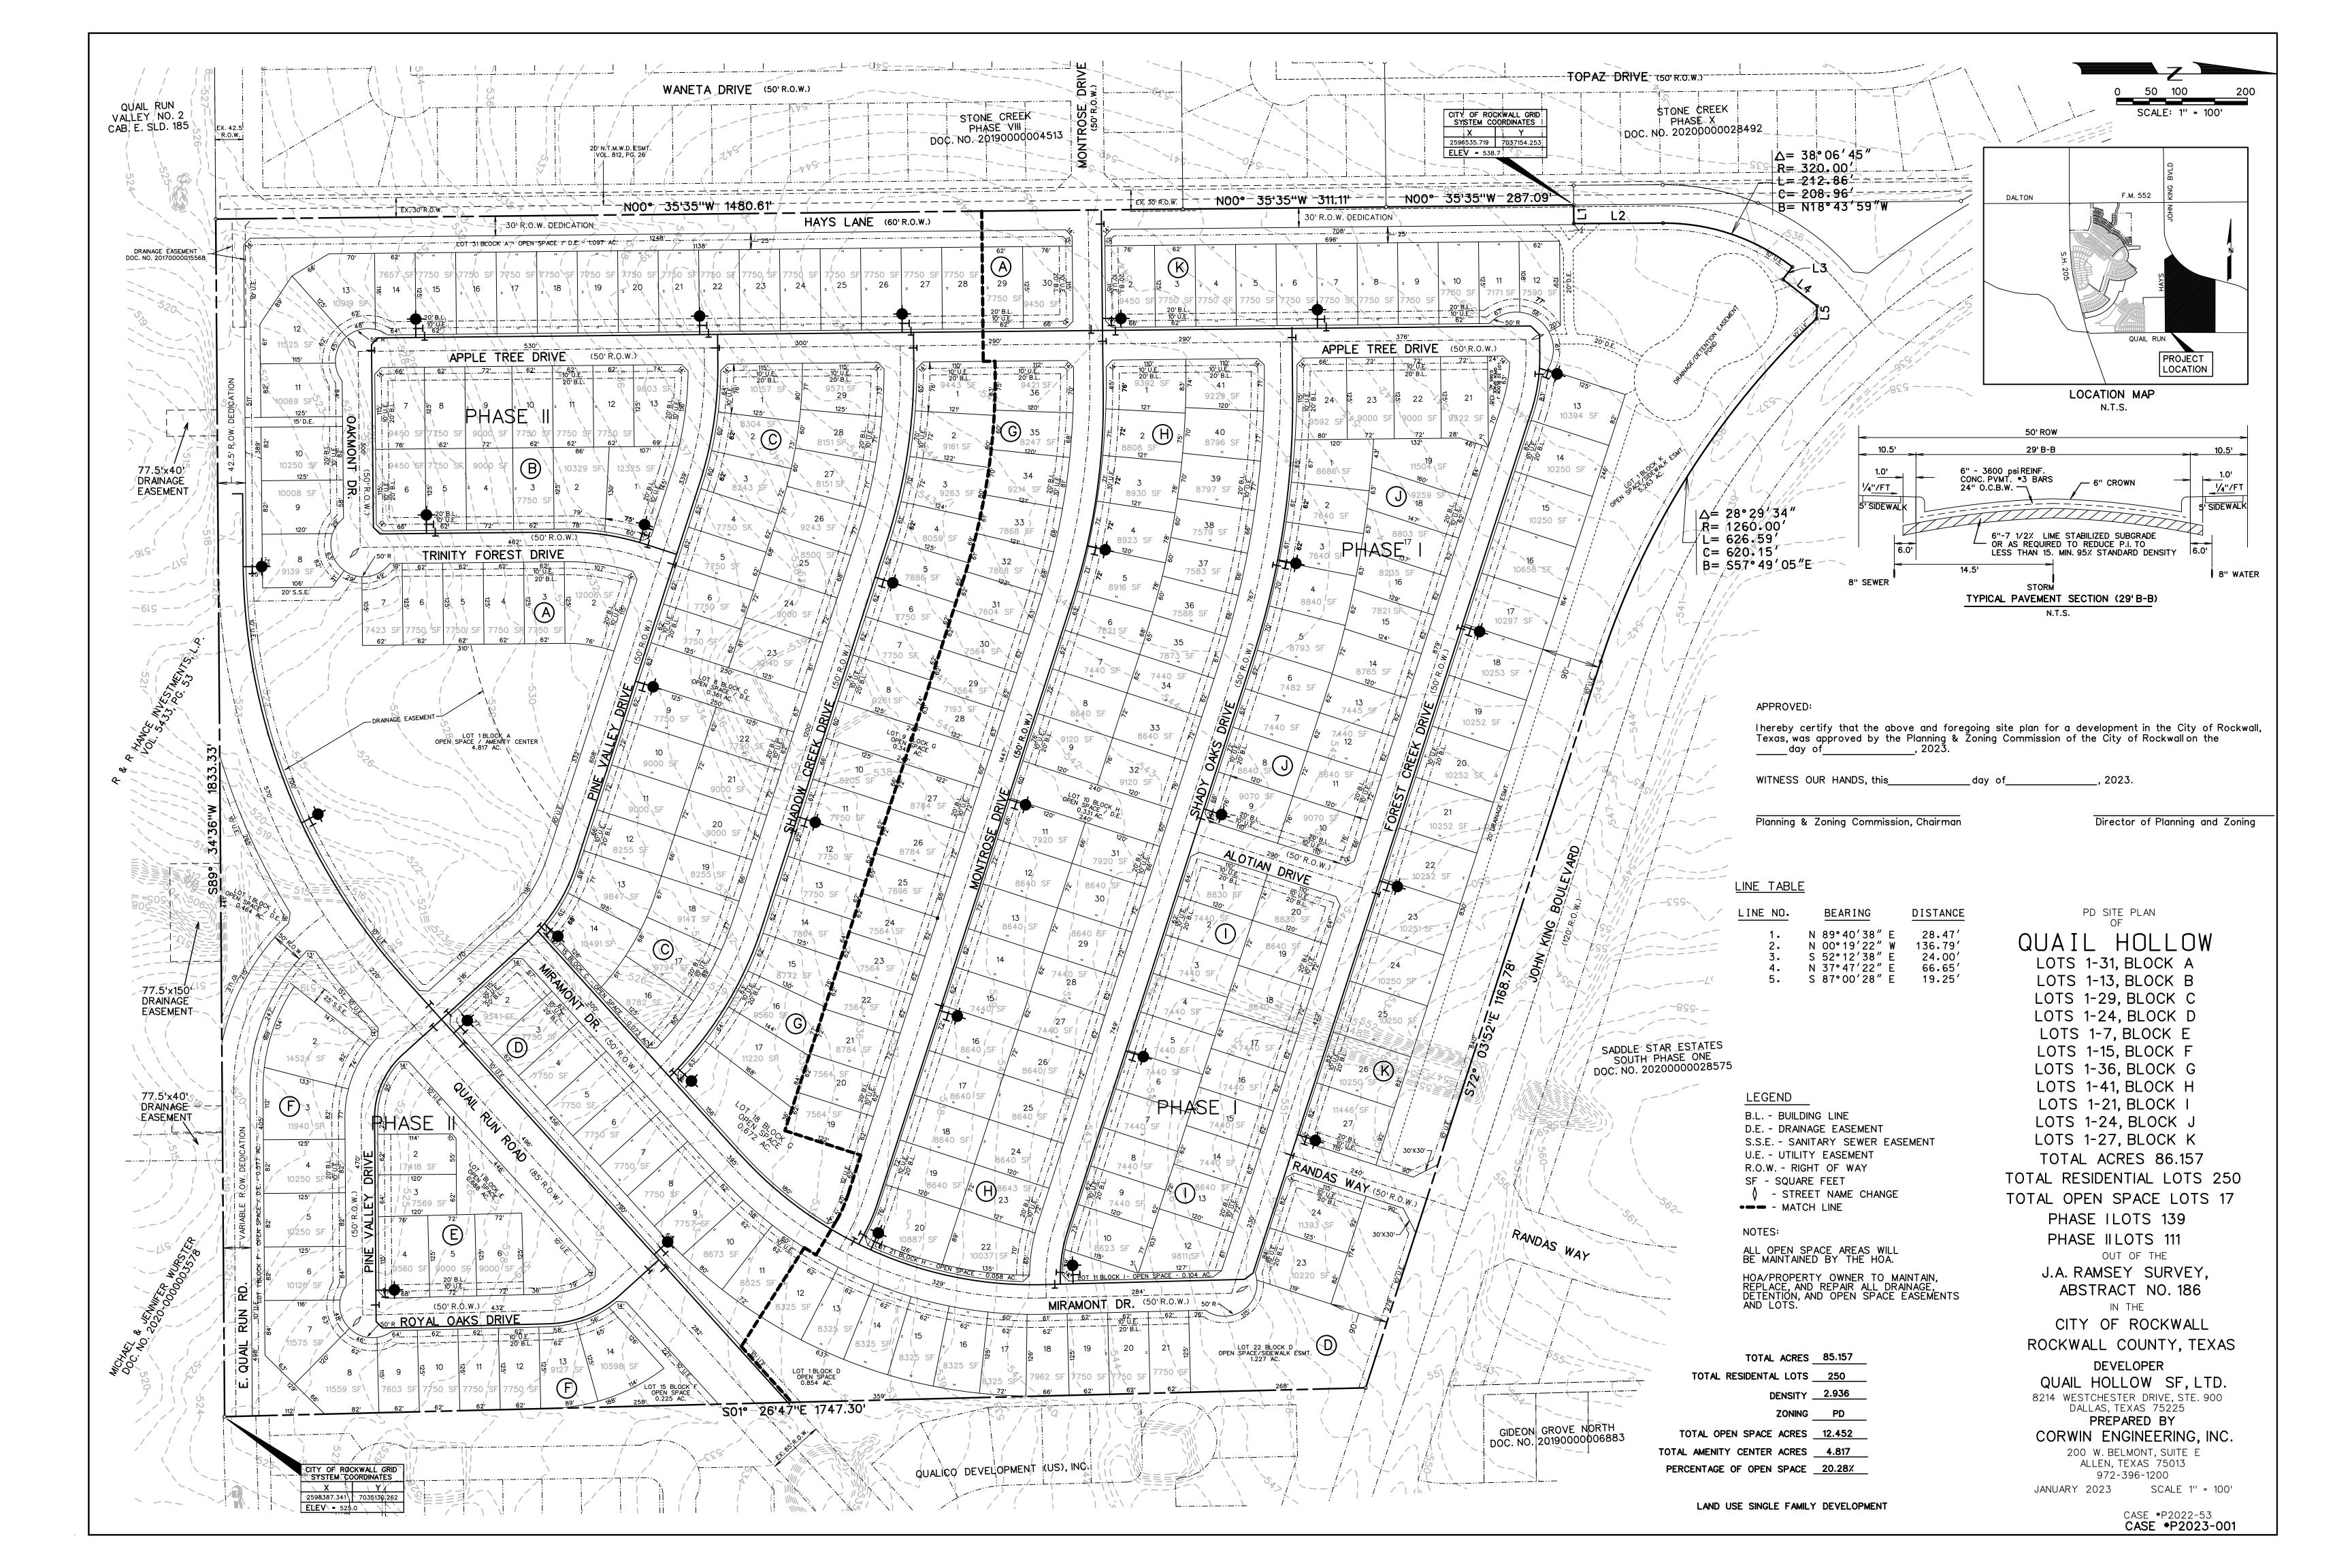

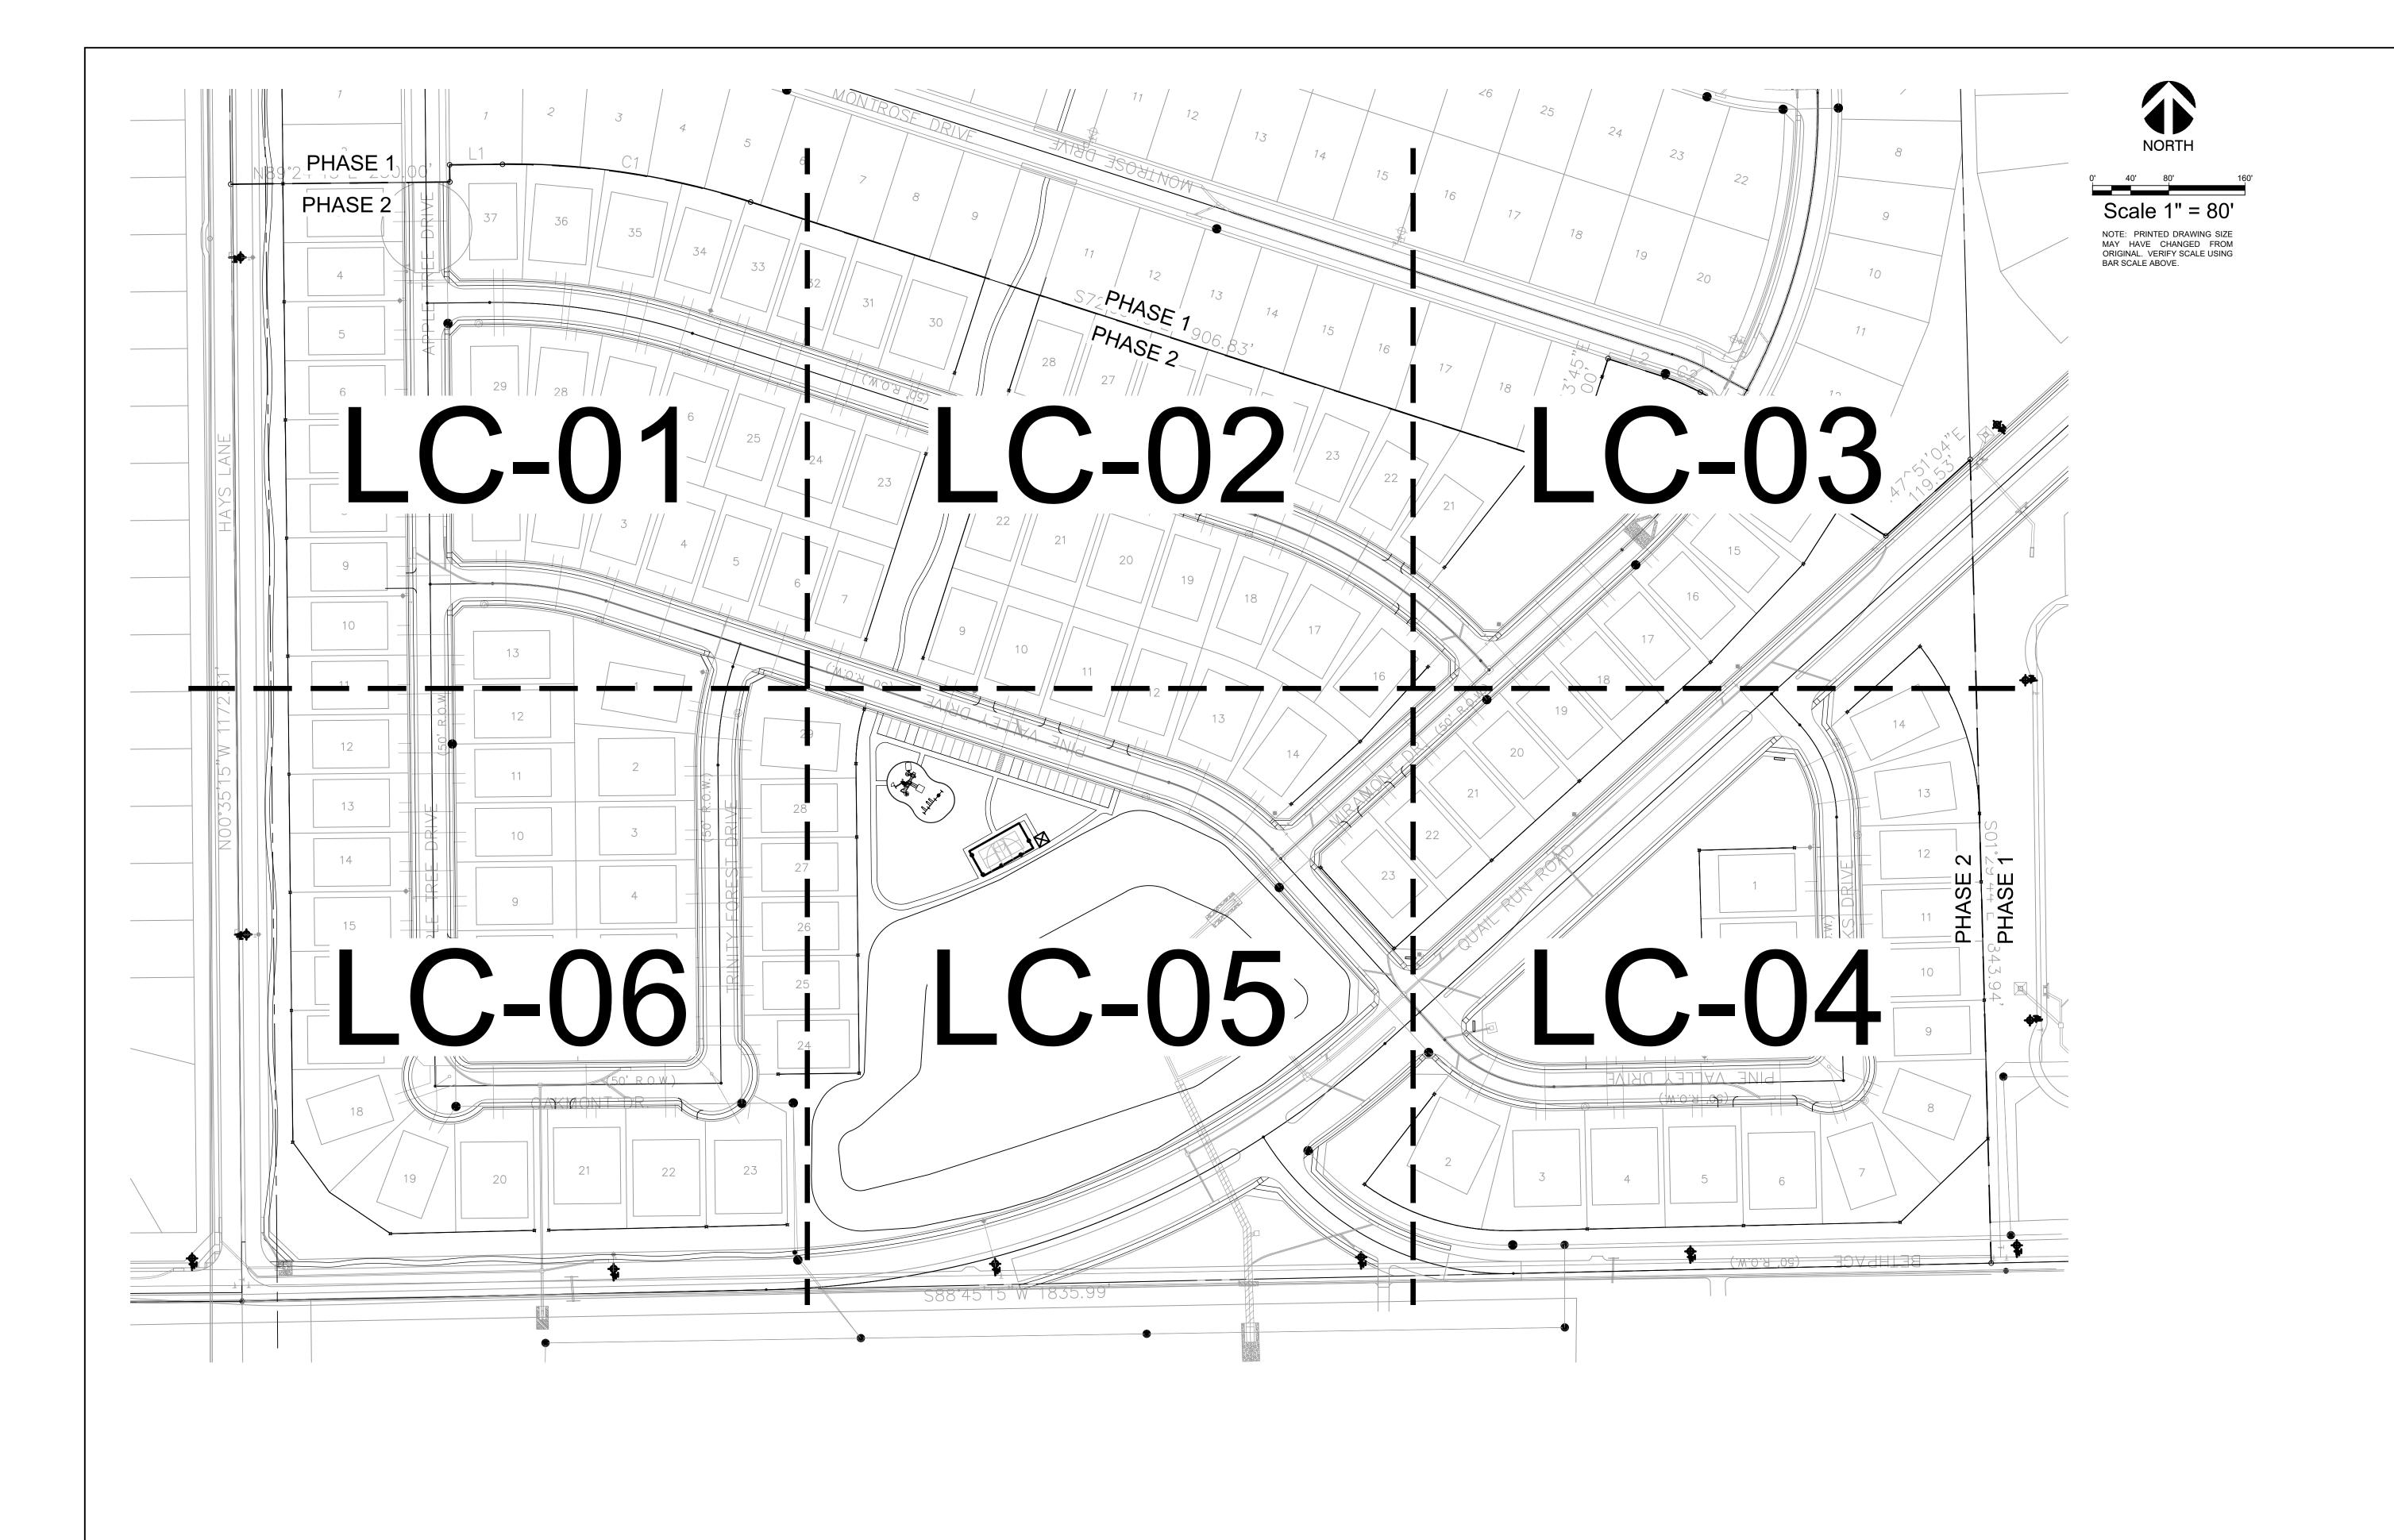



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MARY N. BATES TEXAS L.A. #3613 ISSUED ON: OCTOBER 04, 2024

Company
er Drive, Suite 900

Skorburg (8214 Westchester Dallas, Texas 75225

Quail Hollow Rockwall, TX

OVERALL HARDSCAPE PLAN


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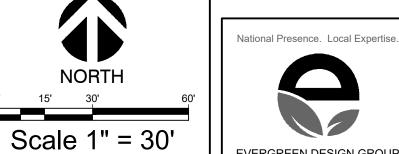
Project Number

 Date
 10/04/24

 Drawn By
 KB

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CONSTRUCTION LEGEND

2. EXPANSION JOINT WITH COLOR CAULK TO MATCH ADJACENT PAVEMENT. SEE DETAIL A, SHEET LC-07.

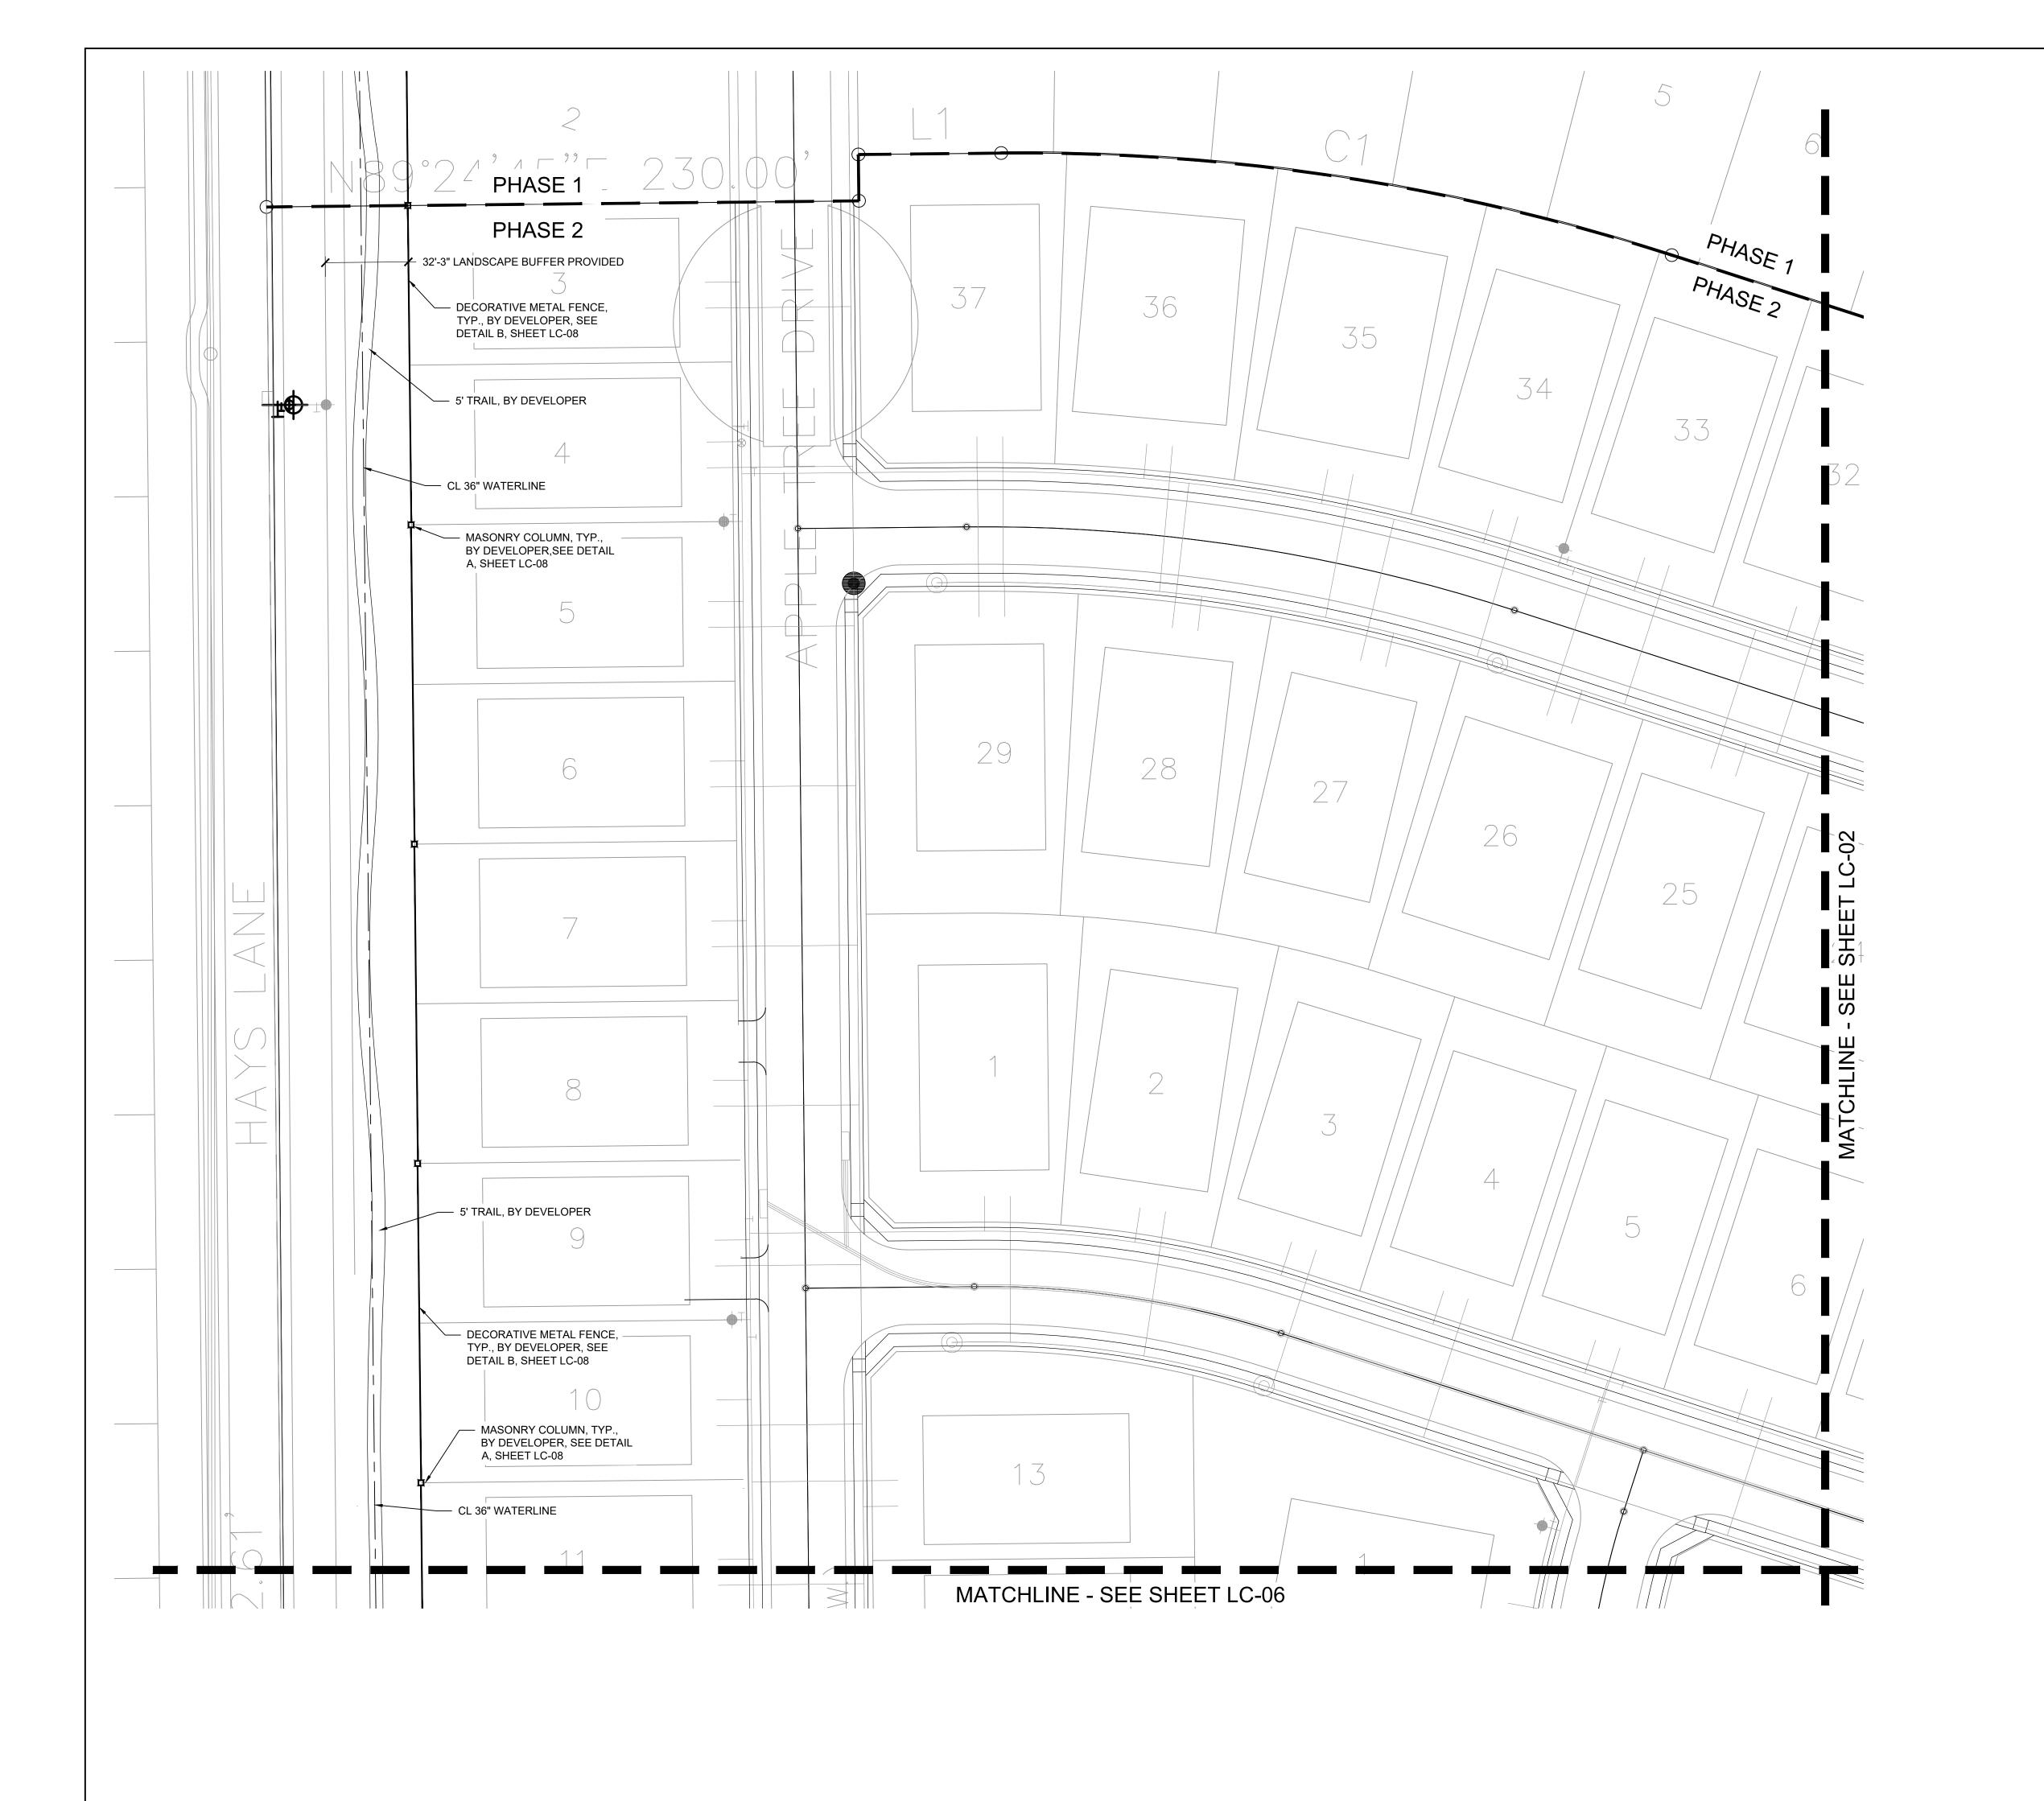3. 4" CONCRETE PAD, LIGHT BROOM FINISH, NATURAL GRAY

4. PLAYGROUND EQUIPMENT, SEE DETAIL D, SHEET LC-08

5. PLAYGROUND SAFETY SURFACING - ENGINEERED WOOD

(7.) MULTI SPORT COURT. SEE DETAIL D, SHEET LC-07.

PRIMARY COLUMN. SEE DETAIL A, SHEET LC-08.

(10.) WROUGHT IRON FENCE W/ MASONRY COLUMN. SEE DETAIL A, SHEET LC-08.

MULCH; SEE DETAIL C, SHEET LC-08.

6.) SWINGS, SEE DETAIL D, SHEET LC-08.

(8.) ADA RAMP. SEE DETAIL C, SHEET LC-07.

COLOR; W/ SAWCUT CONTROL JOINTS; SEE DETAIL B,

(MASTER LIST - NOT ALL ITEMS ARE ON EVERY SHEET)

SHEET LC-07.

EVERGREEN DESIGN GROUP NOTE: PRINTED DRAWING SIZE MAY HAVE CHANGED FROM ORIGINAL. VERIFY SCALE USING BAR SCALE ABOVE. 800.680.6630 www.evergreendesigngroup.com LANDSCAPE ARCHITECTURE LAND PLANNING · IRRIGATION DESIGN

 4-IN THK. CONCRETE WALK, LIGHT BROOM FINISH, NATURAL GRAY COLOR; SEE DETAIL B, SHEET LC-07. THIS DOCUMENT IS ISSUED FOR INTERIM REVIEW AND IS NOT TO BE USED FOR CONSTRUCTION, BIDDING, OR PERMITTING PURPOSES.

> MARY N. BATES TEXAS L.A. #3613

ISSUED ON:


OCTOBER 04, 2024


D ij

Quail Hollow Rockwall, TX

HARDSCAPE PLAN

Date Comment

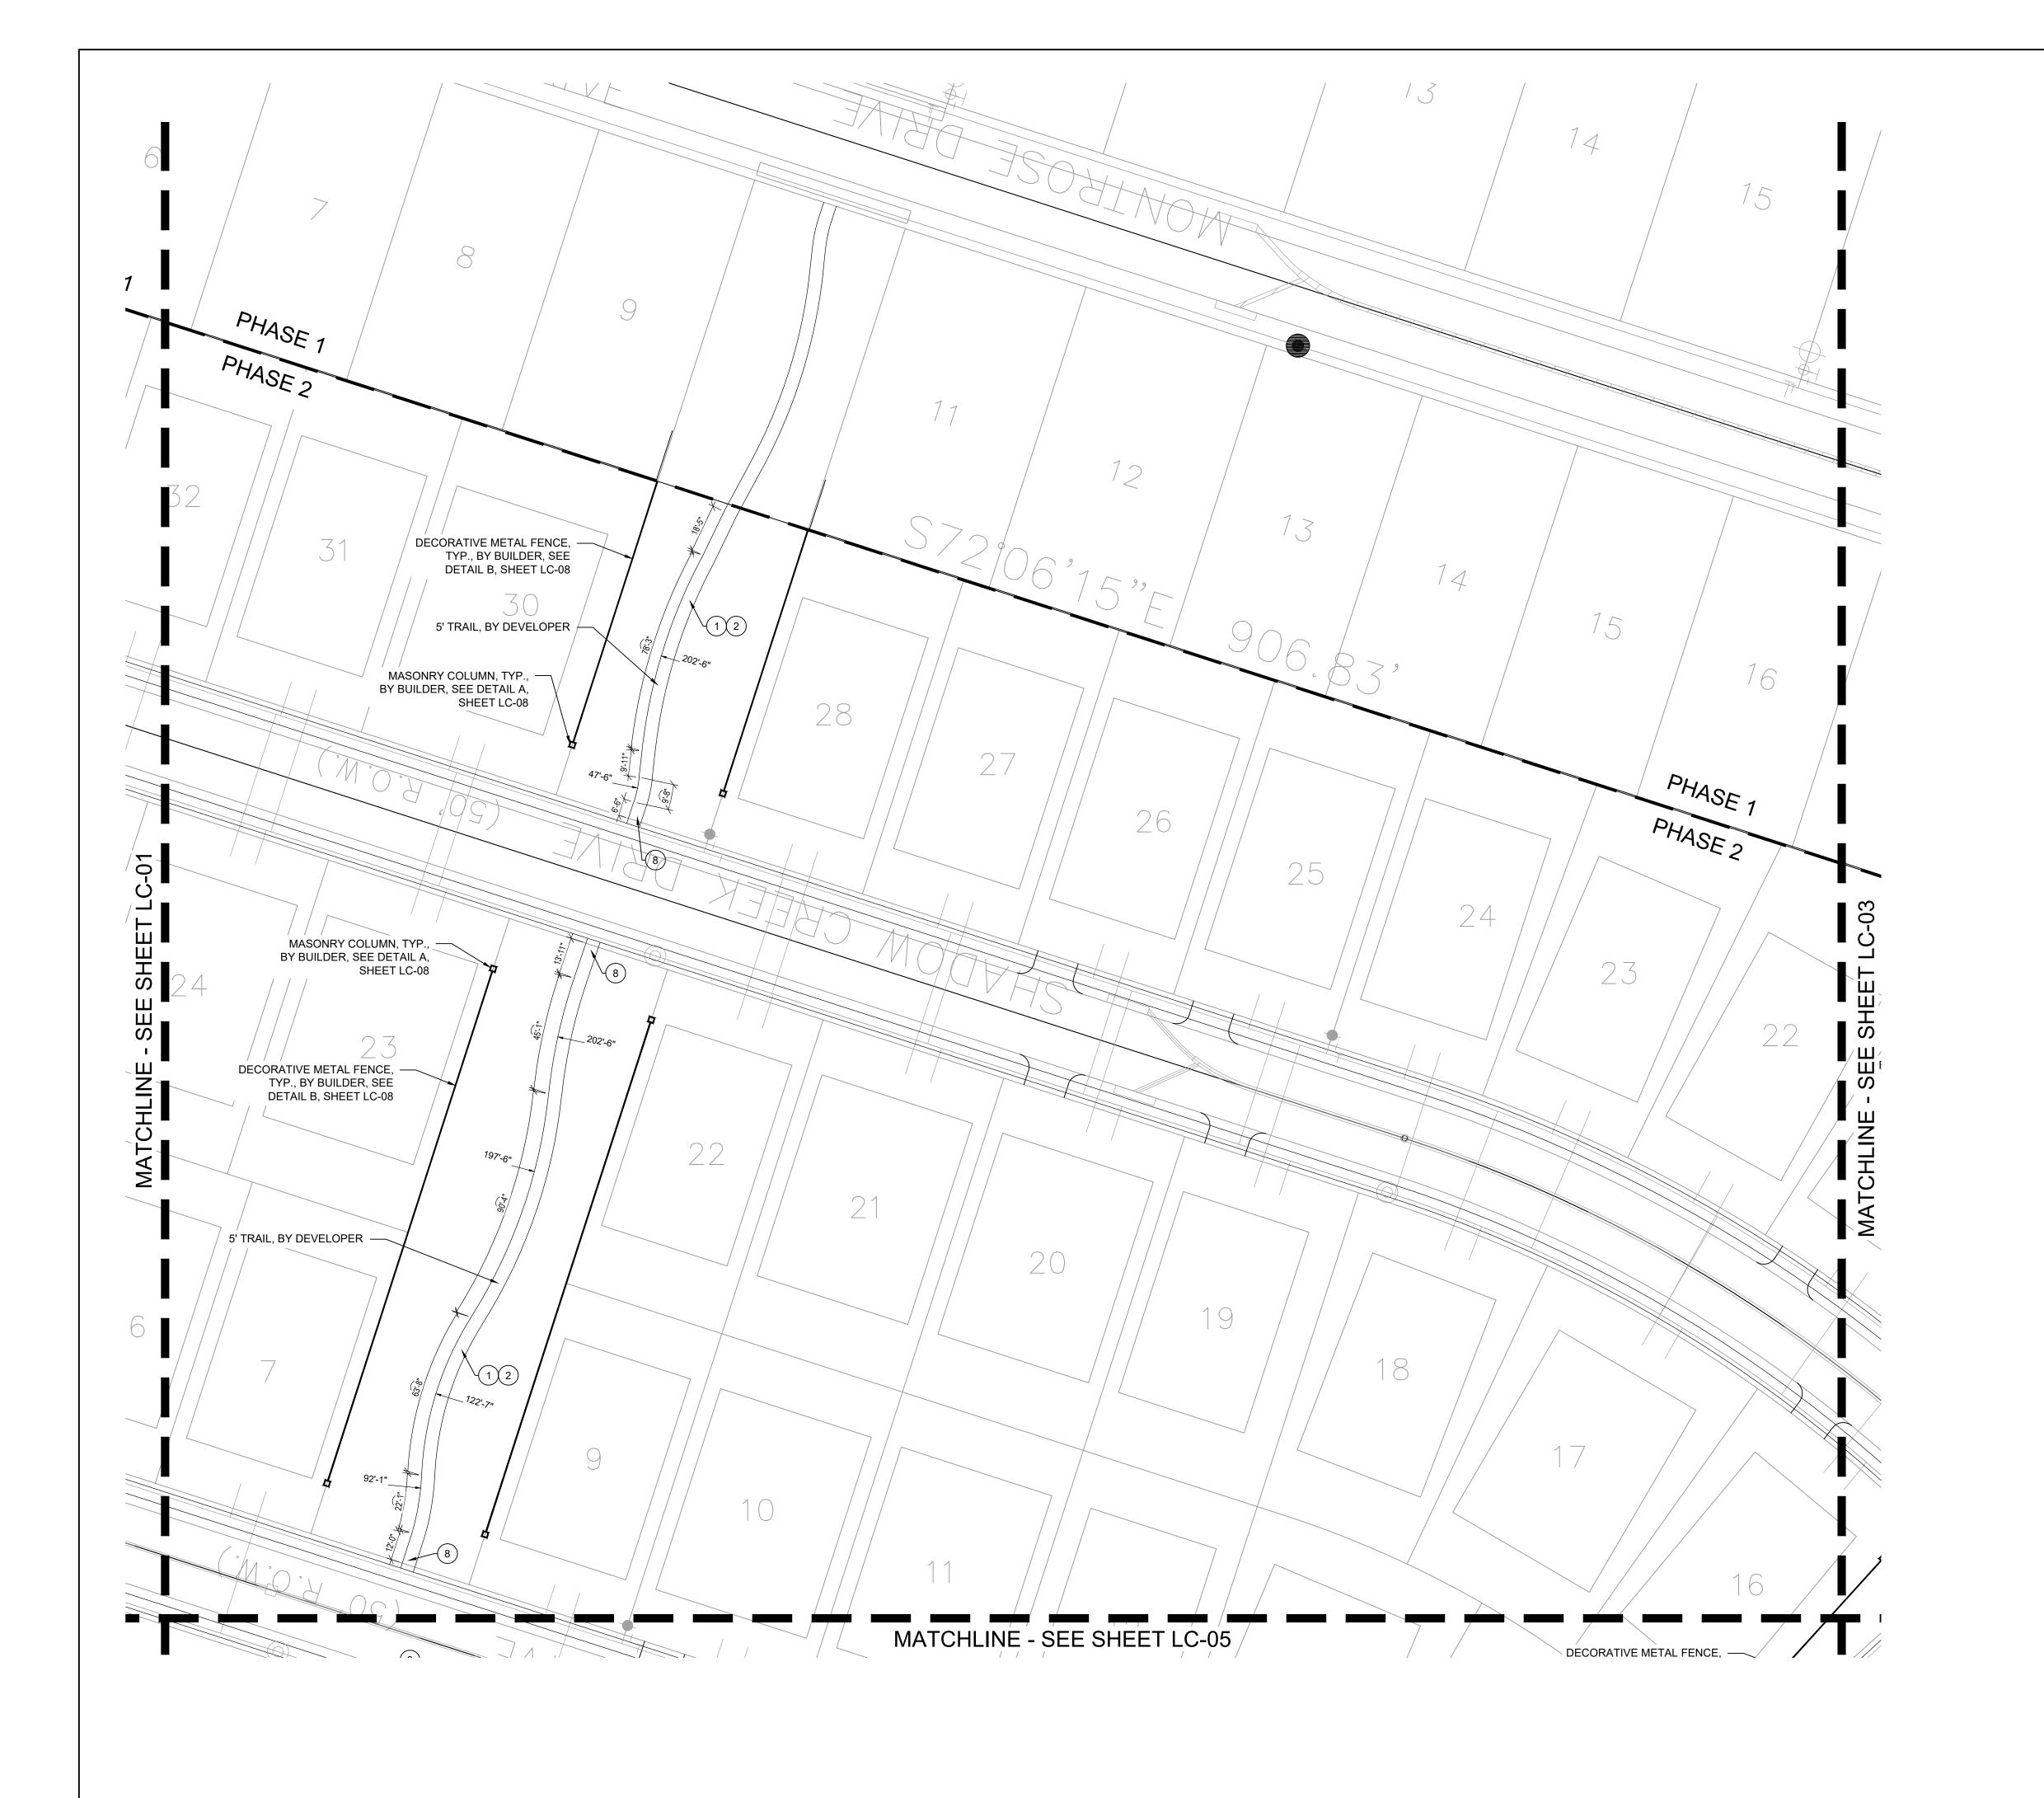

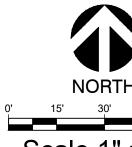

Scale 1" = 30'

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- (5.) PLAYGROUND SAFETY SURFACING ENGINEERED WOOD MULCH; SEE DETAIL C, SHEET LC-08.
- 6. SWINGS, SEE DETAIL D, SHEET LC-08.
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- 8. ADA RAMP. SEE DETAIL C, SHEET LC-07.
- 9. PRIMARY COLUMN. SEE DETAIL A, SHEET LC-08.
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MARY N. BATES
TEXAS L.A. #3613

ISSUED ON: OCTOBER 04, 2024

skorburg Company 214 Westchester Drive, Suite 900 allas, Texas 75225

Quail Hollow Rockwall, TX

HARDSCAPE PLAN


Date Comment


Project Number

Date 10/04/2

Date 10/04/24
Drawn By KB

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Scale 1" = 30'
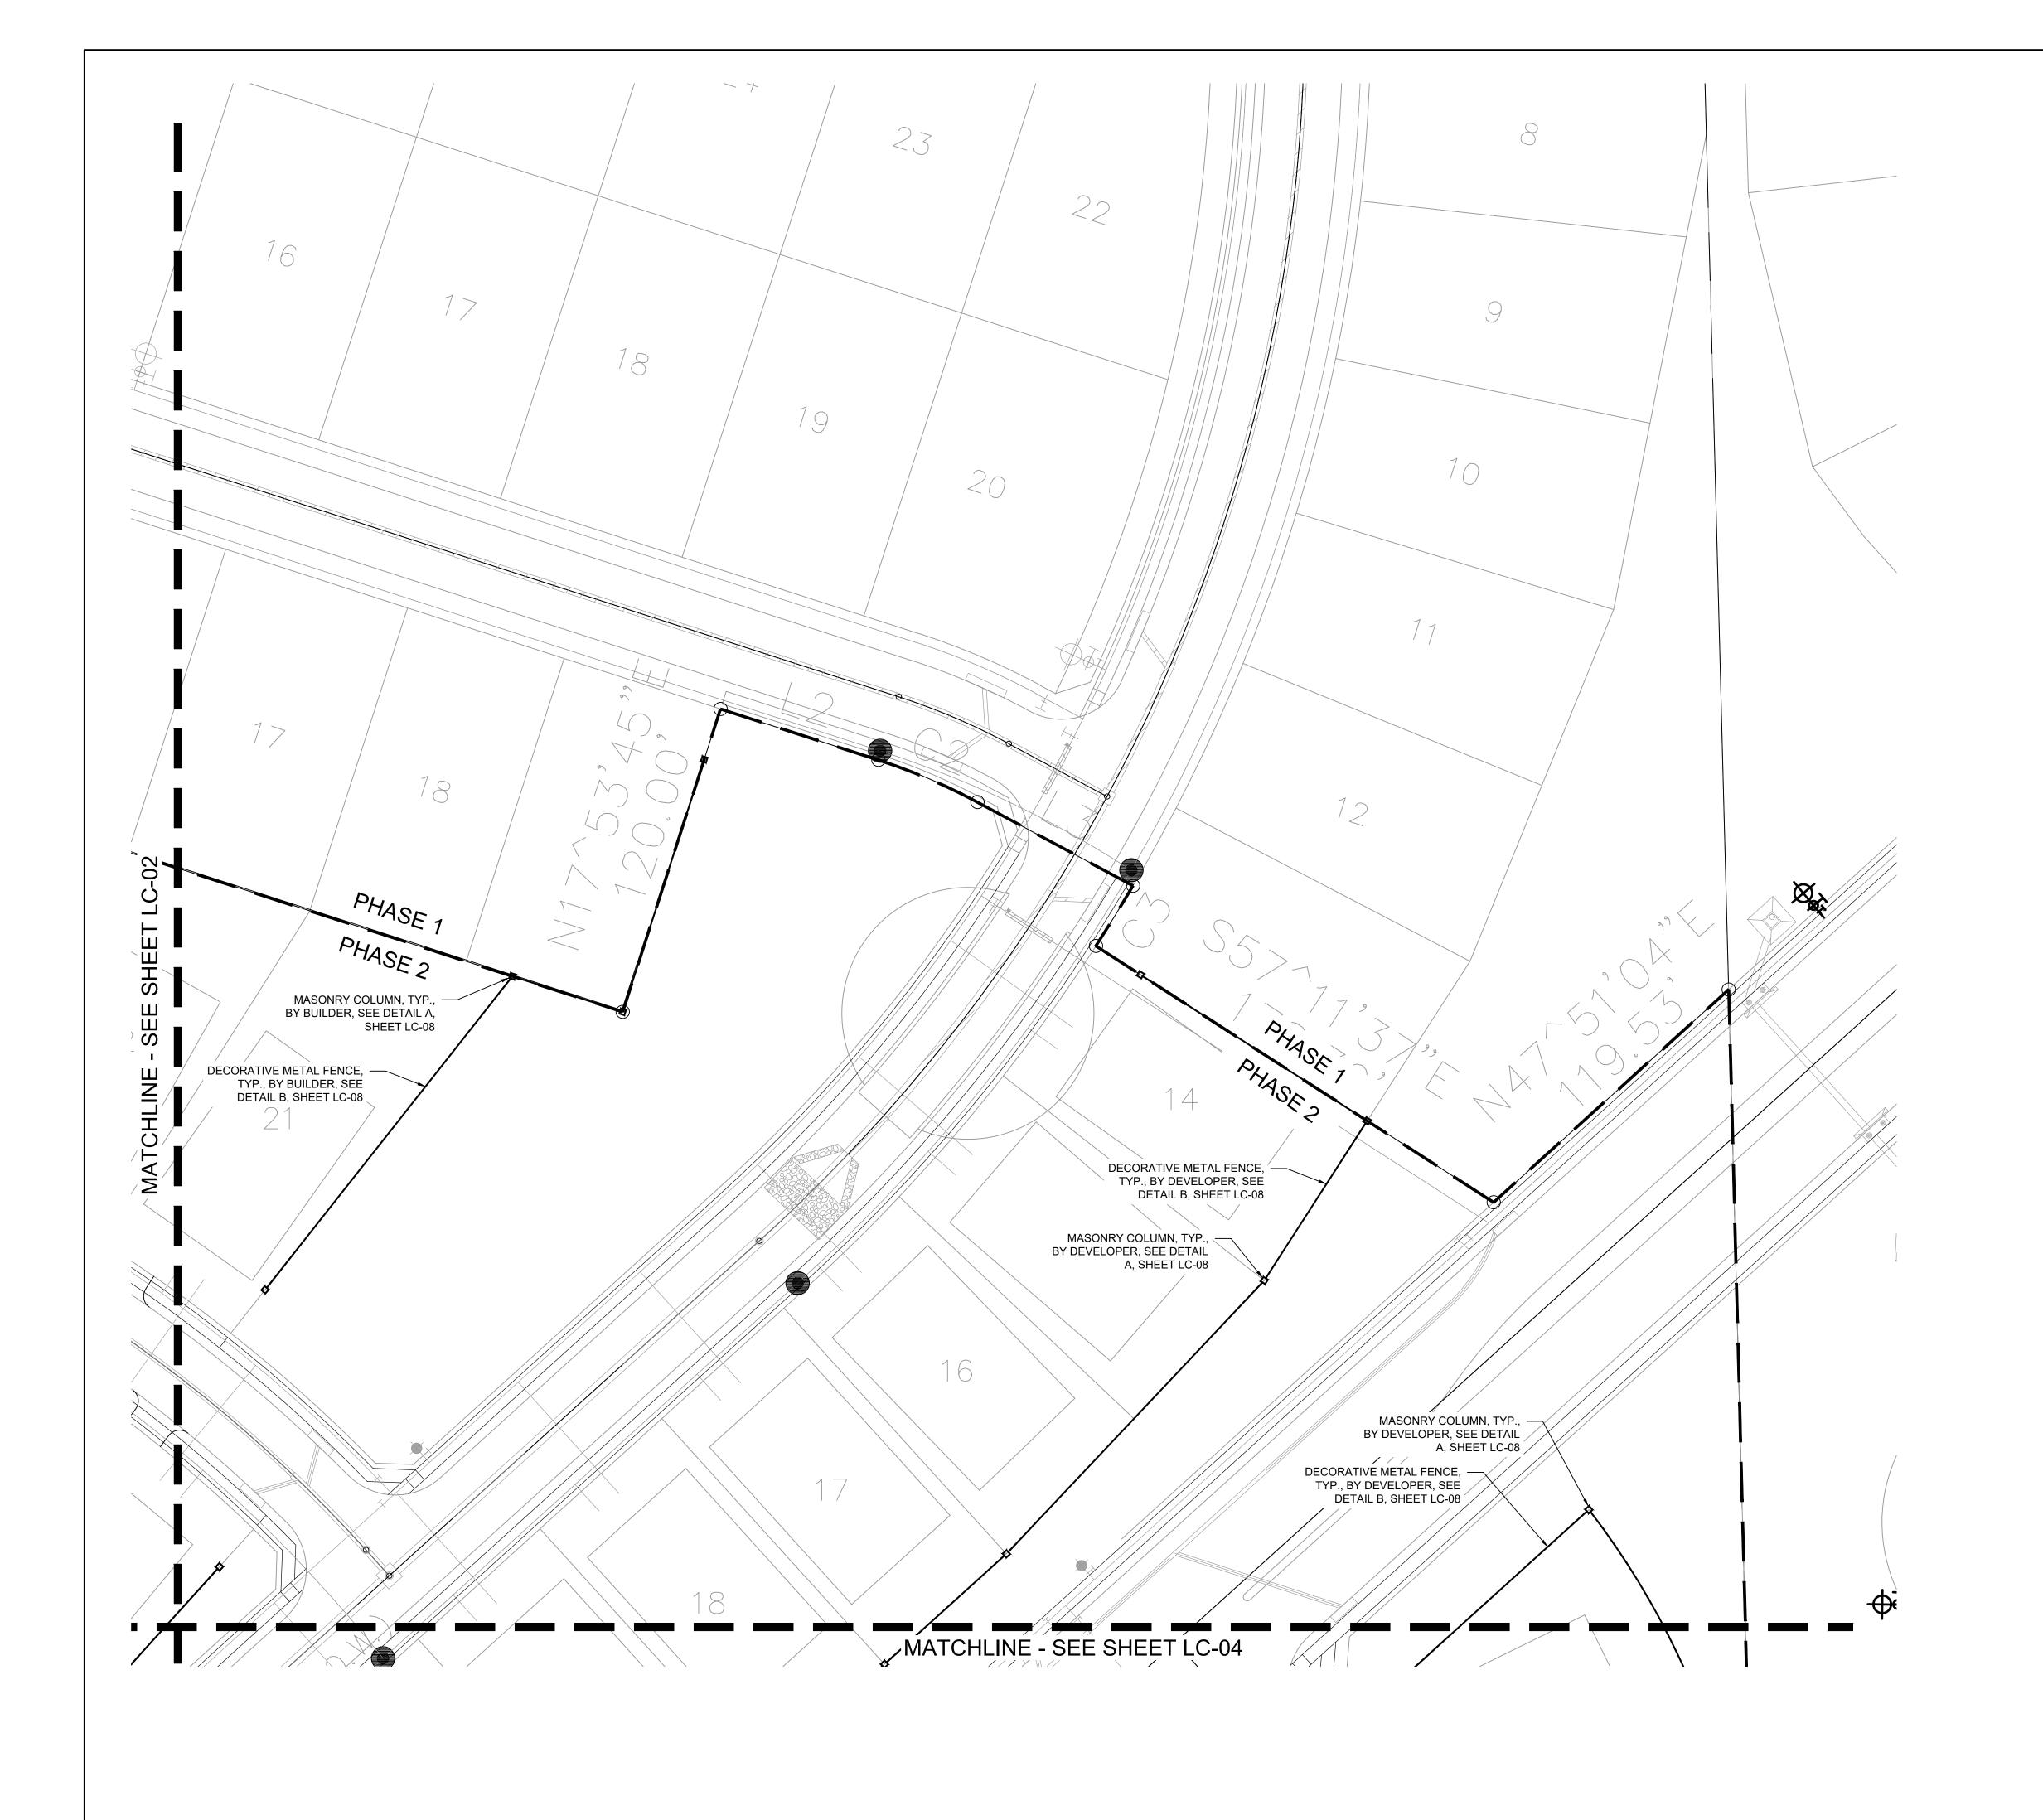
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- 4. PLAYGROUND EQUIPMENT, SEE DETAIL D, SHEET LC-08
- (5.) PLAYGROUND SAFETY SURFACING ENGINEERED WOOD MULCH; SEE DETAIL C, SHEET LC-08.
- 6. SWINGS, SEE DETAIL D, SHEET LC-08.

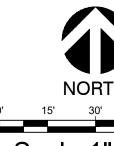SHEET LC-07.

- (7.) MULTI SPORT COURT. SEE DETAIL D, SHEET LC-07.
- 8. ADA RAMP. SEE DETAIL C, SHEET LC-07.
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MARY N. BATES TEXAS L.A. #3613

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Quail Hollow Rockwall, TX

HARDSCAPE PLAN


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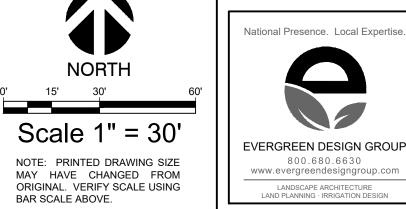
Project Number

 Date
 10/04/24

 Drawn By
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> > MARY N. BATES TEXAS L.A. #3613

MULCH; SEE DETAIL C, SHEET LC-08.

CONSTRUCTION LEGEND
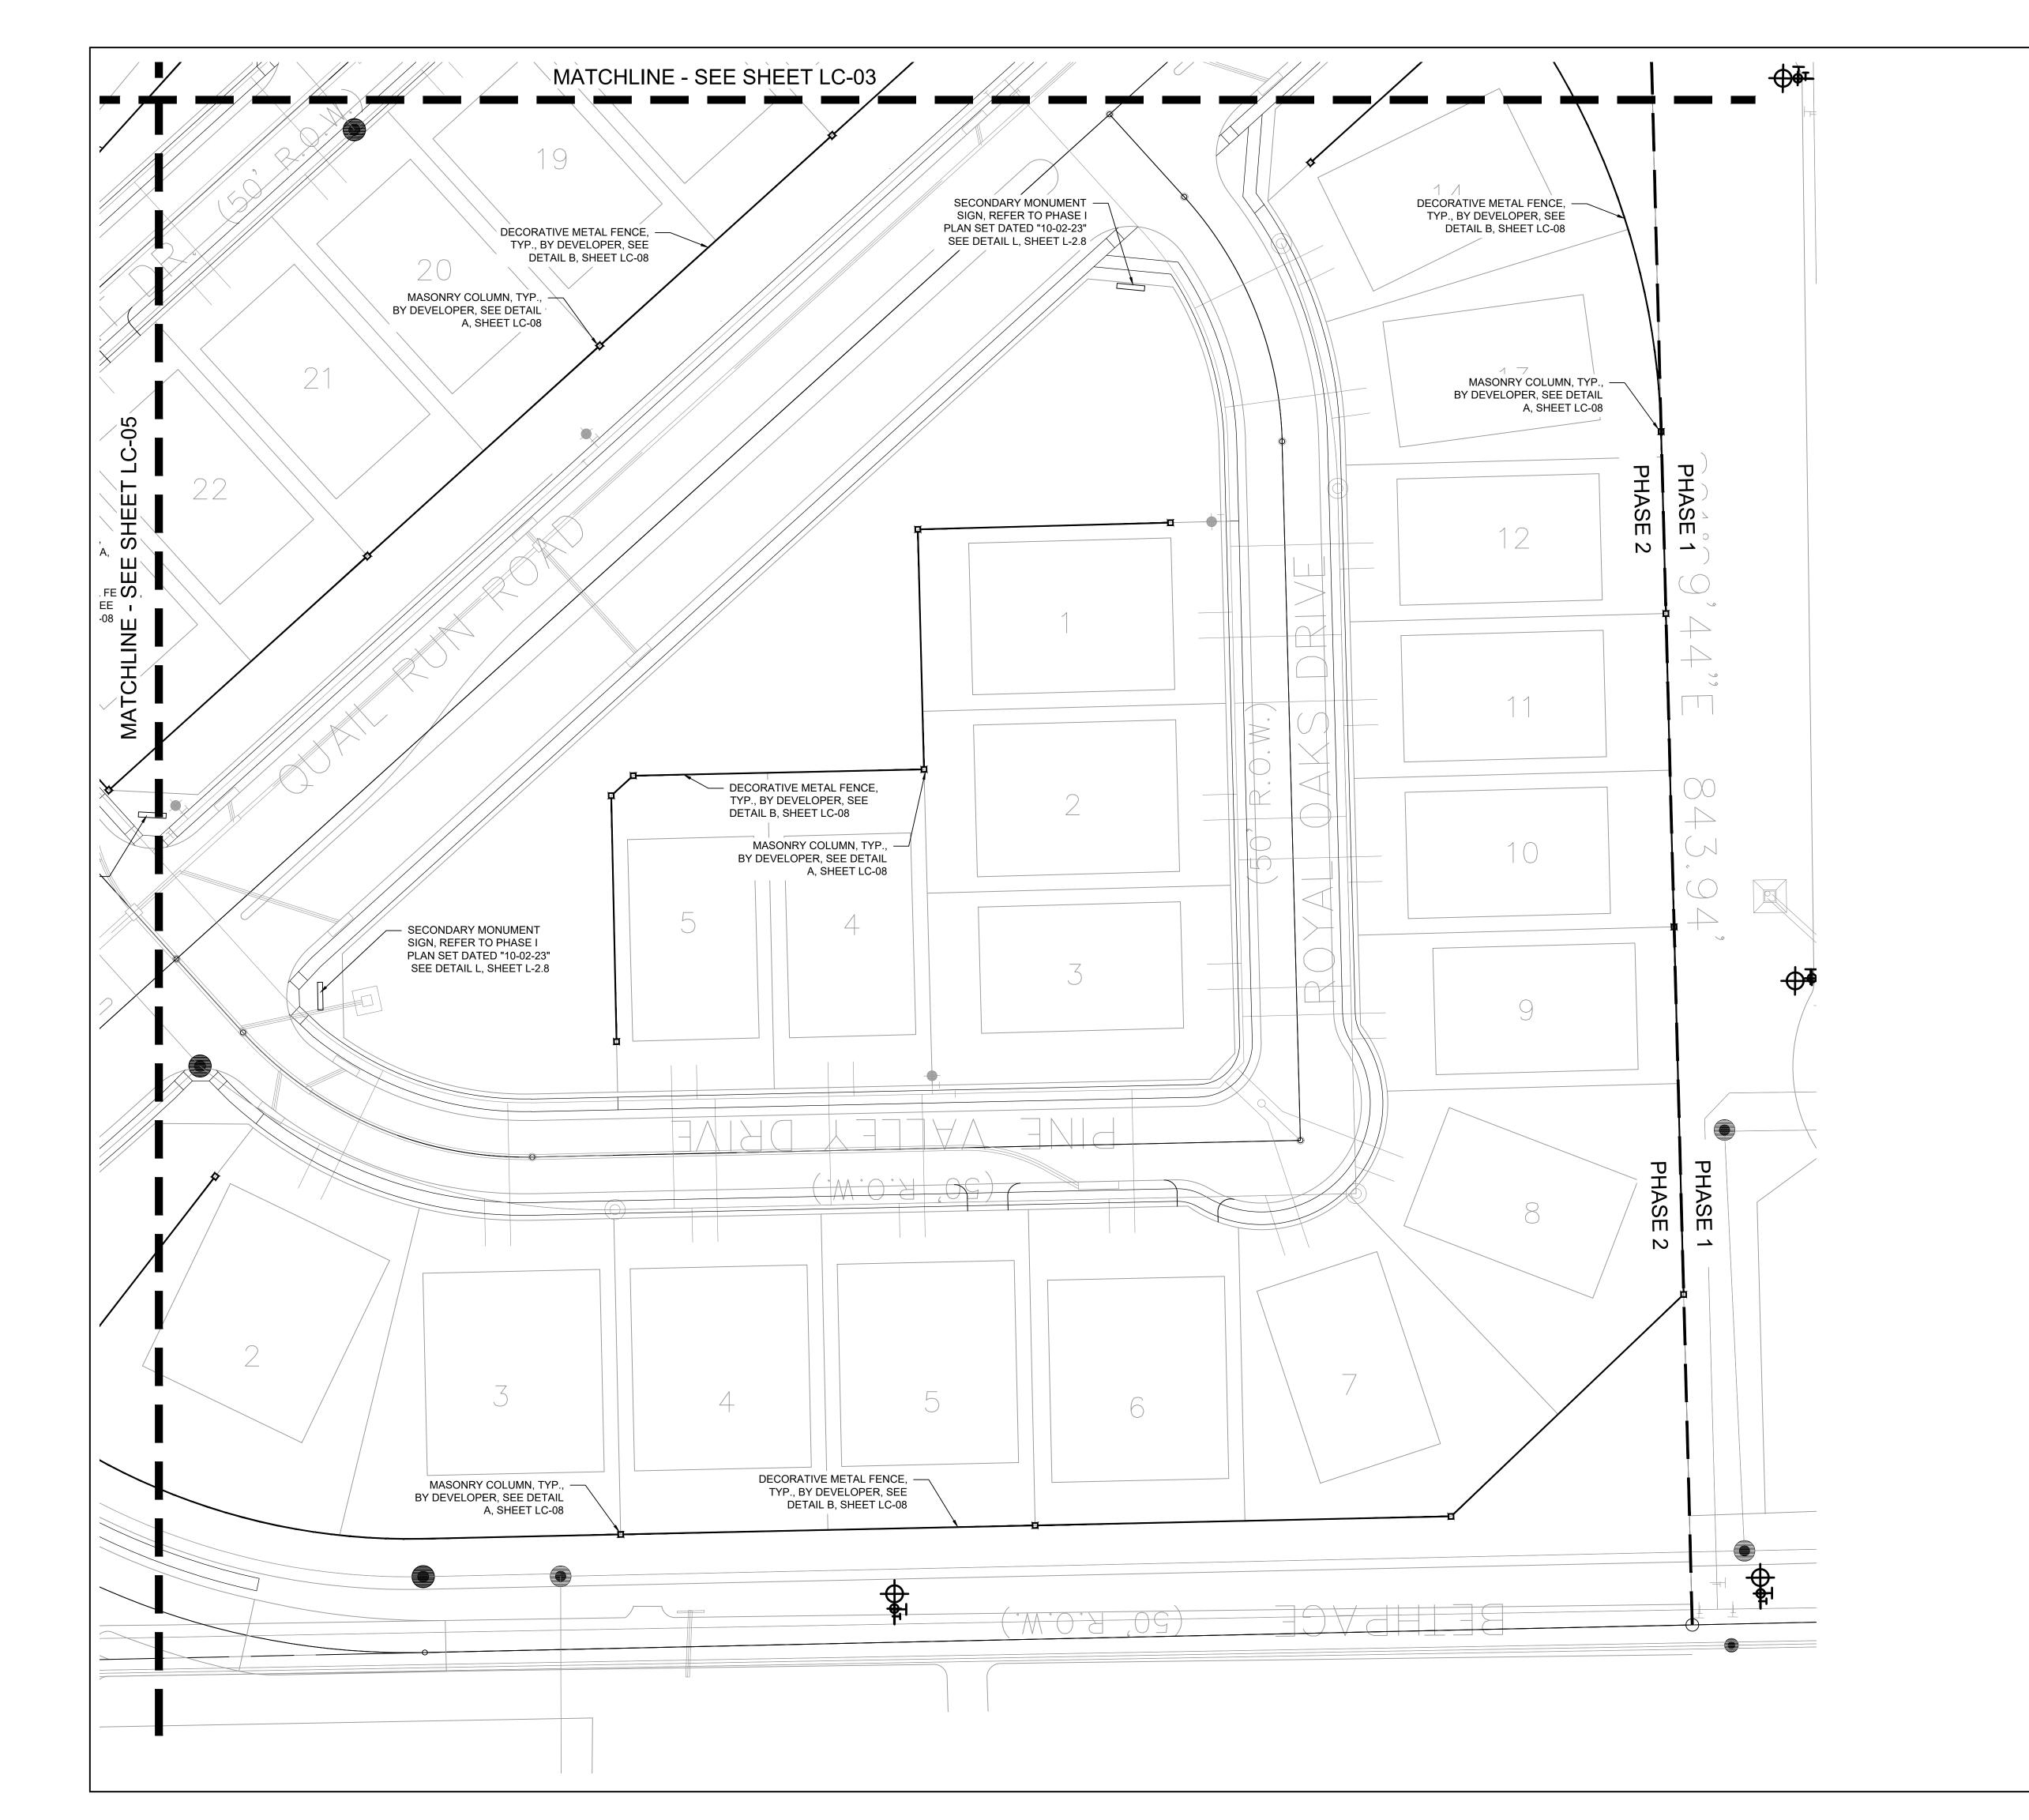
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3. 4" CONCRETE PAD, LIGHT BROOM FINISH, NATURAL GRAY

4.) PLAYGROUND EQUIPMENT, SEE DETAIL D, SHEET LC-08

(5.) PLAYGROUND SAFETY SURFACING - ENGINEERED WOOD

COLOR; W/ SAWCUT CONTROL JOINTS; SEE DETAIL B,

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(MASTER LIST - NOT ALL ITEMS ARE ON EVERY SHEET)

6.) SWINGS, SEE DETAIL D, SHEET LC-08. (7.) MULTI SPORT COURT. SEE DETAIL D, SHEET LC-07.

8.) ADA RAMP. SEE DETAIL C, SHEET LC-07.

(9.) PRIMARY COLUMN. SEE DETAIL A, SHEET LC-08.

SHEET LC-07.

(10.) WROUGHT IRON FENCE W/ MASONRY COLUMN. SEE DETAIL A, SHEET LC-08.

ISSUED ON:


OCTOBER 04, 2024


Quail Hollow Rockwall, TX

HARDSCAPE PLAN

Date Comment

10/04/24 Drawn By

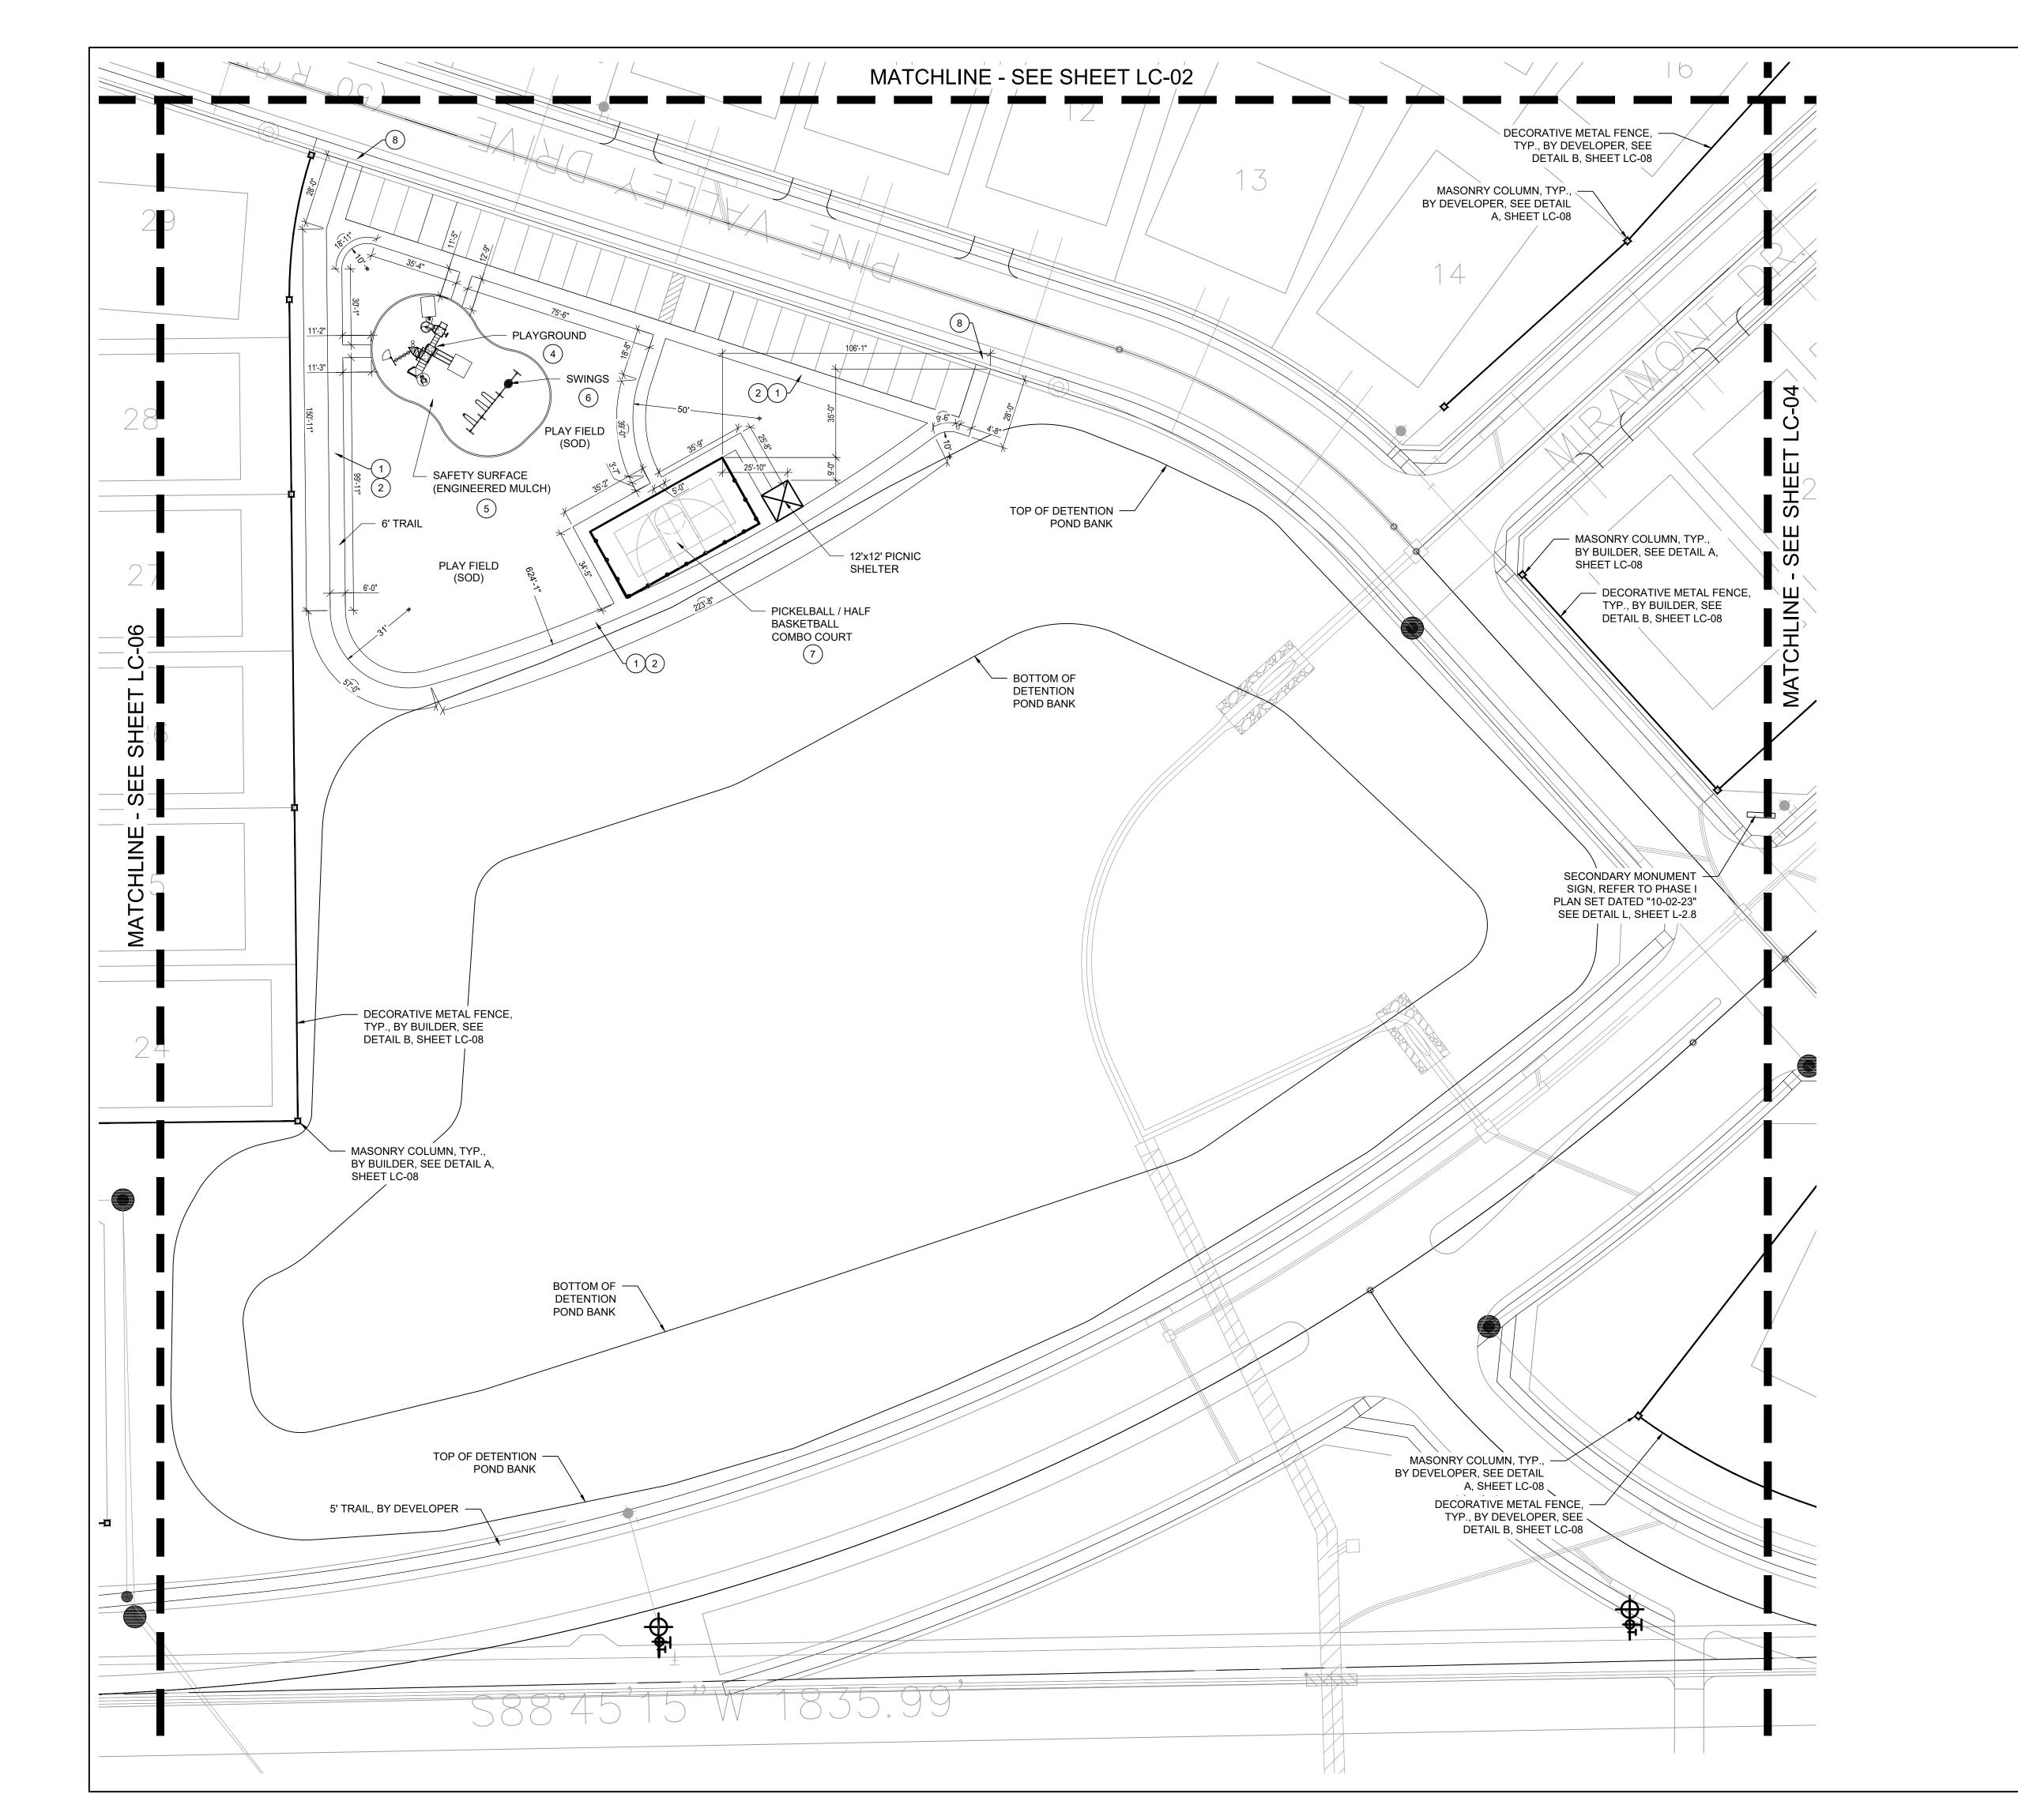

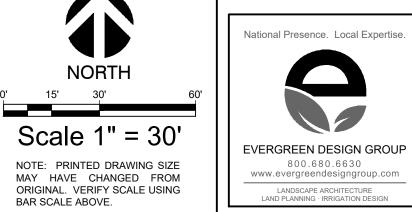

CONSTRUCTION LEGEND (MASTER LIST - NOT ALL ITEMS ARE ON EVERY SHEET)

SHEET LC-07.

4-IN THK. CONCRETE WALK, LIGHT BROOM FINISH, NATURAL GRAY COLOR; SEE DETAIL B, SHEET LC-07.

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(7.) MULTI SPORT COURT. SEE DETAIL D, SHEET LC-07.

(9.) PRIMARY COLUMN. SEE DETAIL A, SHEET LC-08.

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MULCH; SEE DETAIL C, SHEET LC-08.

6.) SWINGS, SEE DETAIL D, SHEET LC-08.

8.) ADA RAMP. SEE DETAIL C, SHEET LC-07.

COLOR; W/ SAWCUT CONTROL JOINTS; SEE DETAIL B,

EXPANSION JOINT WITH COLOR CAULK TO MATCH ADJACENT PAVEMENT. SEE DETAIL A, SHEET LC-07.

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> MARY N. BATES TEXAS L.A. #3613

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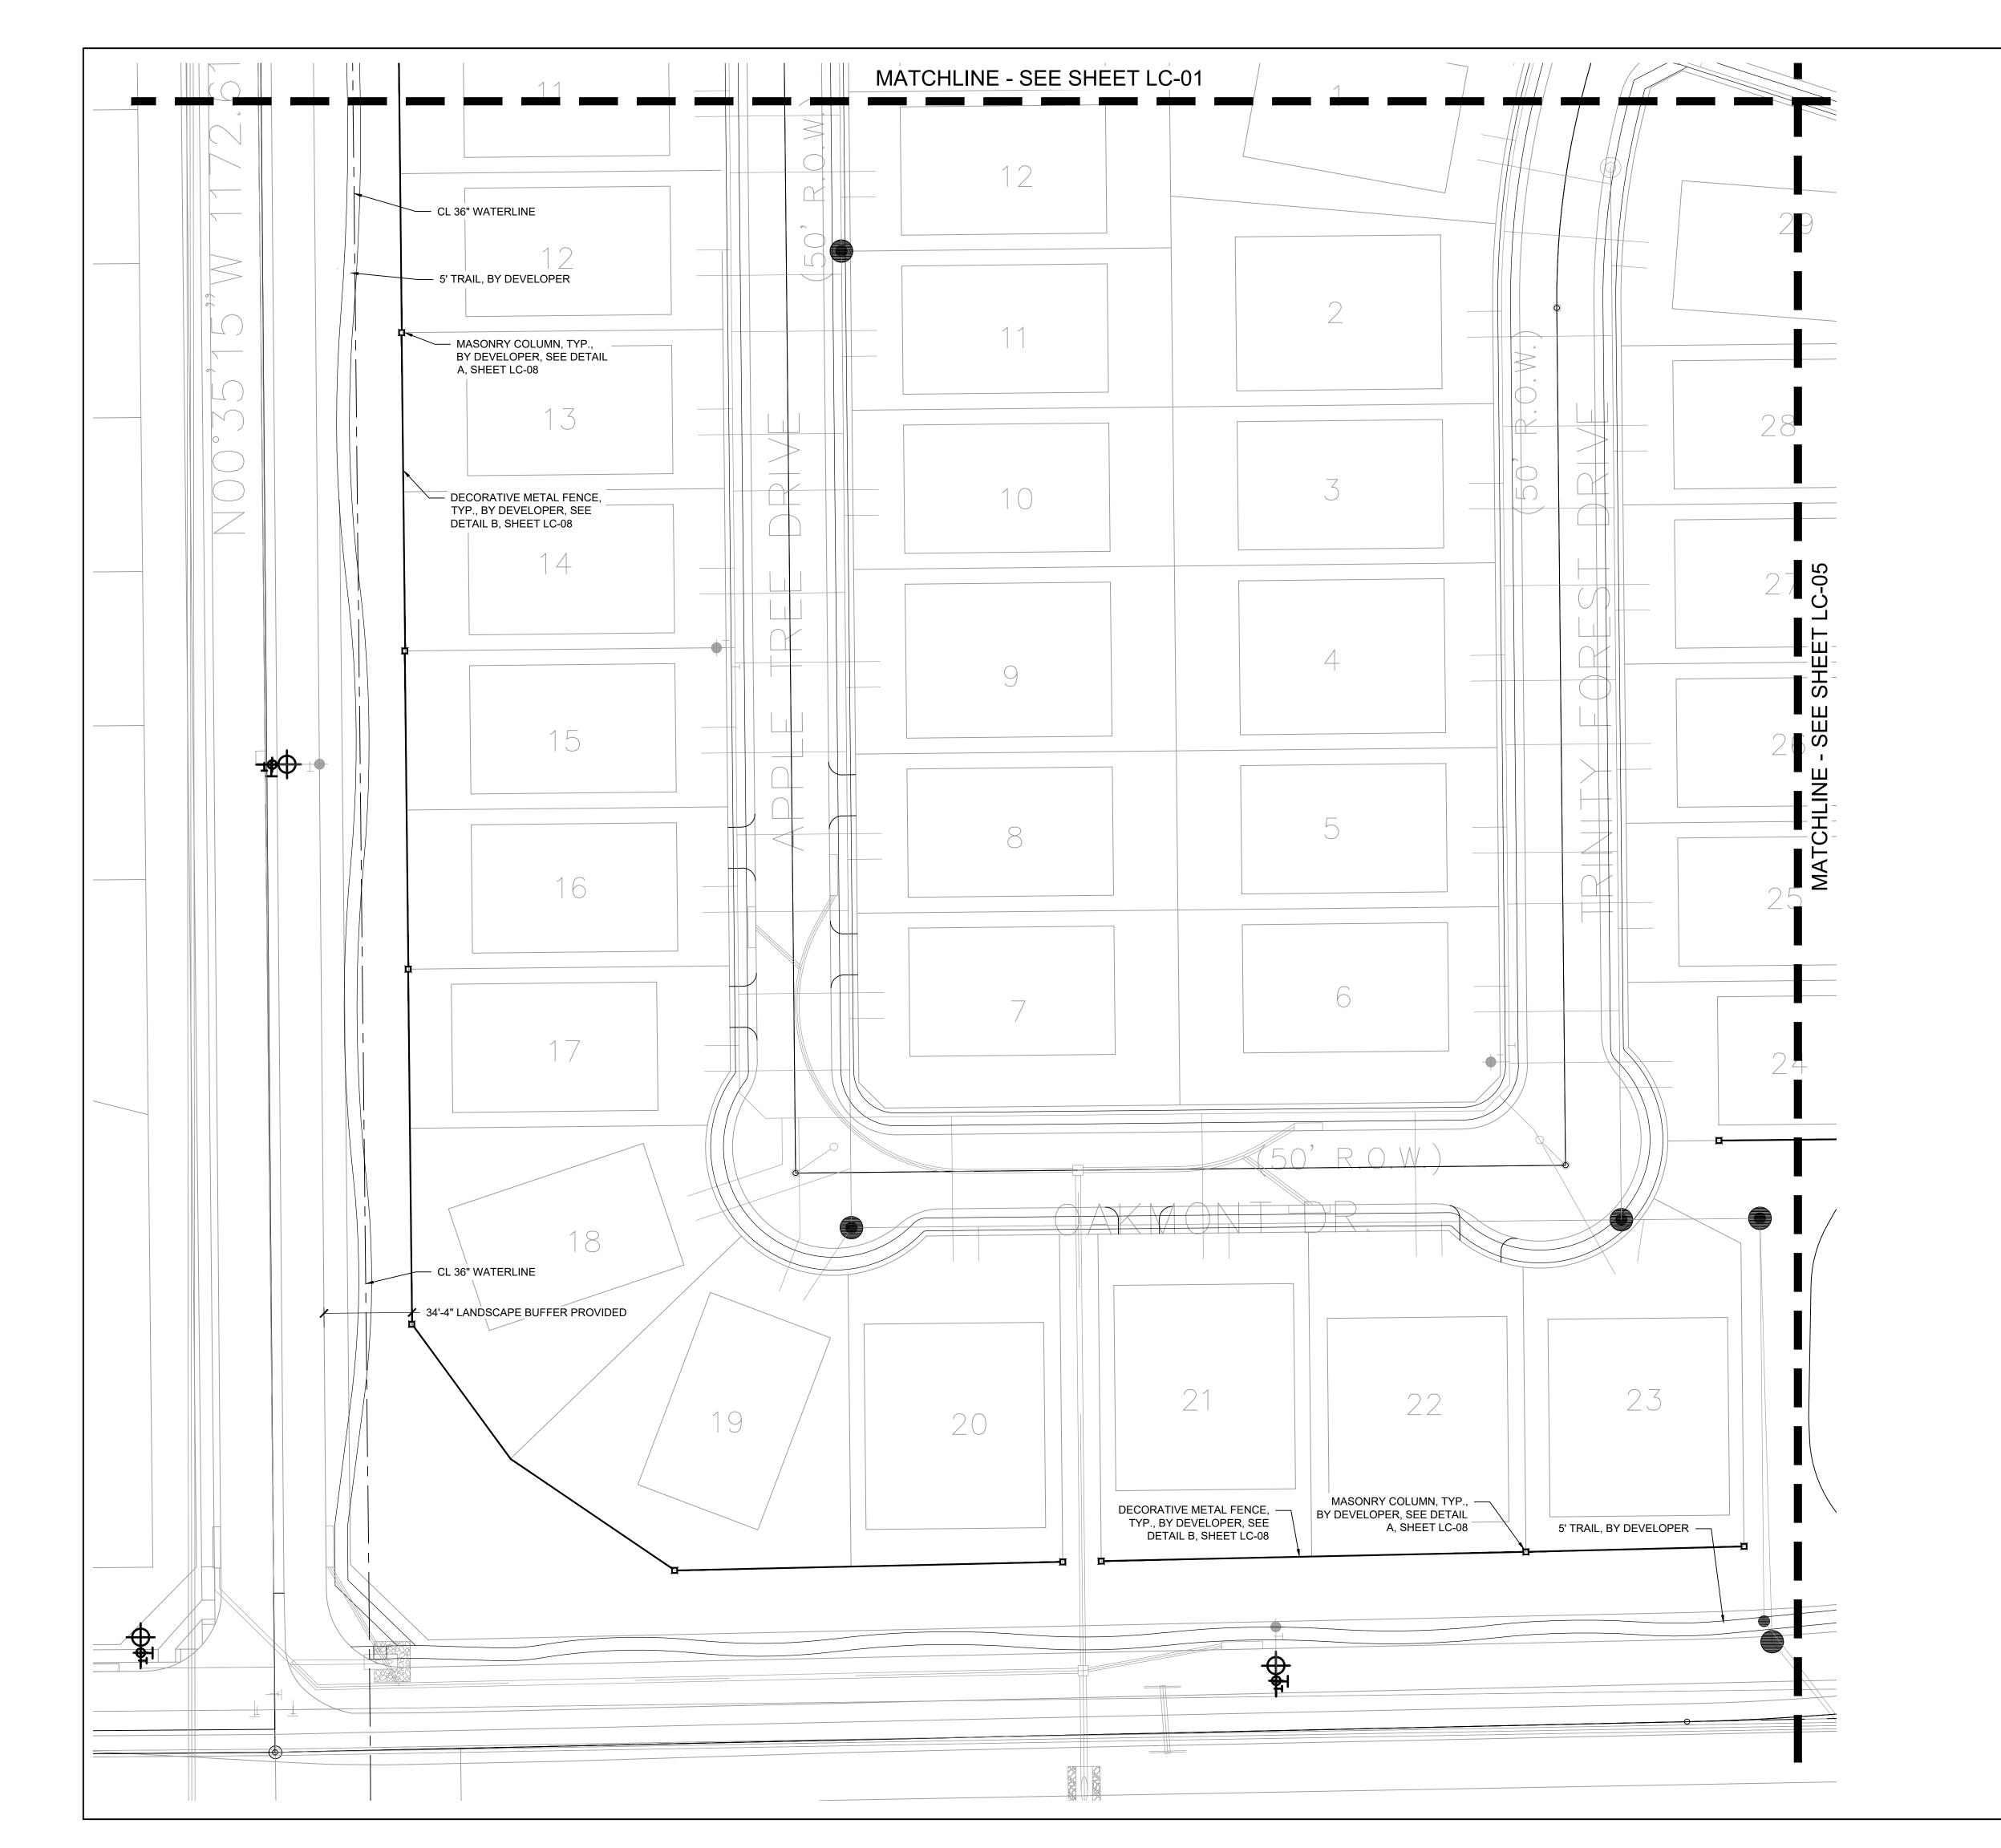
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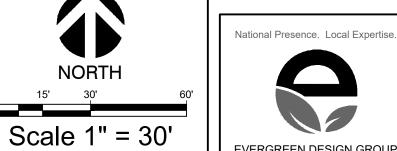
Hollow Quail Rockwall,

HARDSCAPE PLAN

Date Comment

10/04/24 Drawn By





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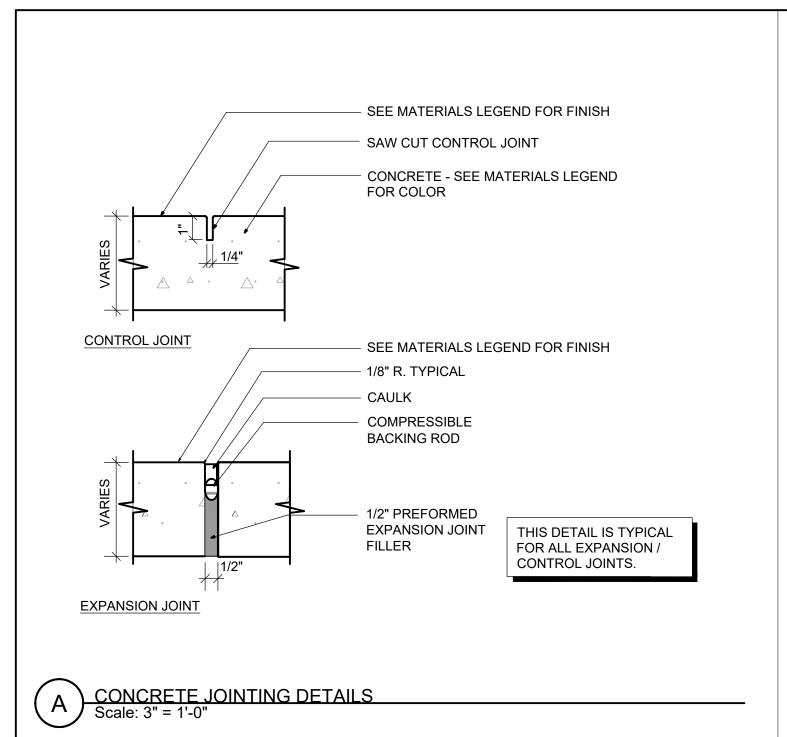
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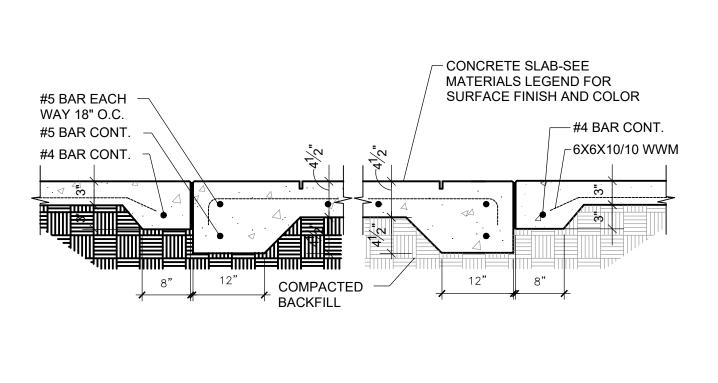
Skol 8214 w Dallas,

Quail Hollow Rockwall, TX


HARDSCAPE PLAN

Date Comment





B CONCRETE PAVEMENT - LIGHT DUTY
Scale: 3/4" = 1'-0"

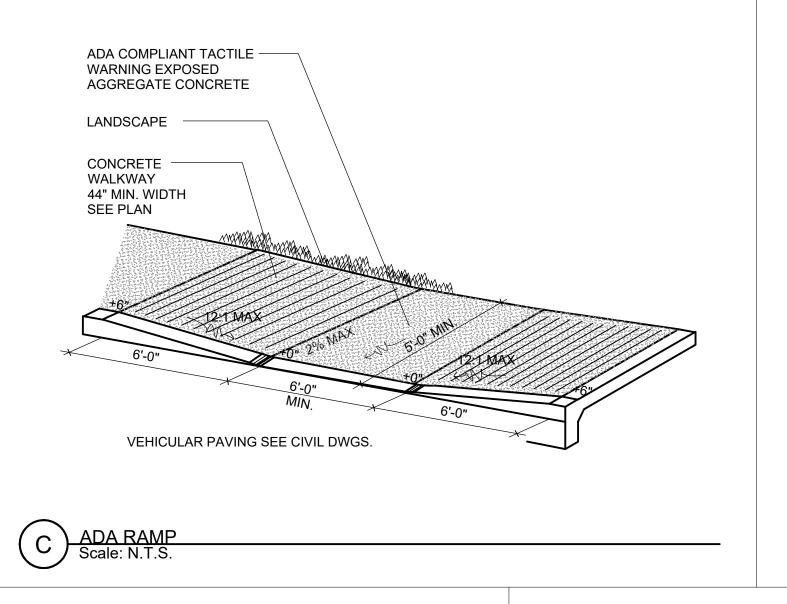



COURT BUILDER "



MANUFACTURER: SPORT COURT SUPPLIER: NEXCOURT CONTACT: CHRIS WALKER PHONE: 972-898-7529 COLORS: TBD OPTIONS: 30'X60' MULTI-SPORT COURT, 1/2 BASKETBALL, PICKLEBALL, 2 SINGLE LIGHTS, FULL 3 SIDES BLACK VINYL COATED CHAIN LINK FENCE BACKSTOP PICKLE BALL COURT FENCE NOTE: 8' HIGH FENCE AT REAR OF COURT. 4' HIGH FENCE AT SIDES OF COURT.



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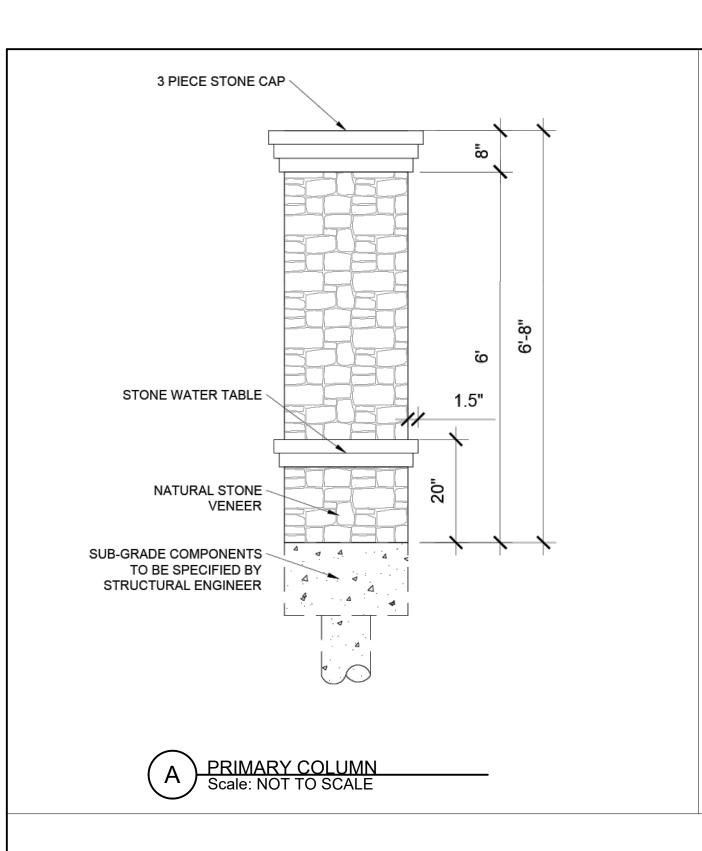
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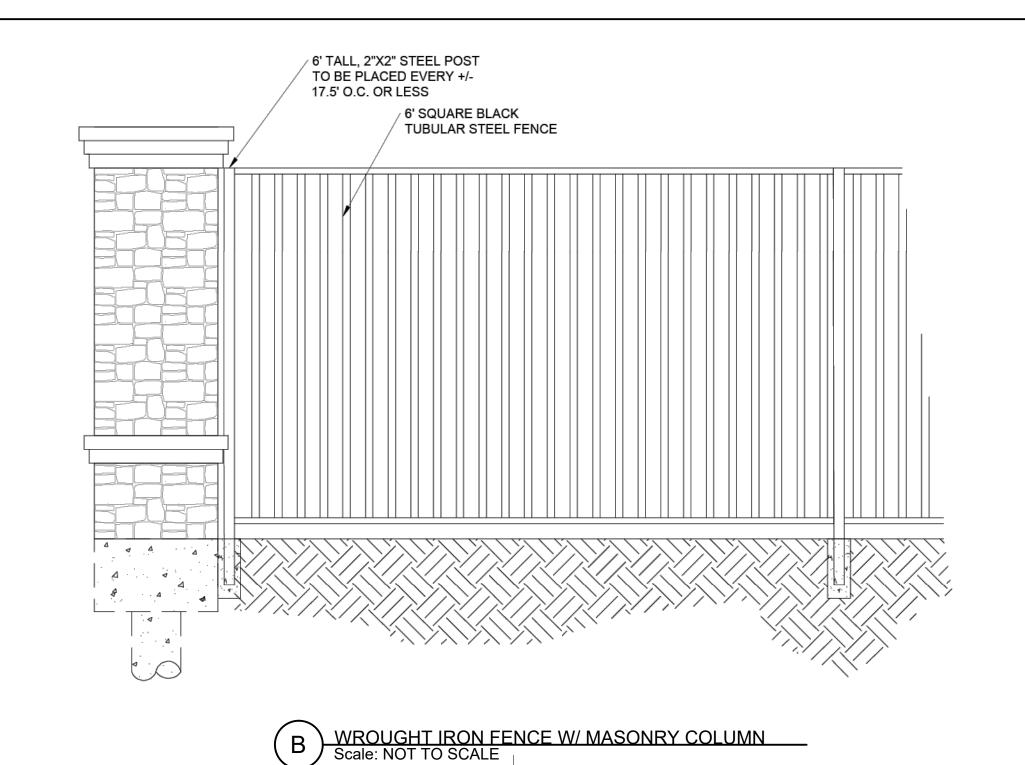
Comparie Drive, Suite Skorburg (8214 Westchester I Dallas, Texas 75225

Hollow LTX Quail Rockwall,

HARDSCAPE **DETAILS**

Date Comment





— ACCESSIBLE CONCRETE RAMP INSIDE EDGE OF RAMP -----FIBAR® WOOD FIBER MUST FALL OUTSIDE ASTM USE ZONE ← FIBAR® WOOD FIBER SLOPE>1% ABOVE GROUND INSTALLATION ABOVE GROUND INSTALLATION ACCESSIBILITY DETAIL

1. INSTALLATION TO BE COMPLETED IN ACCORDANCE WITH MANUFACTURER'S SPECIFICATIONS.

2. DO NOT SCALE DRAWING. 3. THIS DRAWING IS INTENDED FOR USE BY ARCHITECTS, ENGINEERS, CONTRACTORS, CONSULTANTS AND DESIGN PROFESSIONALS

FOR PLANNING PURPOSES ONLY. THIS DRAWING MAY NOT BE USED FOR CONSTRUCTION. 4. ALL INFORMATION CONTAINED HEREIN WAS CURRENT AT THE TIME OF DEVELOPMENT BUT MUST BE REVIEWED AND APPROVED BY

THE PRODUCT MANUFACTURER TO BE CONSIDERED ACCURATE. 5. CONTRACTOR'S NOTE: FOR PRODUCT AND COMPANY INFORMATION VISIT www.CADdetails.com/info AND ENTER

THE FIBAR GROUP LLC 80 BUSINESS PARK DRIVE, SUITE 300 ARMONK, NY 10504 TOLL FREE: 1-800-342-2721 PHONE: (914) 273-8770 FAX: (914) 273-8659

www.fibar.com

ENGINEERED WOOD FIBER PLAYGROUND SAFETY SURFACING
Scale: NOT TO SCALE



MANUFACTURER: LITTLE TYKES SUPPLIER: LEA PARK & PLAY PHONE: (972) 690-8163 COLORS: TBD MODEL: R0306_45555298831



NOTES:

1. INSTALL ALL SHELTER ELEMENTS PER
MANUFACTURER'S RECOMMENDATIONS.

2. CONTRACTOR TO PROVIDE SIGNED AND SEALED
STRUCTURAL DRAWINGS FOR REVIEW PRIOR TO INSTALLATION. INSTALL WITH 12'X20' (4") CONCRETE SLAB.

MODEL: 12' X 12' NAVAJO SHELTER MANUFACTURER: AMERICANA BUILDING PRODUCTS CONTACT: LEA PARK & PLAY NICK BOLLIG, (940) 205-2761

SHELTER DETAILS



NOTES:

1. SURFACE MOUNT TO SHELTER SLAB

2. SUBMIT COLORS TO MATCH PLAYGROUND EQUIPMENT FOR APPROVAL PRIOR TO ORDERING.

MODEL: 8' RECTANGULAR EXPANDED STEEL ADA TABLE MANUFACTURER: ANOVA CONTACT: LEA PARK & PLAY NICK BOLLIG, (940) 205-2761

PICNIC TABLE



NOTES:

1. SURFACE MOUNT TO 4" CONCRETE SLAB
2. SUBMIT COLORS TO MATCH PLAYGROUND
EQUIPMENT FOR APPROVAL PRIOR TO ORDERING.

SCALE: NOT TO SCALE

NICK BOLLIG, (940) 205-2761

MODEL: 6' LATITUDE CONTOUR BENCH MANUFACTURER: ANOVA CONTACT: LEA PARK & PLAY

National Presence. Local Expertise EVERGREEN DESIGN GROUP 800.680.6630 www.evergreendesigngroup.com

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ISSUED ON: OCTOBER 04, 2024


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HARDSCAPE DETAILS

Date Comment

Project Number

10/04/24 Drawn By Checked By



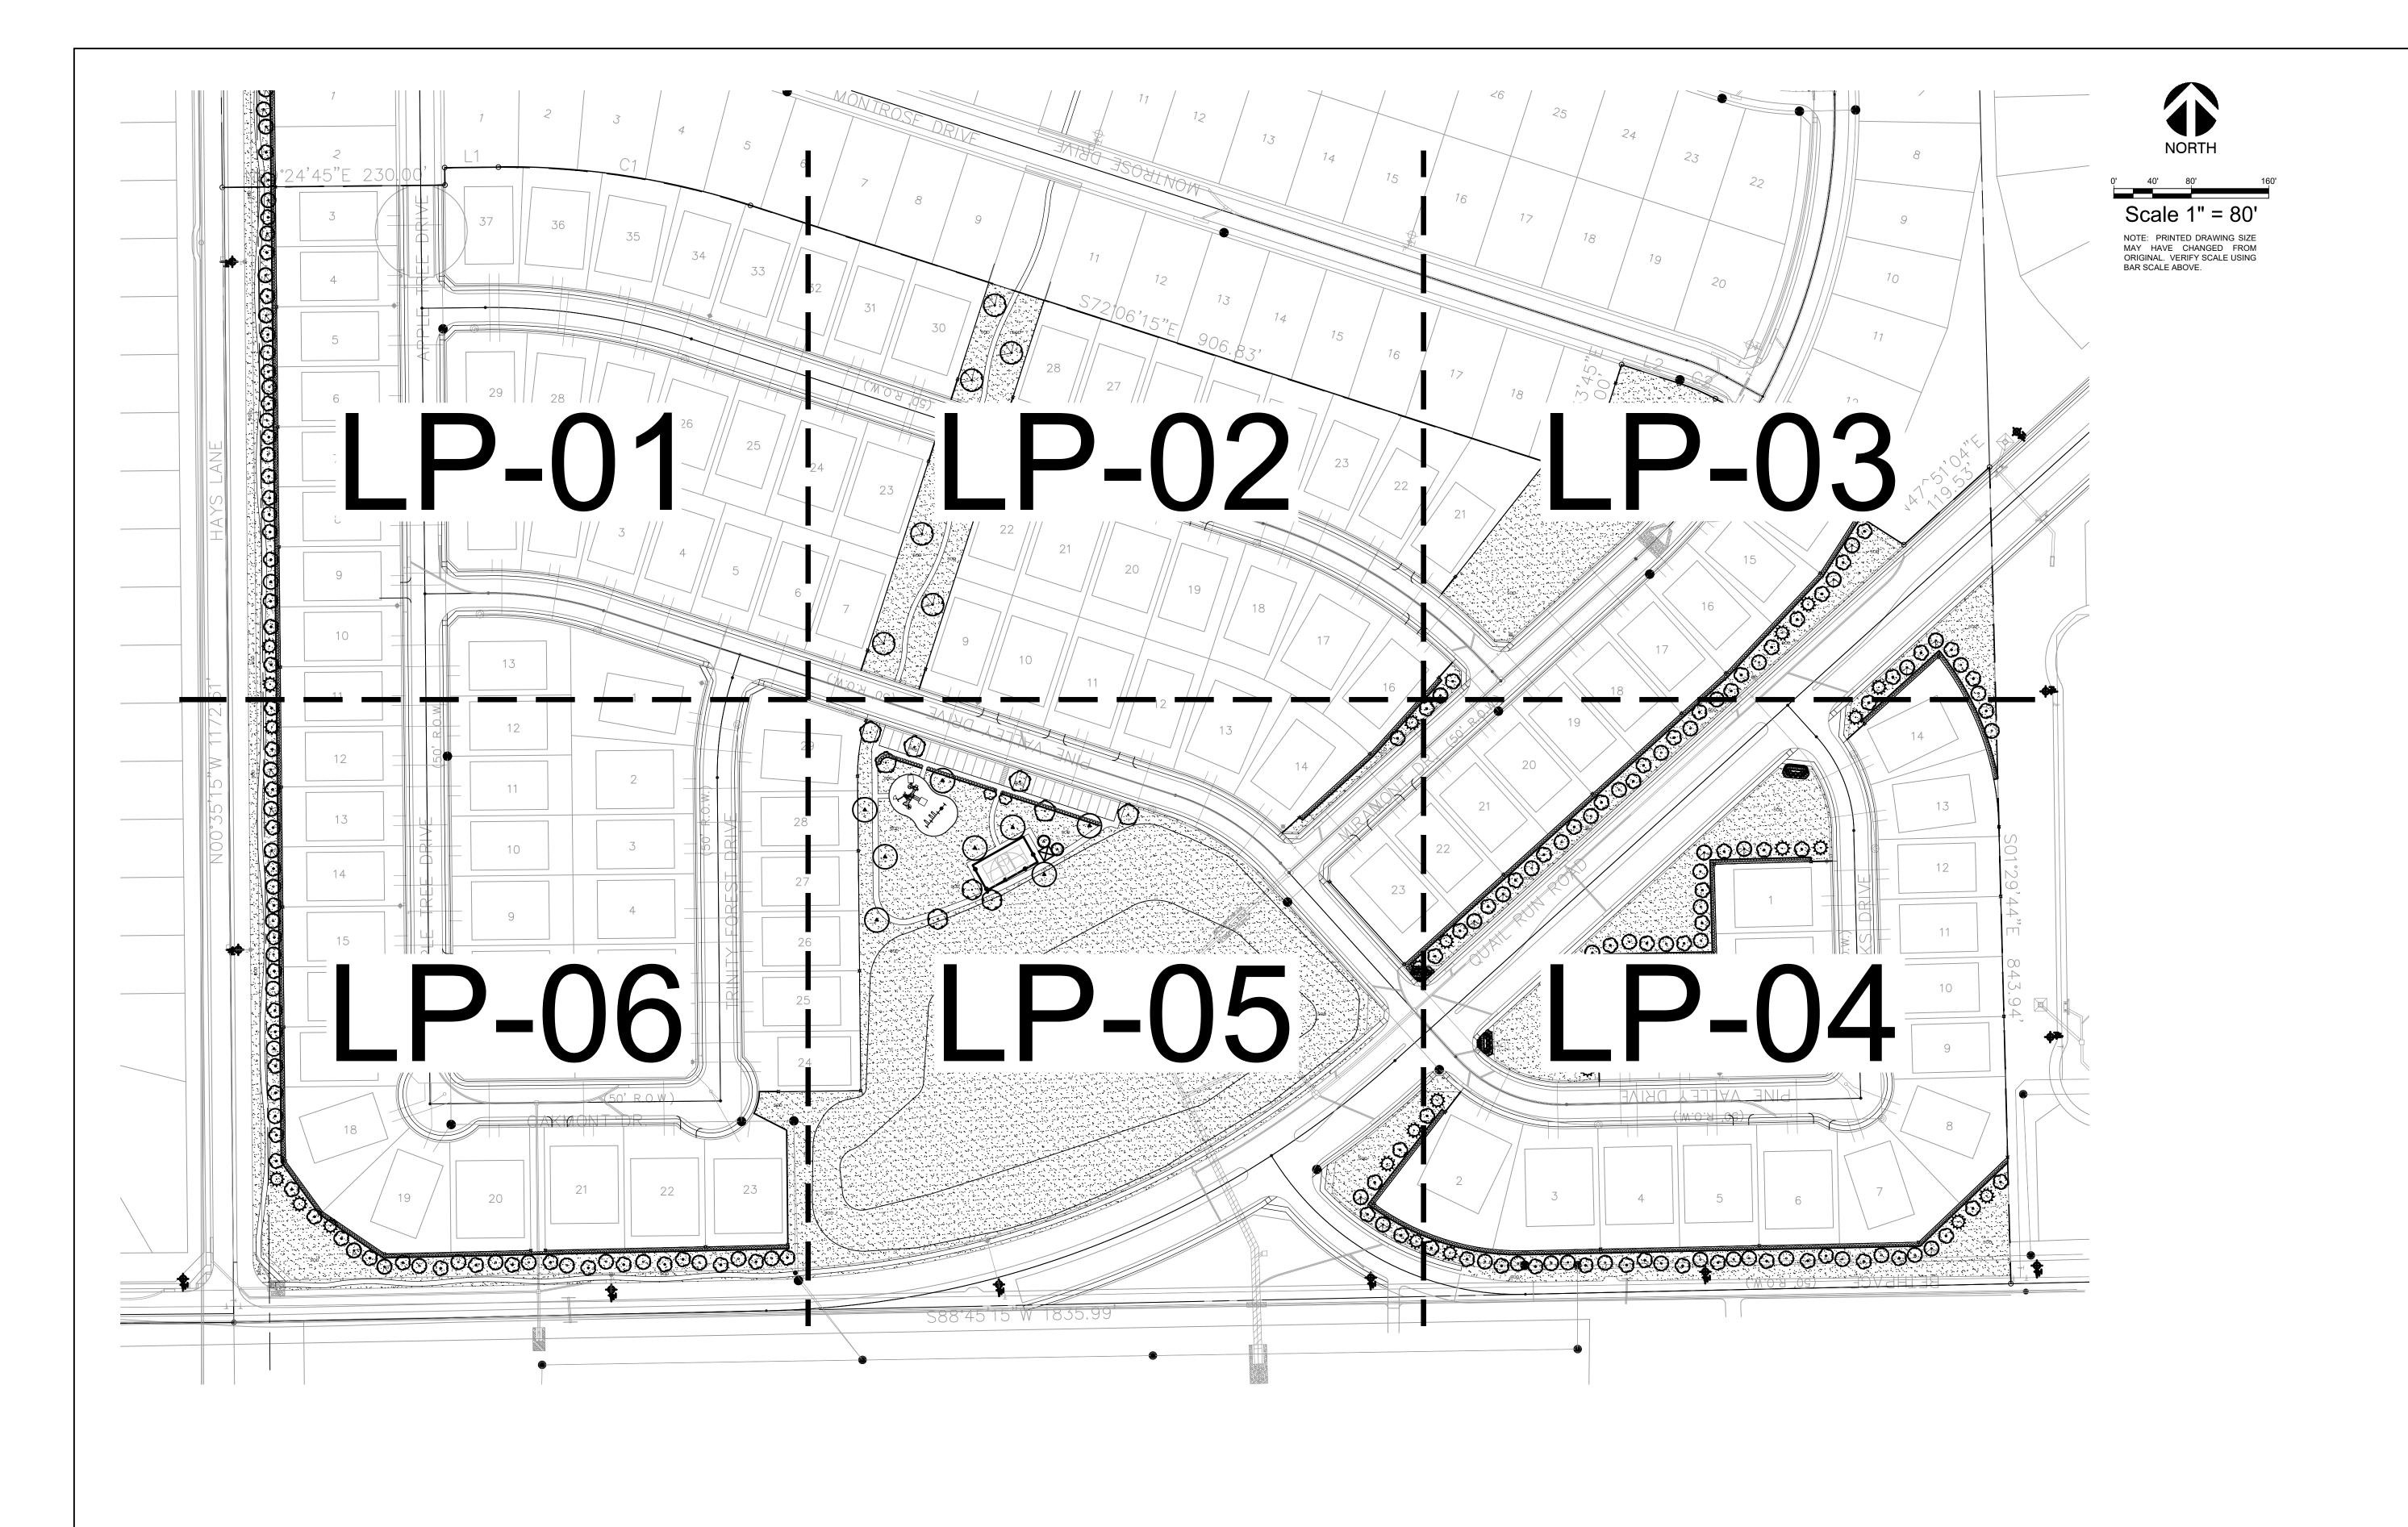

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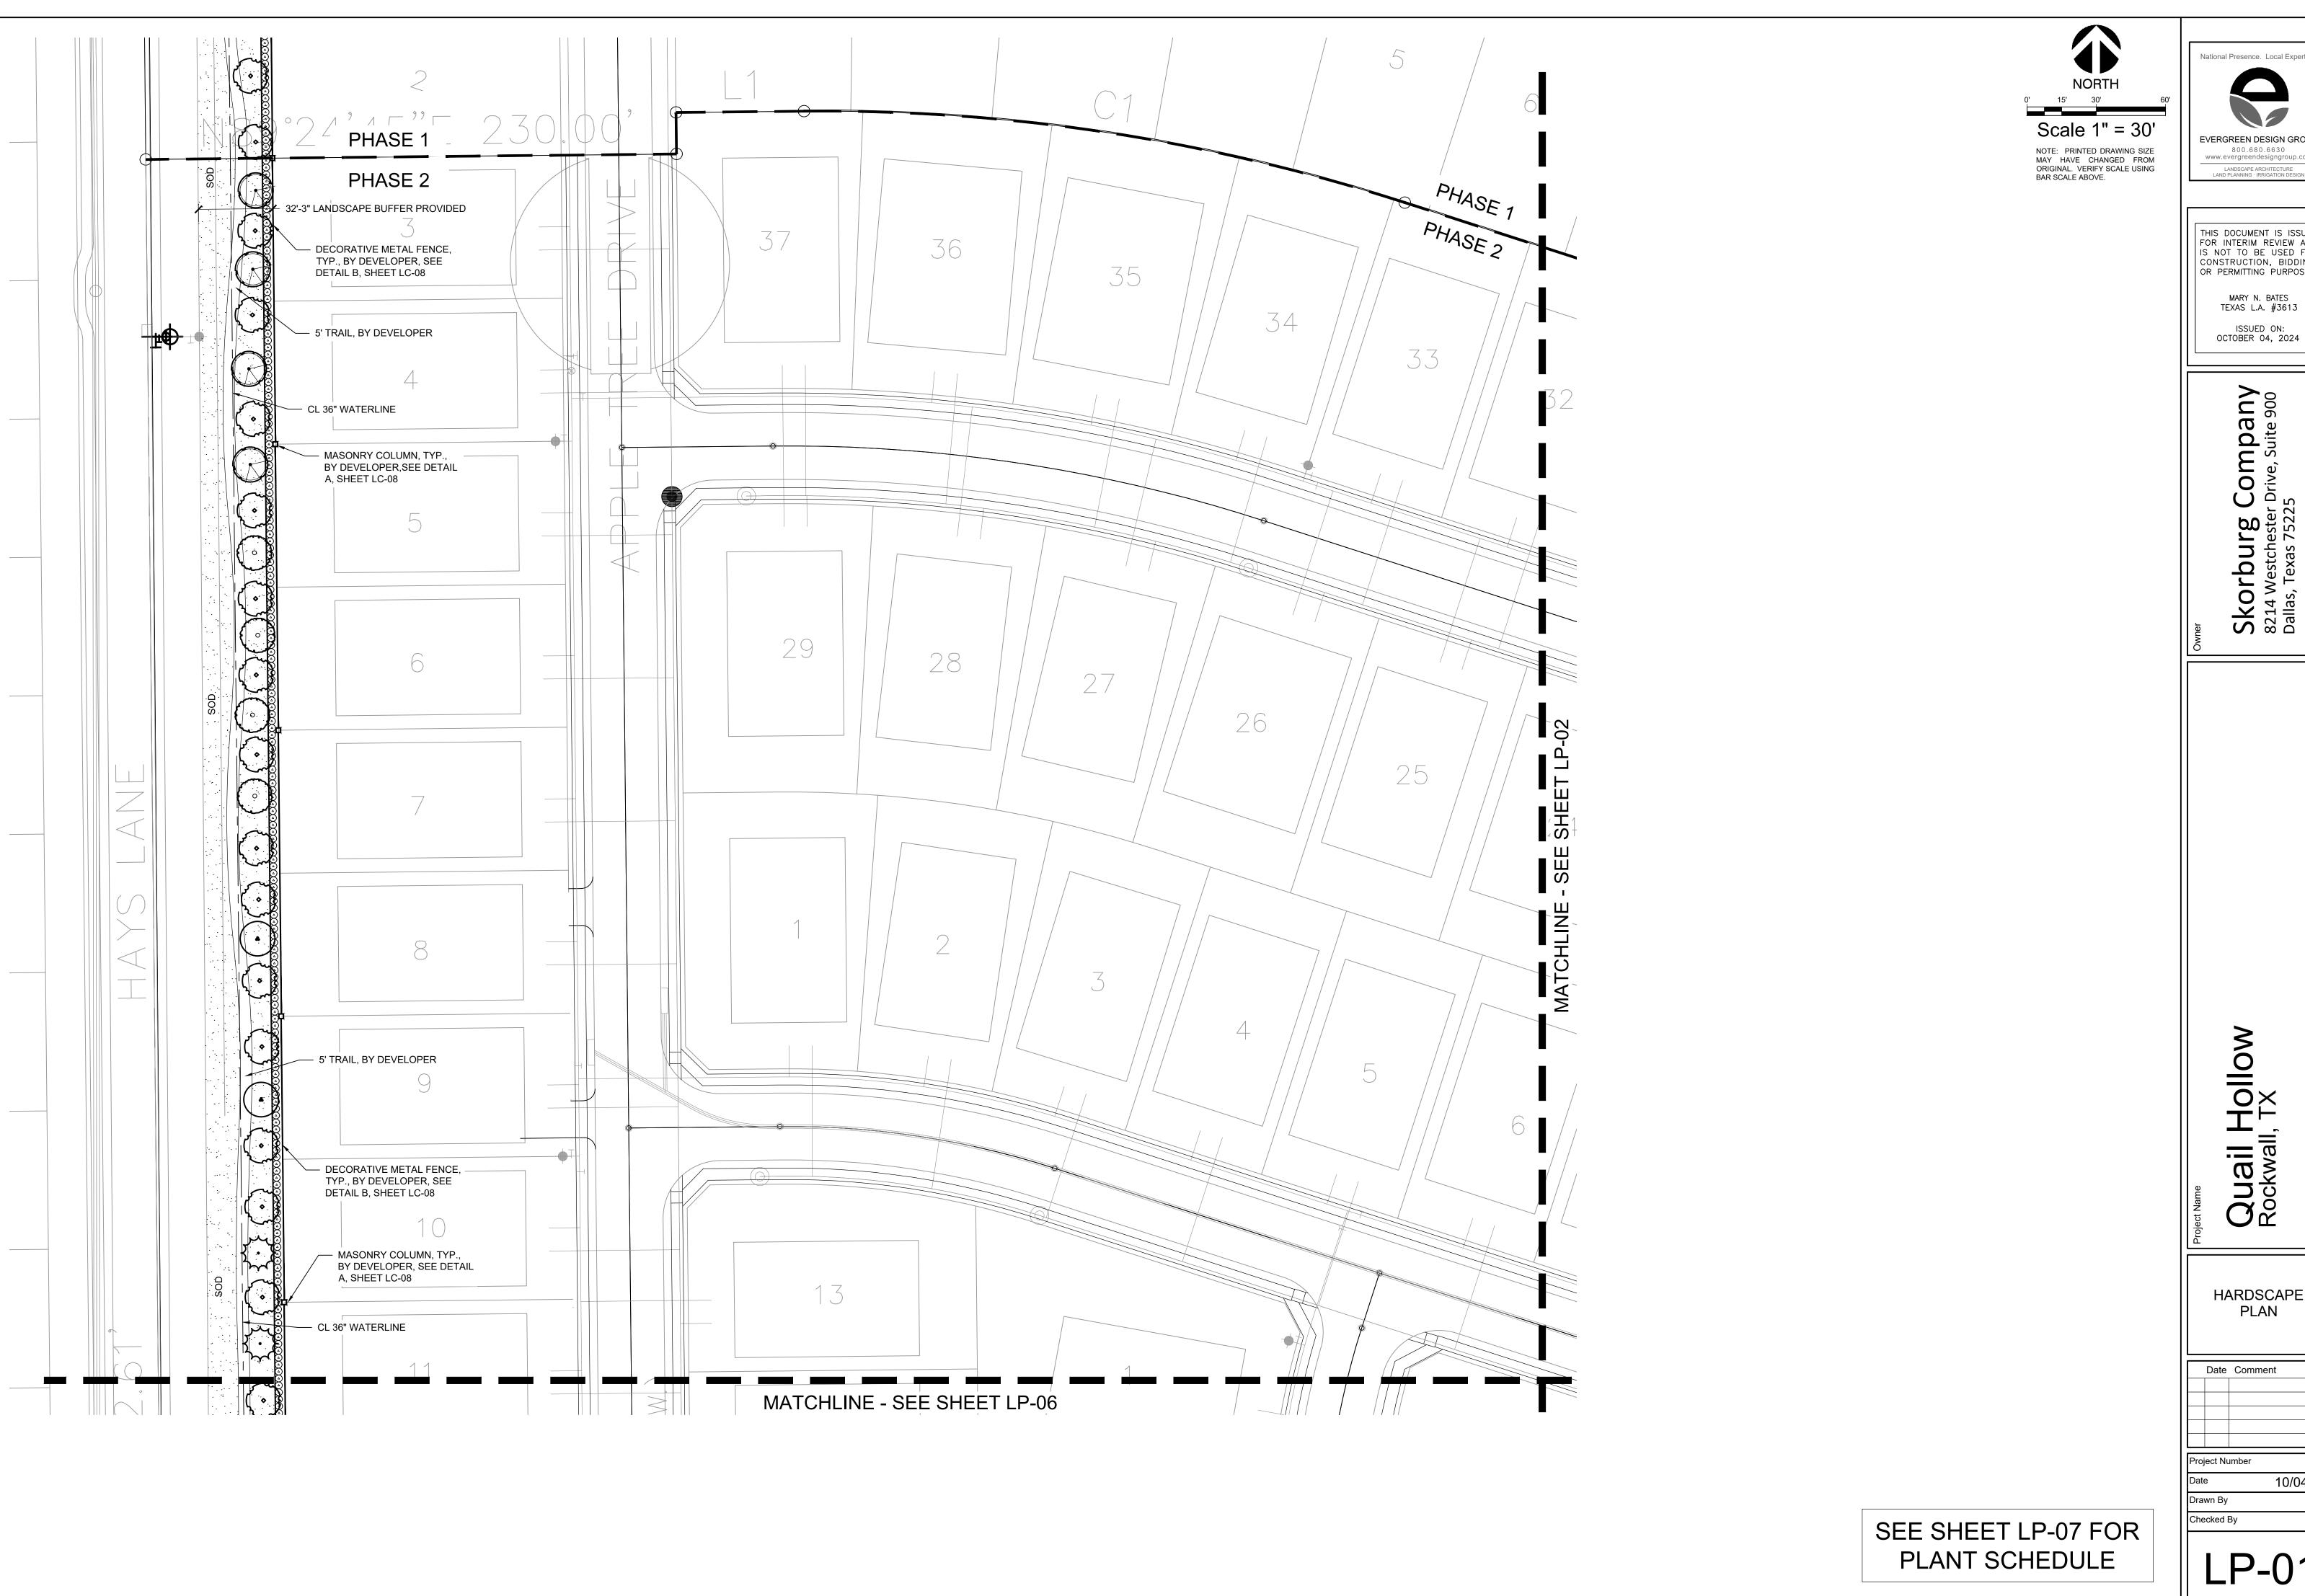
mpal ,e, Suite 9 CO r Drive Skorburg (8214 Westchester | Dallas, Texas 75225

Quail Hollow Rockwall, TX

OVERALL HARDSCAPE PLAN

Date Comment

10/04/24 Drawn By



National Presence. Local Expertise. EVERGREEN DESIGN GROUP 800.680.6630 www.evergreendesigngroup.com LANDSCAPE ARCHITECTURE LAND PLANNING · IRRIGATION DESIGN


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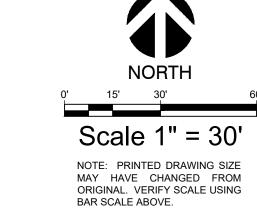
> > mp; e, Suite

Quail Hollow Rockwall, TX

HARDSCAPE PLAN

Date Comment



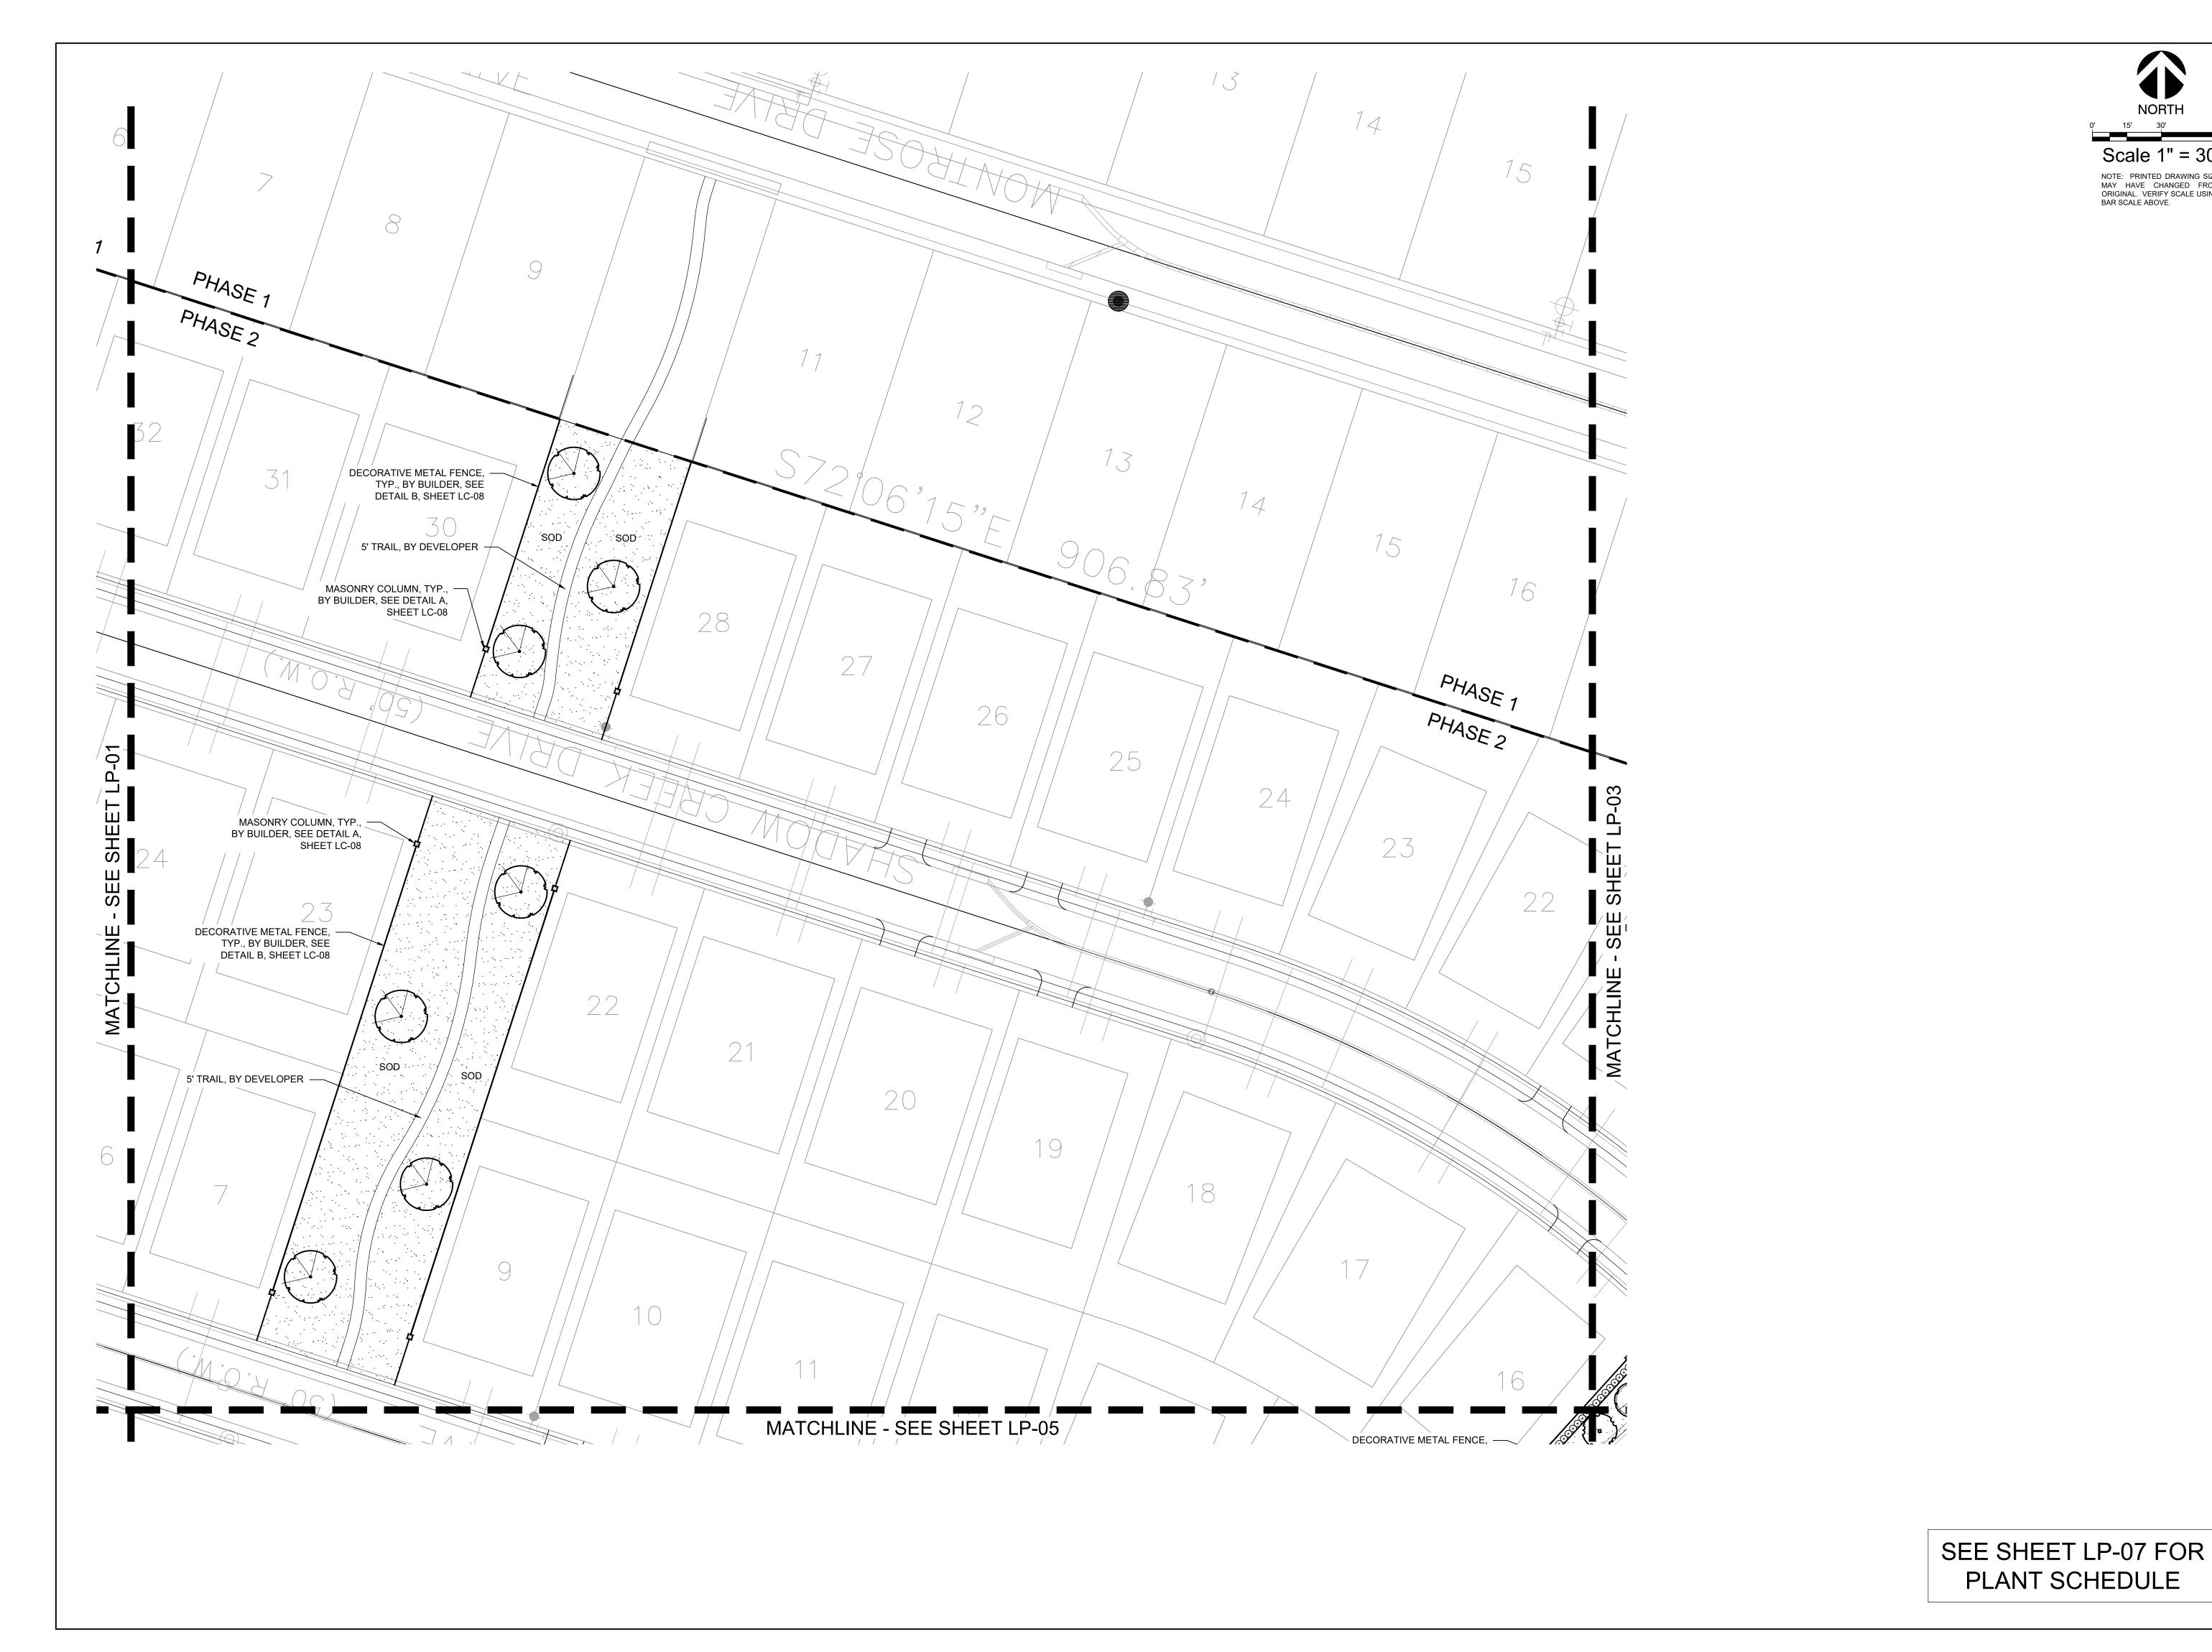




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Quail Hollow Rockwall, TX

HARDSCAPE PLAN

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Scale 1" = 30' NOTE: PRINTED DRAWING SIZE MAY HAVE CHANGED FROM ORIGINAL. VERIFY SCALE USING BAR SCALE ABOVE.




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ISSUED ON: OCTOBER 04, 2024

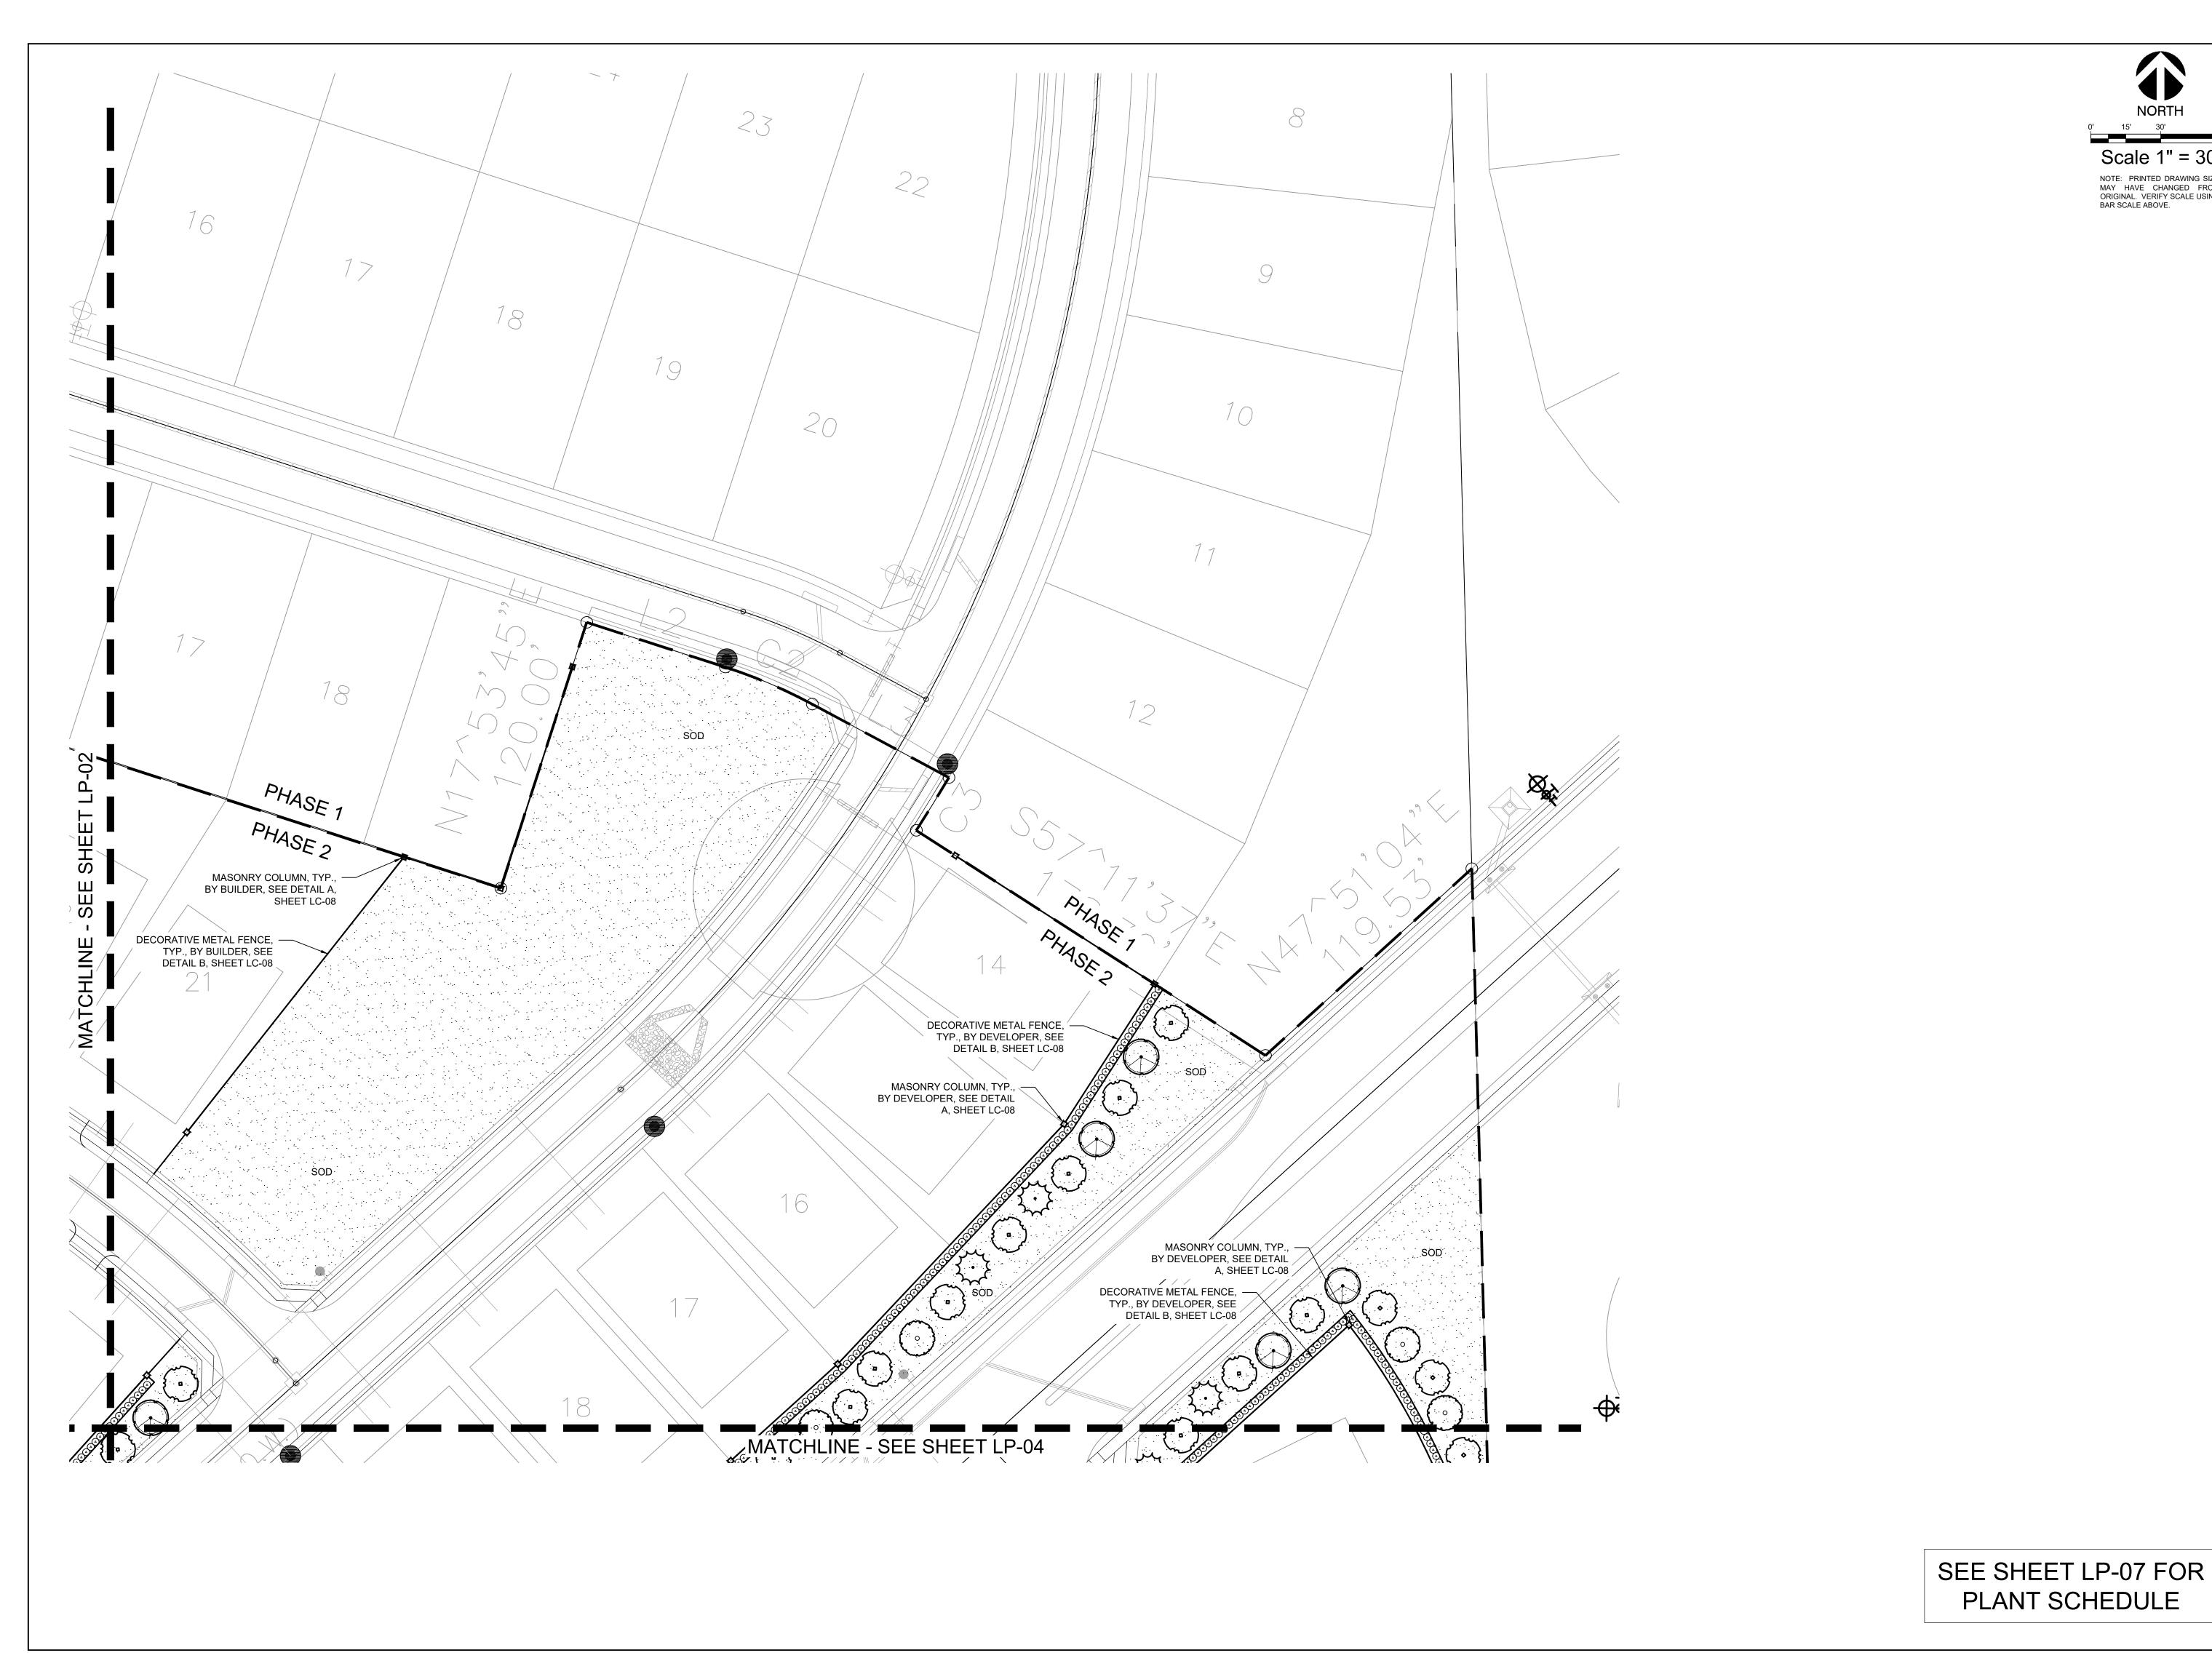Hollow I, TX Quail F Rockwall,

HARDSCAPE PLAN

Date Comment

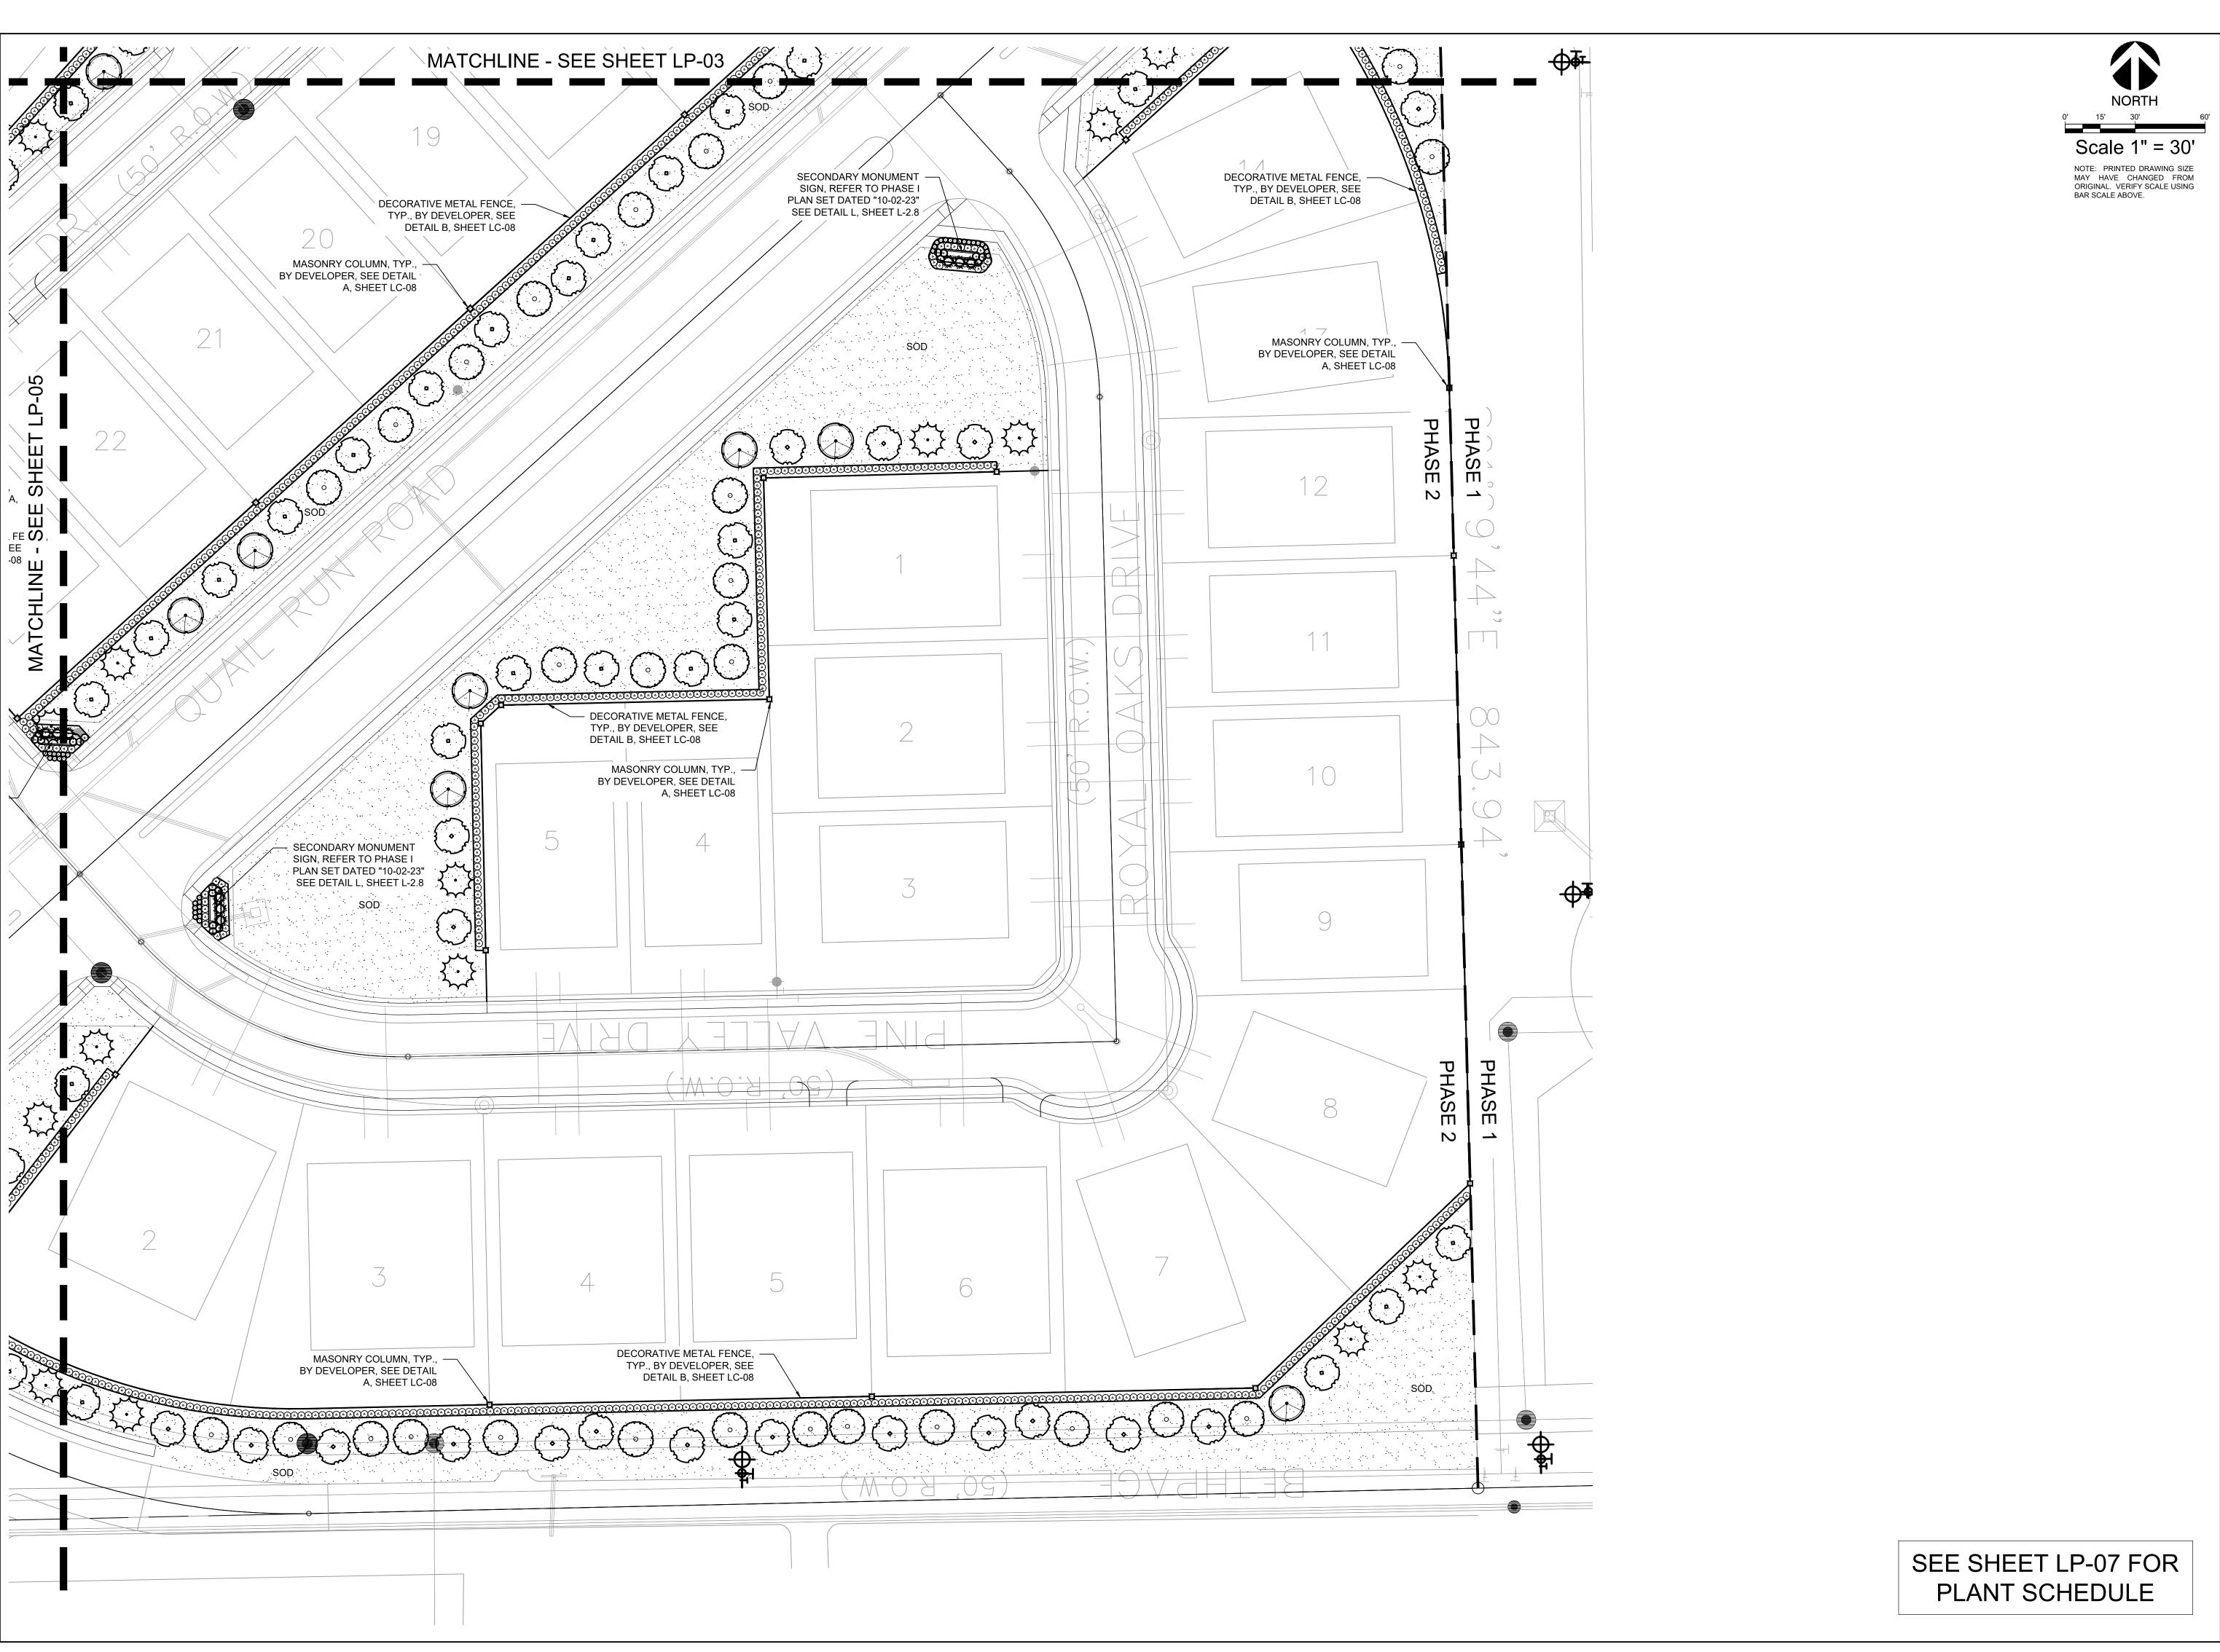

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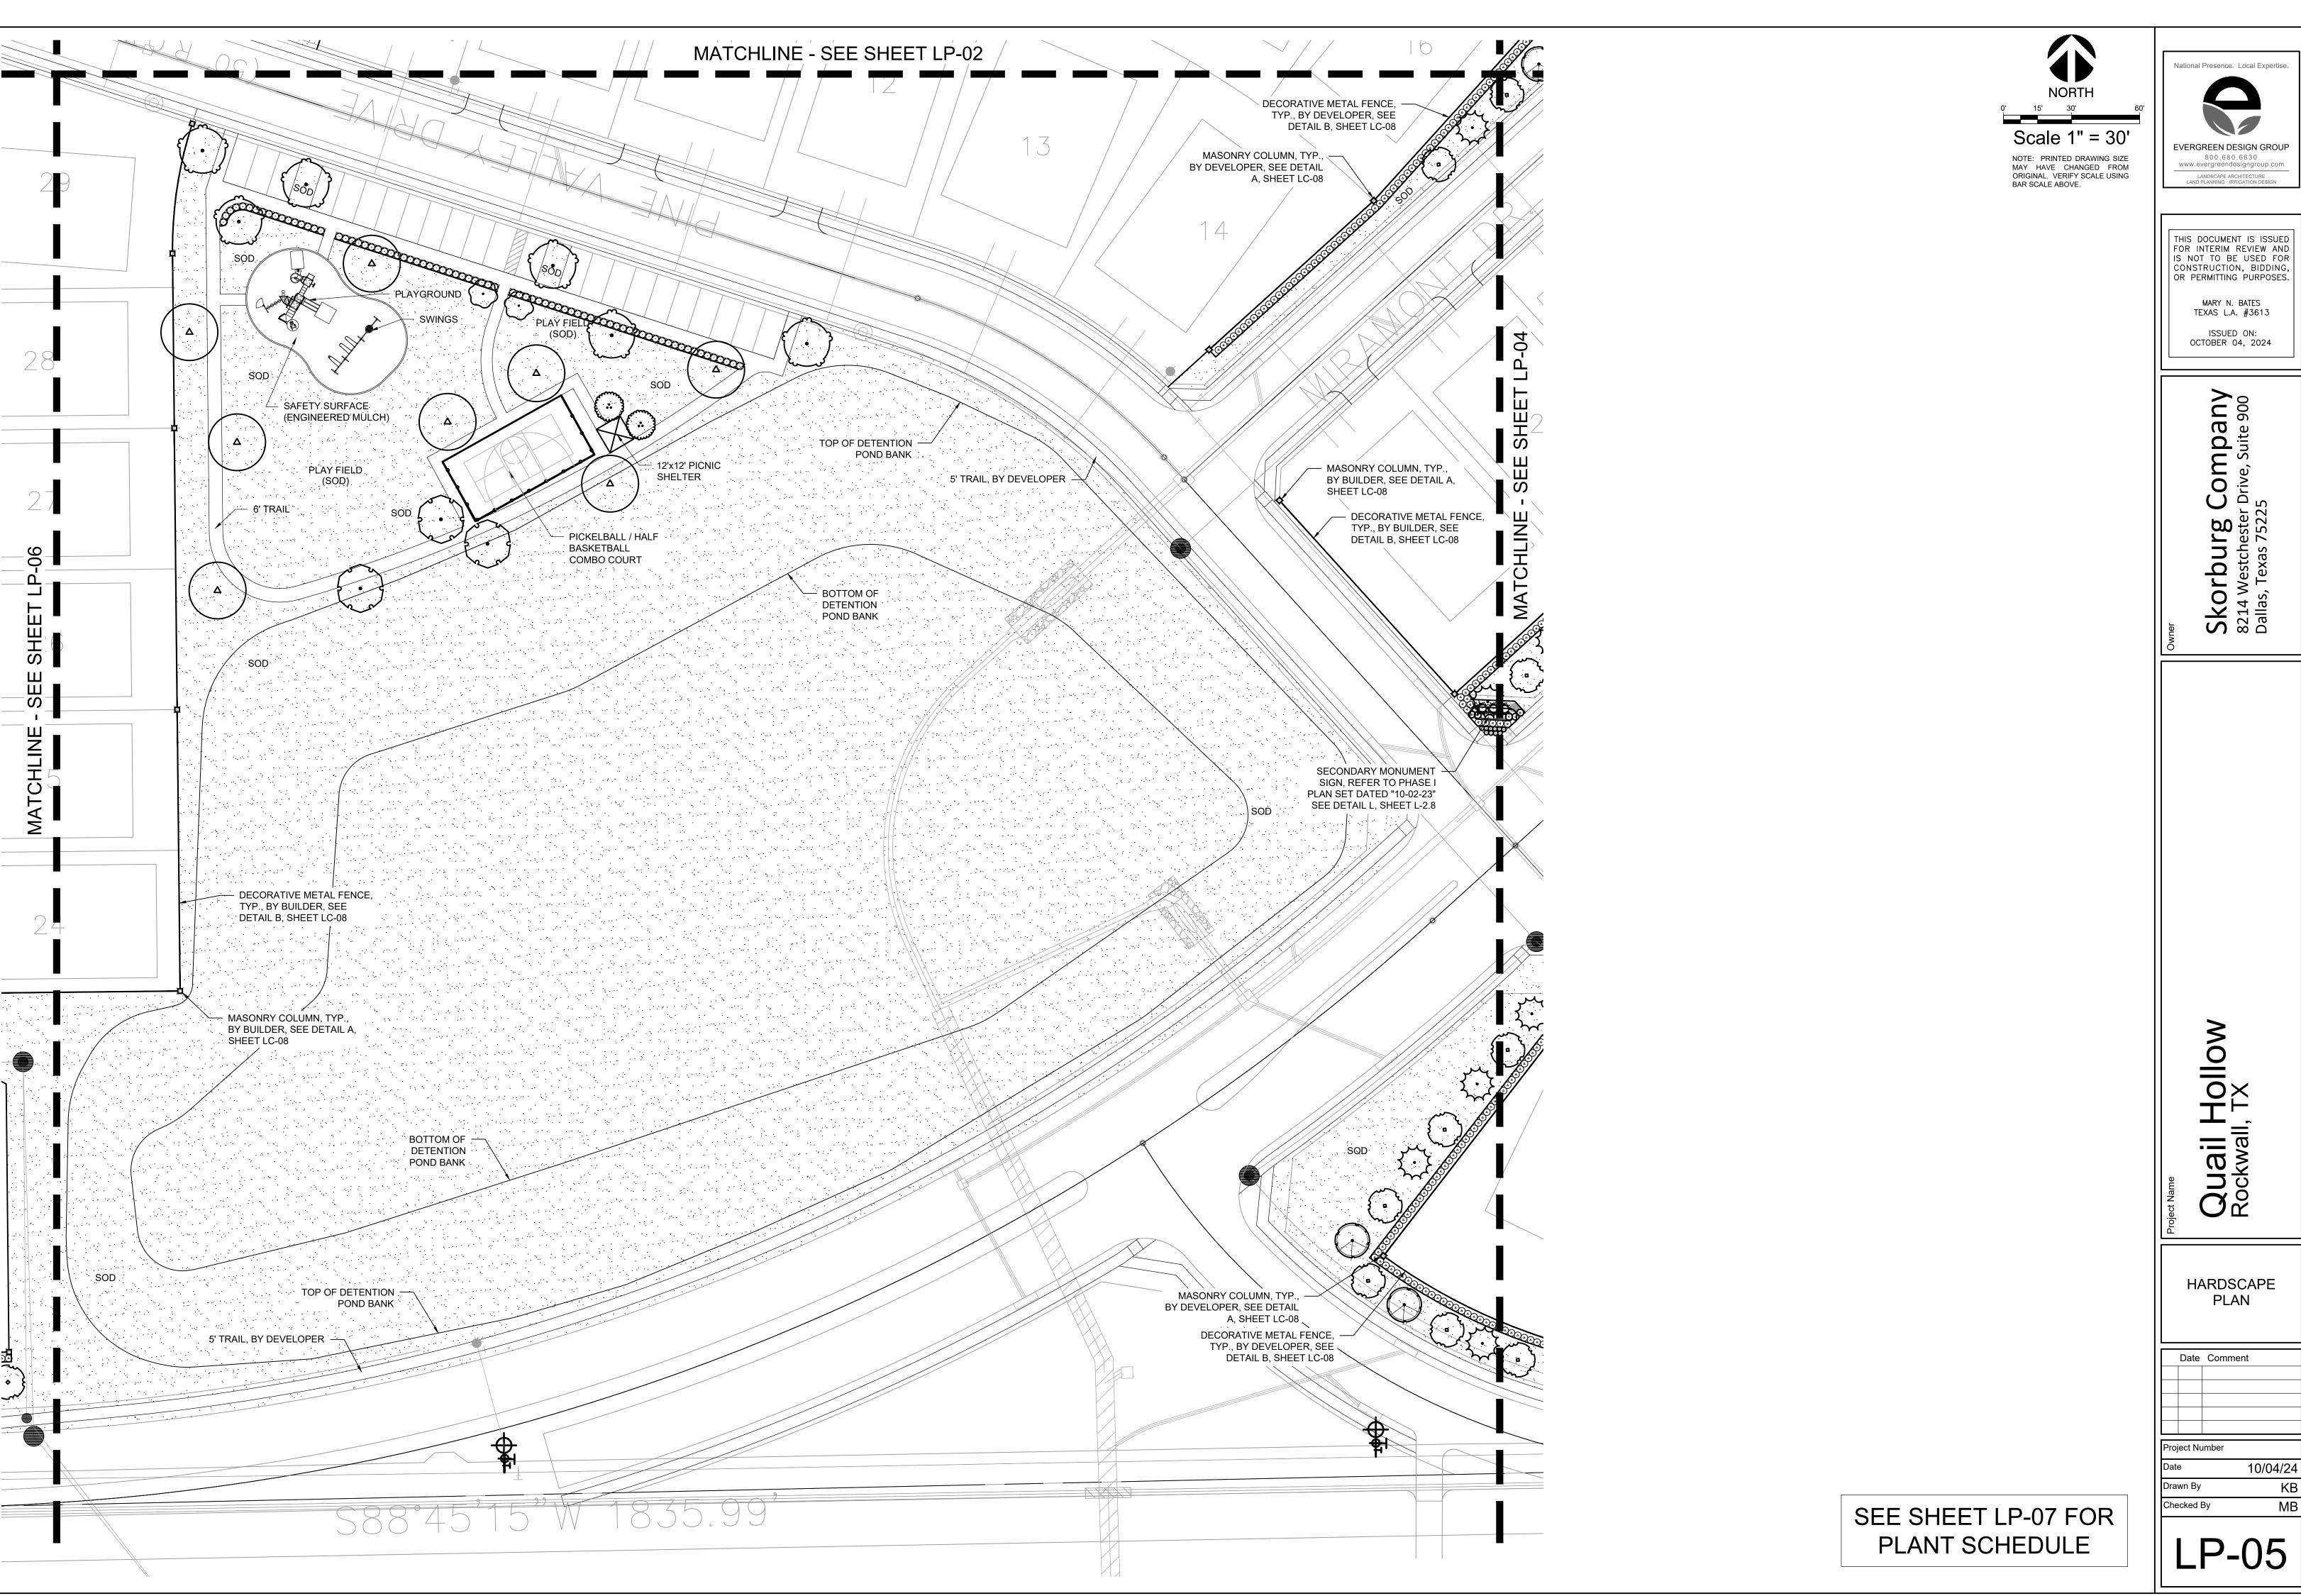
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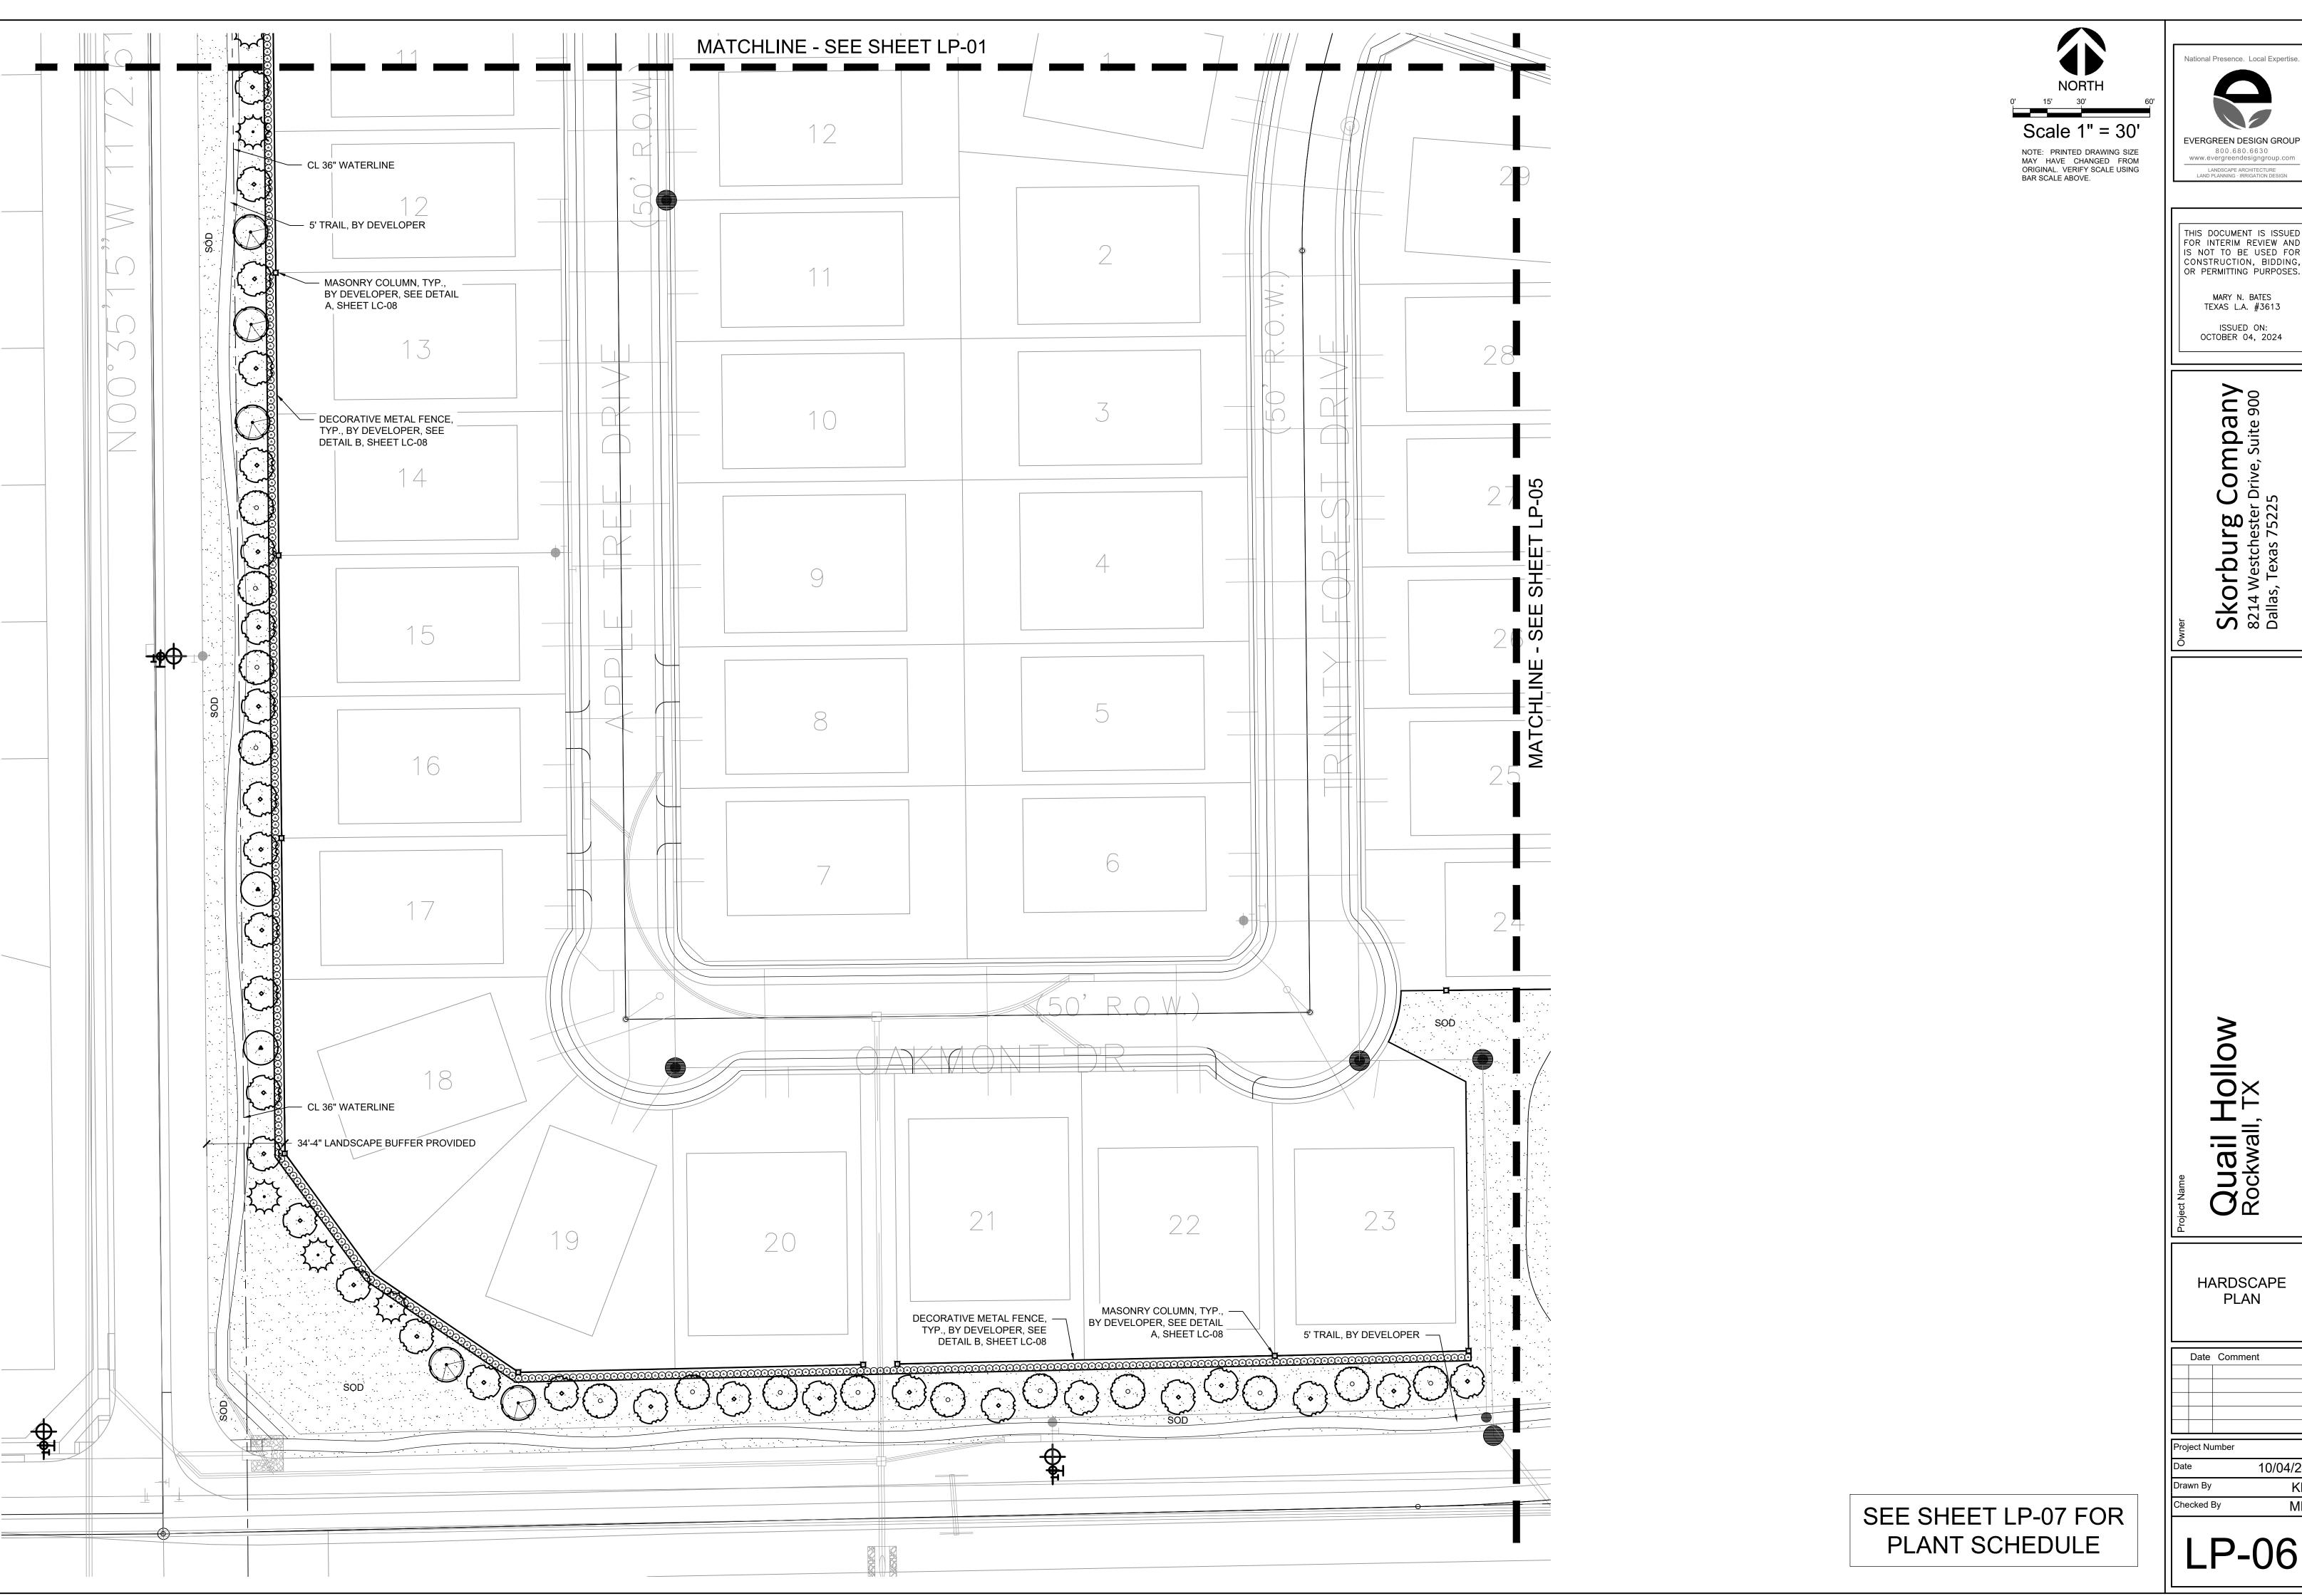
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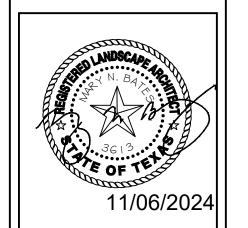
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LANT SCHEDULE											
EES	CODE	QUANTITY	COMMON NAME	BOTANICAL NAME	CONTAINER	CALIPER	SIZE	NOTES			
₹·}	CL	24	DESERT WILLOW	CHILOPSIS LINEARIS	CONT OR B & B	4"		FULL, MATCHING, SYMMETRICAL			
	ID	23	POSSUMHAW HOLLY	ILEX DECIDUA	CONT OR B & B	4"		FULL, MATCHING, SYMMETRICAL			
\odot	IV	47	YAUPON HOLLY	ILEX VOMITORIA	CONT OR B & B	4"		FULL, MATCHING, SYMMETRICAL			
	MG	104	DWARF SOUTHERN MAGNOLIA	MAGNOLIA GRANDIFLORA 'LITTLE GEM'	CONT OR B & B	4"		FULL, MATCHING, SYMMETRICAL			
	QS	3	SHUMARD OAK	QUERCUS SHUMARDII	CONT OR B & B	4"		FULL, MATCHING, SYMMETRICAL			
\odot	QV	8	SOUTHERN LIVE OAK	QUERCUS VIRGINIANA	CONT OR B & B	4"		FULL, MATCHING, SYMMETRICAL			
	UC	6	CEDAR ELM	ULMUS CRASSIFOLIA	CONT OR B & B	4"		FULL, MATCHING, SYMMETRICAL			
•	US	4	MEXICAN BUCKEYE	UNGNADIA SPECIOSA	CONT OR B & B	4"		FULL, MATCHING, SYMMETRICAL			
NAMENTAL TREES	CODE	QUANITITY	COMMON NAME	BOTANICAL NAME	CONTAINER	SIZE	SIZE	NOTES			
\bigcirc	CL	2	DESERT WILLOW	CHILOPSIS LINEARIS	CONT OR B & B		4' HT MIN	FULL, MATCHING, SYMMETRICAL			
\odot	LI	2	CRAPE MYRTLE	LAGERSTROEMIA INDICA	CONT OR B & B		4' HT MIN	FULL, MATCHING, SYMMETRICAL			
RUBS	CODE	QUANITITY	COMMON NAME	BOTANICAL NAME	CONTAINER	SIZE	SPACING	NOTES			
	cs	9	PAPAS GRASS	CORTAGERIA SELLOANA	5 GAL.	24" HT.	36" O.C.	FULL, MATCHING, SYMMETRICAL			
0	DX	78	DWARF WAX MYRTLE	MYRICA PUSILLA	5 GAL.		36" O.C.	FULL, MATCHING, SYMMETRICAL			
0	IC	1345	DWARF BUFORD HOLLY	ILEX CORNUTA 'DWARF BURFORD'	5 GAL.	24" HT.	36" O.C.	FULL, MATCHING, SYMMETRICAL			
	MC	18	PINK MUHLY	MUHLENBERGIA CAPILLARIS	5 GAL.	24" HT.	36" O.C.	FULL, MATCHING, SYMMETRICAL			
\odot	SG	36	AUTUMN SAGE	SALVIA GREGGII	1 GAL.	12" HT.	24" O.C.	FULL, MATCHING, SYMMETRICAL			
)	CODE	QUANITITY	COMMON NAME	BOTANICAL NAME	CONTAINER	SIZE	SPACING	NOTES			
SON	SOD	387,179 SF	CYNODON DACTYLON 'TIF 419'	TIF 419 BERMUDAGRASS		SOLID SOD					





Skorburg Company 8214 Westchester Drive, Suite 900 Dallas, Texas 75225

Quail Hollow Rockwall, TX

> HARDSCAPE PLAN

Date Comment

Project Number

 Date
 10/04/24

 Drawn By
 KB

 Checked By
 MB

I P-07

PLANTING SPECIFICATIONS

GENERAL

- A. QUALIFICATIONS OF LANDSCAPE CONTRACTOR ALL LANDSCAPE WORK SHOWN ON THESE PLANS SHALL BE PERFORMED BY A SINGLE FIRM
- SPECIALIZING IN LANDSCAPE PLANTING. A LIST OF SUCCESSFULLY COMPLETED PROJECTS OF THIS TYPE, SIZE AND NATURE MAY BE REQUESTED BY THE OWNER FOR FURTHER QUALIFICATION MEASURES.
- THE LANDSCAPE CONTRACTOR SHALL HOLD A VALID NURSERY AND FLORAL CERTIFICATE ISSUED BY THE TEXAS DEPARTMENT OF AGRICULTURE, AS WELL AS OPERATE UNDER A COMMERCIAL PESTICIDE APPLICATOR LICENSE ISSUED BY EITHER THE TEXAS DEPARTMENT OF AGRICULTURE OR THE TEXAS STRUCTURAL PEST CONTROL BOARD.
- WORK COVERED BY THESE SECTIONS INCLUDES THE FURNISHING AND PAYMENT OF ALL MATERIALS, LABOR SERVICES FOUIPMENT LICENSES TAXES AND ANY OTHER ITEMS THAT ARE NECESSARY FOR THE EXECUTION, INSTALLATION AND COMPLETION OF ALL WORK, SPECIFIED HEREIN AND / OR SHOWN
- ON THE LANDSCAPE PLANS, NOTES, AND DETAILS. ALL WORK SHALL BE PERFORMED IN ACCORDANCE WITH ALL APPLICABLE LAWS, CODES AND REGULATIONS REQUIRED BY AUTHORITIES HAVING JURISDICTION OVER SUCH WORK, INCLUDING ALL INSPECTIONS AND PERMITS REQUIRED BY FEDERAL, STATE AND LOCAL AUTHORITIES IN SUPPLY, TRANSPORTATION AND INSTALLATION OF MATERIALS.
- THE LANDSCAPE CONTRACTOR SHALL VERIFY THE LOCATION OF ALL UNDERGROUND UTILITY LINES (WATER, SEWER, ELECTRICAL, TELEPHONE, GAS, CABLE, TELEVISION, ETC.) PRIOR TO THE START OF

PRODUCTS

- ALL MANUFACTURED PRODUCTS SHALL BE NEW. CONTAINER AND BALLED-AND-BURLAPPED PLANTS
- FURNISH NURSERY-GROWN PLANTS COMPLYING WITH ANSI Z60.1-2014. PROVIDE WELL-SHAPED, FULLY BRANCHED, HEALTHY, VIGOROUS STOCK FREE OF DISEASE, INSECTS, EGGS, LARVAE, AND DEFECTS SUCH AS KNOTS, SUN SCALD, INJURIES, ABRASIONS, AND DISFIGUREMENT. ALL PLANTS WITHIN A SPECIES SHALL HAVE SIMILAR SIZE, AND SHALL BE OF A FORM TYPICAL FOR THE SPECIES. ALL TREES SHALL BE OBTAINED FROM SOURCES WITHIN 200 MILES OF THE PROJECT SITE, AND WITH SIMILAR
- CLIMACTIC CONDITIONS. ROOT SYSTEMS SHALL BE HEALTHY, DENSELY BRANCHED ROOT SYSTEMS, NON-POT-BOUND, FREE FROM ENCIRCLING AND/OR GIRDLING ROOTS, AND FREE FROM ANY OTHER ROOT DEFECTS (SUCH AS
- TREES MAY BE PLANTED FROM CONTAINERS OR BALLED-AND-BURLAPPED (B&B), UNLESS SPECIFIED ON THE PLANTING LEGEND. BARE-ROOT TREES ARE NOT ACCEPTABLE. ANY PLANT DEEMED UNACCEPTABLE BY THE LANDSCAPE ARCHITECT OR OWNER SHALL BE IMMEDIATELY REMOVED FROM THE SITE AND SHALL BE REPLACED WITH AN ACCEPTBLE PLANT OF LIKE
- TYPE AND SIZE AT THE CONTRACTOR'S OWN EXPENSE. ANY PLANTS APPEARING TO BE UNHEALTHY EVEN IF DETERMINED TO STILL BE ALIVE. SHALL NOT BE ACCEPTED. THE LANDSCAPE ARCHITECT AND OWNER SHALL BE THE SOLE JUDGES AS TO THE ACCEPTABILITY OF PLANT MATERIAL
- 5. ALL TREES SHALL BE STANDARD IN FORM, UNLESS OTHERWISE SPECIFIED. TREES WITH CENTRAL LEADERS WILL NOT BE ACCEPTED IF LEADER IS DAMAGED OR REMOVED. PRUNE ALL DAMAGED TWIGS
- CALIPER MEASUREMENTS FOR STANDARD (SINGLE TRUNK) TREES SHALL BE AS FOLLOWS: SIX INCHES ABOVE THE ROOT FLARE FOR TREES UP TO AND INCLUDING FOUR INCHES IN CALIPER, AND TWELVE INCHES ABOVE THE ROOT FLARE FOR TREES EXCEEDING FOUR INCHES IN CALIPER. MULTI-TRUNK TREES SHALL BE MEASURED BY THEIR OVERALL HEIGHT, MEASURED FROM THE TOP OF THE ROOT BALL. WHERE CALIPER MEASUREMENTS ARE USED, THE CALIPER SHALL BE CALCULATED
- AS ONE-HALF OF THE SUM OF THE CALIPER OF THE THREE LARGEST TRUNKS. ANY TREE OR SHRUB SHOWN TO HAVE EXCESS SOIL PLACED ON TOP OF THE ROOT BALL, SO THAT THE ROOT FLARE HAS BEEN COMPLETELY COVERED, SHALL BE REJECTED. SOD: PROVIDE WELL-ROOTED SOD OF THE VARIETY NOTED ON THE PLANS. SOD SHALL BE CUT FROM
- HEALTHY, MATURE TURF WITH SOIL THICKNESS OF 3/4" TO 1". EACH PALLET OF SOD SHALL BE ACCOMPANIED BY A CERTIFICATE FROM SUPPLIER STATING THE COMPOSITION OF THE SOD.
- SEED: PROVIDE BLEND OF SPECIES AND VARIETIES AS NOTED ON THE PLANS, WITH MAXIMUM PERCENTAGES OF PURITY, GERMINATION, AND MINIMUM PERCENTAGE OF WEED SEED AS INDICATED ON PLANS. EACH BAG OF SEED SHALL BE ACCOMPANIED BY A TAG FROM THE SUPPLIER INDICATING THE
- TOPSOIL: SANDY TO CLAY LOAM TOPSOIL, FREE OF STONES LARGER THAN ½ INCH, FOREIGN MATTER, PLANTS, ROOTS, AND SEEDS.
- COMPOST: WELL-COMPOSTED, STABLE, AND WEED-FREE ORGANIC MATTER, pH RANGE OF 5.5 TO 8; MOISTURE CONTENT 35 TO 55 PERCENT BY WEIGHT; 100 PERCENT PASSING THROUGH 3/4-INCH SIEVE; SOLUBLE SALT CONTENT OF 5 TO 10 DECISIEMENS/M; NOT EXCEEDING 0.5 PERCENT INERT CONTAMINANTS AND FREE OF SUBSTANCES TOXIC TO PLANTINGS. NO MANURE OR ANIMAL-BASED PRODUCTS SHALL BE
- G. FERTILIZER: GRANULAR FERTILIZER CONSISTING OF NITROGEN, PHOSPHORUS, POTASSIUM, AND OTHER NUTRIENTS IN PROPORTIONS, AMOUNTS, AND RELEASE RATES RECOMMENDED IN A SOIL REPORT FROM A
- QUALIFIED SOIL-TESTING AGENCY (SEE BELOW). H. MULCH: SIZE AND TYPE AS INDICATED ON PLANS, FREE FROM DELETERIOUS MATERIALS AND SUITABLE AS A TOP DRESSING OF TREES AND SHRUBS. TREE STAKING AND GLIVING
- STAKES: 6' LONG GREEN METAL T-POSTS. GUY AND TIE WIRE: ASTM A 641, CLASS 1, GALVANIZED-STEEL WIRE, 2-STRAND, TWISTED, 0.106 INCH
- STRAP CHAFING GUARD: REINFORCED NYLON OR CANVAS AT LEAST 1-1/2 INCH WIDE, WITH GROMMETS TO PROTECT TREE TRUNKS FROM DAMAGE STEEL EDGING: PROFESSIONAL STEEL EDGING. 14 GAUGE THICK X 4 INCHES WIDE. FACTORY PAINTED DARK
- GREEN. ACCEPTABLE MANUFACTURERS INCLUDE COL-MET OR APPROVED EQUAL. M. PRE-EMERGENT HERBICIDES: ANY GRANULAR, NON-STAINING PRE-EMERGENT HERBICIDE THAT IS LABELED FOR THE SPECIFIC ORNAMENTALS OR TURF ON WHICH IT WILL BE UTILIZED. PRE-EMERGENT HERBICIDES SHALL BE APPLIED PER THE MANUFACTURER'S LABELED RATES.

METHODS

 A. SOIL PREPARATION BEFORE STARTING WORK, THE LANDSCAPE CONTRACTOR SHALL VERIFY THAT THE GRADE OF ALL LANDSCAPE AREAS ARE WITHIN +/-0.1' OF FINISH GRADE. THE CONTRACTOR SHALL NOTIFY THE

OWNER IMMEDIATELY SHOULD ANY DISCREPANCIES EXIST.

- a. AFTER FINISH GRADES HAVE BEEN ESTABLISHED, CONTRACTOR SHALL HAVE SOIL SAMPLES FROM THE PROJECT'S LANDSCAPE AREAS TESTED BY AN ESTABLISHED SOIL TESTING LABORATORY. EACH SAMPLE SUBMITTED TO THE LAB SHALL CONTAIN NO LESS THAN ONE QUART OF SOIL, TAKEN FROM BETWEEN THE SOIL SURFACE AND 6" DEPTH. IF NO SAMPLE LOCATIONS ARE INDICATED ON THE PLANS, THE CONTRACTOR SHALL TAKE A MINIMUM OF THREE SAMPLES FROM VARIOUS REPRESENTATIVE LOCATIONS FOR TESTING.
- THE CONTRACTOR SHALL HAVE THE SOIL TESTING LABORATORY PROVIDE RESULTS FOR THE FOLLOWING: SOIL TEXTURAL CLASS, GENERAL SOIL FERTILITY, pH, ORGANIC MATTER CONTENT, SALT (CEC), LIME, SODIUM ADSORPTION RATIO (SAR) AND BORON CONTENT. c. THE CONTRACTOR SHALL ALSO SUBMIT THE PROJECT'S PLANT LIST TO THE LABORATORY ALONG
- WITH THE SOIL SAMPLES. d. THE SOIL REPORT PRODUCED BY THE LABORATORY SHALL CONTAIN RECOMMENDATIONS FOR THE FOLLOWING (AS APPROPRIATE): SEPARATE SOIL PREPARATION AND BACKFILL MIX RECOMMENDATIONS FOR GENERAL ORNAMENTAL PLANTS, XERIC PLANTS, TURE, AND NATIVE SEED. AS WELL AS PRE-PLANT FERTILIZER APPLICATIONS AND RECOMMENDATIONS FOR ANY OTHER SOIL RELATED ISSUES. THE REPORT SHALL ALSO PROVIDE A FERTILIZER PROGRAM FOR
- THE ESTABLISHMENT PERIOD AND FOR LONG-TERM MAINTENANCE. THE CONTRACTOR SHALL INSTALL SOIL AMENDMENTS AND FERTILIZERS PER THE SOILS REPORT RECOMMENDATIONS. ANY CHANGE IN COST DUE TO THE SOIL REPORT RECOMMENDATIONS. EITHER
- INCREASE OR DECREASE. SHALL BE SUBMITTED TO THE OWNER WITH THE REPORT. FOR BIDDING PURPOSES ONLY, THE SOIL PREPARATION SHALL CONSIST OF THE FOLLOWING TURF: INCORPORATE THE FOLLOWING AMENDMENTS INTO THE TOP 8" OF SOIL BY MEANS OF
- ROTOTILLING AFTER CROSS-RIPPING: NITROGEN STABILIZED ORGANIC AMENDMENT - 4 CU. YDS. PER 1,000 S.F. PREPLANT TURF FERTILIZER (10-20-10 OR SIMILAR, SLOW RELEASE, ORGANIC) - 15 LBS PER 1,000
- iii. "CLAY BUSTER" OR EQUAL USE MANUFACTURER'S RECOMMENDED RATE TREES, SHRUBS, AND PERENNIALS: INCORPORATE THE FOLLOWING AMENDMENTS INTO THE TOP 8" OF SOIL BY MEANS OF ROTOTILLING AFTER CROSS-RIPPING:
- NITROGEN STABILIZED ORGANIC AMENDMENT 4 CU. YDS. PER 1,000 S.F. 12-12-12 FERTILIZER (OR SIMILAR, ORGANIC, SLOW RELEASE) - 10 LBS. PER CU. YD.
- "CLAY BUSTER" OR EQUAL USE MANUFACTURER'S RECOMMENDED RATE IRON SULPHATE - 2 LBS. PER CU. YD. 5. IN THE CONTEXT OF THESE PLANS, NOTES, AND SPECIFICATIONS, "FINISH GRADE" REFERS TO THE
- FINAL ELEVATION OF THE SOIL SURFACE (NOT TOP OF MULCH) AS INDICATED ON THE GRADING PLANS. a. BEFORE STARTING WORK, THE LANDSCAPE CONTRACTOR SHALL VERIFY THAT THE ROUGH GRADES OF ALL LANDSCAPE AREAS ARE WITHIN +/-0.1' OF FINISH GRADE. SEE SPECIFICATIONS FOR MORE DETAILED INSTRUCTION ON TURF AREA AND PLANTING BED PREPARATION.
- CONSTRUCT AND MAINTAIN FINISH GRADES AS SHOWN ON GRADING PLANS, AND CONSTRUCT AND MAINTAIN SLOPES AS RECOMMENDED BY THE GEOTECHNICAL REPORT. ALL LANDSCAPE AREAS SHALL HAVE POSITIVE DRAINAGE AWAY FROM STRUCTURES AT THE MINIMUM SLOPE SPECIFIED IN THE REPORT AND ON THE GRADING PLANS, AND AREAS OF POTENTIAL PONDING SHALL BE REGRADED TO BLEND IN WITH THE SURROUNDING GRADES AND ELIMINATE PONDING
- c. THE LANDSCAPE CONTRACTOR SHALL DETERMINE WHETHER OR NOT THE EXPORT OF ANY SOIL WILL BE NEEDED. TAKING INTO ACCOUNT THE ROUGH GRADE PROVIDED. THE AMOUNT OF SOIL AMENDMENTS TO BE ADDED (BASED ON A SOIL TEST, PER SPECIFICATIONS), AND THE FINISH GRADES TO BE ESTABLISHED.
- d. ENSURE THAT THE FINISH GRADE IN SHRUB AREAS IMMEDIATELY ADJACENT TO WALKS AND OTHER WALKING SURFACES, AFTER INSTALLING SOIL AMENDMENTS, IS 3" BELOW THE ADJACENT FINISH SURFACE IN ORDER TO ALLOW FOR PROPER MULCH DEPTH. TAPER THE SOIL SURFACE TO MEET FINISH GRADE, AS SPECIFIED ON THE GRADING PLANS, AT APPROXIMATELY 18" AWAY FROM THE WALKS
- e. ENSURE THAT THE FINISH GRADE IN TURF AREAS IMMEDIATELY ADJACENT TO WALKS AND OTHER WALKING SURFACES, AFTER INSTALLING SOIL AMENDMENTS, IS 1" BELOW THE FINISH SURFACE OF THE WALKS. TAPER THE SOIL SURFACE TO MEET FINISH GRADE, AS SPECIFIED ON THE GRADING PLANS, AT APPROXIMATELY 18" AWAY FROM THE WALKS.
- SHOULD ANY CONFLICTS AND/OR DISCREPANCIES ARISE BETWEEN THE GRADING PLANS, GEOTECHNICAL REPORT, THESE NOTES AND PLANS, AND ACTUAL CONDITIONS, THE CONTRACTOR SHALL IMMEDIATELY BRING SUCH ITEMS TO THE ATTENTION OF THE LANDSCAPE
- ARCHITECT, GENERAL CONTRACTOR, AND OWNER. ONCE SOIL PREPARATION IS COMPLETE, THE LANDSCAPE CONTRACTOR SHALL ENSURE THAT THERE ARE NO DEBRIS, TRASH, OR STONES LARGER THAN 1" REMAINING IN THE TOP 6" OF SOIL.

- THE CONTRACTOR SHALL PROVIDE SUBMITTALS AND SAMPLES, IF REQUIRED, TO THE LANDSCAPE ARCHITECT, AND RECEIVE APPROVAL IN WRITING FOR SUCH SUBMITTALS BEFORE WORK COMMENCES. SUBMITTALS SHALL INCLUDE PHOTOS OF PLANTS WITH A RULER OR MEASURING STICK FOR SCALE, PHOTOS OR SAMPLES OF ANY REQUIRED MULCHES, AND SOIL TEST RESULTS AND PREPARATION RECOMMENDATIONS FROM THE TESTING LAB (INCLUDING COMPOST AND FERTILIZER RATES AND TYPES, AND OTHER AMENDMENTS FOR TREE/SHRUB, TURF, AND SEED AREAS AS MAY BE
 - APPROPRIATE). 3. SUBMITTALS SHALL ALSO INCLUDE MANUFACTURER CUT SHEETS FOR PLANTING ACCESSORIES SUCH AS TREE STAKES AND TIES EDGING AND LANDSCAPE FABRICS (IF ANY) WHERE MULTIPLE ITEMS ARE SHOWN ON A PAGE, THE CONTRACTOR SHALL CLEARLY INDICATE THE ITEM BEING CONSIDERED.
- C. GENERAL PLANTING REMOVE ALL NURSERY TAGS AND STAKES FROM PLANTS.
- EXCEPT IN AREAS TO BE PLANTED WITH ORNAMENTAL GRASSES, APPLY PRE-EMERGENT HERBICIDES AT THE MANUFACTURER'S RECOMMENDED RATE. TRENCHING NEAR EXISTING TREES:
- CONTRACTOR SHALL NOT DISTURB ROOTS 1-1/2" AND LARGER IN DIAMETER WITHIN THE CRITICAL ROOT ZONE (CRZ) OF EXISTING TREES, AND SHALL EXERCISE ALL POSSIBLE CARE AND PRECAUTIONS TO AVOID INJURY TO TREE ROOTS, TRUNKS, AND BRANCHES. THE CRZ IS DEFINED AS A CIRCULAR AREA EXTENDING OUTWARD FROM THE TREE TRUNK. WITH A RADIUS EQUAL TO 1' FOR EVERY 1" OF TRUNK DIAMETER-AT-BREAST-HEIGHT (4.5' ABOVE THE AVERAGE
- ALL EXCAVATION WITHIN THE CRZ SHALL BE PERFORMED USING HAND TOOLS. NO MACHINE
- EXCAVATION OR TRENCHING OF ANY KIND SHALL BE ALLOWED WITHIN THE CRZ. ALTER ALIGNMENT OF PIPE TO AVOID TREE ROOTS 1-1/2" AND LARGER IN DIAMETER. WHERE TREE ROOTS 1-1/2" AND LARGER IN DIAMETER ARE ENCOUNTERED IN THE FIELD, TUNNEL UNDER SUCH ROOTS. WRAP EXPOSED ROOTS WITH SEVERAL LAYERS OF BURLAP AND KEEP MOIST.
- CLOSE ALL TRENCHES WITHIN THE CANOPY DRIP LINES WITHIN 24 HOURS. ALL SEVERED ROOTS SHALL BE HAND PRUNED WITH SHARP TOOLS AND ALLOWED TO AIR-DRY. DO NOT USE ANY SORT OF SEALERS OR WOUND PAINTS.
- TREE PLANTING HOLES SHALL BE EXCAVATED TO MINIMUM WIDTH OF TWO TIMES THE WIDTH OF THE ROOTBALL. AND TO A DEPTH EQUAL TO THE DEPTH OF THE ROOTBALL LESS TWO TO FOUR INCHES. SCARIFY THE SIDES AND BOTTOM OF THE PLANTING HOLE PRIOR TO THE PLACEMENT OF THE TREE.
 - REMOVE ANY GLAZING THAT MAY HAVE BEEN CAUSED DURING THE EXCAVATION OF THE HOLE. 3. FOR CONTAINER AND BOX TREES, TO REMOVE ANY POTENTIALLY GIRDLING ROOTS AND OTHER ROOT DEFECTS, THE CONTRACTOR SHALL SHAVE A 1" LAYER OFF OF THE SIDES AND BOTTOM OF THE ROOTBALL OF ALL TREES JUST BEFORE PLACING INTO THE PLANTING PIT. DO NOT "TEASE" ROOTS
 - OUT FROM THE ROOTBALL. 4. INSTALL THE TREE ON UNDISTURBED SUBGRADE SO THAT THE TOP OF THE ROOTBALL IS TWO TO FOUR INCHES ABOVE THE SURROUNDING GRADE 5. BACKFILL THE TREE HOLE UTILIZING THE EXISTING TOPSOIL FROM ON-SITE. ROCKS LARGER THAN 1" DIA. AND ALL OTHER DEBRIS SHALL BE REMOVED FROM THE SOIL PRIOR TO THE BACKFILL. SHOULD

ADDITIONAL SOIL BE REQUIRED TO ACCOMPLISH THIS TASK. USE STORED TOPSOIL FROM ON-SITE OR


- IMPORT ADDITIONAL TOPSOIL FROM OFF-SITE AT NO ADDITIONAL COST TO THE OWNER. IMPORTED TOPSOIL SHALL BE OF SIMILAR TEXTURAL CLASS AND COMPOSITION IN THE ON-SITE SOIL. TREES SHALL NOT BE STAKED UNLESS LOCAL CONDITIONS (SUCH AS HEAVY WINDS OR SLOPES) REQUIRE STAKES TO KEEP TREES UPRIGHT. SHOULD STAKING BE REQUIRED. THE TOTAL NUMBER OF TREE STAKES (BEYOND THE MINIMUMS LISTED BELOW) WILL BE LEFT TO THE LANDSCAPE CONTRACTOR'S DISCRETION. SHOULD ANY TREES FALL OR LEAN, THE LANDSCAPE CONTRACTOR SHALL STRAIGHTEN THE TREE, OR REPLACE IT SHOULD IT BECOME DAMAGED. TREE STAKING SHALL
- ADHERE TO THE FOLLOWING GUIDELINES: TWO STAKES PER TREE 2-1/2"-4" TREES THREE STAKES PER TREE
- TREES OVER 4" CALIPER GUY AS NEEDED THREE STAKES PER TREE MINIMUM, QUANTITY AND POSITIONS AS MULTI-TRUNK TREES NEEDED TO STABILIZE THE TREE
- UPON COMPLETION OF PLANTING, CONSTRUCT AN EARTH WATERING BASIN AROUND THE TREE. COVER THE INTERIOR OF THE TREE RING WITH THE WEED BARRIER CLOTH AND TOPDRESS WITH MULCH (TYPE AND DEPTH PER PLANS).
- SHRUB, PERENNIAL, AND GROUNDCOVER PLANTING DIG THE PLANTING HOLES TWICE AS WIDE AND 2" LESS DEEP THAN EACH PLANT'S ROOTBALL. INSTALL
- THE PLANT IN THE HOLE. BACKFILL AROUND THE PLANT WITH SOIL AMENDED PER SOIL TEST RECOMMENDATIONS. INSTALL THE WEED BARRIER CLOTH, OVERLAPPING IT AT THE ENDS. UTILIZE STEEL STAPLES TO KEEP
- THE WEED BARRIER CLOTH IN PLACE. WHEN PLANTING IS COMPLETE, INSTALL MULCH (TYPE AND DEPTH PER PLANS) OVER ALL PLANTING BEDS. COVERING THE ENTIRE PLANTING AREA. F. SODDING
- SOD VARIETY TO BE AS SPECIFIED ON THE LANDSCAPE PLAN. LAY SOD WITHIN 24 HOURS FROM THE TIME OF STRIPPING. DO NOT LAY IF THE GROUND IS FROZEN. LAY THE SOD TO FORM A SOLID MASS WITH TIGHTLY FITTED JOINTS. BUTT ENDS AND SIDES OF SOD STRIPS - DO NOT OVERLAP STAGGER STRIPS TO DESET JOINTS IN ADJACENT COLIRSES. 4 ROLL THE SOD TO ENSURE GOOD CONTACT OF THE SOD'S ROOT SYSTEM WITH THE SOIL
- 5. WATER THE SOD THOROUGHLY WITH A FINE SPRAY IMMEDIATELY AFTER PLANTING TO OBTAIN AT LEAST SIX INCHES OF PENETRATION INTO THE SOIL BELOW THE SOD.
- G. HYDROMULCHING 1. TURF HYDROMULCH MIX (PER 1,000 SF) SHALL BE AS FOLLOWS:
 - WINTER MIX (OCTOBER 1 MARCH 31) 50# CELLULOSE FIBER MULCH
 - P# UNHULLED BERMUDA SEED # ANNUAL RYE SEED
 - 15# 15-15-15 WATER SOLUBLE FERTILIZER
- 50# CELLULOSE FIBER MULCH HULLED BERMUDA SEED
- 15# 15-15-15 WATER SOLUBLE FERTILIZER 2. SEED HYDROMULCH MIX (PER 1,000 SF) SHALL BE AS FOLLOWS:
- 50# CELLULOSE FIBER MULCH 15# 15-15-15 WATER SOLUBLE FERTILIZER
- SEED RATE PER LEGEND
- ALL SEED SHALL BE DRILL SEEDED AT THE RATES SHOWN ON THE PLANS, WITH A HYDROMULCH MIX APPLIED AFTER SEEDING.
- THE HYDROMULCH MIX (PER 1.000 SF) SHALL BE AS FOLLOWS:
- 50# CELLULOSE FIBER MULCH 15# 15-15-15 WATER SOLUBLE FERTILIZER 4# ORGANIC BINDER
- MULCH
- 1. INSTALL MULCH TOPDRESSING, TYPE AND DEPTH PER MULCH NOTE, IN ALL PLANTING AREAS AND TREE RINGS. 2. DO NOT INSTALL MULCH WITHIN 6" OF TREE ROOT FLARE AND WITHIN 24" OF HABITABLE STRUCTURES, EXCEPT AS MAY BE NOTED ON THESE PLANS. MULCH COVER WITHIN 6" OF CONCRETE WALKS AND CURBS SHALL NOT PROTRUDE ABOVE THE FINISH SURFACE OF THE WALKS AND CURBS. MULCH
- COVER WITHIN 12" OF WALLS SHALL BE AT LEAST 3" LOWER THAN THE TOP OF WALL. 1. DURING LANDSCAPE PREPARATION AND PLANTING, KEEP ALL PAVEMENT CLEAN AND ALL WORK AREAS
- IN A NEAT, ORDERLY CONDITION. DISPOSED LEGALLY OF ALL EXCAVATED MATERIALS OFF THE PROJECT SITE. K. INSPECTION AND ACCEPTANCE
- 1. UPON COMPLETION OF THE WORK, THE LANDSCAPE CONTRACTOR SHALL PROVIDE THE SITE CLEAN, FREE OF DEBRIS AND TRASH, AND SUITABLE FOR USE AS INTENDED. THE LANDSCAPE CONTRACTOR SHALL THEN REQUEST AN INSPECTION BY THE OWNER TO DETERMINE FINAL ACCEPTABILITY. 2. WHEN THE INSPECTED PLANTING WORK DOES NOT COMPLY WITH THE CONTRACT DOCUMENTS, THE LANDSCAPE CONTRACTOR SHALL REPLACE AND/OR REPAIR THE REJECTED WORK TO THE OWNER'S
- SATISFACTION WITHIN 24 HOURS. THE LANDSCAPE MAINTENANCE PERIOD WILL NOT COMMENCE UNTIL THE LANDSCAPE WORK HAS BEEN RE-INSPECTED BY THE OWNER AND FOUND TO BE ACCEPTABLE. AT THAT TIME, A WRITTEN NOTICE OF FINAL ACCEPTANCE WILL BE ISSUED BY THE OWNER, AND THE MAINTENANCE AND GUARANTEE PERIODS WILL COMMENCE.
- LANDSCAPE MAINTENANCE THE LANDSCAPE CONTRACTOR SHALL BE RESPONSIBLE FOR THE MAINTENANCE OF ALL WORK SHOWN ON THESE PLANS FOR 90 DAYS BEYOND FINAL ACCEPTANCE OF ALL LANDSCAPE WORK BY THE OWNER. LANDSCAPE MAINTENANCE SHALL INCLUDE WEEKLY SITE VISITS FOR THE FOLLOWING ACTIONS (AS APPROPRIATE): PROPER PRUNING, RESTAKING OF TREES, RESETTING OF PLANTS THAT HAVE SETTLED, MOWING AND AERATION OF LAWNS, WEEDING, RESEEDING AREAS WHICH HAVE NOT GERMINATED WELL, TREATING FOR INSECTS AND DISEASES, REPLACEMENT OF MULCH, REMOVAL OF LITTER, REPAIRS TO THE IRRIGATION SYSTEM DUE TO FAULTY PARTS AND/OR WORKMANSHIP, AND THE APPROPRIATE WATERING OF ALL PLANTINGS. THE LANDSCAPE CONTRACTOR SHALL MAINTAIN THE IRRIGATION SYSTEM IN PROPER WORKING ORDER, WITH SCHEDULING ADJUSTMENTS BY SEASON
- TO MAXIMIZE WATER CONSERVATION. SHOULD SEEDED AND/OR SODDED AREAS NOT BE COVERED BY AN AUTOMATIC IRRIGATION SYSTEM. THE LANDSCAPE CONTRACTOR SHALL BE RESPONSIBLE FOR WATERING THESE AREAS AND OBTAINING A FULL HEALTHY STAND OF PLANTS AT NO ADDITIONAL COST TO THE OWNER TO ACHIEVE FINAL ACCEPTANCE AT THE END OF THE MAINTENANCE PERIOD, ALL OF THE FOLLOWING
- CONDITIONS MUST OCCUR-THE LANDSCAPE SHALL SHOW ACTIVE, HEALTHY GROWTH (WITH EXCEPTIONS MADE FOR SEASONAL DORMANCY). ALL PLANTS NOT MEETING THIS CONDITION SHALL BE REJECTED AND REPLACED BY HEALTHY PLANT MATERIAL PRIOR TO FINAL ACCEPTANCE ALL HARDSCAPE SHALL BE CLEANED PRIOR TO FINAL ACCEPTANCE. SODDED AREAS MUST BE ACTIVELY GROWING AND MUST REACH A MINIMUM HEIGHT OF 1 1/2
- INCHES BEFORE FIRST MOWING. HYDROMULCHED AREAS SHALL SHOW ACTIVE, HEALTHY GROWTH. BARE AREAS LARGER THAN TWELVE SQUARE INCHES MUST BE RESODDED OR RESEEDED (AS APPROPRIATE) PRIOR TO FINAL ACCEPTANCE. ALL SODDED TURF SHALL BE NEATLY MOWED. M. WARRANTY PERIOD, PLANT GUARANTEE AND REPLACEMENTS THE LANDSCAPE CONTRACTOR SHALL GUARANTEE ALL TREES, SHRUBS, PERENNIALS, SOD, SEEDED/HYDROMULCHED AREAS, AND IRRIGATION SYSTEMS FOR A PERIOD OF ONE YEAR FROM THE
- 2. AFTER THE INITIAL MAINTENANCE PERIOD AND DURING THE GUARANTEE PERIOD, THE LANDSCAPE CONTRACTOR SHALL ONLY BE RESPONSIBLE FOR REPLACEMENT OF PLANTS WHEN PLANT DEATH CANNOT BE ATTRIBUTED DIRECTLY TO OVERWATERING OR OTHER DAMAGE BY HUMAN ACTIONS. PROVIDE A MINIMUM OF (2) COPIES OF RECORD DRAWINGS TO THE OWNER UPON COMPLETION OF WORK. A RECORD DRAWING IS A RECORD OF ALL CHANGES THAT OCCURRED IN THE FIELD AND THAT ARE

DOCUMENTED THROUGH CHANGE ORDERS, ADDENDA, OR CONTRACTOR/CONSULTANT DRAWING MARKUPS.

DATE OF THE OWNER'S FINAL ACCEPTANCE (90 DAYS FOR ANNUAL PLANTS). THE CONTRACTOR SHALL

REPLACE, AT HIS OWN EXPENSE AND TO THE SATISFACTION OF THE OWNER, ANY PLANTS WHICH DIE

IN THAT TIME, OR REPAIR ANY PORTIONS OF THE IRRIGATION SYSTEM WHICH OPERATE IMPROPERLY.

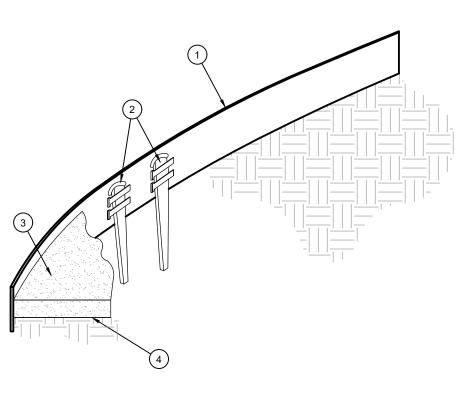

- (1) ROLLED-TOP STEEL EDGING PER PLANS.
- (2) TAPERED STEEL STAKES. (3) MULCH, TYPE AND DEPTH PER PLANS.

(4) FINISH GRADE.

1) INSTALL EDGING SO THAT STAKES WILL BE ON INSIDE OF PLANTING BED. BOTTOM OF EDGING SHALL BE BURIED A MINIMUM OF 1" BELOW FINISH GRADE 3) TOP OF MULCH SHALL BE 1" LOWER THAN TOP OF EDGING.

DISTANCE PER PLAN

(2) MULCH LAYER


(4) TURF (WHERE SHOWN ON PLAN).


(3) PLANT.

24" MIN. TO EDGE


OF MATURE CANOPY




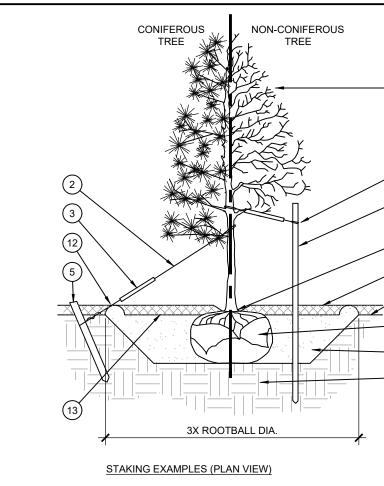


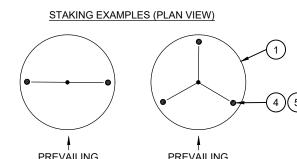

SCALE: NOT TO SCALE

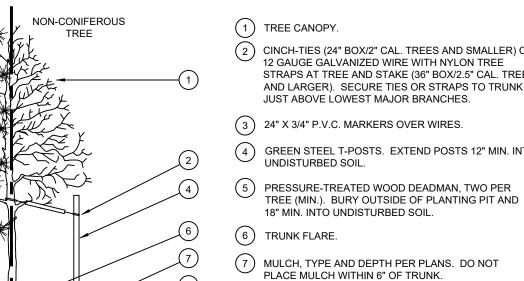

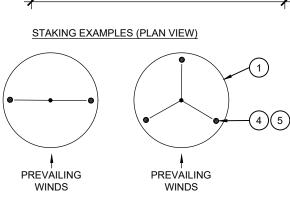

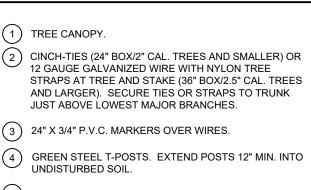

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(11) UNDISTURBED NATIVE SOIL. MARY N. BATES TEXAS L.A. #3613 (12) 4" HIGH EARTHEN WATERING BASIN. ISSUED ON: OCTOBER 04, 2024

SUCH THAT THE ROOTBALL RESTS ON UNDISTURBED SOIL, AND THE ROOT FLARE IS 2"-4" ABOVE FINISH GRADE. FOR B&B TREES, CUT OFF BOTTOM 1/3 OF WIRE BASKET BEFORE PLACING TREE IN HOLE, CUT OFF AND REMOVE REMAINDER OF BASKET AFTER TREE IS SET IN HOLE, REMOVE ALL NYLON TIES, TWINE, ROPE, AND OTHER PACKING MATERIAL. REMOVE AS MUCH

SCARIFY SIDES OF PLANTING PIT PRIOR TO SETTING TREE.

REMOVE EXCESS SOIL APPLIED ON TOP OF THE ROOTBALL THAT

COVERS THE ROOT FLARE. THE PLANTING HOLE DEPTH SHALL BE

10) BACKFILL. AMEND AND FERTILIZE ONLY AS

RECOMMENDED IN SOIL FERTILITY ANALYSIS.


BURLAP FROM AROUND ROOTBALL AS IS PRACTICAL. REMOVE ALL NURSERY STAKES AFTER PLANTING. 5. FOR TREES 36" BOX/2.5" CAL. AND LARGER, USE THREE STAKES OR


(8) FINISH GRADE

9) ROOT BALL.

(13) FINISH GRADE.


DEADMEN (AS APPROPRIATE), SPACED EVENLY AROUND TREE. 6 STAKING SHALL BE TIGHT ENOUGH TO PREVENT TRUNK FROM BENDING, BUT LOOSE ENOUGH TO ALLOW SOME TRUNK MOVEMENT

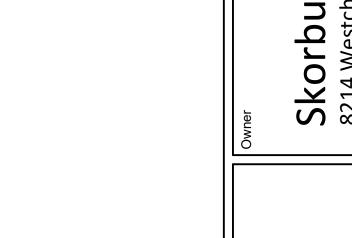

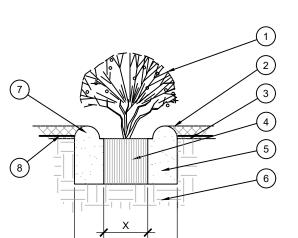


- (1) SHRUB, PERENNIAL, OR ORNAMENTAL GRASS.
- 2) MULCH, TYPE AND DEPTH PER PLANS. PLACE NO MORE THAN 1" OF MULCH WITHIN 6" OF PLANT CENTER.
- (3) FINISH GRADE
- (4) ROOT BALL.
- (5) BACKFILL, AMEND AND FERTILIZE ONLY AS
- (6) UNDISTURBED NATIVE SOIL.
- (7) 3" HIGH EARTHEN WATERING BASIN.
- (8) WEED FABRIC UNDER MULCH.

PLANTING AT PARKING AREA

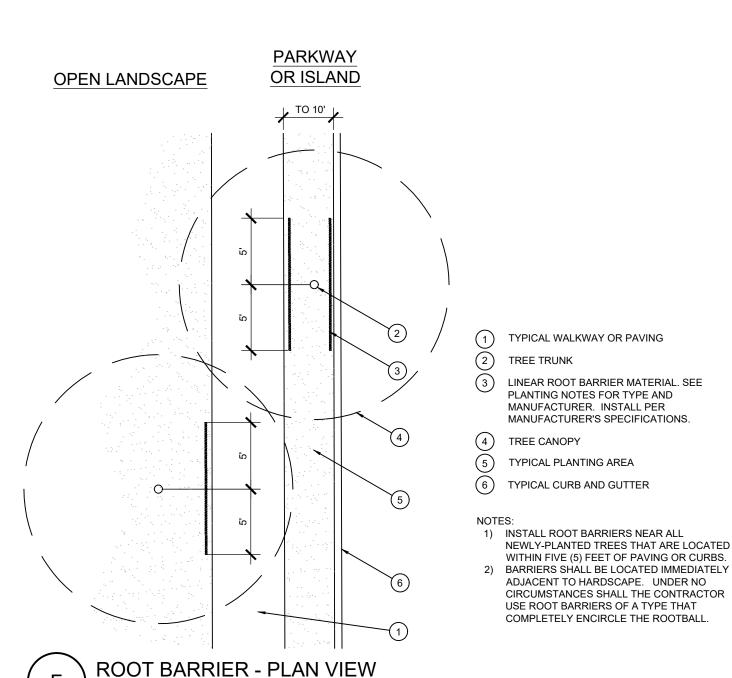



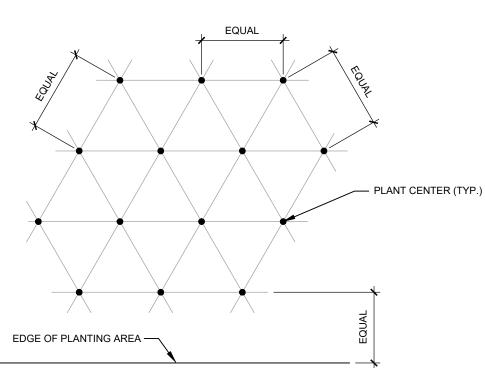

NOTE: ALL PLANTS SHALL BE PLANTED AT EQUAL TRIANGULAR SPACING (EXCEPT WHERE SHOWN ON PLANS AS INFORMAL GROUPINGS). REFER TO PLANT LEGEND FOR SPACING DISTANCE BETWEEN PLANTS.

1) STEP 1: DETERMINE TOTAL PLANTS FOR THE AREA WITH THE FOLLOWING FORMULA: TOTAL AREA / AREA DIVIDER = TOTAL PLANTS PLANT SPACING AREA DIVIDER

2) STEP 2: SUBTRACT THE ROW (S) OF PLANTS THAT WOULD OCCUR AT THE EDGE OF THE PLANTED AREA WITH THE FOLLOWING FORMULA: TOTAL PERIMETER LENGTH / PLANT SPACING = TOTAL PLANT SUBTRACTION

EXAMPLE: PLANTS AT 18" O.C. IN 100 SF PLANTING AREA, 40 LF PERIMETER STEP 1: 100 SF/1.95 = 51 PLANTS STEP 2: 51 PLANTS - (40 LF / 1.95 = 21 PLANTS) = 30 PLANTS TOTAL

0 O ail kwall

> **HARDSCAPE** PLAN

Date Comment

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