

CITY OF ROCKWALL AT CITY PLACE 385 SOUTH GOLIAD ROCKWALL, TEXAS 75087 972-771-7745

DEVELOPMENT APPLICATION

Site Plan	[] Landscape
[]Treescape	[] Building Elevations
[] Photometric /	Lighting Plan
	oles / Color Rendering
	<u> </u>


Property Information			e No.
Addition Name:	Address / L	ocation: 1529	Lagura Orive
Lot(s): Block:	Current Zoning:	mmeri	دسا
# of Acres: (.75) # of Lot	s: # c	of Units:	
Applicant Information			
Name: Rockwall RMKP	LP Company:		
Mailing Address: 6065 Silve	when his		
City: Garland	Sta	ate: TX Zip	75043
Phone: 972-226 -9342 Fax: 9	72-226-9342 En	nail: Kaveene	email-16 yahoo.com
Owner Information			9
Name: KAVEEN Patel	Company:	Rockwal	L'KMKP LP
Mailing Address: 605 Silv	releaf elm		
City: Garland	U st	ate:TX	Zip: 75043
Phone: 972-226-934 Eax:	Some En	nail: Kaveen	email-1 Gyahoo.co
Site Plan Application Submittal Require	ments		J
	st Submittal w/ application or ARB / P&Z Work Sessio		nd Submittal w/ revisions or P&Z
Submittal Fee	See Fee Schedule (attache	d)	
Site Plan	24" x 36", 15 Copies (folder	ed) 2	0 Large copies + one 8.5" x 11"
☐ Treescape Plan	24" x 36", 15 Copies (folde	ed) 2	0 Large copies + one 8.5" x 11"
☐ Landscape Plan	24" x 36", 15 Copies (folde	ed) 2	0 Large copies + one 8.5" x 11"
☐ Photometric Plan	24" x 36", 15 Copies (folde	ed) 2	0 Large copies + one 8.5" x 11"
☐ Building Elevations	24" x 36", 15 Copies (folder	ed) 2	0 Large copies + one 8.5" x 11"
☐ Building Samples / Color Rendering	Check w/ planning staff	•	WA

The application is not considered accepted by the City until the Planning Director and City Engineer has signed below.

City Engineering Signature

Planning Director Signature

JUN 1 5 7006

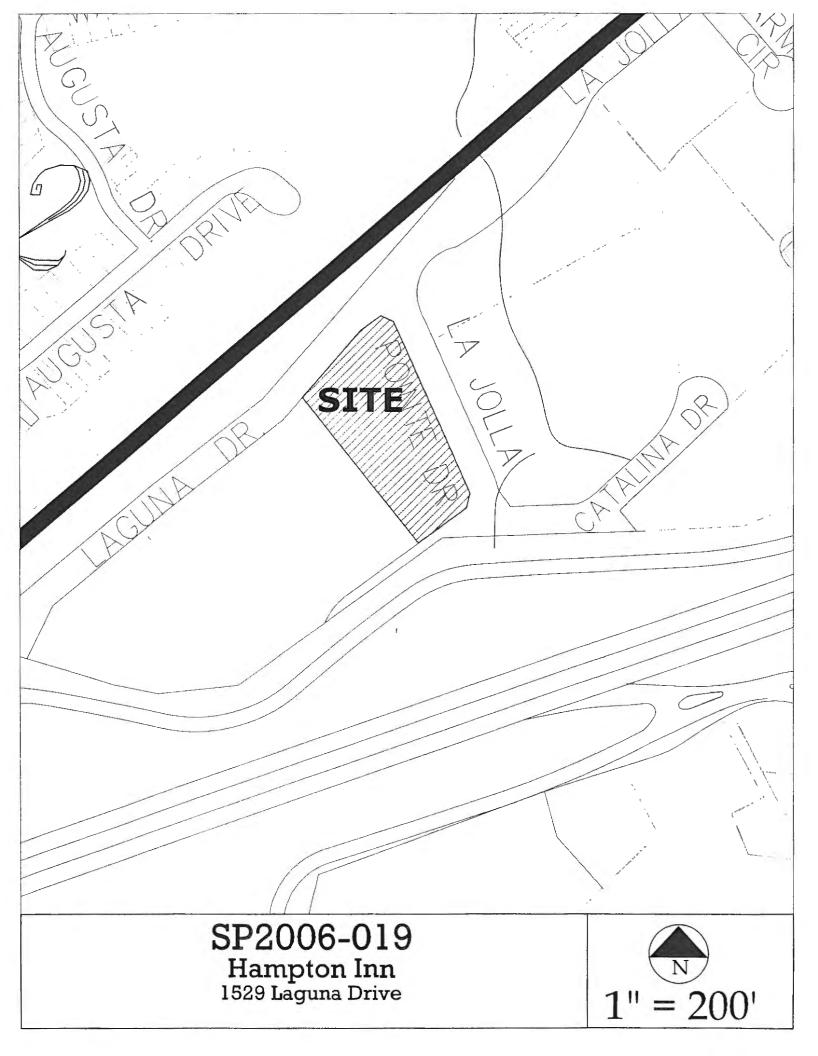

CITY OF ROCKWALL PLANNING AND ZONING COMMISSION MEMO

10-0/

AGENDA DATE: 8/29/2006

APPLICANT: Rockwall RMKP LP

AGENDA ITEM: SP2006-019; Hampton Inn

Discuss and consider a request by Rockwall RMKP, LP, for approval of a site plan for Hampton Inn, a proposed 62-room hotel located on Lot 4R, Block C, La Jolla Pointe Phase 1 Addition, being 1.751-acres zoned (C) Commercial district and situated within the IH-30 Overlay district, and take any action necessary.

BACKGROUND INFORMATION:

The applicant has submitted a site plan for a Hampton Inn hotel, a proposed 62-room hotel located on Lot 4R, Block C, La Jolla Pointe Phase 1 Addition. The required parking for the intended use is 62 spaces (one per room), and the applicant is providing 67 spaces, including three accessible spaces. The site will be accessed from Catalina Drive and Laguna Drive. Because of the grade differential and a slope easement, cross access into the adjacent Carrabba's site is impractical.

The site plan indicates approximately 34% of the site is open space, which exceeds the 15% City requirement for the Commercial District. As this site has no frontage on IH-30, 10-ft buffers are required along each of the three street frontages, with a minimum planting of 1 tree per 50 linear feet (or 15 trees for 716 linear feet). The landscape plan shows two, 3-inch caliper Live Oaks and thirteen, 3-inch caliper Cedar Elm trees within the landscape buffers, meeting City standards. 11 Crepe Myrtles and 6 Little Gem Magnolias, plus a large number of shrubs and other plantings, are also included in the buffers. Live Oaks are also provided in the parking lot and a row of Cedar Elms are planted in the rear of the building to comply with IH-30 Overlay standards.

The elevations propose a 3-story building consisting of natural stone, brick and stucco. The provided natural stone percentage is approximately 30% on each facade, and the building appears to comply with all other City requirements for the IH-30 Overlay district and commercial zoning. All rooftop and ground mounted mechanical equipment must be screened from all adjacent properties and right of ways. The building elevations have been reviewed and approved by the Architectural Review Board (ARB).

The photometric plan indicates pole lights with an overall mounting height of 27'6" (including base), which complies with the IH-30 overlay district. The maximum light level shall be 0.2-FC at all property lines, and all fixtures (including wall mounted) shall be full or partial cut-off as specified in the Unified Development Code.

RECOMMENDATIONS:

On 6/27/06 the Architectural Review Board recommended approval of the site plan and building elevations subject to review of final building materials.

Staff Recommends approval of the request with the following conditions:

- 1. Submittal and approval of engineering plans prior to replat.
- 2. Adherence to fire department requirements.
- 3. Submittal and approval of replat.
- 4. All rooftop and ground mounted mechanical equipment must be screened from all adjacent properties and right of ways.
- All exterior lighting shall be directed downward and be full or partial cut-off as defined by the Unified Development Code. No lighting shall exceed 0.2-FC when measured at the property line.

City of Rockwall Project Plan Review History

Development Services

Development Service

Applied Approved

Closed

Status

Expired

6/19/2006

KW

Page

1

Project Number SP2006-019
Project Name Hampton Inn

Type SITE PLAN

Subtype

Status Staff Review

Applicant Rockwall RMKP LP

Owner Rockwall RMKP LP

Site Address City
1529 LAGUNA DR ROCKWALL

State Zip

Zoning

Subdivision

LA JOLLA POINTE ADDN PH 1

Tract

Lot No 4-R

Parcel No

General Plan

Remarks

LA JOLLA POINTE ADDN PH 1 C 4-R 4118-000C-0004-00-0R

Block

Dates

Type of Review Contact Sent Due Received Elapsed Notes

ENGINEERING CT 6/21/2006

- Replat required.

- Engineering plans submittal and review required prior to approval of replat.
- Site plan does not meet fire department requirements!
- Maximum 3 spaces on a dead-end parking aisle.
- Verify drainage calculations inlets taking the design flows.
- Replace deep inlets with curb inlets.
- Get with fire dept on canopy. No utilities can be under this structure.
- See other misc. markups on site plan.
- Additional engineering comments with full engineering plans submittal.

FIRE

AA

6/21/2006

- Height of building requires 39-ft radius on firelanes.
- Fire department must approve overhead canopy in firelane (min. 14-ft clearance).
- Fire hydrant coverage is inadequate. All points of building must be within 150-ft of a firelane and hydrant.
- See engineering comments and markups for additional issues. Contact Ariana Adair, Fire Marshal with questions.

PLANNING

MH

6/21/2006

- Engineering and fire department issues affecting site layout (e.g. 39-ft radii on firelanes, no dead-end parking aisles with more than 3 spaces, etc).
- Can this lot accommodate required parking (65 spaces) after firelane and parking lot adjustments?
- Alternative dumpster location and/or orientation (away from street)?
- Lighting plan issues: Maximum 0.2-FC at all property lines.
- All fixtures to be full or partial cut-off (i.e. max. 1" reveal.), and must be oriented downward.
- Details on building and flag up-lighting? Accent lighting is generally ok, but cannot glare into ROW or adjacent properties.
- Elevations appear to meet City requirements except for more than 10% "secondary materials" (EIFS). Consider replacing with stucco or additional stone, brick materials. 3/4 vote

				Dates			
						Status	
Type of Review	Contact	Sent	Due	Received	Elapsed	Notes	Remarks

- by Council required for variance approval!

 Landscaping looks ok, except must be changed with any changes to site plan.

 Additional tree at west side of Catalina drive entrance?

Submit 15 large copies and one 8.5"x11" copy of each revised plan no later than Wednesday, July 5th for consideration at the 7/11 P&Z and 7/17 Council (if required) meetings.

Report By: Michael Hampton

SP-2006-019

- · ENGIHEEMER REQ.
- · FIRE DEPT. PER.
- · TURN DUMPSTER AWAY FROM STREET. · EIFS NOT ALLOWED FOR THAN 10070.

ARB – ARCHITECTURAL REVIEW BOARD

Review by this Board is required if the subject project lies within any Overlay District (Scenic Overlay, SH 66, I-30, SH 205, FM 549, SH 276, etc). The ARB will generally hold their meeting the same evening as the Planning & Zoning Commission Work Session, providing their recommendation directly to the Commission and applicant.

Additional information may be required for site plans in an Overlay district, including but not limited to, building material and color samples, color elevations, artistic renderings of project, etc. Check with Planning Staff prior to submittal.

ADMINISTRATIVE SITE PLAN APPROVAL

- ↓ In limited circumstances, as allowed by the Unified Development Code, a site plan application may be approved
 "administratively" by City Staff. To be eligible for administrative approval, the subject tract must NOT have "PD" Planned
 Development zoning and must NOT be located within any Overlay district.
- While there is no formal application deadline and the approval process is typically faster for an "administrative" site plan, that approval is often contingent on other applications (platting, engineering, etc).
- The application fee for administrative site plans shall be the same as other site plans (see attached fee schedule).
- ← Only four (4) copies of each required drawing are necessary with the initial submittal.

APPLICATION FEE SCHEDULE (RES. NO. 05-22)

Zoning Application Fees

	. Zoning Change (Including SUP and PD requests)	\$200 + \$15/Acre*
•	PD Development Plans (if required)	\$200 + \$15/Acre*
	PD Site Plans	\$250 + \$20/Acre*

Platting Application Fees

A 40	Tropitoti I coo	
•	Master Plat	\$100 + \$15/Acre*
•	Preliminary Plat	\$200 + \$15/Acre*
•	Final Plat	\$300 + \$20/Acre*
•	Replat	\$300 + \$20/Acre*
•	Amending or Minor Plat	\$150
•	Plat Reinstatement Request	\$100
•	Filing Fees (Invoiced at time of filing)	Actual Cost

Site Plan Application Fees

	Site Plan (Incl. Elevations, Landscaping, Tree Plan, etc)	\$250 + \$20/Acre*
•	Amended Site Plan, Elevations or Landscaping Plan	\$100

Other Fees

•	Tree Removal Application	\$75
•	Front Yard Fence Application	\$75 (+ Bldg Permit)
•	Zoning Verification Letter	\$25
•	Applicant Appearance Fee	\$25 0

^{*}In determining the fee, please use the exact acreage when multiplying by the per acre amount. For requests on less than one acre, only the "base fee" is required.



RECEIPT

Project Number: SP2006-019

Job Address: 1529 LAGUNA DR

ROCKWALL, TX

Receipt Number: B39067 Printed: 6/19/2006 2:45 pm

Fee Description Account Number Fee Amount

SITE PLANNING

01-4280

\$ 285.00

Date Paid: 6/19/2006 12:00:00AM

Paid By: Kaveen Patel Pay Method: Check 1006

Received By: KW

WADHWA AND ASSOCIATES, INC.


Designers and Planners
1220 Blalock # 230 Houston, TX 77055

(713) 465-0009 FAX (713) 465-2391 FAX TRANSMITTAL MICHAEL HAMPTON 972-771-7748 (F) DATE: 2.24.06 HAMPTON INN & SUITES - POCKWALL, TX. PROJECT: Total Number of Pages Including This Page: WE TRANSMIT: > herewith as per your request DESCRIPTION: IT WAS A PLEASURE TO VIST WITH YOU ON PHONE LAST WEEK SOME TIME AGO. PLEASE AS DISCUSSED ATTA CHED PRELIMINARY THE SITE PLANal YOUR COMMENTS. BE A- 60 THIS WILL ROOM. STORY

PROJECT WITH 62 PARKINGS.

Q----

SENDER: MAHESH

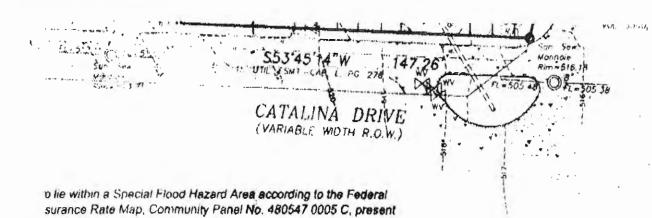

stamped "Arthur Surveying Company" unless otherwise noted. All Iron ped "Arthur Surveying Company".

te of Lot 4R, Block C of La Jolla Pointe Addition, Cabinet E, Page 276.

Humpton THN

Site Plan Checklist

Site plans or development plans shall include the following information:

Ge	neral	
Ø	Applicant's name, address, phone number (where the mail	ey can be reached), and valid e-
N	Other Consultants (Architect, Landscape Architect, etc.	c)
	Development location (including subdivision name, lo	•
	Locator Map	to brook mannoon, and address)
	Proposed use or uses	
	Zoning district	
	Table showing area requirements (min./max) and wha	t is proposed:
_	Lot size	Building size
	Building coverage	Floor to Area Ratio
	• Height	Impervious cover
	Open space	impervious cover
	Location of all existing buildings or structures on lot	
	Adjacent land uses and improvements	
	Scale: one inch (1") equals twenty feet (20'), thirty fee	et (30'), forty feet (40'), etc.
	Location of any on site items	(0 0), 1020) 2000 (10), 000
	Location and type of existing and proposed scre	ening, including screening of
	dumpsters and mechanical equipment, parking areas,	
	storage, etc.	Toping toping toping
Uti	ilities & Drainage	
	Existing and proposed water mains (including size and	l valve locations).
	Water meter size and location.	,
	Existing and proposed sewer mains (including size, m	anholes, and cleanout)
	Sewer service size (provide cleanout at property line).	
	Existing and proposed utility easements	
	Easements (utility, access, drainage, etc.)	
	Existing and proposed fire hydrants (including any near	arby off-site hydrants)
	Existing and proposed fire lines and appurtenances	,
	Location and size of irrigation meters	
	Location and size of grease and sand traps	
	One Hundred (100) year flood elevation (if in flood-pr	rone area)
	Existing and proposed culver	
	Location of Detention, Retention or other significant of	lrainage features.
A	1 1 1	

Meet Engineering

2110	circulation and parking
	Drive approach dimensions and radii (both inside and outside turning radii)
	Delineation and width of internal circulation roadways
	Location and dimensions of ingress/egress
	Distance between driveways and intersecting streets
	Number of required parking spaces and number of parking spaces provided, including
	handicapped parking spaces.
	Parking dimensions (typical 9' x 20')
	Stacking spaces and drive-through land location
	Building entrances
	Fire lanes meeting fire code standard (typically 24 feet wide), (fire lanes to be
	shaded)
	Delivery truck docks & loading docks
	Locations of dumpsters and /or compactors
	Medians, islands, barriers, and channelization
	Width of adjacent streets, alley, or other access abutting property
	Length, width, and taper of turn bays
	A detailed landscape plan in conformance with Article VIII of the City of Rockwall
_	Unified Development Code shall be submitted with the site plan (also see landscape
	standards in Overlay district if applicable).
	Project name, street address, and lot and block description
	Locations and dimensions of proposed landscape buffer strips
	Location of existing boundary lines and dimensions of the lot
	Location of significant drainage features
	Location and size of existing and proposed street and alleys, utility easements, driveways and sidewalks on or adjacent to the lot.
_	Complete description of plant materials shown on the plan, including names,
	locations, container and caliper sizes at installation, heights spread and spacing.
	Quantity of each plant material proposed.
	Complete description of landscaping and screening to be provided in or near off-street
	parking and loading areas, including information as to the amount (in square feet) of
	landscape areas, parking area, off-street parking and loading spaces.
	Location and description, by type and size, of existing protected trees (4" or larger)
	proposed to be retained. Such trees will be marked and drip line of said trees will be
	protected.
_	Size, height, location, and material of proposed seating, lighting, planter's sculptures,
	water features and landscape paving and other site amenities.
	Visibility of triangles on the lot for driveway intersections and public streets.
	Landscape table with calculation of landscaped area provided.
	Location and size of all existing and planned structures on the subject property.
	Trees must be planted at least five (5) feet from water, sewer and storm sewer lines.
	11000 mass of planted at least 11.0 (2) feet from water, sewer and storm sewer filles.

Muf over-must somedown


	Where site lighting is required or proposed, lighting/photometric plan shall be submitted.
9	Show lighting levels in foot-candles (FC) measured throughout the site and extended to all property lines of the subject property. A maximum level of 0.2-FC should be
ď	measured at all property lines. Show location of all exterior lighting, including pole mounted, wall mounted,
	signage, etc. Indicate overall mounting height of all proposed light fixtures Indicate wattage of all light sources
O	Elevation drawings and/or cut sheets for proposed light fixtures on/with the photometric plan.
\checkmark	Specifications and descriptions of all proposed building materials on all buildings.
	Indicate overall height of proposed structure (s).
-	Indicate roofing materials, colors, etc.
	Indicate percentage of all materials used (exclusive of door and windows). Dimension all elements of building, including vertical and horizontal articulation (s).
	Material samples and color elevations/renderings required for all buildings subject to
	Architectural Review Samples - (@meeting?,
	ee Survey and Treescape Plan
	A Tree Survey shall be submitted, drawn to the same scale as the site plan, showing the building pad, pavement areas, and other construction features which will disturb the land indicated.
	Date, scale, north point, names and contact information of both the property owner and the person preparing the plan.
	Project name, street address, and lot and block description.
	Location of all existing or proposed structures, or building pads as shown on the
П	grading plan. All improvements properly dimensioned and referenced to property lines.
	Setback and yard requirements.
	Existing and proposed site elevations, grades, major contours and limits of
_	construction.
	Location of existing or proposed utilities and easements. Location and description, by type of size, of existing protected trees (4" or larger) proposed to be retained. Such trees shall be marked and drip line of said trees shall be
	protected prior to and during all construction, including all dirt work.
	Location of all protected trees (4" or larger) trees to be removed from the site and the
	proposed locations of all replacement trees.
Ш	Table showing inches or trees being removed and replaced.

NOAKES ENGINEERING COMPANY, INC. 3603 B WEST PIONEER PARKWAY ARLINGTON, TEXAS 76013 PHONE: METRO 817-261-7900/FAX 817-275-2154

FAX COVER SHEET

DATE 8/1/00 TIME 11:30 Abn
NUMBER OF PAGES INCLUDING COVER PAGE
RE: Hampton Inn-La ble Pointour FILE NO. 010-7194
TO: Michael Hampton
COMPANY: C.O. R Planning
FAX#: (972)-71-7748
FROM: Jessica Kilgore
SPECIAL INSTRUCTIONS: 200 clarity as needed
special instructions: Jos Clarity as needed from PDF files Sent this morning
Thanks
Jessieu

Note: The information contained in this facsimile message is confidential information intended only for the individual or entity named above. If you have received this communication in error, please notify us. THANK YOU.

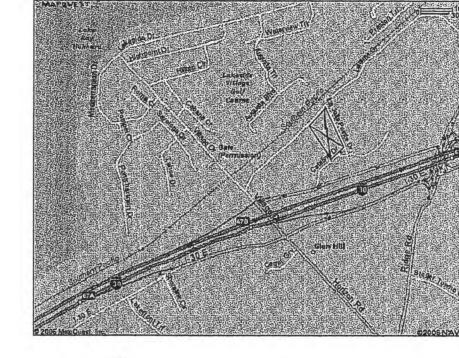



SITE BENCH MARK - FOUND BOX CUT TOP OF WEST CURB OF LAKESIDE DR. APPROX. 120-FT NORTH OF RAILROAD AT NW CORNER OF LA JOLLA POINTE ADDIT., PH II, ELEVATION = 503.23 CONTOURS ARE @ 1-FOOT INTERVALS TOPOGRAPHIC SURVEY FURNISHED BY ARTHUR SURVEYING CO., INC.

SITE AREA: 76,274 SQ. FT. BUILDING PAD AREA: 13,203 SQ. FT 37,130 SQ. FT. PAVED AREA: NET CHANGE IN PAVED IMPERVIOUS SURFACE: + 66%

PARKING SP. REQUIRED: 65 PARKING SP. PROVIDED: 65 (3 H/C)

LANDSCAPING AREA: 15%MIN = 0.263 AC 34% PROVIDED = 0.596 AC OPEN AREA 15' FRONT YARD 10' REAR SETBACK 10' SIDE SETBACK


FIRE LANE / HYDRANTS: . CONCRETE FOR FIRE LANE TO BE 6" THICK 3000 PSI CONCRETE. REST OF THE DRIVE TO BE 5" THICK 3000 PSI CONCRETE.

- 2. FIRE LANE SHALL BE MARKED WITH 6" RED NO PARKING" EVERY 10 - 25' OF LENGTH ALONG THE FIRE LANE. PLACE ON VERTICAL SURFACE OF THE CURB WHERE PRESENT.
- 3. FIRE HYDRANT TO HAVE 15' OF CLEAR SPACE ON EITHER SIDE FOR VISIBILITY 2' OF CLEARANCE MIN. ALL AROUND FOR PROPER OPERATION OF HYDRANT.
- 4. APPROVED PERMANENT BLUE REFLECTIVE MARKERS SHALL BE PROVIDED IN THE PAVING ADJACENT TO ALL HYDRANTS IN CENTER OF THE STREET / FIRELANE FOR EASE IN LOCATING HYDRANTS.

JUN 1 5 2006

2006 019

SITE PLAN SCALE: 1" = 30'-0"Scale 1" = 30'

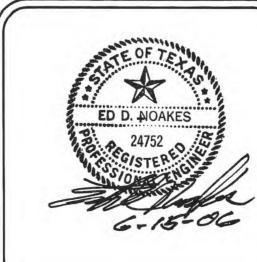

FILE NO. 06 - 7194

NOAKES 3603 V


COMPANY, KWY, STE B


COPER:


6005 GARL


SCALE


SHEET NO.

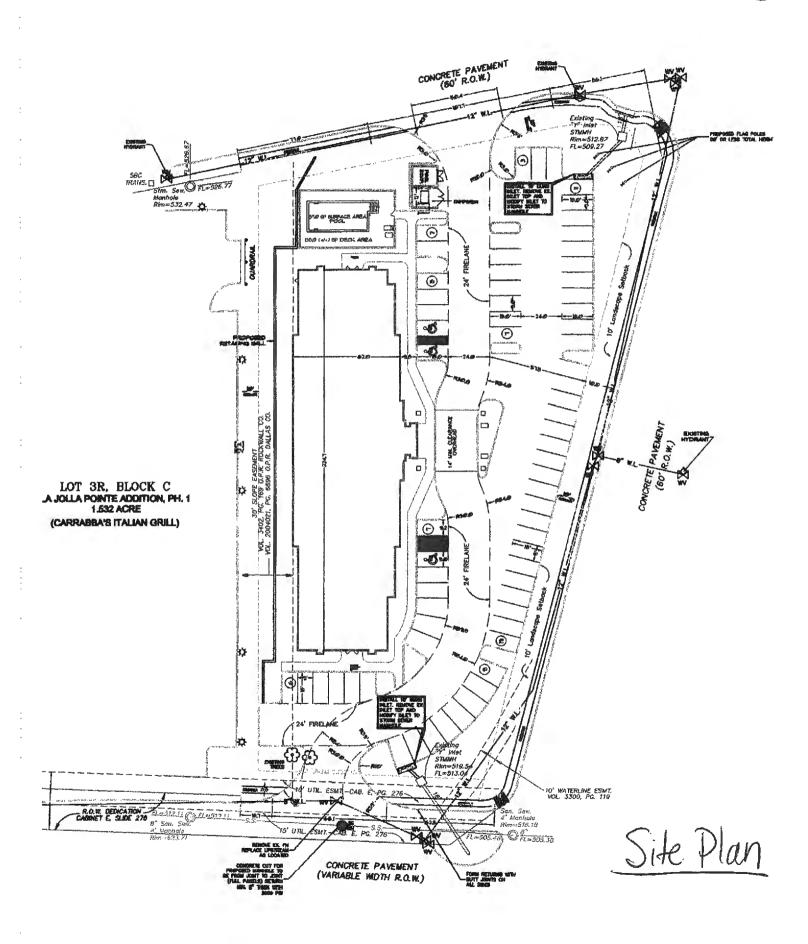

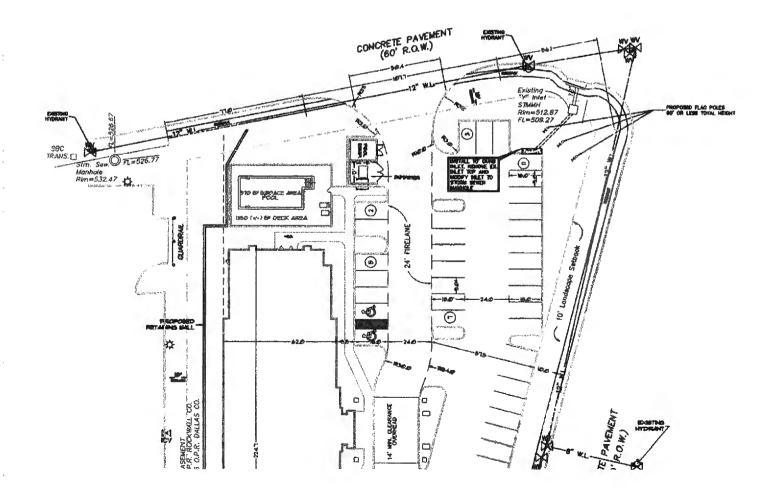

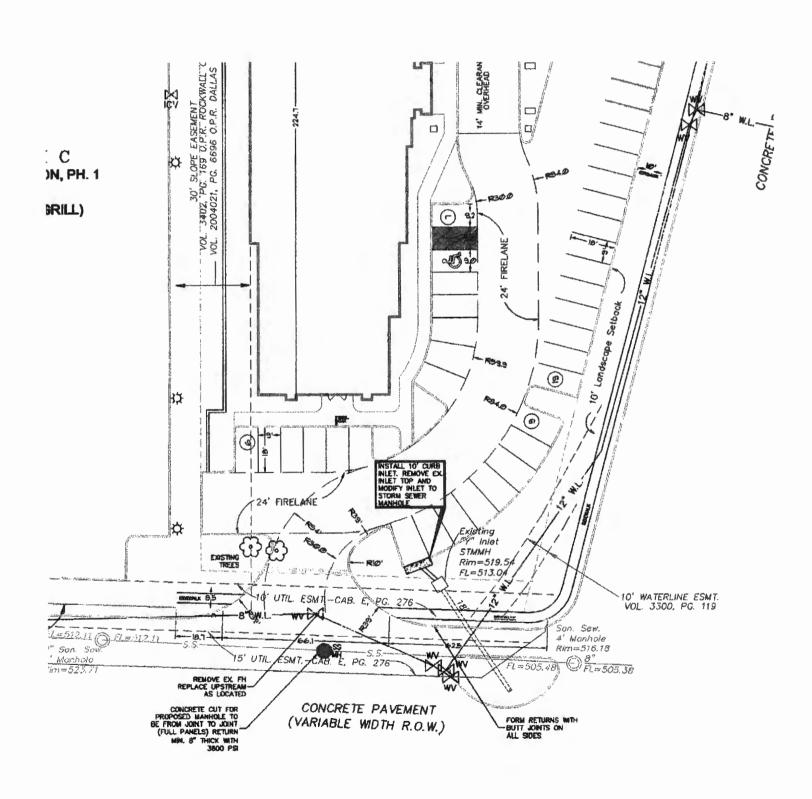

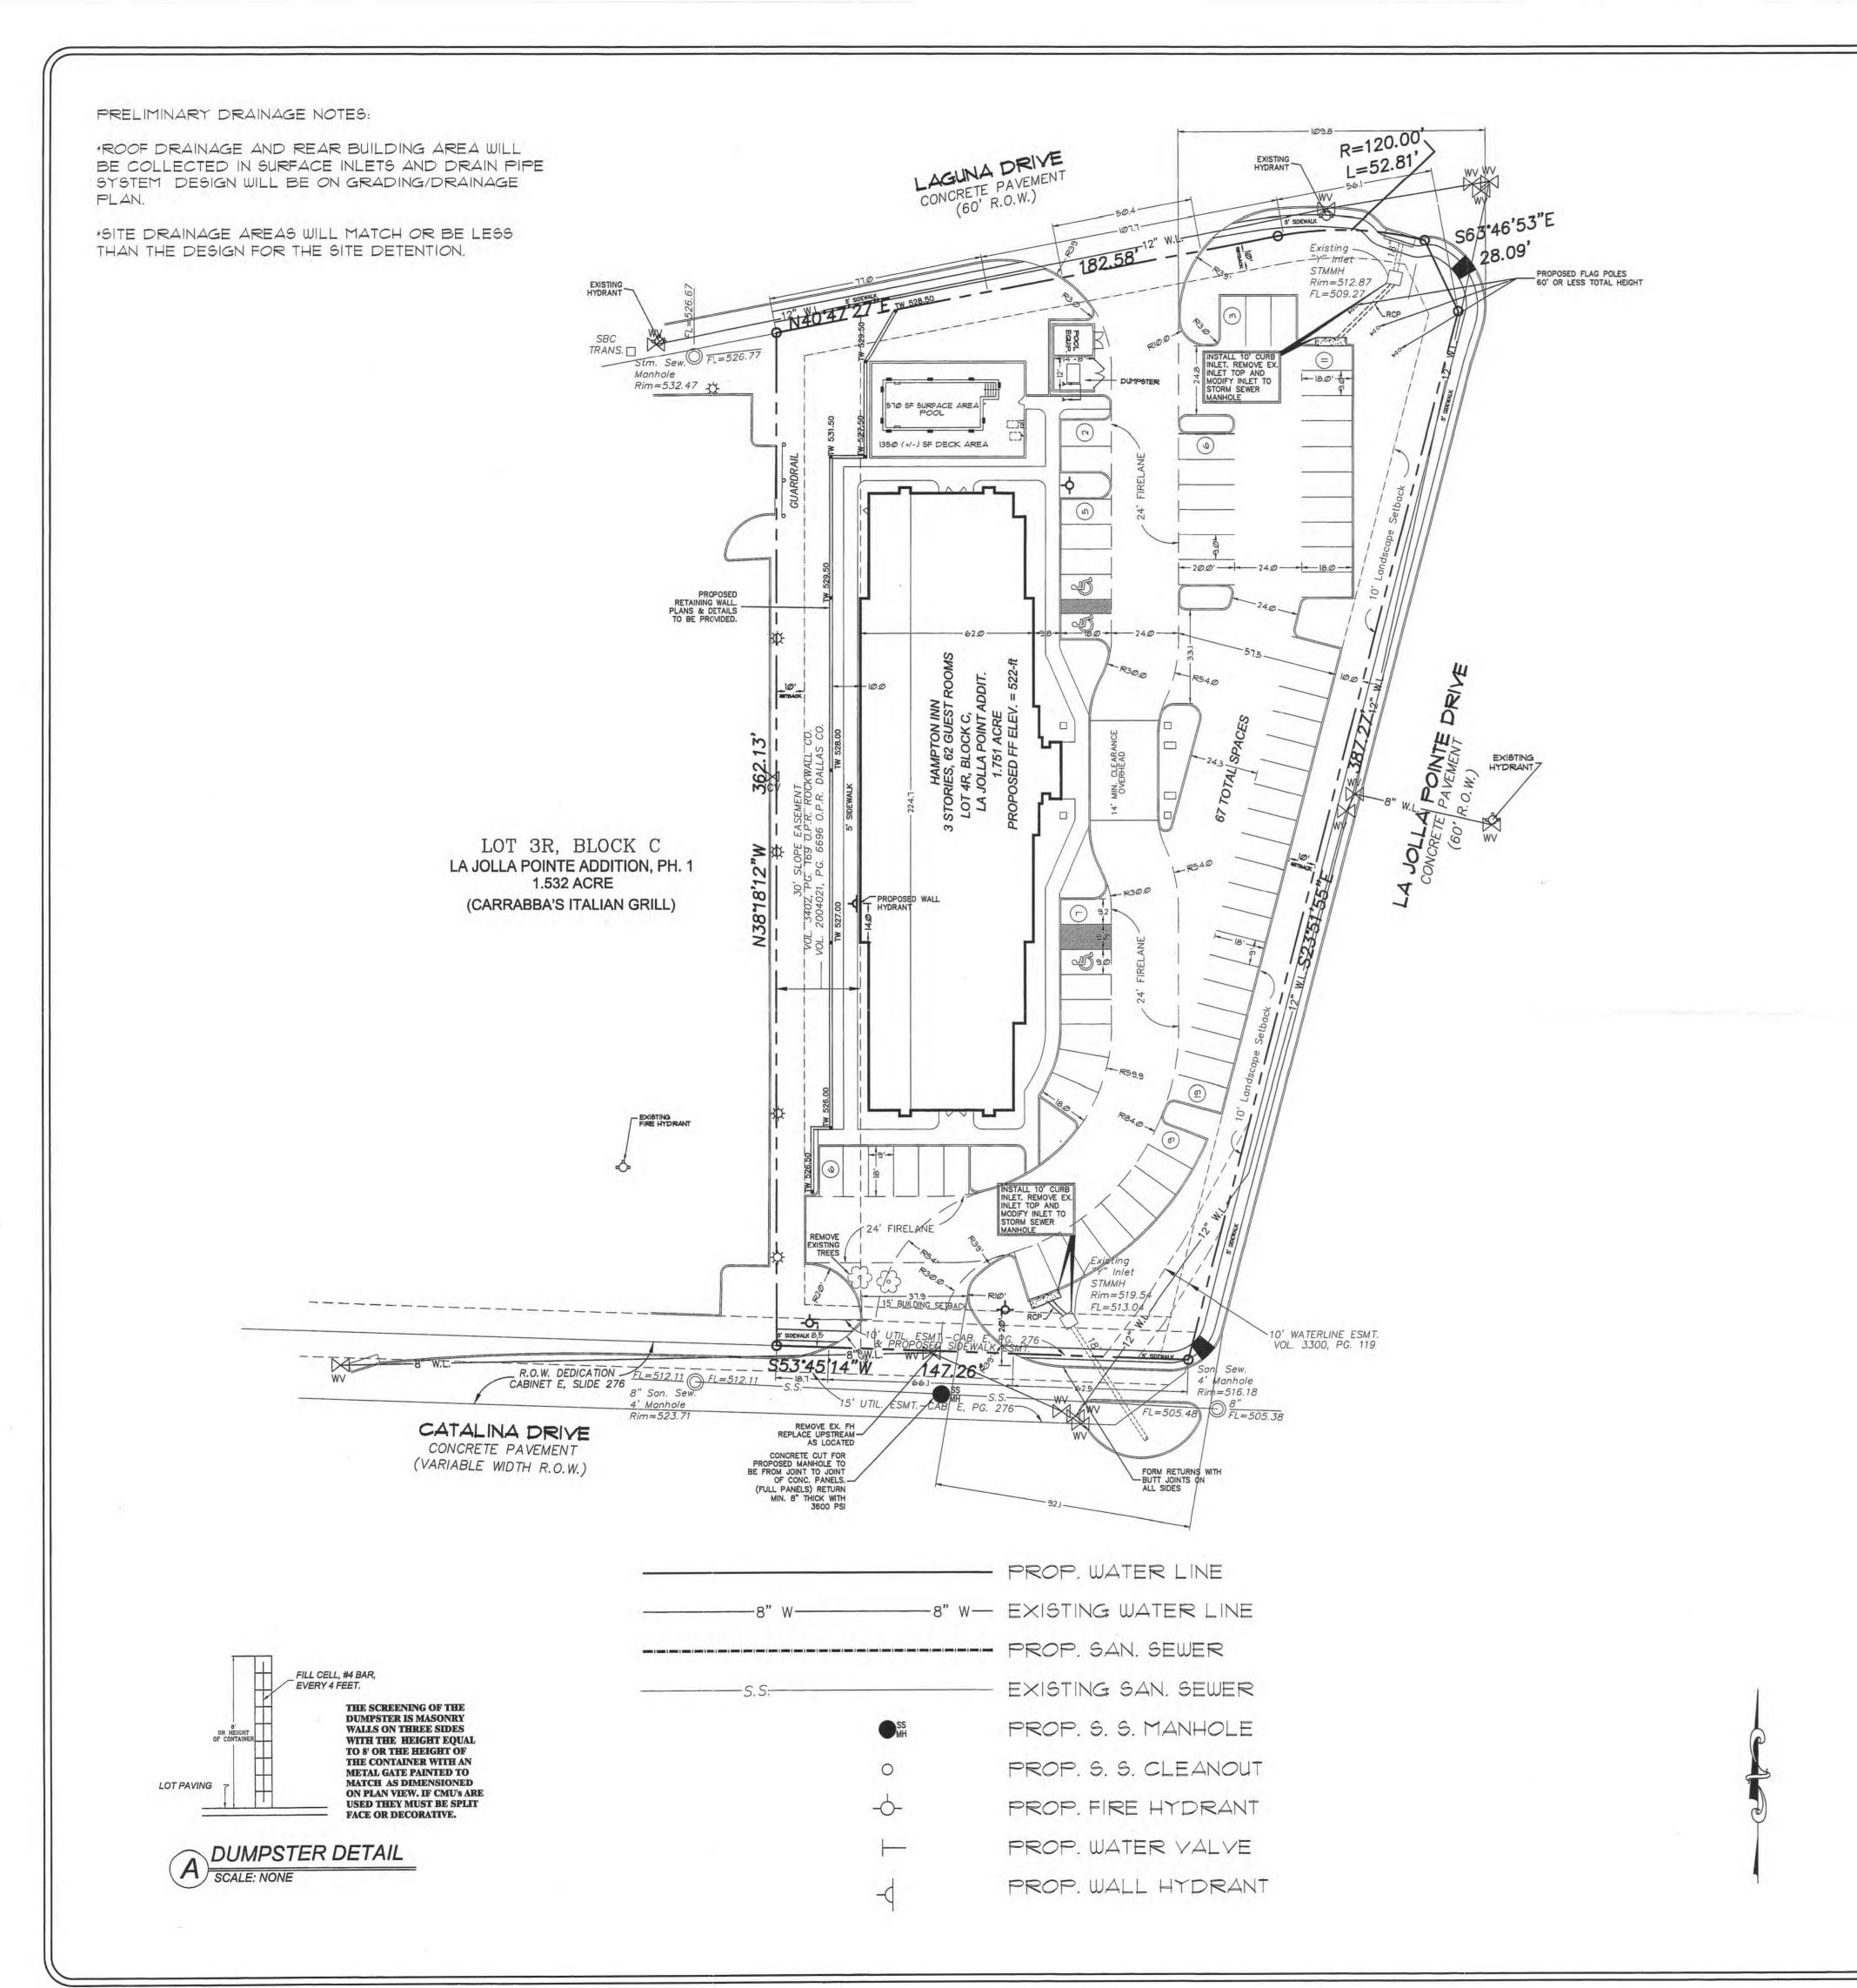

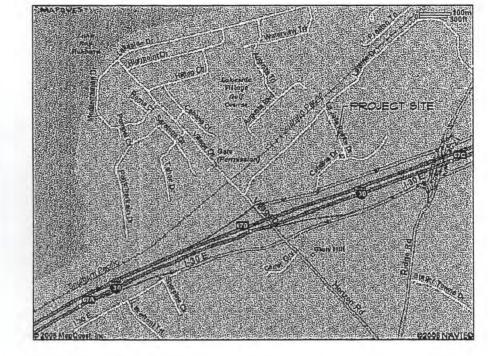



SITE BENCH MARK - FOUND BOX CUT TOP OF WEST CURB OF LAKESIDE DR APPROX. 120-FT NORTH OF RAILROAD AT NW CORNER OF LA JOLLA POINTE ADDIT., PH II, ELEVATION = 503.23 CONTOURS ARE @ 1-FOOT INTERVALS TOPOGRAPHIC SURVEY FURNISHED BY ARTHUR SURVEYING CO., INC.

SITE AREA: 76,274 SQ. FT. BUILDING PAD AREA: 13,203 SQ. FT. PAVED AREA: 37,130 SQ. FT. NET CHANGE IN PAVED IMPERVIOUS SURFACE: + 66%

PARKING SP. REQUIRED: 65 PARKING SP. PROVIDED: 67 (3 H/C)

LANDSCAPING AREA: 15%MIN = 0.263 AC OPEN AREA 34% PROVIDED = 0.596 AC 15' FRONT YARD 10' REAR SETBACK 10' SIDE SETBACK

FIRE LANE / HYDRANTS: 1. CONCRETE FOR FIRE LANE TO BE 6" THICK 3600 P31 CONCRETE. REST OF THE DRIVE TO BE 5" THICK 3000 PSI CONCRETE

2. FIRE LANE SHALL BE MARKED WITH 6" RED STRIPE WITH 4" WHITE LETTERS STATING "FIRE LANE NO PARKING" EVERY 10 - 25' OF LENGTH ALONG THE FRE LANE. PLACE ON VERTICAL SURFACE OF THE CIRB WHERE PRESENT.

3. FIRE HYDRANT TO HAVE 15' OF CLEAR SPACE ON ETHER SIDE FOR VISIBILITY 5' OF CLEARANCE MIN. A_L AROUND FOR PROPER OPERATION OF HYDRANT.

4. APPROVED PERMANENT BLUE REFLECTIVE MARKERS SHALL BE PROVIDED IN THE PAVING ADJACENT TO ALL HYDRANTS IN CENTER OF THE STREET / FIRELANE FOR EASE IN LOCATING HYDRANTS.

5. 14-FOOT MINIMUM OVERHEAD CLEARANCE SHALL HAVE SIGN POSTED TO NOTIFY OF PARKING. STOPPING AND LOADING RESTRICTIONS.


SITE PLAN

SCALE: 1" = 30'-0"

Scale 1" = 30'

AUG 2 3 2006

\$2006 019

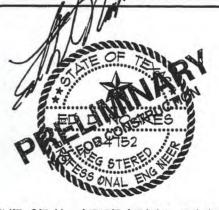

THE SEAL APPEARING ON THIS DOCUMENT WAS AUTHORIZED BY ED D. NOAKES, P.E. 24752 ON 8-22-2006

FILE NO. 06 - 7194

NOAKES 3603 W

KAVEEN

MR.

DEVELOPER:

6005 SILVERLEAF GARLAND, TEXAS

VE, ROCKWALL, COCK C
TE ADDITION
TALL, TEXAS

POINTE I LOT 4R, JOLLA PO 'Y OF RO

JOIL


I

ENGINEERING COMPANY, II W. PIONEER PKWY, STE B LINGTON, TEXAS 76013


3 W. PIONEER PKWY, STARLINGTON, TEXAS 7601

SCALE 1" - 30'

SHEET NO.

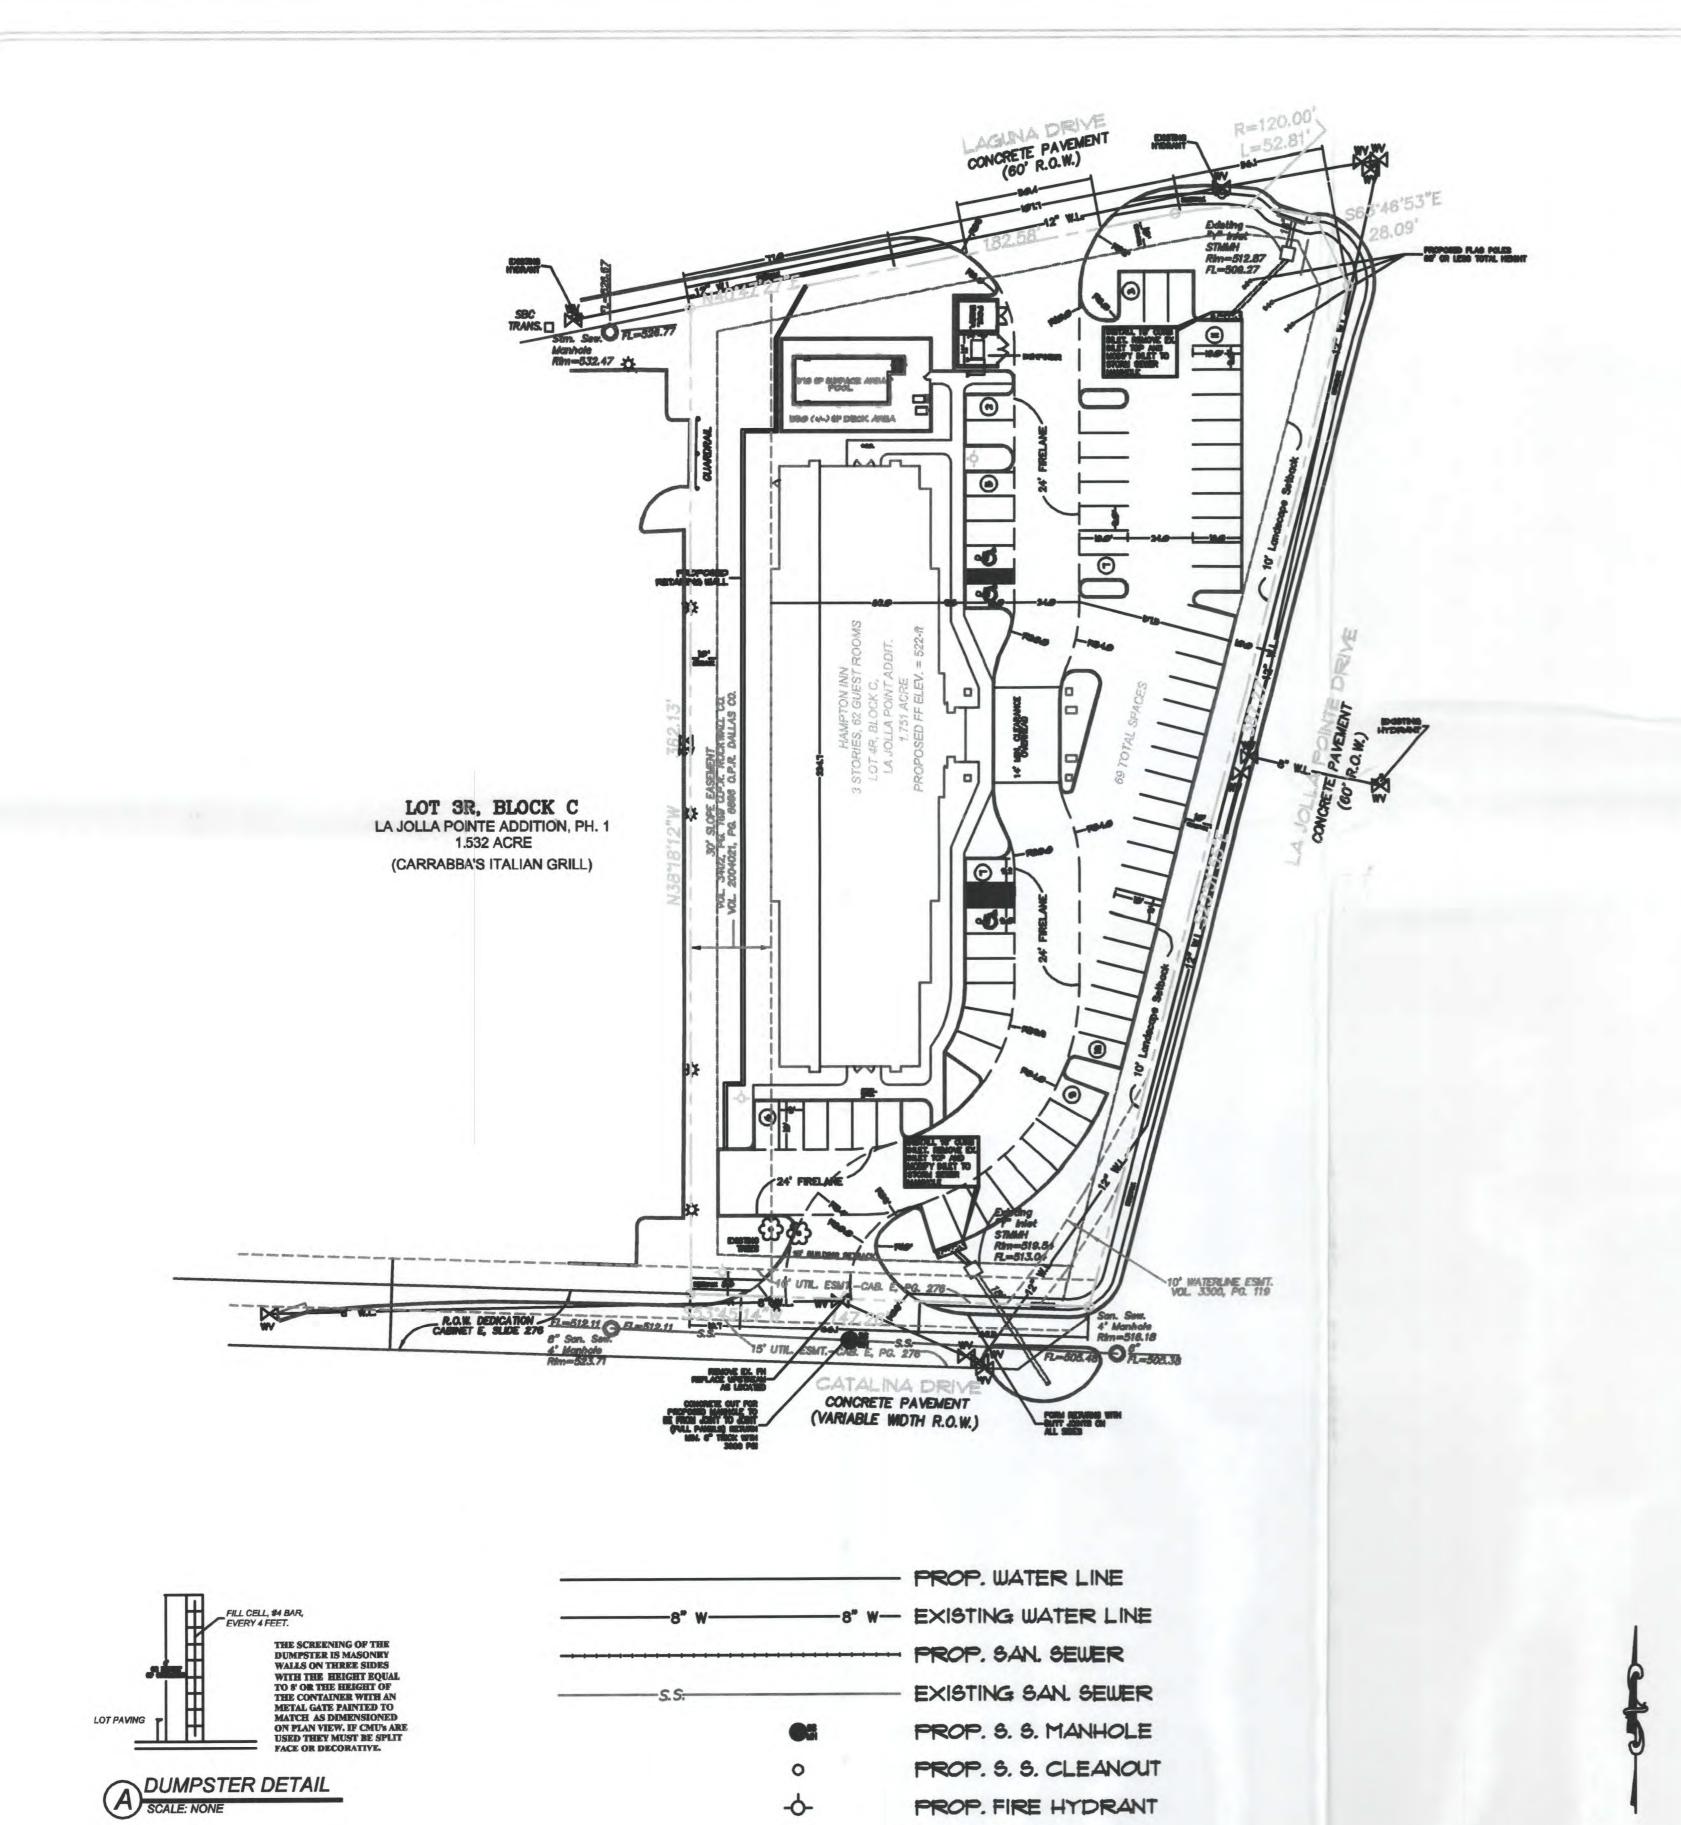

PROP. WATER YALVE

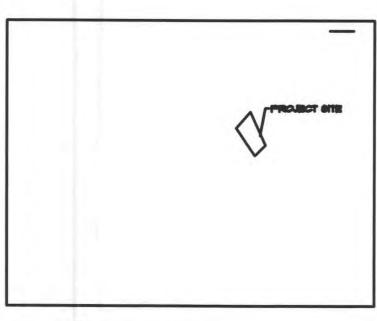



SITE BENCH MARK - FOUND BOX OUT TOP OF WEST CURB OF LAKESIDE DR APPROX 120-FT NORTH OF RAILROAD AT NW CORNER OF LA JOLLA POINTE ADDIT, PH II, ELEVATION = 50323 CONTOURS ARE . I-FOOT INTERVALS TOPOGRAPHIC SURVEY FURNISHED BY ARTHUR SURVEYING CO., INC.

76,274 SQ. FT. BUILDING PAD AREA: 13,203 SQ. FT. PAYED AREA: 37,130 SQ. FT. NET CHANGE IN PAYED IMPERVIOUS SURFACE: +66%

PARKING SP. REQUIRED: 65 PARKING SP. PROVIDED: 69 (3 H/C)

LANDSCAPING AREA: 15%MIN = 0.263 AC OPEN AREA 34% PROVIDED = 0.596 AC 15' FRONT YARD 10' REAR SETBACK

FIRE LANE / HYDRANTS:
1. CONCRETE FOR FIRE LANE TO BE 6' THICK 3600 POI CONCRETE. REST OF THE DRIVE TO BE 5' THICK 3000 PSI CONCRETE.

2. FIRE LANE SHALL BE MARKED WITH 6' RED STRIPE WITH 4' WHITE LETTERS STATING FIRE LANE NO PARKING' EVERY 10 - 25' OF LENGTH ALONG THE FIRE LANE. PLACE ON VERTICAL SURFACE OF THE CURB WHERE PRESENT.

3. FIRE HYDRANT TO HAVE IS' OF CLEAR SPACE ON EITHER SIDE FOR YISIBILTY 5' OF CLEARANCE MIN. ALL AROUND FOR PROPER OPERATION OF HYDRANT.

4. APPROVED PERMANENT BLUE REFLECTIVE MARKERS SHALL BE PROVIDED IN THE PAYING ADJACENT TO ALL HYDRANTS IN CENTER OF THE STREET / FIRELANE FOR EASE IN LOCATING HYDRANTS.

5. 14-FOOT MINIMUM OVERHEAD CLEARANCE SHALL HAVE SIGN POSTED TO NOTIFY OF PARKING, STOPPING AND LOADING RESTRICTIONS.

FILE COPY

AUG 0 1 2006

PRELIMINARY NOT FOR CONSTRUCTION

06-7194 SCALE


SHEET NO.

1" - 30'

FILE NO.

SITE PLAN

SCALE: 1" = 30'-0"Scale 1" = 30'

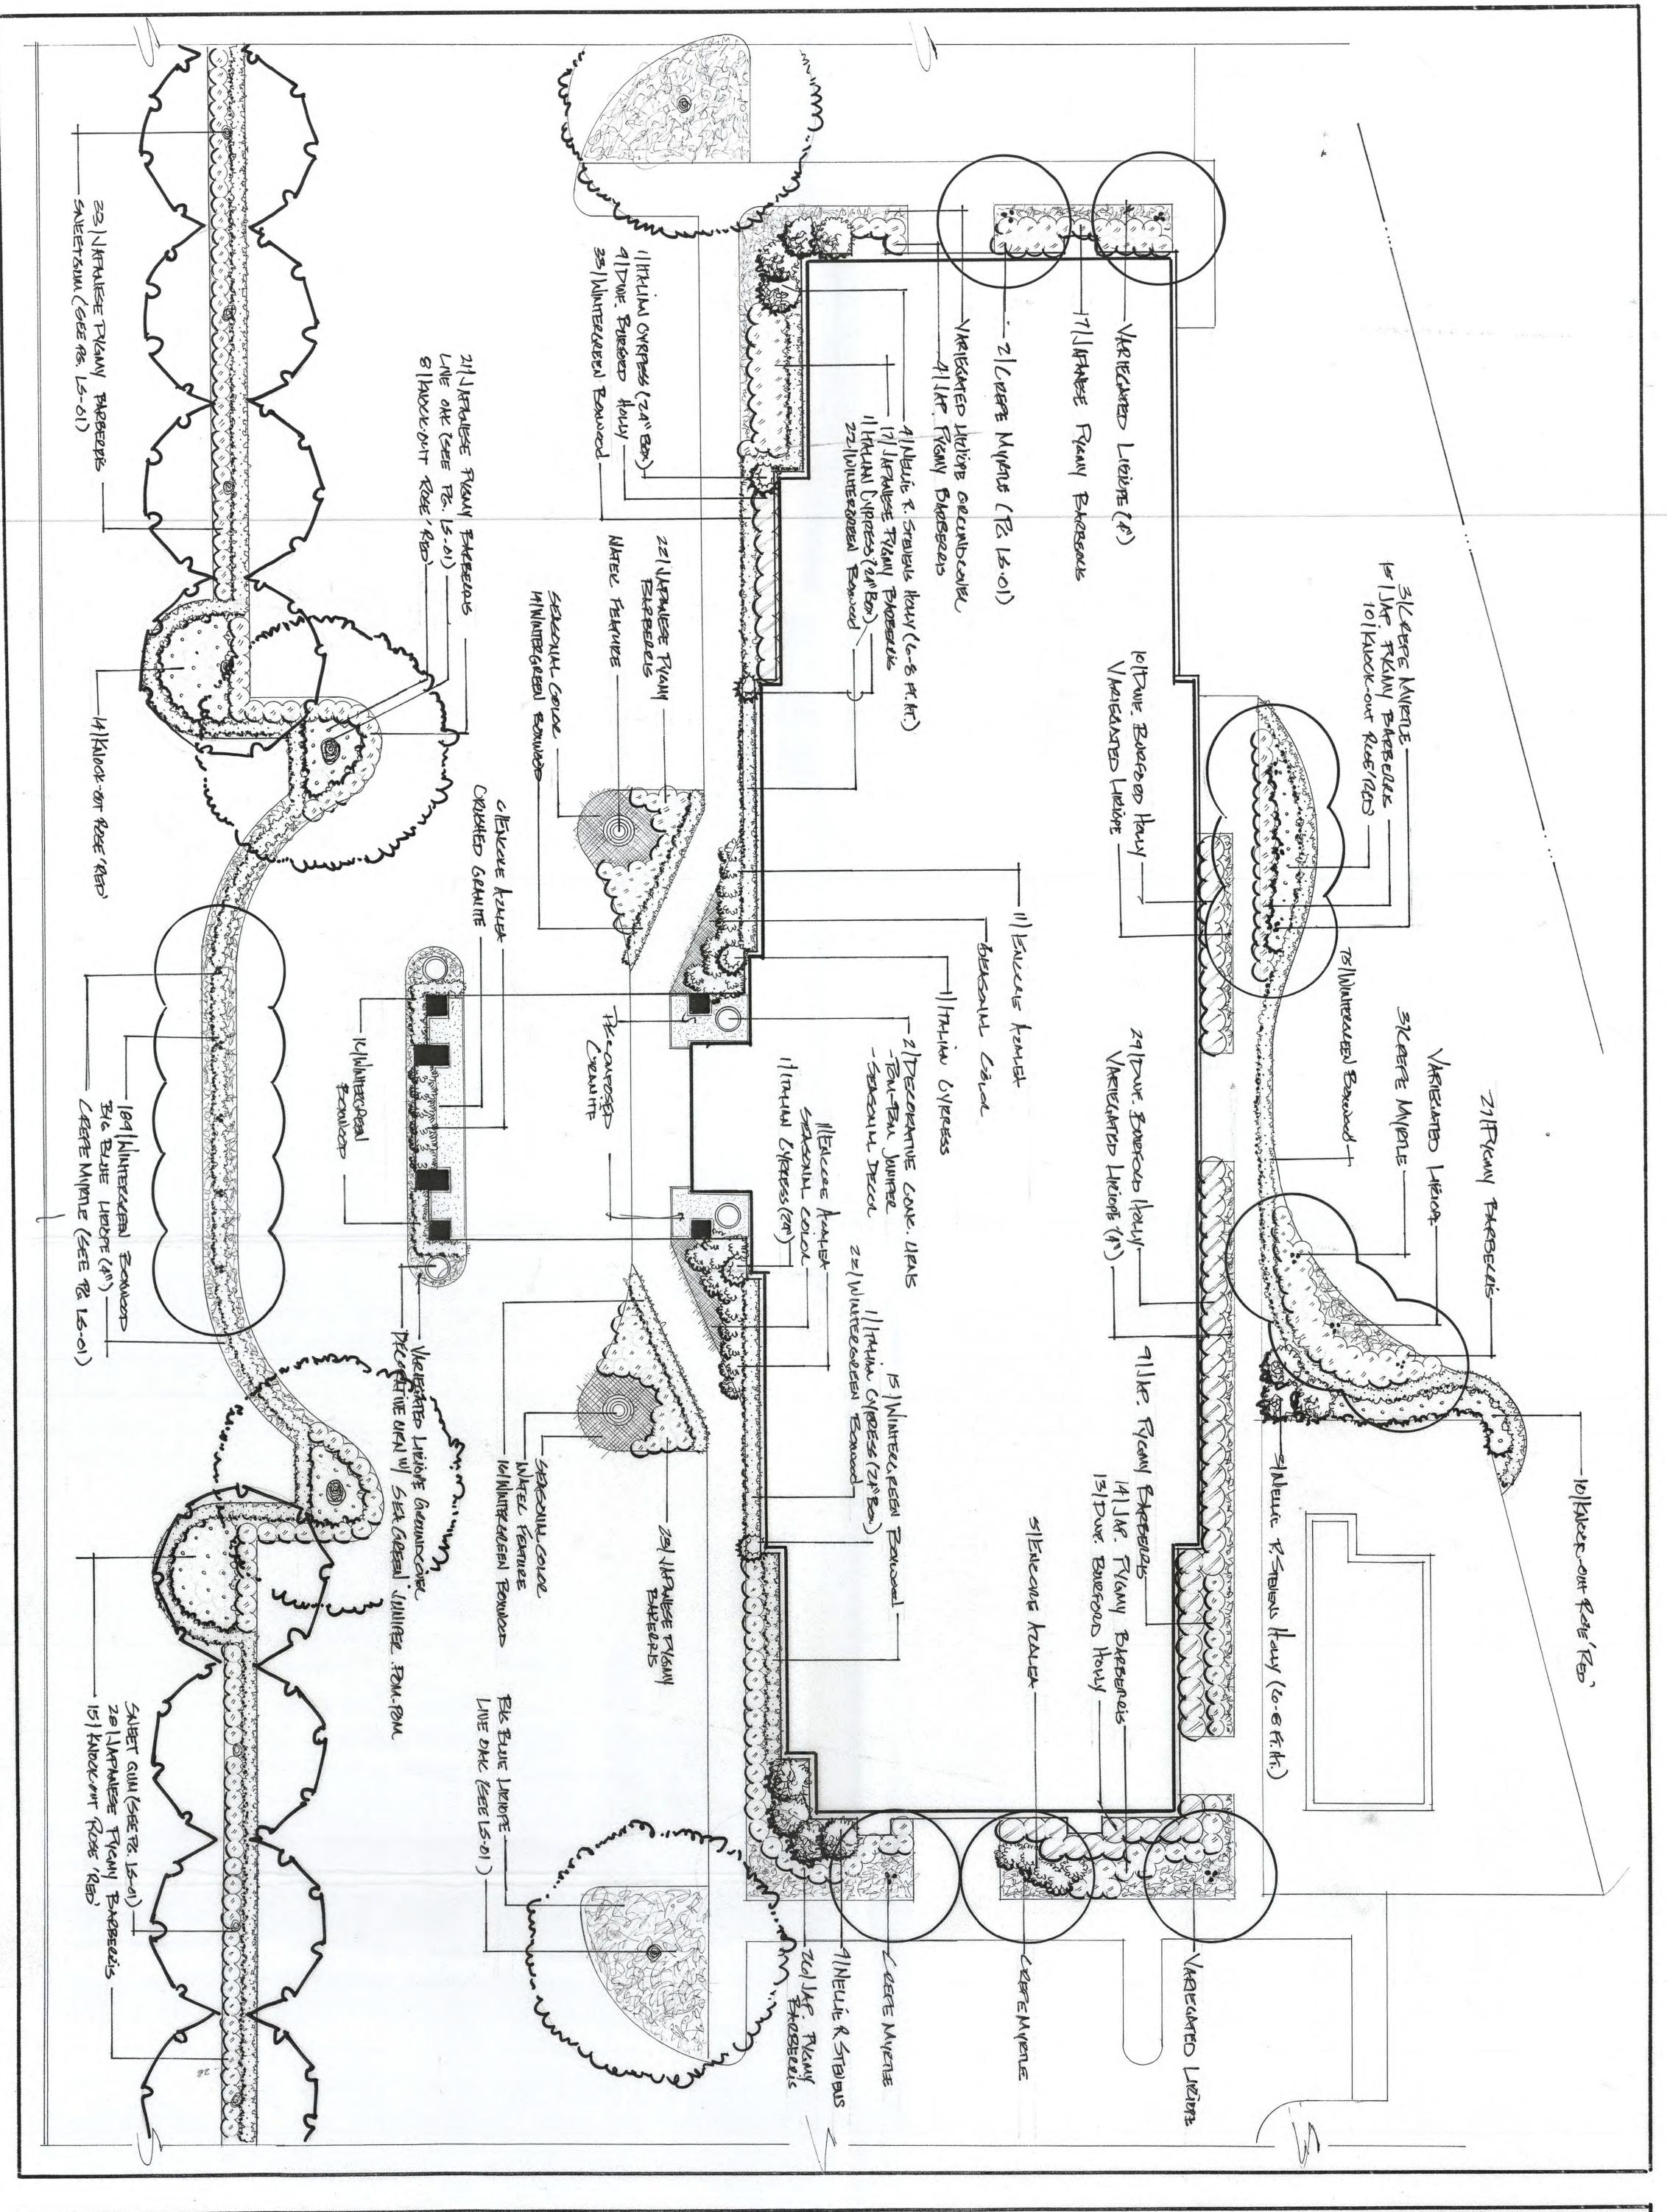



All plans and specifications are the property of *Unique Creations* and are not intended to be used for the solicitation of bids or for private use. These provisions may be waived if a design fee has been paid in full to *Unique Creations*.

Attn. Commercial Printers: DO NOT REPRODUCE COPIES OF THIS PLAN!


All plans and specifications should be approved by local City offices and /or Homeowner Associations to ensure all buildings, structures, fences, pools, decks, retaining walls, sidewalks, and irrigation systems meet all local building codes and requirements. *Unique Creations* is not to be held responsible.




LA JOHAPT. DR. & LAGUNA DR.

PECKWAH, TX

CEATRAL FLANTING FLAN

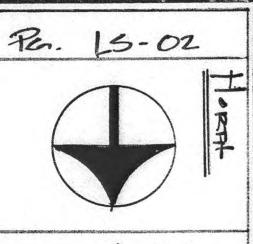

SCALE: 1"=10'0"

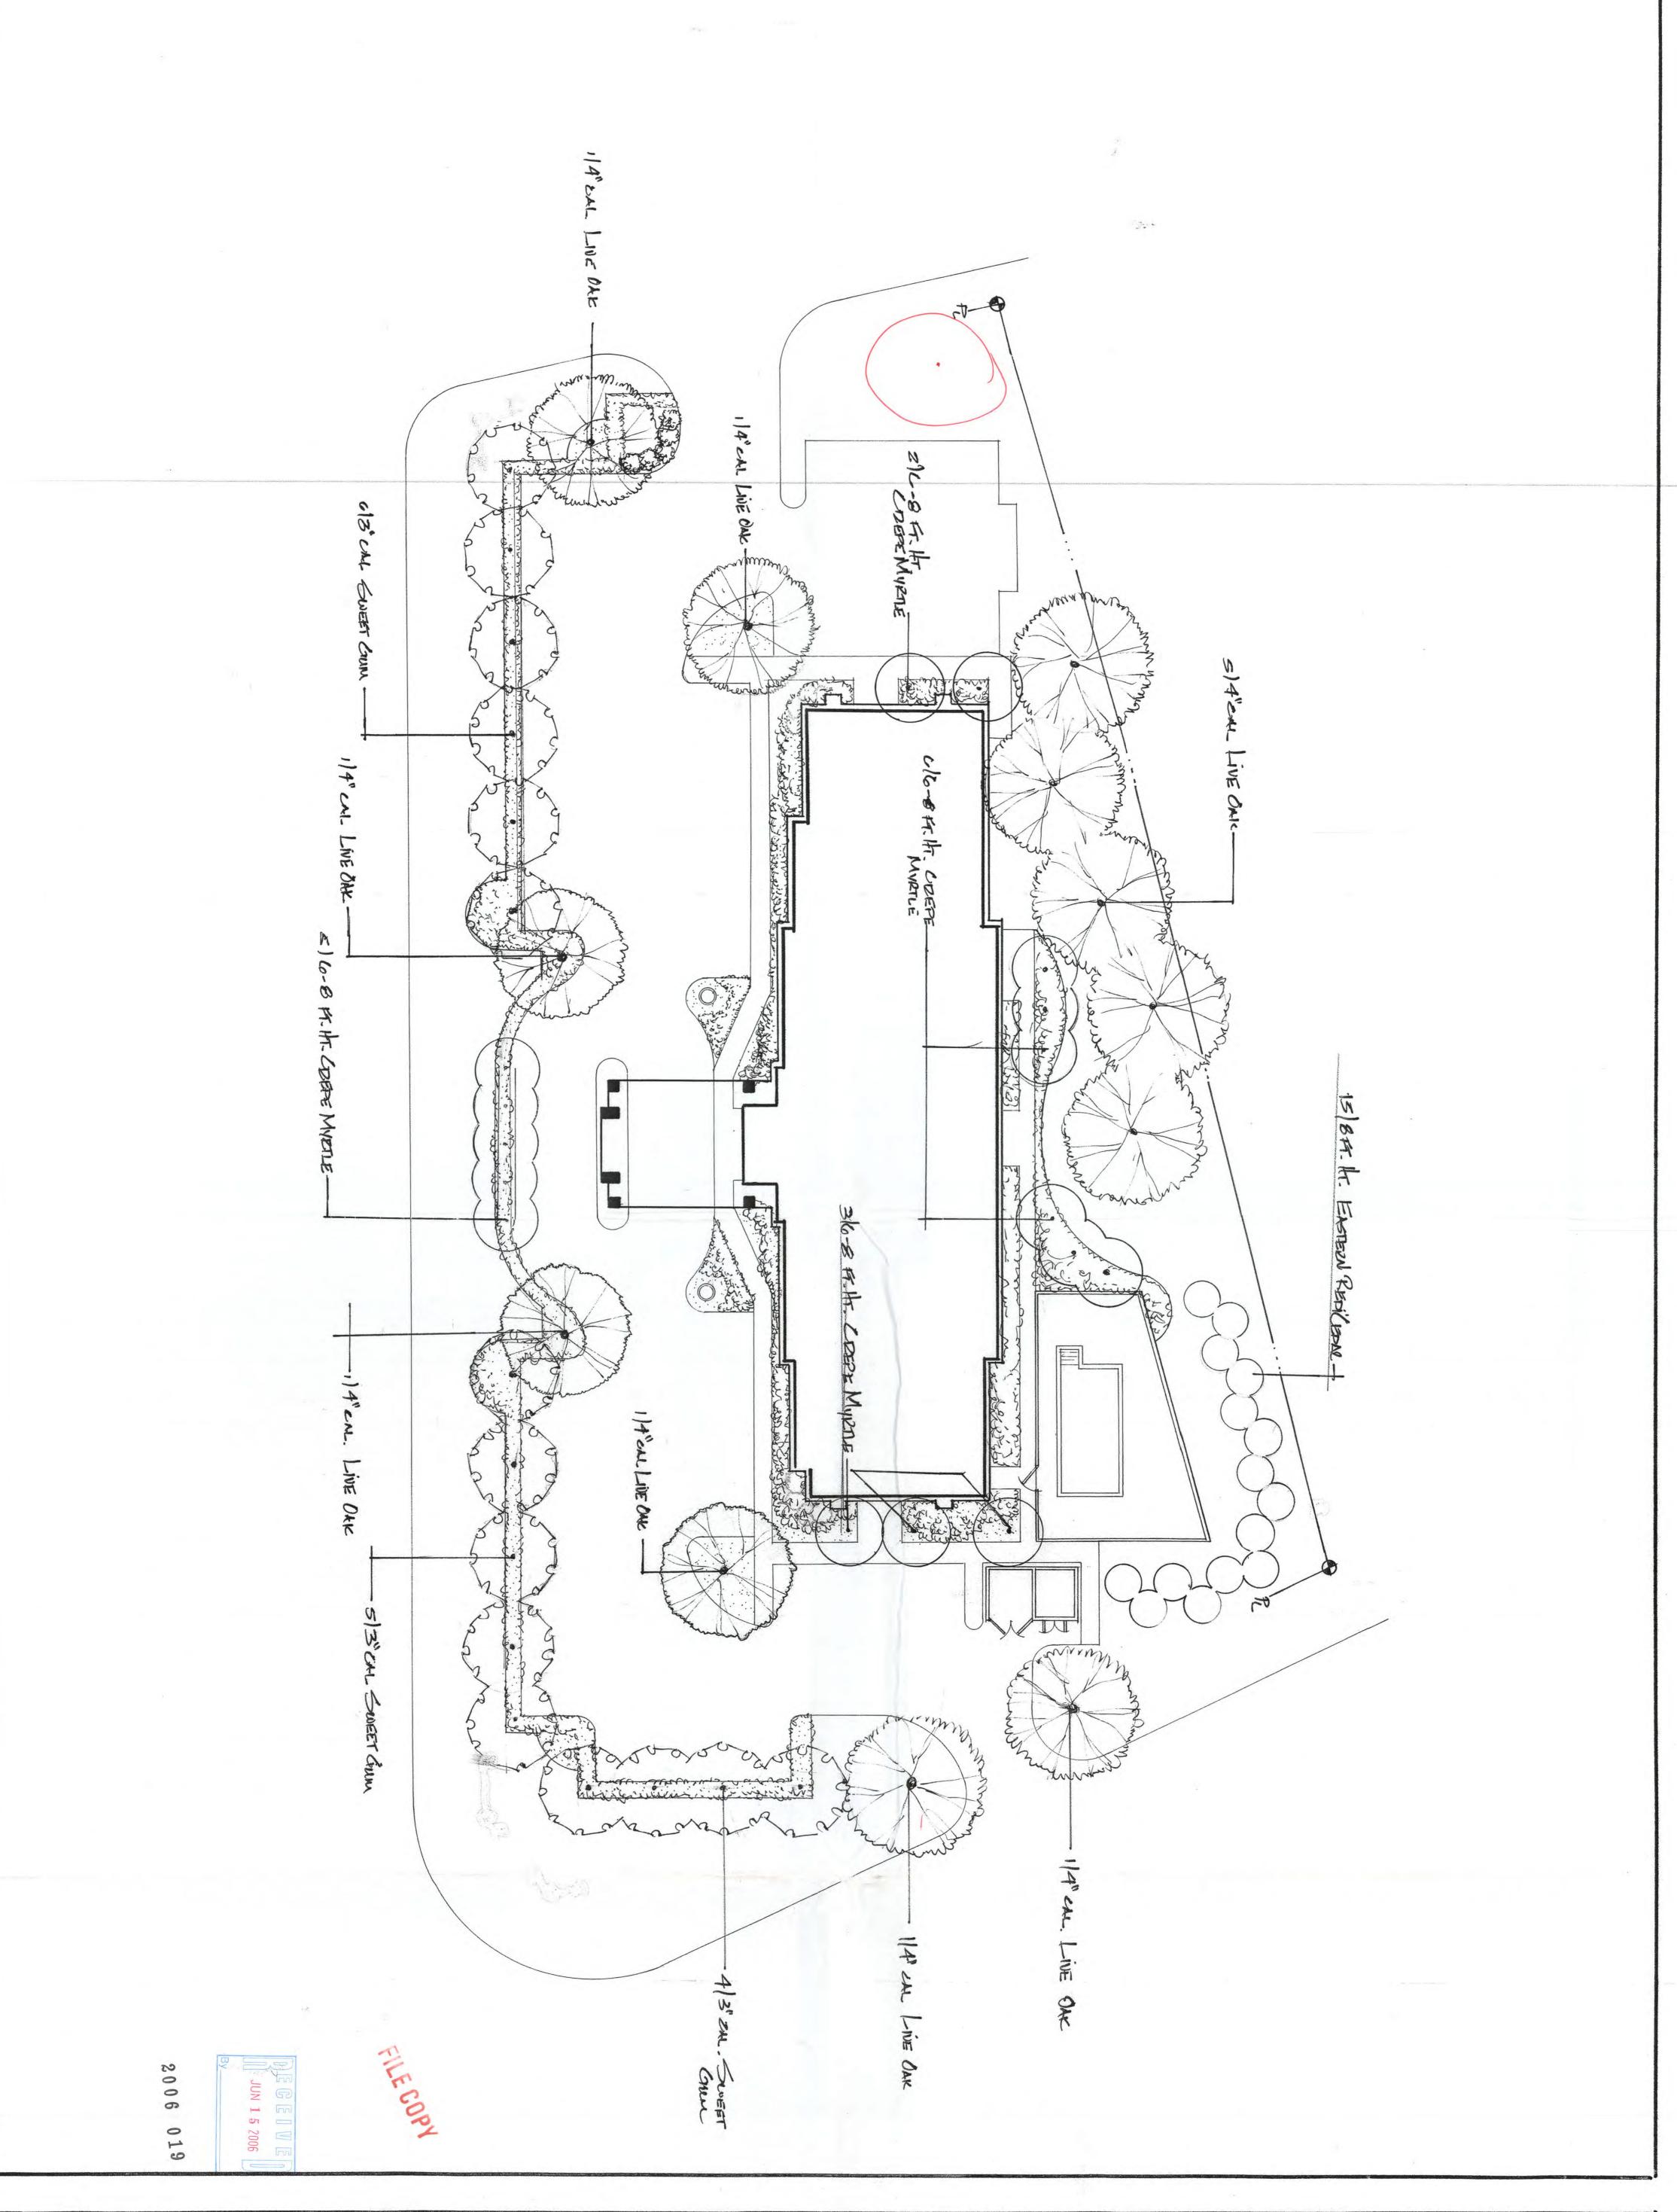



All plans and specifications are the property of *Unique Creations* and are not intended to be used for the solicitation of bids or for private use. These provisions may be waived if a design fee has been paid in full to *Unique Creations*.


Attn. Commercial Printers: DO NOT REPRODUCE COPIES OF THIS PLAN!

All plans and specifications should be approved by local City offices and /or Homeowner Associations to ensure all buildings, structures, fences, pools, decks, retaining walls, sidewalks, and irrigation systems meet all local building codes and requirements. *Unique Creations* is not to be held responsible.




LA JOHN PT. DR. & LAGMAN DR ROCKWALL, TX

SHADE & ORNAMENTAL'S

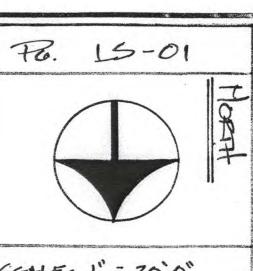

SCALE: 1" = 20'0"

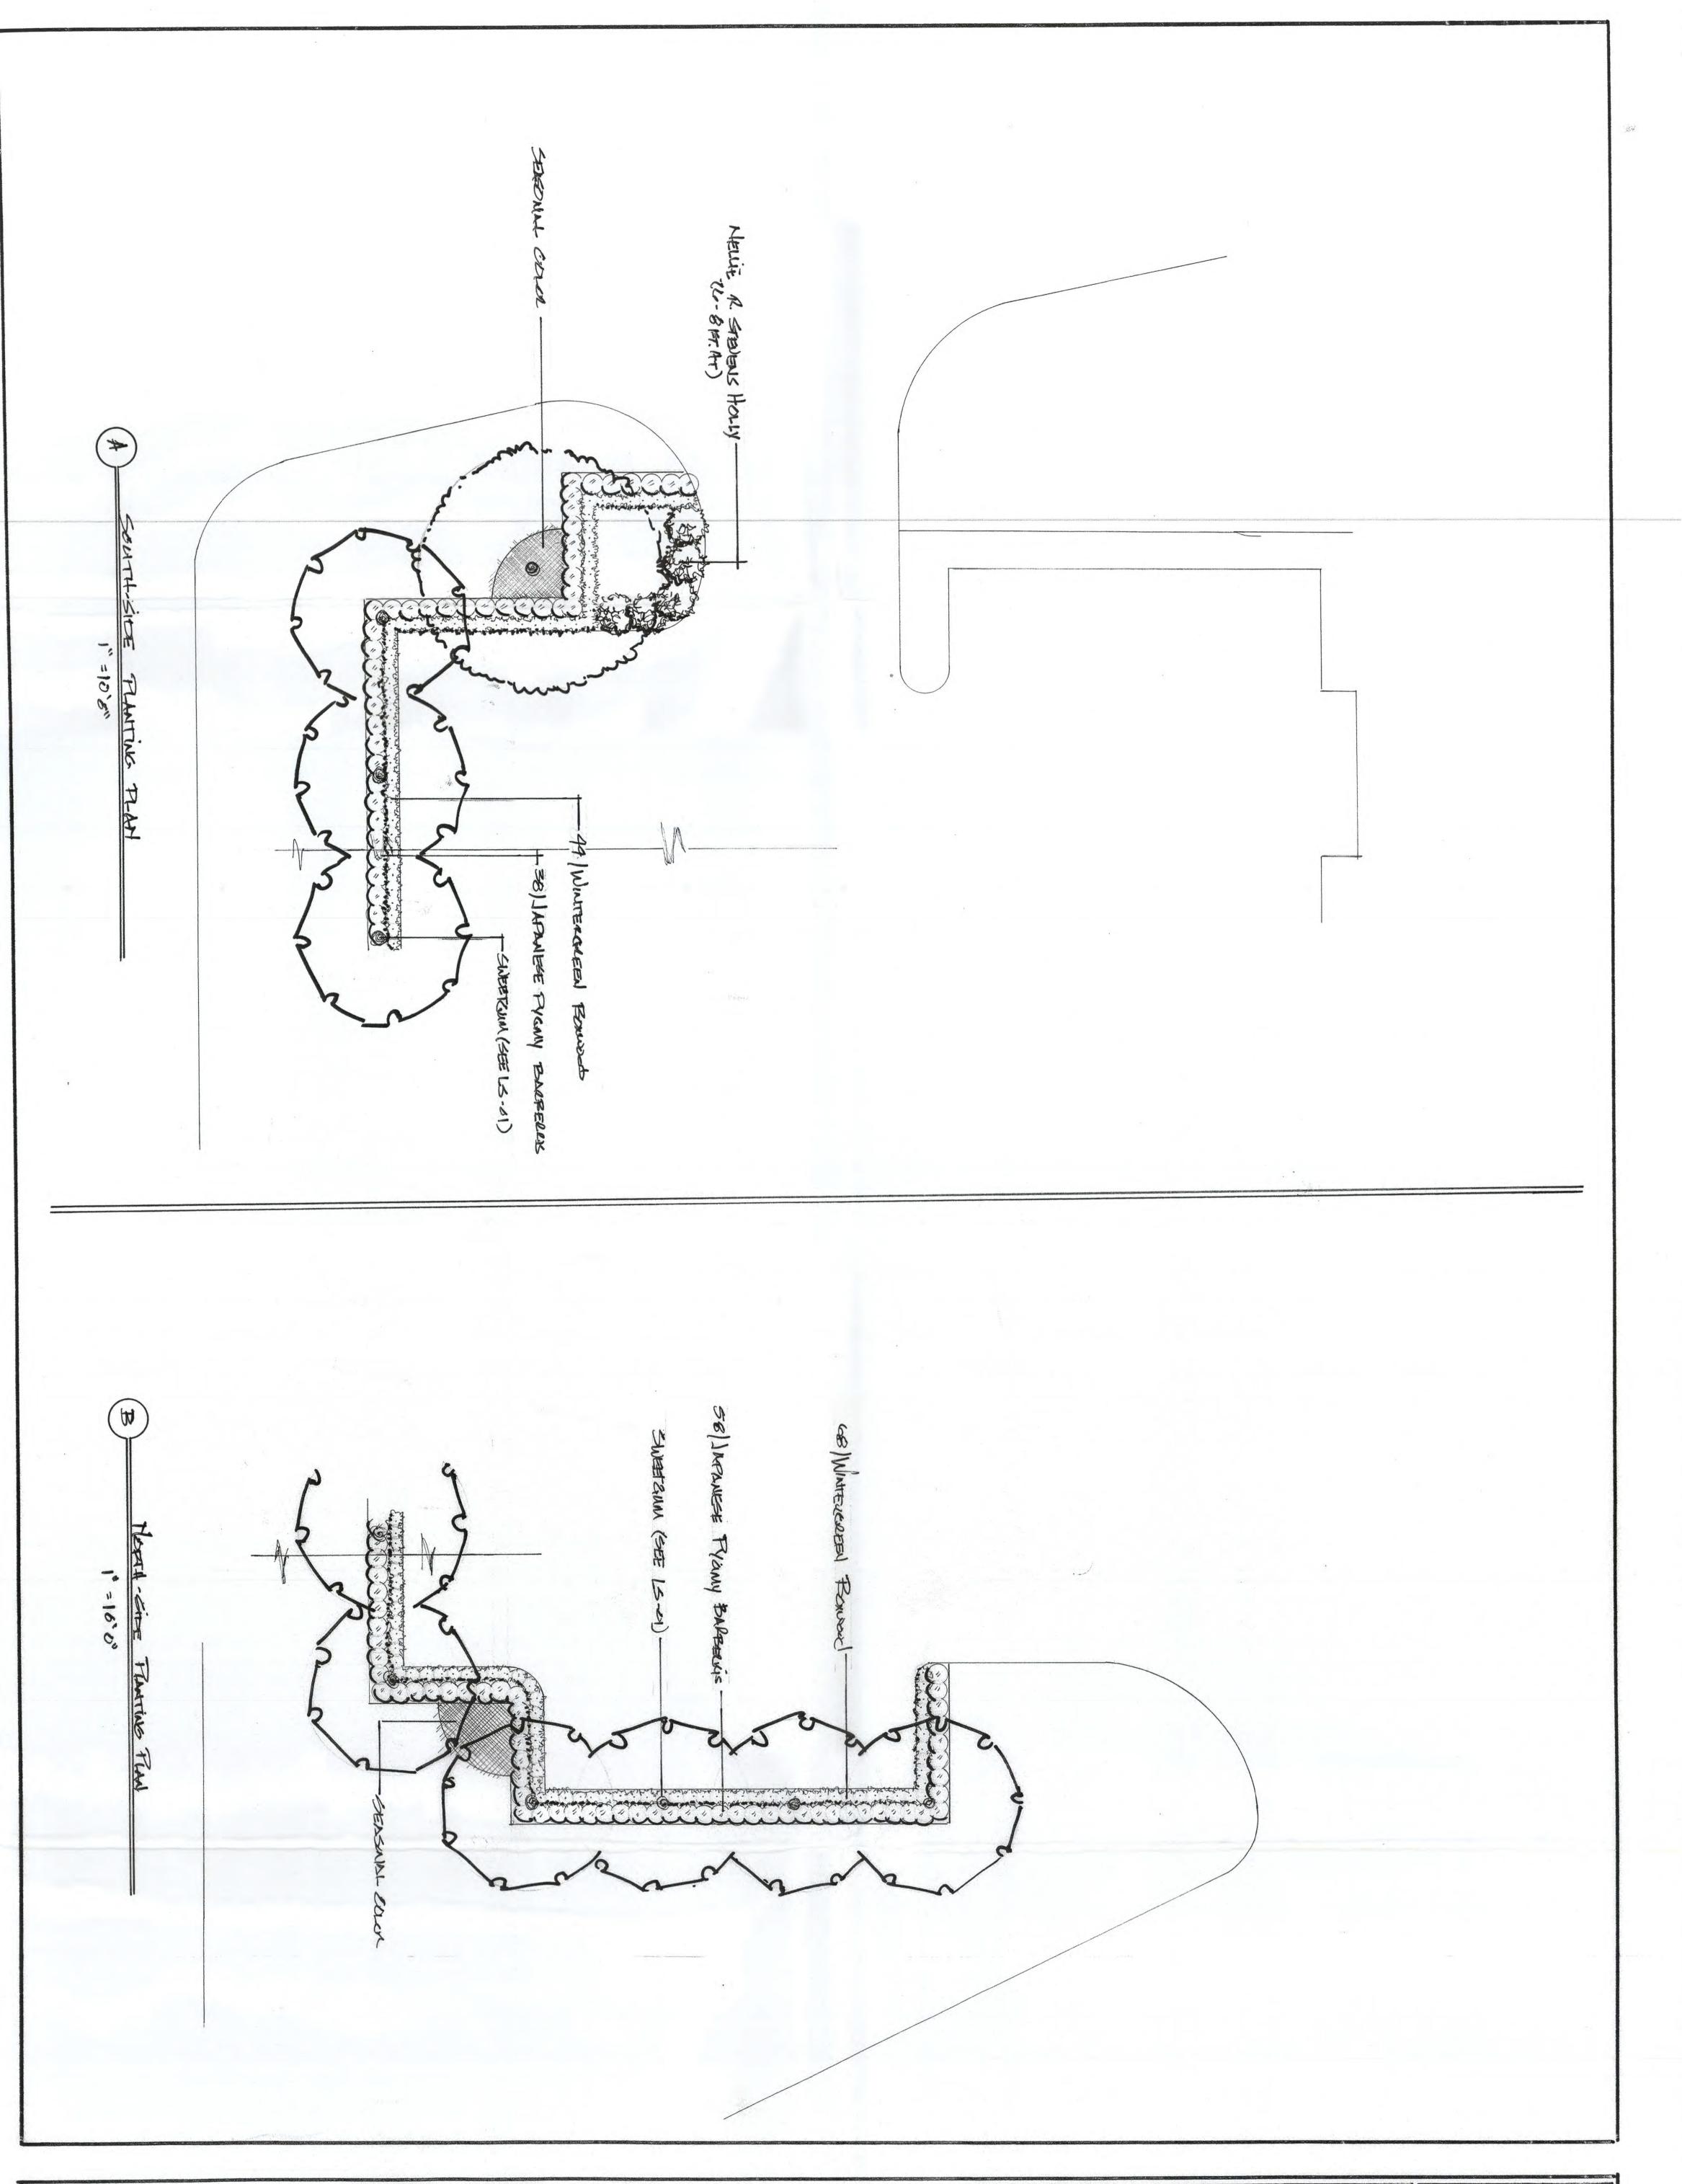




All plans and specifications are the property of *Unique Creations* and are not intended to be used for the solicitation of bids or for private use. These provisions may be waived if a design fee has been paid in full to *Unique Creations*.

Attn. Commercial Printers: DO NOT REPRODUCE COPIES OF THIS PLAN!

All plans and specifications should be approved by local City offices and /or Homeowner Associations to ensure all buildings, structures, fences, pools, decks, retaining walls, sidewalks, and irrigation systems meet all local building codes and requirements.


Unique Creations is not to be held responsible.

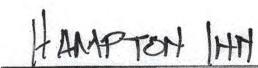

LAJOLHA FITER: CACHINA FIR


PECKENALL, TX

NORTH: SOUTH PLANTING PLANS

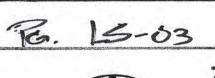



SCALE: |" = 100"

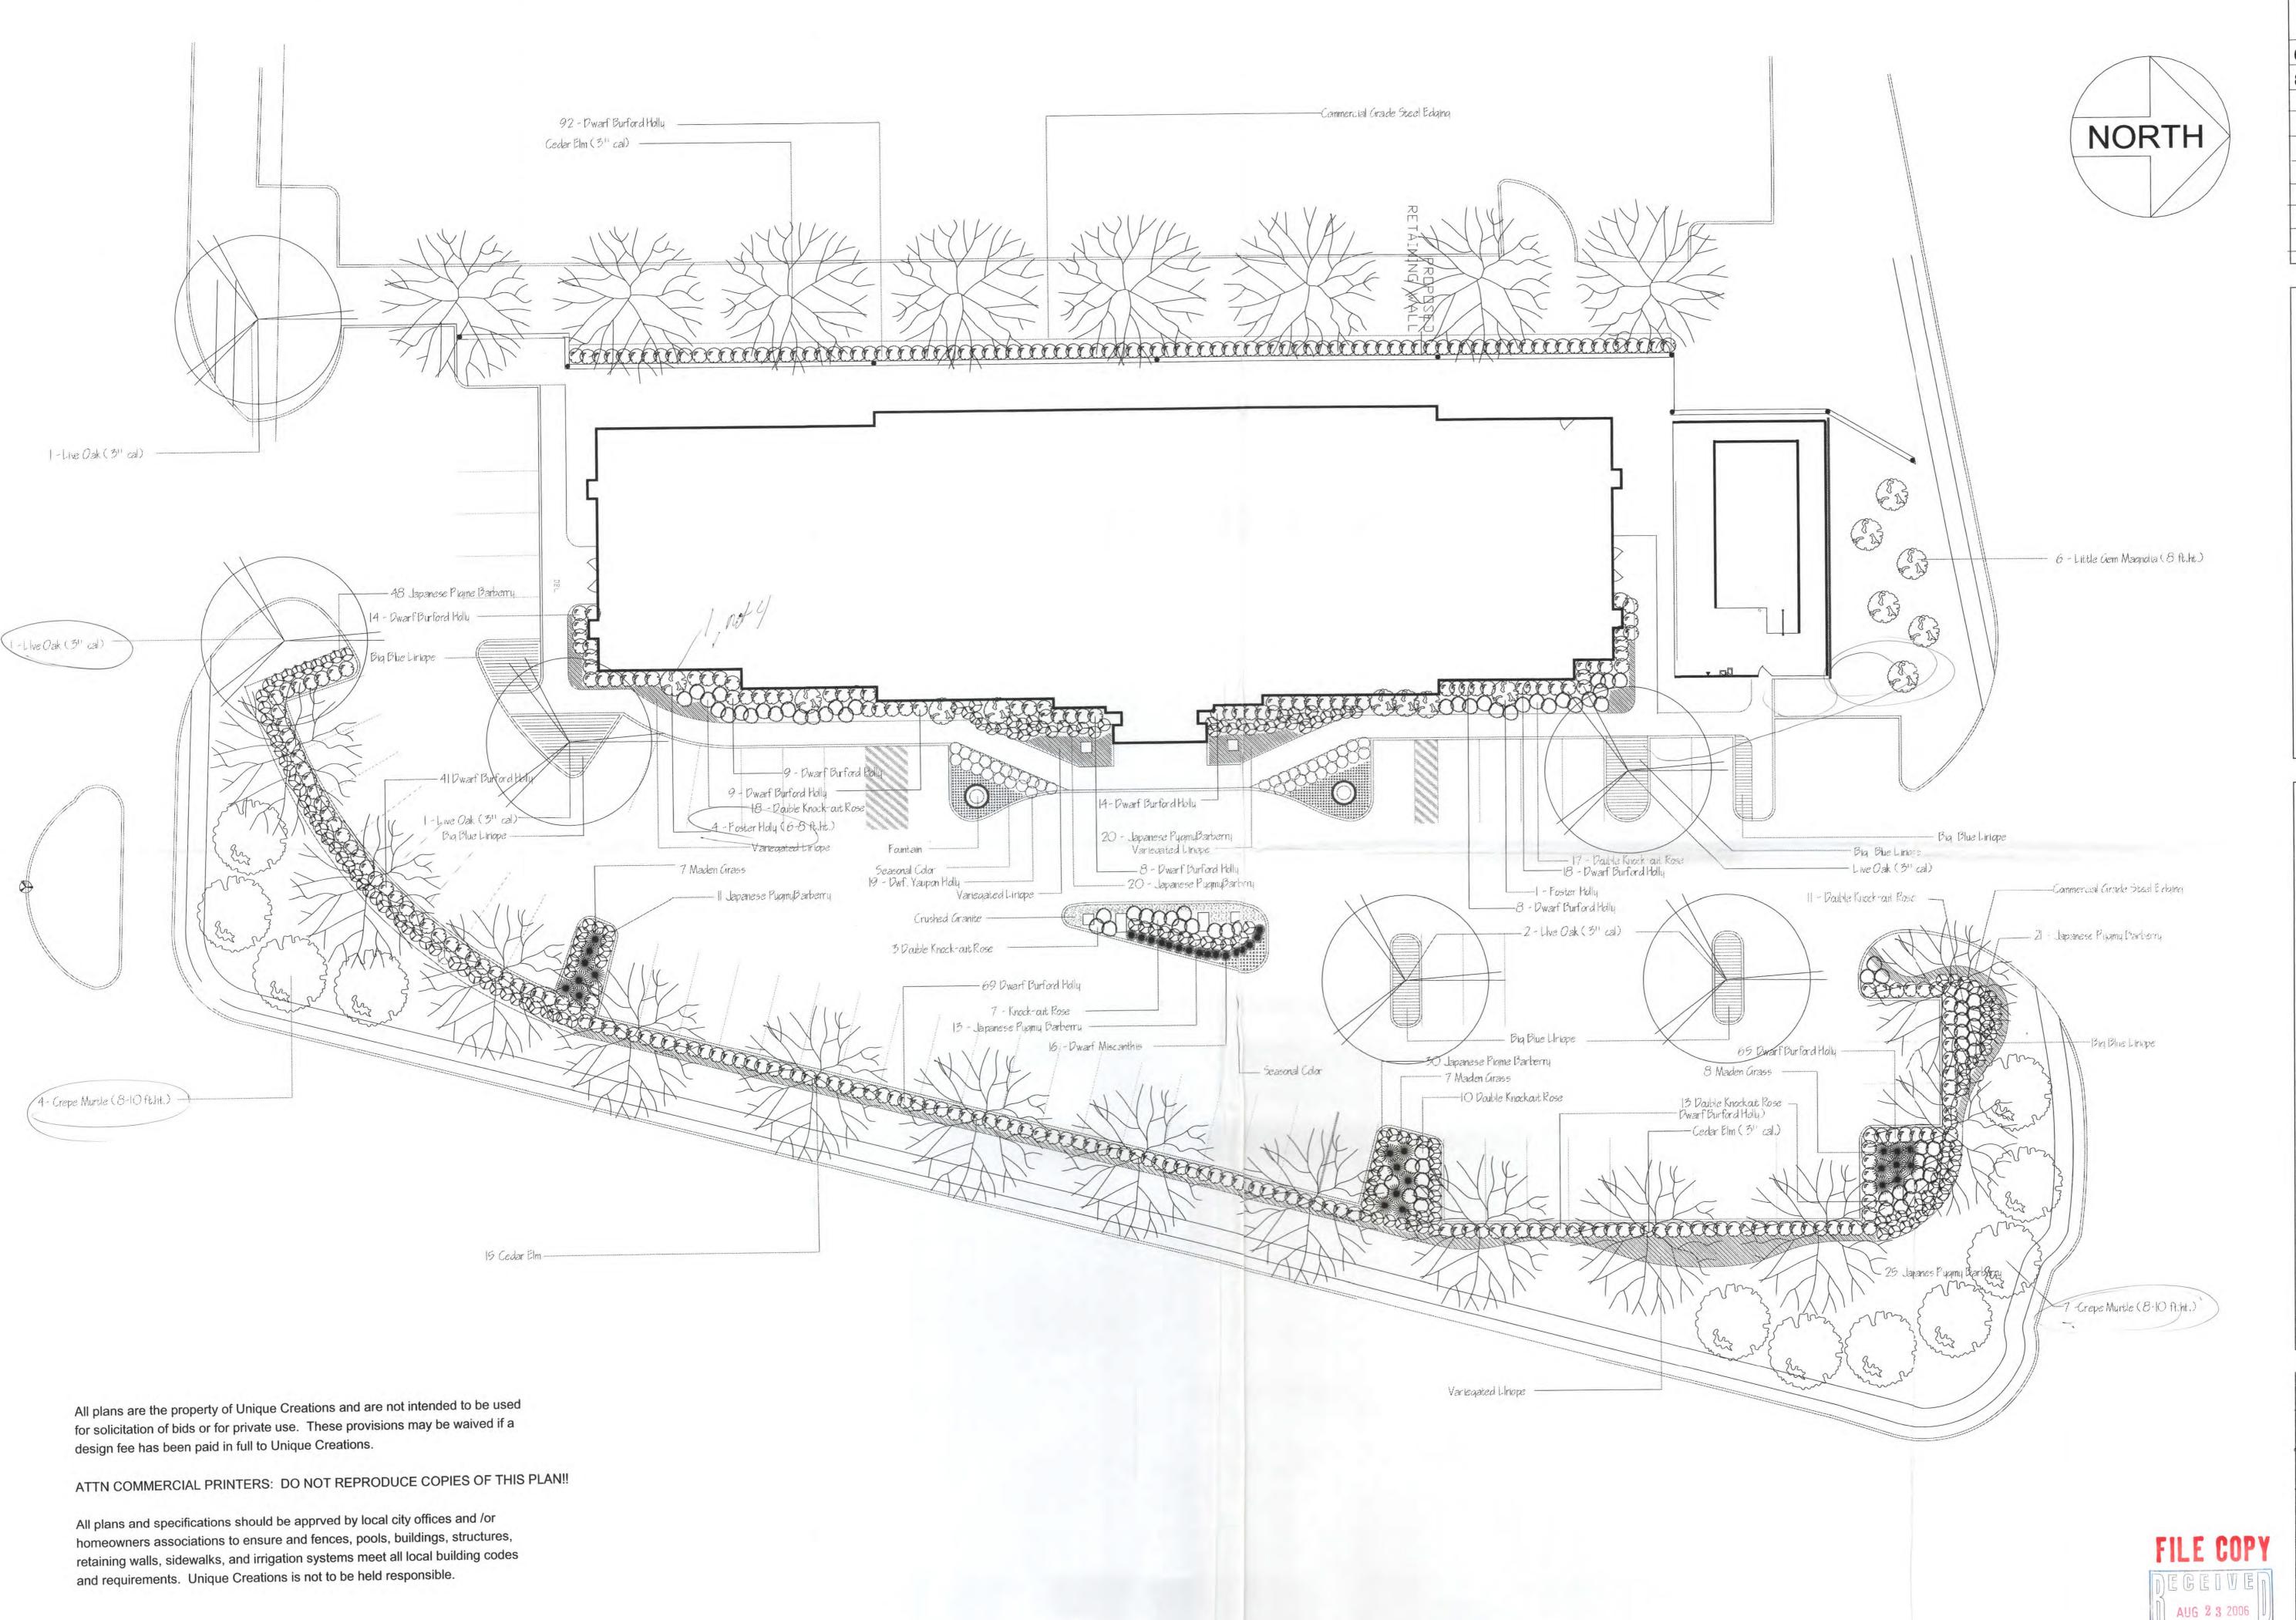

Revisions
6/16/06 Initial Planning
8/22/06 Site 2 planning

Lot 4, Block C
La Jolla Point Dr. & Laguna Dr

F CREATIONS

Scale: 1/16"=1'0"


Drawn By: M.L.M.

Date: 8/22/06

Sheet No.

522006-019

LS 1.01

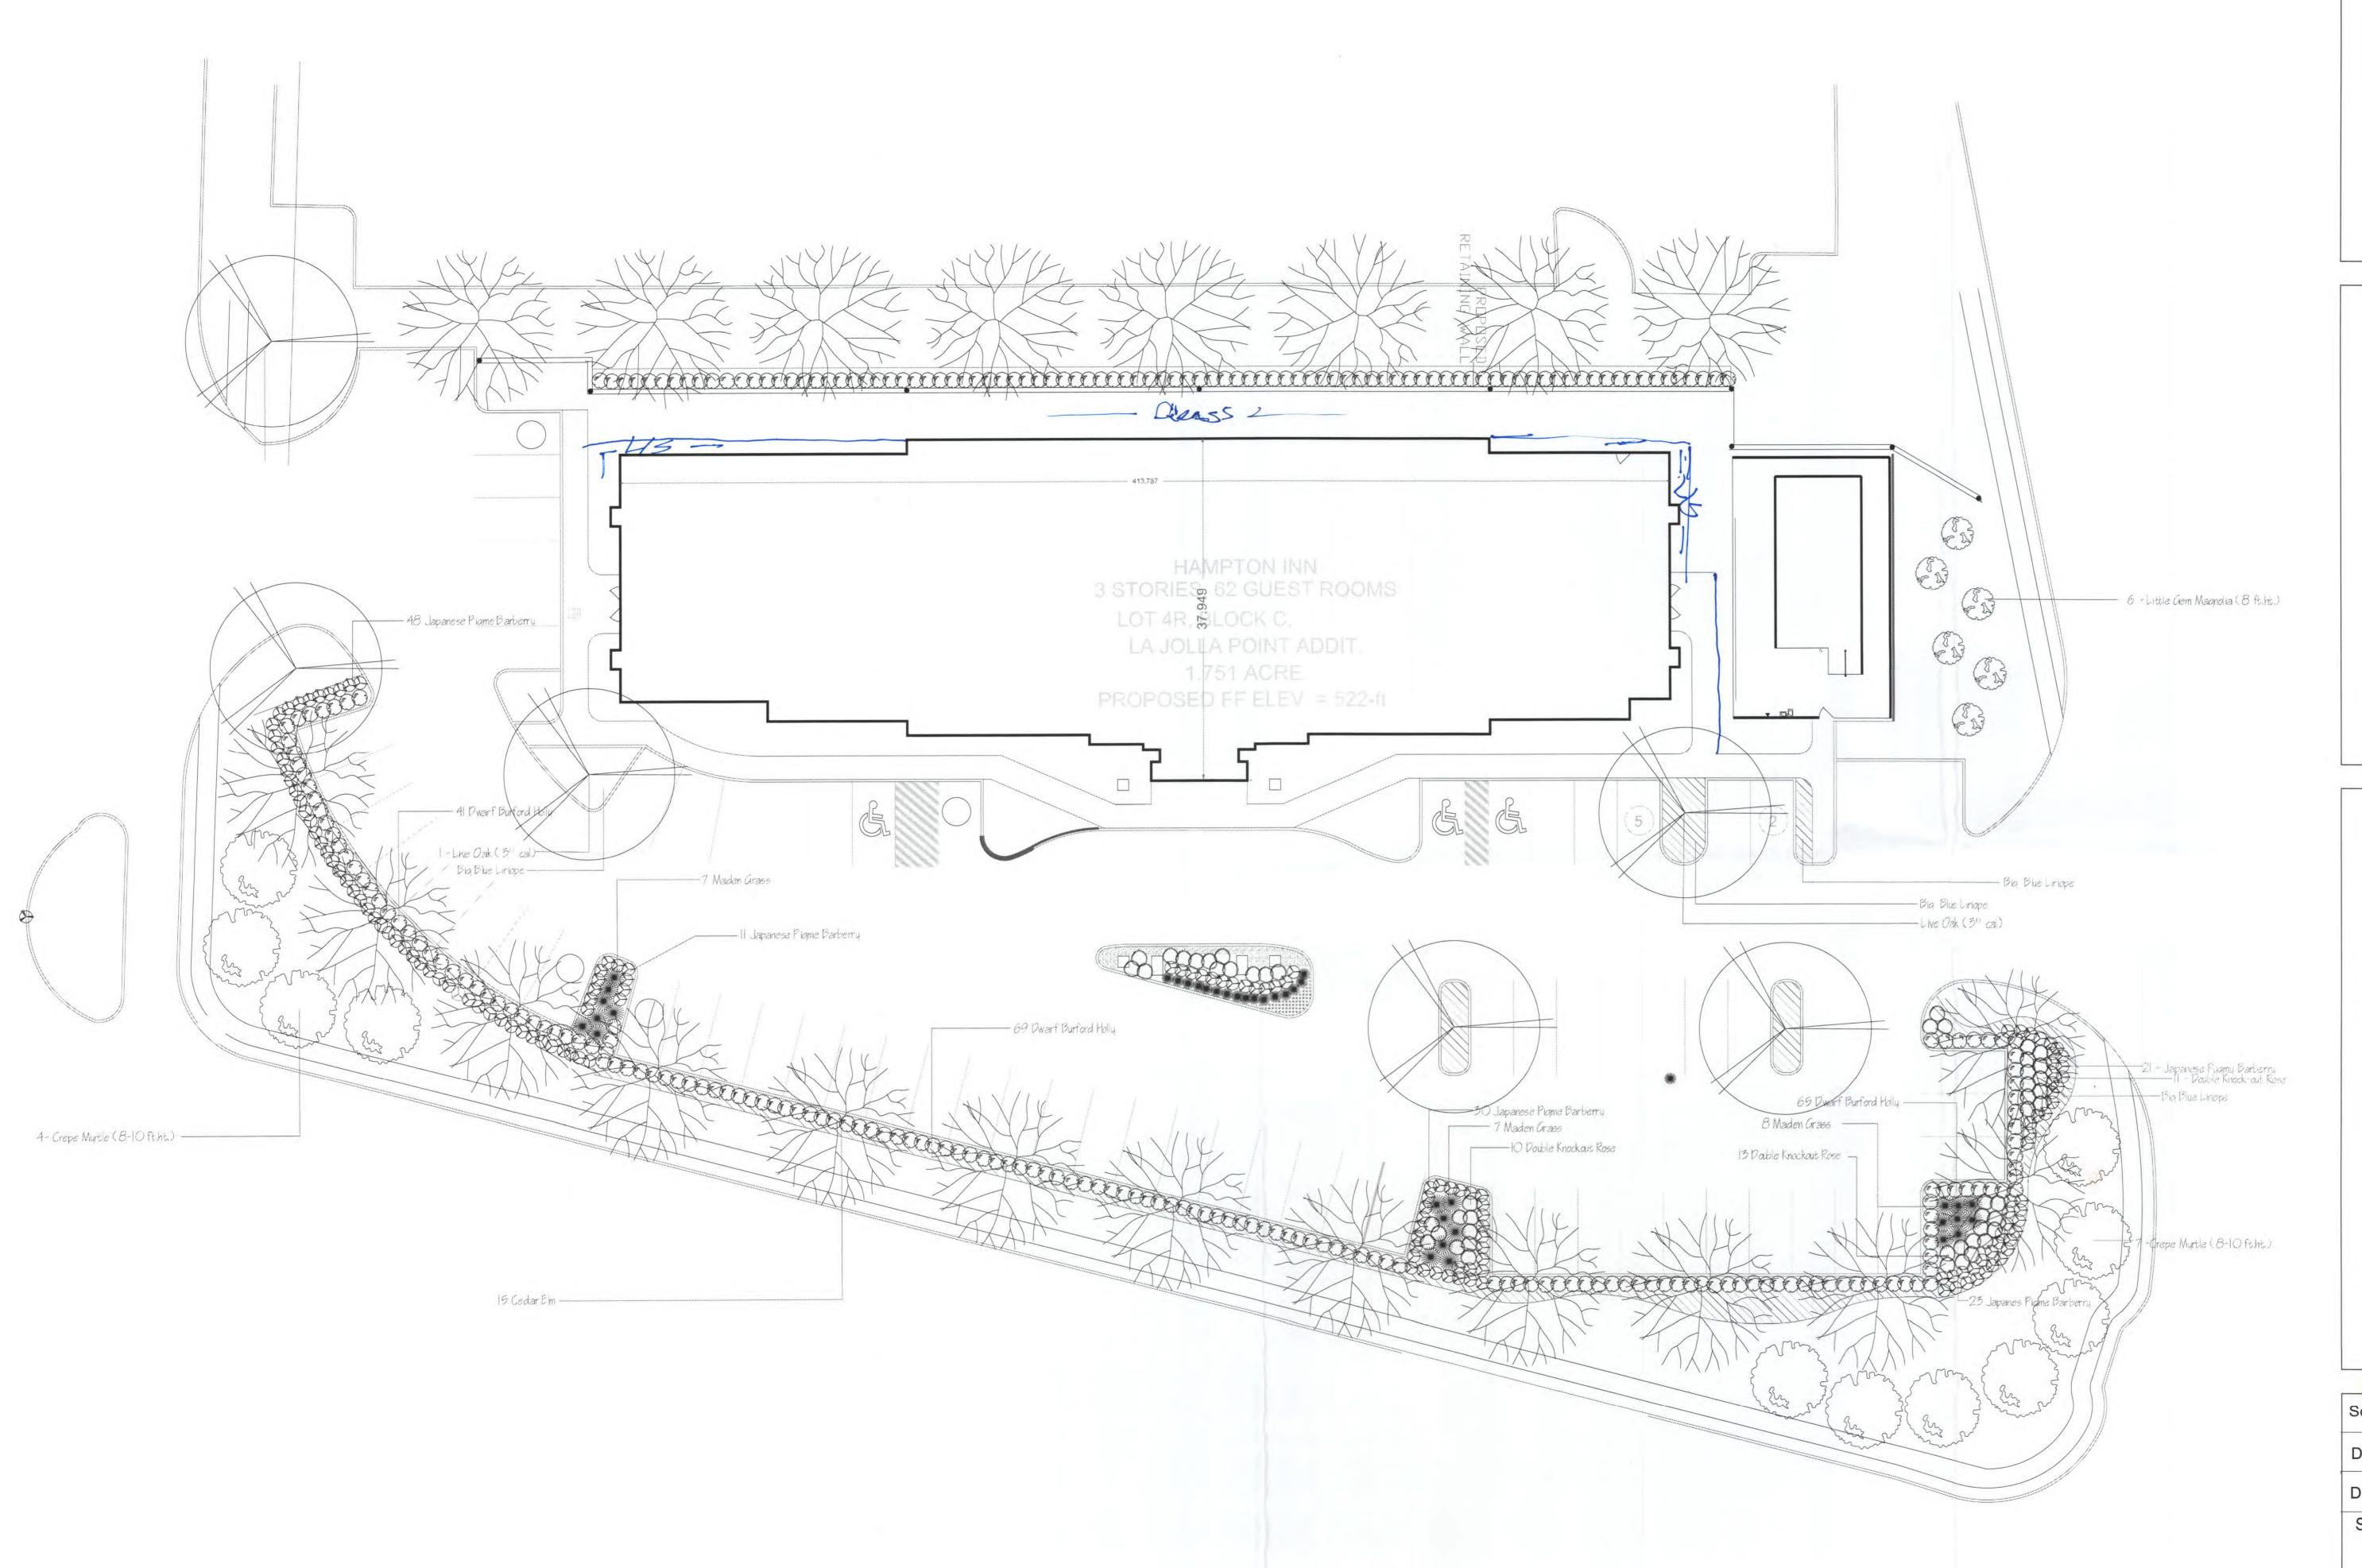





Scale

Drawn By:

Date: Sheet No.

> LS 1.01

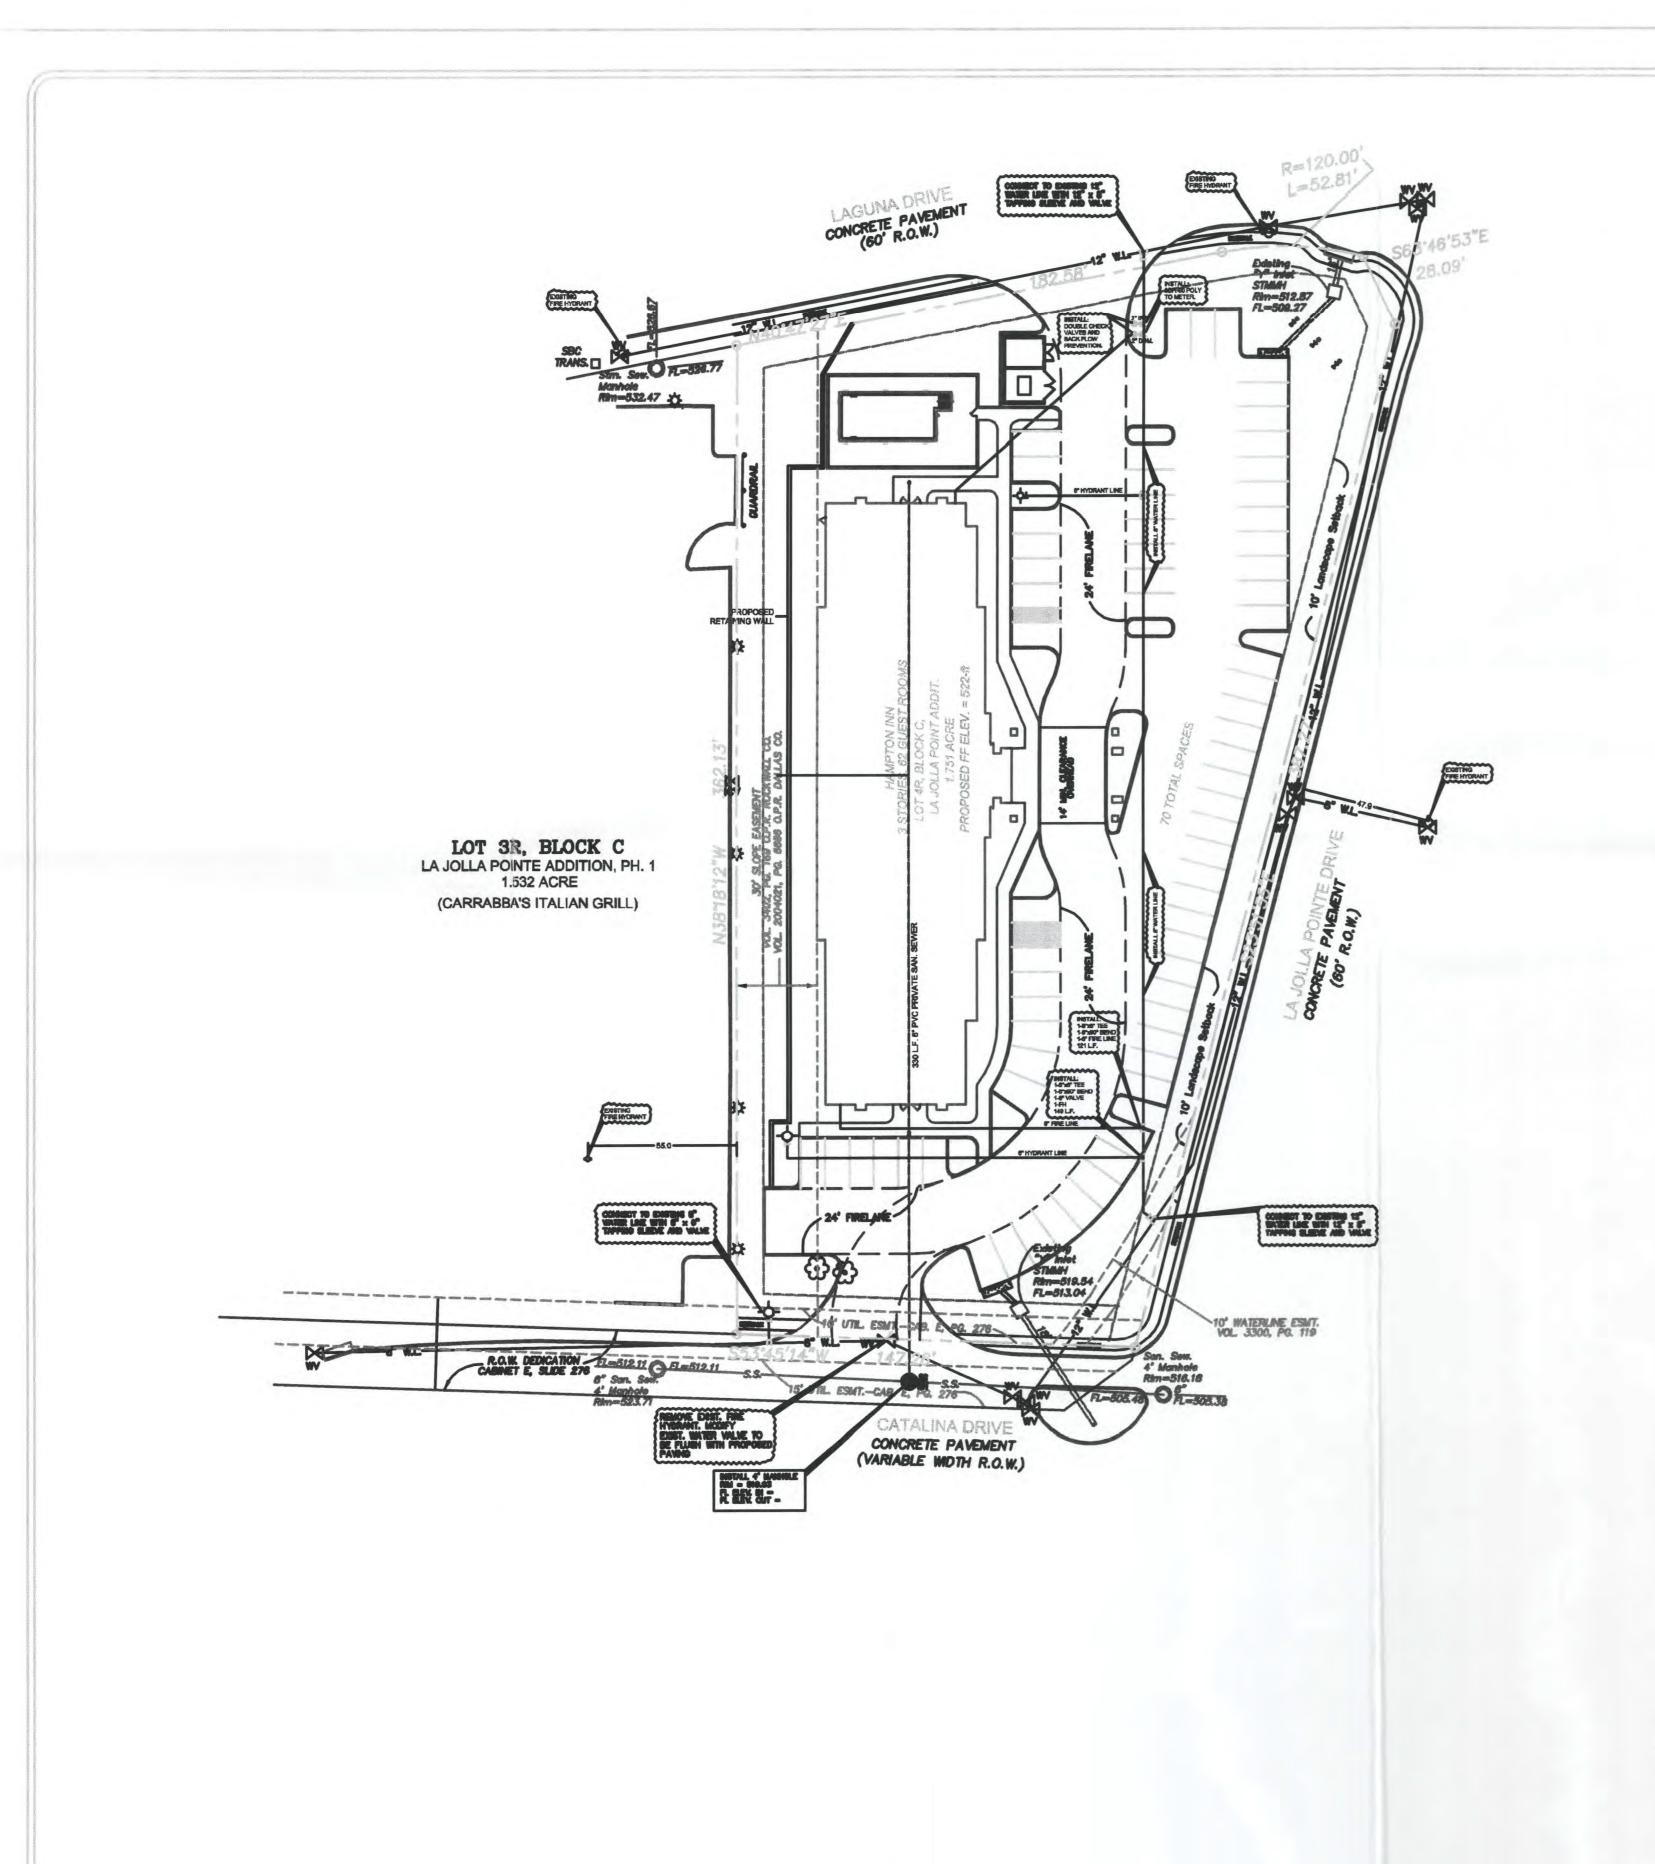

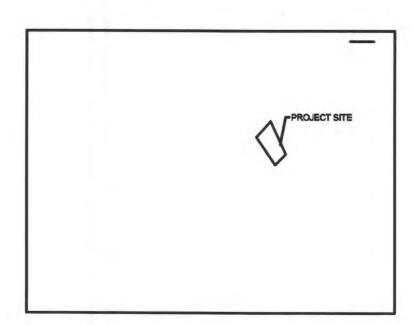

SITE MAP SCALE: NONE

SITE BENCH MARK - FOUND BOX CUT TOP OF WEST CURB OF LAKESIDE DR. APPROX. 120-FT NORTH OF RAILROAD AT NW CORNER OF LA JOLLA POINTE ADDIT., PH II, ELEVATION = 503.23 CONTOURS ARE @ 1-FOOT INTERVALS TOPOGRAPHIC SURVEY FURNISHED BY ARTHUR SURVEYING CO., INC. DEVELOPER: MR. KAVEEN R. P. 6005 SILVERLEAF LANE GARLAND, TEXAS 75043 (214) 629 - 2840

HAMPTON INN
LLA POINTE DRIVE, ROCKWALL, TO
LA JOLLA POINTE ADDITION

ENGINEERING COMPANY, INC.
7. PIONEER PKWY, STE B
INGTON, TEXAS 78013

NOAKES ENGINEERING COI 3603 W. PIONEER PKWY, ARLINGTON, TEXAS 76

PRELIMINARY NOT FOR CONSTRUCTION

AUG 0 1 2006

PROP. WATER LINE

* w- EXISTING WATER LINE

- PROP. SAN. SEWER

EXISTING SAN. SEWER

PROP. S. S. MANHOLE

PROP. S. S. CLEANOUT

PROP. FIRE HYDRANT

PROP. WATER VALVE

FILE NO. 06-7194


> SCALE 1" - 30'


> > SHEET NO.


UTILITY PLAN


SCALE: 1" = 30'-0"


Scale 1" = 30'

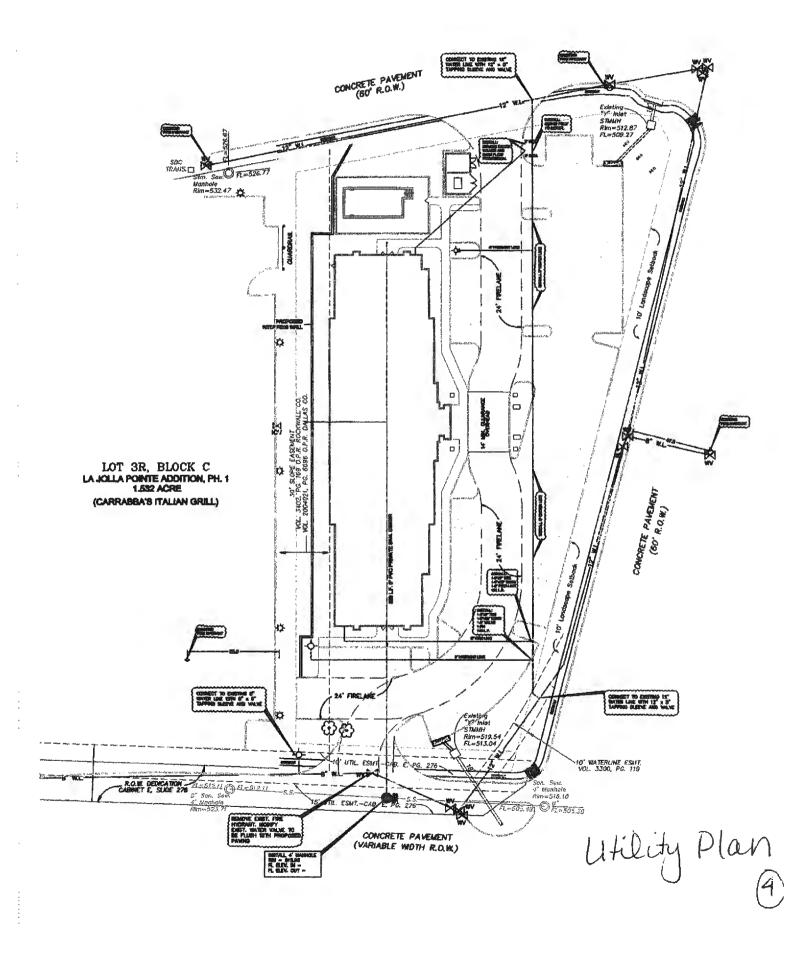

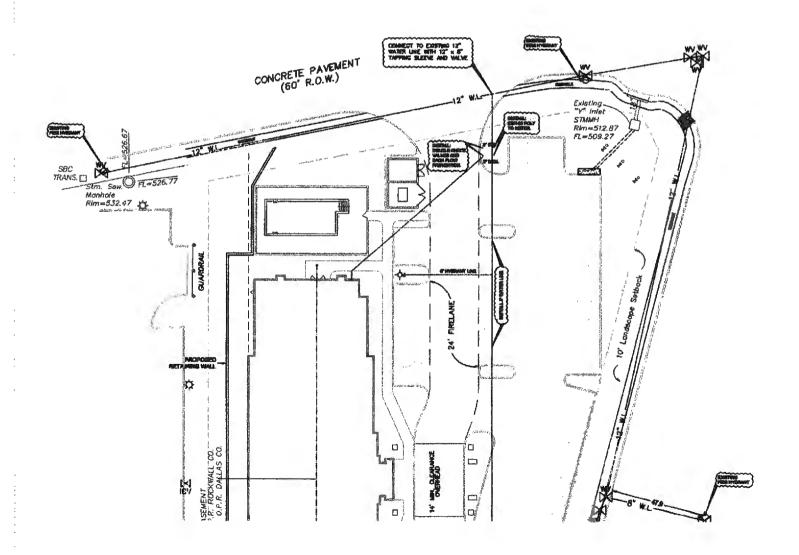

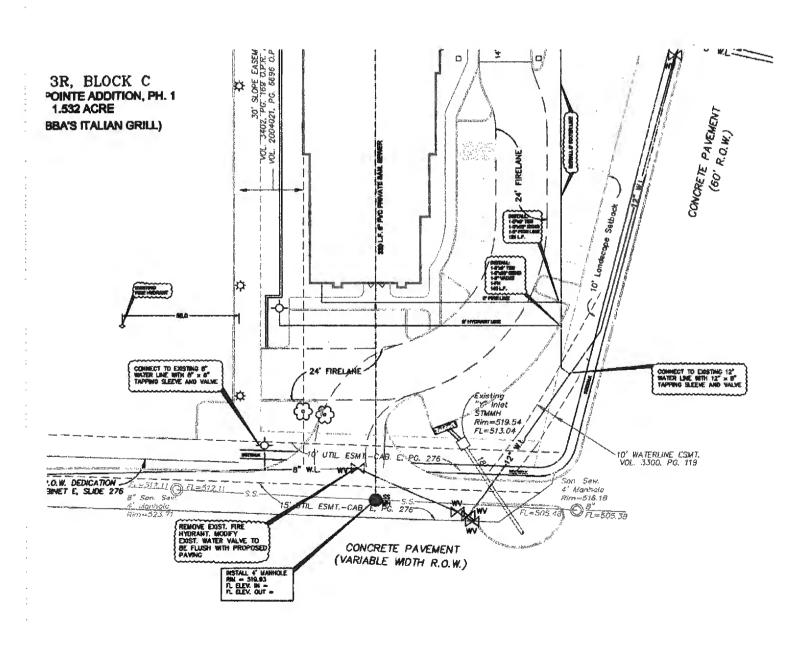

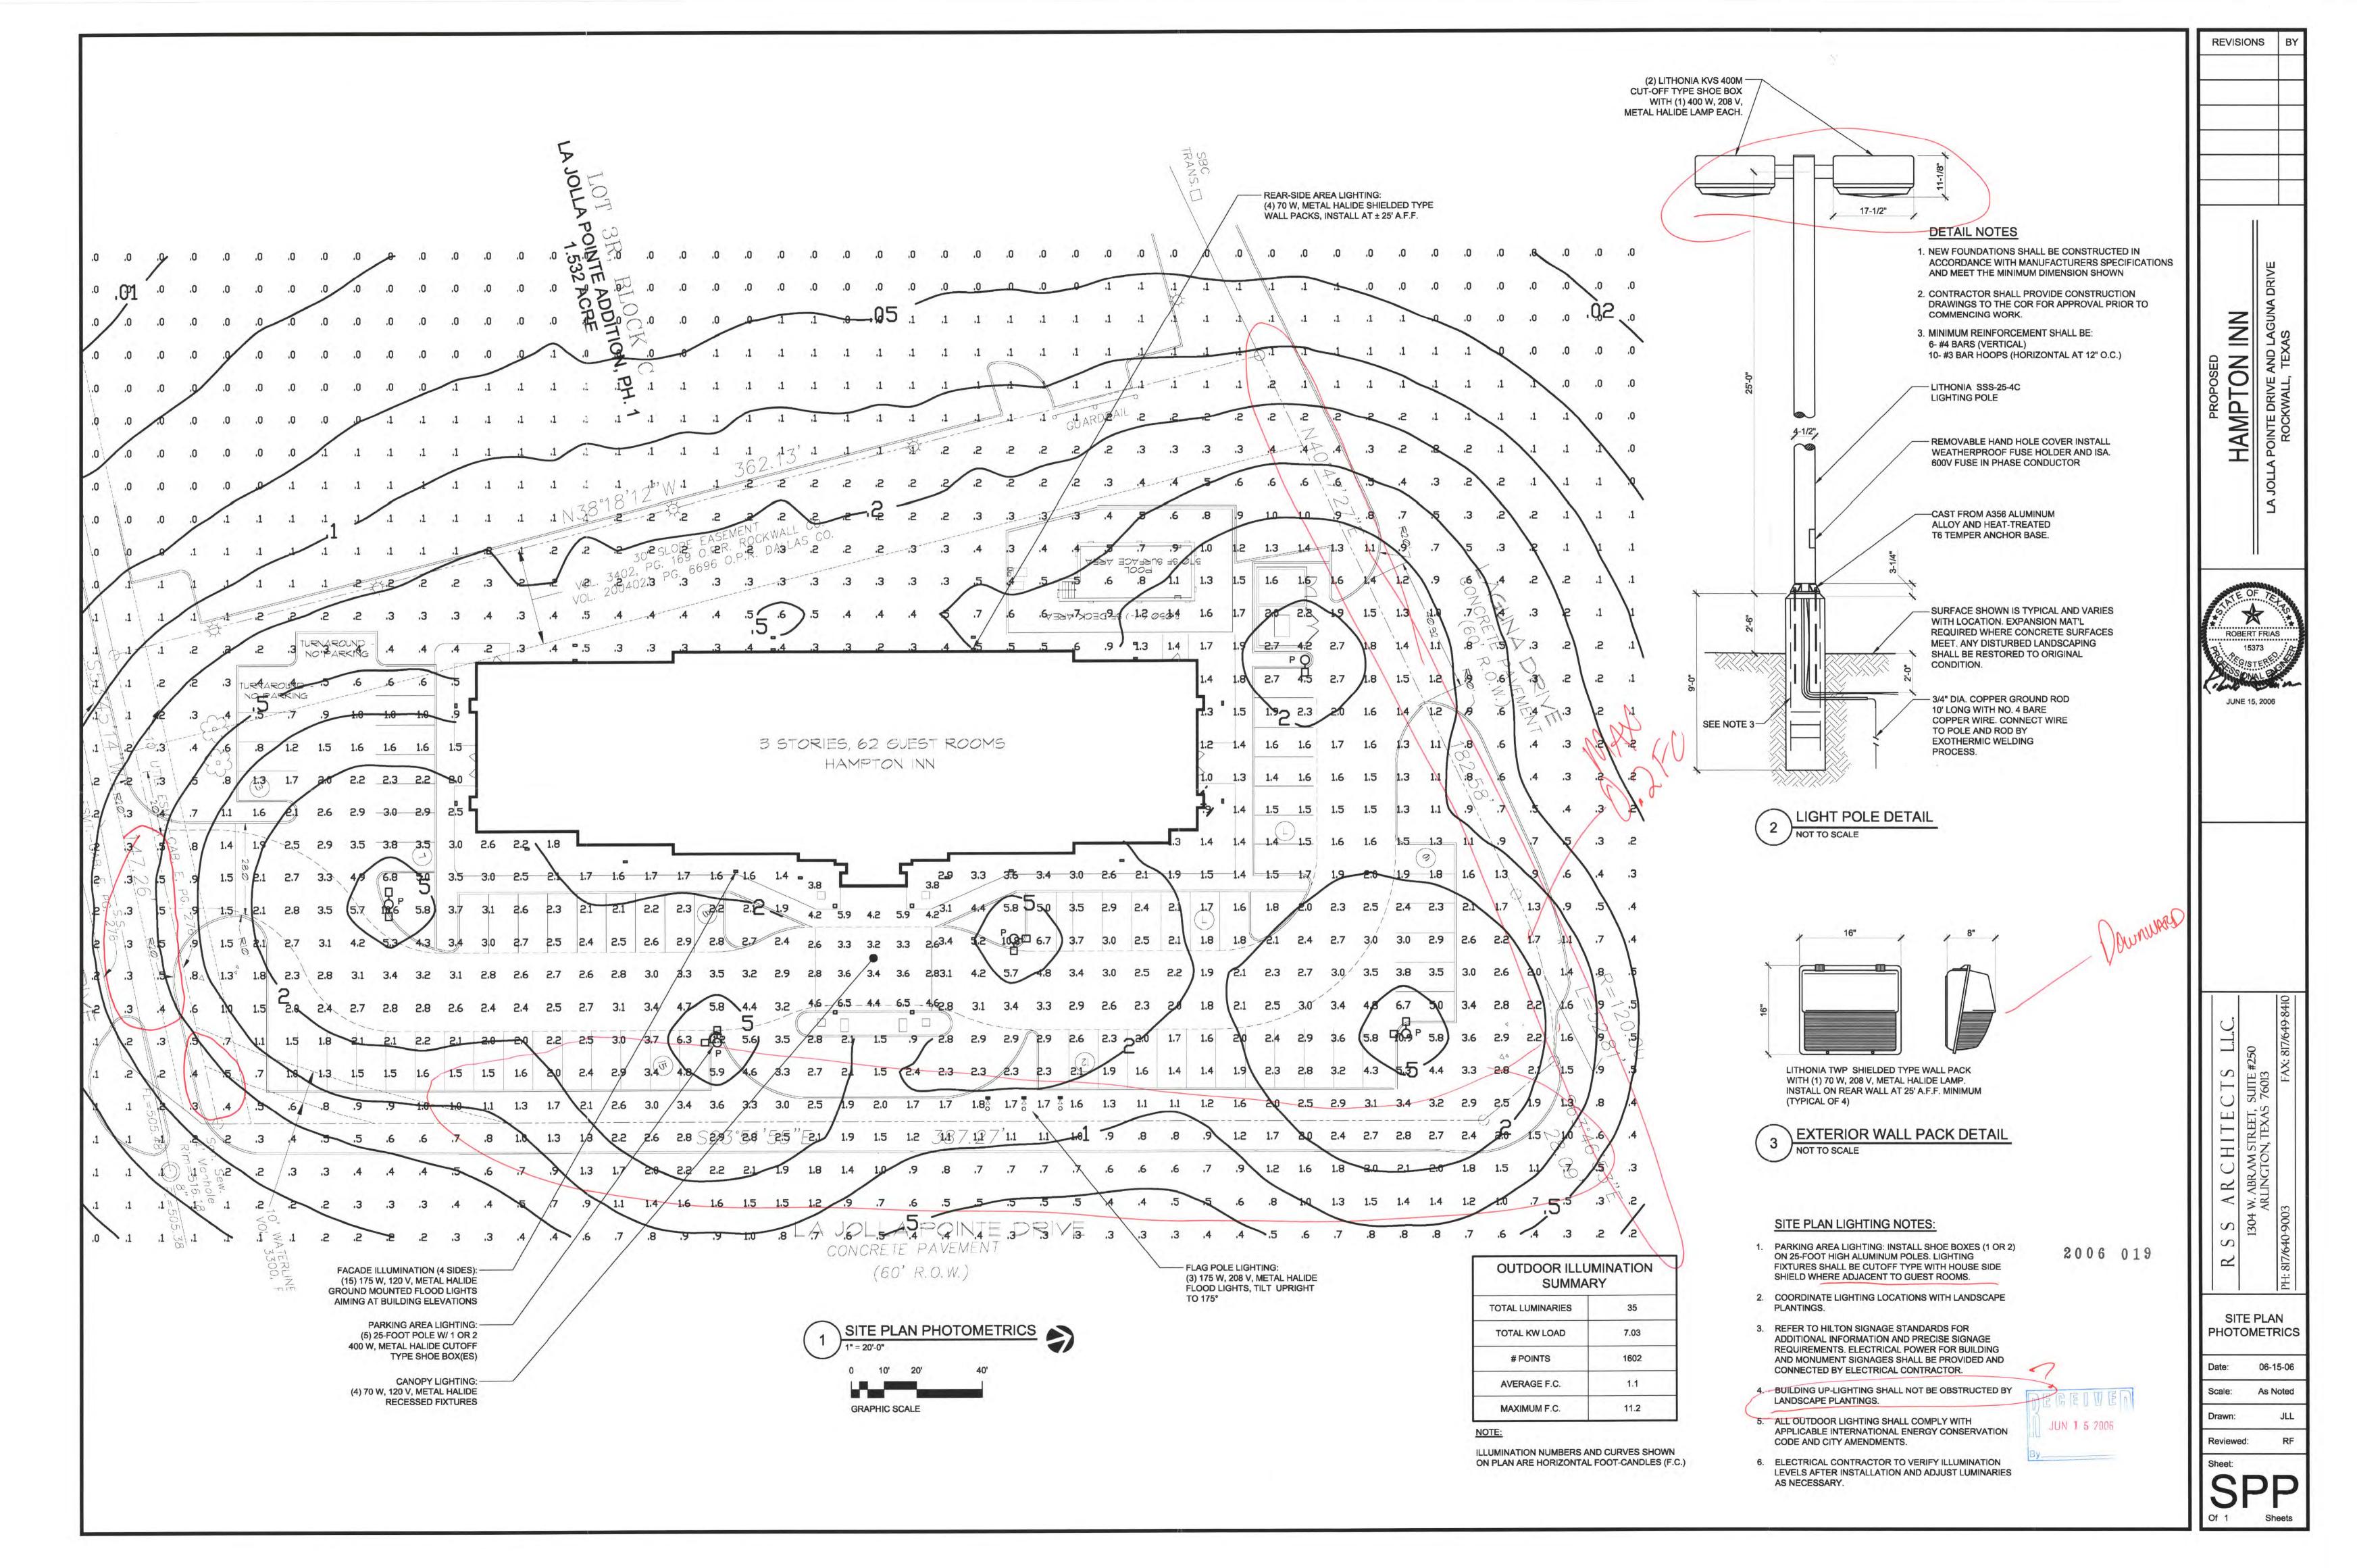

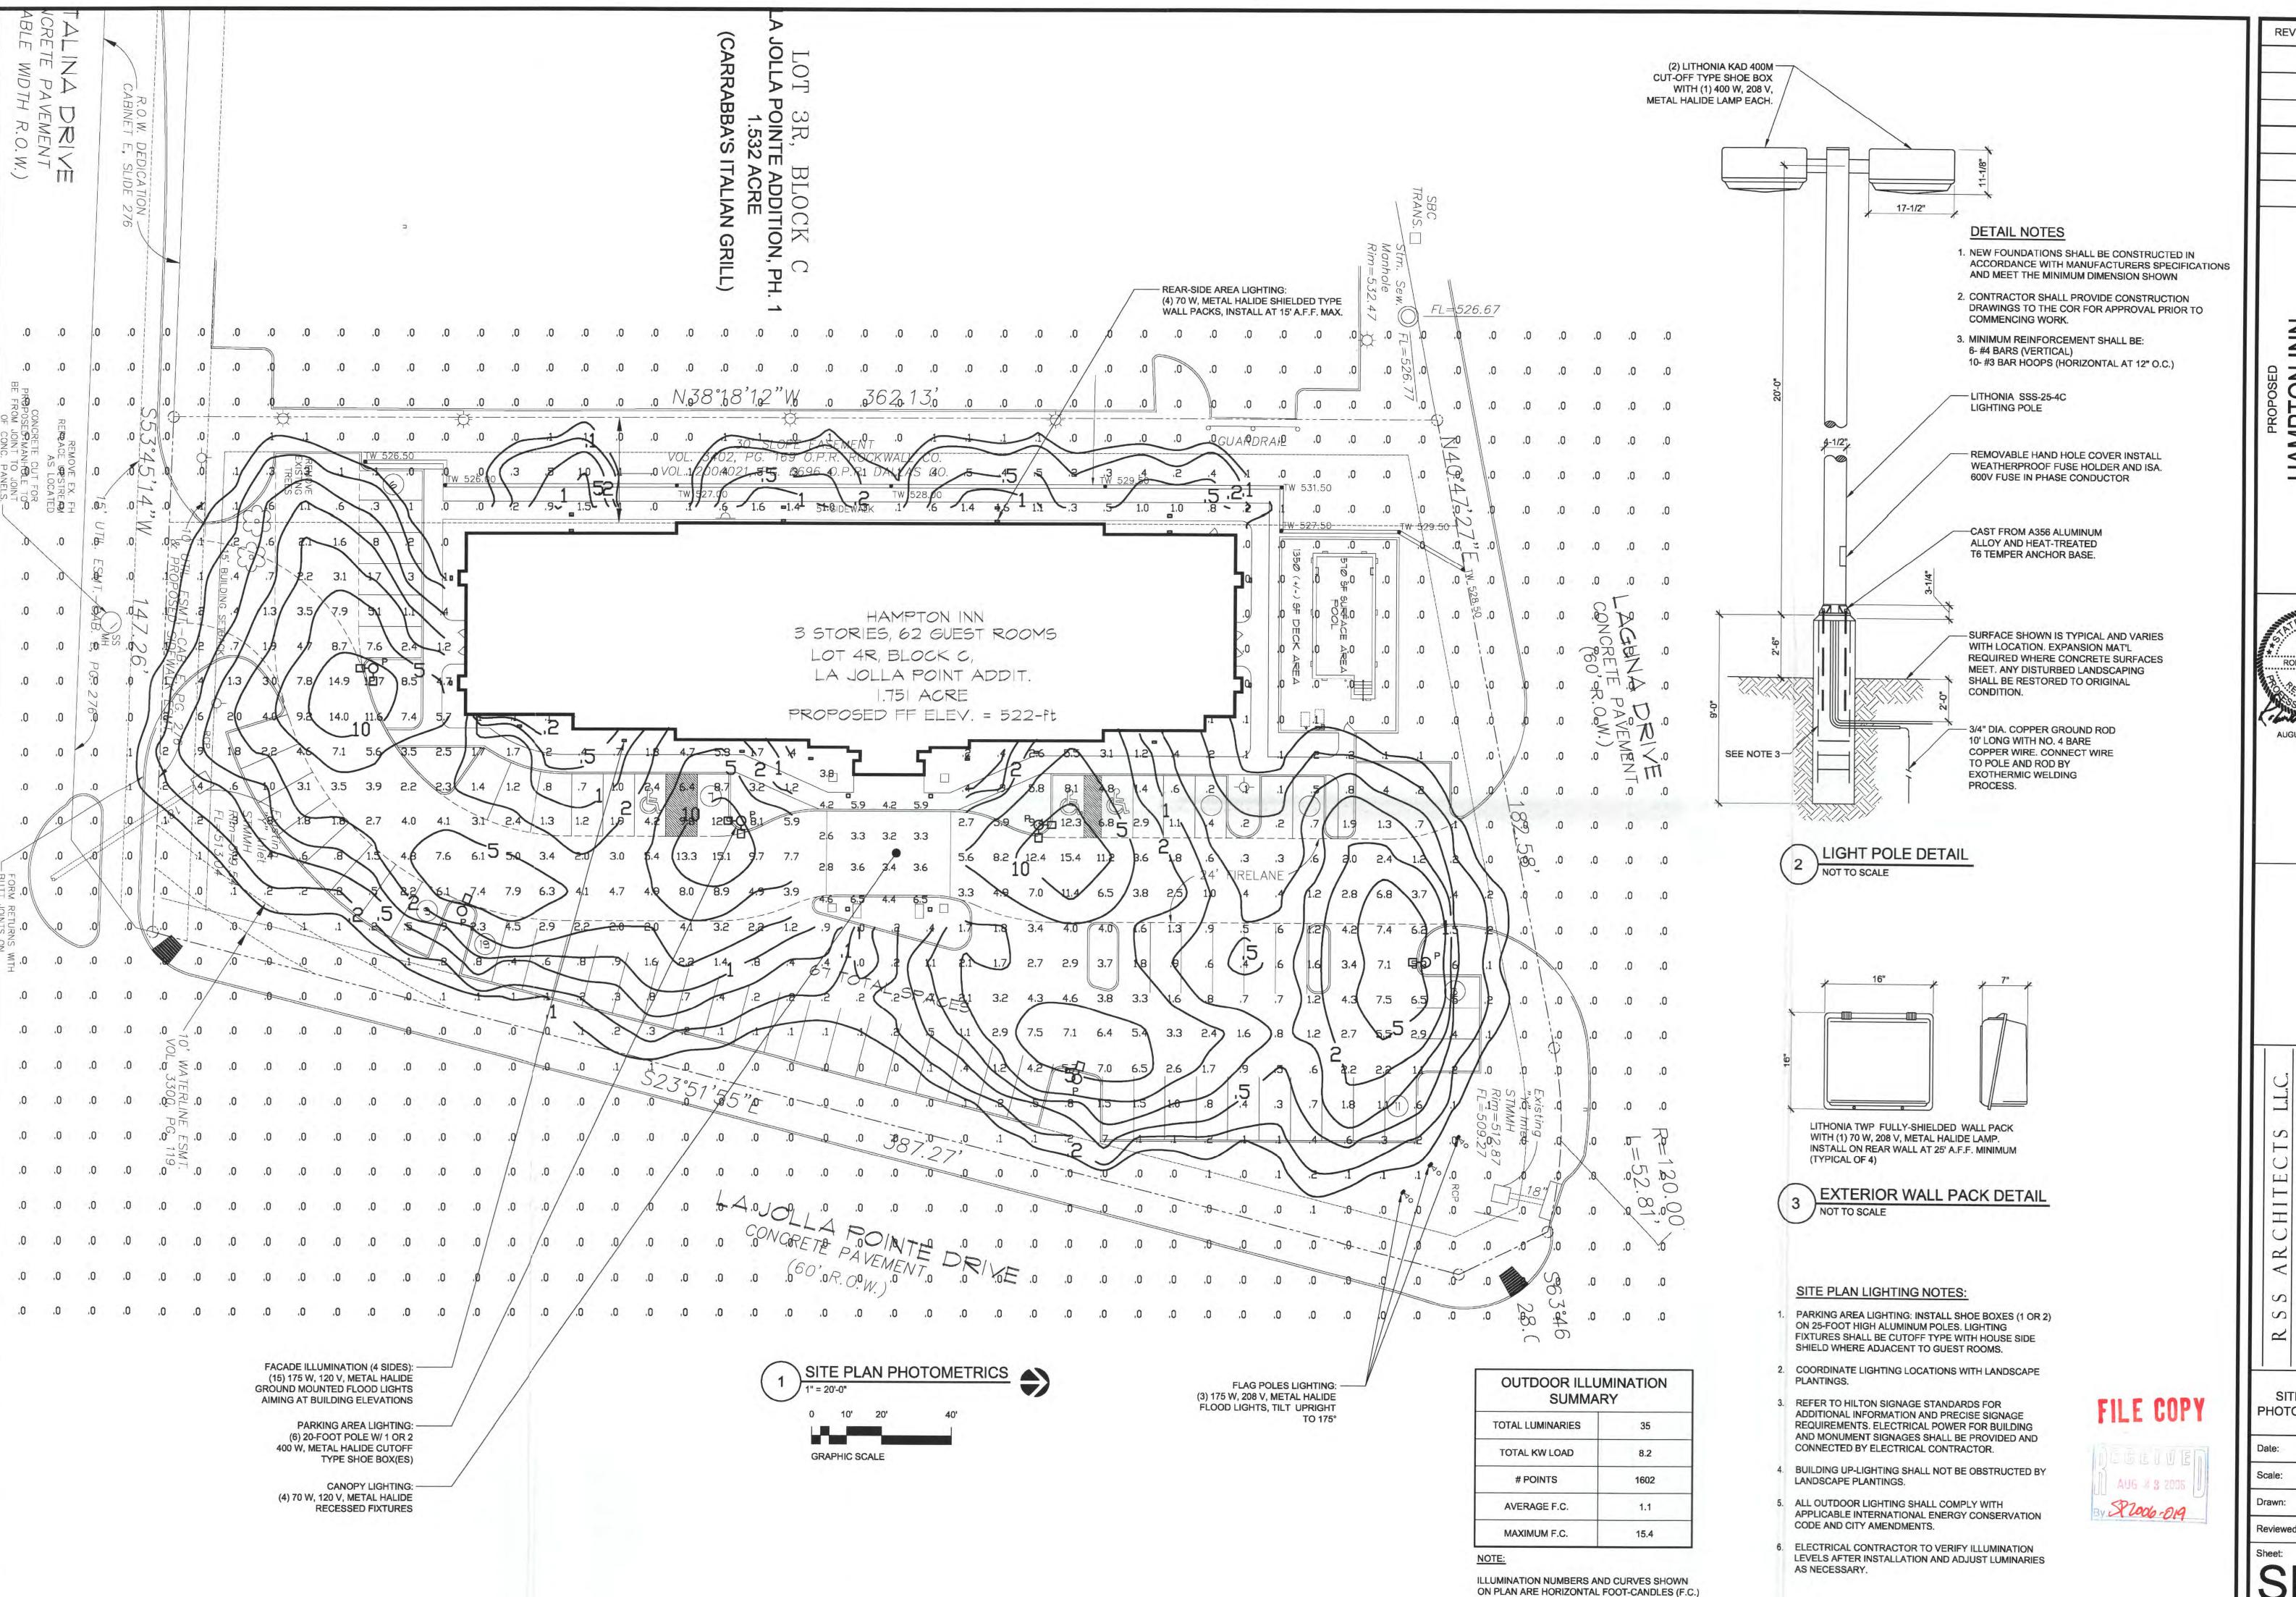

REVISIONS

HAMPTON INN



AUGUST 23, 2006


ARCHITEC W. ABRAM STREET, S ARLINGTON, TEXAS

SITE PLAN **PHOTOMETRICS**

06-15-06

As Noted

Reviewed:

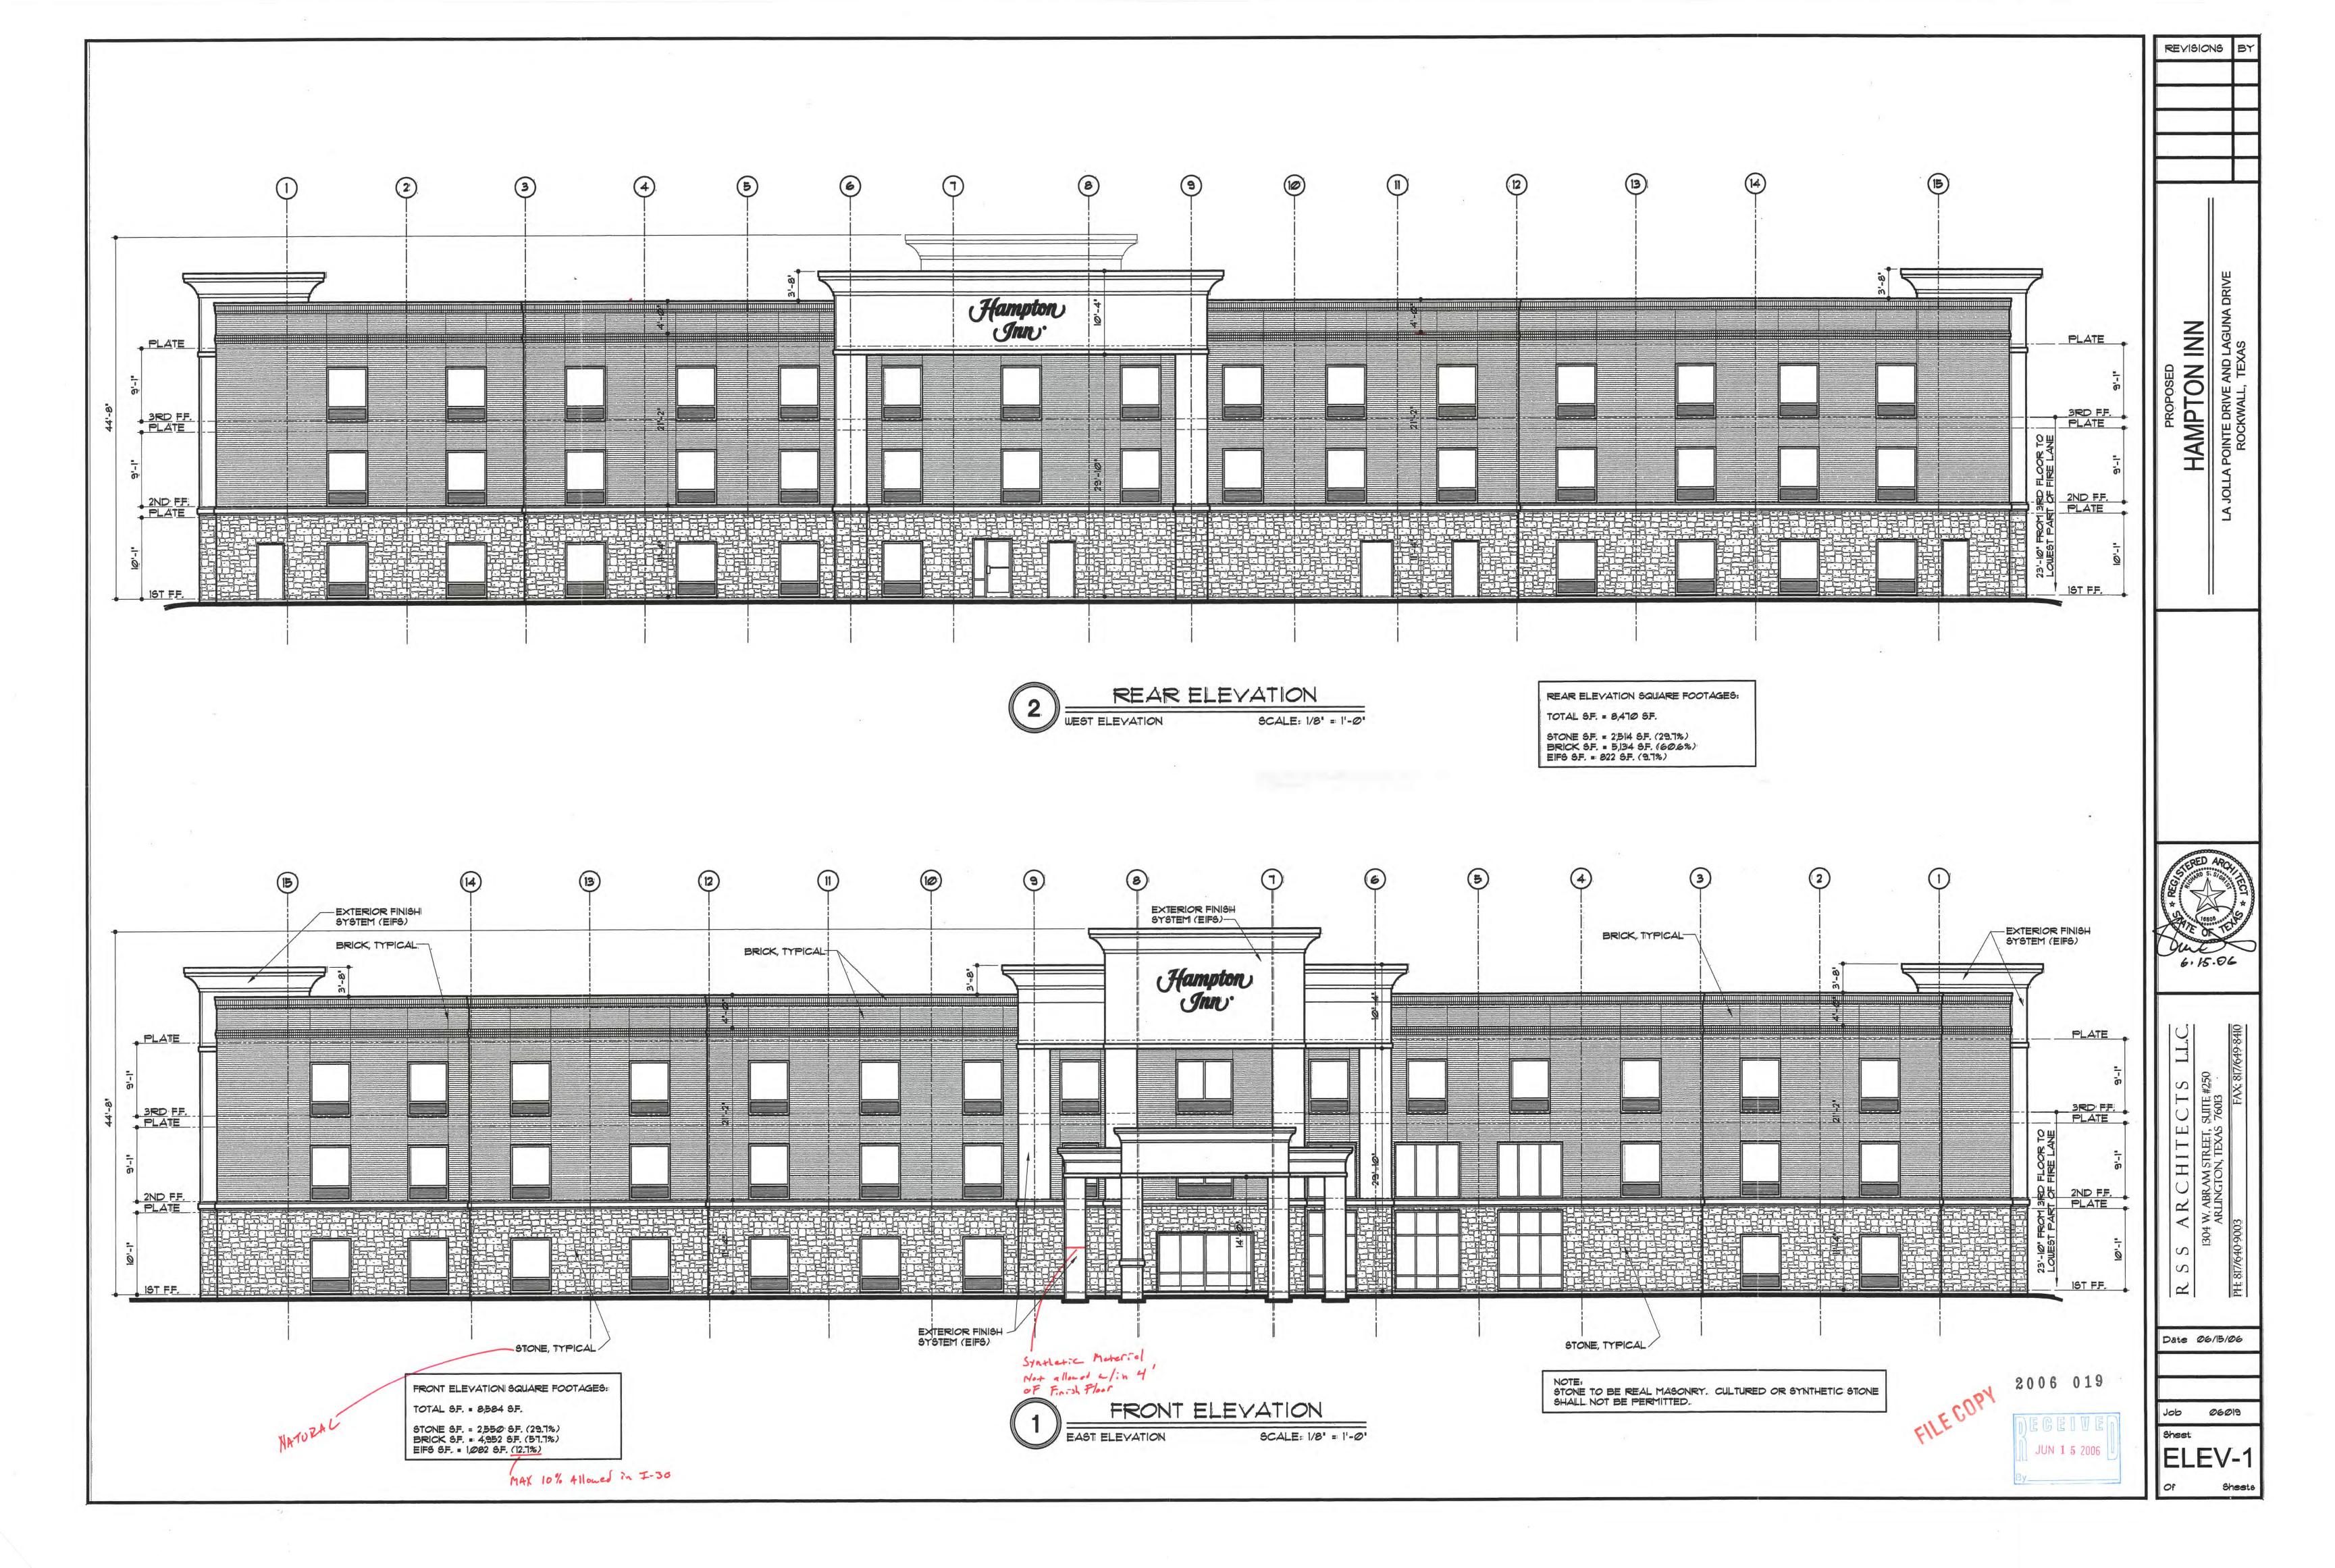



RIGHT SIDE ELEVATION

NORTH ELEVATION

SCALE: 1/8" = 1'-0"

STONE S.F. = 808 S.F. (30.4%)
BRICK S.F. = 1,190 S.F. (44.8%)
EIFS S.F. = 658 S.F. (24.8%)

RIGHT ELEVATION SQUARE FOOTAGES:

TOTAL SF. = 2,656 SF.



LEFT ELEVATION SQUARE FOOTAGES:

TOTAL SF. = 2,656 SF.

STONE SF. = 808 SF. (30.4%)

BRICK SF. = 1,190 SF. (44.8%)

EIFS S.F. = 658 SF. (24.8%)



ECOPY DEGI

DEGE IVED

JUN 1 5 2006

By


2006 019

HAMPTON IN

LA JOLLA POINTE DRIVE AND LAG

ROCKWALL, TEXAS

REVISIONS

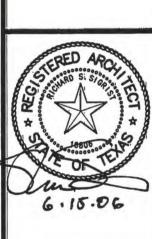


S ARCHITECTS LLC.


1304 W. ABRAM STREET, SUITE #250
ARLINGTON, TEXAS 76013
40-9003
FAX: 817/649-8410

Date 06/15/06

Job 06019

Sheet: ELEV-2

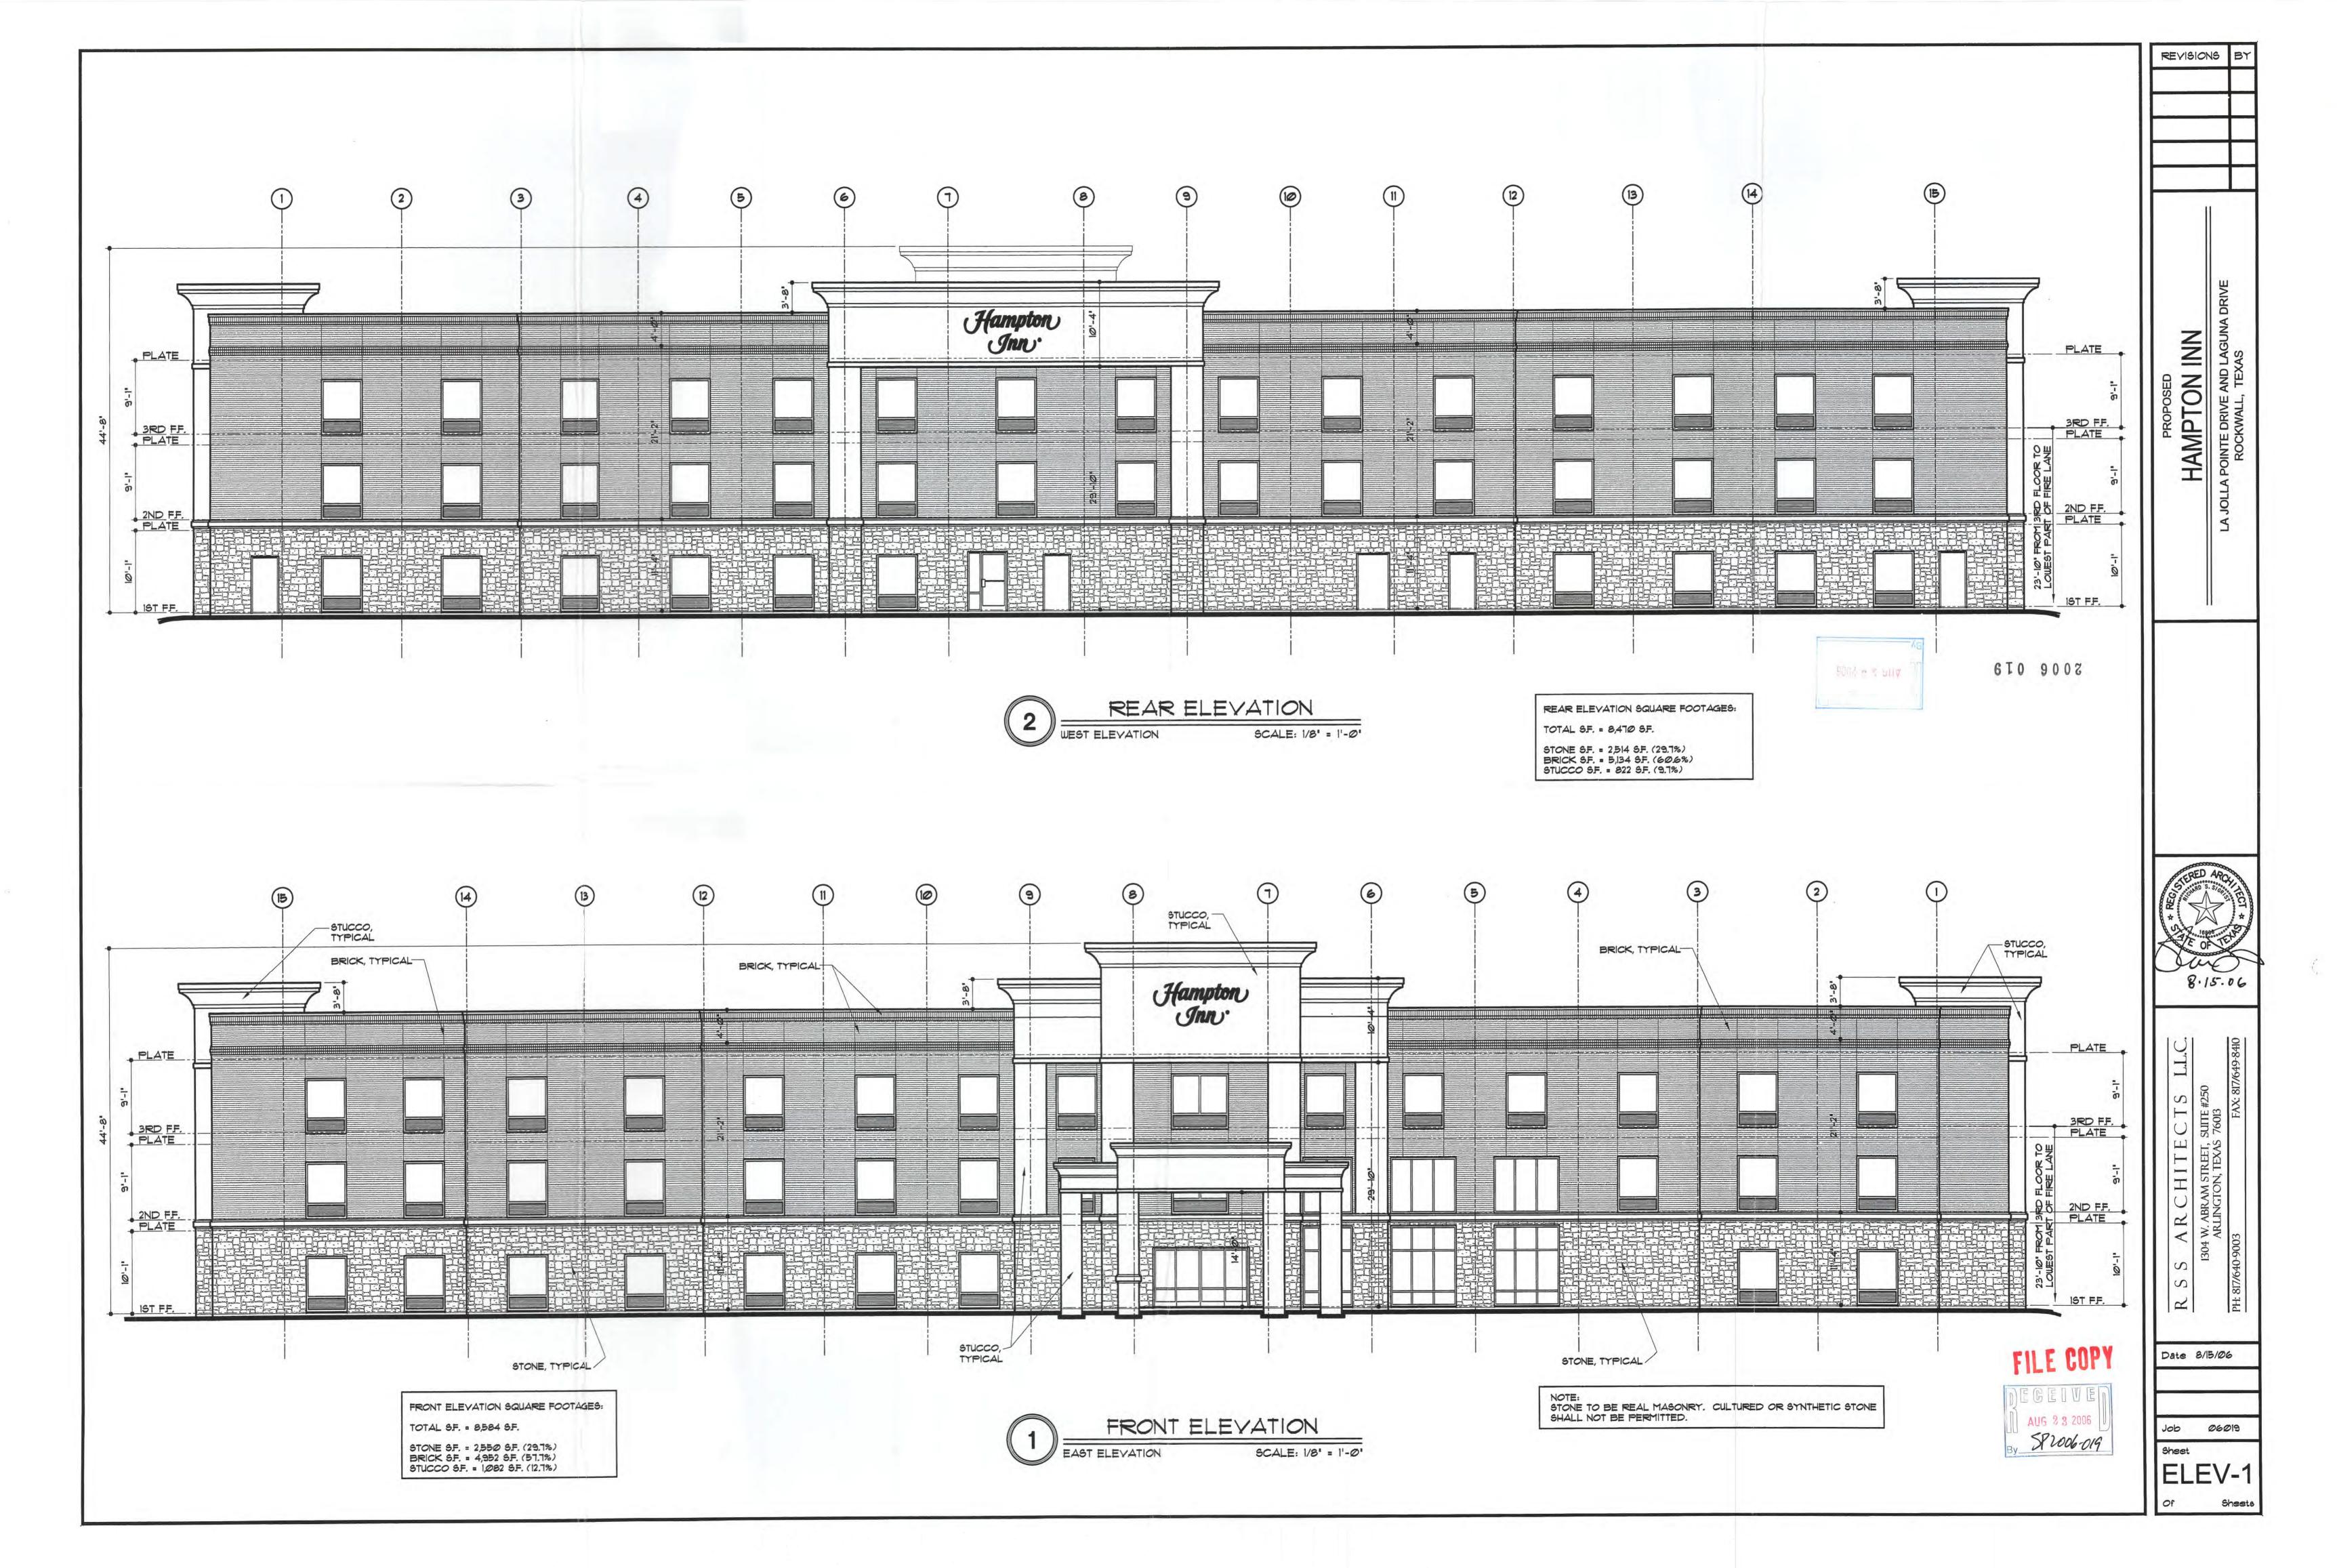

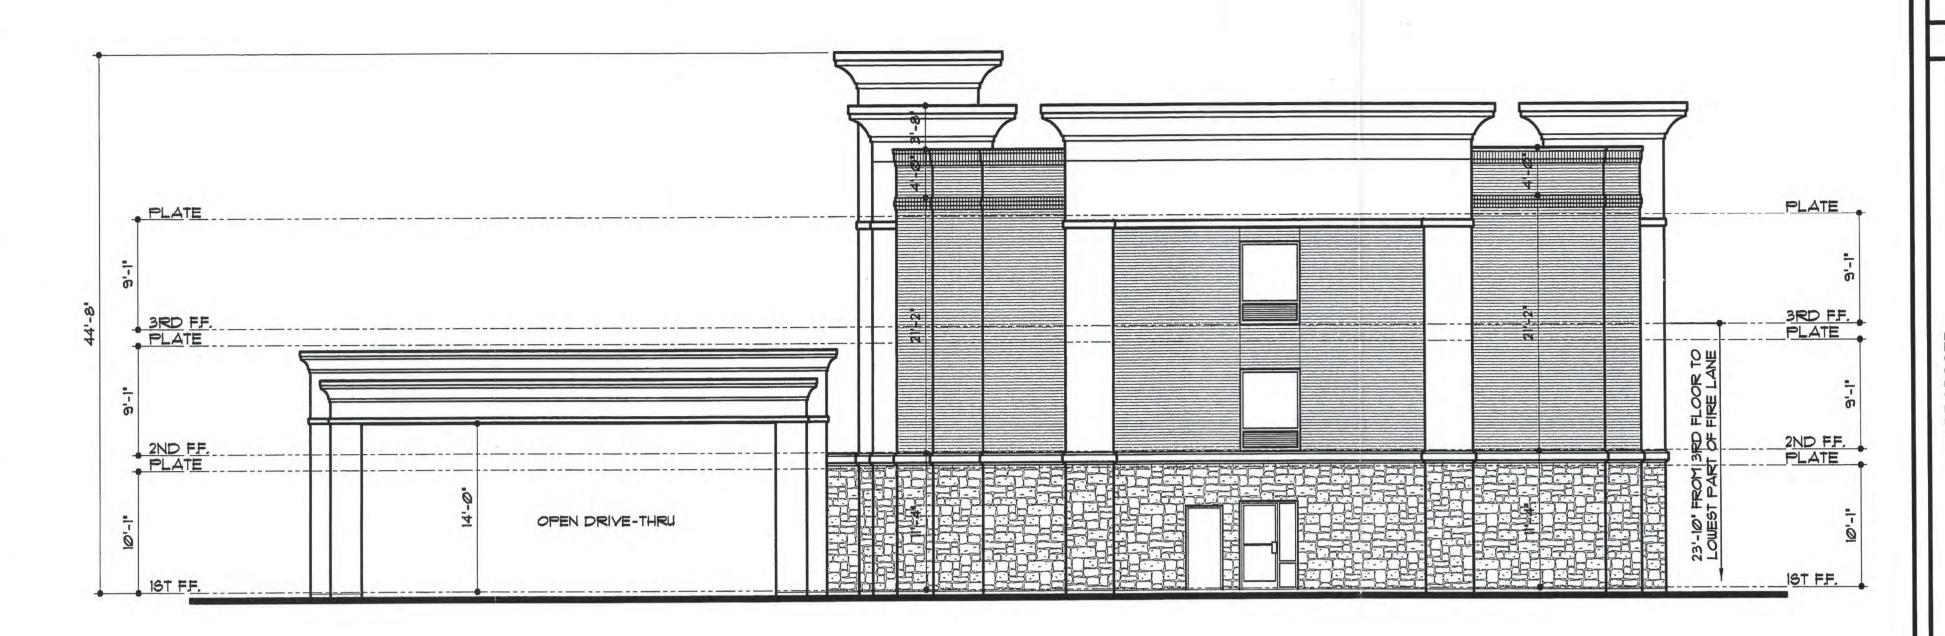

RIGHT ELEVATION SQUARE FOOTAGES:


TOTAL SF. = 2,656 SF.

STONE S.F. = 808 S.F. (30.4%) BRICK S.F. = 1,190 S.F. (44.8%) STUCCO S.F. = 658 S.F. (24.8%)

RIGHT SIDE ELEVATION

\$000 OT8



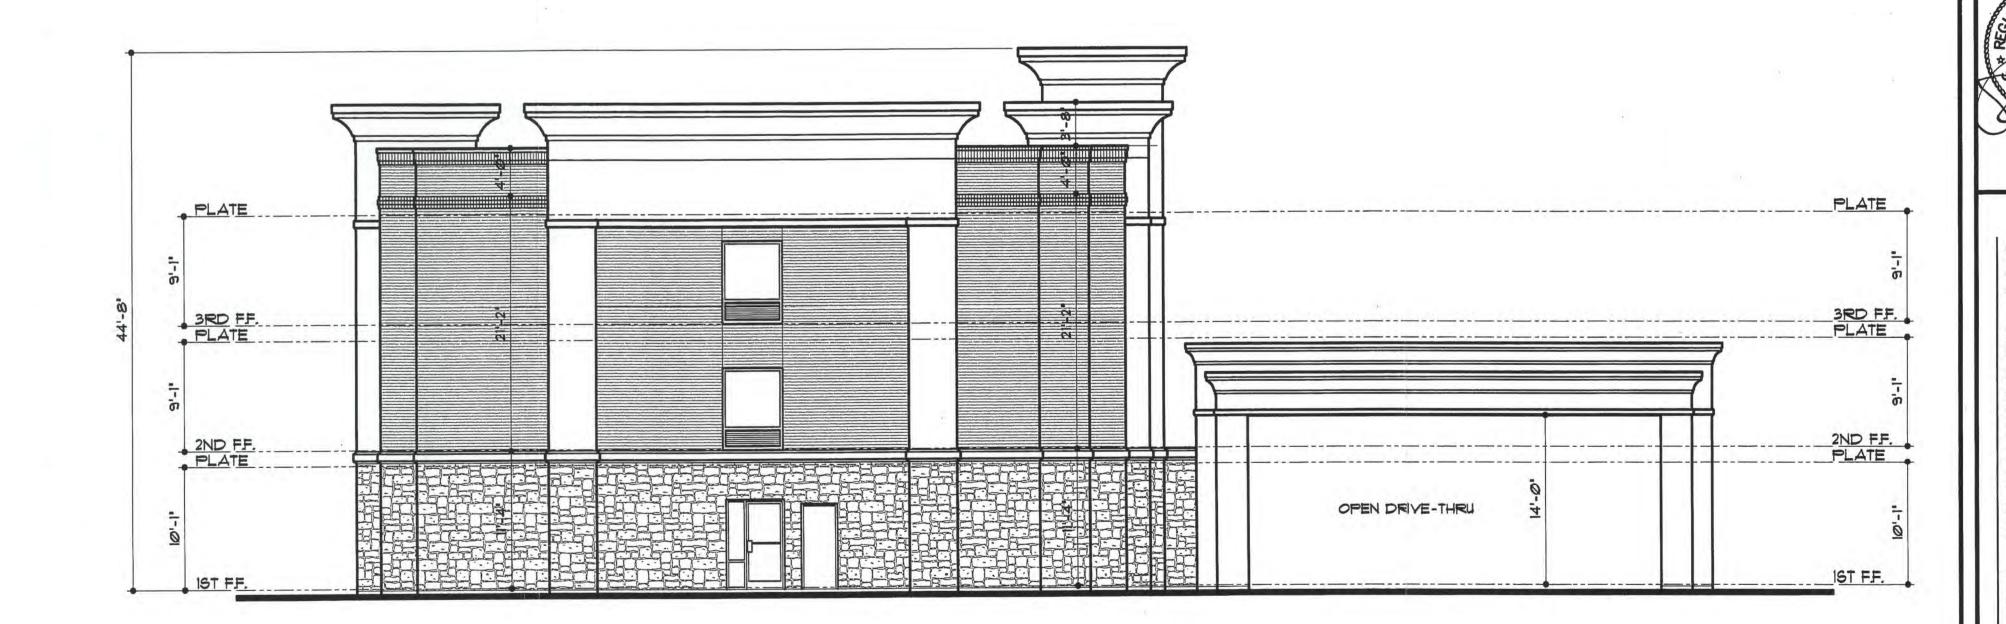


LEFT ELEVATION SQUARE FOOTAGES:

TOTAL SF. = 2,656 SF.

STONE S.F. = 808 S.F. (30.4%) BRICK S.F. = 1,190 S.F. (44.8%) STUCCO S.F. = 658 S.F. (24.8%)

LEFT SIDE ELEVATION SCALE: 1/8' = 1'-0"

FILE COPY

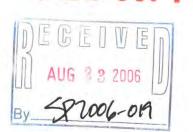

Job Shea



CITY OF ROCKWALL

at Rockwall CityPlace

8/30/2006

Rockwall RMKP LP Kaveen Patel 6005 Silverleaf Ln. Garland, TX 75043

RE: SP2006-019, Hampton Inn

Project Type: SITE PLAN

Dear Applicant:

This letter serves to notify you that the above referenced case that you submitted before the City of Rockwall was approved by the Planning and Zoning Commission on 8/29/2006. The following is a record of all recommendations, voting records and conditions of approval:

On 6/27/06 the Architectural Review Board recommended approval of the site plan and building elevations subject to review of final building materials.

Staff Recommends approval of the request with the following conditions:

- 1. Submittal and approval of engineering plans prior to replat.
- 2. Adherence to fire department requirements.
- 3. Submittal and approval of replat.
- 4. All rooftop and ground mounted mechanical equipment must be screened from all adjacent properties and right of ways.
- 5. All exterior lighting shall be directed downward and be full or partial cut-off as defined by the Unified Development Code. No lighting shall exceed 0.2-FC when measured at the property line.

On 8/29/06 the Planning and Zoning Commission approved the site plan with staff conditions by a vote of 6 to 0 (Hunter absent).

Please contact the City of Rockwall Planning Staff at (972) 771-7745 with any questions regarding this matter.

Sincerely yours

Michael Hampton, AICP

Planning and Zoning Manager