PLANNING AND ZONING CASE CHECKLIST City of Rockwall Planning and Zoning Department 385 S. Goliad Street Rockwall, Texas 75087

☐ TREESCAPE PLAN

HITECTURAL REVIEW BOARD DATE HPAB DATE PARK BOARD DATE COPY OF ORDINANCE (ORD.#) ZONING APPLICATION SPECIFIC USE PERMIT ZONING CHANGE PD CONCEPT PLAN PD DEVELOPMENT PLAN PON MAP NEWSPAPER PUBLIC NOTICE SOO-FT. BUFFER PUBLIC NOTICE PROJECT REVIEW STAFF REPORT CORRESPONDENCE SITE PLAN LANDSCAPE PLAN COPY-ALL PLANS REQUIRED COPY-MARK-UPS	ASE # 572019-044 P&Z DATE 12/31	CC DATE	APPROVED/DENI
ZONING APPLICATION ☐ SPECIFIC USE PERMIT ☐ ZONING CHANGE ☐ PD CONCEPT PLAN ☐ PD DEVELOPMENT PLAN ☐ PON MAP ☐ FLU MAP ☐ NEWSPAPER PUBLIC NOTICE ☐ 500-FT. BUFFER PUBLIC NOTICE ☐ PROJECT REVIEW ☐ STAFF REPORT ☐ CORRESPONDENCE ☐ COPY-ALL PLANS REQUIRED	ITECTURAL REVIEW BOARD DATE	HPAB DATE P	ARK BOARD DATE
□ TREESCAPE PLAN □ CITY COUNCIL MINUTES-LASERFICHE □ PHOTOMETRIC PLAN □ MINUTES-LASERFICHE □ BUILDING ELEVATIONS □ PLAT FILED DATE	☐ SPECIFIC USE PERMIT ☐ ZONING CHANGE ☐ PD CONCEPT PLAN ☐ PD DEVELOPMENT PLAN ☐ PD DEVELOPMENT PLAN ☐ SITE PLAN ☐ LANDSCAPE PLAN ☐ TREESCAPE PLAN ☐ PHOTOMETRIC PLAN ☐ BUILDING ELEVATIONS ☐ MATERIAL SAMPLES	APPLICATIONS RECEIPT LOCATION MAP HOA MAP PON MAP FLU MAP NEWSPAPER PU 500-FT. BUFFER PROJECT REVIEV STAFF REPORT CORRESPONDEN COPY-ALL PLANS COPY-MARK-UP CITY COUNCIL M MINUTES-LASER PLAT FILED DATI	BLIC NOTICE PUBLIC NOTICE V ICE S REQUIRED S IINUTES-LASERFICHE FICHE
	PLATTING APPLICATION MASTER PLAT PRELIMINARY PLAT FINAL PLAT REPLAT ADMINISTRATIVE/MINOR PLAT VACATION PLAT LANDSCAPE PLAN	ZONING MAP UPDA	ATED



information."

DEVELOPMENT APPLICATION

City of Rockwall Planning and Zoning Department 385 S. Goliad Street Rockwall, Texas 75087

57	'JSE ONLY	-

IG CASE NO. 5P2019 - 041

NOTE: THE APPLICATION IS NOT CONSIDERED ACCEPTED BY THE CITY UNTIL THE PLANNING DIRECTOR AND CITY ENGINEER HAVE SIGNED BELOW.

ELIZABETH A. MORGAN

NOTARY PUBLIC - STATE OF TEXAS 10# 1078404-7 COMM. EXP. 02-28-2021

DIRECTOR OF PLANNING: CITY ENGINEER:

Please check the a	ppropriate box below to indicate	the type of develop	oment request	(SELECT ON	ILY ONE BOX]:		
[] Preliminary P [] Final Plat (\$300. [] Replat (\$300. [] Amending or [] Plat Reinstate Site Plan Applica [] Site Plan (\$25	\$100.00 + \$15.00 Acre) ¹ lat (\$200.00 + \$15.00 Acre) ¹ 00.00 + \$20.00 Acre) ¹ 00 + \$20.00 Acre) ¹ Minor Plat (\$150.00) ement Request (\$100.00)	\$100.00)	Zoning Application Fees: [] Zoning Change (\$200.00 + \$15.00 Acre) ¹ [] Specific Use Permit (\$200.00 + \$15.00 Acre) ¹ [] PD Development Plans (\$200.00 + \$15.00 Acre) ¹ Other Application Fees: [] Tree Removal (\$75.00) [] Variance Request (\$100.00) Notes: ¹: In determining the fee, please use the exact acreage when multiplying by per acre amount. For requests on less than one acre, round up to one (1) acrease.				
PROPERTY INFO	ORMATION [PLEASE PRINT]						
Address	409 W. Washing	ton					
	Lowe & Allen			Lo	t west half	Block	14
General Location					, ,		,
ZONING, SITE P	LAN AND PLATTING INFOR	MATION [PLEASE I	PRINT)				
Current Zoning	Downtown		Current Use	Vaca	nt		
Proposed Zoning	Downtown		Proposed Use	Offic	e		
Acreage	1.27	Lots [Current]			Lots [Proposed])	
SITE PLANS AND process, and fail	D PLATS: By checking this box you ackno ure to address any of staff's comments by	wledge that due to the the date provided on t	e passage of <u>HB31</u> he Development Co	67 the City n	o longer has flexibilit sult in the denial of y	ty with regard our case.	to its approva
OWNER/APPLIC	CANT/AGENT INFORMATIO	N [PLEASE PRINT/CHE	CK THE PRIMARY	CONTACT/OR	IGINAL SIGNATURES	ARE REQUIRE	D]
[] Owner	washington lace				y & Reges		
Contact Person	Jimmy Mc Clintock 3021 Ridge Road HI44		Contact Person	ROSS	Ramsay		
Address	3021 Ridge Road HI44		Address	2225	Ridge Road	1201	
City, State & Zip	Rackwall Texas 75032	. (City, State & Zip	Rockn	iall Toxas	15087	
	972.983.2222				774.8889		
	LMBC. rw egmail.	Com	E-Mail	ryran	nsay eyah	au.con	
Before me, the undersig	CATION [REQUIRED] gned authority, on this day personally app ue and certified the following:	neared Ross Ray			he undersigned, wh		nformation on
"I hereby certify that I a cover the cost of this ap that the City of Rockwa	m the owner for the purpose of this applic plication, has been paid to the City of Roc Ill (i.e. "City") is authorized and permitted	cation; all information s kwall on this the 13 st d to provide informatio	day of	true and corre	ect; and the applicati , 20 <u>1 9</u> . By si tion to the public. Ti	on fee of \$ gning this appl he City is also	ication, I agree

Notary Public in and for the State of Texas My Commission Expires 02-28-21

permitted to reproduce any copyrighted information submitted in conjunction with this application, if such reproduction is associated or in response to a request for public

Given under my hand and seal of office on this the 13th day of December, 2019.



DEVELOPMENT REVIEW COMMITTEE (DRC) CITY OF ROCKWALL, PLANNING & ZONING DEPARTMENT

Phone: (972) 771-7745

Email: Planning@Rockwall.com

External Review:

Wayne Carter, Charter Communications
Jim Friske, Charter Communications

Dinah Wood, Atmos Randy Voight, Oncor Phillip Dickerson, Oncor Brian Duncan, AT&T Javier Fernandez, RISD Brenda Callaway, TXDOT

Stephen Geiger, Farmer's Electric Frank Spataro, Farmer's Electric

Internal Review:

Amy Williams, Engineering

John Shannon, Building Inspections

Ariana Hargrove, Fire Andy Hesser, Parks Andy Villarreal, Police

From: Planning & Zoning Department

Date: 12/17/2019

To assist the Planning Department in evaluating the attached request, we are sending it to you for your review and comments. Please return any comments and/or plan mark-ups to us within five (5) days. Internal staff will also be required to have all comments input into CRW no later than Friday, 12/19/2019. Planning staff will assemble all comments received in time for our regularly scheduled DRC meeting on 12/19/2019 at 2:00 p.m. The Planning and Zoning Commission work session will be held on 12/30/2019 at 6:00 p.m. You are welcome to attend both meetings. If you have any questions, please contact us at (972) 771-7745.

Project Number:

SP2019-044

Project Name:

Office Complex

Project Type:

SITE PLAN

Applicant Name:

ROSS RAMSAY

Owner Name:

JIMMY MCCLINTOCK

Project Description:

Discuss and consider a request by Steven Reyes of Ramsay & Reyes, LLC on behalf of Jimmy McClintock of LMGC, LLC for the approval of a site plan for an office building on a 0.739-acre tract of land identified as a portion of Lot 14 of the Lowe & Allen Addition [0.4590-acres] and Lot 2-R, Block A, Washington Place Addition [0.28-acres], City of Rockwall, Rockwall County, Texas, zoned Downtown (DT) District, situated within the SH-66 Overlay (SH-66 OV) District, addressed as 409 W. Washington

Street, and take any action necessary



RECEIPT

Project Number: SP2019-044

Job Address: 409 W WASHINGTON ST

ROCKWALL, TX 75087

Receipt Number: B87434

Printed: 3/5/2020 2:23 pm

Fee Description Account Number Fee Amount

SITE PLANNING

01-4280 \$270.00

Total Fees Paid: \$270.00

Date Paid: 11/18/2019 12:00:00AM Paid By: Ramsay & Reyes, LLC Pay Method: CHECK 1008

Received By: DG

City of Rockwall



11/18/2019 DG

Project Plan Review History

Owner

Applicant

Project Number Project Name

SP2019-044 Office Complex

SITE PLAN

Subtype

Type

Staff Review Status

Site Address

City, State Zip

Tract

409 W WASHINGTON ST

ROCKWALL, TX 75087

Subdivision WASHINGTON PLACE

Block W/2 OF 14

Lot No

JIMMY MCCLINTOCK

ROSS RAMSAY

Parcel No

General Plan

Applied

Closed

Expired

Status

Zoning

Approved

4180-0014-0000-B0-0R

Type of Review / Notes	Contact	Sent	Due	Received	Elapse	d Status	Remarks
BUILDING	Russell McDowell	11/18/201	9 11/25/20	019 11/18/2019		APPROVED	
ENGINEERING	Sarah Johnston	11/18/201	9 11/25/20	019 11/22/2019	4	COMMENTS	

(11/22/2019 9:26 AM SJ)

- M Add note, "No trees within 5' of utilities" to the landscape plan. Standards of Design and Construction Sect. 4.4
- M Must dimension the distance from the driveways to the nearest driveway on either side. Standards of Design 2.6
- M Parking near the building or head to head parking to be 20'x9'. All other parking to be 18'x9'. Standards of Design 2.20
- M No structures in easements. This includes retaining walls and footings. Standards of Design 5.1.3
- M All fire lane radii to be 20' min. If the building is 36' or taller, the fire lane radius must be 30'min. Standards of Design 2.20
- M No structures in easements. This includes retaining walls and footings, dumpster and screening wall must be out of easements. Standards of Design 5.1.3
- M All fire hydrants must have a 20'x20' easement established. Fire hydrants to have 5' of clearance around all sides. Standards of Design 5.2.11
- M Minimum easement width is 20' for proposed easements. Standards of Design 5.1.3
- M Retaining walls in detention require a variance Standards of Design 3.4.4
- M Must stub out the 8" water and 8" sewer to the northern property for future expansion. Standards of Design 5.1.2
- M All fire lanes or drive isles must be a minimum of 24' wide. Standards of Design and Construction 2.20
- M Must install a 6' sidewalk along the street frontage. Standards of Design 2.14.
- M Proposed & existing water and sewer to be shown on site plan (Not separate sheet)
- M 10' U.E required along ROW
- M Water line must be looped on-site place water line in fire lane instead of TXDOT ROW. Standards of Design 5.2.2
- M Must meet all standards of design and construction.
- I Landscape plan shows walls in detention. Not allowed without variance approval, from P&Z Commission
- I Was the ROW for Second St. purchased?
- I 4% Engineering Fees
- I Impact Fees
- I Must have detention on-site. Manning's C-value is per zoning
- I Water and sewer lines must have 10' of easement on both sides
- I No utilities in detention easements
- I No grate utilities allowed
- I Fire Lane paving to be 8" 3600 psi (6.5 sack mix)
- I No sand allowed under paving.
- I Walls 3' and over must be engineered
- I All retaining walls to be rock or stone face. No smooth concrete walls.
- I If using the pond for detention, it must be over the existing level.
- I Detention outfall must reach sheet flow conditions prior to crossing the property line.
- I Will need TxDOT driveway and utility permits.
- I TIA required w/ fees.
- I Engineering review fees apply

ENGINEERING Sarah Johnston

12/19/2019 12/26/2019 12/19/2019

COMMENTS

Project Reviews.rpt Page 2 of 9

A turning radius of 30-feet for buildings 30-feet or above in height and/or 3 or more stories in height.

Fire lane cannot exceed 10% in grade change, with cross slope not exceeding 5%. The angles of approach and departure for fire apparatus access roads shall be within the limits established by the fire code official based on the fire department's apparatus.

GIS 11/18/2019 11/25/2019 11/20/2019 2 APPROVED Lance Singleton See comments

Project Reviews.rpt Page 3 of 9

Type of Review / Note	s Contact	Sent	Due	Received	Elapsed	d Status	Remarks
(11/20/2019 4:48	PM LS)						
Address assignme	ent will be:						
409 W. Washingt	on St, Rockwall, TX 75087						
PLANNING	Korey Brooks	11/18/201	9 11/25/201	9 11/22/2019	4	COMMENTS	Comments

Project Reviews.rpt Page 4 of 9

SP2019-044; 409 W Washington Street

Please address the following comments (M= Mandatory Comments; I = Informational Comments)

- I.1 This a request by Steven Reyes of Ramsay & Reyes, LLC on behalf of Jimmy McClintock of LMGC, LLC for the approval of a site plan for an office building on a 0.739-acre tract of land identified as a portion of Lot 14 of the Lowe & Allen Addition [0.4590-acres] and Lot 2-R, Block A, Washington Place Addition [0.28-acres], City of Rockwall, Rockwall County, Texas, zoned Downtown (DT) District, situated within the SH-66 Overlay (SH-66 OV) District, addressed as 409 W. Washington Street.
- I.2 For questions or comments concerning this case please contact Korey Brooks in the Planning Department at (972) 772-6434 or email kbrooks@rockwall.com. M.3 For reference, include the case number (SP2019-044) in the lower right-hand corner of all pages on future submittals.
- 1.4 This project is subject to all requirements stipulated by the Unified Development Code (UDC).
- M.5 Please make the following clarifications on the site plan to ensure staff can properly review this project and convey all of the required elements to the City's boards and commissions:
- (1) Please do not provide a separate page for utilities. Please show on site plan and landscape plan.
- (2) Please show topo on site plan and landscape plan.
- (3) Please remove labels for Lots 1R and 2R and provide existing lot and block information on site plan.
- (4) Please correct address on plans. Some plans indicate 409 W Washington and some indicate 411 W. Washington.
- (5) Please provide site data table on site plan.
- (6) Please show centerlines of adjacent roadways.
- (7) Please note that all plans need to match (i.e. currently the utility plan does not match site plan.
- (8) Please note that the water line will need to be looped through the site.
- (9) Please check the orientation of the stairs on the site plan.
- (10) Please remove the concrete planter from the parking space
- (11) Please remove signage from the site plan.
- (12) Please utilize a variety of line types and line weights. It is difficult to determine what the lines are (i.e. there are several lines running N/S adjacent to the concrete planter)
- (13) Please note that the dumpster enclosure cannot face the street. Also, a detail has been provided.
- (14) Please dimension a typical parking space.
- (15) Please check radii at drive aisles to ensure conformance to the engineering standards of design.
- (16) Please show and label the property line.
- (17) Please show FL with a hatch pattern, stipple, shade of gray, etc.
- (18) Please provide pavement type and depth.
- (19) Please show proposed sidewalks as a hatch pattern.
- (20) Please dimension distance of building from property lines.
- (21) Please note, the site plan, building elevations, rendering do not seem to match. (i.e. the site plan shows projections/recesses adjacent to Washington Street that do not appear in the rendering and building elevations.
- (22) Please provide all engineering information on site plan.
- (23) Please provide treescape plan
- (24) Please note that walls in the detention area will require a variance.
- (25) Please label detention pond and show on all plans.
- (26) Please show and label property line on LS Plan.
- LANDSCAPE PLAN
- (27) Please remove the cross slope % and show topo on landscape plan.

Project Reviews.rpt Page 5 of 9

- (32) Please show centerline of ROW.
- (33) Please note, that the dumpster enclosure cannot face public ROW. Detail has been provided.
- (34) Please show and label property line.
- (35) Please note, it is difficult to see location of fixtures. Please greyscale FC and bold the fixtures

BUILDING ELEVATIONS

PHOTOMETRIC PLAN

- (36) Please note, that the one-story building is required to be two-stories min
- (37) What is the material below the stairs? Retaining wall? Please show and label.
- I.6 Please note that failure to address all comments provided by staff by 5:00 PM on December 3, 2019 will result in the automatic denial of the case on the grounds of an incomplete submittal. No refund will be given for cases that are denied due to an incomplete submittal, and a new application and fee will be required to resubmit the case.
- 1.7 Staff has identified the aforementioned items necessary to continue the submittal process. Please make these revisions and corrections, and provide any additional information that is requested.
- o Revisions for this case will be due on December 3, 2019;
- o The Planning & Zoning Worksession is November 26, 2019.
- The Planning and Zoning Commission Meeting for this case is December 10, 2019
- o The City Council Meeting for this case is December 16, 2019.

PLANNING Korey Brooks 12/19/2019 12/26/2019 12/20/2019 1 COMMENTS Comments

Project Reviews.rpt Page 6 of 9

SP2019-044; Site Plan for 409 W. Washington Street

Please address the following comments (M= Mandatory Comments; I = Informational Comments)

- I.1 This is a request by Steven Reyes of Ramsay & Reyes, LLC on behalf of Jimmy McClintock of LMGC, LLC for the approval of a site plan for an office building on a 0.739-acre tract of land identified as a portion of Lot 14 of the Lowe & Allen Addition [0.4590-acres] and Lot 2-R, Block A, Washington Place Addition [0.28-acres], City of Rockwall, Rockwall County, Texas, zoned Downtown (DT) District, situated within the SH-66 Overlay (SH-66 OV) District, addressed as 409 W. Washington Street.
- I.2 For questions or comments concerning this case please contact Korey Brooks in the Planning Department at (972) 772-6434 or email kbrooks@rockwall.com. M.3 For reference, include the case number (SP2019-044) in the lower right-hand corner of all pages on future submittals.
- 1.4 This project is subject to all requirements stipulated by the Unified Development Code (UDC).
- M.5 In order to constitute a complete submittal all applications are required to provide the following elements: [1] a site plan, [2] landscape plan, [3] building elevations and this submittal is complete.

M.6 Site Plan. Please make the following clarifications on the Site Plan to ensure staff can properly review this project and convey all of the required elements to the City's boards and commissions:

- (1) Please check building elevations. The windows from the second floor of Building 1 do not align with the windows from Building 2.
- (2) Please note, the amount of cast stone seems heavy for a building of this size.
- (3) Please take a look at the south elevation and provide some relief on the portion of the building that has no windows.
- (4) Please note, the rendering does not appear to match the building elevations.
- (5) Please schedule a meeting with staff to discuss revisions.
- (6) Trash/Recycling Enclosures. Trash/Recycling enclosures shall befour (4) sided. These receptacles shall be screened by a minimum six (6) foot, solid masonry dumpster enclosure that utilizes the same masonry materials as the primary building and incorporates an opaque, self-latching gate. The opaque, self-latching gate shall not be constructed utilizing wood fencing materials. If the primary building does not use masonry materials, a masonry material that is complimentary in color and scale shall be utilized. These enclosures shall be located to the side or rear of the primary building, and shall not front on to a public right-of-way. Every effort shall be made to reduce the visibility of these structures utilizing landscaping and/or the building. All trash/recycling enclosures shall be constructed in conformance to the diagram below, unless otherwise approved/required by the City and/or its contractor for trash services. Please provide elevation for dumpster enclosure.
- (1) Utility Equipment and Air Condition Units. Pad or roof mounted utility equipment and air conditioning units shall be screened from the view from of any adjacent public streets or properties. Roof mounted utility equipment and air conditioning units shall be screened using a parapet wall that completely impairs the visibility of the equipment, and is constructed on all sides of the building. Ground mounted Utility equipment and air conditioning units shall be screened utilizing plantings, berms, walls matching the main structure, or an architectural feature that is integral to the building's design. Please show how all equipment will be screened.

SUBSECTION 1.08: PUBLIC RIGHT-OF-WAY VISIBILITY

(A) Street/drive intersection visibility obstruction triangles. A landscape plan showing the plan of the street on both sides of each proposed drive/street to the proposed development with the grades, curb elevations, proposed street/drive locations, and all items (both natural and manmade) within the visibility triangles as prescribed below shall be provided with all site plans, if they are not on engineering plans that are submitted at the same time. this plan shall show no horizontal or vertical restrictions (either existing or future) within the areas defined below.

Project Reviews.rpt Page 7 of 9

- (B) Obstruction/interference triangles defined. No fence, wall screen, billboard, sign face, tree or shrub foliage, berm, or any other item, either manmade or natural, shall be erected, planted, or maintained in such a position or place so as to obstruct or interfere within the following minimum standards; however, on non-residentially zoned lots, a single pole for mounting a sign may be placed within this area provided the pole does not exceed 12-inches in diameter, and provided every portion of the sign has a minimum height clearance of nine (9) feet: Please provide where applicable
- (1) Visibility Triangles. Vision at all intersections which intersect at or near right angles shall be clear at elevations between 24-inches and nine (9) feet above the top of the curb elevation, within a triangular area formed by extending the two (2) curblines from their point of intersection, for the following minimum distances for the applicable intersection, and connecting these points with an imaginary line, thereby making a triangle. If there are no curbs existing, the triangular area shall be formed by extending the property lines from their point of intersection for a distance as prescribed below, and connecting these points with an imaginary line, thereby making a triangle as shown below.
- (2) Intersection of two (2) public streets. The minimum required distance from the curb shall be 30-feet and the minimum distance from the property line on streets without a curb shall be 20-feet.
- (3) Intersection of a public street and an alley. The minimum required distance measured from the property line shall be 15-feet, or 25-feet from street curb.
- (4) Intersection of private drive and public street. The minimum required distance from the curbshall be 15-feet and the minimum distance from the property line on streets without a curb shall be ten (10) feet.
- (C) Sight distance requirements. The city hereby adopts the standards for both vertical and horizontal sight distance requirements set forth in the latest edition of AASHTO green book "a policy on geometric design of highways and streets" for the construction of both public street intersections and private drive intersections, unless otherwise approved by the city engineer. If, in the opinion of the city engineer, a proposed street or drive intersection does not meet these standards, additional engineering information exhibiting how the standards have been addressed may be required for submission and approval by the city's engineer.
- I.7 Please note that failure to address all comments provided by staff by 5:00 PM on January 7, 2020 will result in the automatic denial of the case on the grounds of an incomplete submittal. No refund will be given for cases that are denied due to an incomplete submittal, and a new application and fee will be required to resubmit the case.
- 1.8 Staff has identified the aforementioned items necessary to continue the submittal process. Please make these revisions and corrections, and provide any additional information that is requested. Revisions for this case will be due on January 7, 2020.

M.9 Below are the meeting dates for your request. A representative is required to attend all meetings:

- December 30, 2019 Architectural Review Board (ARB) Meeting 5:00 p.m.—immediately before the Planning and Zoning Worksession.
- December 30, 2019 Planning and Zoning Worksession 6:00 p.m. immediately following the ARB Meeting.
- January 14, 2020 2nd Architectural Review Board (ARB) Meeting (at the discretion of the ARB) 5:00 p.m. immediately before the Planning and Zoning Meeting.
- January 14, 2020 Planning and Zoning Meeting 6:00 p.m. immediately following the ARB Meeting. M.10 Please see standard site plan wording below.

SITE PLAN SIGNATURE BLOCK

APPROVED:


Project Reviews.rpt Page 8 of 9

I hereby certify that the above and foregoing site plan for a development in the City of Rockwall, Texas, was approved by the Planning & Zoning Commission of the City of Rockwall on the [DAY] day of [MONTH], [YEAR].

WITNESS OUR HANDS, this [DAY] day of [MONTH], [YEAR].

Planning & Zoning Commission, Chairman Director of Planning and Zoning

Project Reviews.rpt Page 9 of 9

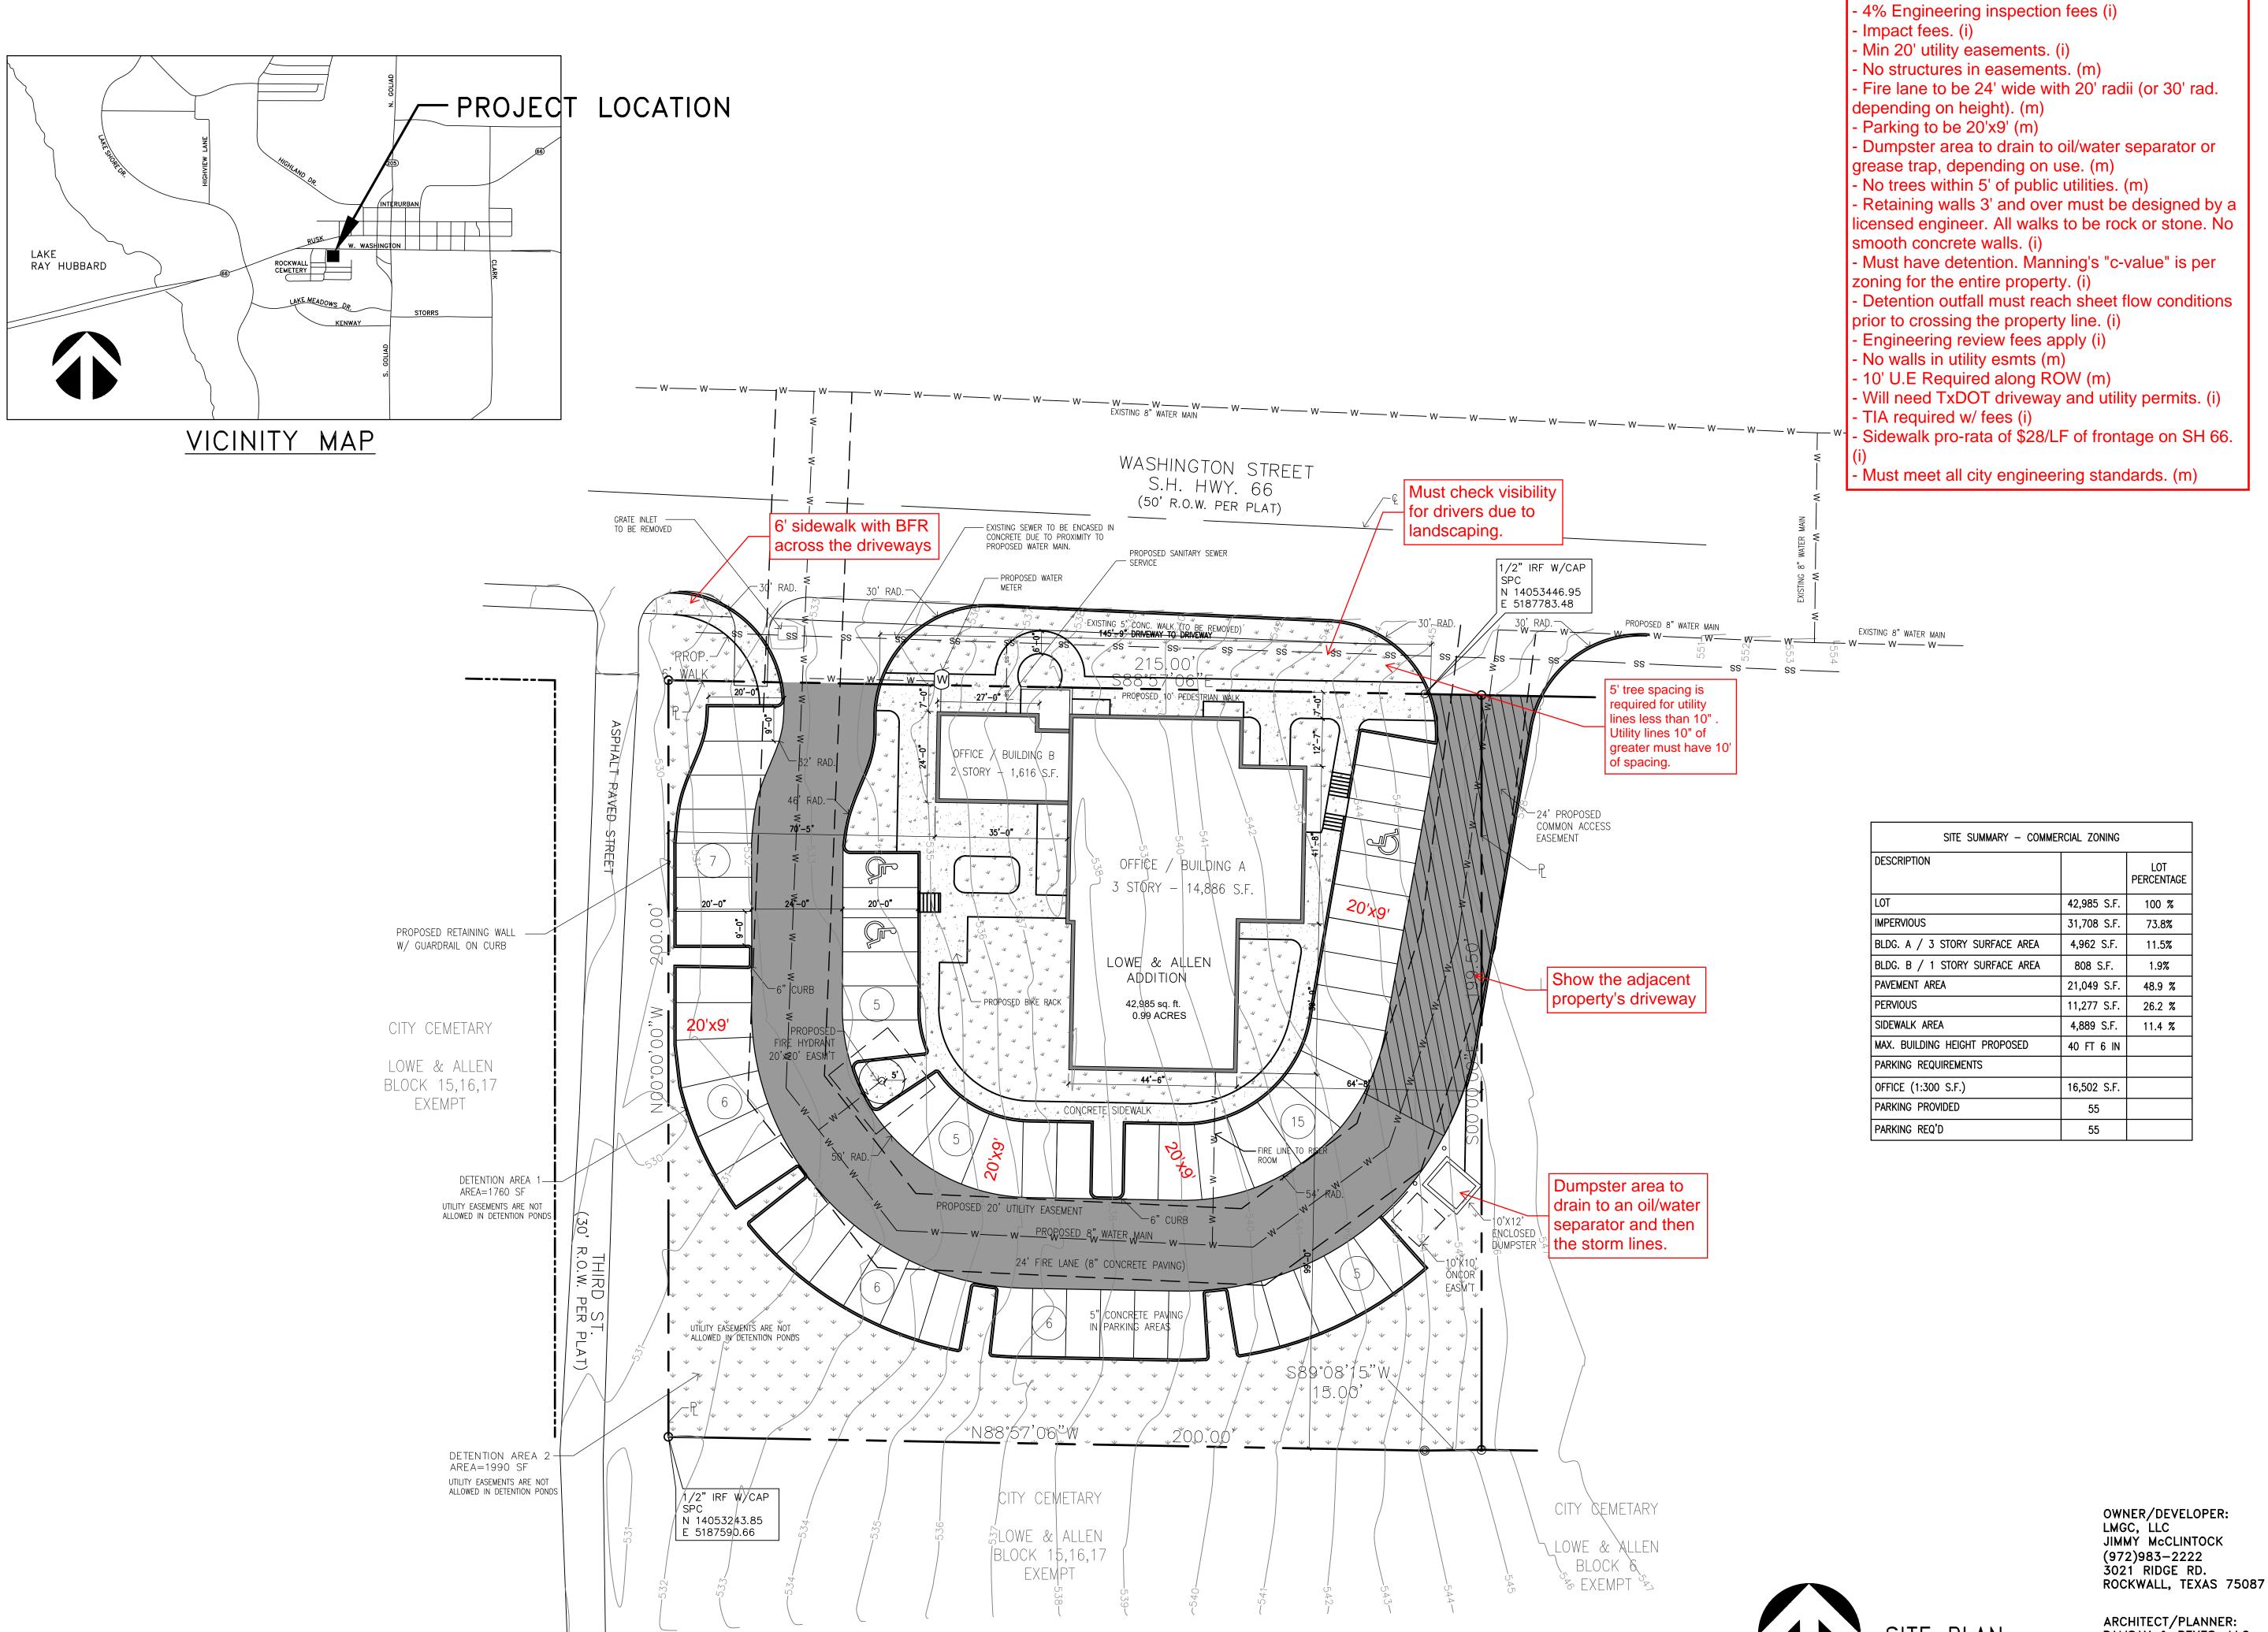

& REYES, LLC

RAMSAY & RENARCHITECTURE - MANA



No. DESCRIPTIONS/ISSUE DATE

BUSINESS PARK
409 W. WASHINGTON
ROCKWALL, TEXAS 75087

OJECT No.	
AWN BY	SR
ECKED BY	RR
TE	12/13/2019
ALE	1" = 20'
EET NO.	of

DRAWING NAME:

SITE
PLAN

ARCHITECT/PLANNER:
RAMSAY & REYES, LLC
ROSS RAMSAY
(214)536-5306
2235 RIDGE RD. STE 201
ROCKWALL, TEXAS 75087

S1.0






City of Rockwall

Planning & Zoning Department 385 S. Goliad Street Rockwall, Texas 75032 (P): (972) 771-7745 (W): www.rockwall.com The City of Rockwall GIS maps are continually under development and therefore subject to change without notice. While we endeavor to provide timely and accurate information, we make no guarantees. The City of Rockwall makes no warranty, express or implied, including warranties of merchantability and fitness for a particular purpose. Use of the information is the sole responsibility of the user.



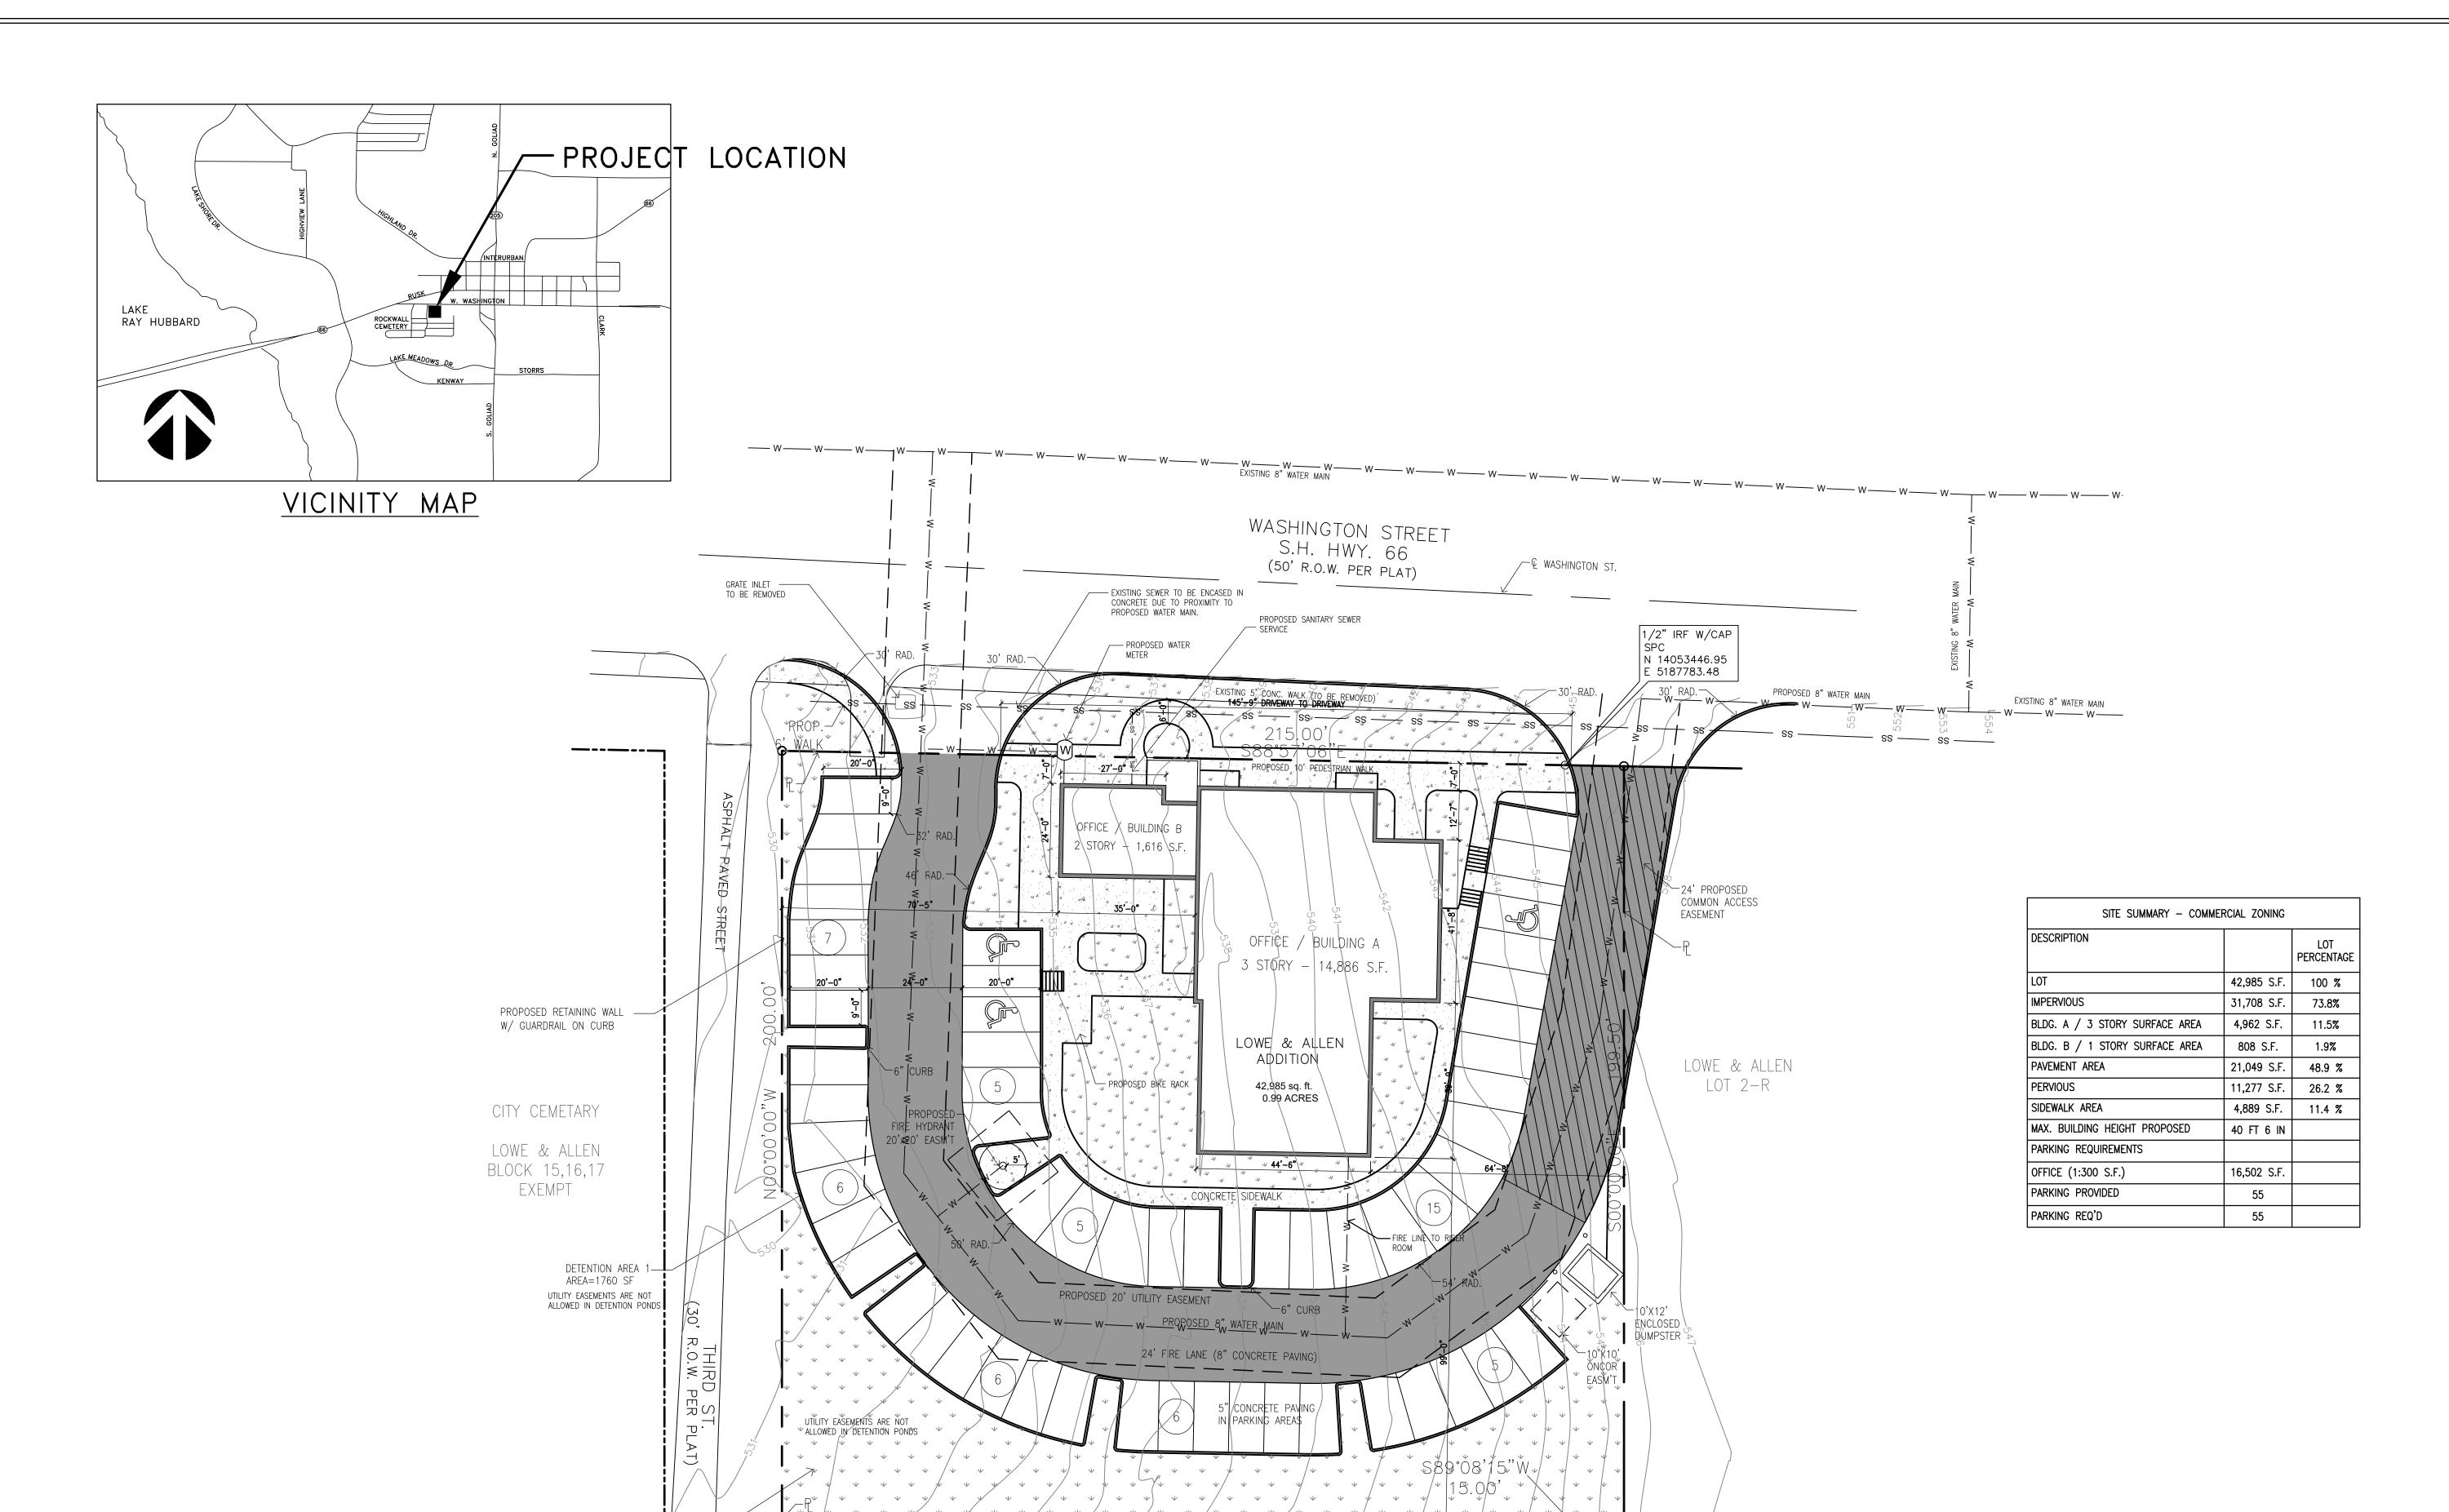

CITY CEMETARY

DLOWE & ALLEN

BLOCK 15,16,17

EXEMPT


DETENTION AREA 2 — AREA=1990 SF

UTILITY EASEMENTS ARE NOT ALLOWED IN DETENTION PONDS

/1/2" IRF W/CAP

N 14053243.85

E 5187590.66

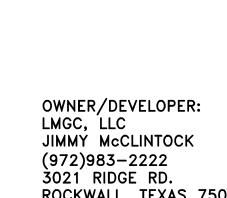

ARCHITECT/PLANNER:
RAMSAY & REYES, LLC
ROSS RAMSAY
(214)536-5306
2235 RIDGE RD. STE 201
ROCKWALL, TEXAS 75087

JIMMY McCLINTOCK
(972)983-2222
3021 RIDGE RD.
ROCKWALL, TEXAS 75087

ARCHITECT/PLANNER:
RAMSAY & REYES, LLC

CITY DEMETARY

LOWE & ALLEN

BLOCK &

S EXEMPT S

S1.0

PLAN

 $\bigcap_{i=1}^{n}$

PROJECT No.

DRAWN BY
CHECKED BY

SCALE

SHEET NO.

DRAWING NAME:

WASHINGTON TEXAS 7508


SR

12/13/2019

1" = 20'


of

RAMSAY & REYES, LLC ARCHITECTURE - MANAGEMENT

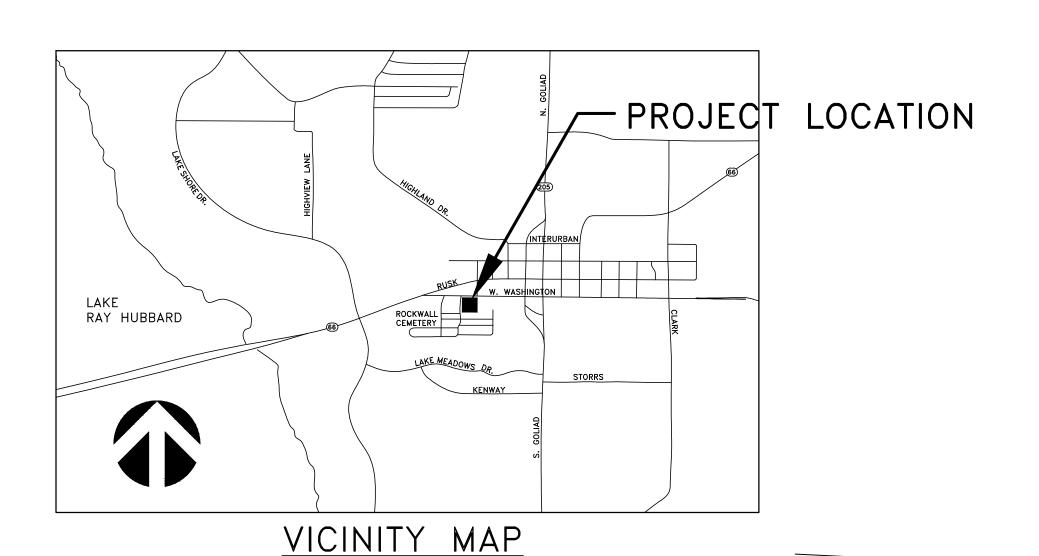

WASHINGTON STREET S.H. HWY. 66 (50' r.o.w. per plat)

/—€ WASHINGTON ST.

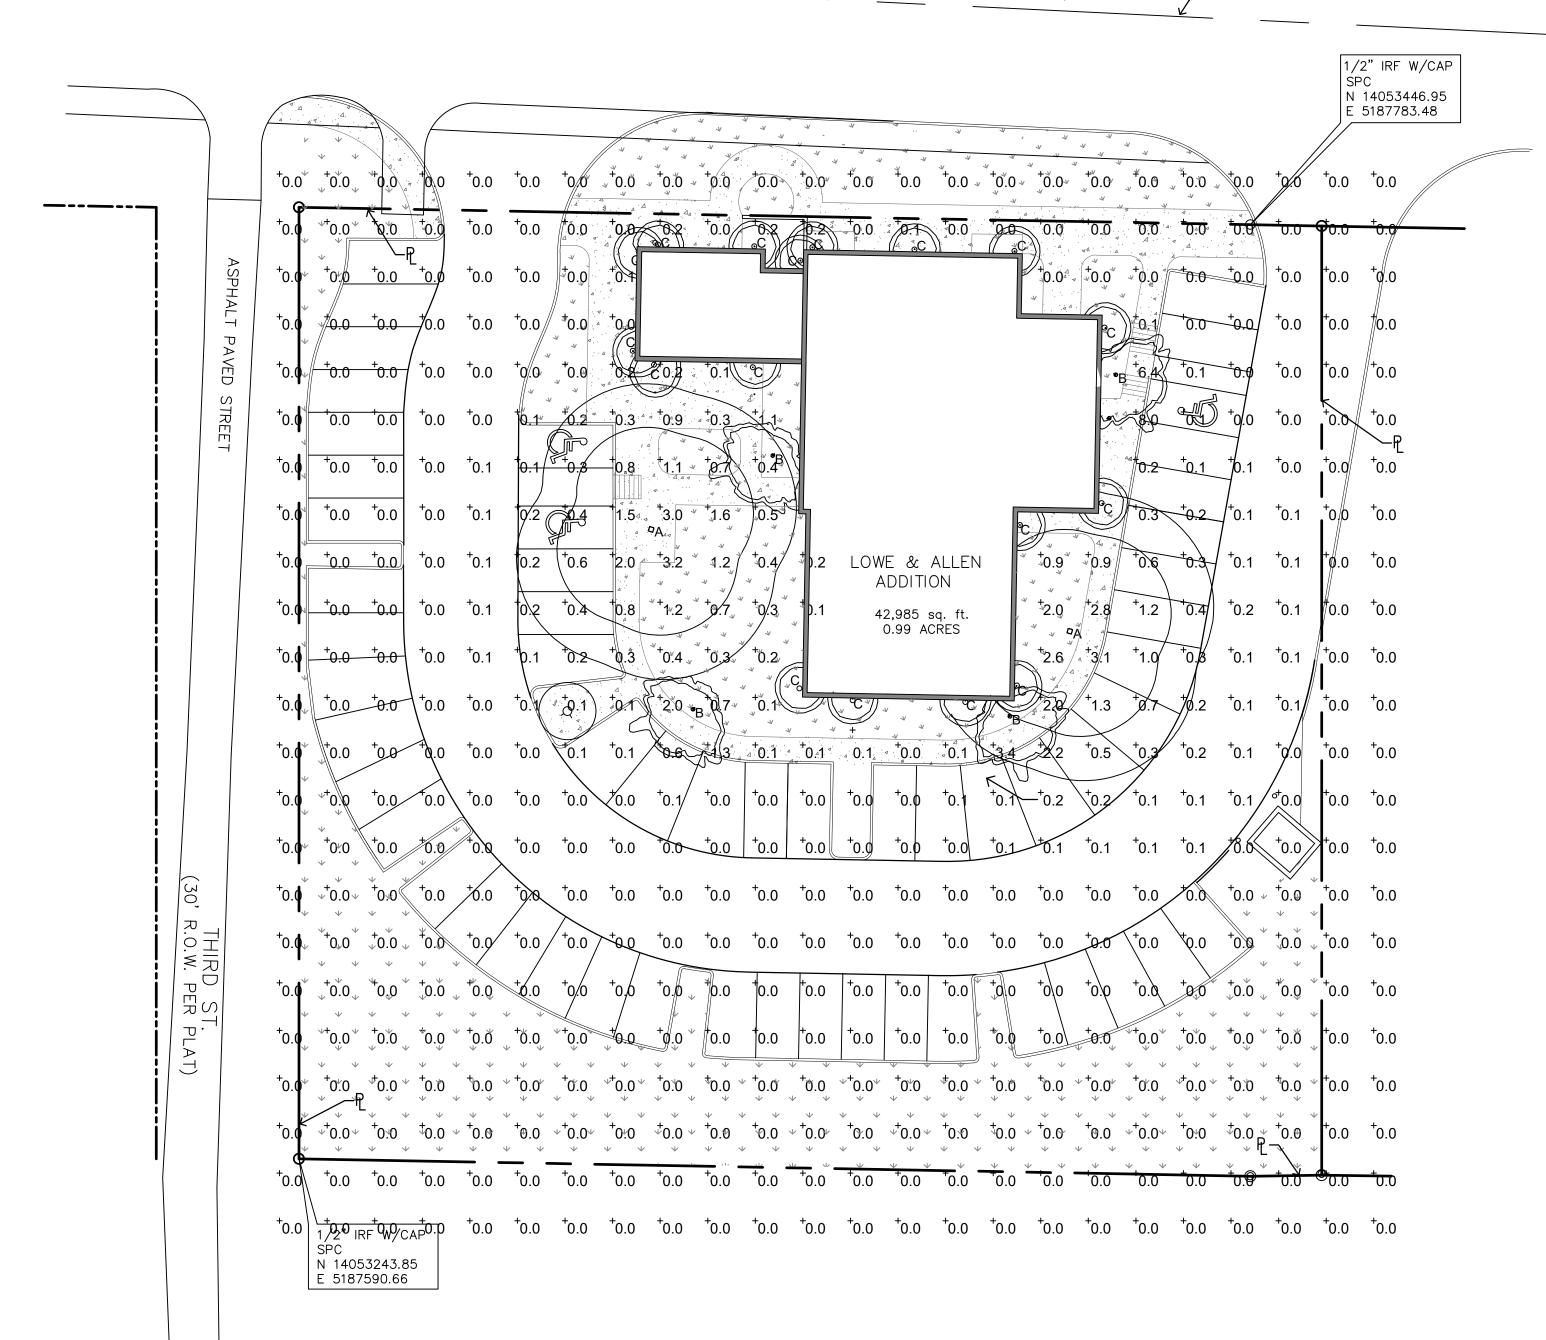


SITE SUMMARY — COMM	ERCIAL ZONING	
DESCRIPTION		LOT PERCENTAGE
LOT	42,985 S.F.	100 %
IMPERVIOUS	31,708 S.F.	73.8%
BLDG. A / 3 STORY SURFACE AREA	4,962 S.F.	11.5%
BLDG. B / 1 STORY SURFACE AREA	808 S.F.	1.9%
PAVEMENT AREA	21,049 S.F.	48.9 %
PERVIOUS	11,277 S.F.	26.2 %
SIDEWALK AREA	4,889 S.F.	11.4 %
MAX. BUILDING HEIGHT PROPOSED	40 FT 6 IN	
PARKING REQUIREMENTS		
OFFICE (1:300 S.F.)	16,502 S.F.	
PARKING PROVIDED	55	
PARKING REQ'D	55	

SCALE: 1" = 20'

OWNER/DEVELOPER: LMGC, LLC JIMMY McCLINTOCK (972)983-2222 3021 RIDGE RD. ROCKWALL, TEXAS 75087

ARCHITECT/PLANNER: RAMSAY & REYES, LLC ROSS RAMSAY (214)536-5306 2235 RIDGE RD. STE 201 ROCKWALL, TEXAS 75087

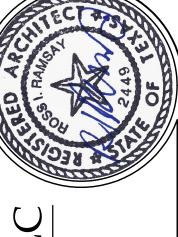

RAMSAY & REYES, LLC ARCHITECTURE - MANAGEMENT





	DATE			
REVISIONS				
	ş			

BUSIN

PROJECT No. SR DRAWN BY CHECKED BY 12/13/2019 SCALE 1" = 20'SHEET NO. of

DRAWING NAME: PHOTOMETRIC SITE PLAN

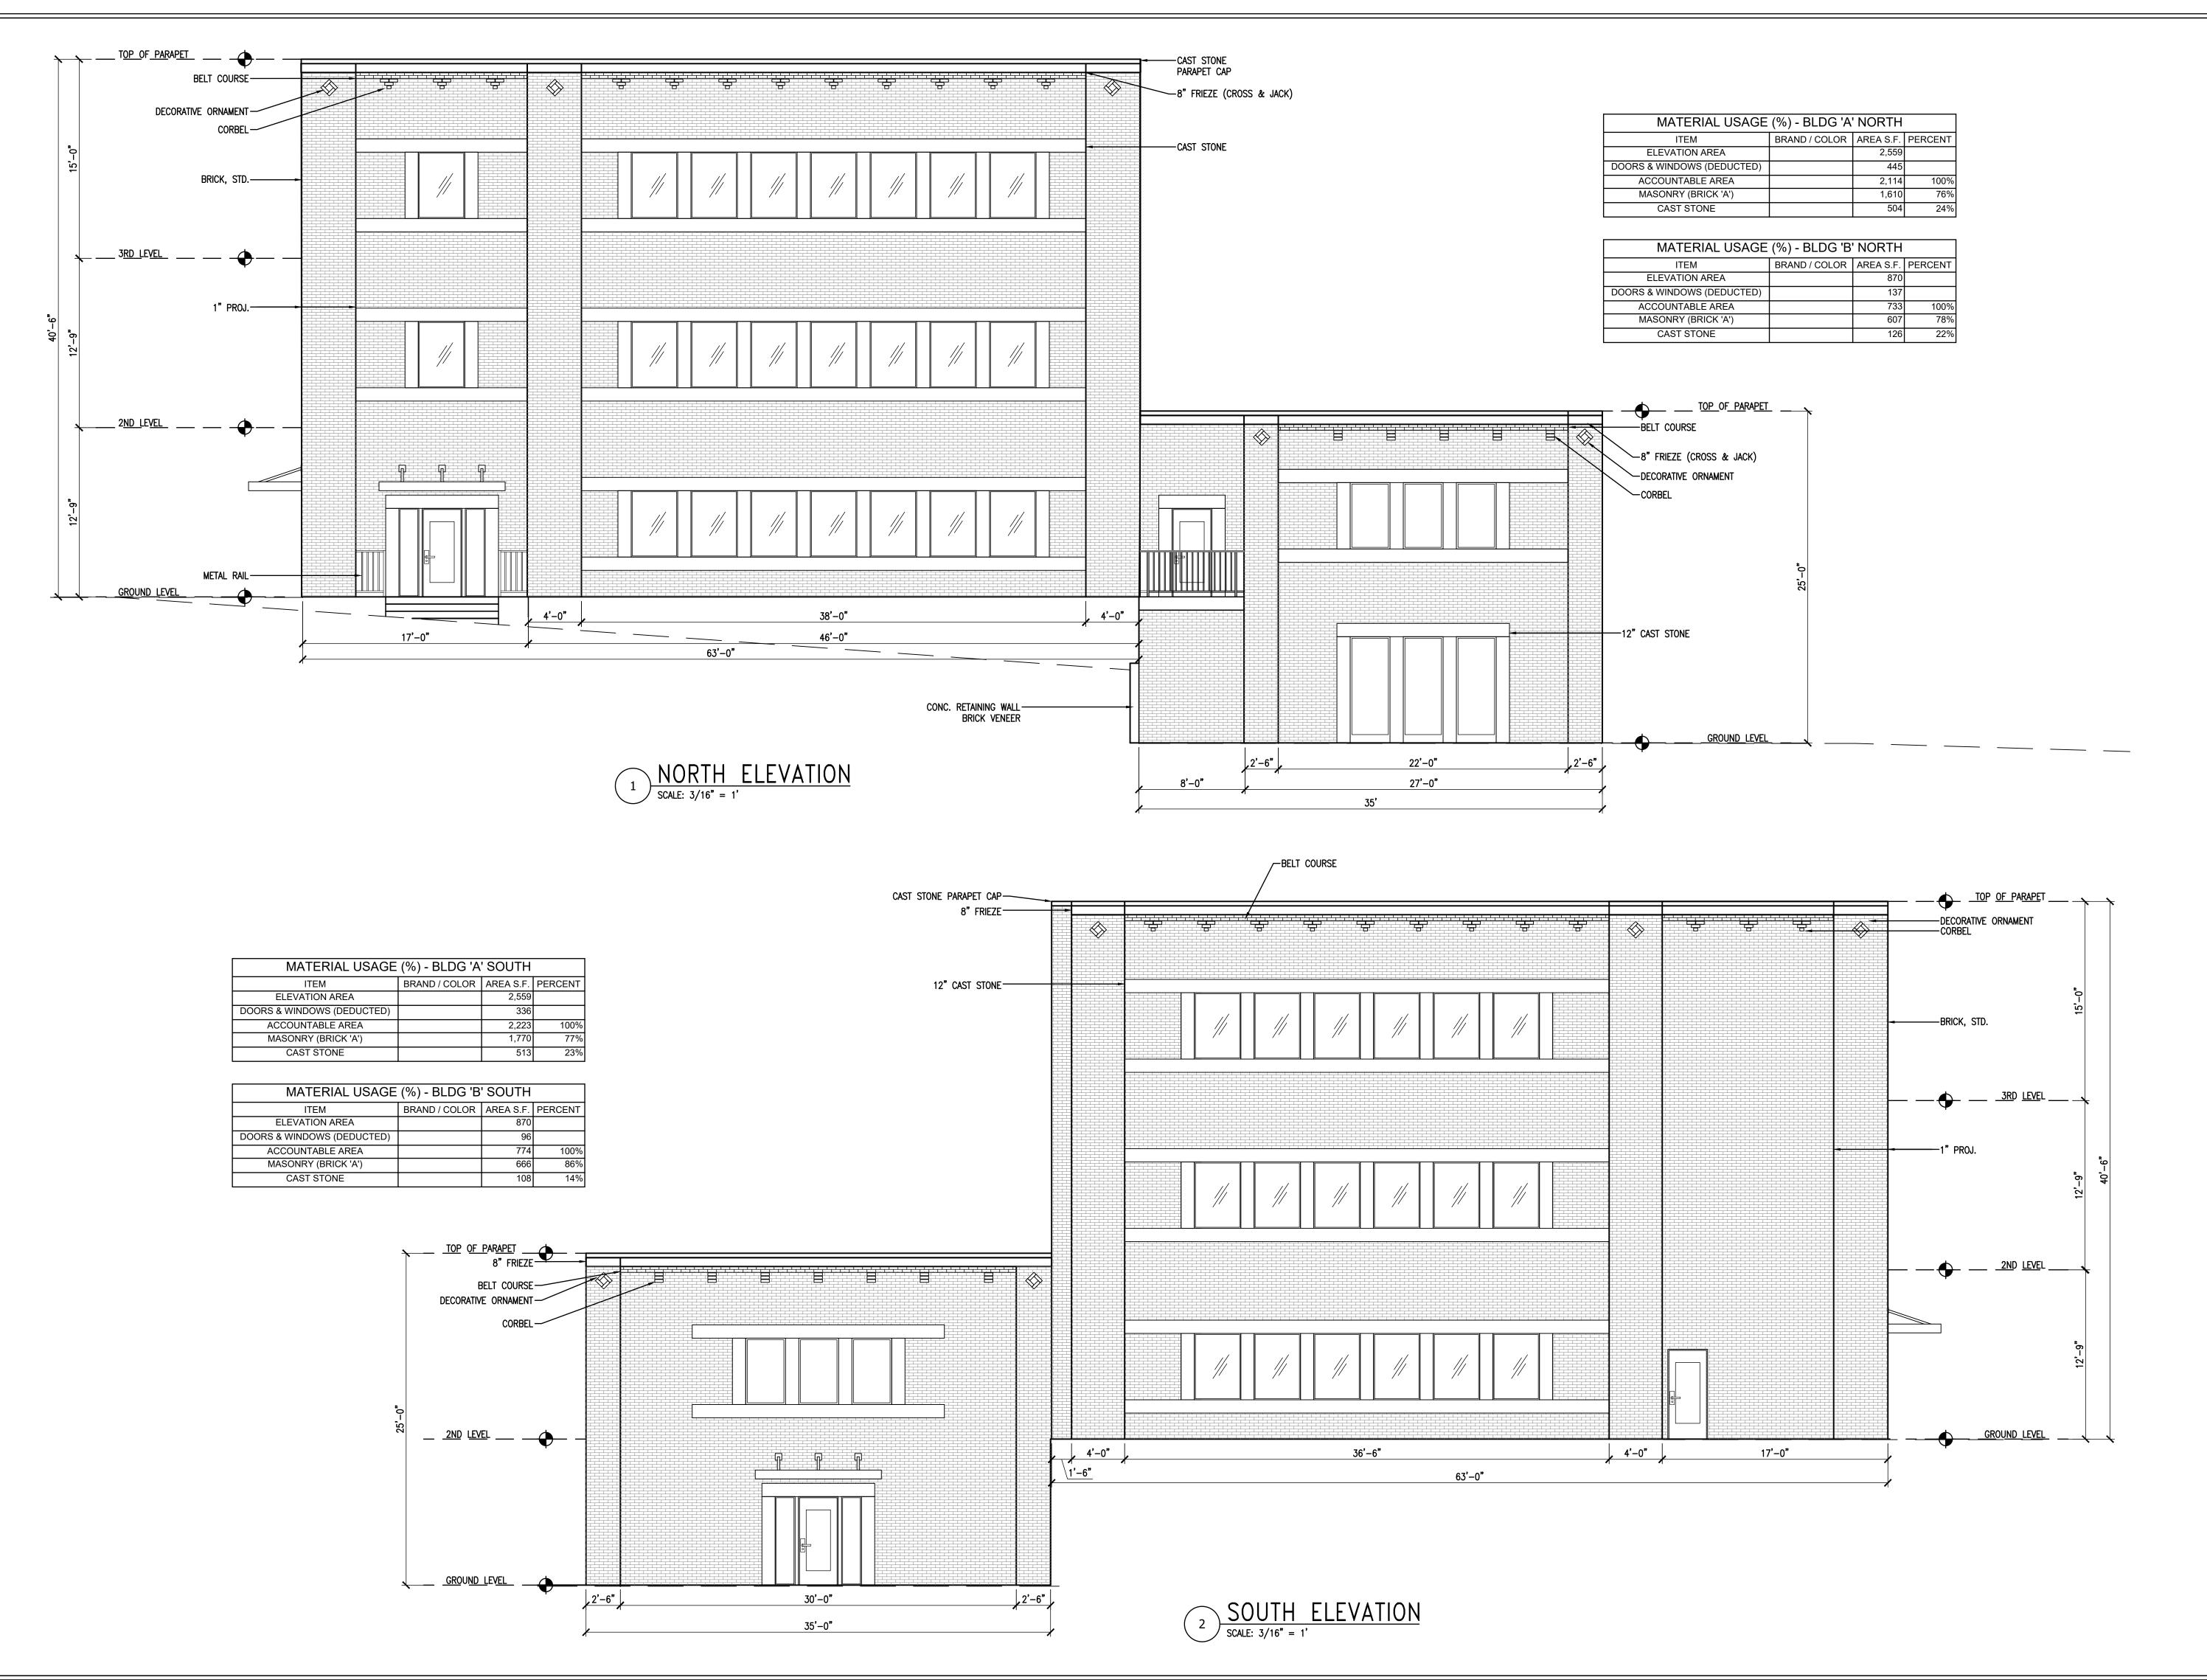

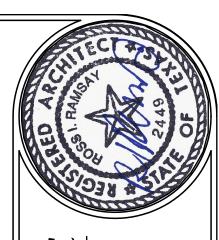

RAMSAY & REYES, LLC

ATE OF STATE OF STATE

No. DESCRIPTIONS/ISSUE DATE

BUSINESS PARK
409 W. WASHINGTON

PROJECT No. ---
DRAWN BY SR

CHECKED BY RR

DATE 12/13/2019

SCALE 3/16" = 1'


SHEET NO. ###8f ####

DRAWING NAME:


ELEVATION NORTH & SOUTH


A-20

MATERIAL USAGE	E (%) - BLDG 'A	A' EAST	
ITEM	BRAND / COLOR	AREA S.F.	PERCENT
ELEVATION AREA		3,807	
DOORS & WINDOWS (DEDUCTED)		579	
ACCOUNTABLE AREA		3,228	100%
MASONRY (BRICK 'A')		2,521	78%
CAST STONE		707	12%

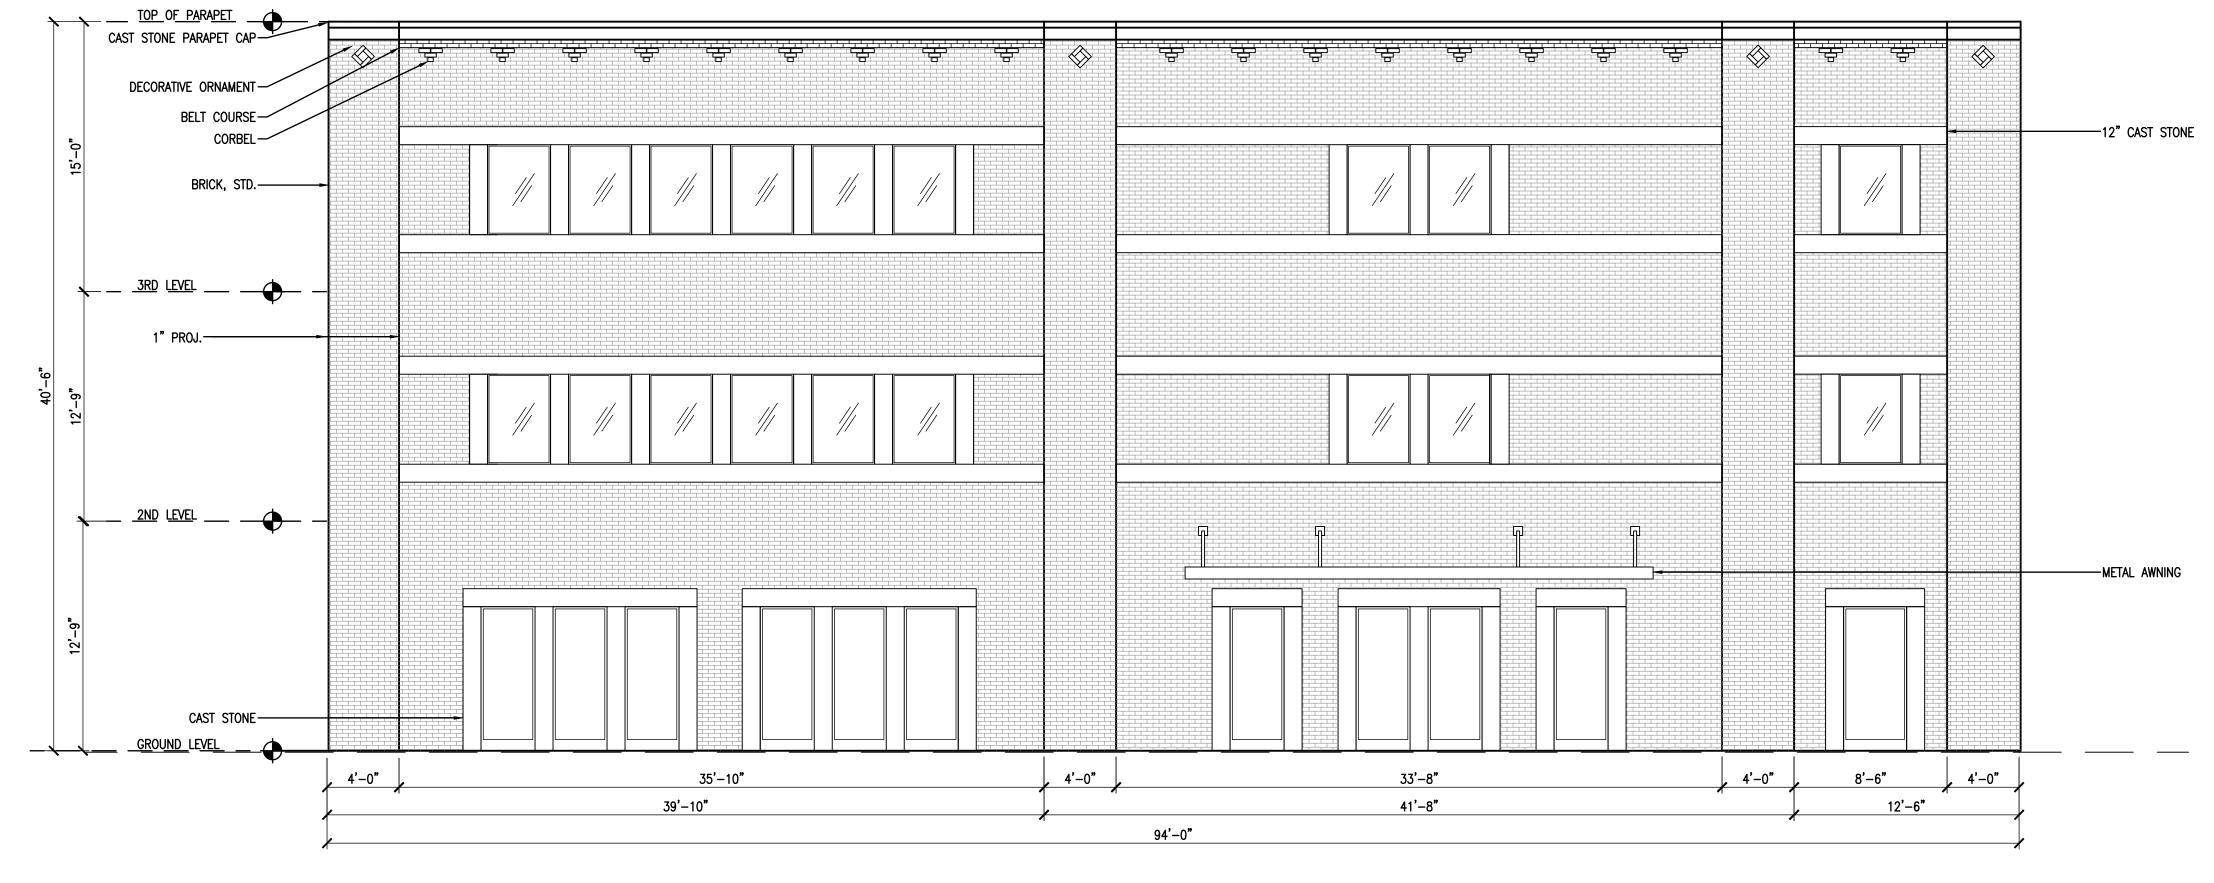


EAST ELEVATION SCALE: 3/16" = 1'

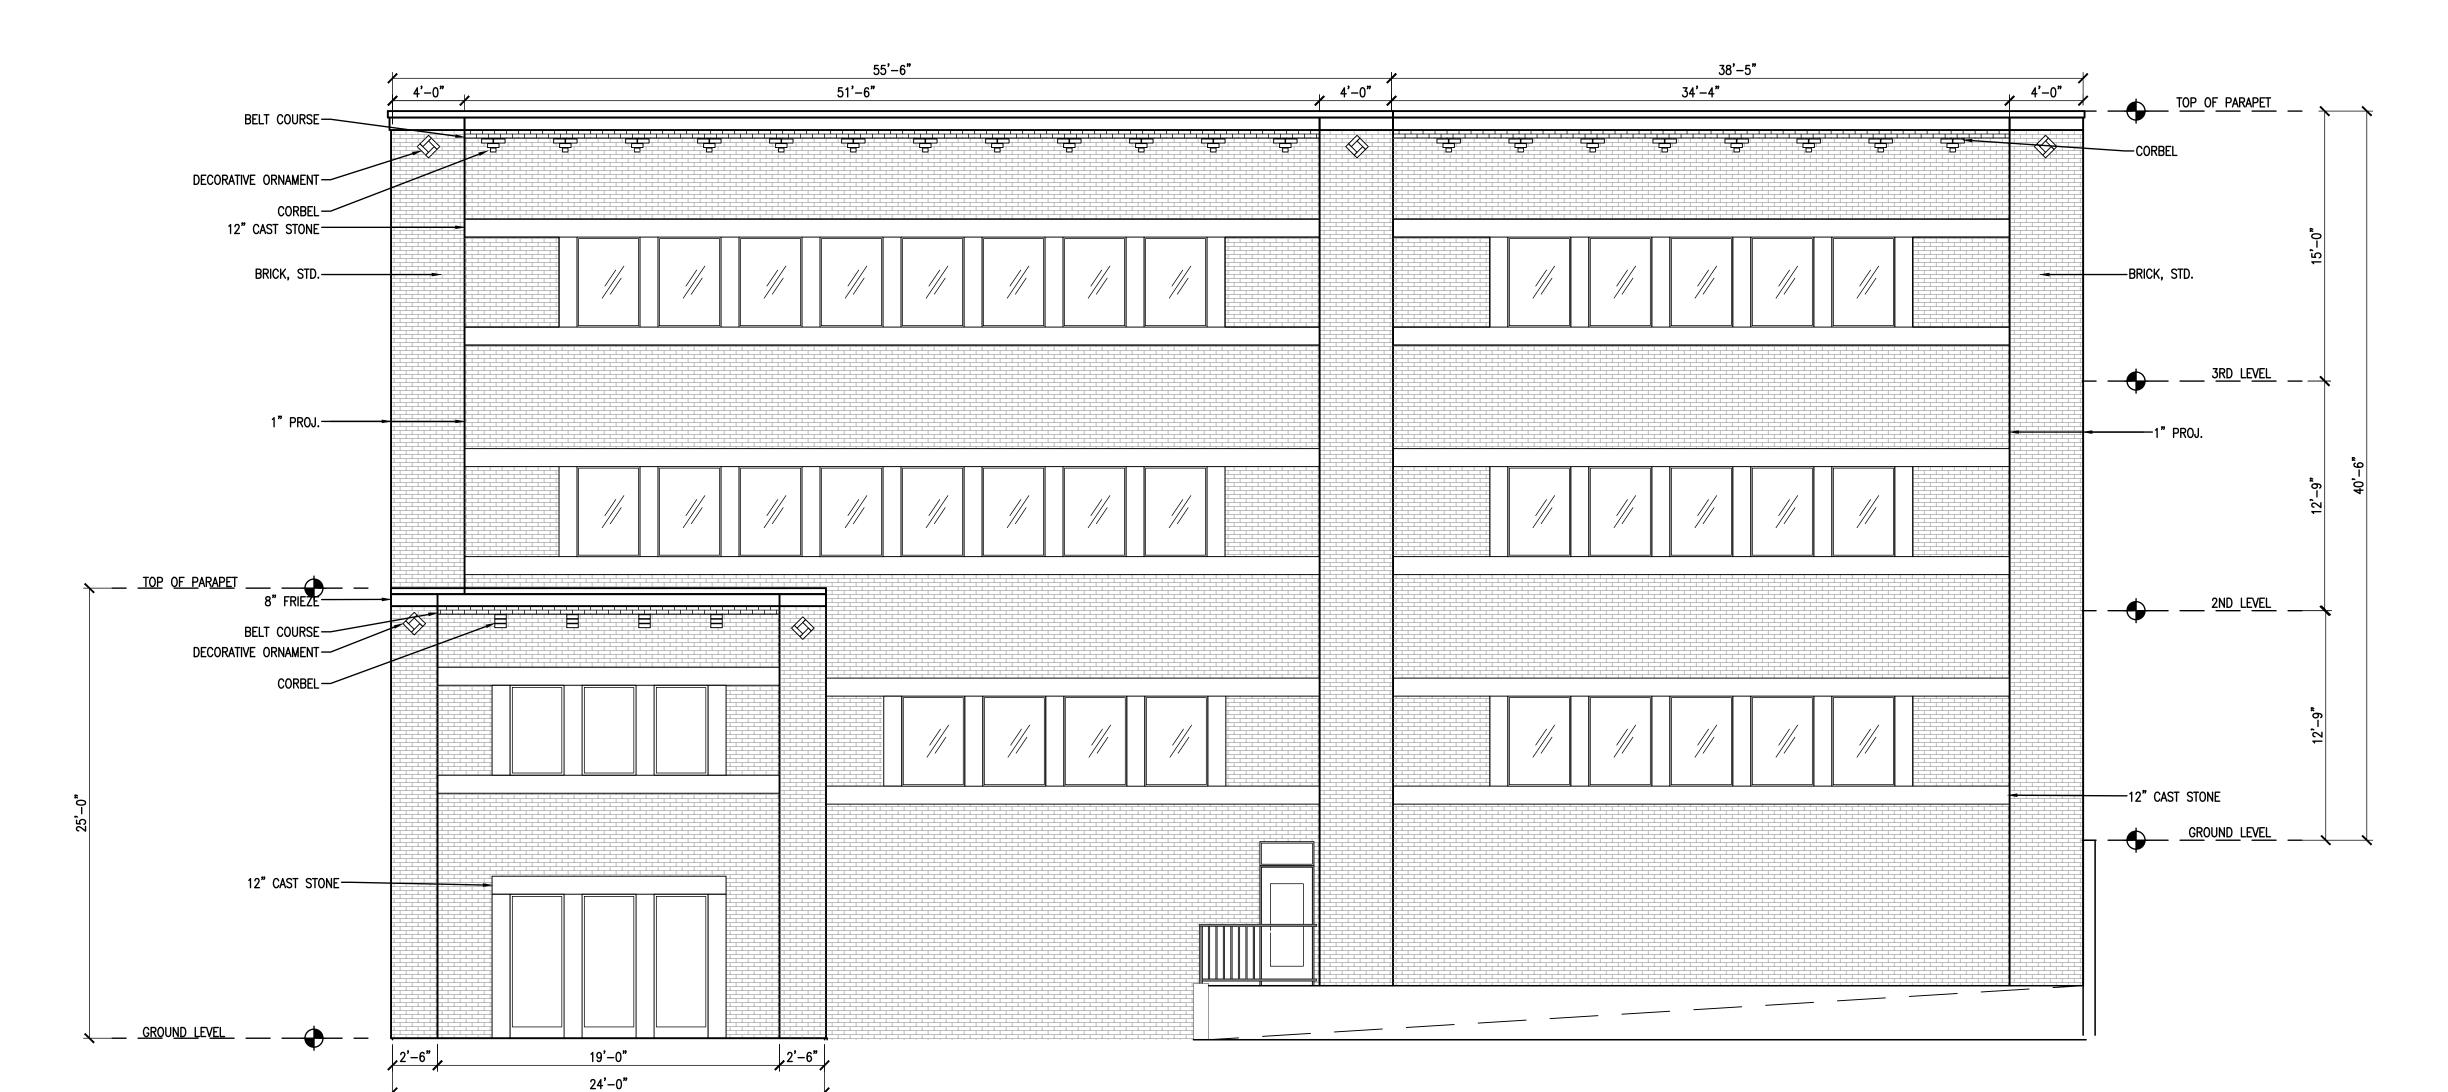

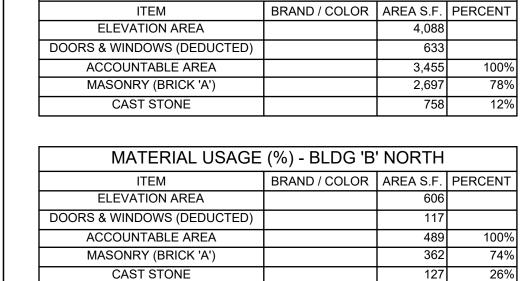

MATERIAL USAGE (%) - BLDG 'A' WEST

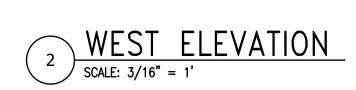



RAMSAY & REYES, LLC

BUSINE

PROJECT No. SR DRAWN BY RR CHECKED BY 12/13/2019 3/16" = 1'SCALE ###**#**f #### SHEET NO.

DRAWING NAME:

ELEVATION EAST & WEST

		DATE			
	REVISIONS	DESCRIPTIONS/ISSUE			
-d1					
		છું			

ARK

 $\bigcup_{i=1}^{n}$

PROJECT No.

CHECKED BY

DRAWN BY

SCALE

TON 7508

ING AS

409 CKW

SR

RR

12/13/2019

1" = 20'

Job Name: Type: Quantity:

H-EM-08

Emblem Shade

Collection

FINISH -Offered in exceptional finishes, comprised of: polyester/polished powder coat, baking enamal liquid, raw metal, or galvanized finishes. Standard Finishes are: 91(Black), 93(White),

95(Dark Green), 96(Galvanized), BR47(Powder Coat Rust), BK01(Black Texture), GN20(Powder Coat Patina). Upgraded Finishes are: 29, 66, 82, 90, 92, 94, 97,

99, 100, 103, 104, 105, 110, 112, 113, 114, 115, 117, 118, 119, 120, 127, 128, 129, 133, 134, 135, 136, 98, 101, 102, 137, 138, 139, 140, 121, 122, 123, 124, 125, 126, 11, 01, 22, 25, 33, 77, 89, 24, 44, 48, 49, 15, 16.

For interior finish of fixture refer to color chart on pages 344-348.

HI-LITE MFG.

13450 Monte Vista Avenue

Telephone: (909) 465-1999

CO., INC

Chino, California 91710

Toll Free: (800) 465-0211

web: www.hilitemfg.com

e-mail: sales@hilitemfg.com

Fax: (909) 465-0907

MOUNTING - Stem, Arm, and Flush mounting available.

ACCESSORIES - WGR(Wire Guard) and SK(Swivel Knuckle) available.

REFLECTOR - Heavy duty, spun shade, aluminum 6061-0 and/or 1100-0, galvanized 22 gauge, steel 20/22 gauge, copper 032/040 and brass 032/040 construction. Dependant on finish.


SOCKETS/LAMPS - Available in:

Incandescent - rated 200 watt max/120 volt, medium base. Compact Fluorescent(CFL)

- rated 13/18/26/32 watt max/120/277 volt, GX24Q base. Metal Halide(MH)

rated 35/50/70/100 watt max/120/208/240/277 volt, medium base, 4KV socket.

High Pressure Sodium(HPS) rated 50/70/100 watt max/120/277 volt, medium SHEET NO. of DRAWING NAME: OUTDOOR LIGHT SPECS.

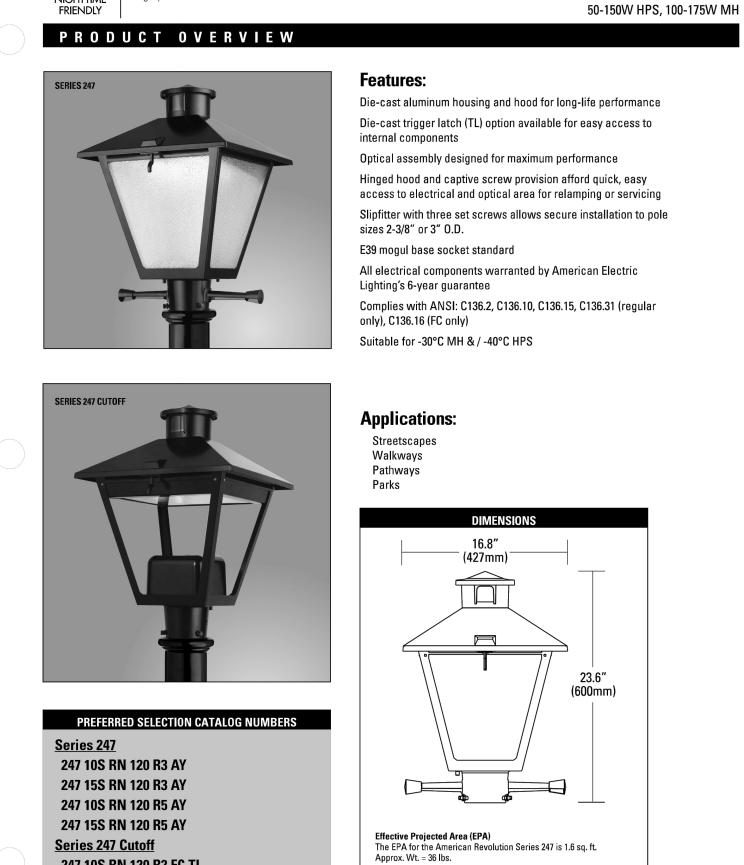

DL-247-A

sistent with LEED® goals

& Green Globes™ criteria for light pollution reduction

Series 247 Cutoff

247 10S RN 120 R2 FC TL


247 10M XN MT1 R2 FC TL

American Revolution

Series 247 and 247 Cutoff


American Electric Lighting

©2012 Acuity Brands Lighting, Inc. All Rights Reserved.

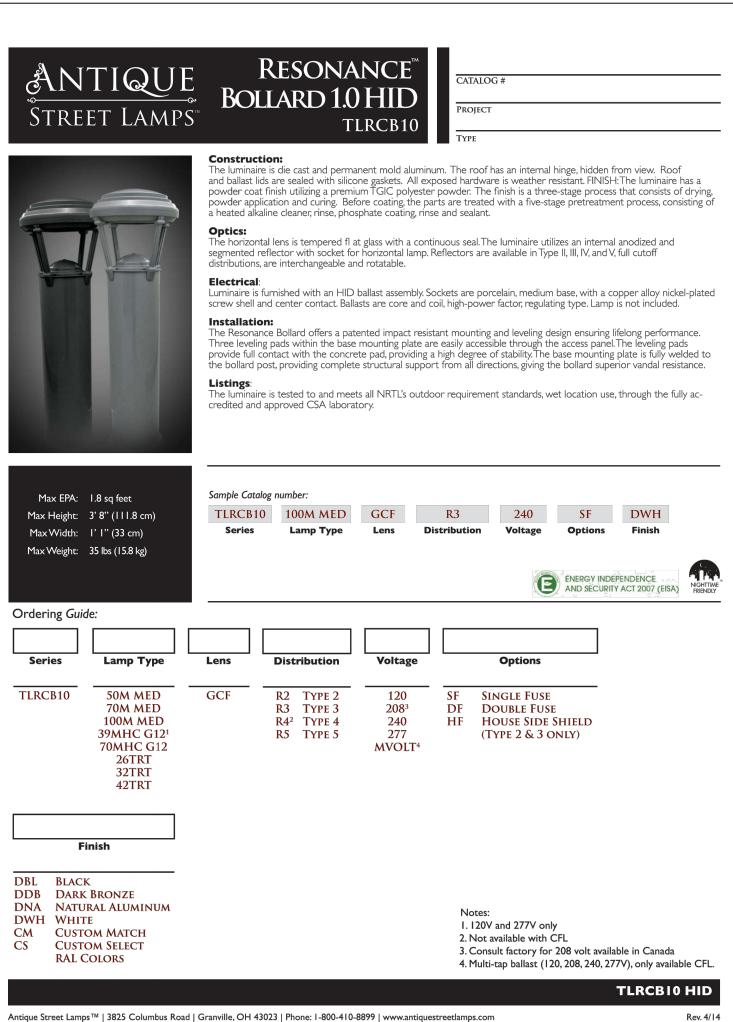

MADE IN THE U.S.A.

Suitable for wet location. (Except when cord mounted)

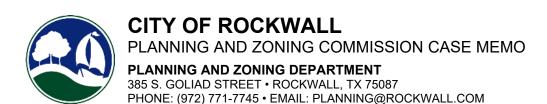

TO: Planning and Zoning Commission

DATE: January 14, 2020

APPLICANT: Steven Reyes; Ramsay and Reyes Architecture, LLC

CASE NUMBER: SP2019-044; Site Plan for 409 W. Washington Street

SUMMARY

Discuss and consider a request by Steven Reyes of Ramsay & Reyes, LLC on behalf of Jimmy McClintock of LMGC, LLC for the approval of a site plan for an office building on a 0.739-acre tract of land identified as a portion of Lot 14 of the Lowe & Allen Addition [0.4590-acres] and Lot 2-R, Block A, Washington Place Addition [0.28-acres], City of Rockwall, Rockwall County, Texas, zoned Downtown (DT) District, situated within the SH-66 Overlay (SH-66 OV) District, addressed as 409 W. Washington Street, and take any action necessary.

BACKGROUND

The subject property was annexed prior to 1959, is zoned Downtown (DT) District, is situated within the SH-66 Overlay (SH-66 OV) District, and is considered to be a part of one of the original areas of the City of Rockwall. On May 26, 2017, a building permit was issued [*BLD2017-1600*] for to allow the demolition of a single-family home on the subject property. Subsequently, in 2018, a building permit was issued [*BLD2018-0900*] to allow the demolition of a carport, a garage, and a barn on the subject property. Since that time, the property has remained vacant.

PURPOSE

The applicant has submitted a request for approval of a site plan for an office building on the subject property. The proposed office building will be approximately 16,502 SF, will be clad with brick, and will utilize a flat roof system, which is typical of the existing buildings within the Downtown (DT) District. The proposed building is designed to give the appearance of two (2) attached buildings with one (1) building being two (2) stories in height and the other building being three (3) stories in height.

ADJACENT LAND USES AND ACCESS

The subject property is located at 409 W. Washington Street. The land uses adjacent to the subject property are as follows:

North: Directly north of the property is W. Washington Street, which is identified as a P3U (principle arterial, three [3]-lane, undivided roadway) on the City's Master Thoroughfare Plan. Following this, there is a vacant tract of land and W. Rusk Street, which is identified as a P3U (principle arterial, three [3]-lane, undivided roadway) on the City's Master Thoroughfare Plan. Beyond this, there are several single-family homes. These areas are zoned Downtown (DT) and

Single-Family 7 (SF-7) District.

South: Directly south of the subject property, there is a cemetery that is owned by the City of Rockwall. Following this, there are two (2) single-family residential subdivisions (i.e. Stonebridge Meadows, Phases 4, 3, & 2; and Ridgeview Subdivisions) and a condominium complex (i.e.

Bent Tree Condominiums). These areas are zoned Cemetery (CEM), Single-Family 7 (SF-7) and Multi-Family 14 (MF-14) Districts.

East: Directly east of the subject property, there is a vacant tract of land, a real estate office (i.e. Gold Key Realty), and a daycare facility (i.e. Marigold Learning Academy). Following this, there several vacant tracts of land, a city-owed parking lot, and N. Goliad Street, which is identified as a P3U (principle arterial, three [3]-lane, undivided roadway) on the City's Master Thoroughfare Plan.

West: Directly west of the subject property, there is a single-family home and a City-owned cemetery. Following this, there is a daycare facility (i.e. Children's Park Day Care), a vacant tract of land, an office building, and a veterinary hospital (i.e. Avery Veterinary Clinic). Beyond this, there is a retail store with gasoline sales (i.e. Shell), a single-family residential subdivision (i.e. Stonebridge Meadows, Phases 4 & 5) and S. Lakeshore Drive, which is identified as a minor collector on the City's Master Thoroughfare Plan. These areas are zoned Downtown (DT), Cemetery (CEM), General Retail (GR), Single-Family 7 (SF-7), and Single-Family 10 (SF-10) Districts.

DENSITY AND DIMENSIONAL REQUIREMENTS

According to Section 1, *Land Use Schedule*, of Article IV, *Permissible Uses*, of the Unified Development Code (UDC) the proposed office building is permitted by-right in the Downtown (DT) District. With the exception of the minor waivers being requested, the submitted site plan, landscape plan, treescape plan, photometric plan, and building elevations generally conform to the technical requirements contained within the UDC for a property located within the Downtown (DT) District. A summary of the density and dimensional requirements for the subject property are as follows:

Ordinance Provisions	Zoning District Standards	Conformance to the Standards
Building Height	Min. 2 Stories Max. 4 Stories	X=2 Stories and 3 Stories; In Conformance
Minimum Front Yard Setback	24-Feet	X=24-Feet; In Conformance
Pedestrian Walkway Width	10-Feet	X=10-Feet; In Conformance
Minimum Masonry Requirement	100%	X=100%; In Conformance
Minimum Number of Parking Spaces	55 Spaces	X=55 Spaces; In Conformance

TREESCAPE PLAN

The applicant has indicated that there are no protected trees requiring mitigation on the subject property.

CONFORMANCE WITH THE CITY'S CODES

The proposed office building conforms to the requirements stipulated in Subsection 4.07, *Downtown (DT) District*, of Section 4, *Commercial Districts*, of Article V, *District Development Standards*, of the Unified Development Code (UDC) as follows:

- (1) <u>Function/Land Use.</u> Retail, personal service, residential, and office uses shall be allowed throughout the district. In this case, the proposed use is an office building and conforms to this requirement.
- (2) <u>Block Face.</u> Building walls should be continuous along block faces to create a strong edge to the street an contribute to creating and attractive and active pedestrian environment. In this case, the building utilizes a design that gives the appearance of two (2) buildings with a continuous block face. The building will also utilize contrasting brick patterns/colors to give the appearance of two (2) attached buildings.

- (3) <u>Building Form.</u> Buildings shall be designed and constructed in a tri-partite architecture to that they have a distinct base, middle, and top. The proposed building elevations appear to conform to this requirement.
- (4) <u>External Façade Materials.</u> Ground floor exterior walls, excluding windows and doors, shall be constructed of 100% brick, natural or cast stone. The applicant is proposing to utilize 100% brick.
- (5) <u>Color.</u> The dominant color of all buildings shall be muted shades of warm grey, red, green, beige, or brown. Black, gold, and stark white shall not be used except as an accent color. The submitted building elevations indicate that the brick will be brown.
- (6) <u>Non-residential at Grade.</u> The ground floor entry must be located at the approximate elevation of the adjacent sidewalk. All of the proposed entryways conform to this requirement.

VARIANCES/EXCEPTIONS REQUESTED BY THE APPLICANT

Based on the information submitted by the applicant, staff has identified the following exception to the requirements of the Unified Development Code (UDC):

(1) Building Standards

(a) Architectural Features. According to Subsection 4.07, Downtown (DT) District, of Section 4, Commercial Districts, of Article V, District Development Standards, of the Unified Development Code (UDC), each building and separate lease space at grade along the street edge shall have a functioning primary entry from the sidewalk. Such entries must be inset from the front building plane by at least five (5)-feet. Secondary entries may be set back as little as three (3)-feet. Functioning entries must be located no greater than 30-feet apart. The applicant is providing two (2) primary entries adjacent to W. Washington street; however, the entryways are not recessed five (5) feet behind the building plane. Alternatively, the applicant has provided a stoop with a canopy at the entryway located closest to the eastern property line and a canopy at the entryway closest to the western properly line. Additionally, the distance between the two (2) entries is greater than 30-feet (i.e. approximately 60-feet). Since this does not meet the requirements stipulated in the Unified Development Code (UDC), approval of a minor waiver is required. The Unified Development Code gives staff the ability to approve minor waivers administratively; however, staff felt it necessary to allow the Architectural Review Board (ARB) and the Planning and Zoning Commission to review the request and determine if approval of a minor waiver is necessitated.

CONFORMANCE WITH OURHOMETOWN VISION 2040 COMPREHENSIVE PLAN

The Future Land Use Plan adopted with the OurHometown Vision 2040 Comprehensive Plan, indicates that the subject property is located within the Downtown District and is designated for *Downtown (DT)* land uses. The Downtown District is considered to be the cultural heart of the community and embodies the small-town atmosphere that is characteristic of the City of Rockwall. Being the original town area, this district is significantly developed and contains the City's oldest residential and commercial buildings. It is expected that the Downtown District will continue to prosper through investments in appropriate infill development and adaptive reuse of existing structures. New development in this area should be held to a higher level of scrutiny than other areas of the City to ensure that the district retains its small-town character. The Downtown (DT) land use designation should include a combination of land uses that are complementary to the existing development pattern and are intended to add the attractive, pedestrianoriented environment of Rockwall's historic downtown. In addition, this area is the historic core of the City and should continue to be a symbol of community life in Rockwall. Primary land uses include office, retail restaurant, and residential land uses while secondary land uses include institutional and civic land uses. In this case, the proposed office building is considered to be a primary use within the Downtown District and appears to be in conformance with the policies and goals contained in the Comprehensive Plan.

ARCHITECTURAL REVIEW BOARD (ARB):

On November 26, 2019, the Architectural Review Board (ARB) reviewed the proposed building elevations and requested that the applicant provide additional windows for balance, to provide primary entryways adjacent to W. Washington Street, to increase the smaller building to two (2) stories, to raise the parapet on the rear of the building, and to provide an updated rendering. The applicant has provided revised plans that appear to generally conform to these requests.

On December 30, the Architectural Review Board (ARB) was unable to make a quorum, and as a result, the proposed building elevations have not been reviewed. The Architectural Review Board (ARB) will review the proposed building elevations and forward a recommendation to the Planning and Zoning Commission at the meeting on January 14, 2020.

CONDITIONS OF APPROVAL

If the Planning and Zoning Commission choose to approve the applicant's request to, then staff would propose the following conditions of approval:

- (1) All comments provided by the Planning, Engineering, and Fire Department must be addressed prior to the submittal of a building permit;
- (2) Any construction resulting from the approval of this site plan shall conform to the requirements set forth by the Unified Development Code (UDC), the International Building Code (IBC), the Rockwall Municipal Code of Ordinances, city adopted engineering and fire codes and with all other applicable regulatory requirements administered and/or enforced by the state and federal government.






City of Rockwall

Planning & Zoning Department 385 S. Goliad Street Rockwall, Texas 75032 (P): (972) 771-7745 (W): www.rockwall.com The City of Rockwall GIS maps are continually under development and therefore subject to change without notice. While we endeavor to provide timely and accurate information, we make no guarantees. The City of Rockwall makes no warranty, express or implied, including warranties of merchantability and fitness for a particular purpose. Use of the information is the sole responsibility of the user.



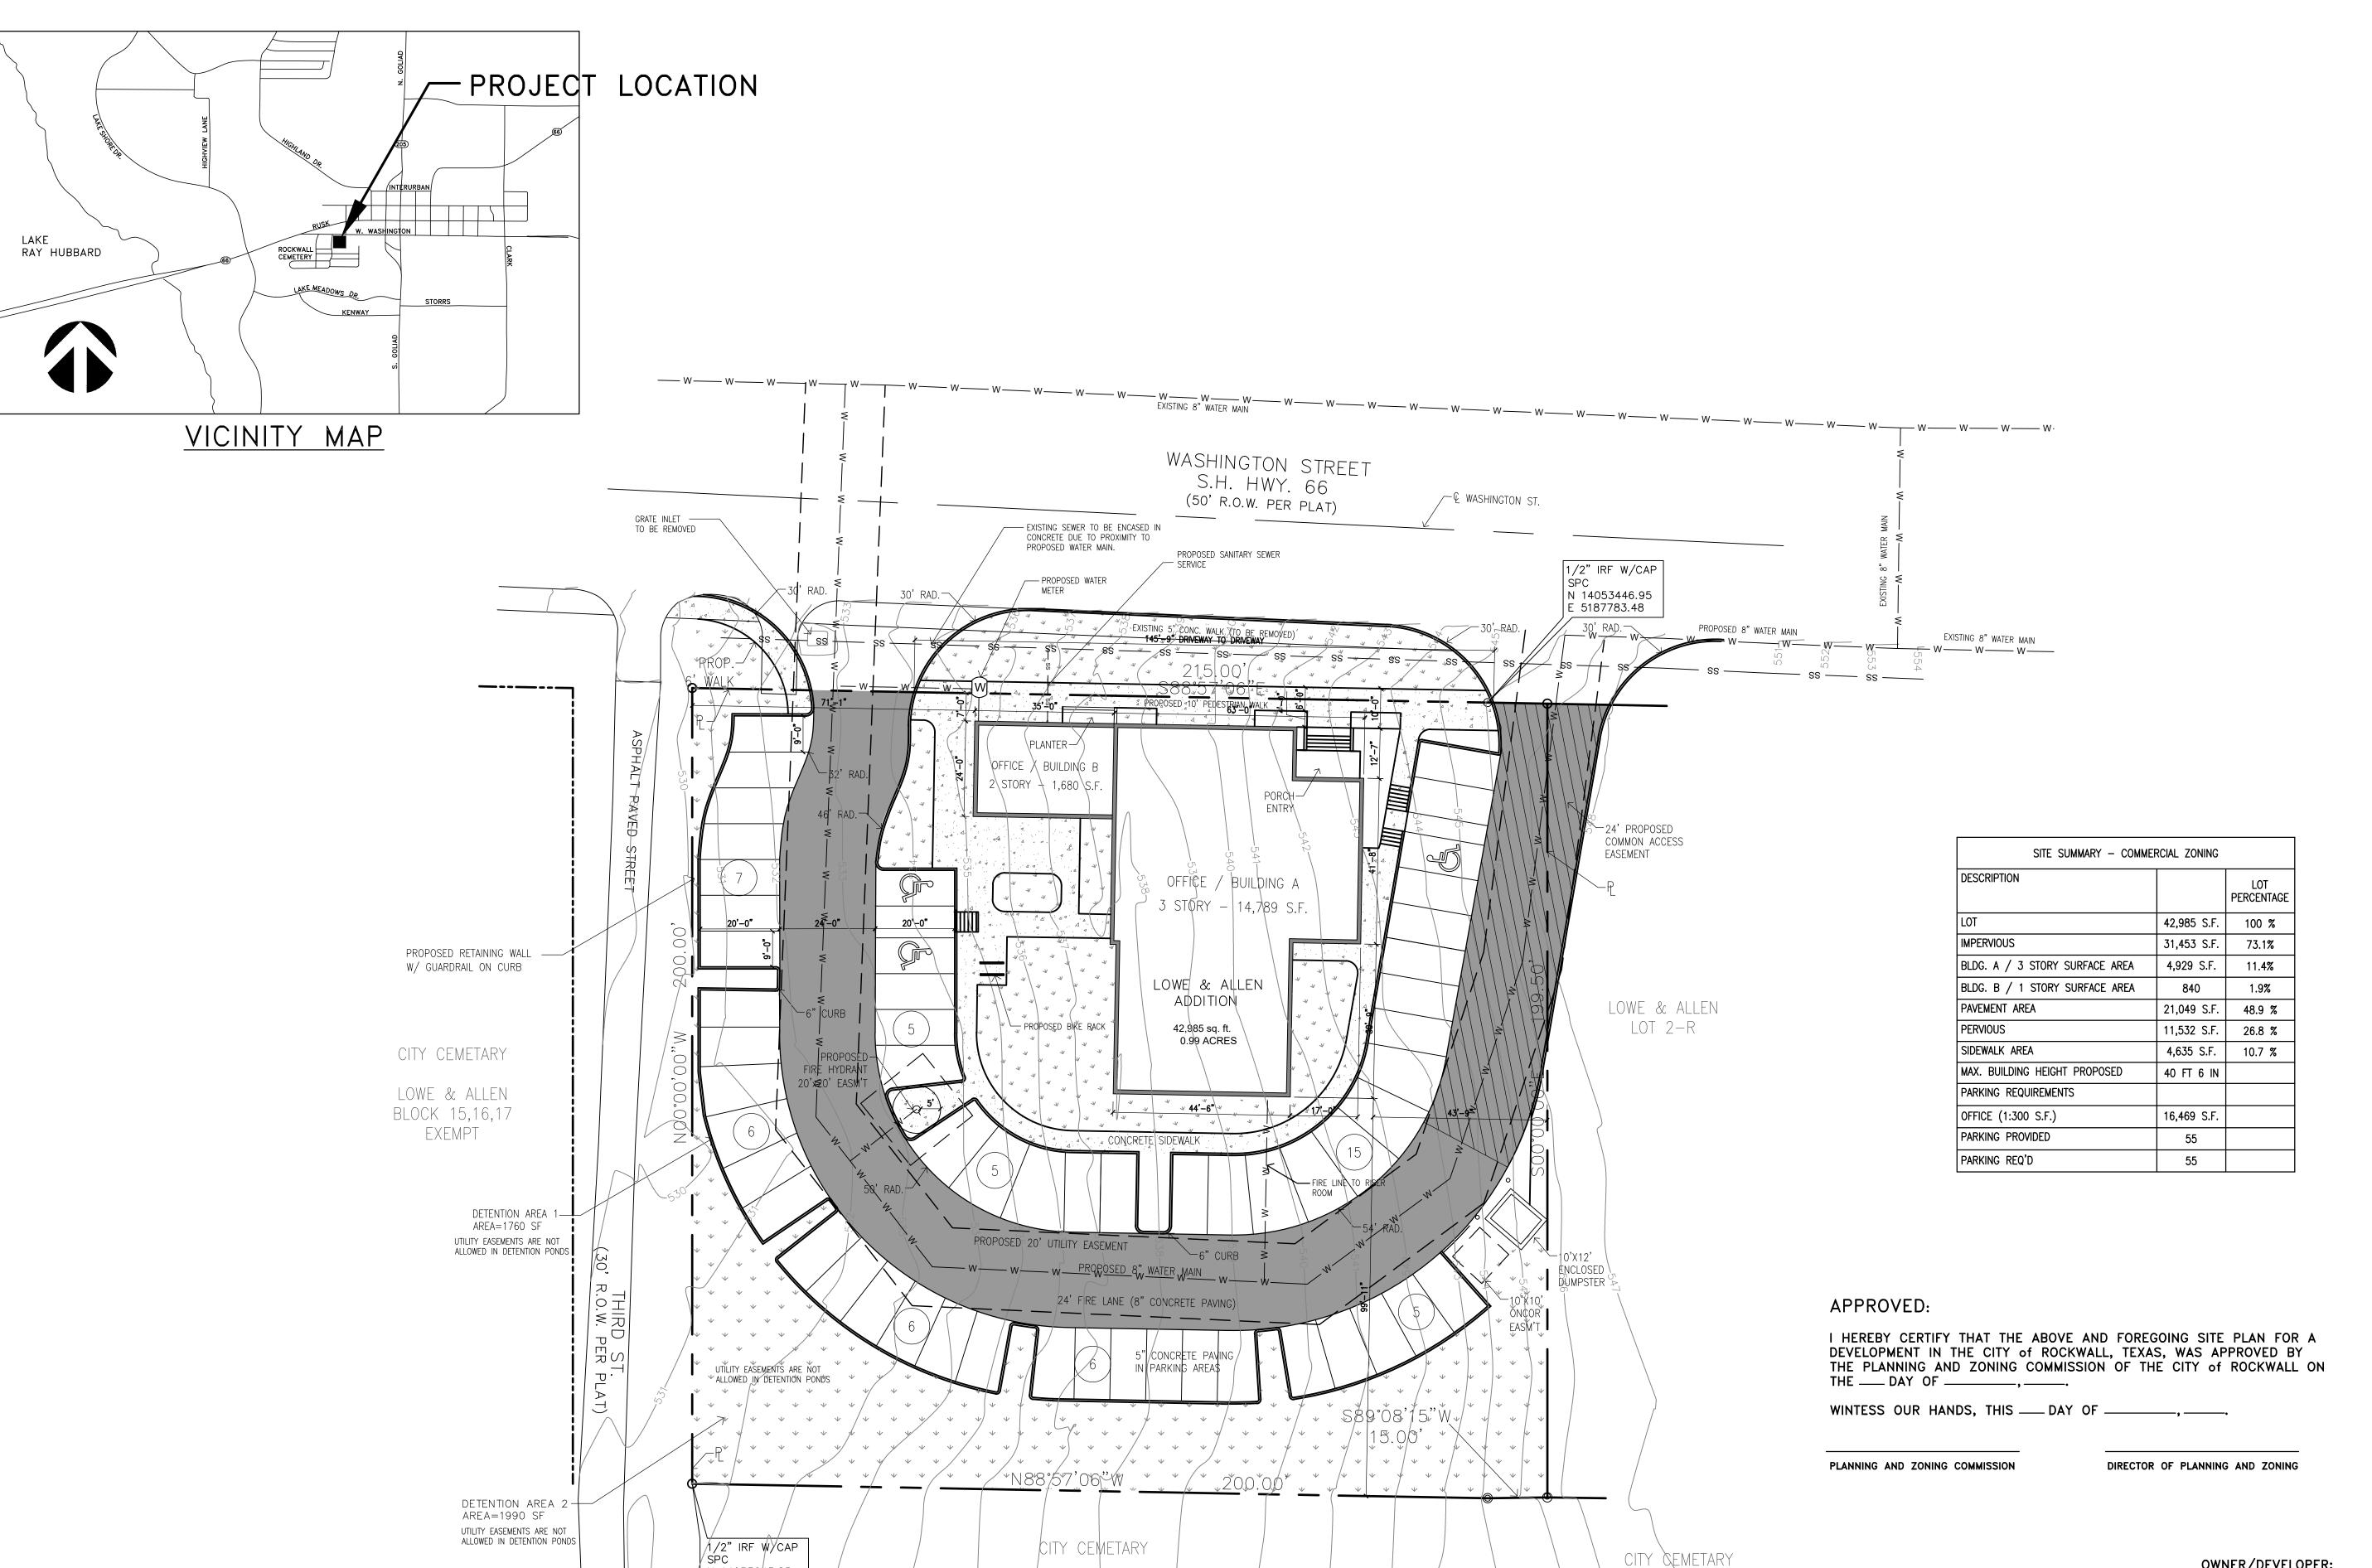


CLOWE & ALLEN

BLOCK 15,16,17

EXEMPT

N 14053243.85

E 5187590.66

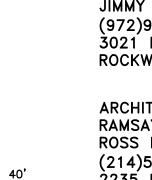

LOWE & ALLEN

BLOCK &

S EXEMPT S

OWNER/DEVELOPER: LMGC, LLC JIMMY McCLINTOCK (972)983-2222 3021 RIDGE RD. ROCKWALL, TEXAS 75087

RAMSAY & REYES, LLC ROSS RAMSAY 2235 RIDGE RD. STE 201 ROCKWALL, TEXAS 75087

ARCHITECT/PLANNER: (214)536-5306



RAMSAY & REYES, LL ARCHITECTURE - MANAGEMENT

SP2019-044

PLAN

WASHINGTON TEXAS 7508

SR

01/07/2020

1" = 20'

of

ARK

 $\bigcap_{i=1}^{n}$

PROJECT No.

DRAWN BY CHECKED BY

SCALE

SHEET NO.

DRAWING NAME:

The same of the sa	Qm	Quercus macrocarpa / Burr Oak 6" cal.	B & B	2
The same	Qv	Quercus virginiana / Southern Live Oak 6" cal.	B & B	2
	Ss	Sophora secundiflora / Texas Mountain Laurel 2" cal.	20" Box	3
	UI	Ulmus parvifolia / Chinese Lacebark Elm 3" cal.	B & B	4
AADO	Vc	Vitex agnus-castus / Chaste Tree 3" cal.	B & B	10 -
SHRUBS	CODE	BOTANICAL / COMMON NAME	SIZE	QTY

Hesperaloe parviflora / Red Yucca

(+)	Lm	Lantana montevidensis `New Gold` / Gold Lantana	3 gal	3
	Lg	Leucophyllum frutescens `Green Cloud` TM / Texas Ranger	5 gal	12
	Ls	Ligustrum sinense `Sunshine` / Sunshine Ligustrum	5 gal	30
	Lp	Loropetalum chinense `Purple Diamond` / Fringe Flower	3 gal	21
	Msc	Mahonia `Soft Caress` / Soft Caress Mahonia	3 gal	7

•		_	
Msc	Mahonia `Soft Caress` / Soft Caress Mahonia	3 gal	7
Ма	Miscanthus sinensis `Adagio` / Dwarf Maiden Grass	3 gal	6
Ptv	Pittosporum tobira `Variegata` / Variegated Mock Orange	5 gal	15
Ptw	Pittosporum tobira `Wheeler`s Dwarf` / Dwarf Pittosporum	3 gal	5
Rop	Rosmarinus officinalis `Prostratus` / Trailing Rosemary	3 gal	7
Sg	Salvia greggii `Pink` / Pink Autumn Sage	3 gal	6
	Ma Ptv Ptw Rop	Ma Miscanthus sinensis `Adagio` / Dwarf Maiden Grass Ptv Pittosporum tobira `Variegata` / Variegated Mock Orange Ptw Pittosporum tobira `Wheeler`s Dwarf` / Dwarf Pittosporum Rop Rosmarinus officinalis `Prostratus` / Trailing Rosemary	Ma Miscanthus sinensis `Adagio` / Dwarf Maiden Grass 3 gal Ptv Pittosporum tobira `Variegata` / Variegated Mock Orange 5 gal Ptw Pittosporum tobira `Wheeler`s Dwarf` / Dwarf Pittosporum 3 gal Rop Rosmarinus officinalis `Prostratus` / Trailing Rosemary 3 gal

Agave ovatifolia `Frosty Blue` / Whale`s Tongue Agave

Cynodon dactylon `419 Hybrid` / Bermuda Grass

Yucca pendula / Soft Leaf Yucca

CODE BOTANICAL / COMMON NAME

GROUND COVERS CODE BOTANICAL / COMMON NAME

REQUIRED PLANTINGS

16"

15"

12"

12"

127"

QTY

QTY

2,245 sf

A. STREET TREES: 1 TREE FOR EVERY 50 L.F. OF FRONTAGE W Washington Street - 215 / 50 = 4.3

GRATE INLET TO BE REMOVED

THE IRRIGATION SYSTEM FOR THIS PROJECT IS TO CONSIST OF A 12 STATION SMART CONTROLLER WITH WI-FI CAPABILITIES AND A WIRELESS RAIN / FREEZE SENSOR. SHRUBS WILL BE IRRIGATED WITH IN-LINE DRIP TUBE FED FROM 1" DRIP ZONE VALVE ASSEMBLIES. LAWN AREAS TO BE IRRIGATED WITH LOW FLOW ROTARY NOZZLES ON 4" POP-UP BODIES. POINT OF CONNECTION, BACKFLOW, WYE STRAINER AND SHUT OFF VALVE TO BE INSTALLED PER CITY OF HOUSTON STANDARD IRRIGATION REQUIREMENTS.

TREE REGIONATION KEY	
TREE DESIGNATION KEY	

4 TREES REQUIRED

(6) 3" TREES PROVIDED

EXISTING SEWER TO BE ENCASED IN CONCRETE DUE TO PROXIMITY TO PROPOSED WATER MAIN.

PROPOSED WATER

(1) 6" TREE PROVIDED


SYMBOL	DESCRIPTION	MITIGATION RATIO
Р	PROTECTED TREE	(1:1)
SP	SECONDARY PROTECTED TREE	(1:.5)
F	FEATURE TREE	(1:2)
D	DISEASED TREE PER ARBORIST	(1:0)


TREES TO BE 5' FROM UTILITY LINES MINIMUM.

SITE SUMMARY					
DESCRIPTION		LOT PERCENTAG			
LOT	42,985 S.F.	100 %			
IMPERVIOUS	31,708 S.F.	73.8%			
BLDG. A / 3 STORY SURFACE AREA	4,962 S.F.	11.5%			
BLDG. B / 1 STORY SURFACE AREA	808 S.F.	1.9%			
PAVEMENT AREA	21,049 S.F.	48.9 %			
PERVIOUS	11,277 S.F.	26.2 %			
SIDEWALK AREA	4,889 S.F.	11.4 %			
MAX. BUILDING HEIGHT PROPOSED	40 FT 6 IN				
PARKING REQUIREMENTS					
OFFICE (1:300 S.F.)	16,502 S.F.				
PARKING PROVIDED	55				


409 W WASHINGTON

LANDSCAPE PLANS

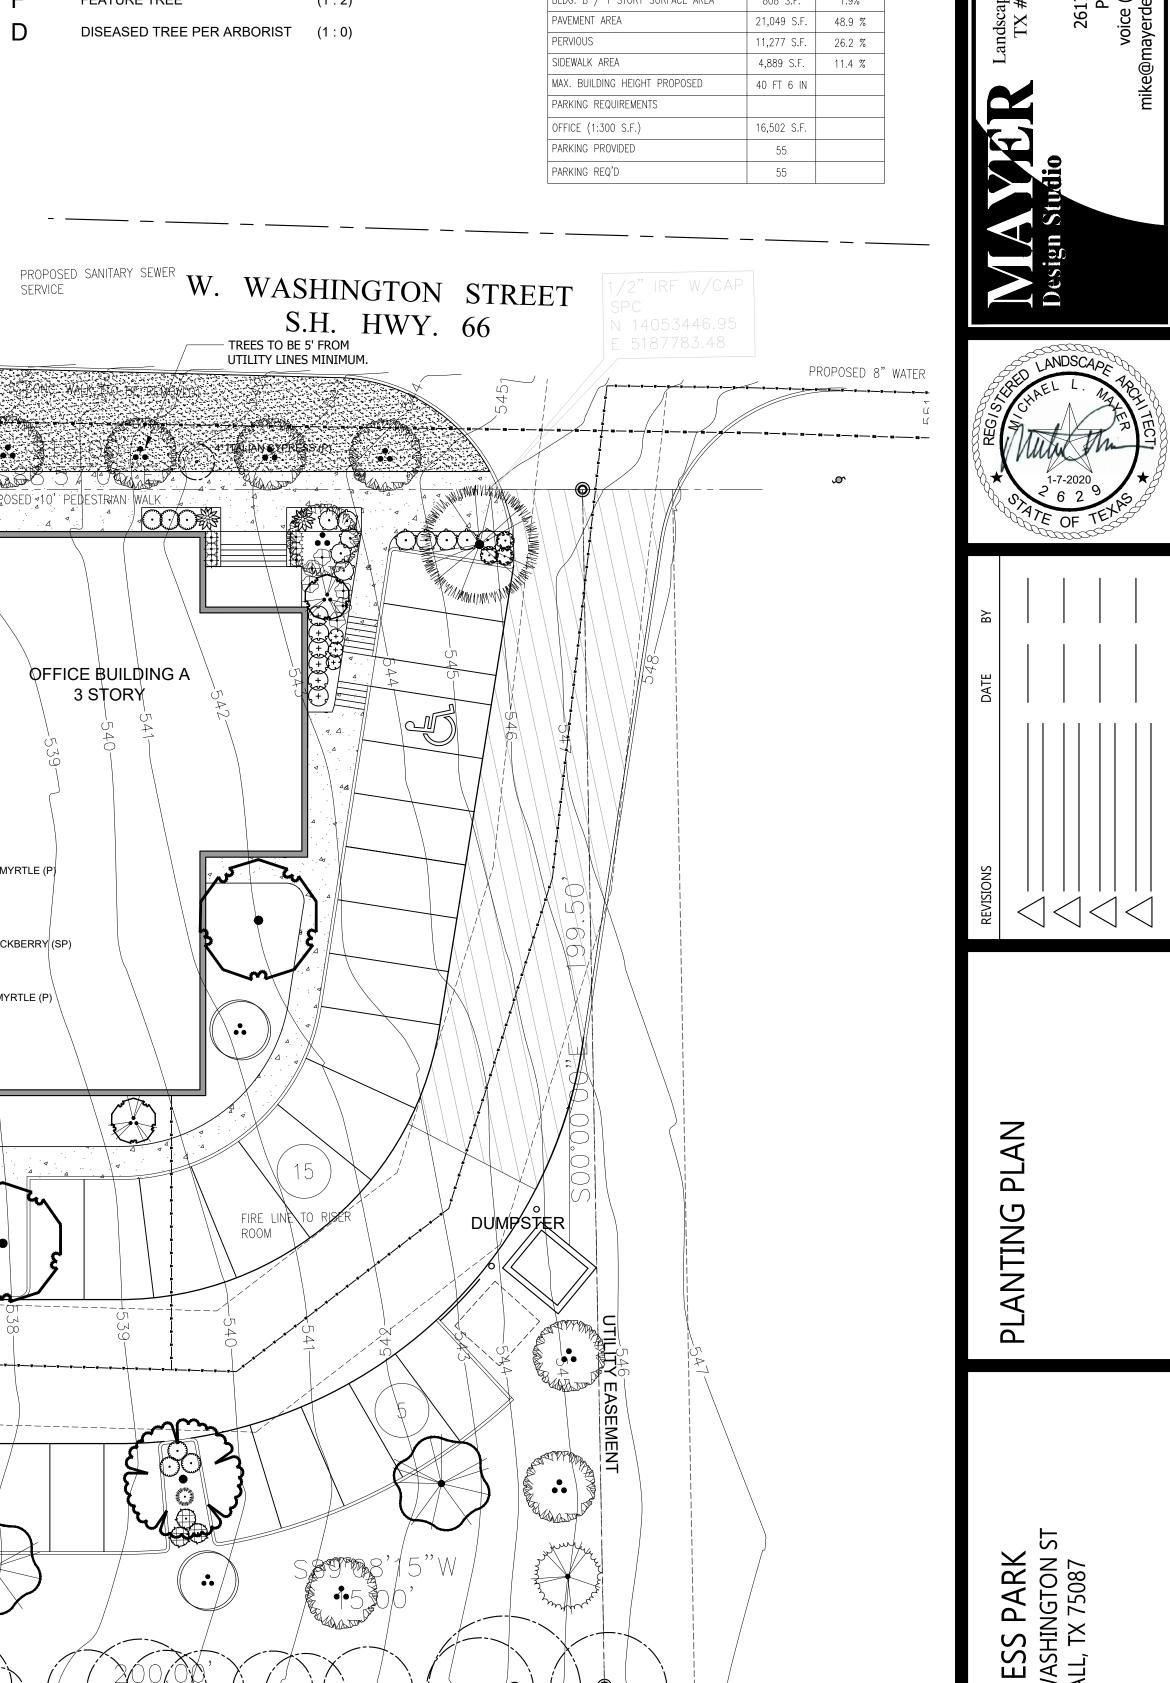

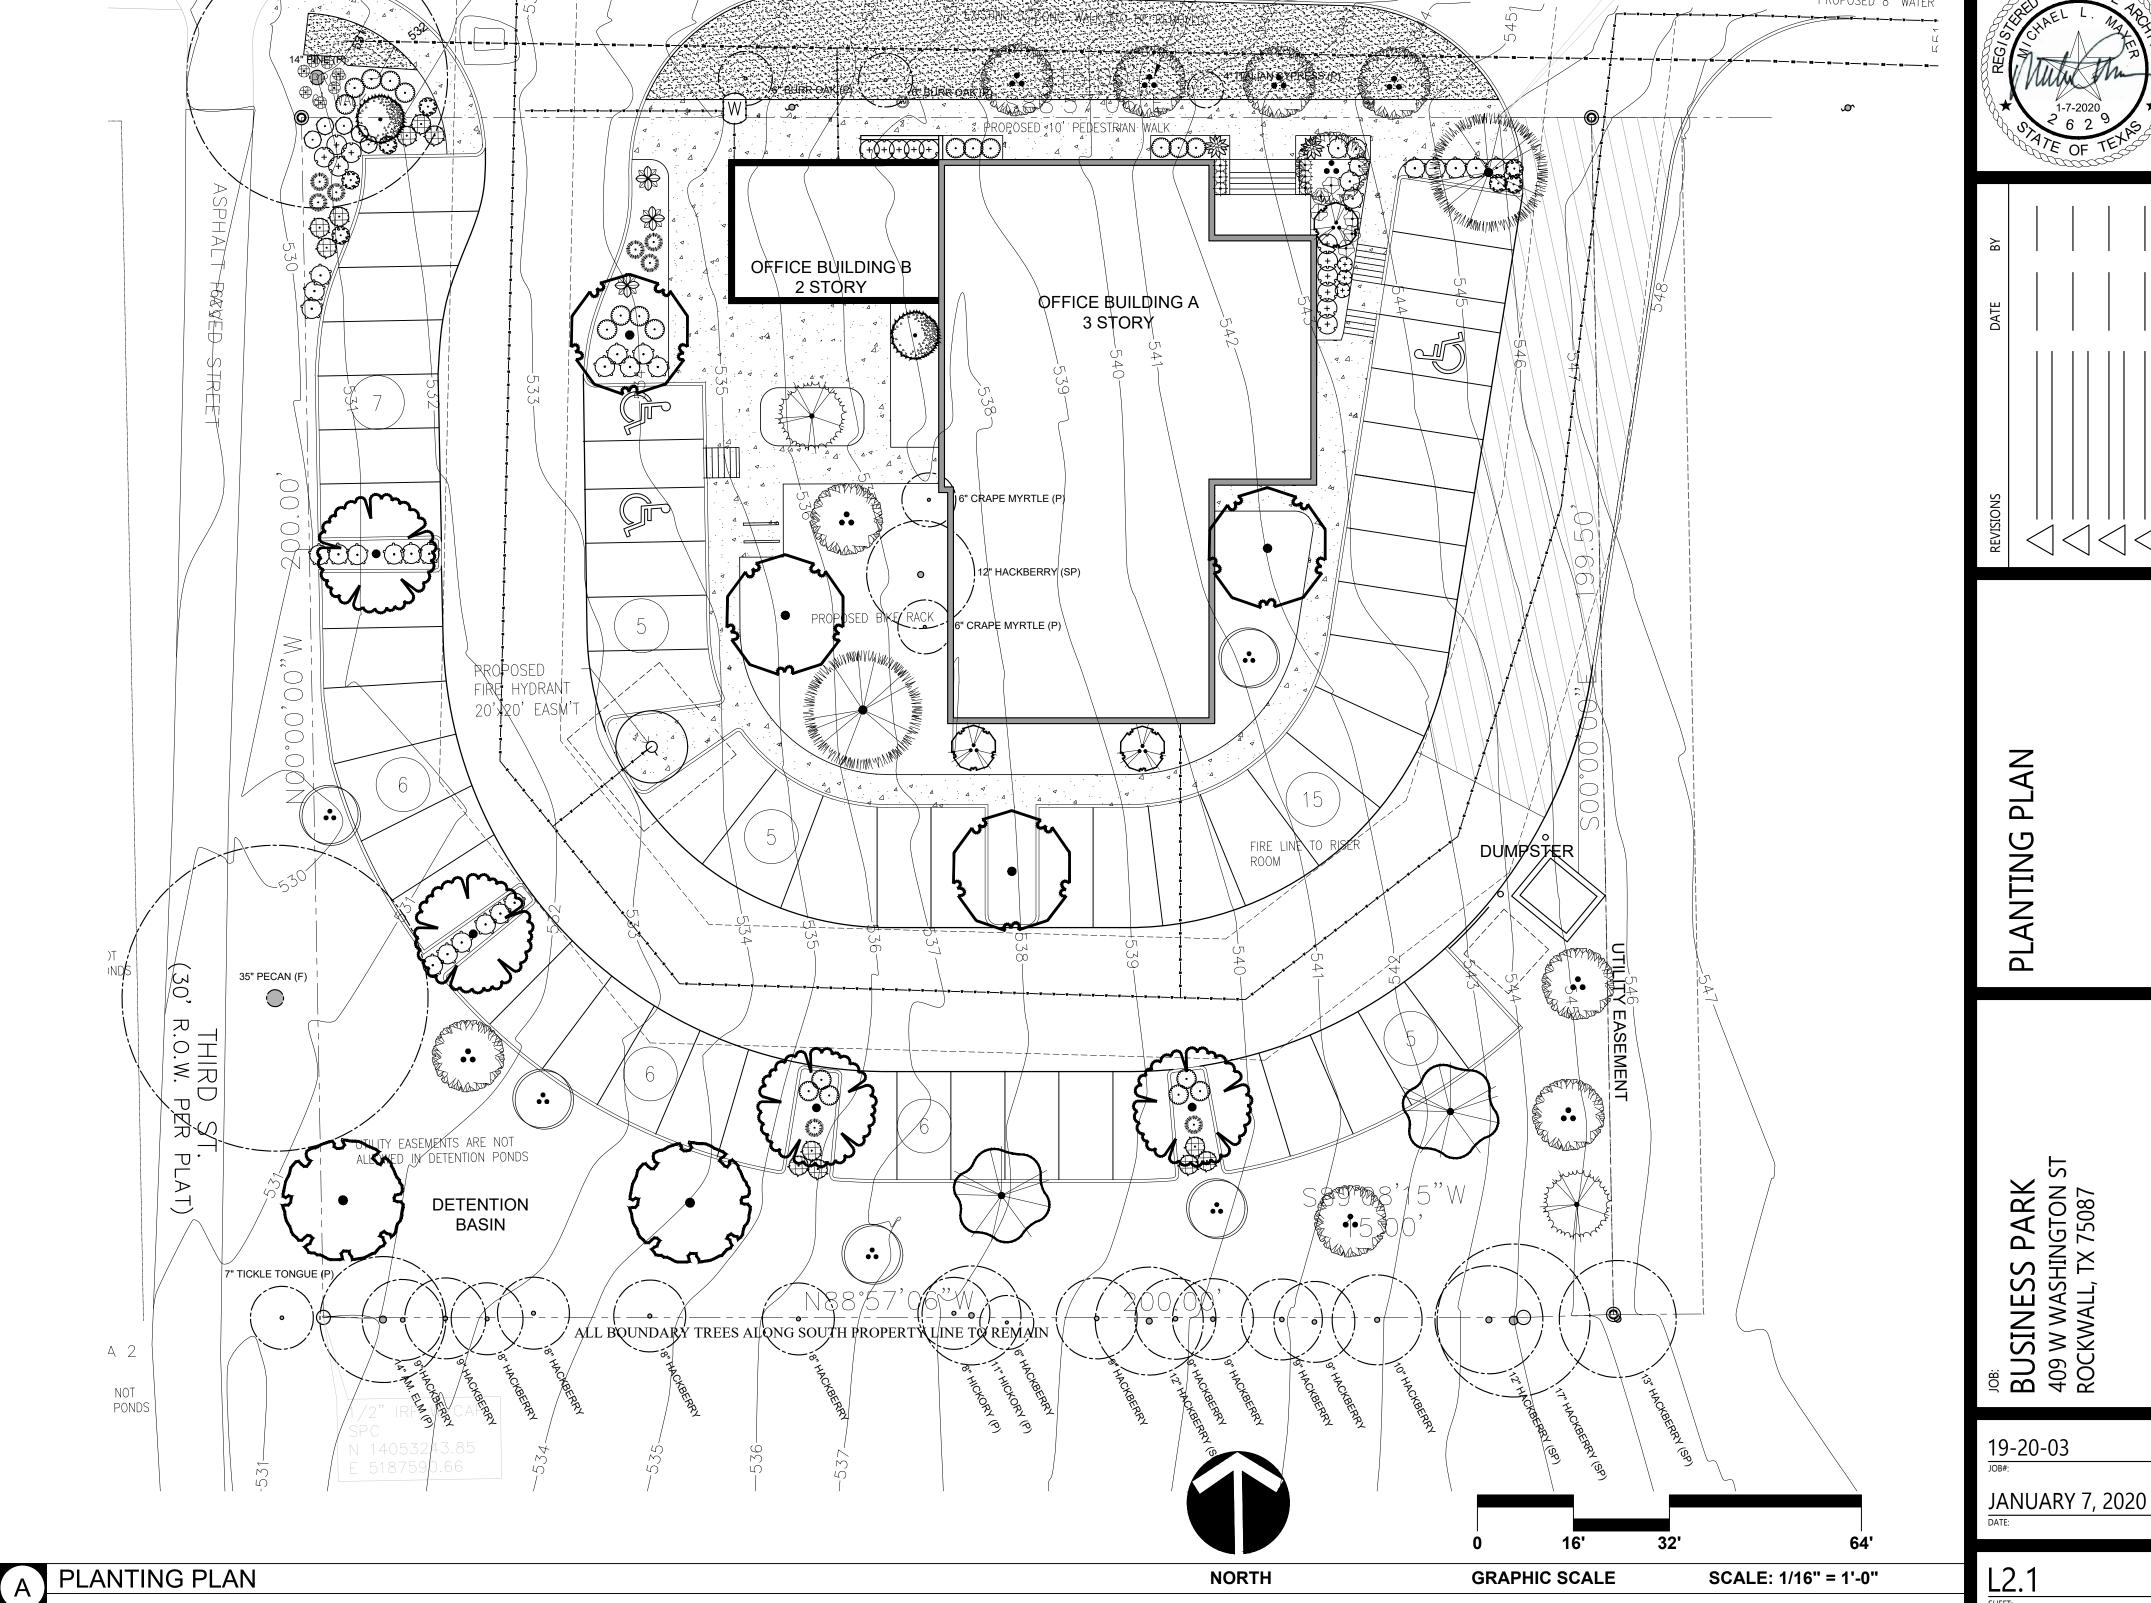


CACTI

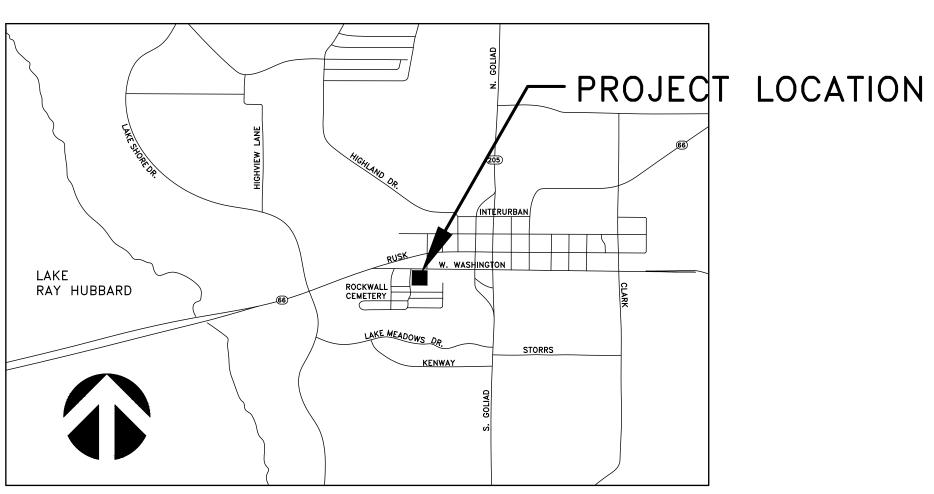

VICINITY MAP

WASHINGTON STREET S.H. HWY. 66 (50' r.o.w. per plat)

∕—€ WASHINGTON ST.

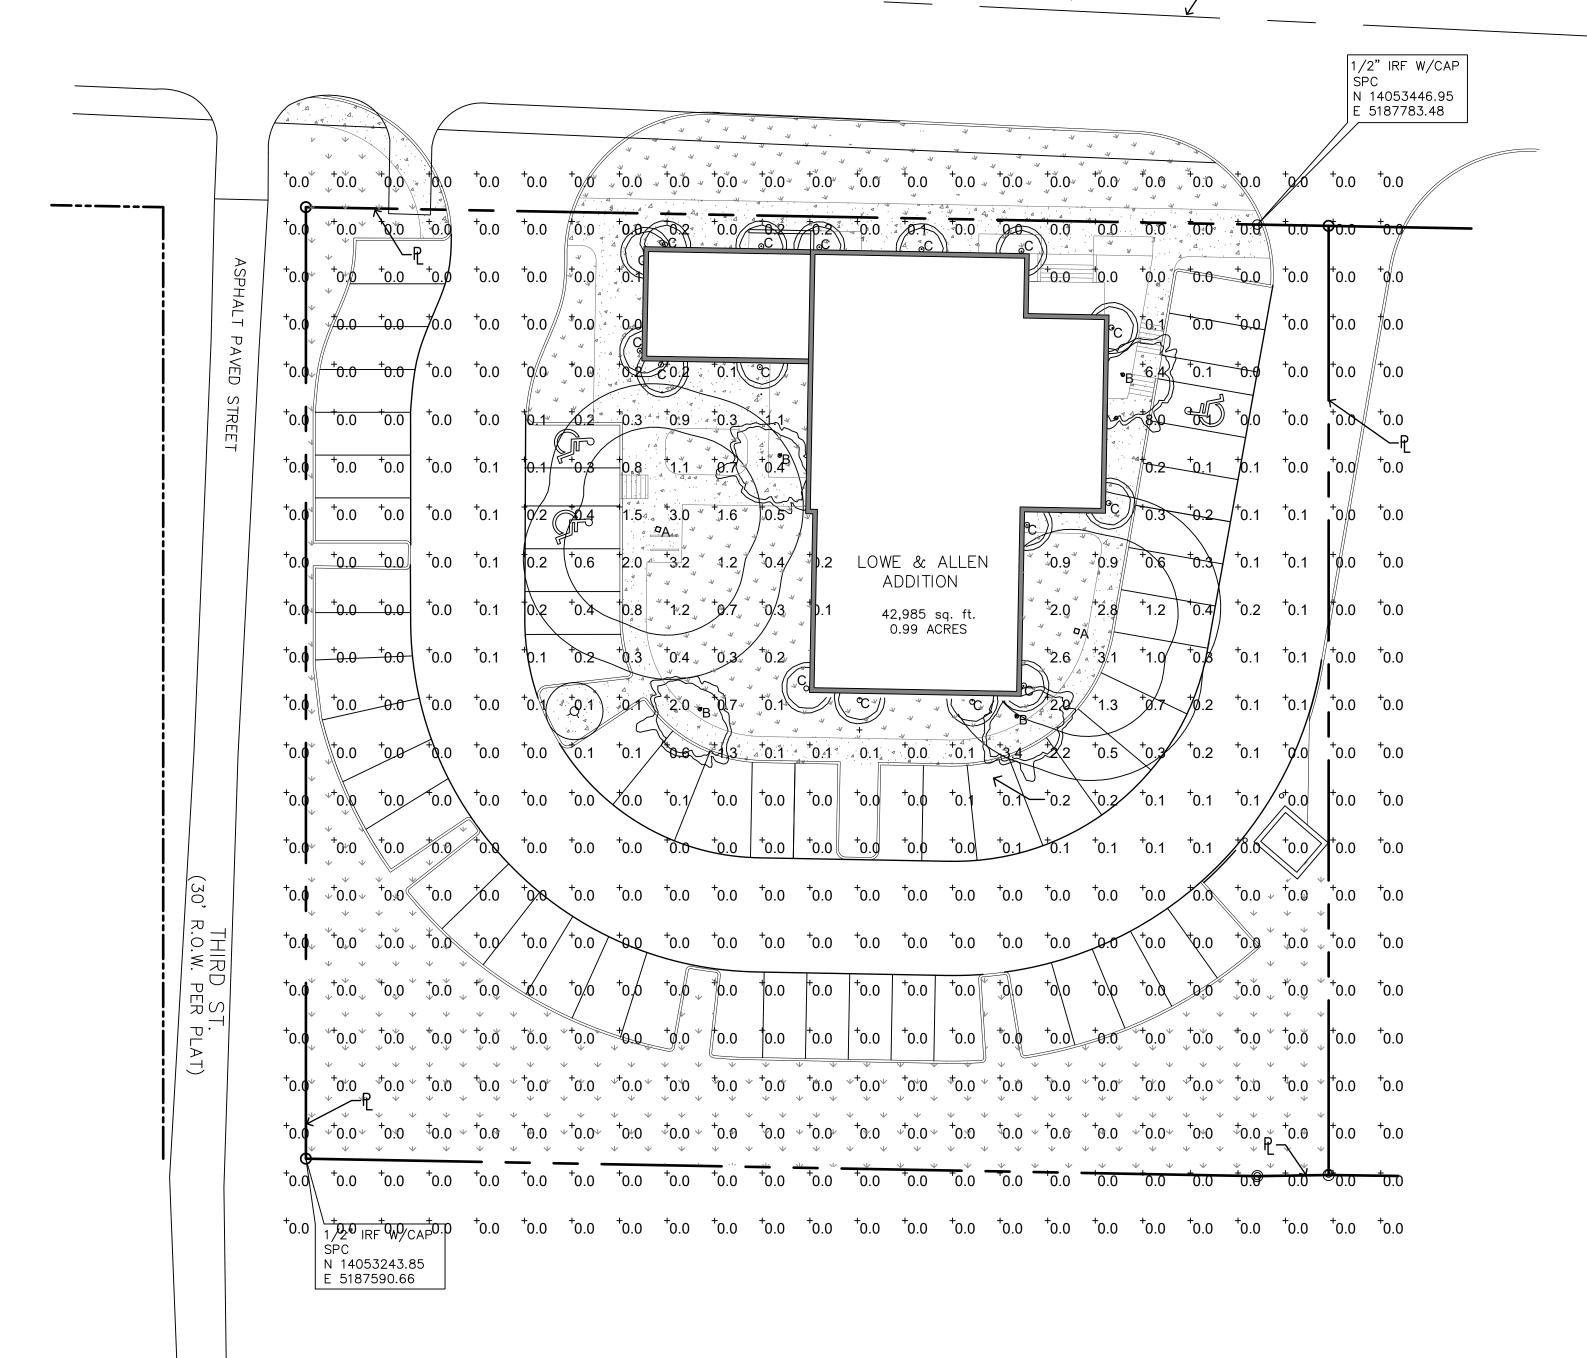

SITE SUMMARY — COMM	ERCIAL ZONING	
DESCRIPTION		LOT PERCENTAGE
LOT	42,985 S.F.	100 %
IMPERVIOUS	31,453 S.F.	73.1%
BLDG. A / 3 STORY SURFACE AREA	4,929 S.F.	11.4%
BLDG. B / 1 STORY SURFACE AREA	840	1.9%
PAVEMENT AREA	21,049 S.F.	48.9 %
PERVIOUS	11,532 S.F.	26.8 %
SIDEWALK AREA	4,635 S.F.	10.7 %
MAX. BUILDING HEIGHT PROPOSED	40 FT 6 IN	
PARKING REQUIREMENTS		
OFFICE (1:300 S.F.)	16,469 S.F.	
PARKING PROVIDED	55	
PARKING REQ'D	55	

PHOTOMETRIC SITE PLAN

SCALE: 1"=20'

SCALE: 1" = 20'

OWNER/DEVELOPER:
LMGC, LLC
JIMMY McCLINTOCK
(972)983-2222
3021 RIDGE RD.
ROCKWALL, TEXAS 75087

ARCHITECT/PLANNER:
RAMSAY & REYES, LLC
ROSS RAMSAY
(214)536-5306
2235 RIDGE RD. STE 201
ROCKWALL, TEXAS 75087



TON 75087

BUSINESS PARK
409 W. WASHINGTON
CKWALL, TEXAS 75087

PROJECT No.

DRAWN BY

CHECKED BY

DATE

DATE

SCALE

SCALE

SHEET NO.

SR

RR

01/07/2020

1" = 20'


Sheet no.

DRAWING NAME:

PHOTOMETRI

PHOTOMETRIC SITE PLAN

SP2019-044

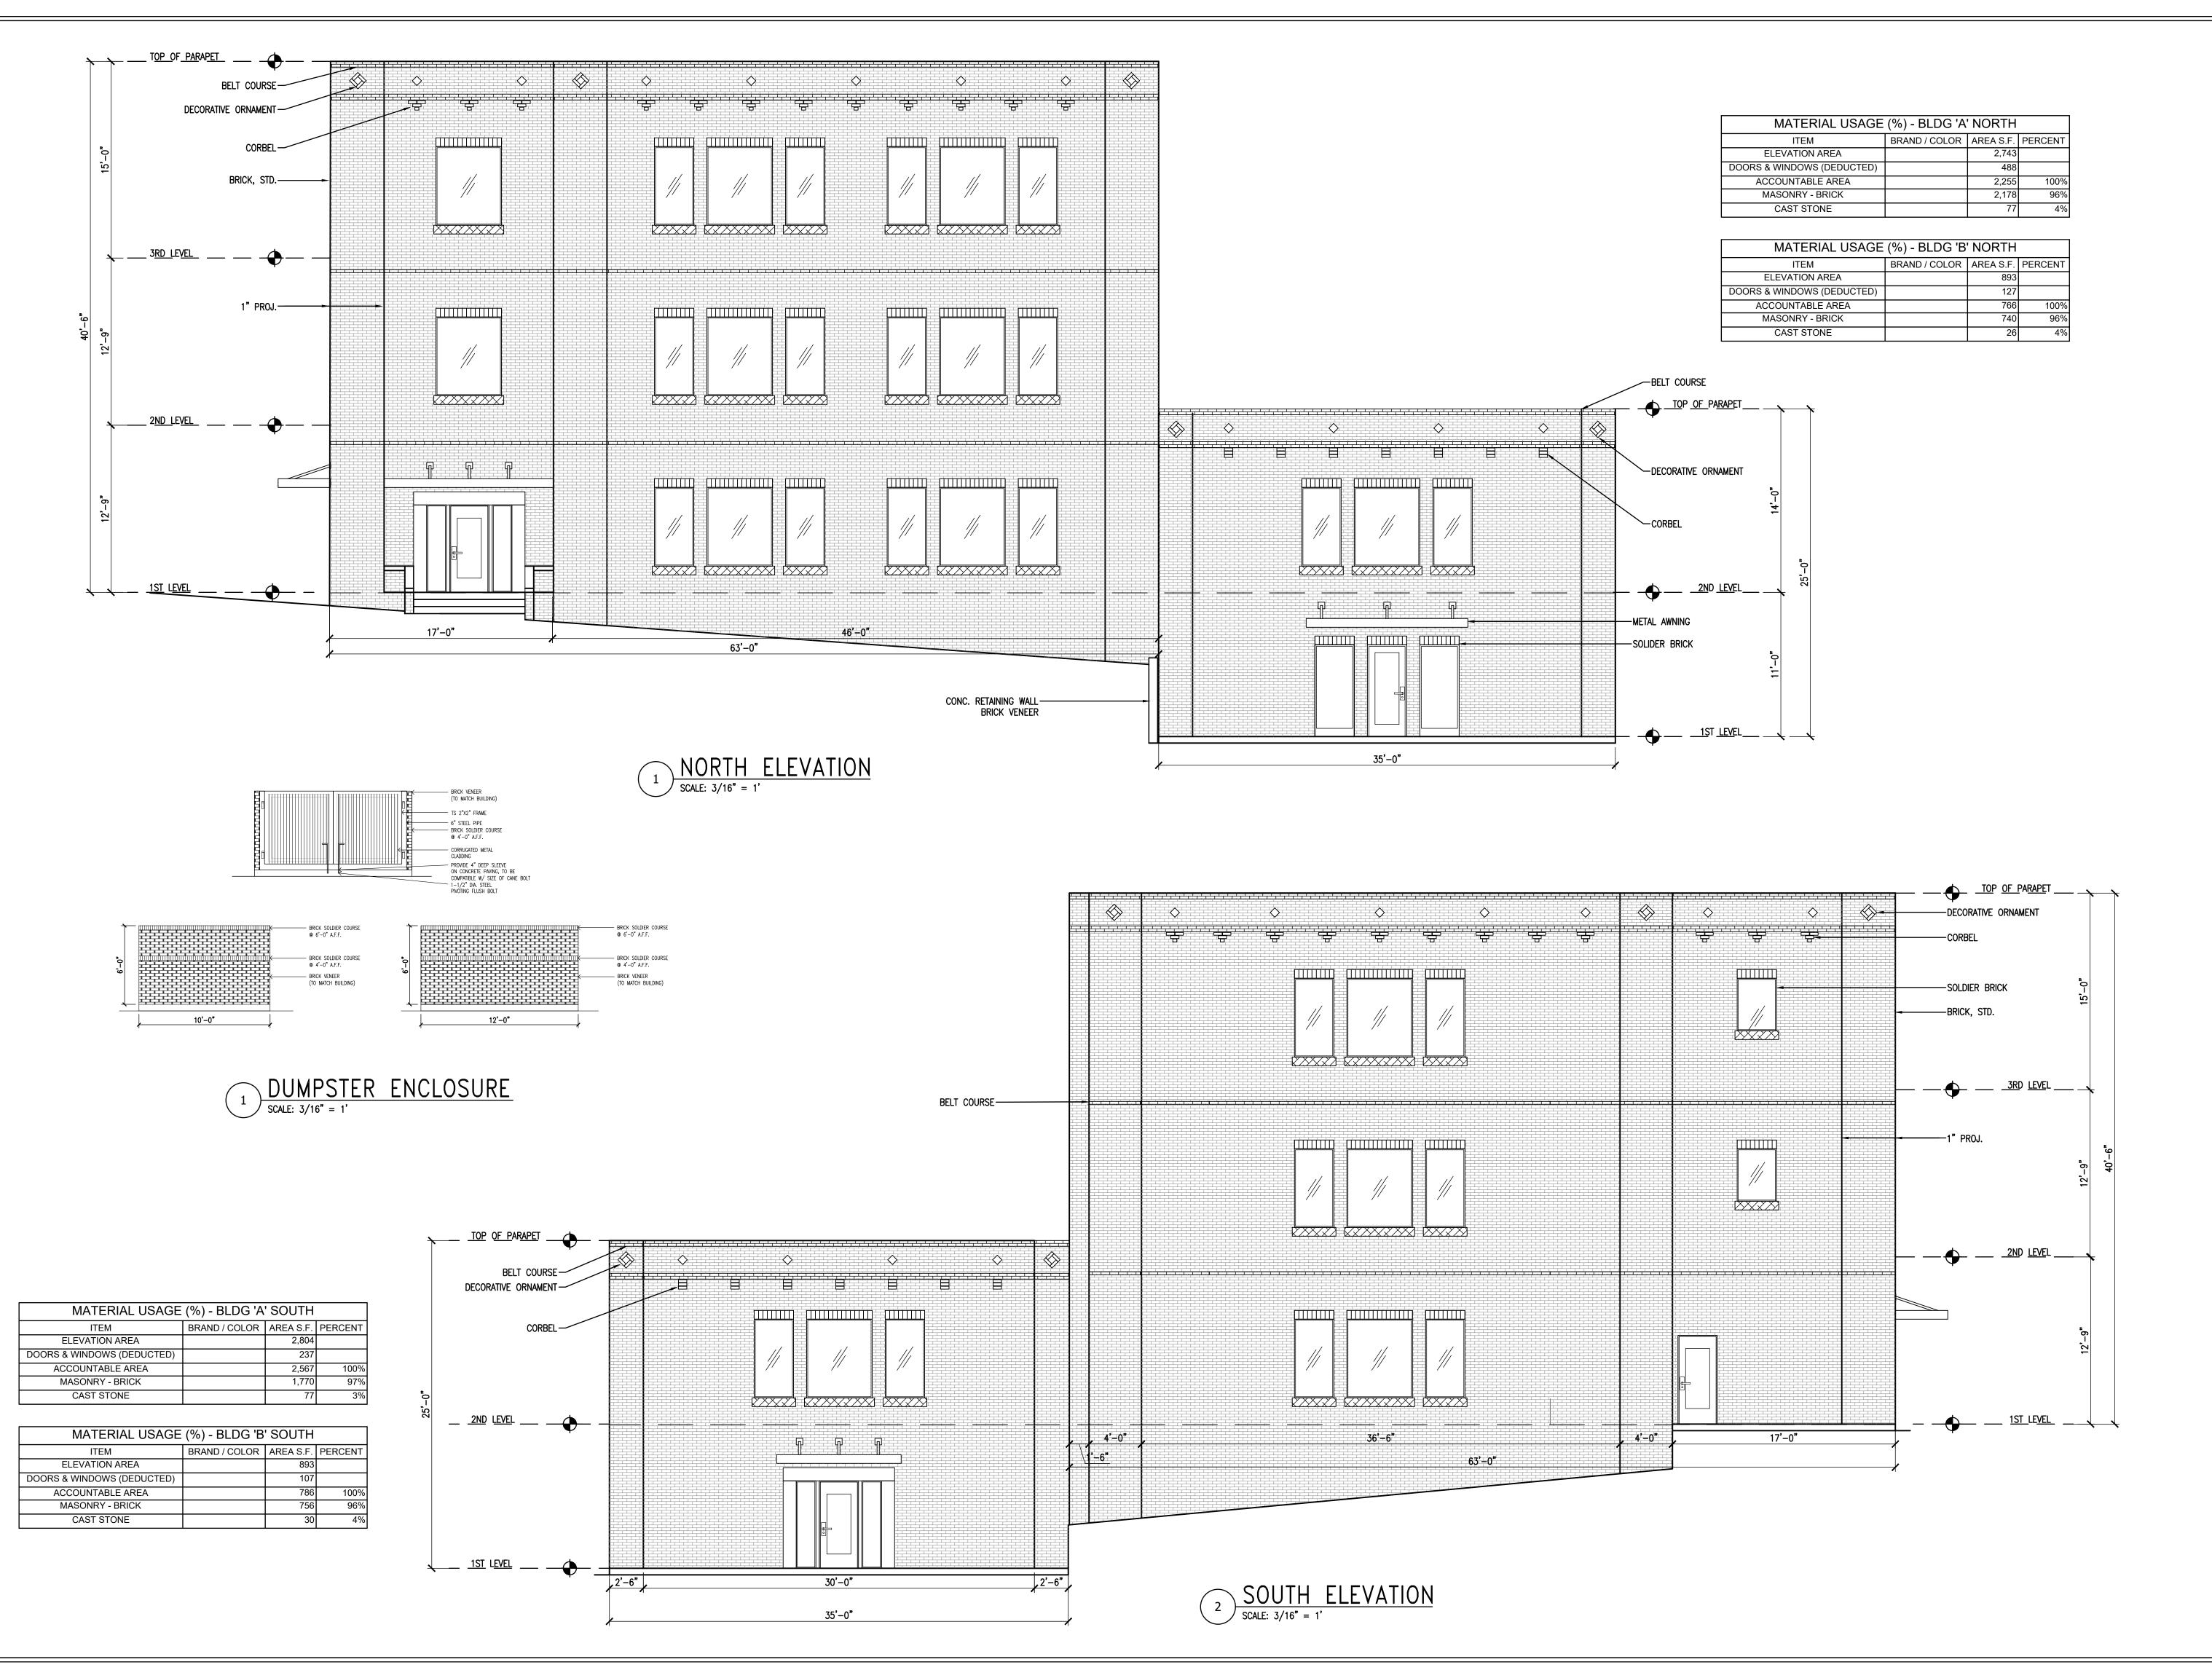



RAMSAY & REYES, LLC

RAMS

No. DESCRIPTIONS/ISSUE DATE

BUSINESS PARK

PROJECT No. ---
DRAWN BY SR

CHECKED BY RR

DATE 01/07/2020

SCALE 3/16" = 1'


SHEET NO. of


DRAWING NAME:

ELEVATION NORTH & SOUTH


A - 201

SP2019-044

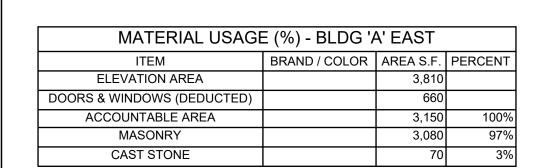

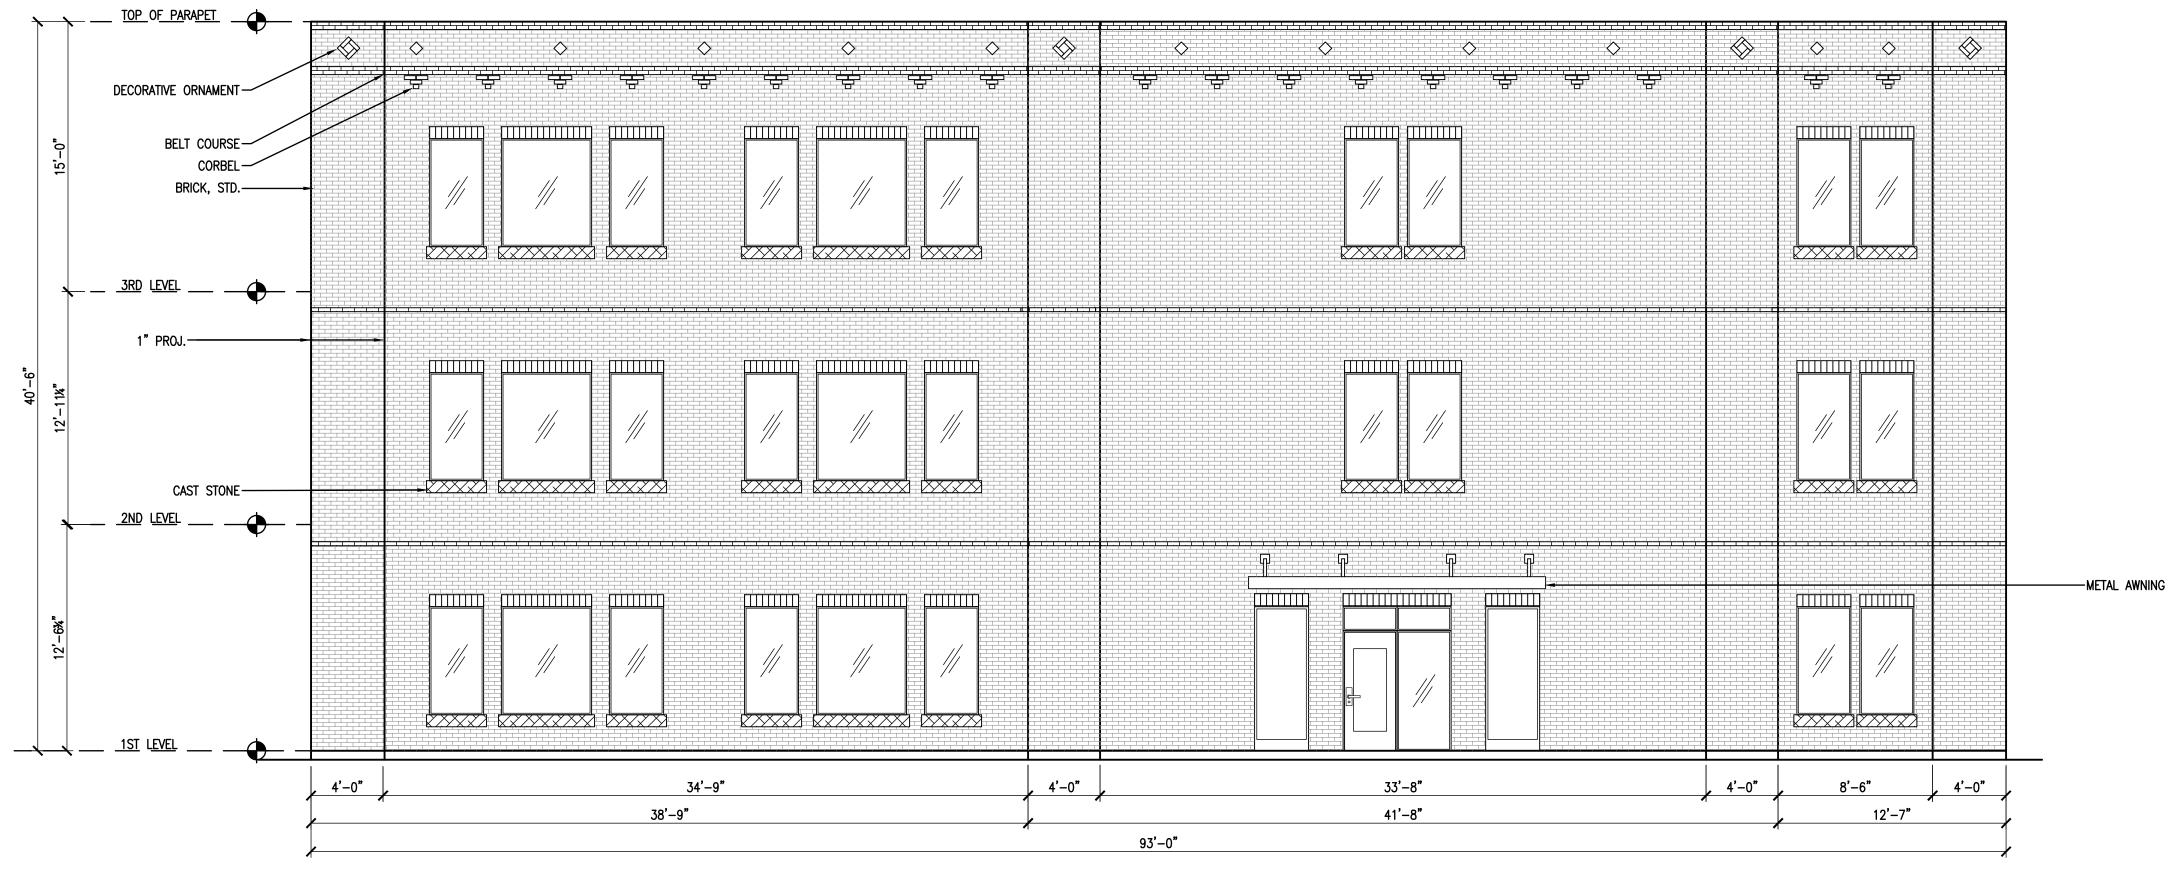



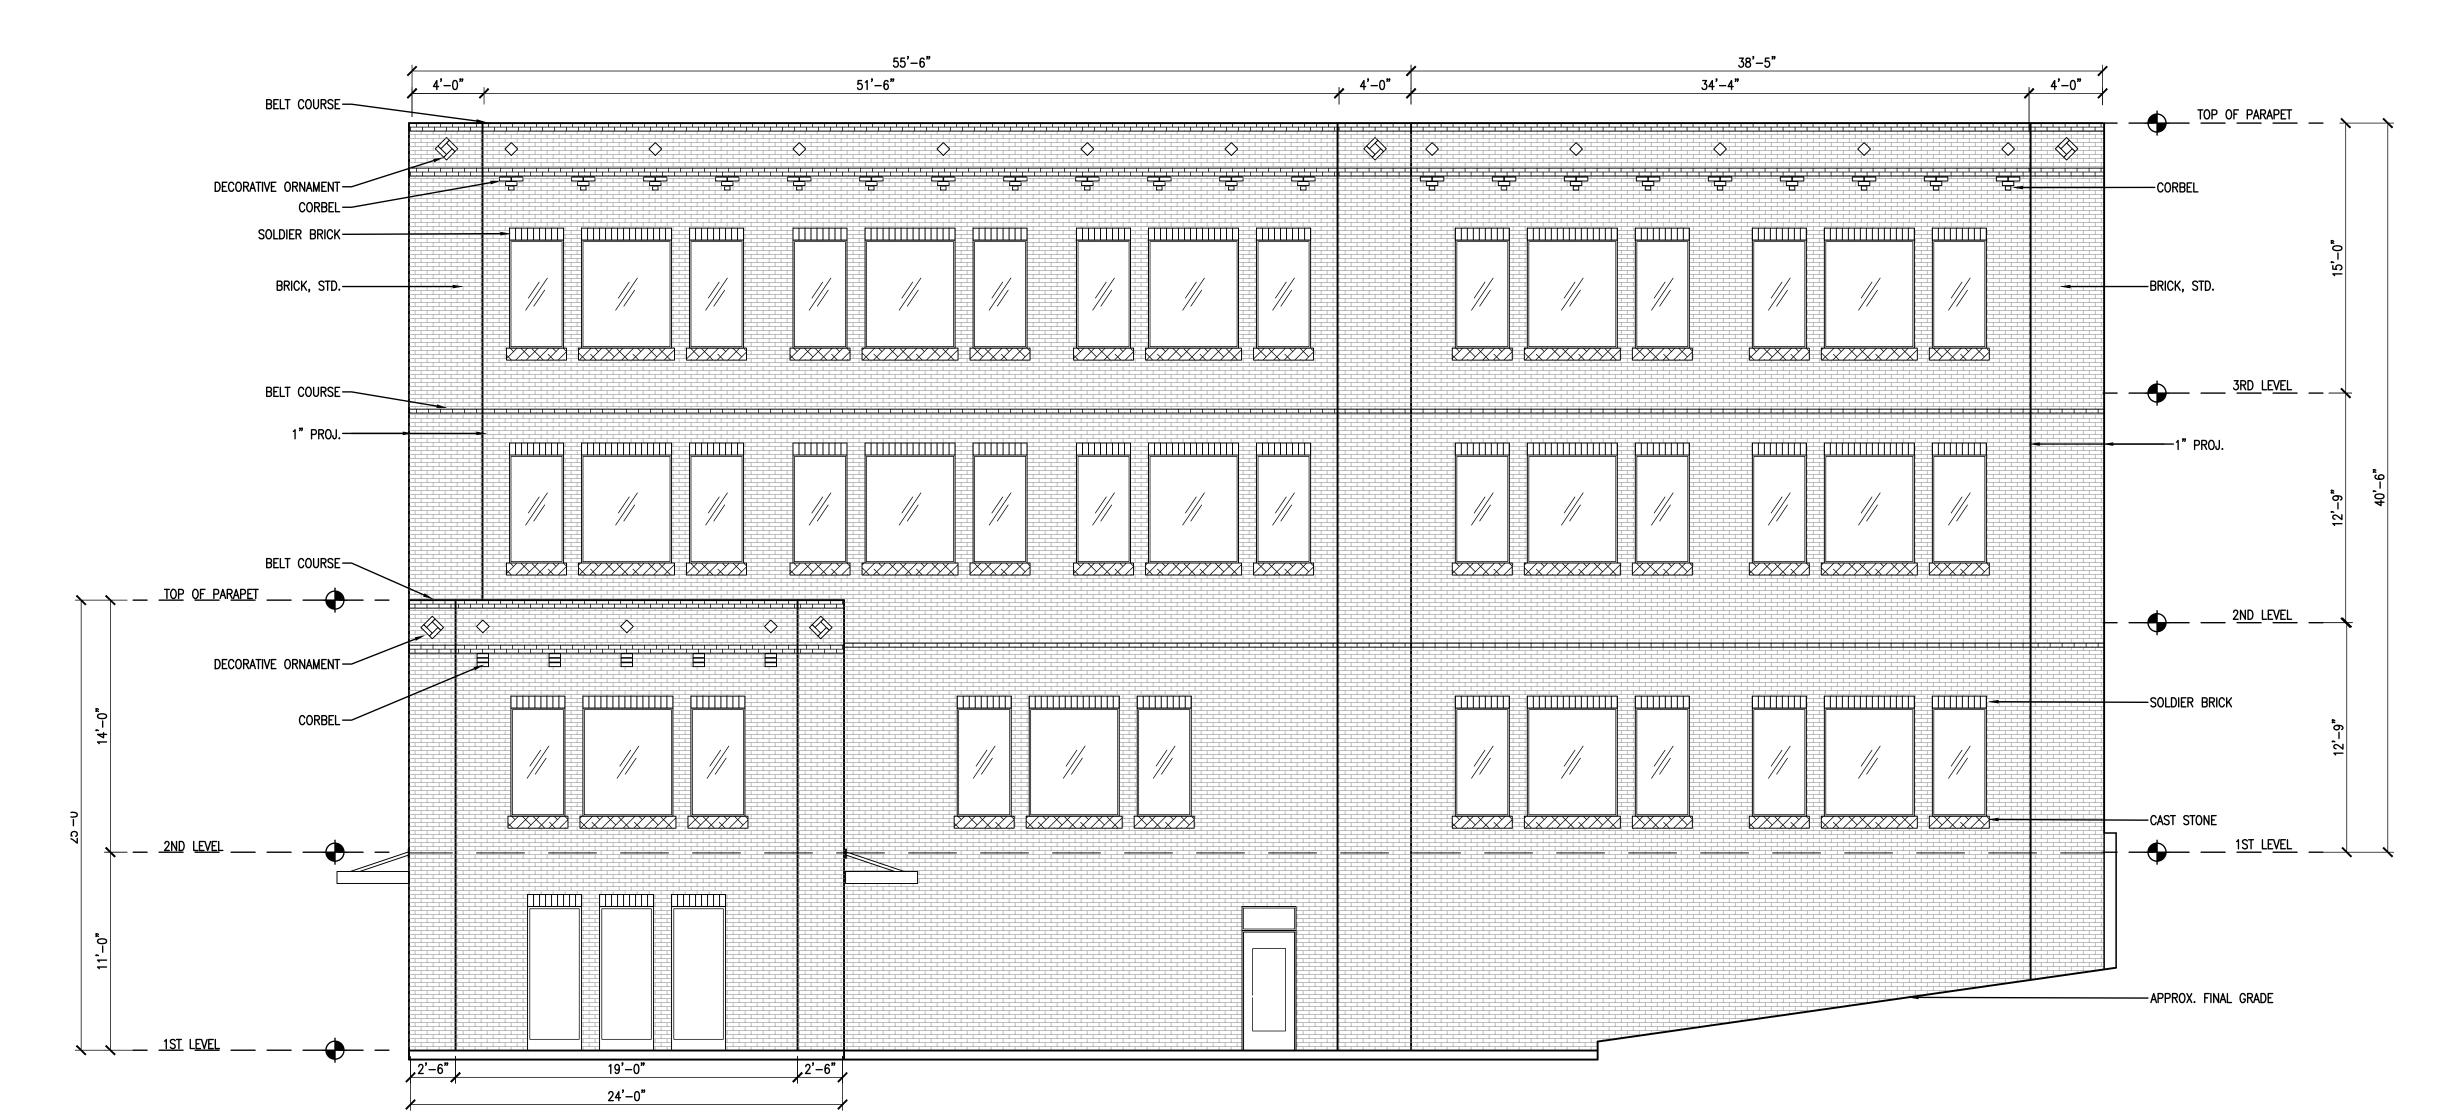

MATERIAL USAGE (%) - BLDG 'A' WEST						
ITEM	BRAND / COLOR	AREA S.F.	PERCENT			
ELEVATION AREA		4,176				
DOORS & WINDOWS (DEDUCTED)		853				
ACCOUNTABLE AREA		3,323	100%			
MASONRY		3,219	97%			
CAST STONE		104	3%			

MATERIAL USAGE (%) - BLDG 'B' WEST ITEM BRAND / COLOR AREA S.F. PE ELEVATION AREA 604	
ELEVATION AREA 604	RCEN
DOORS & WINDOWS (DEDUCTED) 136	
ACCOUNTABLE AREA 468	100
MASONRY 460	99
CAST STONE 8	1





RAMSAY & REYES, LLC

DATE OF STATE OF STAT

No. DESCRIPTIONS/ISSUE DATE

No. DESCRIPTIONS/ISSUE

S 7

BUSINESS PARK
409 W. WASHINGTON

 PROJECT No.

 DRAWN BY
 SR

 CHECKED BY
 RR

 DATE
 01/07/2020

 SCALE
 3/16" = 1'

 SHEET NO.
 of

DRAWING NAME:

ELEVATION
EAST & WEST

A - 202

SP2019-04

	DATE			
REVISIONS	DESCRIPTIONS/ISSUE			
	ė			

ARK


 $\mathbb{B}^{\mathbb{C}}$

PROJECT No.

TON 7508

ING AS

Job Name: Quantity:

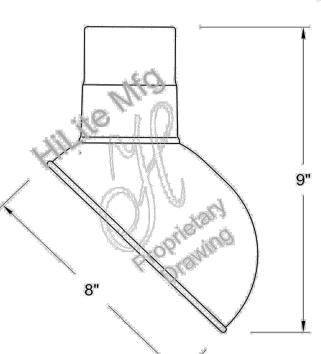

H-EM-08

Emblem Shade

Collection

FINISH -Offered in exceptional finishes, comprised of: polyester/polished powder coat, baking enamal liquid, raw metal, or galvanized finishes.

Standard Finishes are: 91(Black), 93(White), 95(Dark Green), 96(Galvanized), BR47(Powder Coat Rust), BK01(Black Texture), GN20(Powder Coat Patina). Upgraded Finishes are: 29, 66, 82, 90, 92, 94, 97,

99, 100, 103, 104, 105, 110, 112, 113, 114, 115, 117, 118, 119, 120, 127, 128, 129, 133, 134, 135, 136, 98, 101, 102, 137, 138, 139, 140, 121, 122, 123, 124, 125, 126, 11, 01, 22, 25, 33, 77, 89, 24, 44, 48, 49, 15, 16.

For interior finish of fixture refer to color chart on pages 344-348.

HI-LITE MFG.

13450 Monte Vista Avenue

Telephone: (909) 465-1999

e-mail: sales@hilitemfg.com

CO., INC

Chino, California 91710

Toll Free: (800) 465-0211

Fax: (909) 465-0907 web: www.hilitemfg.com

> MOUNTING - Stem, Arm, and Flush mounting available.

ACCESSORIES - WGR(Wire Guard) and SK(Swivel Knuckle) available.

aluminum 6061-0 and/or 1100-0, galvanized 22 gauge, steel 20/22 gauge, copper 032/040 and brass 032/040 construction. Dependant on finish.

REFLECTOR - Heavy duty, spun shade,

SOCKETS/LAMPS - Available in:

Incandescent rated 200 watt max/120 volt, medium base. Compact Fluorescent(CFL) - rated 13/18/26/32 watt max/120/277 volt,

GX24Q base. Metal Halide(MH)

rated 35/50/70/100 watt max/120/208/240/277 volt, medium base, 4KV socket.

High Pressure Sodium(HPS) - rated 50/70/100 watt max/120/277 volt, medium

DRAWN BY SR CHECKED BY RR 01/07/2020 SCALE 1" = 20'SHEET NO. of DRAWING NAME:

OUTDOOR LIGHT SPECS.

©2012 Acuity Brands Lighting, Inc. All Rights Reserved.

50M MED

70M MED

100M MED

39MHC G121

70MHC G12

26TRT

32TRT

42TRT

Antique Street Lamps™ | 3825 Columbus Road | Granville, OH 43023 | Phone: I-800-410-8899 | www.antiquestreetlamps.com

GCF

120

208³ 240 277

SINGLE FUSE

HF HOUSE SIDE SHIELD

(TYPE 2 & 3 ONLY)

DF DOUBLE FUSE

RESONANCE

TLRCB10

a heated alkaline cleaner, rinse, phosphate coating, rinse and sealant.

The luminaire is die cast and permanent mold aluminum. The roof has an internal hinge, hidden from view. Roof and ballast lids are sealed with silicone gaskets. All exposed hardware is weather resistant. FINISH: The luminaire has a powder coat finish utilizing a premium TGIC polyester powder. The finish is a three-stage process that consists of drying, powder application and curing. Before coating, the parts are treated with a five-stage pretreatment process, consisting of

Luminaire is furnished with an HID ballast assembly. Sockets are porcelain, medium base, with a copper alloy nickel-plated screw shell and center contact. Ballasts are core and coil, high-power factor, regulating type. Lamp is not included.

The Resonance Bollard offers a patented impact resistant mounting and leveling design ensuring lifelong performance. Three leveling pads within the base mounting plate are easily accessible through the access panel. The leveling pads provide full contact with the concrete pad, providing a high degree of stability. The base mounting plate is fully welded to the bollard post, providing complete structural support from all directions, giving the bollard superior vandal resistance.

Listings: The luminaire is tested to and meets all NRTL's outdoor requirement standards, wet location use, through the fully accredited and approved CSA laboratory.

ENERGY INDEPENDENCE NIGHTIME RICHTIME FRIENDLY

TLRCB10 HID

Rev. 4/14

The horizontal lens is tempered fl at glass with a continuous seal. The luminaire utilizes an internal anodized and segmented reflector with socket for horizontal lamp. Reflectors are available in Type II, III, IV, and V, full cutoff distributions, are interchangeable and rotatable.

BOLLARD 1.0 HID

Sample Catalog number:

TLRCB10 100M MED

R2 TYPE 2

R3 TYPE 3

R4² Type 4

R5 TYPE 5

MADE IN THE U.S.A.

Suitable for wet location. (Except when cord mounted)

DL-247-A

Consistent with LEED[®] goals & Green Globes™criteria Series 247 and 247 Cutoff for light pollution reduction 50-150W HPS, 100-175W MH PRODUCT OVERVIEW Features: Die-cast aluminum housing and hood for long-life performance Die-cast trigger latch (TL) option available for easy access to internal components Optical assembly designed for maximum performance Hinged hood and captive screw provision afford guick, easy access to electrical and optical area for relamping or servicing Slipfitter with three set screws allows secure installation to pole sizes 2-3/8" or 3" O.D. E39 mogul base socket standard All electrical components warranted by American Electric Lighting's 6-year guarantee Complies with ANSI: C136.2, C136.10, C136.15, C136.31 (regular only), C136.16 (FC only) Suitable for -30°C MH & / -40°C HPS **Applications:** Streetscapes Walkways Pathways

Parks

STREET LAMPS

American Revolution

PREFERRED SELECTION CATALOG NUMBERS Series 247 247 10S RN 120 R3 AY 247 15S RN 120 R3 AY 247 10S RN 120 R5 AY 247 15S RN 120 R5 AY Series 247 Cutoff 247 10S RN 120 R2 FC TL 247 10M XN MT1 R2 FC TL

DIMENSIONS (427mm)⁻ Effective Projected Area (EPA)
The EPA for the American Revolution Series 247 is 1.6 sq. ft. Approx. Wt. = 36 lbs.

American Electric Lighting

Max EPA: 1.8 sq feet

Max Height: 3' 8" (111.8 cm)

Max Width: 1' 1" (33 cm)

Max Weight: 35 lbs (15.8 kg)

Ordering Guide:

TLRCB10

DBL BLACK DDB DARK BRONZE DNA NATURAL ALUMINUM DWH WHITE I. I20V and 277V only CM CUSTOM MATCH
CS CUSTOM SELECT 2. Not available with CFL CUSTOM SELECT 3. Consult factory for 208 volt available in Canada RAL COLORS 4. Multi-tap ballast (120, 208, 240, 277V), only available CFL.

Lee, Henry

From: Steven Reyes <steven.reyes85@yahoo.com>
Sent: Monday, November 18, 2019 8:36 AM

To: Gonzales, David **Subject:** 409 W Washington

Attachments: 11_15_19-BUILDINGRENDER.png

The render should've been included in the flash drive. See attached

Steven Reyes (972)345-1684 Ramsay & Reyes

CAUTION: This email originated from outside of the organization. Do not click links or open attachments unless you recognize the sender and know the content is safe.

Lee, Henry

From: Miller, Ryan

Sent: Tuesday, July 28, 2020 1:49 PM

To: Gonzales, David **Cc:** Henry Lee

Subject: FW: 409 W. Washington

Follow Up Flag: Follow up Flag Status: Flagged

FYI ... this is concerning Ross's project over there on Washington Street. He will need to add this to his mitigation costs. Thanks.



RYAN C. MILLER, AICP

DIRECTOR OF PLANNING & ZONING • PLANNING & ZONING DIVISION • CITY OF ROCKWALL 972.772.6441 OFFICE RMILLER@ROCKWALL.COM 385 S. GOLIAD STREET • ROCKWALL, TX 75087

HELPFUL LINKS | CITY OF ROCKWALL WEBSITE | PLANNING & ZONING DIVISION WEBSITE | MUNICIPAL CODE WEBSITE GIS DIVISION WEBSITE | CITY OF ROCKWALL INTERACTIVE MAPS | UNIFIED DEVELOPMENT CODE

NOTES

1) <u>APPOINTED AND ELECTED OFFICIALS</u>: BY <u>REPLYING ALL</u> TO THIS EMAIL YOU MAY BE IN VIOLATION OF THE TEXAS OPEN MEETINGS ACT. PLEASE REPLY ONLY TO THE SENDER.

2) PLEASE NOTE THAT ANY CORRESPONDENCE SENT TO CITY STAFF MAY BECOME PUBLIC RECORD

From: Sales, Travis

Sent: Tuesday, July 28, 2020 1:48 PM

To: Miller, Ryan

Subject: 409 Rusk Tree Evaluation

30" caliper Pecan Carla illinoinensis

This tree is showing some signs of limb die back sporadically and is not uncommon in the summer for a pecan of this age

There are many improper pruning cuts that might be playing a part in the limb die back.

For the most part I would say the tree is an average to above average health.

I saw no sign of disease or insect and feel that this tree is a candidate for tree mitigation.

ISA Certified Arborist ISA Municipal Specialist TX0973

Travis E. Sales, MCPTM City of Rockwall Director Parks, Recreation and Animal Services 108 E. Washington Rockwall, Texas, 75087 Office: 972-772-6467 Mobile: 972-880-4234

This email was scanned by Bitdefender

Lee, Henry

From: Steven Reyes <steven.reyes85@yahoo.com>

Sent: Wednesday, August 5, 2020 3:45 PM

To: Gonzales, David

Subject: Fwd: 409 pecan tree # 2157 (29" pecan)

Attachments: 409 Wash - L1.1 TREESCAPE.pdf; 409 Wash - L2.1 PLANTING.pdf

Follow Up Flag: Follow up Flag Status: Flagged

Dave:

Here is the latest on the landscape plans

From: Ross Ramsay [mailto:r7ramsay@yahoo.com]

Sent: Tuesday, July 28, 2020 1:48 PM

To: Michael Mayer < mike@mayerdesignstudio.com >

Subject: 409 pecan tree # 2157 (29" pecan)

The city arborist said it is healthy, so we need to mitigate it.

Regards, Ross Ramsay

This email was scanned by Bitdefender

CAUTION: This email originated from outside of the organization. Do not click links or open attachments unless you recognize the sender and know the content is safe.

Lee, Henry

From: Gonzales, David

Sent: Wednesday, August 5, 2020 5:10 PM

To: 'Steven Reyes'

Subject: RE: 409 pecan tree # 2157 (29" pecan)

Attachments: TREESCAPE PLAN [Staff Mark-Up -- Revised Plan] (08.05.2020).pdf

Steven,

Please see the attached mark-up for the treescape plan. I spoke with Ryan and he is OK with 100% of the balance towards the City's Tree Fund. This would be due at the time of platting. If this is OK, then simply make the changes to the plan. However, if your client would rather plant the trees to satisfy the mitigation, then they will need to work out an arrangement with the Parks Department.

Let me know what you would like to do.

Thank you,



DAVID GONZALES, AICP

PLANNING & ZONING MANAGER
PLANNING & ZONING DIVISION • CITY OF ROCKWALL
972.772.6488 OFFICE

DGONZALES@ROCKWALL.COM

385 S. GOLIAD STREET • ROCKWALL, TX 75087

HELPFUL LINKS | CITY OF ROCKWALL WEBSITE | PLANNING & ZONING DIVISION WEBSITE | MUNICIPAL CODE WEBSITE

GIS DIVISION WEBSITE | CITY OF ROCKWALL INTERACTIVE MAPS | MAIN STREET DIVISION

From: Steven Reyes [mailto:steven.reyes85@yahoo.com]

Sent: Wednesday, August 5, 2020 3:45 PM

To: Gonzales, David

Subject: Fwd: 409 pecan tree # 2157 (29" pecan)

Dave:

Here is the latest on the landscape plans

From: Ross Ramsay [mailto:r7ramsay@yahoo.com]

Sent: Tuesday, July 28, 2020 1:48 PM

To: Michael Mayer <mike@mayerdesignstudio.com>

Subject: 409 pecan tree # 2157 (29" pecan)

The city arborist said it is healthy, so we need to mitigate it.

Regards,

Ross Ramsay

This email was scanned by Bitdefender

CAUTION: This email originated from outside of the organization. Do not click links or open attachments unless you recognize the sender and know the content is safe.