PLANNING AND ZONING CASE CHECKLIST City of Rockwall Planning and Zoning Department 385 S. Goliad Street Rockwall, Texas 75087

☐ TREESCAPE PLAN

| P&Z CASE # <u>\$P2019-048</u> P&Z DATE | CC DATE | APPROVED/DENIE |
|---|--|--|
| ARCHITECTURAL REVIEW BOARD DATE | HPAB DATE | PARK BOARD DATE |
| ZONING APPLICATION SPECIFIC USE PERMIT ZONING CHANGE PD CONCEPT PLAN PD DEVELOPMENT PLAN SITE PLAN LANDSCAPE PLAN TREESCAPE PLAN PHOTOMETRIC PLAN BUILDING ELEVATIONS MATERIAL SAMPLES COLOR RENDERING | APPLICATI RECEIPT LOCATION HOA MAP PON MAP FLU MAP NEWSPAP S00-FT. BL PROJECT R STAFF REP CORRESPO COPY-ALL COPY-MAF CITY COUN MINUTES- PLAT FILED | ER PUBLIC NOTICE UFFER PUBLIC NOTICE UEVIEW ORT ONDENCE PLANS REQUIRED RK-UPS ICIL MINUTES-LASERFICHE |
| | NOTES: | |
| PLATTING APPLICATION ☐ MASTER PLAT ☐ PRELIMINARY PLAT | | |
| ☐ FINAL PLAT ☐ REPLAT ☐ ADMINISTRATIVE/MINOR PLAT ☐ VACATION PLAT ☐ LANDSCAPE PLAN | ZONING MAP | UPDATED |



DEVELOPMENT APPLICATION

City of Rockwall Planning and Zoning Department 385 S. Goliad Street Rockwall, Texas 75087

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|-----|----|-----|----|----|---|
| 314 | | OJE | UN | | |

PLANNING & ZONING CASE NO.

SP2019-

NOTE: THE APPLICATION IS NOT CONSIDERED ACCEPTED BY THE CITY UNTIL THE PLANNING DIRECTOR AND CITY ENGINEER HAVE SIGNED BELOW.

DIRECTOR OF PLANNING:

CITY ENGINEER:

| Please check the appropriate box below to indicate the typ | e of development request [SELECT ONLY ONE BOX]: |
|--|---|
|--|---|

| Platting Applica | tion Fees | | 7 | | | |
|--|---|--|---|---|------------------|--|
| Platting Application Fees: Master Plat (\$100.00 + \$15.00 Acre) 1 Preliminary Plat (\$200.00 + \$15.00 Acre) 1 Final Plat (\$300.00 + \$20.00 Acre) 1 Replat (\$300.00 + \$20.00 Acre) 1 Amending or Minor Plat (\$150.00) Plat Reinstatement Request (\$100.00) Site Plan Application Fees: Site Plan (\$250.00 + \$20.00 Acre) 1 X Amended Site Plan/Elevations/Landscaping Plan (\$100.00) | | Zoning Application Fees: [] Zoning Change (\$200.00 + \$15.00 Acre) ¹ [] Specific Use Permit (\$200.00 + \$15.00 Acre) ¹ [] PD Development Plans (\$200.00 + \$15.00 Acre) ¹ Other Application Fees: [] Tree Removal (\$75.00) [] Variance Request (\$100.00) Notes: ¹: In determining the fee, please use the exact acreage when multiplying by the per acre amount. For requests on less than one acre, round up to one (1) acre. | | | | |
| | | | | | | |
| Addres | s 2885 Market Center Dr., F | Rockwall, TX 7 | 75032 | | | |
| Subdivision | R W MARKETCENTER A | DDITION | | Lot 1A Block | В | |
| General Location | NWC W Ralph Hall Parkw | vay and Marke | et Center Drive | | | |
| ONING, SITE F | PLAN AND PLATTING INFO | RMATION IPL | EASE PRINT | | | |
| | Commercial (C) District | | Current Use | RETAIL | | |
| Proposed Zoning | Commercial (C) District | | Proposed Use | RETAIL | | |
| Acreage | 21.440 | Lots [Current | | Lots [Proposed] 1 | | |
| [X] SITE PLANS AN process, and fair | D PLATS : By checking this box you ack fure to address any of staff's comments | nowledge that due by the date provided | to the passage of <u>HB310</u> d on the Development Ca | 67 the City no longer has flexibility with regal lendar will result in the denial of your case. | rd to its appro | |
| | | | | ONTACT/ORIGINAL SIGNATURES ARE REQUI | RED1 | |
| | Dunhill Partners, Inc. | | | Winkelmann & Associates, Inc. | | |
| Contact Person | Jill Fisher | | Contact Person | Maria Bonilla | | |
| Address | 3100 Monticello Avenue, S | SUite 300 | Address | 6750 Hillcrest Plaza Drive Suite 215 | | |
| City, State & Zip | Dallas, TX 75205 | | City, State & Zip | Dallas, TX 75230 | | |
| Phone | +1 (214) 261-9588 | | Phone | +1 (972) 490-7090 | | |
| E-Mail | jfisher@dunhillpartners.com | n | E-Mail | mbonilla@winkelmann.com | | |
| efore me, the undersi | CATION [REQUIRED] gned authority, on this day personally ar ue and certified the following: | ppeared Ste | on Hegen | [Owner] the undersigned, who stated the | e information | |
| hereby certify that I a over the cost of this ap at the City of Rockwo | im the owner for the purpose of this app plication, has been paid to the City of Ro ill (i.e. "City") is authorized and permitt | ockwall on this the . ted to provide infor | mation contained within | rue and correct; and the application fee of \$ | oplication, I ag | |

Notary Public in and for the State of Texas **DEVELOPMENT APPLICATION . CITY OF RO**

Owner's Signature

RICHARD JOSEPH LEE

Notary Public, State of Texas

REMAIL SEE COUNTY PUBLIC STATE OF TEXAS

REMAIL SEE TO LINGUIST STATE OF TEXAS TO SEE TO SE Notary ID 130251369

X 75087 • [P] (972) 771-7745 • [F] (972) 771-7727

My Commission Expires



[] PLAT TYPE.

DEVELOPI INT APPLICATION SUBMITTAL REQUIREMENTS

City of Rockwall Planning and Zoning Department 385 S. Goliad Street Rockwall, Texas 75087

PLATTING APPLICATION SUBMITTAL REQUIREMENTS [ALL PLAT TYPES]

| | [] MINOR/AMENDING PLAT. [] MASTER PLAT. [] PRELIMINARY PLAT. [] FINAL PLAT. [] REPLAT. [] VACATION PLAT. |
|---------|--|
| | Staff requires four (4), 18" x 24" copies be submitted at the time the application is submitted. Each set of plans should be folded into a <i>Tri-Fold</i> with the project title or identifier facing out. |
| [] | DIGITAL COPY OF THE PLAT. The following is required with all plat submittals: |
| | [] ONE (1) PDF COPY OF THE PLAT [] ONE (1) SURVEY BOUNDARY CLOSURE REPORT. |
| | * AFTER APPROVAL STAFF WILL REQUIRE ONE (1) AUTOCAD/ESRI (DWG, DXF, OR SHP FILE FORMAT) FILE |
| [] | TREESCAPE PLAN [IF APPLICABLE]. |
| [] | LANDSCAPE PLAN [IF APPLICABLE]. |
| [] | APPLICATION AND APPLICATION FEE. |
| SITE PL | AN APPLICATION SUBMITTAL REQUIREMENTS |
| [X] | PLAN SET. A plan set is composed of the following items: |
| | [X] SITE PLAN. [] LANDSCAPE PLAN. N/A [] TREESCAPE PLAN. N/A [] PHOTOMETRIC PLAN. N/A [X] BUILDING ELEVATIONS. |
| | Staff requires the submittal of four (4) complete plan sets and one (1) digital copy in .pdf format with a site plan application. All sheets submitted to staff shall be 24" x 36", arranged into sets, and be folded to a 9" x 12" <i>Tri-Fold</i> with the project title or identifier facing out. |
| [X] | BUILDING MATERIAL SAMPLE BOARD. See the Material Sample Board Design Guidelines in this development packet. Match existing building. |
| [X] | AFFEICATION AND ATTEICATION FEE. |
| ZONIN | G CHANGE APPLICATION SUBMITTAL REQUIREMENTS |
| [] | LEGAL DESCRIPTION. A legal description consists of written words that delineate a specific piece of real property. A legal description may be a metes and bounds description or, if the property is platted, a copy of the plat may be submitted to verify the lot and block survey system. |
| [] | ZONING EXHIBIT OR CONCEPT PLAN. A zoning exhibit is generally a survey, plat, concept plan or other visual description of the property [Specific Use Permit (SUP) exhibits can be a site plan or building elevations; check with staff for prior to submitting an application for what is appropriate]. Staff requires four (4), 24" x 36" copies and one digital copy (PDF preferred) be submitted at the time the application is submitted. All submittals should be folded individually so that the project title or identifier is facing out. In order to reduce the applicant's costs and to conserve paper, staff may accept other sheet sizes for a submittal if an appropriate scale and level of detail is maintained. Check with staff prior to submitting a small or larger drawing size. |
| [] | LETTER OF EXPLANATION. A letter from the applicant or property owner explaining the purpose of the zoning application. |
| [] | APPLICATION AND APPLICATION FEE. |
| | |

IT IS IMPORTANT TO YOU AS AN APPLICANT TO RETURN A FULLY COMPLETED APPLICATION PACKAGE. WITHOUT A COMPLETE APPLICATION SUBMITTAL, THE CASE MAY NOT BE PROCESSED AND MAY NOT BE PLACED ON A PUBLIC HEARING AGENDA.



CHECKLIST I JR SITE PLAN SUBMITTAL

City of Rockwall Planning and Zoning Department 385 S. Goliad Street Rockwall, Texas 75087

| CASE NUMBER: | REVIEWED BY: | |
|-------------------|--------------|--|
| OVERLAY DISTRICT: | REVIEW DATE: | |

1.1 GENERAL INFORMATION FOR ALL PLANS SUBMITTED

| Requirements | ✓= OK | N/A | Comments | UDC Reference |
|---|-------|-----------|--|------------------|
| Items Necessary for Site Plan Review: | | No series | | Per Application |
| ✓ Site Plan | Ø | | | |
| ✓ Landscape Plan | | X | | |
| ✓ Treescape Plan | | X | | |
| ✓ Photometric Plan | | X | | |
| ✓ Building Elevations | X | | | |
| Building Material Sample Board and/or Color Rendering of Building Elevations | | X | If required the sample board should detail all building materials, with each material clearly labeled and indicating manufacturer info, color, etc. Check with Planning Staff to see which is appropriate for the submitted project. | - |
| Submittal Requirements | K | | Four (4) large (24" x 36") <u>folded</u> copies and one (1) PDF digital copy of each plan is required at the time of submittal. | |
| Is the property properly platted? | | | Indicate if the property has been properly platted. | |
| Title Block (Project Name, Legal Description and/or Address) | [X] | | The title block is to be located in the lower right hand corner of all sheets and contain the project name, street address, and/or the lot and block designation. | |
| Case Number | DX. | | The case number should be placed in the lower right hand corner below the title block of all sheets. | • |
| Owners (Name, Address, and Phone Number) | Ø | | The owners name, address, and phone number are required to be in the lower right hand corner left of the title block. | |
| Developer (Name, Address, and Phone Number) | × | | The name, address, and phone number of the person or company that prepared the plans are required in the lower right hand corner left of the title block. | |
| North Point | Ø | | The north point or north arrow must be facing true north (or straight up) on all plans, unless the scale of the drawings or scope of the project requires a different position. | |
| Numeric and Graphic Scale | | | The recommended engineering scales are 1"=20', 1"=40', etc with a maximum of 1"=100'. | - |
| Vicinity Map | × | | The vicinity map should locate the site relative to the nearest major roadways in a one-half mile radius. | |
| Date | 又 | | The date that the plans were prepared is required on all submittals. | ili ili <u>-</u> |
| Proposed Land Use: | | | Indicate the proposed use for this site. Additionally, indicate the proposed use for all structures. | • |
| ✓ Commercial | × | | Land Uses Permitted in the RO, NS, GR, C, DT, RC & Designated Planned Development District Ordinances. | |
| ✓Industrial | | × | Land Uses Permitted in the RT, LI, HI & Designated Planned Development District Ordinances. | - |

2.1 SITE PLAN: MISCELLANEOUS A DENSITY & DIMENSIONAL INFORMATION

| Requirements | √= OK | N/A | Comments | UDC Reference |
|--|----------|-----|--|---------------|
| Total Lot or Site Area (Acreage and Square Footage) | DX. | | If the site is part of a larger tract include a key map showing the entire tract of land and the location of the site being planned. | |
| Perimeter Dimensions of the Site | (X | | Indicate the perimeter dimensions of the site in feet. | - |
| Buildings (Square Footage) | ⊠ | | Indicate the location and total square footage of all existing and planned buildings on the site. | |
| Perimeter Dimensions of all Buildings | | | Indicate the wall lengths of all buildings on the site. | - |
| Distance Between Buildings | □ □ | | Indicate the distance between all existing and planned buildings located on the site. | |
| Distance Between Buildings and Property Lines | | | Indicate the distance between all property lines and existing and planned buildings located on the site. | - |
| Indicate all Property Lines | ⊠ | | Indicate all existing property lines. If the site plan requires a platting case that will alter the property lines show the proposed changes in a different line weight. | - |
| Indicate all Building Setbacks | | | Indicate all building setbacks adjacent to right-of-way. | |
| Indicate all Easements | CX. | | Additionally, indicate all utilities both existing and proposed. | - |
| Indicate all Drive/Turning Radii | DZ. | | | _ |
| Indicate all Drive Widths | X | | | |
| Indicate all Fire Lanes | X | | Indicate and label the widths of all fire lanes existing and proposed for the site. | - |
| Indicate location of all Fire Hydrants | Ď . | | | |
| Indicate all Sidewalks | | | Indicate and label the widths of all sidewalks existing and proposed for the site. | |
| Adjacent Street Right-Of-Way | CX. | | Reference the City's Master Transportation Plan for right-of-way information. | |
| Label all Adjacent Street Name | | | Label all adjacent existing and proposed street names. | - |
| Adjacent Street Centerlines | | | Indicate the street centerline for all existing and proposed streets. | |
| Median Breaks in Adjacent Streets | DX. | | | - |

2.2 SITE PLAN: PARKING INFORMATION

| Requirements | ✓= OK | N/A | Comments | UDC Reference |
|--------------------------------------|-------|-----|--|-----------------|
| Dimension of a Typical Parking Space | DX. | | See the comment section in Adequate Parking and Maneuvering below. | |
| Parking Table | | | Provide parking table indicating the total number of required parking spaces by use, the total number of required handicapped parking spaces and the total parking provided. | |
| Handicap Parking Spaces Shown | X | | | Art. VI 5.4 |
| Adequate Parking | × | | Reference Table 3 of Article VI. | Art. VI Table 3 |
| Adequate Parking and Maneuvering | X | | All parking spaces and aisle dimensions shall conform to the off-street parking requirements in section 2.19 of the City's Standards of Design and Construction (Check w/ the Engineering Department). | Art. VI 5.3.C |
| Adequate Loading Area | | × | Loading spaces shall be a minimum of 12 feet in width, 65 feet in length, and 14 feet in height except as may otherwise be approved by the city engineer (Art. VI 6.5 Loading Requirements). | Art. VI 6.4 |
| Adequate Loading Maneuvering | | | 为是"在1861年"的。 第1888年第1888年第1888年第1888年第1888年第1888年第1888年第1888年第1888年第1888年第1888年第1888年第1888年第1888年第1888年第1888年第1888年第1888年第1 | Art. VI 6 |
| Type and Depth of Paving Material | × | | Indicate the type and depth of the paving material and provide a detail or cut-sheet. All required parking and loading areas shall be constructed of concrete, but may have a surface treatment of brick, stone or other similar material. | Art. VI 3.2 |

| 2.3 SITE PLAN: SIGNAGE | | | | |
|--|--------------------|-----------|--|----------------|
| Requirements | √= OK | N/A | Comments | UDC Reference |
| NOTE: All signage shall conform to Chapter | 32 of the Rockwa | ll Munici | oal Code of Ordinance, unless otherwise specified in ar | Overlay |
| District or Planned Development District wit | h specific signage | requiren | | |
| Proposed or Existing Signage | | | Indicate the location and type of all proposed and/or existing signage on the site plan. Additionally, provide a detail or cut-sheet showing the elevations, lighting and dimensions of the proposed signage. | |
| 2.4 SITE PLAN: SCREENING | | | | |
| Requirements | √= OK | N/A | Comments | UDC Reference |
| Indicate the Type and Location of any Existing and/or Proposed Fences | × | | Label the height and type of fence proposed or existing. All fencing shall conform to Chapter 10, Article XI of the Code of Ordinances. | |
| Utility Equipment Screening (Pad or Ground Mounted) | | Ø | Pad mounted utility equipment, and air conditioning units, shall be screened from horizontal view from any adjacent public street and from any adjacent property. Utility equipment and air conditioning units shall be screened utilizing plantings, berms, or walls matching the main structure. | Art 1/1 E 2 |
| Utility Equipment Screening (Roof Mounted) | | | All buildings must be designed such that no roof mounted mechanical equipment, HVAC, or satellite dishes shall be visible from any direction. | Art. V 1.5.3 |
| Above Ground Storage Tanks | | × | Aboveground storage tanks shall be screened utilizing plantings, berms, or walls matching the main structure. | Art. V 1.5.4 |
| Dumpster Screening | | Ø | Dumpster storage should be located to the rear of the buildings with proper access. Trash dumpster shall not be located in any required parking space and shall allow proper access by service trucks. The minimum enclosure area shall be 12'x10'. A minimum of 6" bollards will be required at potential impact zones and the pad site shall be paved to city standards. | Art. V 1.5.2 |
| Outside Storage | | □ | | |
| Off-Street Loading Dock Screening | | DX. | Off-street loading docks must be screened from all public streets and any residential district that abuts or is directly across a public street or alley from the lot. The screening must be at least six feet in height and may be provided by using a masonry fence, berms, plantings or a combination of the above. | Art. V 1.5.1 |
| Residential Adjacency Standards | × | | The director may require wing walls, landscape screens, changes in building orientation, and/or other architectural elements to minimize the impact of uses adjacent to residential property within 150 feet (also reference Art. VIII 5.2). | Art. V 1.6 |
| 3.1 LANDSCAPE PLAN | | | | |
| Requirements | ✓= OK | N/A | Comments | UDC Reference |
| Provide Site Data | | × | Provide the same site data information required in Section 2.1 Site Plan: Miscellaneous and Density and Dimensional Requirements of this checklist. | Art. VIII 4.3 |
| Impervious Area vs. Landscape/Open Space Area Provided and Required (As Per Zoning District) | _ | × | Indicate the applicable zoning district the percentage of landscaping required and provided, and the impervious area vs. the amount of landscaping and open spaces required and provided. | Art. VIII 5.12 |
| Landscape Table | | Ż | Provide a landscape table showing plant materials, quantities, size and spacing for existing and proposed landscaping. Complete description of plant materials shown on the plan, including names, locations, qualities, container or caliper sizes at installation, heights, spread, and spacing requirements should also be listed on the | Art. VIII 4.3 |

plan.

| | | | Provide the same site data information required in | |
|---|-------|----------|---|-----------------|
| 4.1 TREESCAPE PLAN Requirements | √= OK | N/A | Comments | UDC Reference |
| Irrigation Requirements Note | | | of UDC. | Art. VIII 5.5 |
| Tree Locations | | X | Trees must be planted at least five feet from water, sewer and storm sewer lines. Provide note indicating irrigation will meet requirements | Art. VIII 4.3 |
| Street Trees | | × | Large trees (a species which normally reaches a height of 30 feet or more upon maturity) shall be provided in the required street landscape buffer in numbers equal to one (1) tree for every 50 feet of street frontage. | Art. VIII 5.7 |
| Identify Visibility Triangles | | | Identify visibility triangles on all lots for all driveway intersections and public streets. | |
| Location of all Site Amenities | _ | | Identify the size, height, location, and material of proposed seating, lighting, planter's sculptures, water features and landscape paving and other public amenities. | Art. VIII 4.3 |
| Parking Lot Landscaping | | Œ | Complete description of landscaping and screening to be provided in or near off-street parking and loading areas, including the information as to the amount (in sq. ft.) of landscape area to be provided internal to parking areas, the total square included in the parking area, and the number and location of required off-street parking and loading spaces. | Art. VIII 5.9 |
| Protected Trees (To Remain On Site) | | À | Indicate the location and provide a description by type and size of all existing protected trees (4" or larger) proposed to be retained. Such trees shall be marked and a drip line of said tress shall be protected prior to and during all construction, including dirt work. | Art. IX 3 |
| ✓ Trees not allowed in Landscape Buffers | | Ø | Silver Maple, Box Elder, Mimosa, Catalpa, Hackberry, Sugarberry, Honey Locust, Tulip Tree, Chinaberry, Sycamore, Cottonwood, Willows, American Elm, Siberian Elm, Jerusalem Thorn/Petuma, Bois D'Arc, Flowering Crabapple Tree, Ginko Tree, Peach/Plum, Mulberry, Texas Mountain Laurel, Lilac Chaste Tree, and Pine Tree. | Art. VIII 5.3.F |
| ✓ Trees allowed in Street Landscape Buffers | 0 | M | Cedar Elm, Texas Red Oak, Homestead Elm, Lace Bark Elm, Bald Cypress, Chinese Pistachio, October Glory Maple, Pecan, Texas Ash, Live Oak, Chinquapin Oak, and Burr Oak (Understory Trees: Texas Redbud, Mexican Plum, Downy Hawthorn, Wax Myrtle, Yaupon, and Deciduous Yaupon) | Art. VIII 5.3.E |
| Acceptable Landscape Materials: | | | landscape buffers. | Art. VIII 5.3 |
| Indicate all Landscape Buffers | | × | Indicate the locations and dimensions of the required | Art. VIII 5.1 |
| Location of Water Courses and Significant Drainage Features | | × | Indicate the locations of all existing and/or proposed water courses and the location of any existing and/or proposed significant drainage features. | |
| Indicate all Landscaping | | | Indicate the location of all existing and proposed landscaping. | |

| Requirements | ✓= OK | N/A | Comments | UDC Reference |
|--|-------|-----|---|---------------|
| Provide Site Data | | DX. | Provide the same site data information required in Section 2.1 Site Plan: Miscellaneous and Density and Dimensional Requirements of this checklist. | |
| Buildings | | X | Indicate the location of all existing or proposed structures, and/or the building pads as shown on the grading plan. | |
| Indicate all Site Elevations, Grades, Major Contours and the Limits of Construction | | × | | Art. IX 3 |
| Protected Trees (To Remain On Site) | | X | Indicate the location and provide a description by type and size of all existing protected trees (4" or larger) proposed to be retained. Such trees shall be marked and a drip line of said tress shall be protected prior to and during all construction, including dirt work. | Art. IX 3 |

| Protected Trees (To be Removed from the Site) | | | Indicate the location fall protected trees (4" or larger) that are to be remover from the site and the proposed locations of all replacement trees. | Art. IX 3 |
|---|---------------|-----------|--|------------------|
| Treescape Table | | | Provide a table showing the total inches of trees to be removed and the total inches of trees to be replaced. | Art. IX 3 |
| 5.1 PHOTOMETRIC AND LIGHTING PLA | NS | | | |
| Requirements | √= OK | N/A | Comments | UDC Reference |
| Provide Site Data | | × | Provide the same site data information required in Section 2.1 Site Plan: Miscellaneous and Density and Dimensional Requirements of this checklist. | |
| Indicate Lighting Levels (in Foot Candles [FC]) | | × | Show lighting levels in foot-candles (FC) measured throughout the site and extended to all property lines of the subject property. | Art. VII 3.4 |
| Adjacent Property with Common Lot Lines: | | | | Art. VII 3.3 |
| ✓ Residential Use | | X | The allowable maximum light intensity measured at the property line of a residential property shall be 0.2 of one foot candle. | Art. VII 3.3.B |
| ✓ Commercial Use | | × | The allowable maximum light intensity measured at the property line of a non-residential property shall be 0.2 of one foot candle. Subject to requirements in Art. VII 3.3.C. | Art. VII 3.3.C |
| Under-Canopy Lighting | | | Under canopy lighting (i.e. fuel stations, drive through lanes and covered parking structures) shall not exceed 0.35 of one foot candle (with the exception below). | Art. VII 3.3.G.1 |
| Lighting for Motor Vehicle Dealerships | | | Shall not exceed 0.3 of one foot candle within the front yard of the development. The remainder will comply with the 0.2 of one foot candle. | Art. VII 3.3.G.2 |
| Lighting in Parking Areas | | | Parking areas are not to exceed a maintained average of 1.5 foot candles at ground level, and shall distribute not more than 0.2 of one foot candle of light upon any adjacent property. | Art. VI 3.4.A |
| Indicate all Exterior Lighting | | | Indicate the location and type of all exterior lighting, including pole mounted, wall-mounted, signage, etc. | |
| Indicate the Mounting Height for all Proposed Light Fixtures | | × | No light pole, base or combination thereof shall exceed 30 feet, unless further restricted within an Overlay District. | Art. VII 3.3.D |
| Indicate the Wattage of all Light Sources | | × | | |
| Proposed Light Fixtures | | × | Provide elevation drawings and/or cut-sheets of proposed light fixtures on/with photometric plan. | - |
| 6.1 BUILDING ELEVATIONS: NON-INDU | ISTRIAL | | | |
| Requirements | √= OK | N/A | Comments | UDC Reference |
| NOTE: Specific Zoning and Overlay Districts may | have addition | al design | | |
| Provide Exterior Elevations | Ď | | North South East West (Circle all that apply) | - |
| Indicate Exterior Elevations Adjacent to Public Right-of-Way | X | | North South East West (Circle all that apply) | |
| 90% Masonry Requirement | \ | | For Buildings less than 25,000 Sq. Ft.: Exterior walls should consist of 90% masonry materials excluding doors and windows. For Buildings greater than 25,000 Sq. Ft.: 90% of exterior walls shall consist of brick, stone, split faced CMU, plaster, stucco or a combination of. | |
| Indicate Amount and Location of the 20% (of the 90%) Stone Requirement. | × | | Applies to \underline{f} acades that are visible from a public right-ofway and/or open space. | Art. 4.1.A.1 |
| Indicate the Surface Area of Each Facade | × | | Indicate the surface area (square feet) of each façade and the percentage and square footage of each material used on that façade. | - |
| Proposed Building Materials | □ □ | | Specifications and description of all proposed building materials, on all proposed buildings. | - |
| Indicate the Roofing Materials and Color | × | | moteriors, on an proposed buildings. | - |

| Indicate Parapet Wall Height (If Applicable) | Ņ | | If applicable indicate apparapet wall by dashing in the top of roof deck. | |
|---|--|----------------|---|------------------|
| Indicate all Roof Mounted Mechanical Equipment (If Applicable) | × | | If applicable indicate any proposed roof mounted mechanical equipment and indicate how these will be screened from view. | |
| Indicate Any Additional Design Elements Proposed (If Applicable) | | | Indicate any additional design elements for the base, walls, or parapets (such as cornice, arcades, and covered walkways/windows). Be sure to include the location, size, color, and material of any proposed structure. | |
| Indicate Building Height(s) [H] | ă | | The height of the building shall be measured from the average elevation of the finished grade along the front of the building to the highest point of the roof or parapet of the building if it is a flat, mansard or shed roof; or to the midpoint of the roof if it is gable, hip or gambrel roof. | Art. V 4.1.B.1 |
| Minimum Standards for Articulation: | | | | |
| Horizontal Articulation of Façades: Projecting Offset = 25% x (H) [Min. 5 Ft.] Length of Offset = 25% x (L) [Min. 15 Ft.] Distance Between* (L) = 3 x (H) [Max. 60 Ft.] | ⊠ | | should occur every feet* in between an offset that projects out from the wall at = (H) x 25% = The length of the offset is = (L) x 25% = (* Minimum distance between projections is 60') | Art. V 4.1.C.1.a |
| Vertical Articulation of Façades: Height Extension = 25% x (H) [Min. 5 Ft.] Length of Extension = 25% x (L) [Min. 15 Ft.] Distance Between* (L) = 3 x (H) [Max. 60 Ft.] | | | should occur every feet in between the offset that extends above roof parapet at = (H) x 25% = The length of the height extension is = (L) x 25% = (* Minimum distance between extensions is 60') | Art. V 4.1.C.1.b |
| | | | (Millimum distance between extensions is 60') | |
| 6.2 BUILDING ELEVATIONS: INDUSTRIA | NL | | | |
| Requirements | √= OK | N/A | Comments | UDC Reference |
| | | | | |
| NOTE: Industrial buildings are subject to all the the following standards. | elements listed | in Section | on 6.1 Building Elevations: Non-Industrial with the exc | eption of |
| the following standards. Minimum Standards for Articulation: | elements listed | in Section | on 6.1 Building Elevations: Non-Industrial with the exce | eption of |
| the following standards. | elements listed | in Section | should occur every feet* in between an offset that projects out from the wall at = (H) x 25% = The length of the offset is = (L) x 25% = | Art. V 5.C.1.a |
| the following standards. Minimum Standards for Articulation: Horizontal Articulation of Façades: Projecting Offset = 25% x (H) [Min. 5 Ft.] Length of Offset = 25% x (L) [Min. 20 Ft.] | | | should occur every feet* in between an offset that projects out from the wall at = (H) x 25% = | |
| the following standards. Minimum Standards for Articulation: Horizontal Articulation of Façades: Projecting Offset = 25% x (H) [Min. 5 Ft.] Length of Offset = 25% x (L) [Min. 20 Ft.] Distance Between* (L) = 4 x (H) [Max. 80 Ft.] Vertical Articulation of Façades: Height Extension = 25% x (H) [Min. 5 Ft.] Length of Extension = 25% x (L) [Min. 20 Ft.] | | Ø | should occur every feet* in between an offset that projects out from the wall at = (H) x 25% = The length of the offset is = (L) x 25% = (* Minimum distance between projections is 80')should occur every feet in between the offset that extends above roof parapet at = (H) x 25% = The length of the height extension is = (L) x 25% = | Art. V 5.C.1.a |
| the following standards. Minimum Standards for Articulation: Horizontal Articulation of Façades: Projecting Offset = 25% x (H) [Min. 5 Ft.] Length of Offset = 25% x (L) [Min. 20 Ft.] Distance Between* (L) = 4 x (H) [Max. 80 Ft.] Vertical Articulation of Façades: Height Extension = 25% x (H) [Min. 5 Ft.] Length of Extension = 25% x (L) [Min. 20 Ft.] Distance Between* (L) = 4 x (H) [Max. 80 Ft.] | e Plan crict or a Planne opment District | ⊠ ed Develo | should occur every feet* in between an offset that projects out from the wall at = (H) x 25% = The length of the offset is = (L) x 25% = (* Minimum distance between projections is 80')should occur every feet in between the offset that extends above roof parapet at = (H) x 25% = The length of the height extension is = (L) x 25% = (* Minimum distance between extensions is 80') | Art. V 5.C.1.a |

| Planning & Zoning Work Session (Packet Due/): |
|---|
| Date:/ |
| |
| |
| |
| DRC Meeting |
| Date:// |
| |
| ARB Meeting Date: / / |
| Sale// |
| Planning and Zoning Meeting (Packet Due/): |
| Date://. 1 st 2 nd |
| 2 nd |
| Vote: For, Against; Abstaining, Absent (). |
| City Council Meeting (Packet Due/): |
| Date:// |
| Date:/ |
| Vote: For, Against; Abstaining, Absent (). |
| vote ror, Against, Abstaining, Absent (). |
| |
| GENERAL NOTES: |
| GENERAL NOTES. |
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DEVELOPMENT REVIEW COMMITTEE (DRC) CITY OF ROCKWALL, PLANNING & ZONING DEPARTMENT

Phone: (972) 771-7745

Email: Planning@Rockwall.com

External Review:

Wayne Carter, Charter Communications
Jim Friske, Charter Communications

Dinah Wood, Atmos Randy Voight, Oncor Phillip Dickerson, Oncor Brian Duncan, AT&T Javier Fernandez, RISD Brenda Callaway, TXDOT

Stephen Geiger, Farmer's Electric Frank Spataro, Farmer's Electric

Internal Review:

Amy Williams, Engineering

John Shannon, Building Inspections

Ariana Hargrove, Fire Andy Hesser, Parks Andy Villarreal, Police

From: Planning & Zoning Department

Date: 12/13/2019

To assist the Planning Department in evaluating the attached request, we are sending it to you for your review and comments. Please return any comments and/or plan mark-ups to us within five (5) days. Internal staff will also be required to have all comments input into CRW no later than Friday, 12/13/2019. Planning staff will assemble all comments received in time for our regularly scheduled DRC meeting on at 2:00 p.m. The Planning and Zoning Commission work session will be held on 12/19/2019 at 6:00 p.m. You are welcome to attend both meetings. If you have any questions, please contact us at (972) 771-7745.

Project Number:

SP2019-048

Project Name:

2885 MARKET CENTER DRIVE

Project Type:

SITE PLAN

Applicant Name:

MARIA BONILLA

Owner Name:

JILL FISHER

Project Description:



RECEIPT

Project Number: SP2019-048

Job Address: I30 ROCKWALL, TX 75032

Receipt Number: B87700
Printed: 12/18/2019 11:58 am

Fee Description Account Number Fee Amount

SITE PLANNING

01-4280 \$100.00

Total Fees Paid:
Date Paid: 12/18/2019 12:00:00AM

Paid By: MARIA BONILLA

Pay Method: CHECK 5309

Received By: AG

\$100.00



DEVELOPMENT APPLICATION

City of Rockwall Planning and Zoning Department 385 S. Goliad Street Rockwall, Texas 75087

| STAFF USE ONLY | 3 |
|----------------|---|
|----------------|---|

PLANNING & ZONING CASE NO.

· SP2019-048

NOTE: THE APPLICATION IS NOT CONSIDERED ACCEPTED BY THE CITY UNTIL THE PLANNING DIRECTOR AND CITY ENGINEER HAVE SIGNED BELOW.

DIRECTOR OF PLANNING:

CITY ENGINEER:

| Please check the | appropriate box below to indicate the ty | pe of development request | [SELECT ONLY ONF BOX]: | | |
|--|--|--|--|--|--|
| Please check the appropriate box below to indicate the type of developments of type of | | Zoning Appl [] Zoning C [] Specific [] PD Deve Other Applic [] Tree Ren [] Variance Notes: 1: In determini | Zoning Application Fees: [] Zoning Change (\$200.00 + \$15.00 Acre) ¹ [] Specific Use Permit (\$200.00 + \$15.00 Acre) ¹ [] PD Development Plans (\$200.00 + \$15.00 Acre) ¹ Other Application Fees: [] Tree Removal (\$75.00) [] Variance Request (\$100.00) | | |
| PROPERTY INF | ORMATION [PLEASE PRINT] | | | | |
| Addres | 2885 Market Center Dr., Rockwa | all, TX 75032 | | | |
| Subdivision | R W MARKETCENTER ADDITION | NC | Lot 1A Block B | | |
| General Location | NWC W Ralph Hall Parkway and | d Market Center Drive | | | |
| | PLAN AND PLATTING INFORMAT | | | | |
| | Commercial (C) District | | e RETAIL | | |
| | Commercial (C) District | | | | |
| | | Proposed Use | | | |
| Acreage | e 21.440 Lots | [Current] 1 | Lots [Proposed] 1 | | |
| [X] <u>SITE PLANS AN</u> process, and fair | D PLATS: By checking this box you acknowledge ure to address any of staff's comments by the da | that due to the passage of <u>HB31</u> te provided on the Development C | 167 the City no longer has flexibility with regard to its approval alendar will result in the denial of your case. | | |
| OWNER/APPLI | CANT/AGENT INFORMATION [PLE | ASE PRINT/CHECK THE PRIMARY | CONTACT/ORIGINAL SIGNATURES ARE REQUIRED] | | |
| [x] Owner | Dunhill Partners, Inc. | [X] Applicant | Winkelmann & Associates, Inc. | | |
| Contact Person | Jill Fisher | Contact Person | Maria Bonilla | | |
| Address | 3100 Monticello Avenue, SUite 30 | OO Address | 6750 Hillcrest Plaza Drive Suite 215 | | |
| City, State & Zip | Dallas, TX 75205 | City, State & Zip | Dallas, TX 75230 | | |
| Phone | +1 (214) 261-9588 | Phone | +1 (972) 490-7090 | | |
| | jfisher@dunhillpartners.com | E-Mail | mbonilla@winkelmann.com | | |
| defore me, the undersing this application to be training the training that I are the cost of this application the City of Rockwall the | iii (i.e. City) is authorized and permitted to nro | of the submitted herein is a this the day of DR with his information contained with in the submitted herein is a submitted herein is a submitted herein in the submitted herein in the submitted herein is a submitted herein in the submitted herein in the submitted herein is a submitted herein in the submitted herein is a submitted herein in the submitted herein is a submitted herein in the submitted herein is a submitted herein in the submitted herein in the submitted herein is a submitted herein in the submitted herein in the submitted herein in the submitted herein is a submitted herein in the sub | true and correct; and the application fee of \$ 100.000, to | | |
| nformation." | uny copyrighted information submitted in conjun | ection with this application, if such | reproduction is associated or in response to a request for public | | |


DEVELOPMENT APPLICATION • CITY OF RO

Notary Public in and for the State of Texas

RICHARD JOSEPH LEE

X 75087 • [P] (972) 771-7745 • [F] (972) 771-7727

My Commission Expires

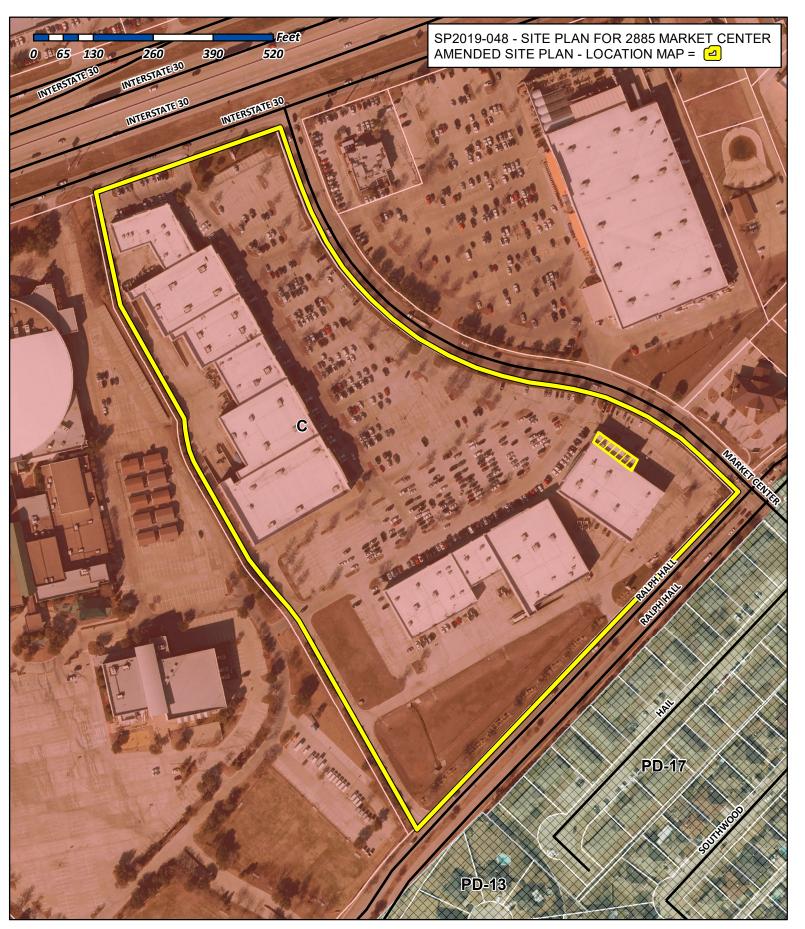






City of Rockwall

Planning & Zoning Department 385 S. Goliad Street Rockwall, Texas 75032 (P): (972) 771-7745 (W): www.rockwall.com The City of Rockwall GIS maps are continually under development and therefore subject to change without notice. While we endeavor to provide timely and accurate information, we make no guarantees. The City of Rockwall makes no warranty, express or implied, including warranties of merchantability and fitness for a particular purpose. Use of the information is the sole responsibility of the user.



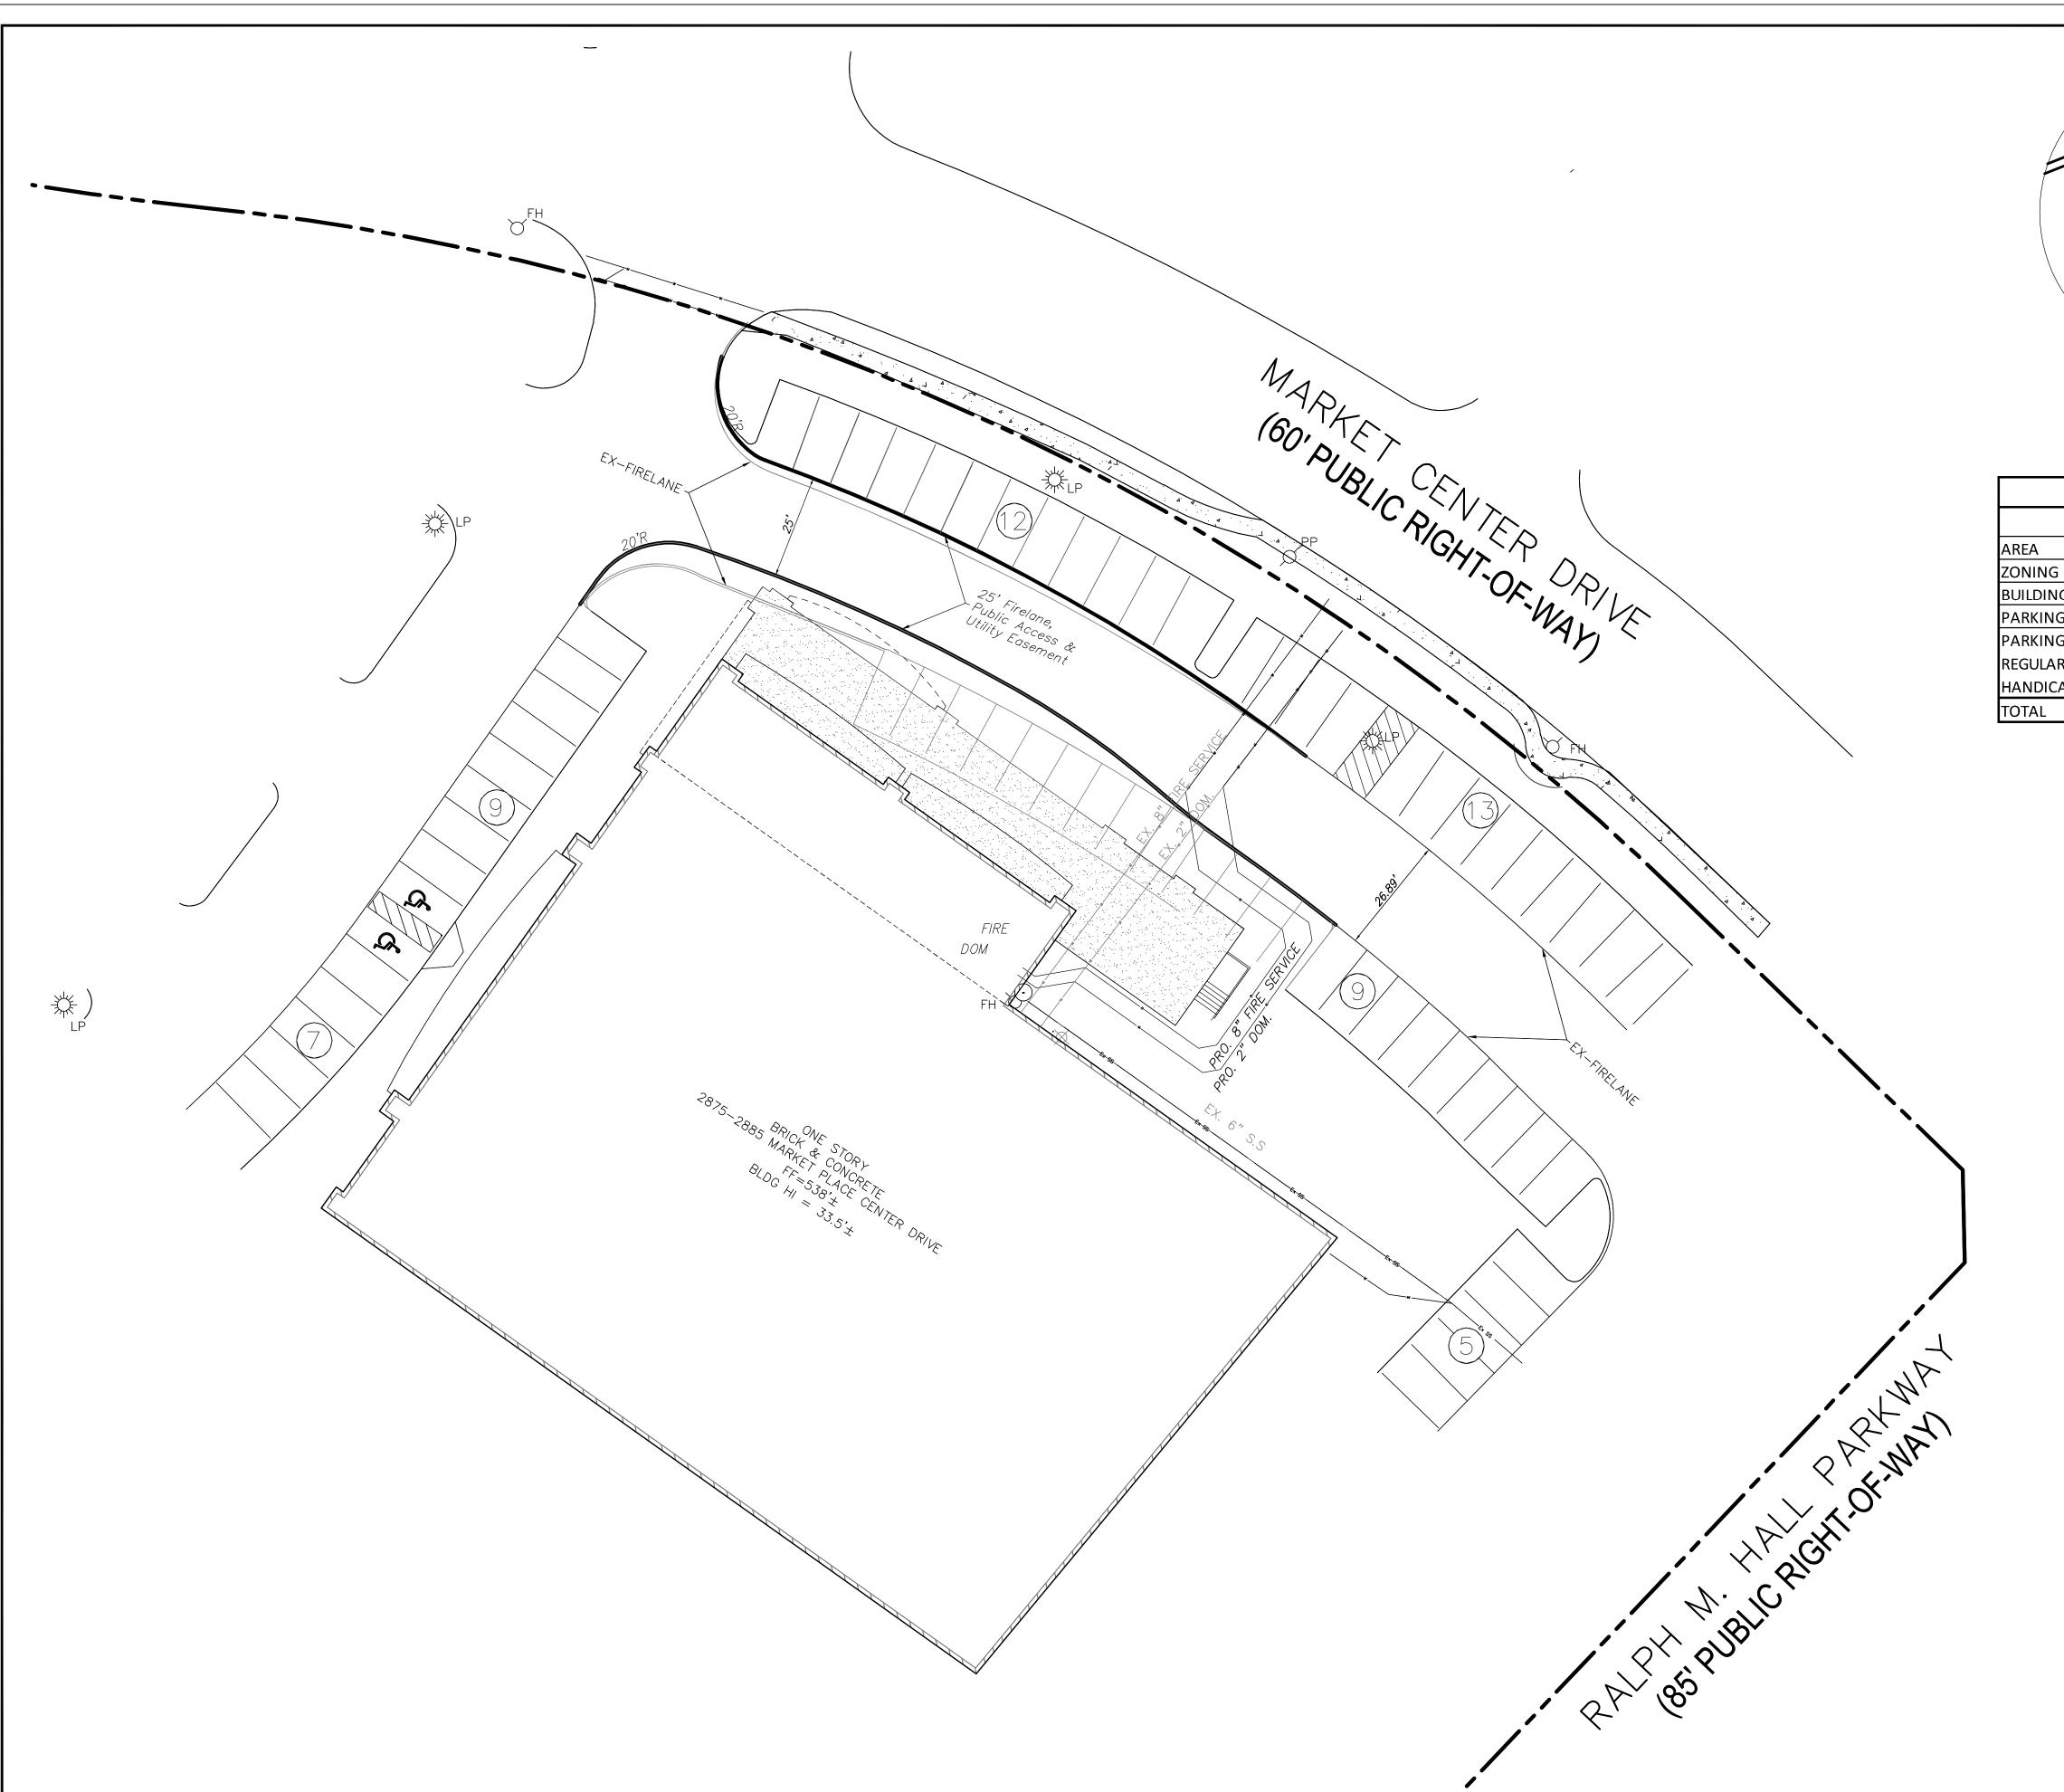

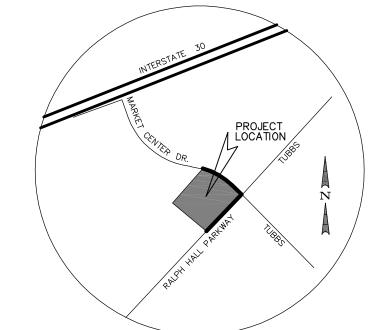

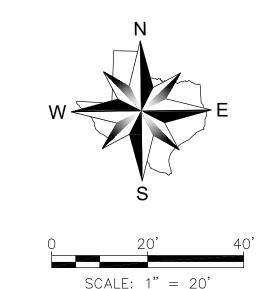

| /ICINITY MAP |) |
|--------------|---|
| NOT TO SCALE | |

| SITE DATA TABLE | | | | | |
|-------------------------------|--------------|----------------|--------------|----------------|--|
| | Exis | sting | Prop | osed | |
| AREA | 934,236 S.F. | 21.44 ACRES | 934,236 S.F. | 21.44 ACRES | |
| ZONING | с (сомі | C (COMMERCIAL) | | C (COMMERCIAL) | |
| BUILDINGS AREA (S.F.) | 2, | 2,547 | | 3,014 | |
| PARKING REQUIRED (1/200 S.F.) | 13 | | 15 | | |
| PARKING PROVIDED: | | | I | | |
| REGULAR (9'×18') | 1015 | | 1001 | | |
| HANDICAP(1 VAN) | 2 | 26 | | 26 | |
| TOTAL | 1041 | | 10 |)27 | |

| | - | $\digamma \! \! \! \! \! \! \! \! \! \! \! \! \! \! \! \! \! \! \!$ | |
|---------------------------------------|--------|---|---|
| , , , , , , , , , , , , , , , , , , , | _/_/ | $-\Lambda$ | " |
| | _ (7/ | — / V | |

| | PROPOSED BUILDING EXPANSIO |
|----|----------------------------|
| PP | POWER POLE |

LP LIGHT POLE


FH FIRE HYDRANT

12-09-2019

BATH & BODY WORKS EXPANSION 2885 MARKET CENTER DRIVE ROCKWALL, TX 75032

C-03.00


SP2018-034

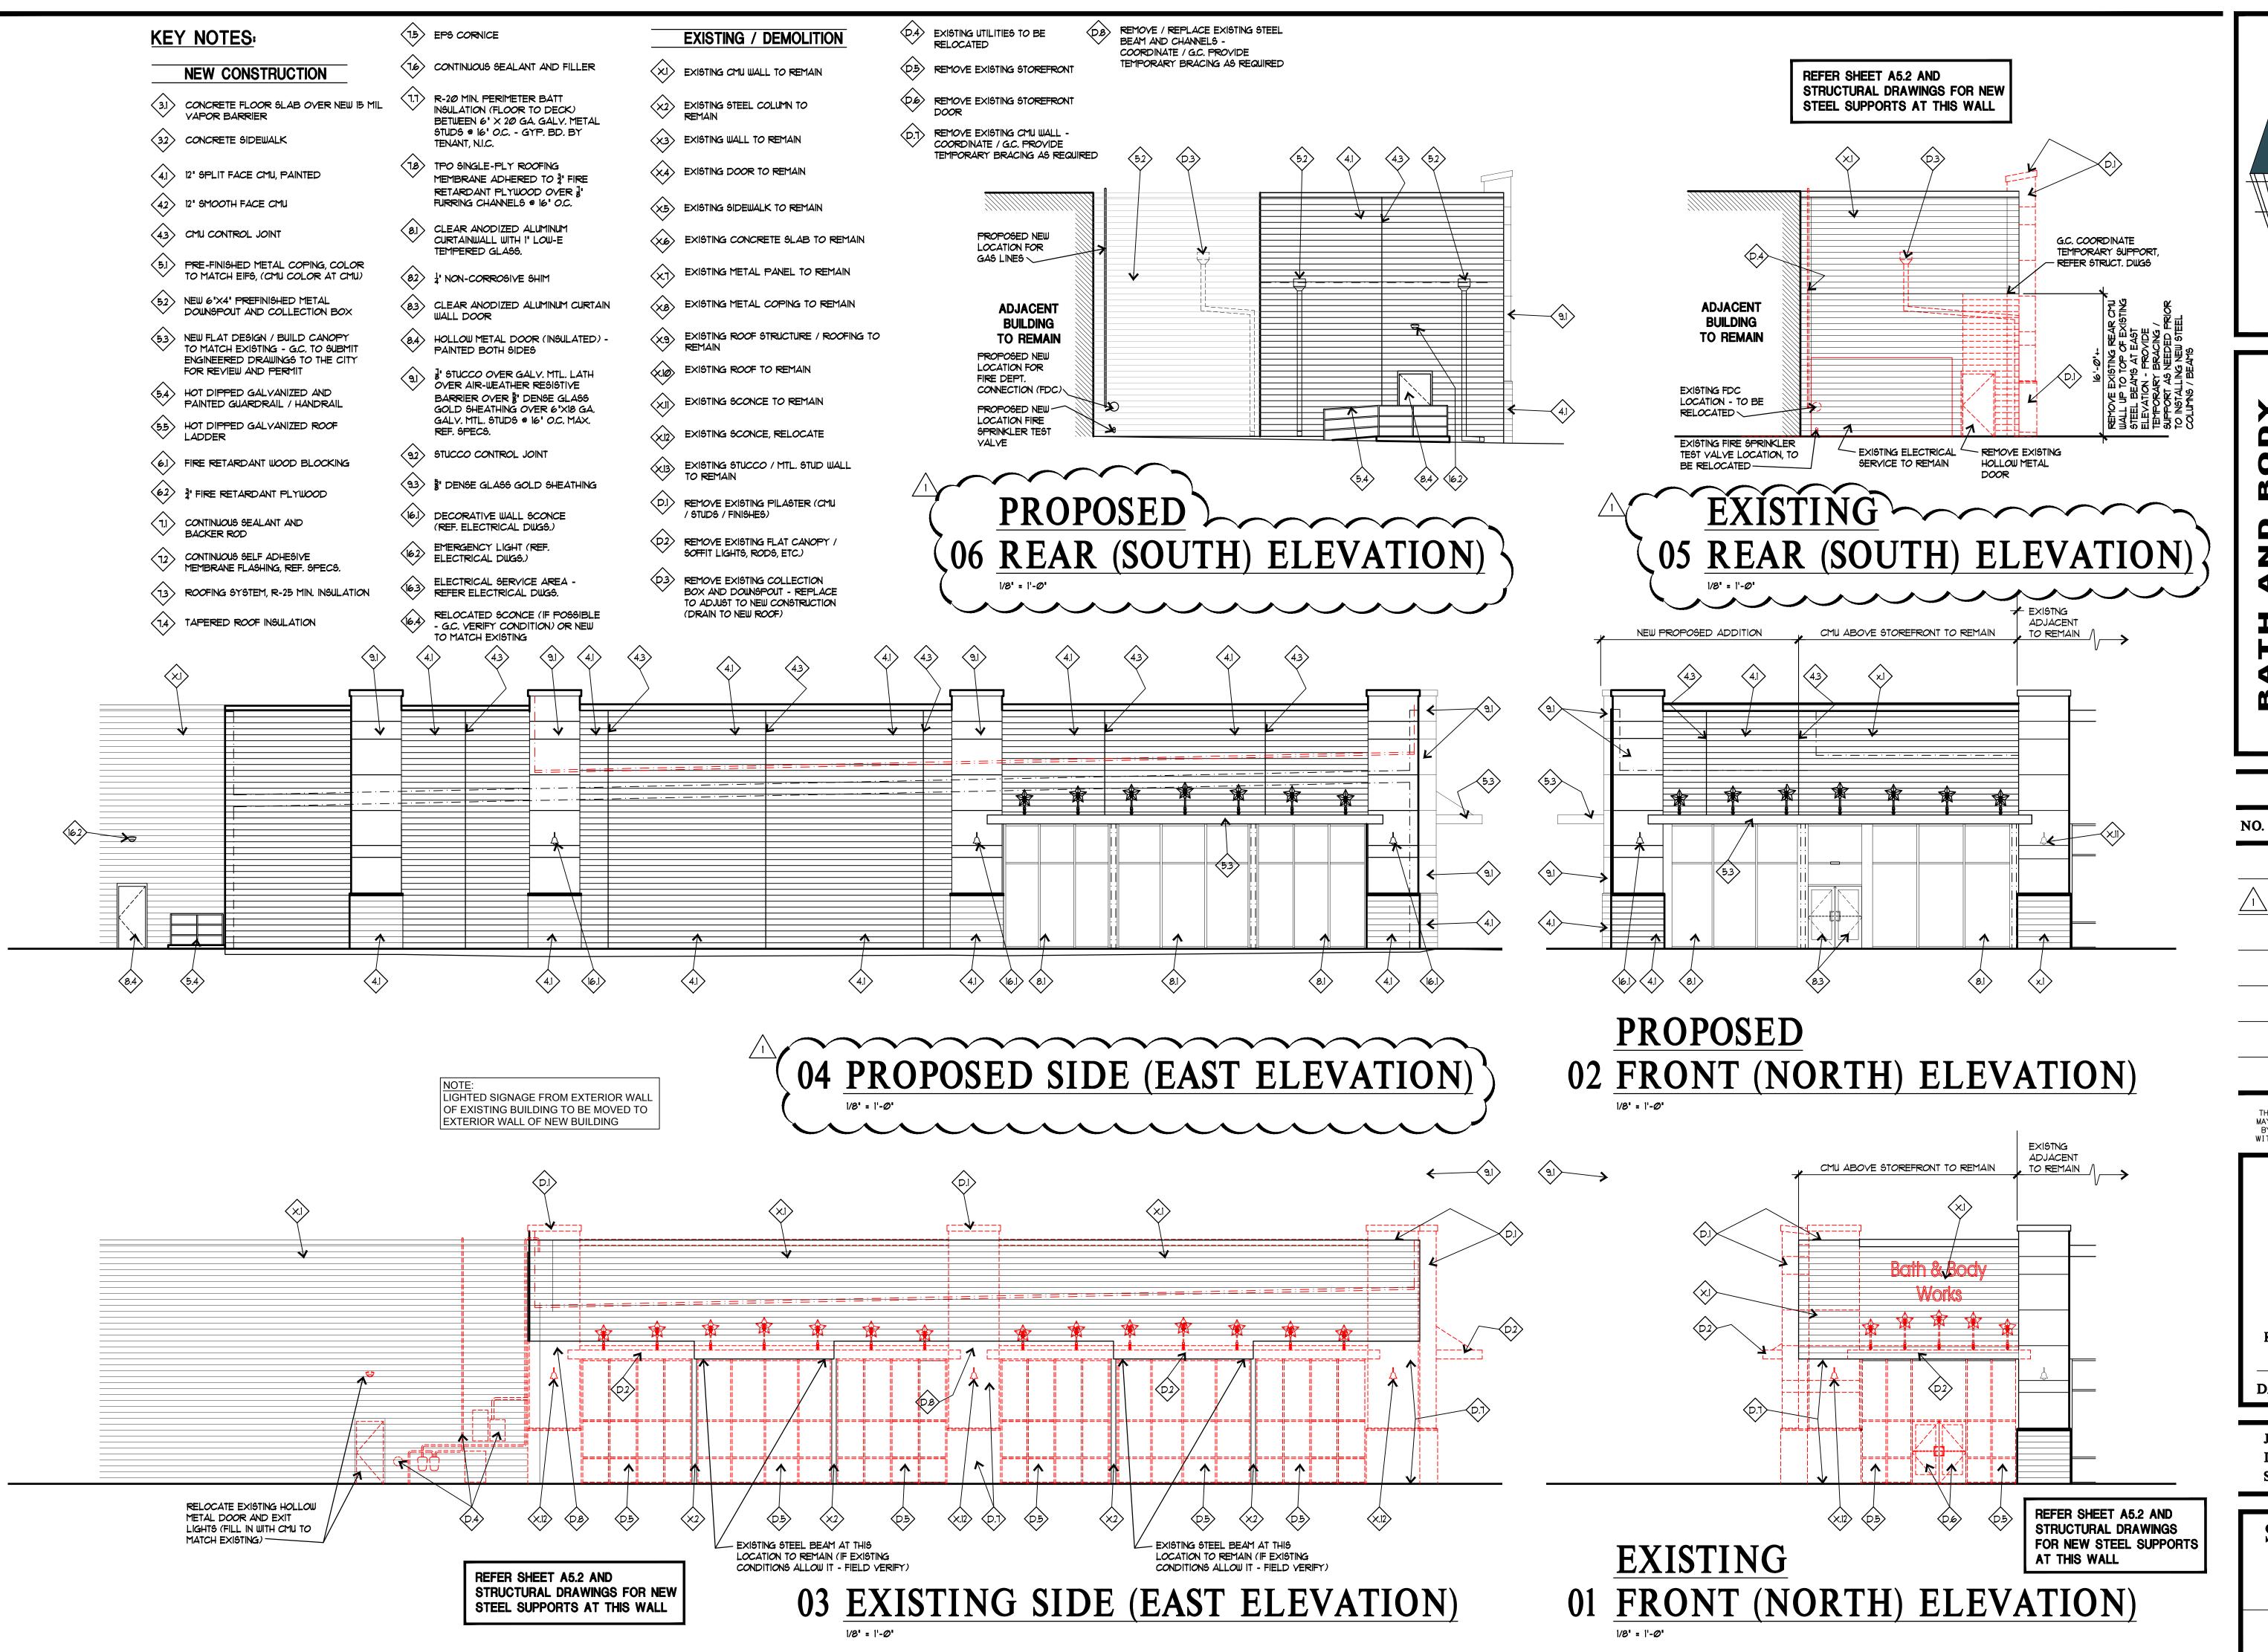

ISSUE LOG

DESCRIPTION DATE ISSUED FOR BID AND PERMIT ASI NO. 2 (RE-ISSUE FOR BID & PERMIT)


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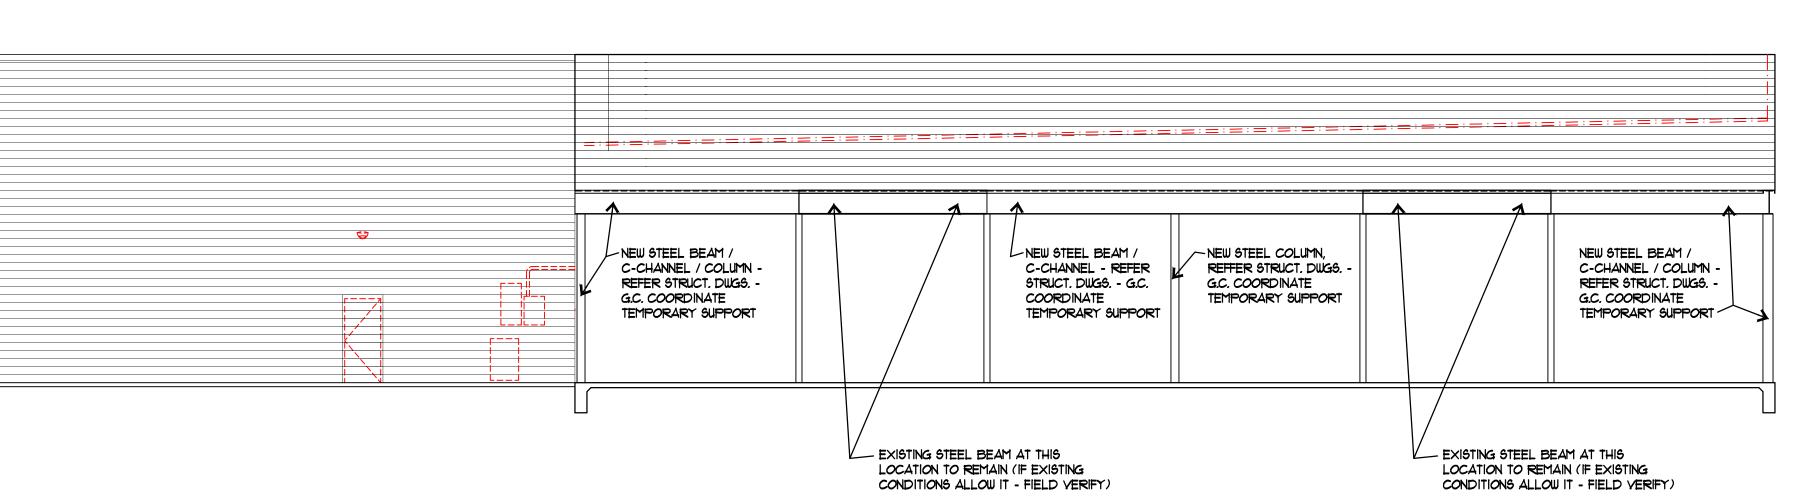
JOB NO.: 18-058 **DATE:** 3/5/19 SCALE: AS NOTED

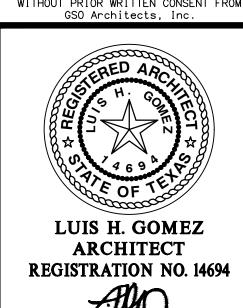SHEET NO.

ELEVATIONS



04 PROPOSED SIDE (WEST ELEVATION)

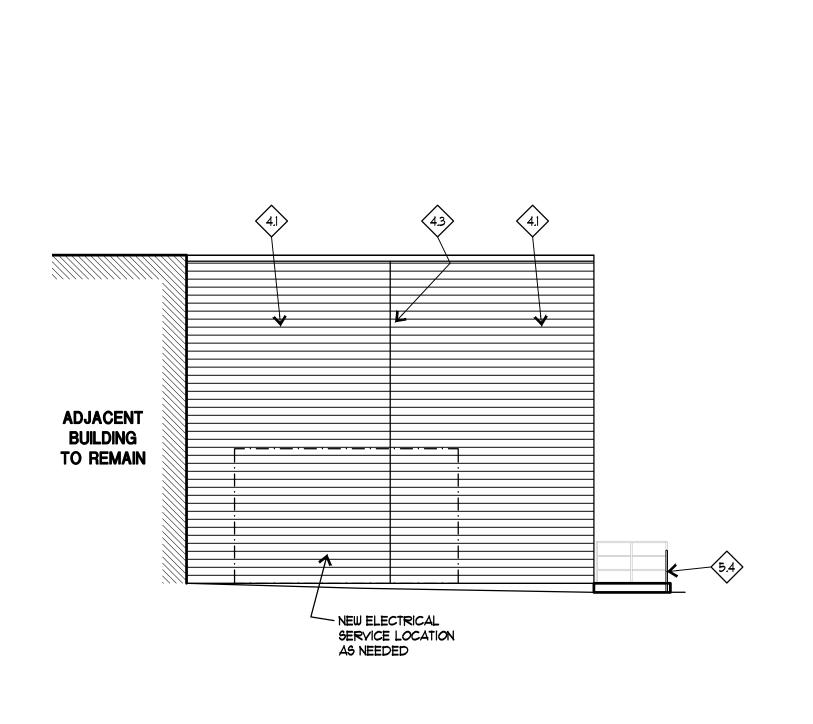

02 EXISTING WITH NEW STEEL SIDE (EAST ELEVATION)

KEY NOTES:

NEW CONSTRUCTION

- 3.1 CONCRETE FLOOR SLAB OVER NEW 15 MIL
- (32) CONCRETE SIDEWALK
- (4.1) 12" SPLIT FACE CMU, PAINTED
- (42) 12" SMOOTH FACE CMU
- (4.3) CMU CONTROL JOINT
- 5.1) PRE-FINISHED METAL COPING, COLOR
 TO MATCH FIES (CMIL COLOR AT CMIL) TO MATCH EIFS, (CMU COLOR AT CMU)
- 52 NEW 6'X4' PREFINISHED METAL
 DOWNSPOUT AND COLLECTION B DOWNSPOUT AND COLLECTION BOX
- 5.3 NEW FLAT DESIGN / BUILD CANOPY
 TO MATCH EXISTING GC TO SUBMI TO MATCH EXISTING - G.C. TO SUBMIT ENGINEERED DRAWINGS TO THE CITY FOR REVIEW AND PERMIT
- 5.4 HOT DIPPED GALVANIZED AND PAINTED GUARDRAIL / HANDRAIL
- HOT DIPPED GALVANIZED ROOF LADDER
- (6.1) FIRE RETARDANT WOOD BLOCKING
- (62) 3 FIRE RETARDANT PLYWOOD
- (1.1) CONTINUOUS SEALANT AND BACKER ROD
- CONTINUOUS SELF ADHESIVE MEMBRANE FLASHING, REF. SPECS.
- ROOFING SYSTEM, R-25 MIN. INSULATION
- (1.4) TAPERED ROOF INSULATION
- (1.5) EPS CORNICE

(16) CONTINUOUS SEALANT AND FILLER

1.1) R-20 MIN. PERIMETER BATT INSULATION (FLOOR TO DECK) BETWEEN 6" × 20 GA. GALY. METAL


- STUDS @ 16' O.C. GYP. BD. BY TENANT, N.I.C. (1.8) TPO SINGLE-PLY ROOFING
- MEMBRANE ADHERED TO 3" FIRE RETARDANT PLYWOOD OVER 3" FURRING CHANNELS @ 16" O.C.
- (8.1) CLEAR ANODIZED ALUMINUM CURTAINWALL WITH 1' LOW-E
- (82) ¼" NON-CORROSIVE SHIM

TEMPERED GLASS.


- 83 CLEAR ANODIZED ALUMINUM CURTAIN WALL DOOR
- (8.4) HOLLOW METAL DOOR (INSULATED) PAINTED BOTH SIDES
- 9.1 STUCCO OVER GALV. MTL. LATH OVER AIR-WEATHER REGISTION BARRIER OVER & DENSE GLASS GOLD SHEATHING OVER 6'XIS GA. GALY. MTL. STUDS @ 16' O.C. MAX. REF. SPECS.
- (92) STUCCO CONTROL JOINT
- (9.3) § DENSE GLASS GOLD SHEATHING
- (16.1) DECORATIVE WALL SCONCE (REF. ELECTRICAL DWGS.)
- EMERGENCY LIGHT (REF. ELECTRICAL DWGS.)
- ELECTRICAL SERVICE AREA -REFER ELECTRICAL DWGS.
- RELOCATED SCONCE (IF POSSIBLE - G.C. VERIFY CONDITION) OR NEW TO MATCH EXISTING

EXISTING / DEMOLITION

- (XI) EXISTING CMU WALL TO REMAIN
- EXISTING STEEL COLUMN TO
- (x3) EXISTING WALL TO REMAIN (X4) EXISTING DOOR TO REMAIN
- (X5) EXISTING SIDEWALK TO REMAIN
- (X6) EXISTING CONCRETE SLAB TO REMAIN
- EXISTING METAL PANEL TO REMAIN
- EXISTING METAL COPING TO REMAIN
- EXISTING ROOF STRUCTURE / ROOFING TO REMAIN
- EXISTING ROOF TO REMAIN
- (XII) EXISTING SCONCE TO REMAIN
- EXISTING SCONCE, RELOCATE
- EXISTING STUCCO / MTL. STUD WALL TO REMAIN TO REMAIN
- D.I REMOVE EXISTING PILASTER (CMU / STUDS / FINISHES)
- D2 REMOVE EXISTING FLAT CANOPY / SOFFIT LIGHTS, RODS, ETC.)
- REMOVE EXISTING COLLECTION BOX AND DOWNSPOUT - REPLACE TO ADJUST TO NEW CONSTRUCTION (DRAIN TO NEW ROOF)

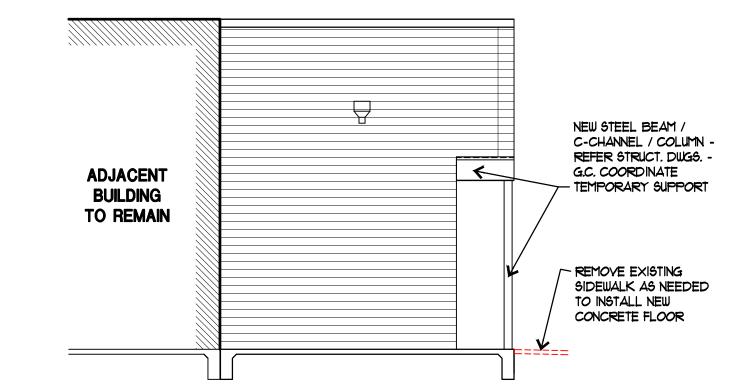


EXISTING WITH NEW STEEL (03 REAR (SOUTH) ELEVATION)

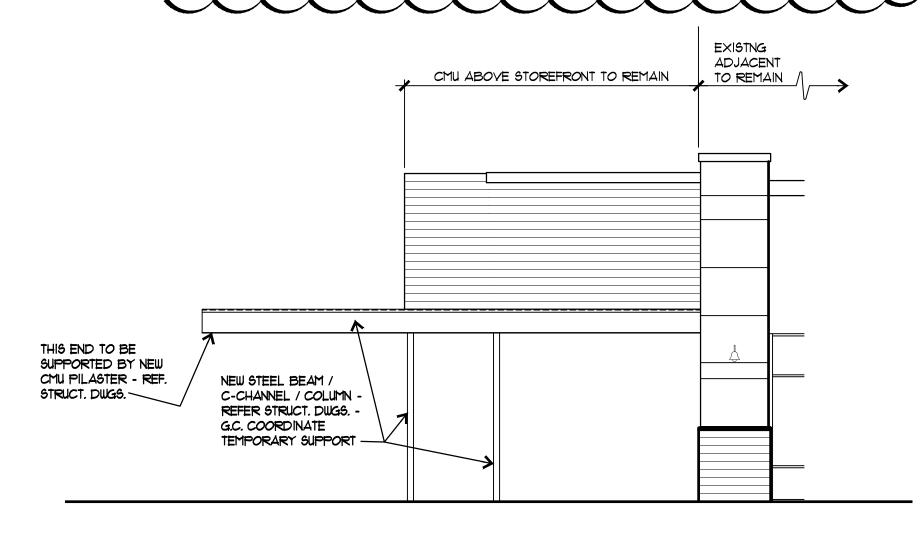

EXISTING (WITH NEW STEEL) 01 FRONT (NORTH) ELEVATION)

ISSUE LOG DESCRIPTION DATE ISSUED FOR BID AND PERMIT ASI NO. 2 (RE-ISSUE TOR BID & PERMIT)


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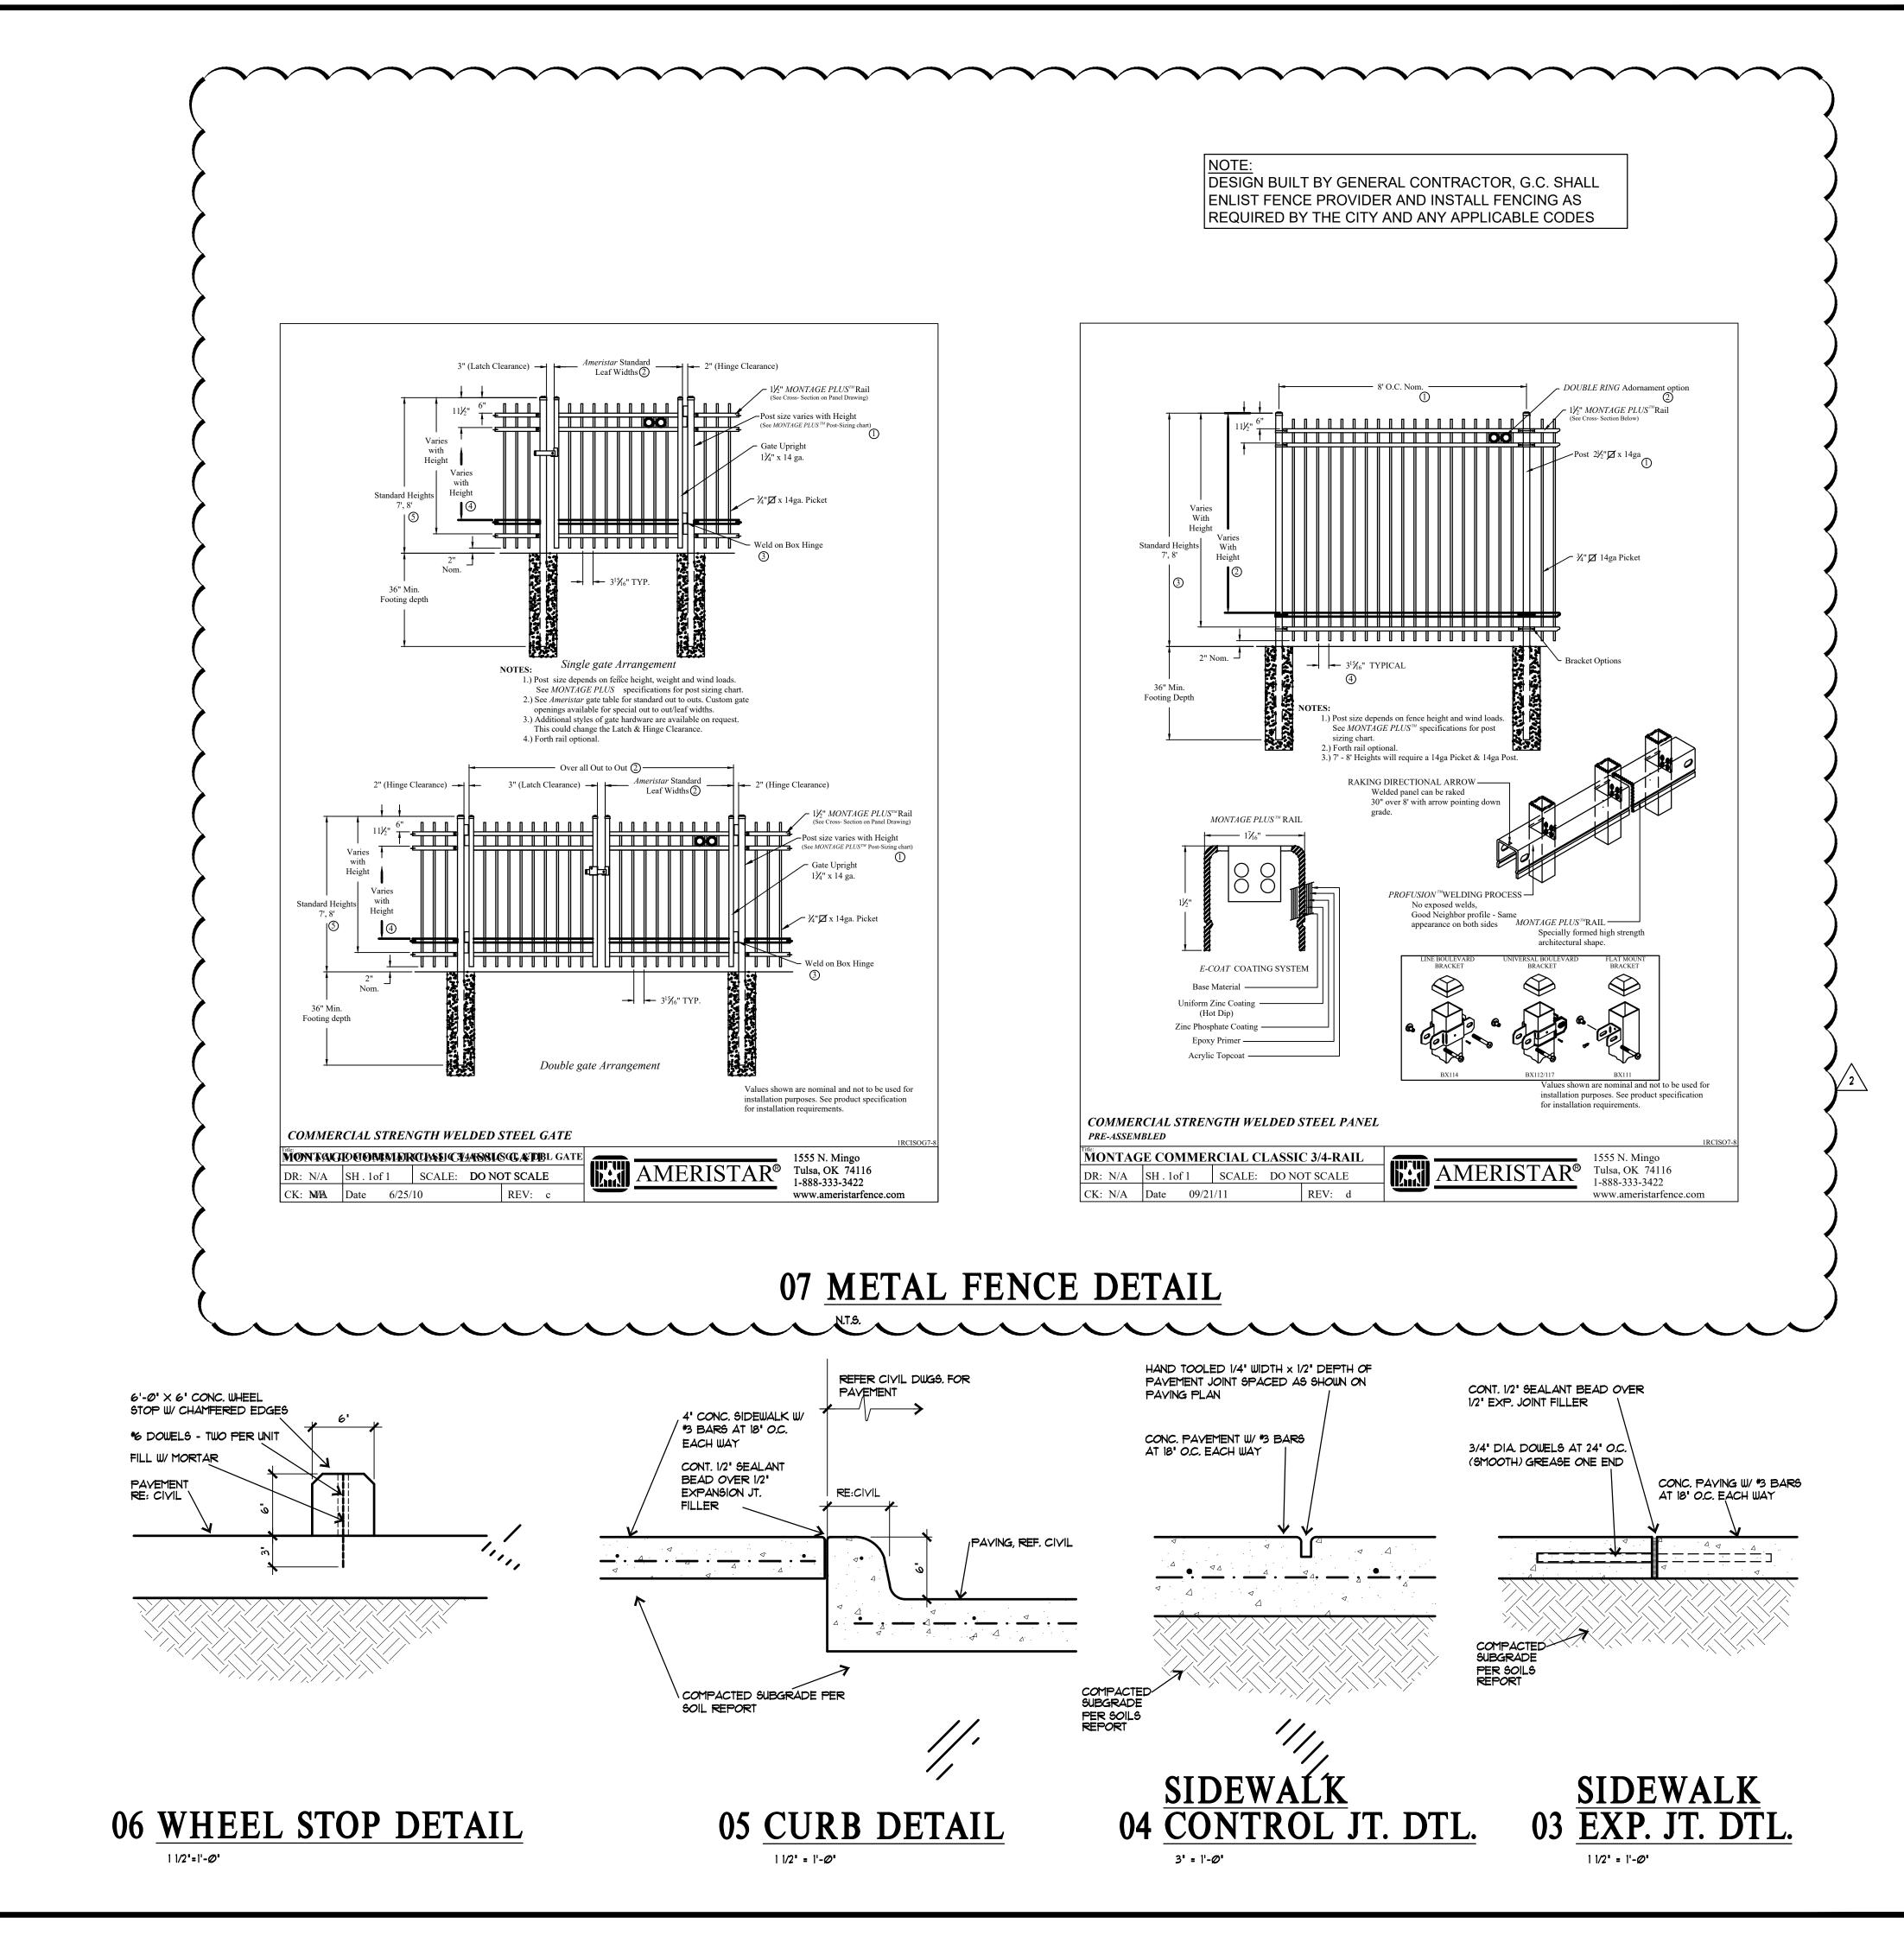


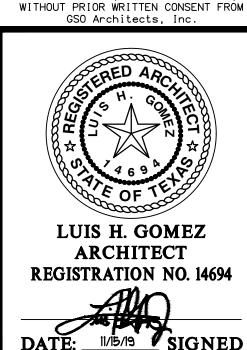JOB NO.: 18-058 **DATE:** 3/5/19 SCALE: AS NOTED

SHEET NO.


ELEVATIONS



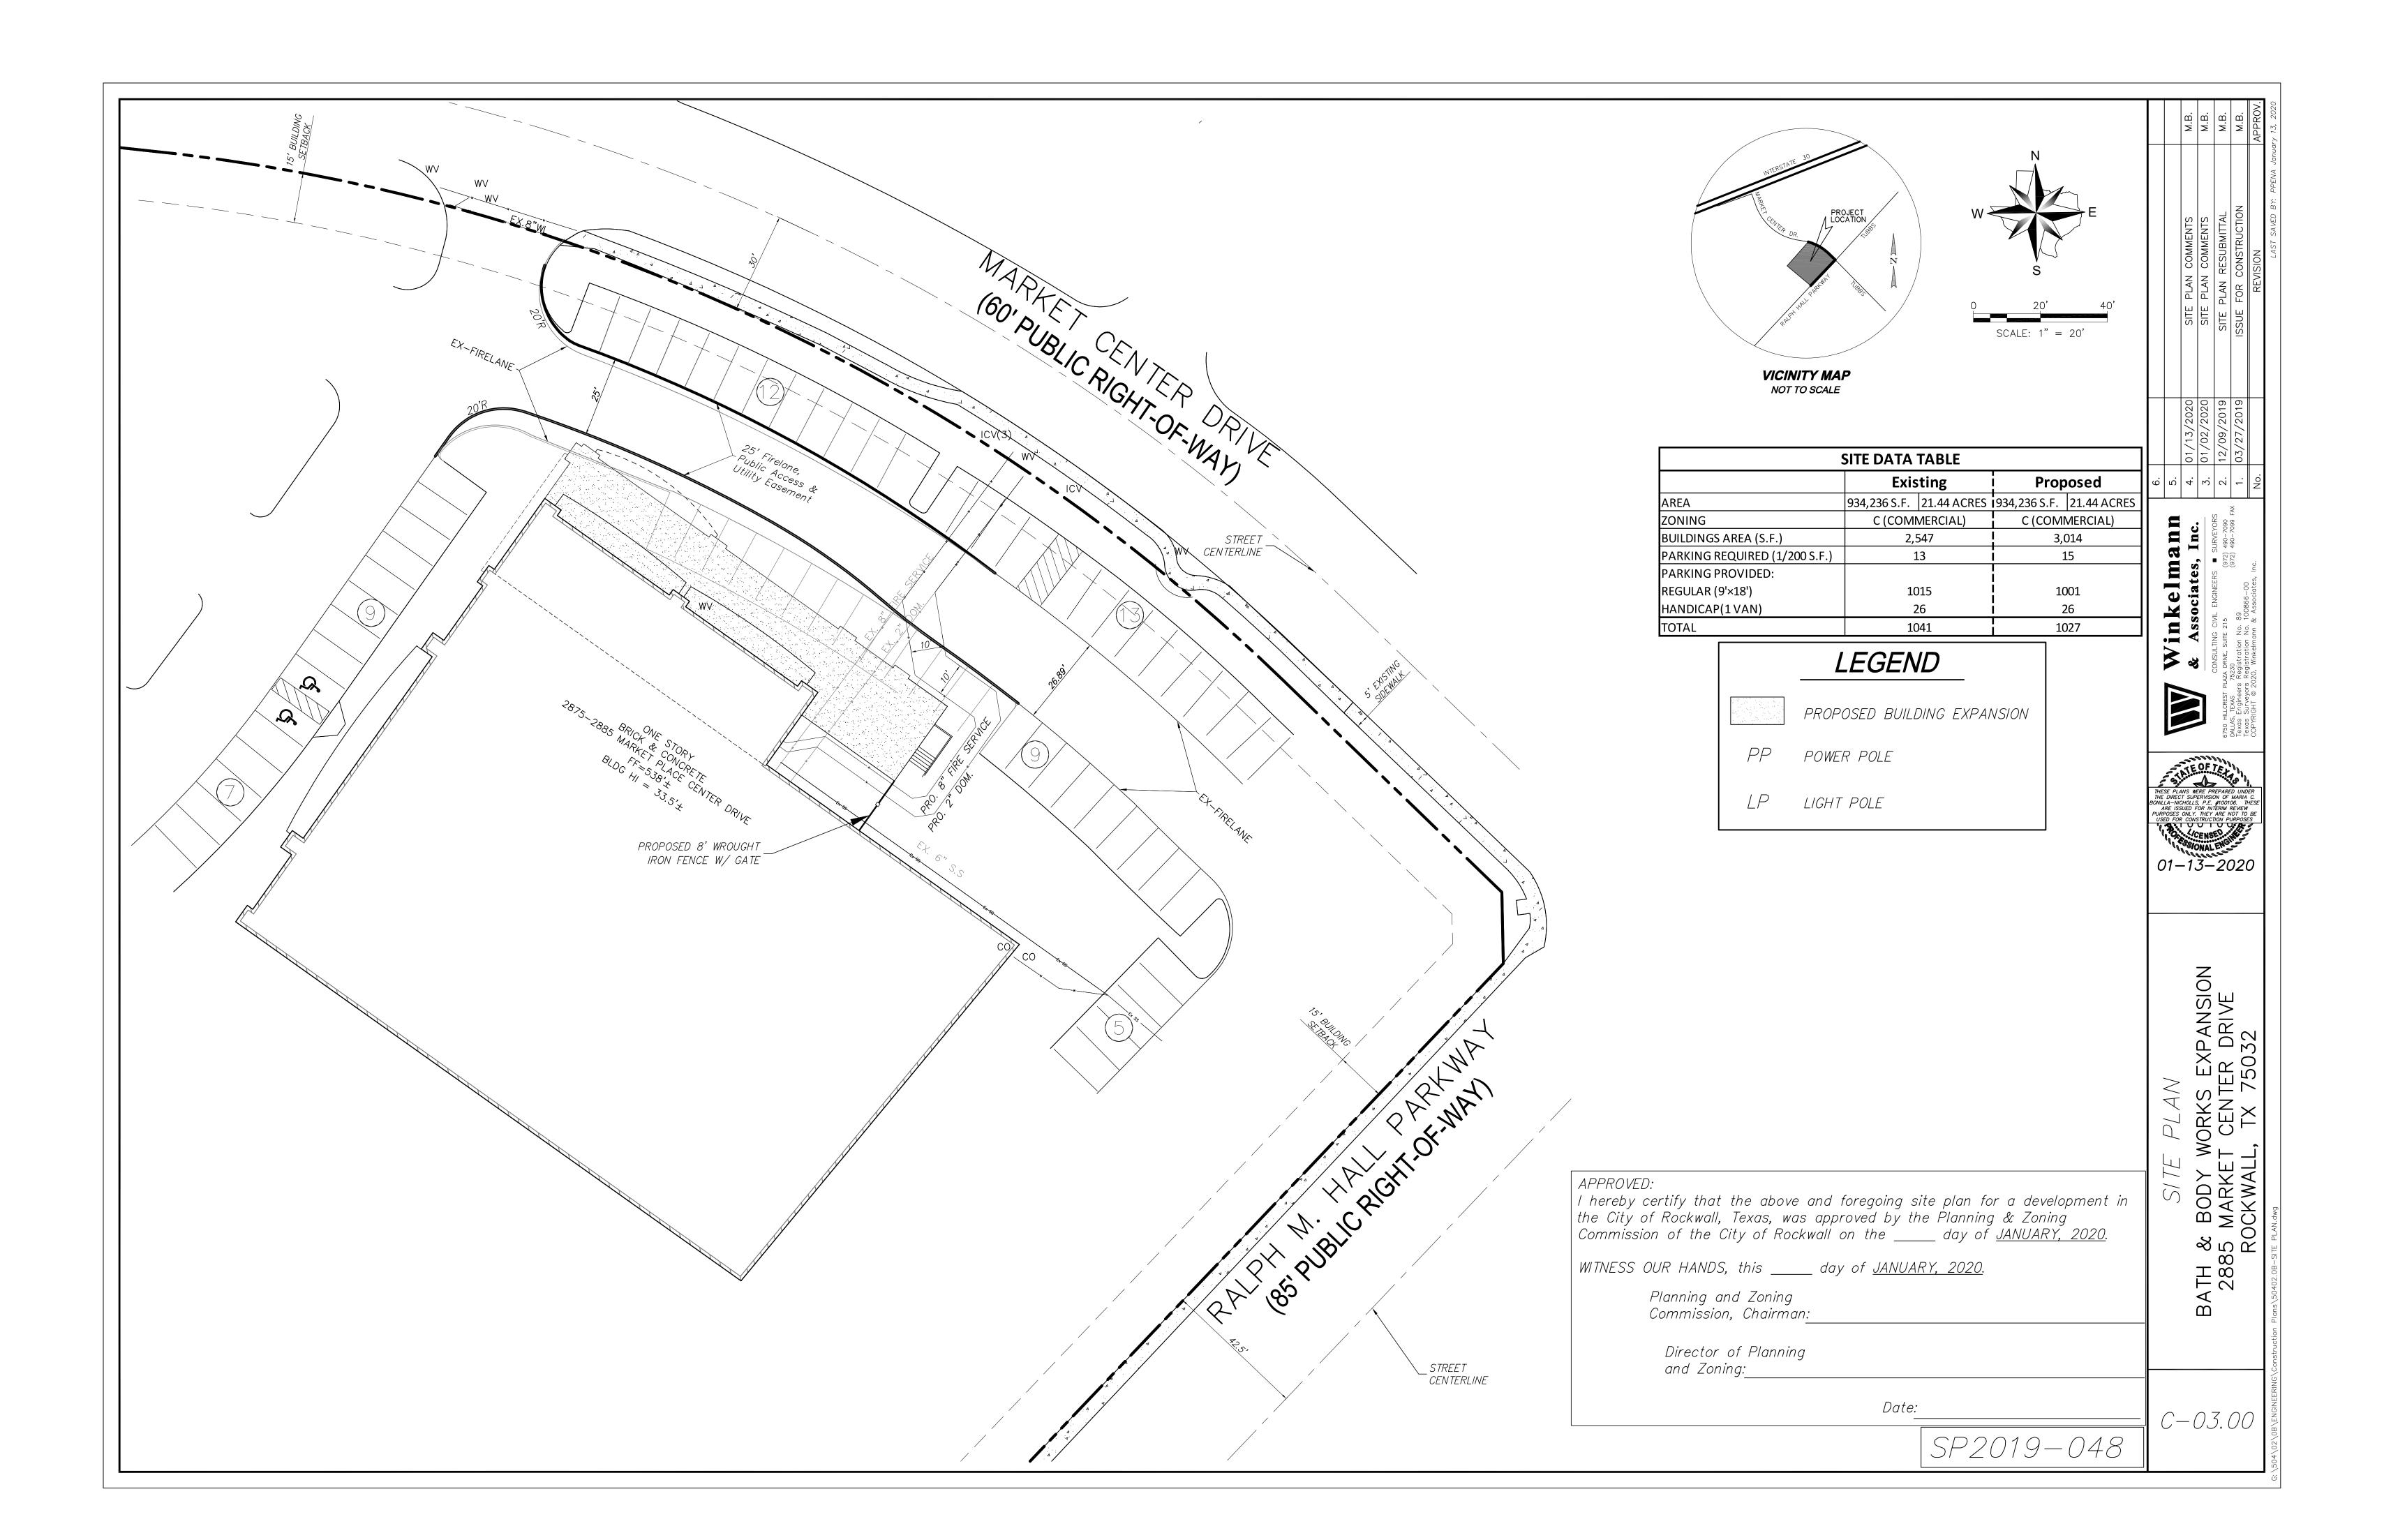


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SHEET NO. PAVING DETAILS

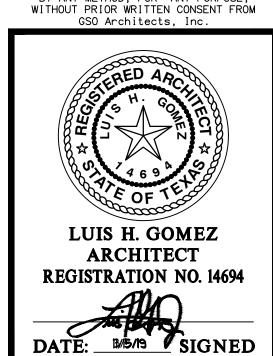


GSO ARCHILL RD. SUITE 226, LB
156
DALLAS, TX 75230
Www. GSOGCChitects.com

WORKS
EXPANSION
ROCKWALL, TEXAS

ISSUE LOG
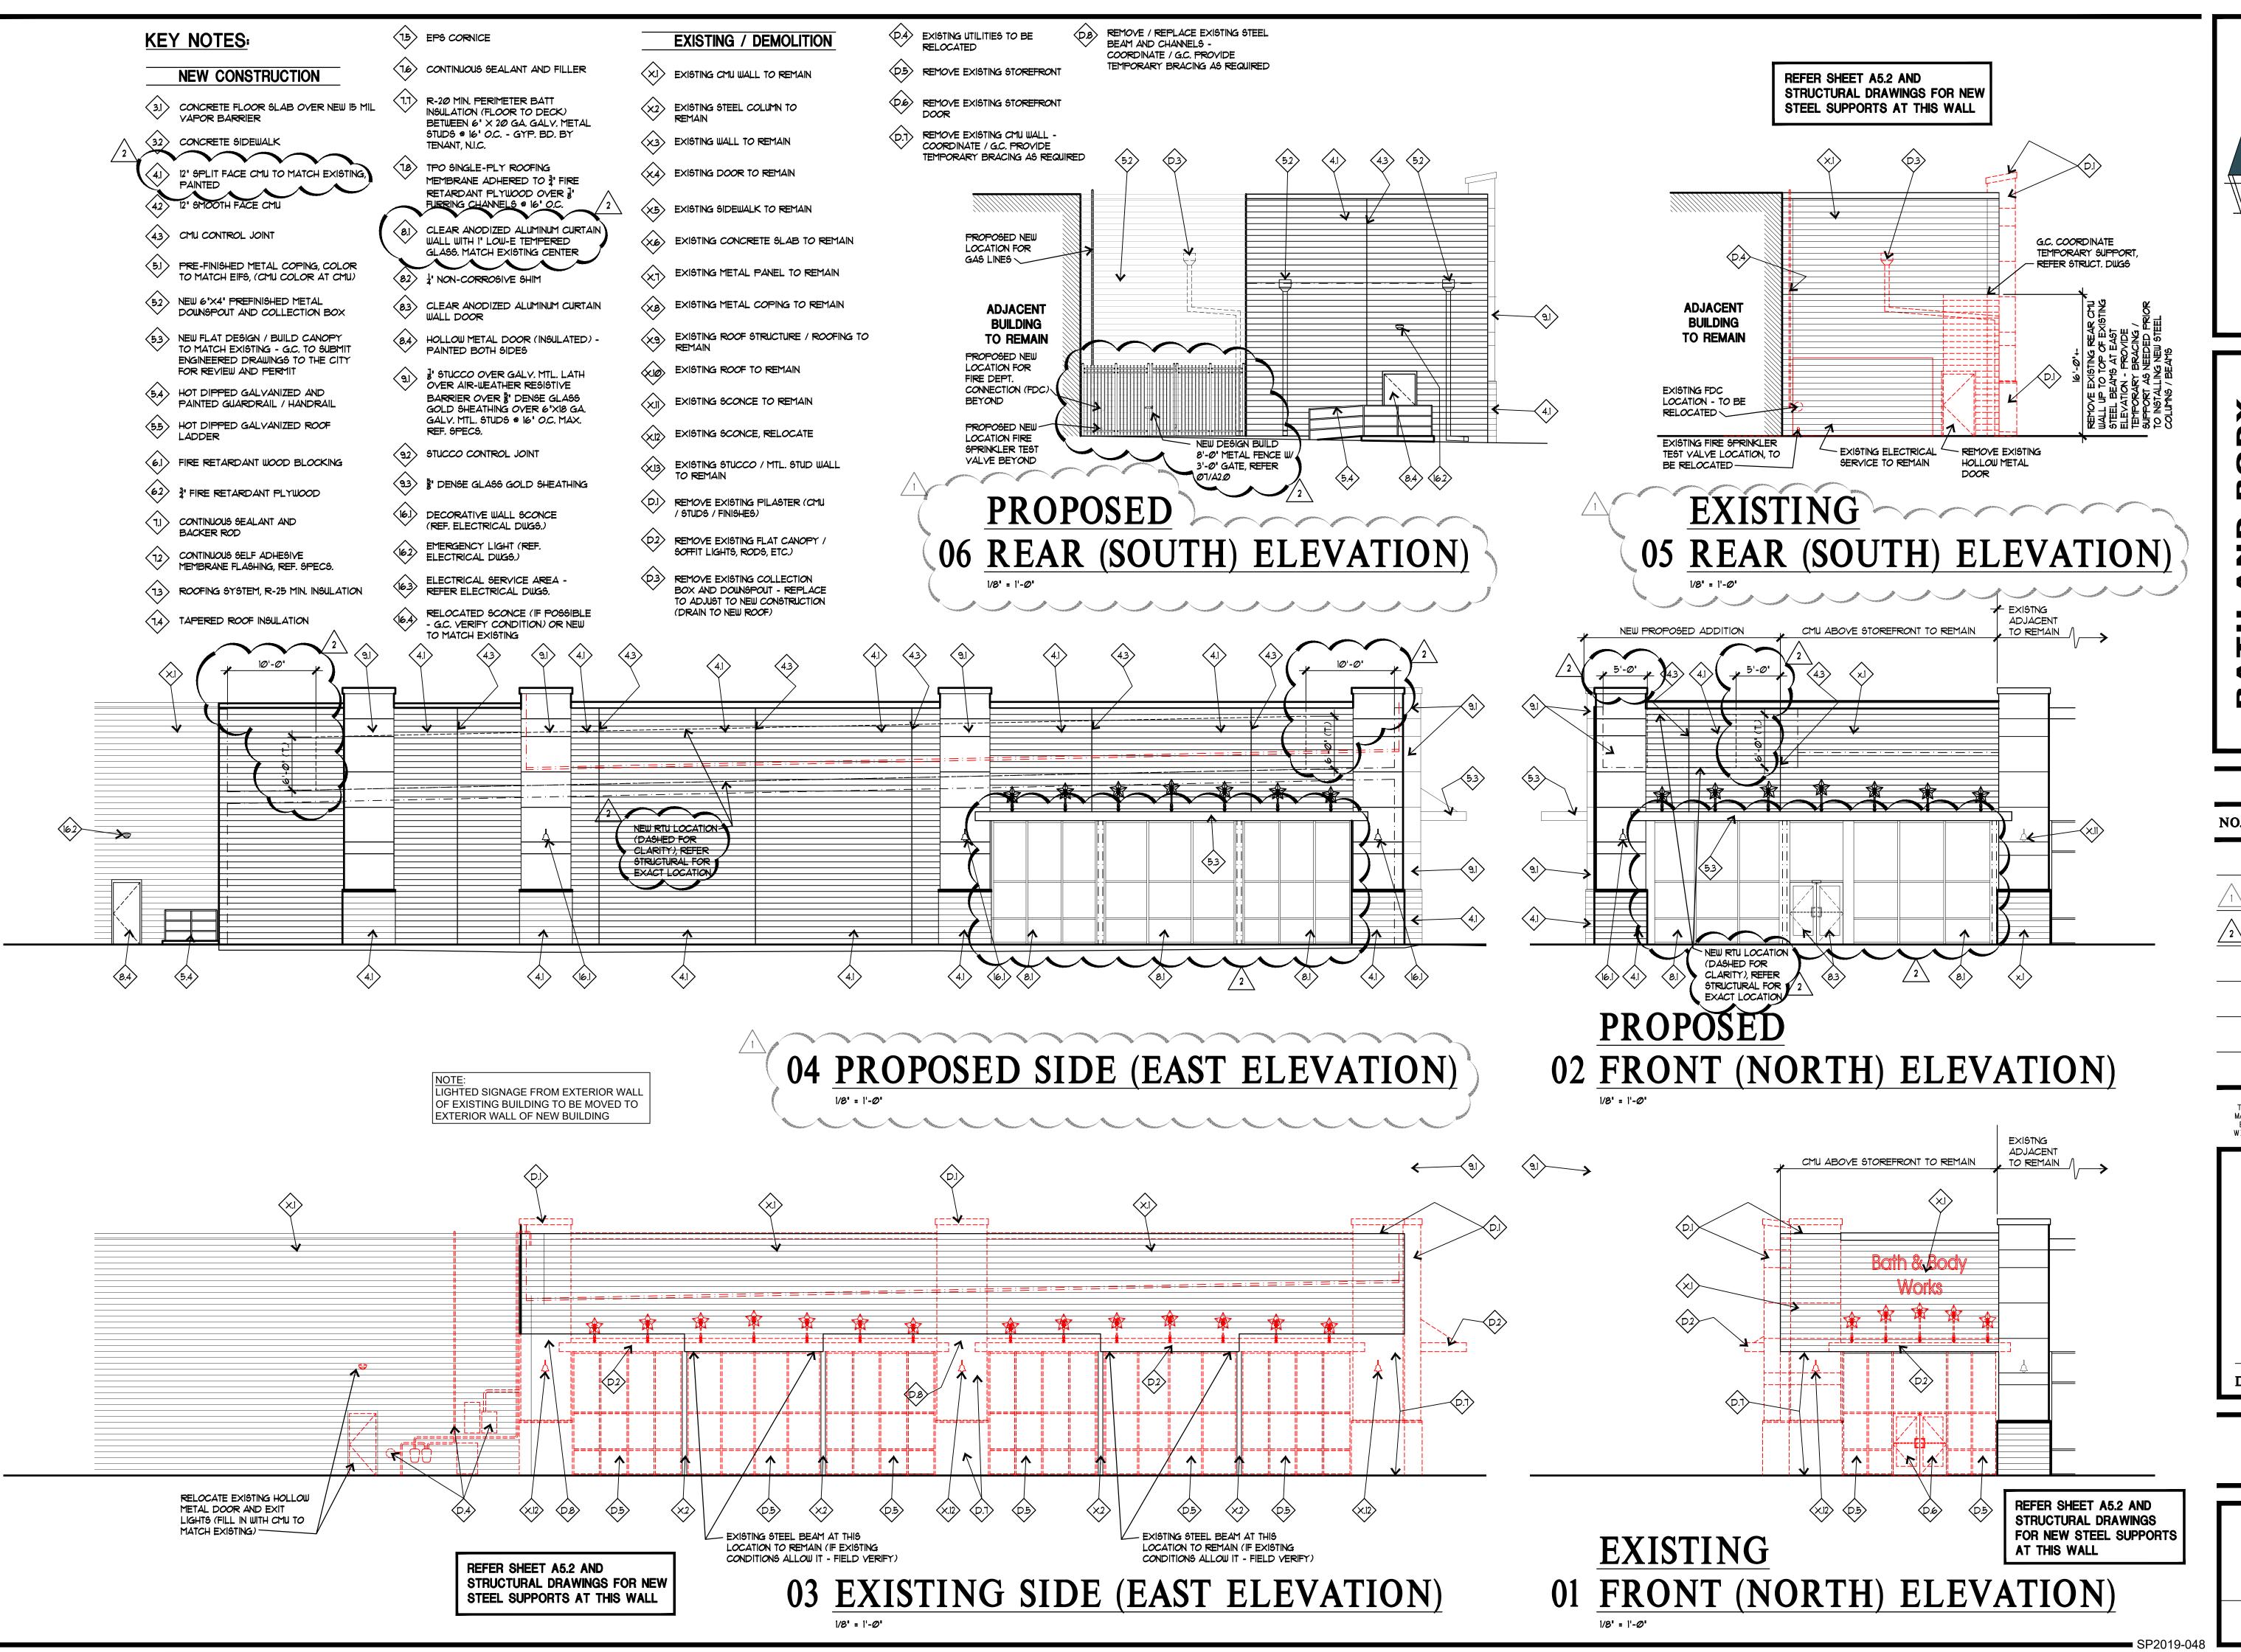
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JOB NO. : 18-058

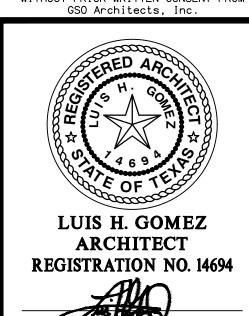
DATE: 3/5/19

SCALE: AS NOTED

SHEET NO.

A5.1

ELEVATIONS

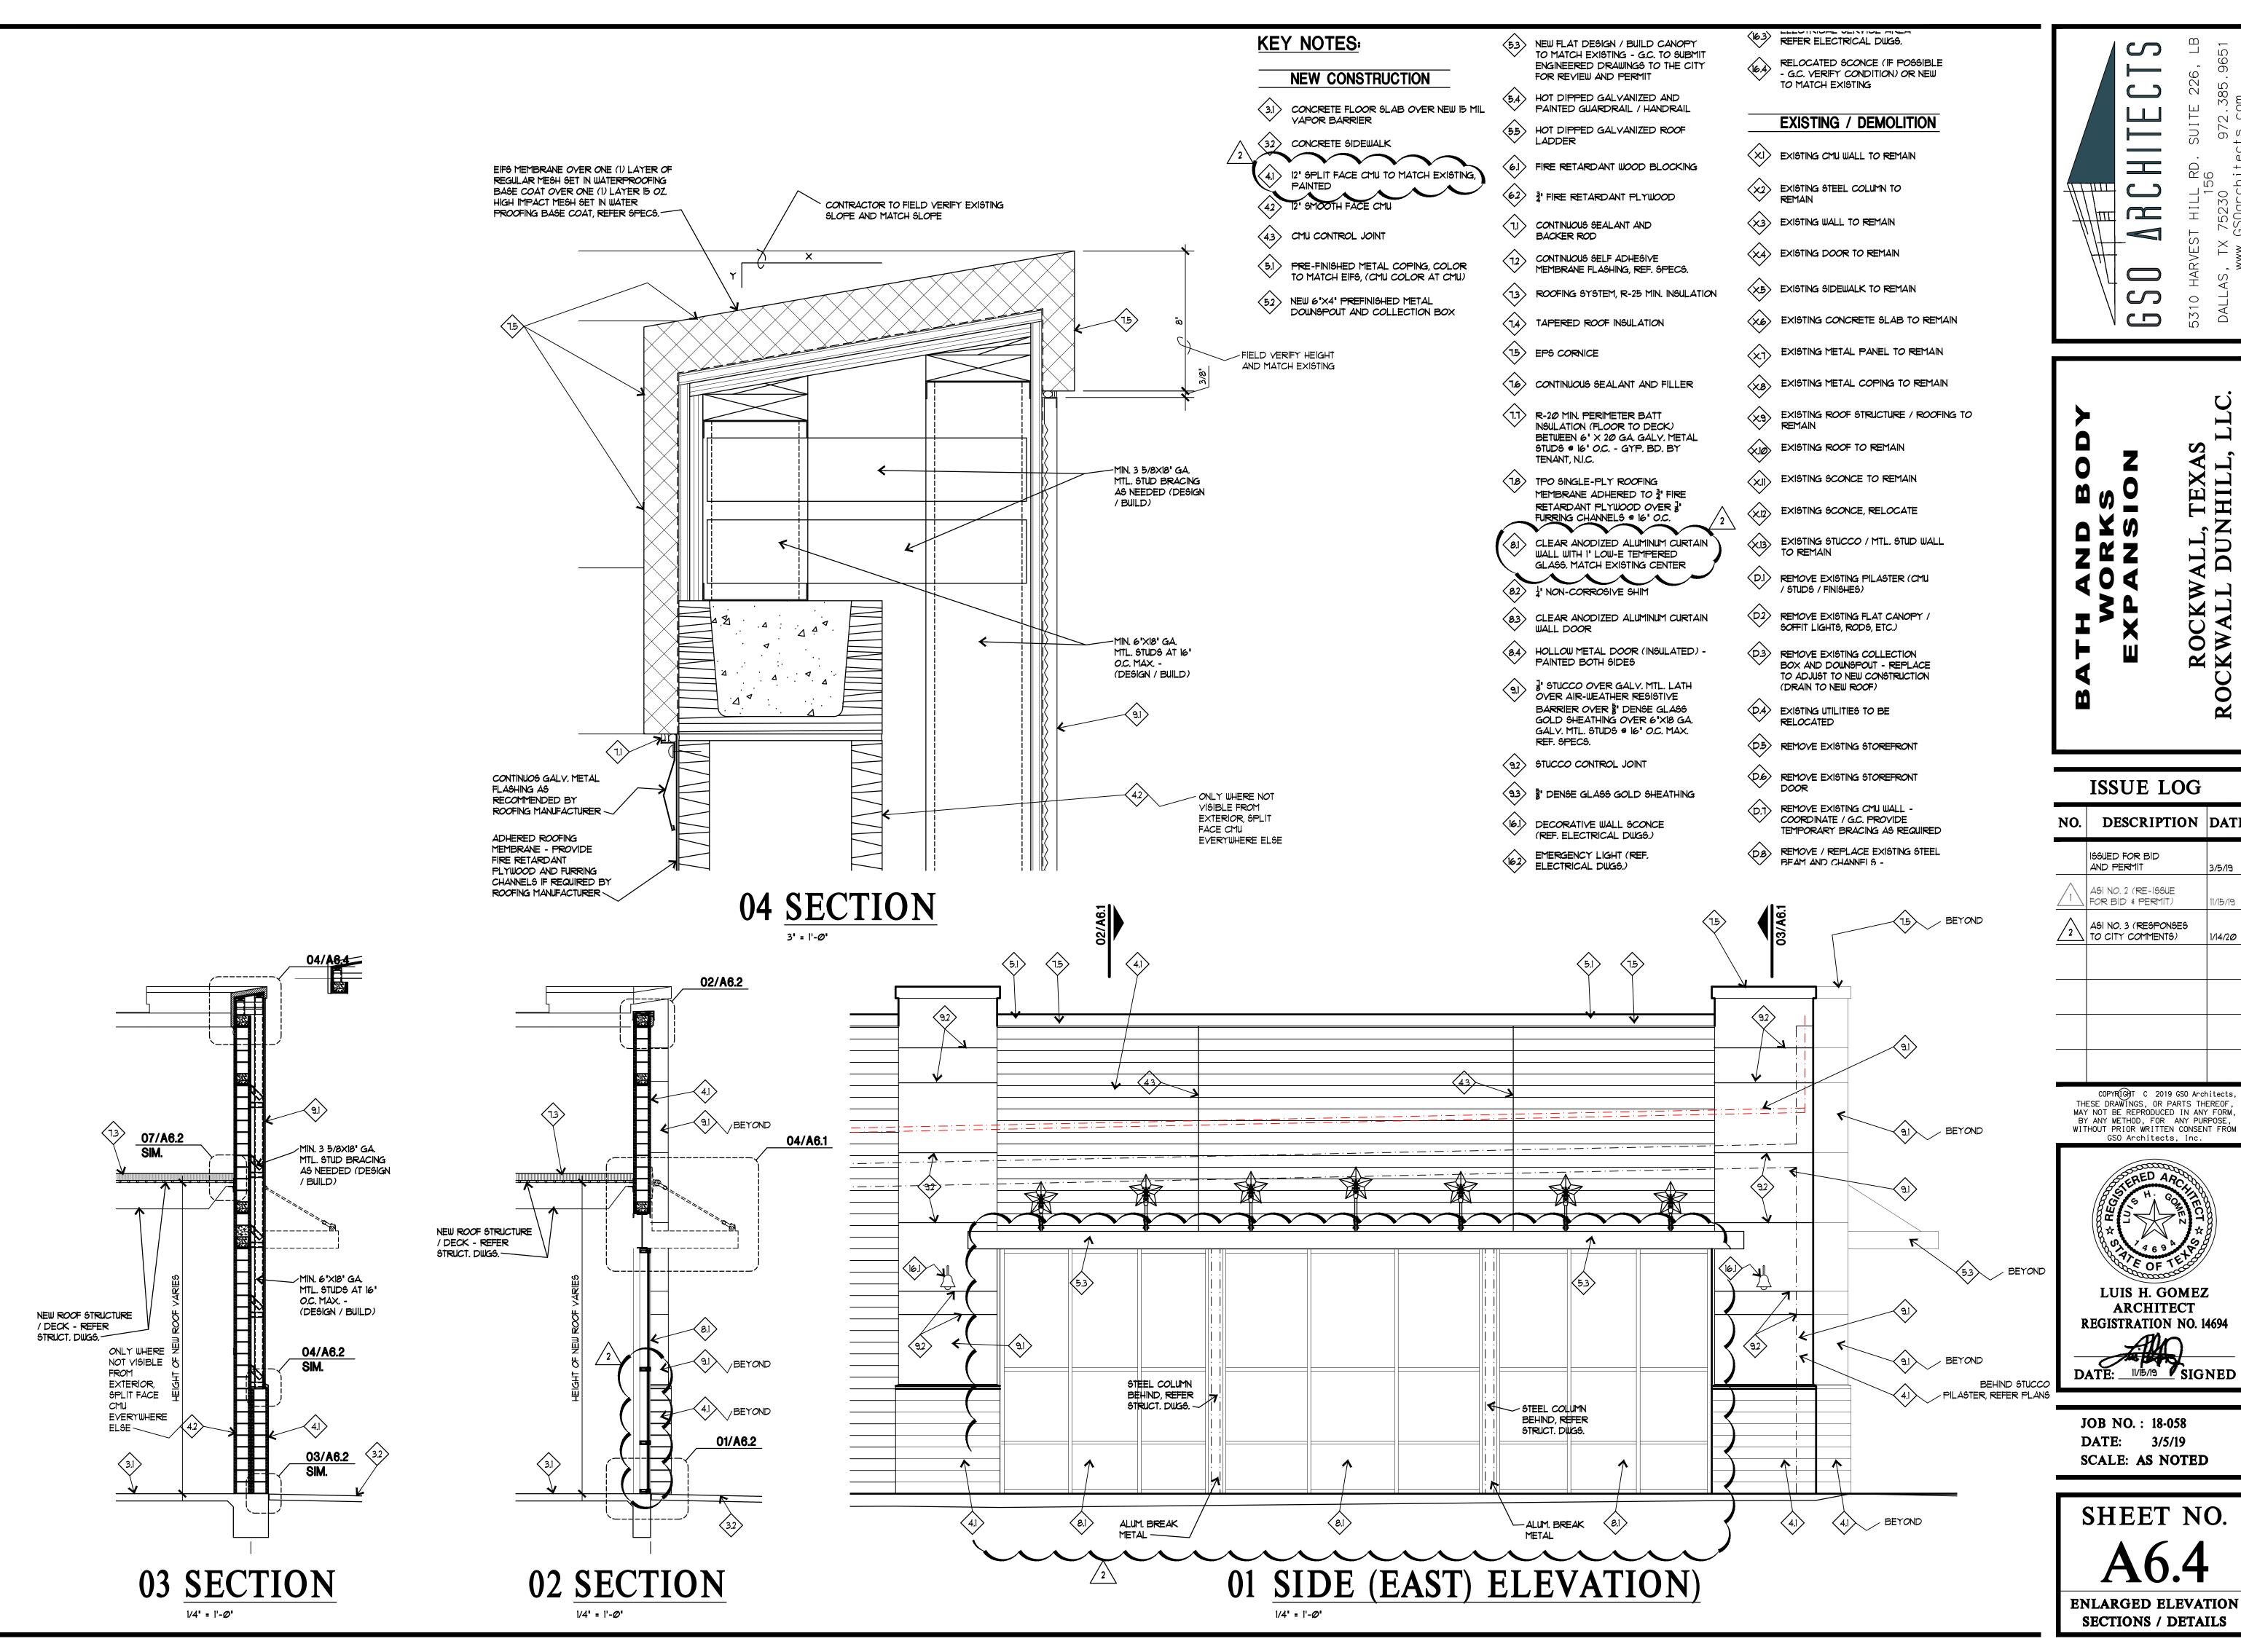


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ISSUE LOG


DESCRIPTION DATE ISSUED FOR BID AND PERMIT 3/5/19 ASI NO. 2 (RE-ISSUE FOR BID & PERMIT) ASI NO. 3 (RESPONSES TO CITY COMMENTS)

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JOB NO.: 18-058 **DATE:** 3/5/19 SCALE: AS NOTED

SHEET NO.

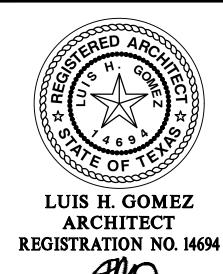


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972.385.9651
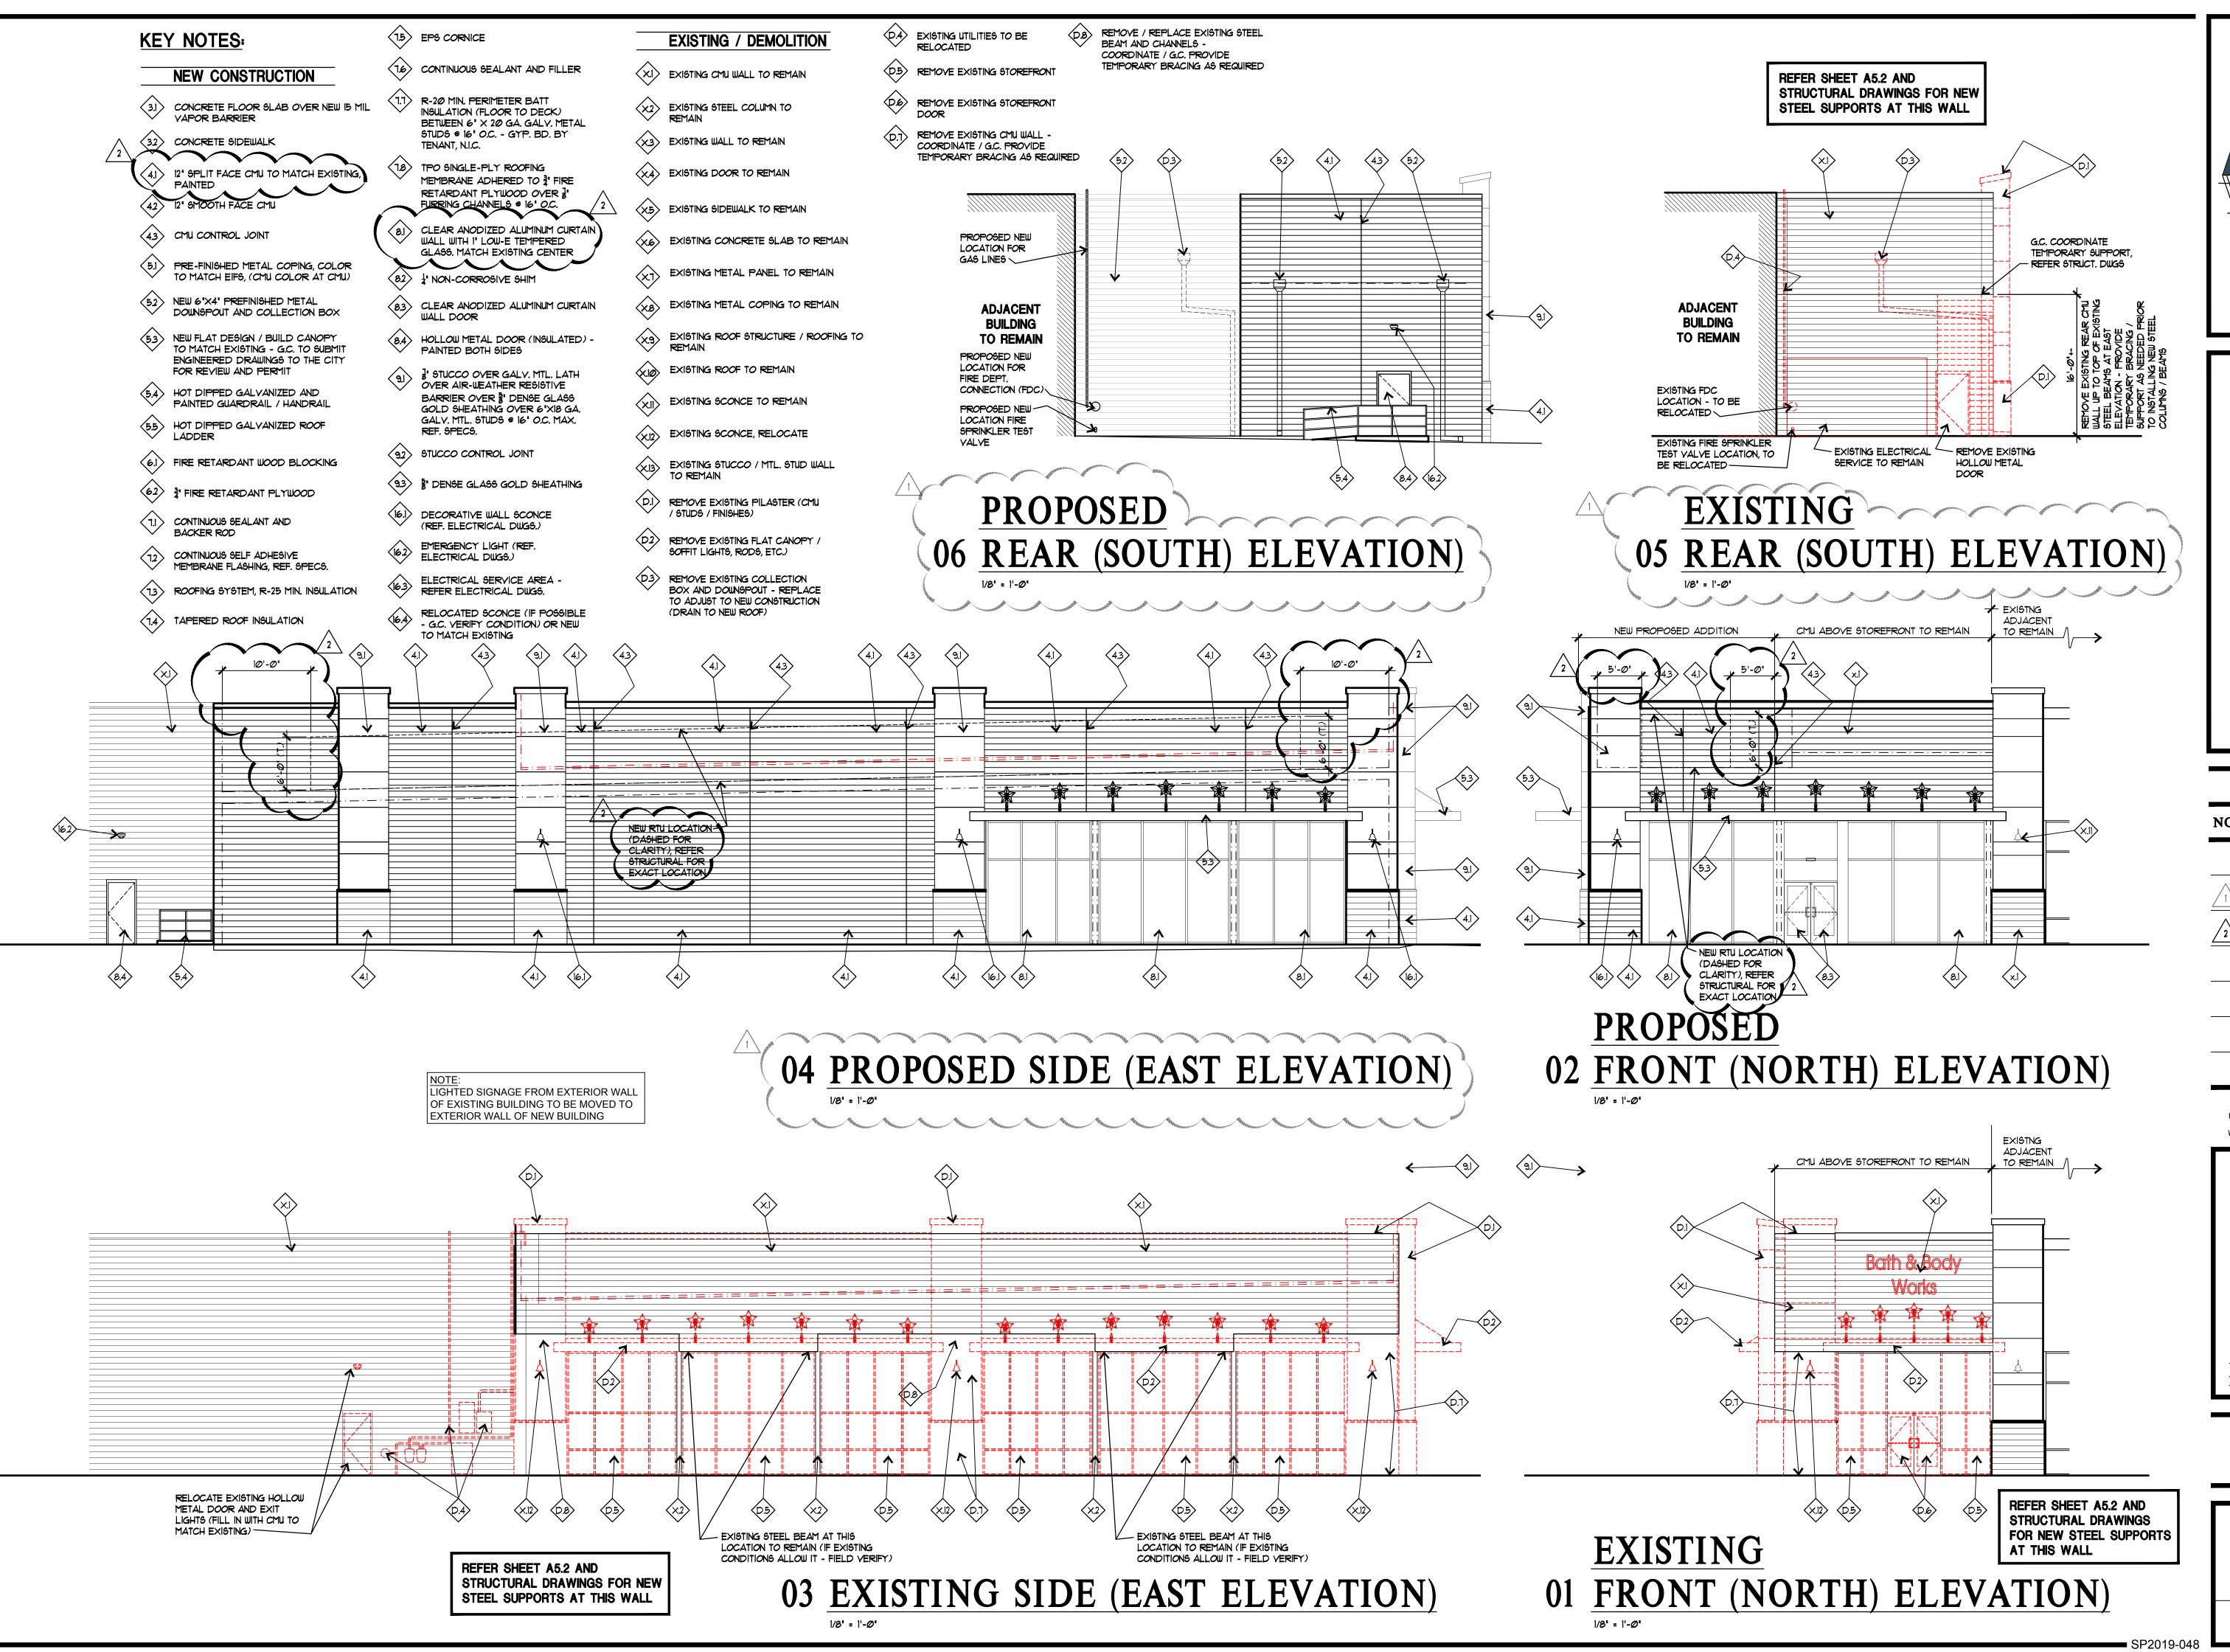
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ROCKWALL DUNHILL, LLC

ISSUE LOG

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JOB NO.: 18-058

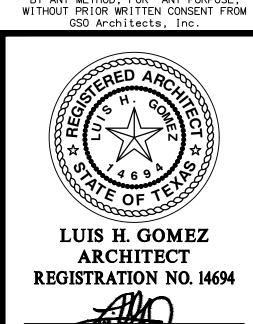
DATE: 3/5/19

SCALE: AS NOTED

SHEET NO.

A5.1

ELEVATIONS

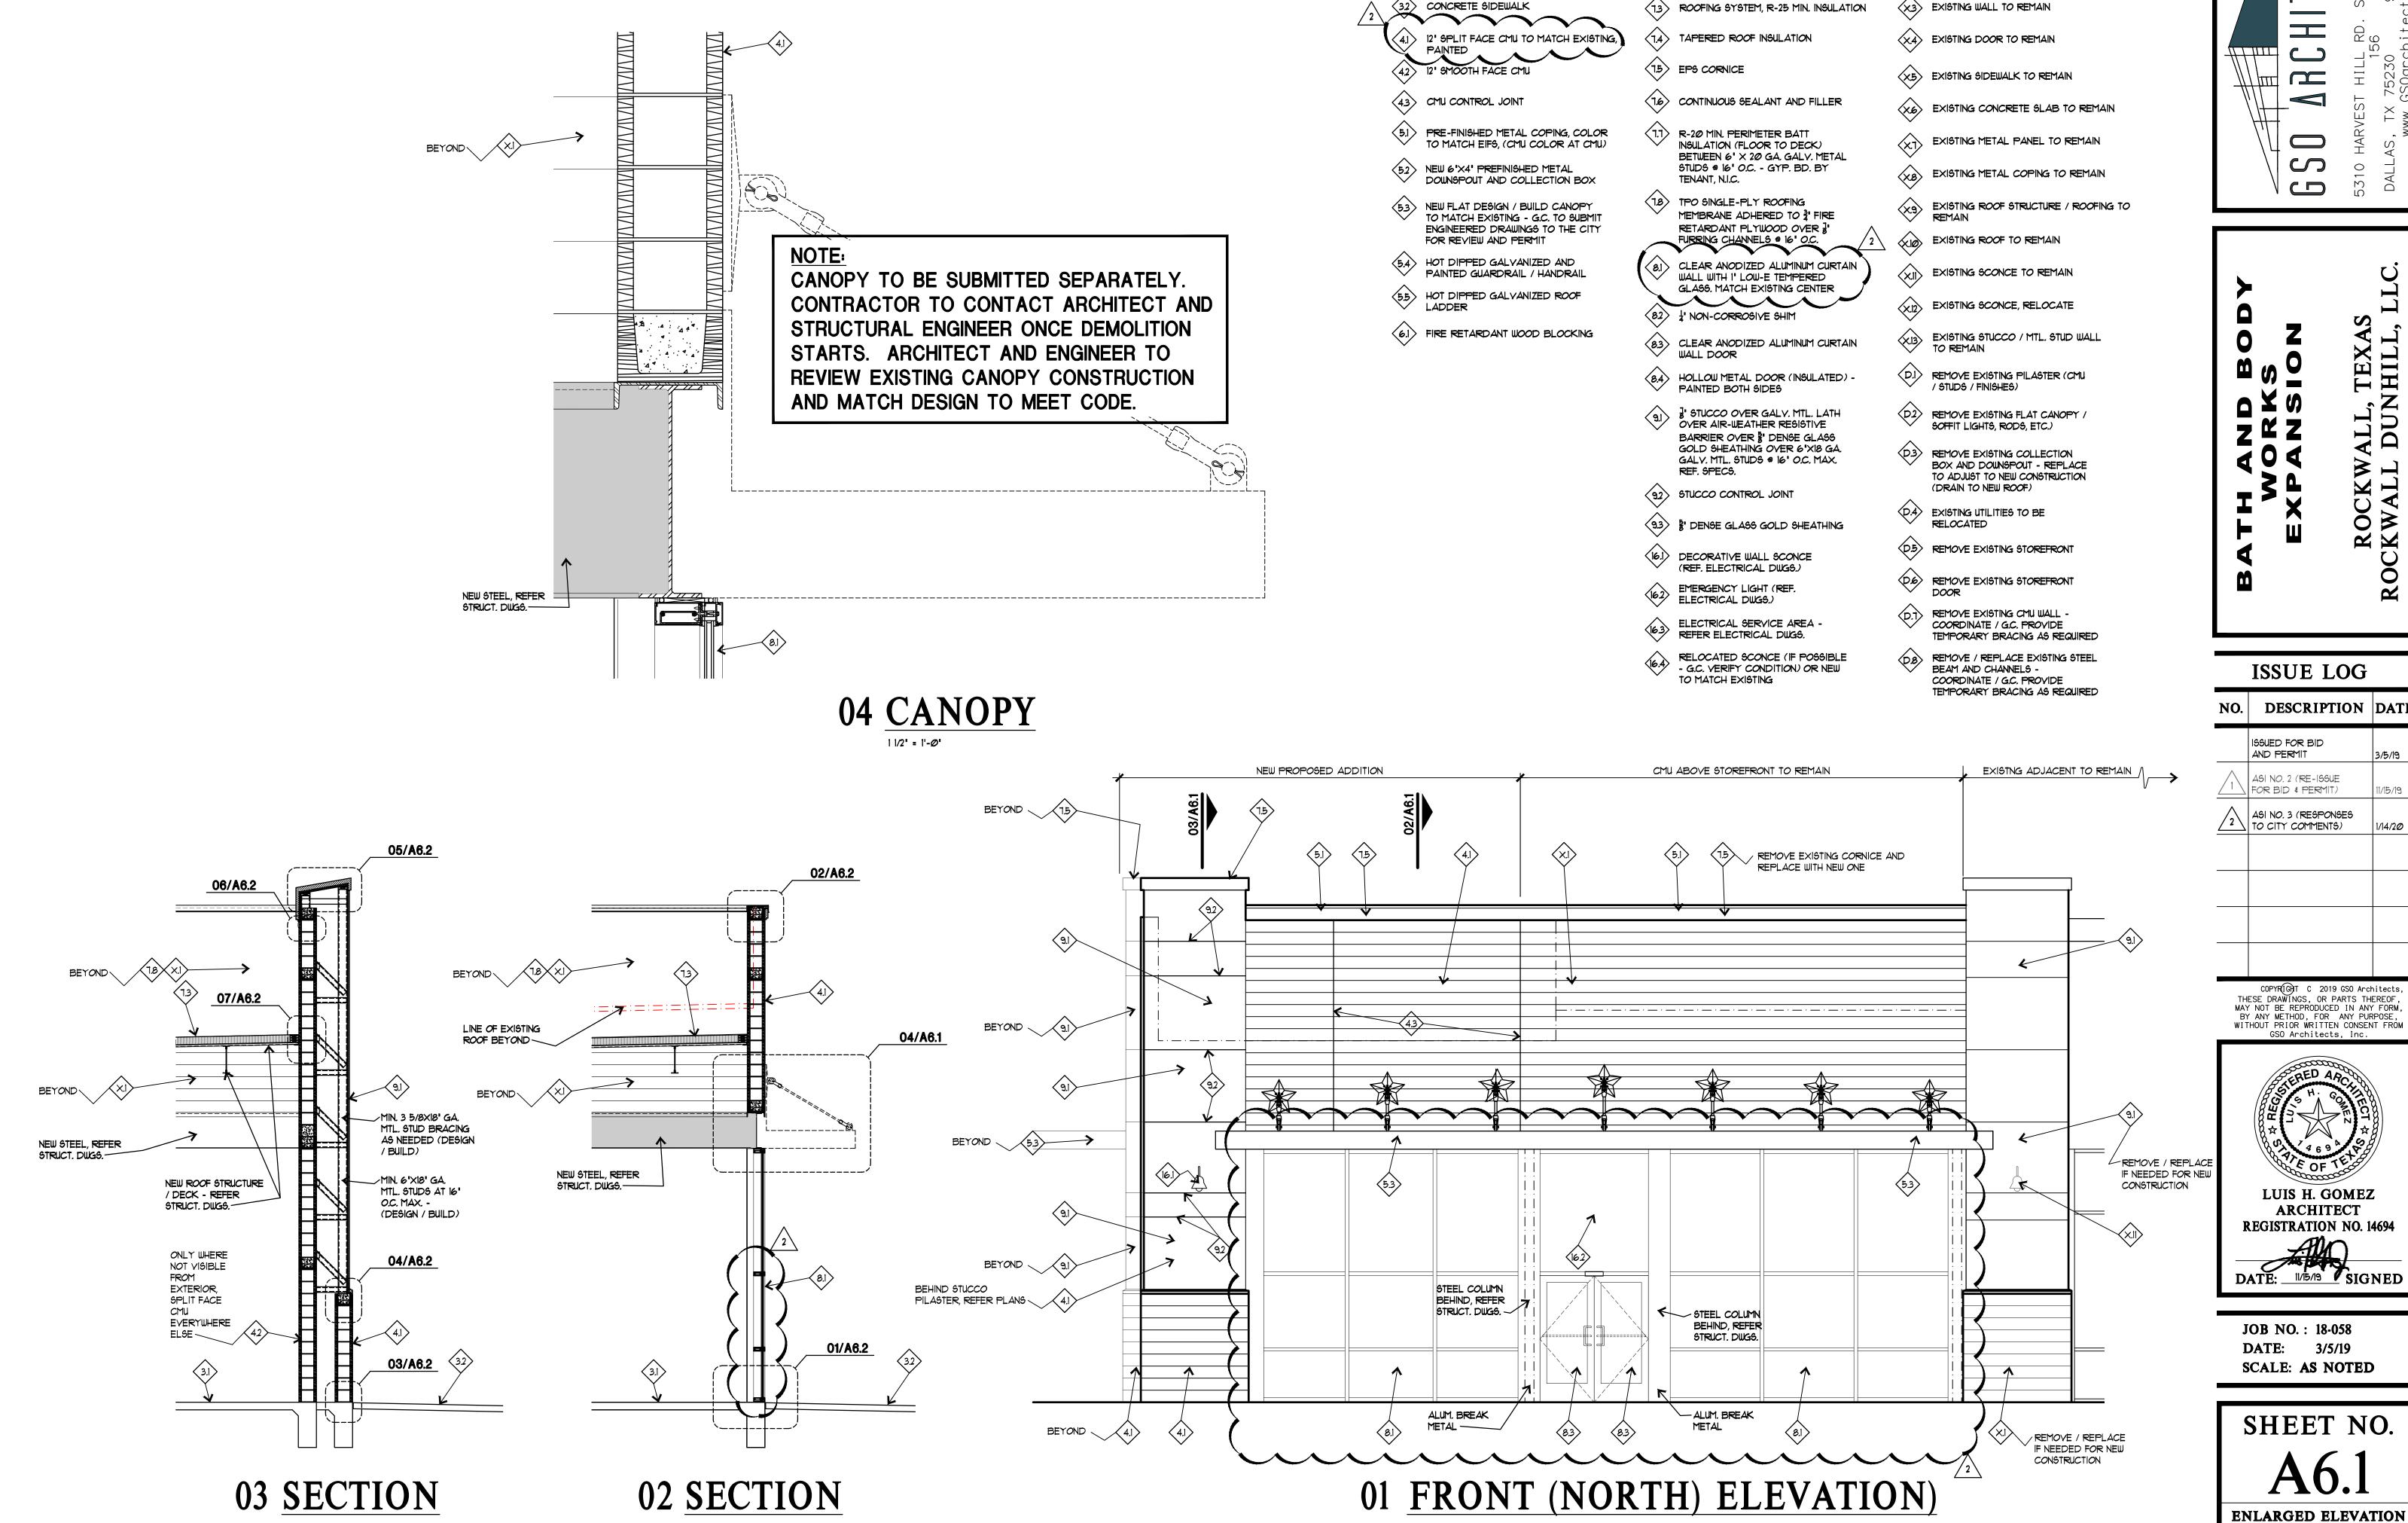

1/4" = 1'-0"

KEY NOTES:

NEW CONSTRUCTION

3.1) CONCRETE FLOOR SLAB OVER NEW 15 MIL VAPOR BARRIER

62 3 FIRE RETARDANT PLYWOOD

CONTINUOUS SELF ADHESIVE
MEMBRANE FLASHING, REF. SPECS.

CONTINUOUS SEALANT AND BACKER ROD

EXISTING / DEMOLITION

(XI) EXISTING CMU WALL TO REMAIN

EXISTING STEEL COLUMN TO

> TEX HIL ŏ≽ M M

ISSUE LOG

DESCRIPTION DATE ISSUED FOR BID AND PERMIT 3/5/19 ASI NO. 2 (RE-ISSUE FOR BID & PERMIT) ASI NO. 3 (RESPONSES TO CITY COMMENTS)


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LUIS H. GOMEZ **ARCHITECT REGISTRATION NO. 14694**

JOB NO.: 18-058 DATE: 3/5/19 SCALE: AS NOTED

SHEET NO.

SECTIONS / DETAILS



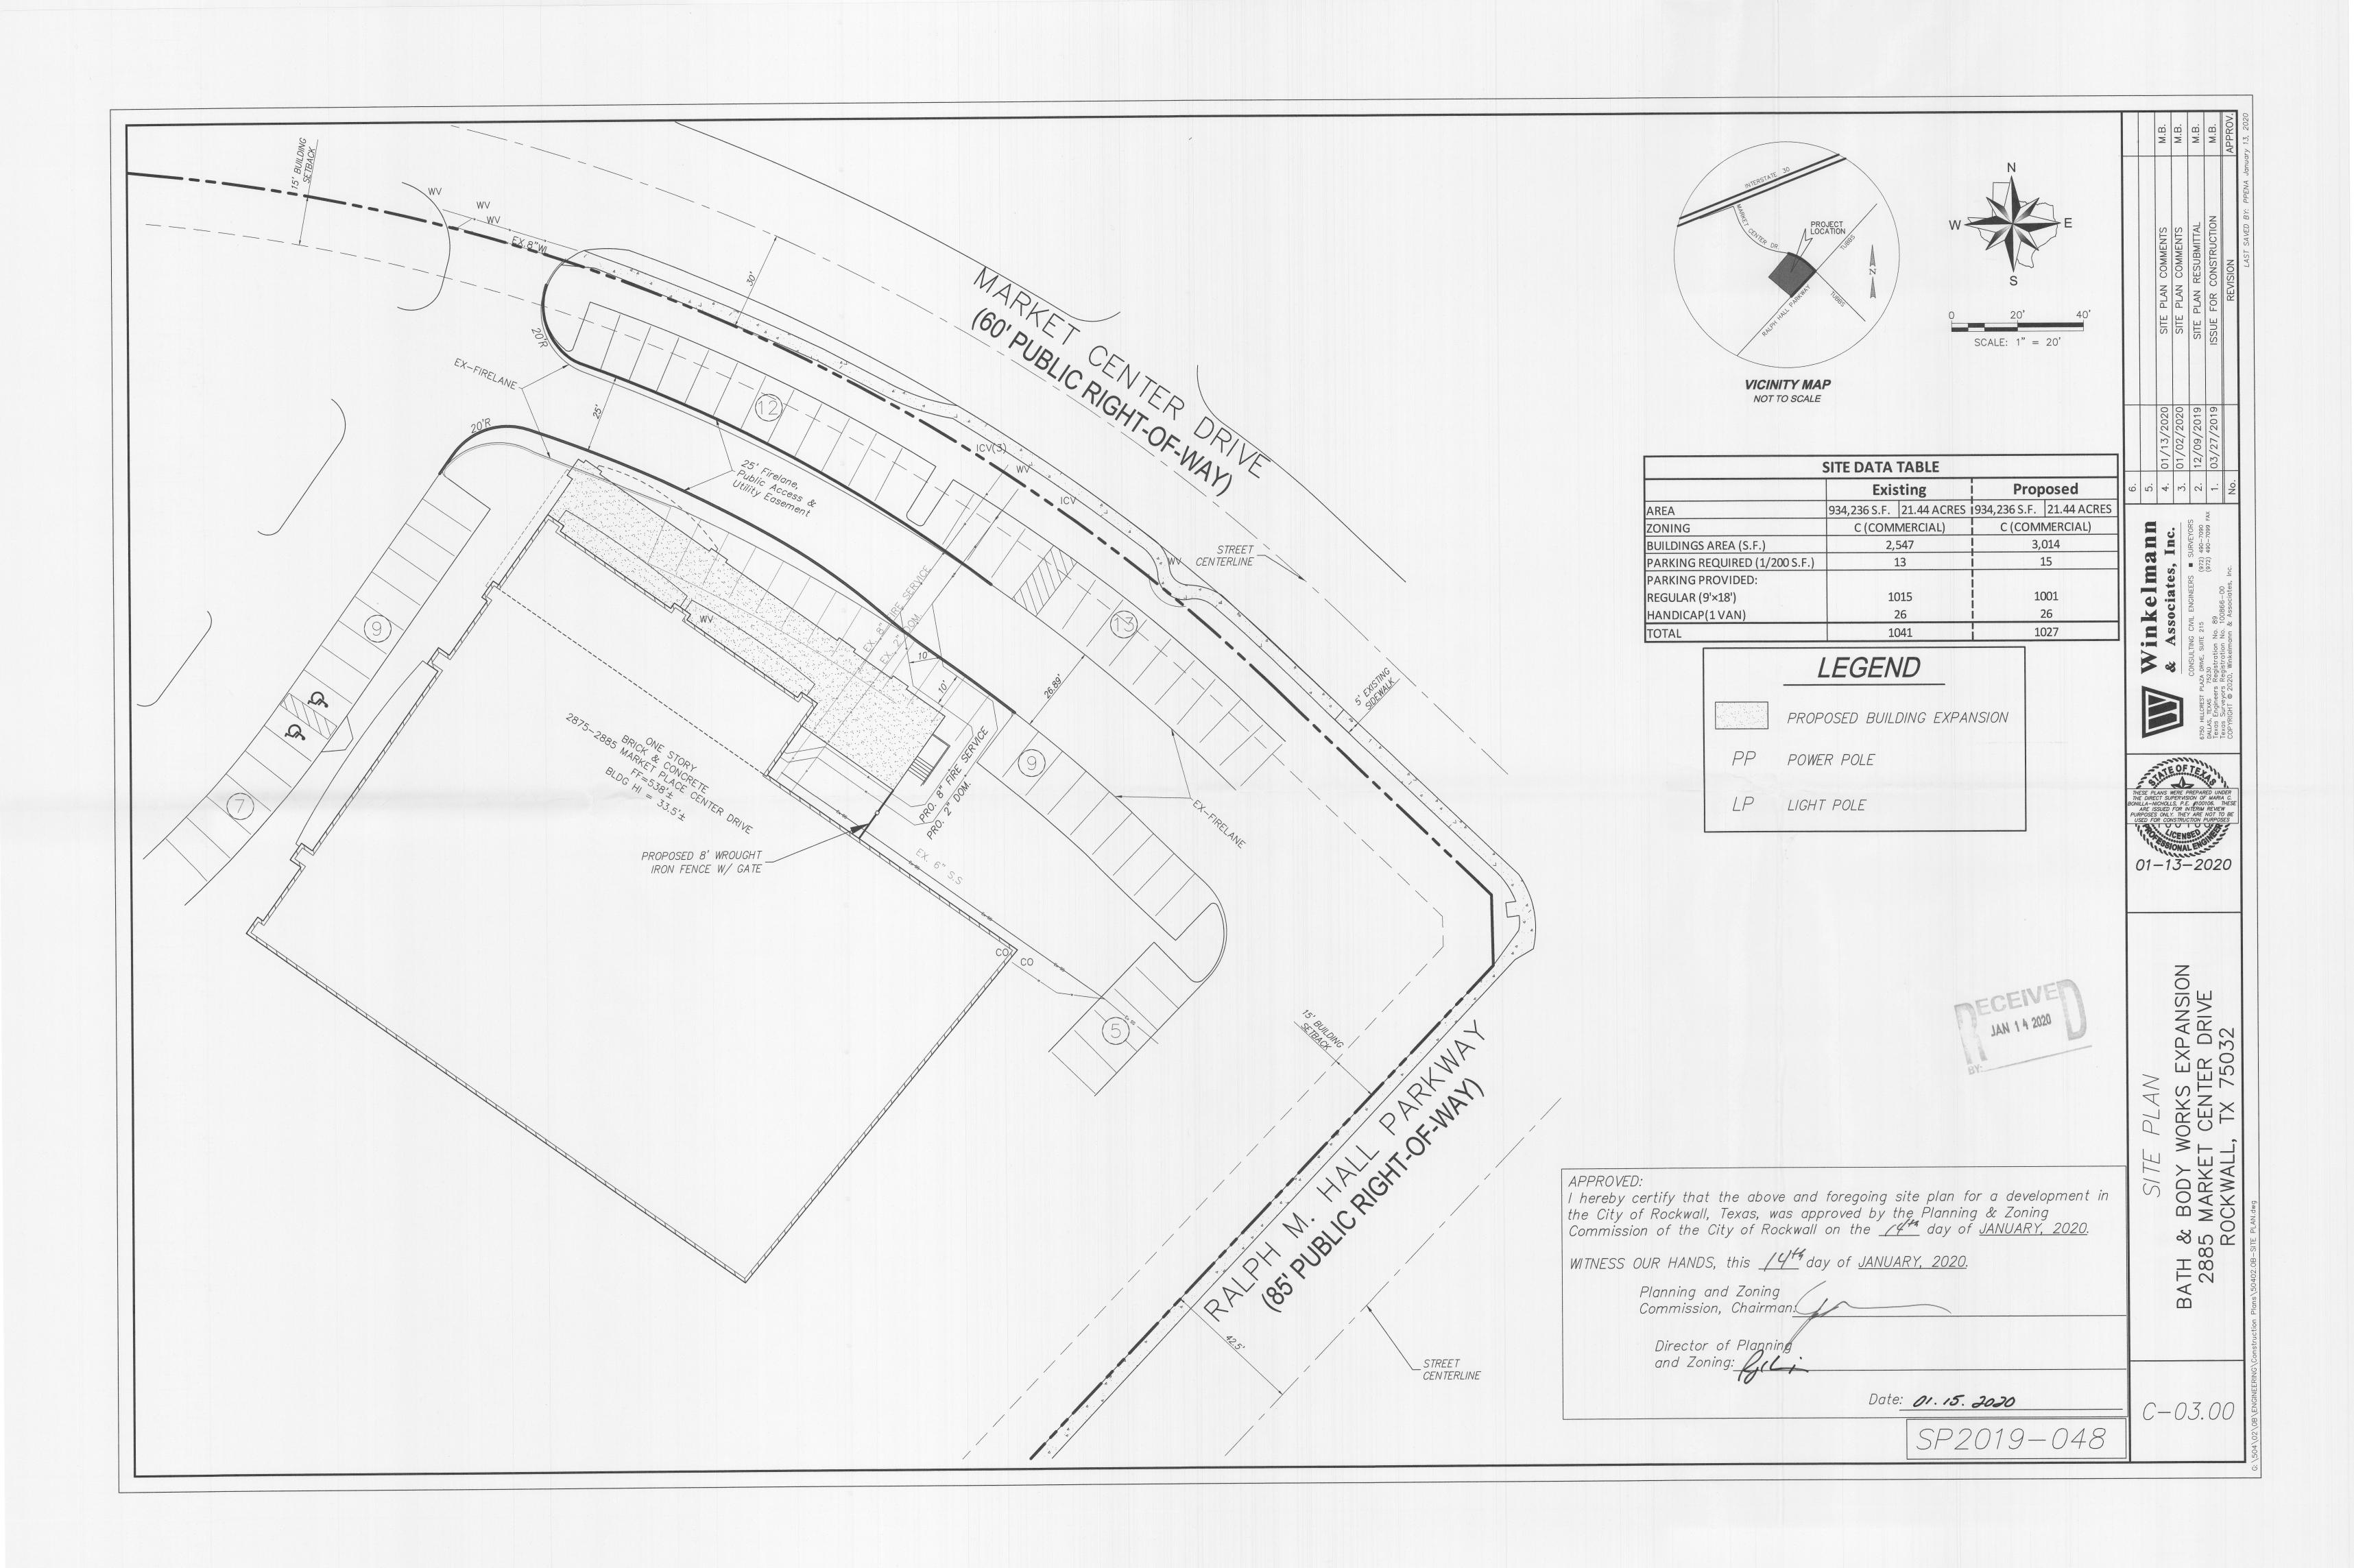

January 21, 2020

TO:

Maria Bonilla

Winkelmann & Associates, Inc. 6750 Hillcrest Plaza, Drive, Suite 215

Dallas, TX 75230

CC:

Jill Fisher

Dunhill Partners, Inc.

3100 Monticello Avenue, Suite 300

Dallas, TX 75205

FROM:

David Gonzales, AICP

City of Rockwall Planning and Zoning Department

385 S. Goliad Street Rockwall, TX 75087

SUBJECT:

SP2019-048; Administrative Site Plan for 2885 Market Center - Bath & Body Works Expansion

Maria Bonilla:

This letter serves to notify you that the above referenced site plan case, that you submitted for consideration by the City of Rockwall, was approved administratively on January 14, 2020. The following is a record of all recommendations, voting records and conditions of approval:

Staff Conditions

Please note that the property will require a replat prior to the issuance of a building permit. The replat will account for any portion of the firelane, public access, or utility easements requiring abandonment that is not consistent with the previous replats (*i.e. Case No. P2019-003*) alignment and/or abandonment.

Prior to submitting your civil engineering plans to the Engineering Department, you will need to submit bonded and digital copies of the site plan showing that all outstanding comments have been addressed. Please note that site plans that have not been completed within two (2) years of the final approval date shall be deemed to have expired. An extension may be granted by the Planning and Zoning Commission upon submission of a written request at least 90-days prior to the expiration date. Should you have any questions or concerns regarding your site plan or the site plan process, please feel free to contact me a (972) 771-7745.

Sincerely,

David Gonzales, AICP Planning and Zoning Manager