
### **PLANNING AND ZONING CASE CHECKLIST**

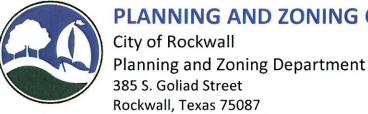

☐ TREESCAPE PLAN

P&Z CASE # <u>SP2019 - 050</u> P&Z DATE 12 32	5 19 CC DATE	APPROVED/DENIE
ARCHITECTURAL REVIEW BOARD DATE	HPAB DATE	PARK BOARD DATE
ZONING APPLICATION  SPECIFIC USE PERMIT ZONING CHANGE PD CONCEPT PLAN PD DEVELOPMENT PLAN  SITE PLAN LANDSCAPE PLAN TREESCAPE PLAN PHOTOMETRIC PLAN BUILDING ELEVATIONS MATERIAL SAMPLES COLOR RENDERING	□ APPLICATION □ RECEIPT □ LOCATION IN □ HOA MAP □ PON MAP □ FLU MAP □ NEWSPAPER □ 500-FT. BUF □ PROJECT REV □ STAFF REPO □ CORRESPON □ COPY-ALL PL □ COPY-MARK □ CITY COUNC □ MINUTES-LA □ PLAT FILED II □ CABINET #_	AP  PUBLIC NOTICE FER PUBLIC NOTICE VIEW RT DENCE LANS REQUIRED -UPS IL MINUTES-LASERFICHE
PLATTING APPLICATION    MASTER PLAT   PRELIMINARY PLAT   FINAL PLAT   REPLAT   ADMINISTRATIVE/MINOR PLAT   VACATION PLAT	NOTES:	PDATED



#### DEVELOP ... IENT APPLICATION

City of Rockwall Planning and Zoning Department 385 S. Goliad Street Rockwall Texas 75087

PLANNING & JUNING CASE NO. SPZO(9-050)

**NOTE:** THE APPLICATION IS NOT CONSIDERED ACCEPTED BY THE CITY UNTIL THE PLANNING DIRECTOR AND CITY ENGINEER HAVE SIGNED BELOW.

DIRECTOR OF PLANNING:

	Nockwall, Texas 7500	67		CITY ENGINEER:			11
Please check the d	appropriate box below to indic	cate the type of deve	elopment reque	st [SELECT ONLY	ONE BOX]:		
[ ] Preliminary F [ ] Final Plat (\$3 [ ] Replat (\$300 [ ] Amending or [ ] Plat Reinstate Site Plan Applica [ ] Site Plan (\$25	\$100.00 + \$15.00 Acre) <sup>1</sup> Plat (\$200.00 + \$15.00 Acre) <sup>1</sup> 00.00 + \$20.00 Acre) <sup>1</sup> .00 + \$20.00 Acre) <sup>1</sup> Minor Plat (\$150.00) ement Request (\$100.00)	an (\$100.00)	[ ] Zoning [ ] Specifi [ ] PD De  Other App [ ] Tree R [ ] Varian  Notes: 1: In determ	pplication Fees:  Change (\$200.00 or Use Permit (\$20 ovelopment Plans (\$10 ovelopment Pl	0.00 + \$15.00 Acro \$200.00 acro	Acre) 1	3 by the
PROPERTY INFO	ORMATION [PLEASE PRINT]	······			THE RESERVE TO SERVE THE PARTY OF THE PARTY		
Address	Ranch	Trail	Rochwal	1 Tx 750	272		
Subdivision	4	Cres		Lot	17	Block	
General Location							
ZONING, SITE P	LAN AND PLATTING INFO	ORMATION [PLEAS	SE PRINT]				
Current Zoning	Commercial		Current L	ise Office	7.		
Proposed Zoning	Commercial		Proposed L				
Acreage	7,215	Lots [Current]	2		ots [Proposed]	1	
[ ] SITE PLANS AND process, and fail	D PLATS: By checking this box you ac ure to address any of staff's comment	cknowledge that due to ts by the date provided o	the passage of <u>HE</u> n the Development	3167 the City no lo Calendar will result	nger has flexibility v in the denial of you	<b>!</b> with regard to it: r case.	s approvi
OWNER/APPLIC	CANT/AGENT INFORMAT	ION [PLEASE PRINT/C	HECK THE PRIMAR	Y CONTACT/ORIGIN	IAL SIGNATURES AR	RE REQUIRED]	
[ ] Owner	Epic Rockwill	Ventures	[ ] Applicar	it Ramsai	1 + Renes	s LKG	
Contact Person	Wilka Dalan		Contact Perso	n Ross	Ramson		
Address	315 Ranch Trail		Addres	s 2235	Ridiza Ro	end)	
City, State & Zip	ROCKWAN TY 75	5032	City, State & Zi	· Rxk	wan Tx 7	5087	
Phone	469-774-2611		Phon	- 11/0	92) 888	_	
E-Mail	mdaul & Snapi	nga.com	E-Ma	100	in e yaha		
Before me, the undersig	CATION [REQUIRED] gned authority, on this day personally ue and certified the following:	0	ga	$\sim$	undersigned, who s		nation o
			6				

"I hereby certify that I am the owner for the purpose of this application; all information submitted berein is true and correct; and the application fee of  $\frac{390.00}{1000}$  cover the cost of this application, has been paid to the City of Rockwall on this the  $\frac{1670}{1000}$  day of  $\frac{1}{1000}$  equal to  $\frac{1}{1000}$ . By signing this application,  $\underline{\phantom{a}}$  , 20  $\underline{\phantom{a}}$  . By signing this application, I agree that the City of Rockwall (i.e. "City") is authorized and permitted to provide information contained within this application to the public. The City is also authorized and permitted to reproduce any copyrighted information submitted in conjunction with this application, if such reproduction is associated or in response to a request for public ELIZABETH A. MORGAN

Given under my hand and seal of office on this the  $\sqrt{\phantom{a}}$ 

Notary Public in and for the State of Texas

My Commission Expires 0 2-25-20 24

NOTARY PUBLIC - STATE OF TEXAS 108 1078404-7 COMM. EXP. 02-28-2021



### DEVELOPMENT REVIEW COMMITTEE (DRC) CITY OF ROCKWALL, PLANNING & ZONING DEPARTMENT

Phone: (972) 771-7745

Email: Planning@Rockwall.com

**External Review:** 

Wayne Carter, Charter Communications

Jim Friske, Charter Communications

Dinah Wood, Atmos Randy Voight, Oncor Phillip Dickerson, Oncor Brian Duncan, AT&T Javier Fernandez, RISD Brenda Callaway, TXDOT

Stephen Geiger, Farmer's Electric Frank Spataro, Farmer's Electric

Internal Review:

Amy Williams, Engineering

John Shannon, Building Inspections

Ariana Hargrove, Fire Andy Hesser, Parks Andy Villarreal, Police

From: Planning & Zoning Department

Date: 12/16/2019

To assist the Planning Department in evaluating the attached request, we are sending it to you for your review and comments. Please return any comments and/or plan mark-ups to us within five (5) days. Internal staff will also be required to have all comments input into CRW no later than Friday, 12/19/2019. Planning staff will assemble all comments received in time for our regularly scheduled DRC meeting on 12/19/2019 at 2:00 p.m. The Planning and Zoning Commission work session will be held on 12/30/2019 at 6:00 p.m. You are welcome to attend both meetings. If you have any questions, please contact us at (972) 771-7745.

**Project Number:** 

SP2019-050

**Project Name:** 

315 Ranch Trail

**Project Type:** 

SITE PLAN

**Applicant Name:** 

**ROSS RAMSAY** 

**Owner Name:** 

WILLIAMS, RONNIE L & KIM A

**Project Description:** 



### **RECEIPT**

**Project Number: SP2019-050** Job Address: 315 RANCH TRAIL **ROCKWALL, TX 75032** 

**Receipt Number:** B87695 Printed: 12/18/2019 9:59 am

**Fee Description Account Number Fee Amount** 

SITE PLANNING

01-4280 \$390.00

\$390.00

**Total Fees Paid:** Date Paid: 12/18/2019 12:00:00AM

Received By: AG

Paid By: ROSS RAMSAY Pay Method: CHECK 1292



**Platting Application Fees:** 

[ ] Master Plat (\$100.00 + \$15.00 Acre) 1

Notary Public in and for the State of Texas

] Preliminary Plat (\$200.00 + \$15.00 Acre) 1

### **DEVELOPMENT APPLICATION**

City of Rockwall Planning and Zoning Department 385 S. Goliad Street Rockwall, Texas 75087

STAFF USE ONLY

PLANNING & ZONING CASE NO. SPZOL9 -050.

**NOTE:** THE APPLICATION IS NOT CONSIDERED ACCEPTED BY THE CITY UNTIL THE PLANNING DIRECTOR AND CITY ENGINEER HAVE SIGNED BELOW.

My Commission Expires 0 2-25-20 21

**DIRECTOR OF PLANNING:** 


[ ] Zoning Change (\$200.00 + \$15.00 Acre) 1

CITY ENGINEER:

**Zoning Application Fees:** 

Please check the appropriate box below to indicate the type of development request [SEL	ELECT ONLY ON	IE BOX]:
---	---------------	----------

[ ] Preliminary Plat (\$200.00 + \$15.00 Acre) <sup>1</sup> [ ] Final Plat (\$300.00 + \$20.00 Acre) <sup>1</sup> [ ] Replat (\$300.00 + \$20.00 Acre) <sup>1</sup> [ ] Amending or Minor Plat (\$150.00) [ ] Plat Reinstatement Request (\$100.00)  Site Plan Application Fees: [ Site Plan (\$250.00 + \$20.00 Acre) <sup>1</sup> [ ] Amended Site Plan/Elevations/Landscaping Plan (\$100.00)	[ ] Specific Use Permit (\$200.00 + \$15.00 Acre) <sup>1</sup> [ ] PD Development Plans (\$200.00 + \$15.00 Acre) <sup>1</sup> Other Application Fees: [ ] Tree Removal (\$75.00) [ ] Variance Request (\$100.00)  Notes:  ¹: In determining the fee, please use the exact acreage when multiplying by the per acre amount. For requests on less than one acre, round up to one (1) acre.
PROPERTY INFORMATION [PLEASE PRINT]	
Address Kanch Trail	Rochuall Tx 75032
Subdivision Resimbon Acres	Lot 17 Block
General Location	
ZONING, SITE PLAN AND PLATTING INFORMATION [PL	EASE PRINT]
Current Zoning Commercia	Current Use
Proposed Zoning Commercial	Proposed Use Office
Acreage 7,215 Lots [Curren	
[ ] <u>SITE PLANS AND PLATS</u> : By checking this box you acknowledge that due	to the passage of <u>HB3167</u> the City no longer has flexibility with regard to its approval
process, and failure to address any of staff's comments by the date provide  OWNER/APPLICANT/AGENT INFORMATION [PLEASE PRINT]	
1 Jowner Epic Rockwall Vantures	[ ] Applicant   PAM Sam   Pam and 1 years
Contact Person Wika Da Vi	[ ] Applicant RGM SAID & RENCS LLC Contact Person RSSS RGMSAM
Address 315 Remoh Trail	Address 2235 Ridiza Road
	=33 K101 TE (2003)
City, State & Zip ROCKWAN TY 75032	City, State & Zip Rockwan Ty 75087
Phone 469-774-261/	City, State & Zip Rockwan Tx 75087  Phone 469-792 8869
E-Mail mdas/Esnapmga.co	E-Mail Y ramson e yoho, com
NOTARY VERIFICATION [REQUIRED]  Before me, the undersigned authority, on this day personally appeared this application to be true and certified the following:	[Owner] the undersigned, who stated the information on
triat the City of Rockwall (i.e. "City") is authorized and permitted to provide infor	ition submitted herein is true and correct; and the application fee of \$\frac{390.00}{0.00}\$, to 16.7 day of 100 cember 2012. By signing this application, I agree mation contained within this application to the public. The City is also authorized and this application, if such reproduction is associated or in response to a request for public
Given under my hand and seal of office on this the $16\%$ day of Doce	
Owner's Signature	IDS 1 0 7 8 4 0 4 - 7 COMM. EXP. 02-28-2021

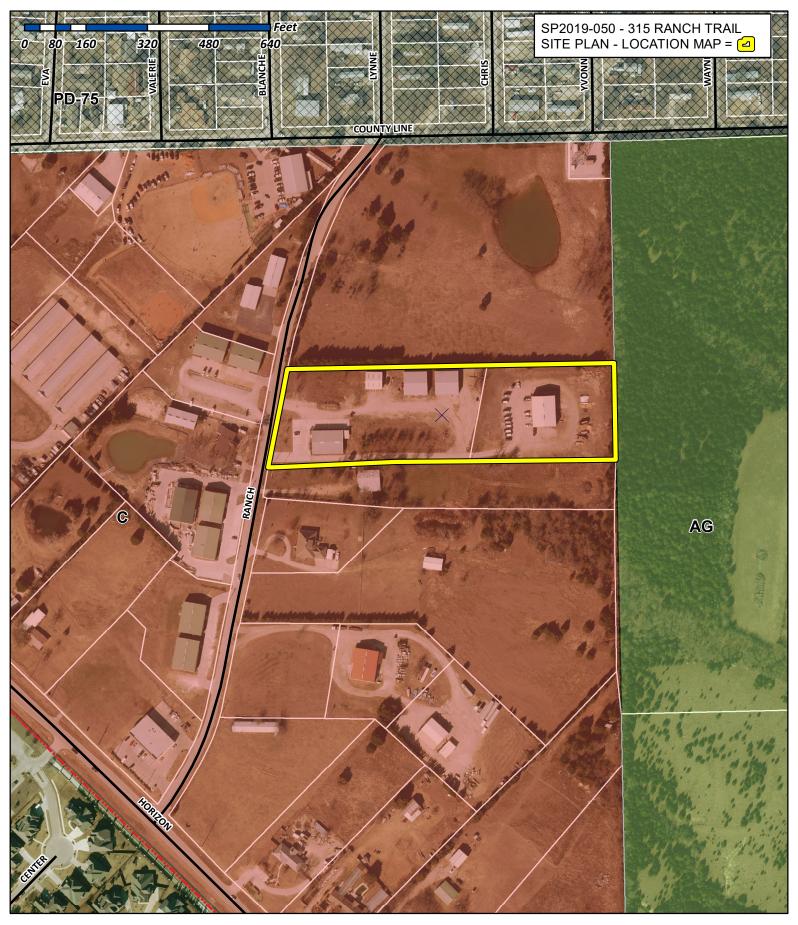





## City of Rockwall Planning & Zoning Department 385 S. Goliad Street

Planning & Zoning Department 385 S. Goliad Street Rockwall, Texas 75032 (P): (972) 771-7745 (W): www.rockwall.com The City of Rockwall GIS maps are continually under development and therefore subject to change without notice. While we endeavor to provide timely and accurate information, we make no guarantees. The City of Rockwall makes no warranty, express or implied, including warranties of merchantability and fitness for a particular purpose. Use of the information is the sole responsibility of the user.




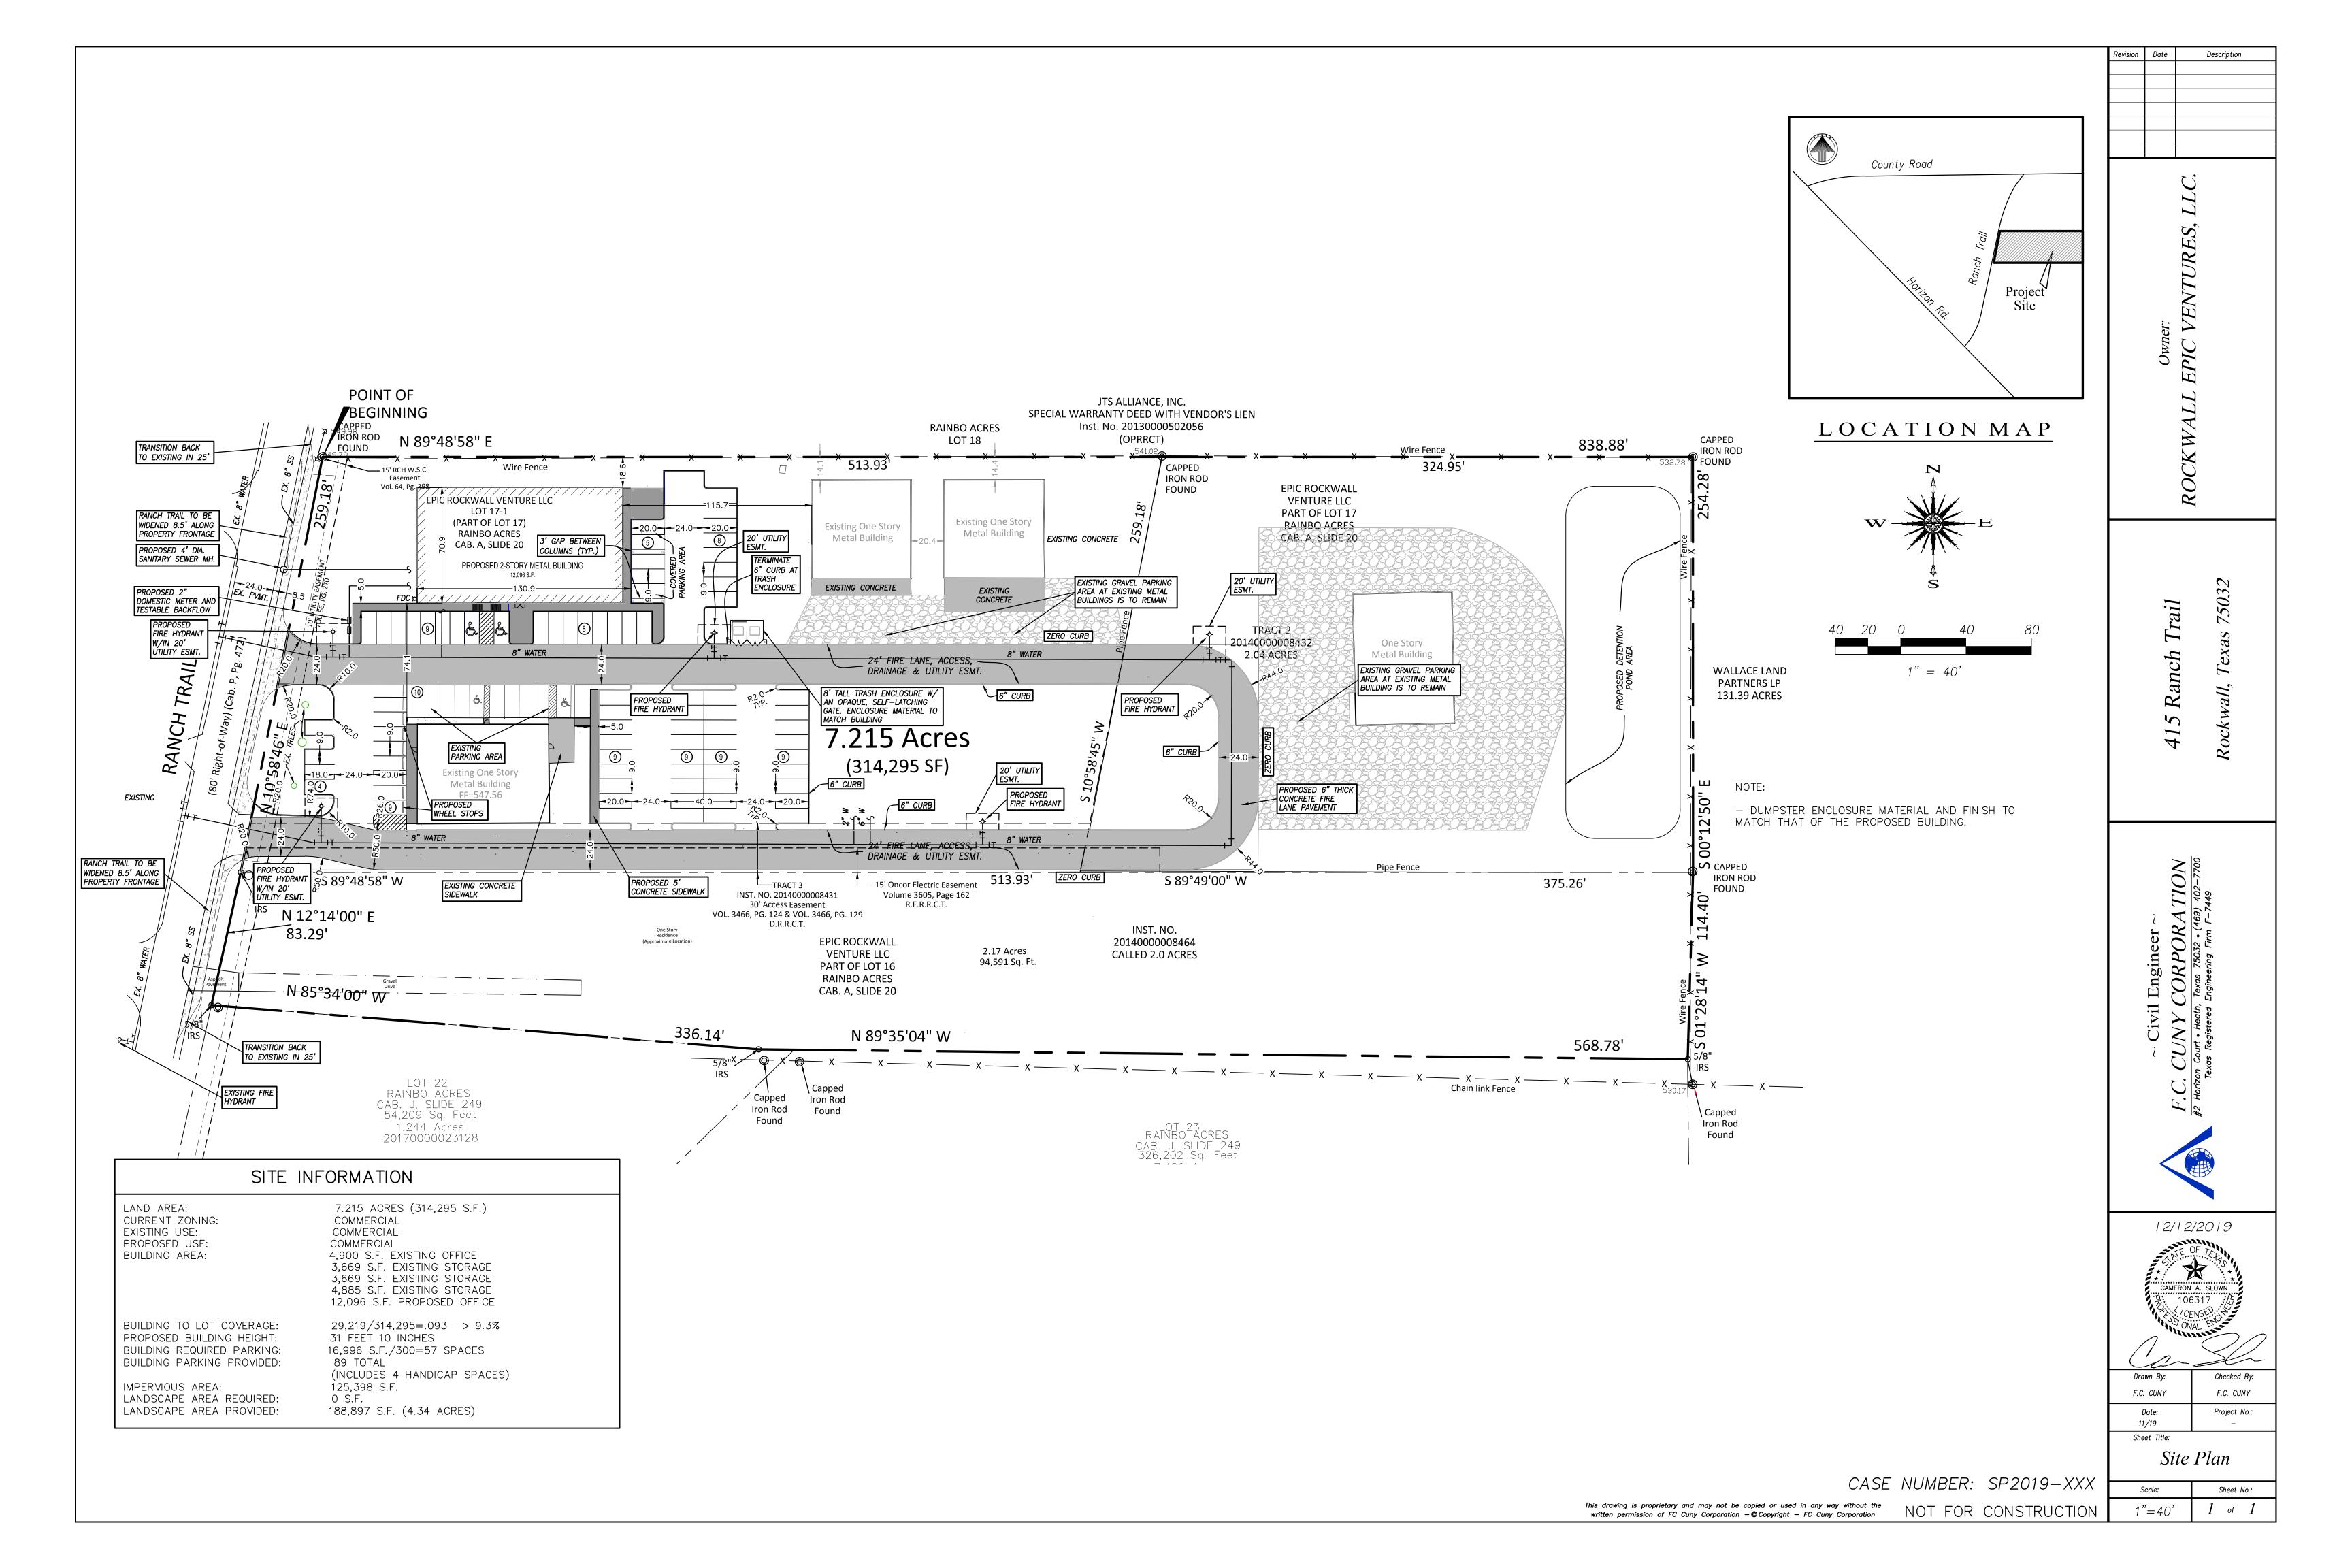

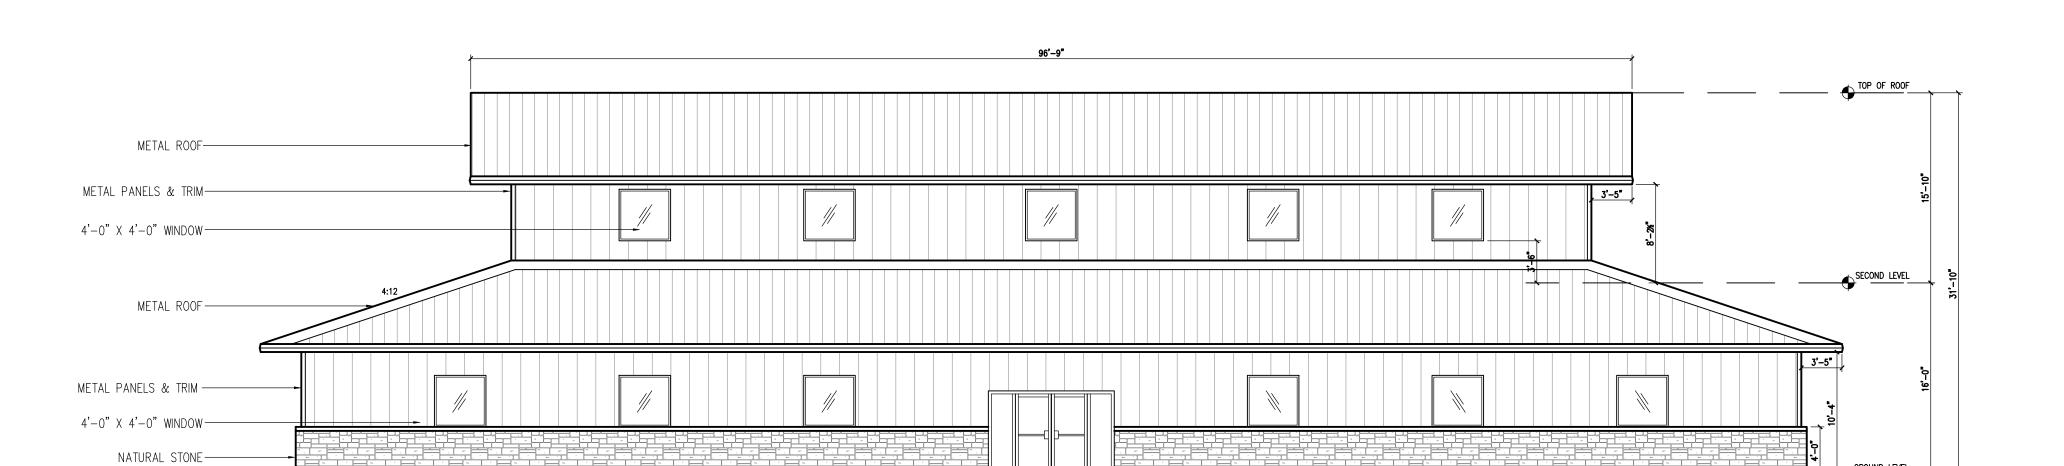


MATERIAL US	AGE (%) - SO	UTH	
ITEM	BRAND / COLOR	AREA S.F.	PERCENT
ELEVATION AREA		1,779	
DOORS & WINDOWS (DEDUCTED)		249	
ACCOUNTABLE AREA		1,530	100%
NATURAL STONE		423	28%
INSULATED METAL PANELS		1,107	72%
	•		

## SOUTH ELEVATION SCALE: 1/8" = 1'

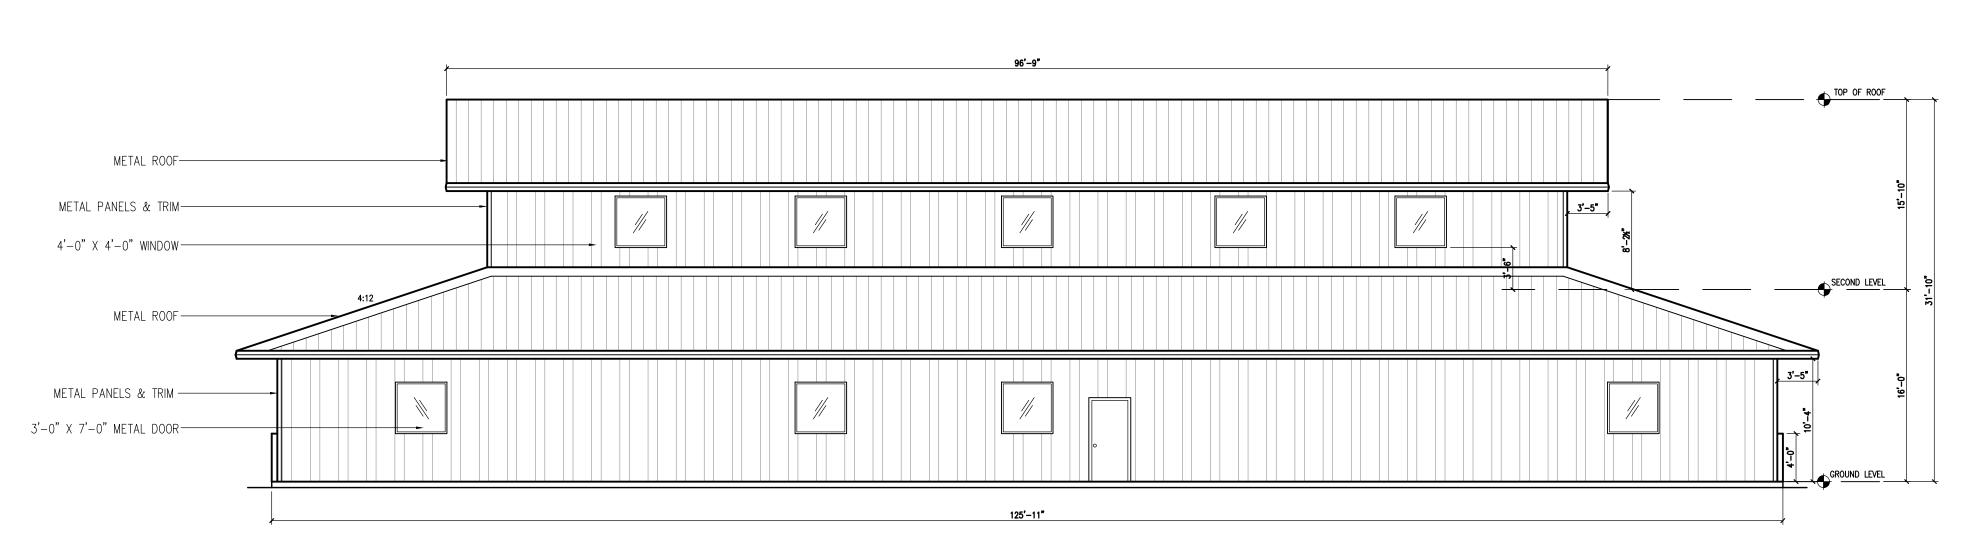

MATERIAL USAGE (%) - NORTH					
ITEM	BRAND / COLOR	AREA S.F.	PERCENT		
ELEVATION AREA		1,779			
DOORS & WINDOWS (DEDUCTED)		170			
ACCOUNTABLE AREA		1,003	100%		
INSULATED METAL PANELS		1,003	100%		

# NORTH ELEVATION SCALE: 1/8" = 1'

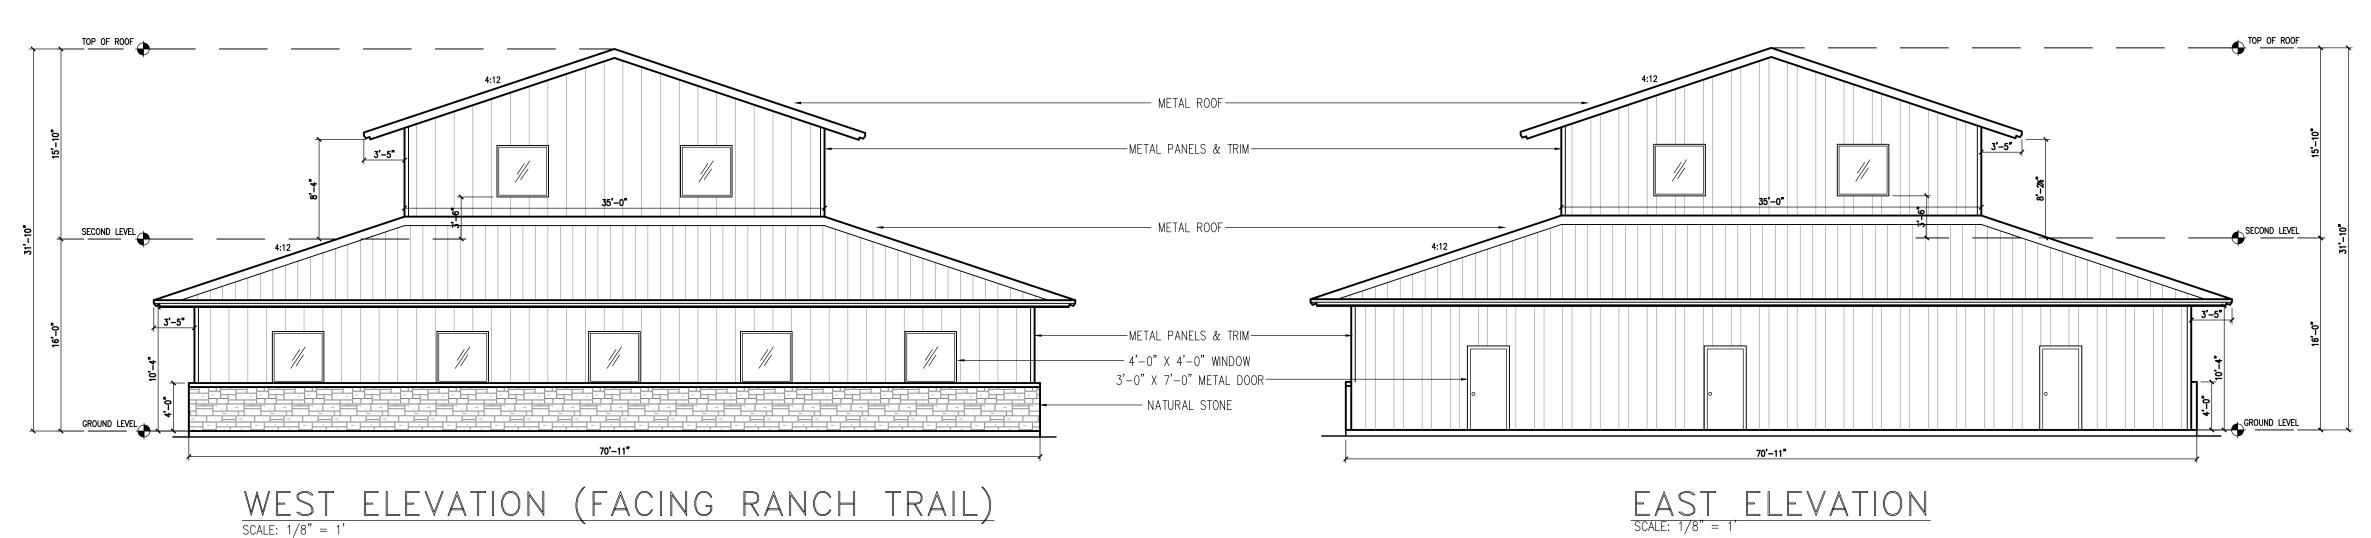

SITE SUMMARY - LIG	HT INDUSTRIAL	
DESCRIPTION		LOT PERCEN <sup>T</sup> AGE
LOT	314,295 S.F.	100 %
IMPERVIOUS	125,398 S.F.	39.9%
PROPOSED BUILDING	12,139 S.F.	3.9%
EXISTING OFFICE	4,900 S.F.	1.5%
EXISTING STORAGE	3,669 S.F.	1.2%
EXISTING STORAGE	3,669 S.F.	1.2%
EXISTING STORAGE	10,900 S.F.	3.4 %
PAVEMENT AREA	41,897 S.F.	43.5 %
PERVIOUS		60.1 %
LANDSCAPE AREA	188,897 S.F.	32.5 %
BUILDING TO LOT COVERAGE	29,219 / 314,295	9.3 %
MAX. BUILDING HEIGHT PROPOSED	31'-10"	
PARKING REQUIREMENTS		
OFFICE (1:300 S.F.)	16,996 S.F.	57
PARKING PROVIDED	4 H.C.	57

WEST	ELEVATION	(FACING	RANCH	TRAIL)
$\overline{SCALE: 1/8" = 1'}$				,

MATERIAL USAGE (%) - WEST				
ITEM	BRAND / COLOR	AREA S.F.	PERCENT	
ELEVATION AREA		1,041		
DOORS & WINDOWS (DEDUCTED)		95		
ACCOUNTABLE AREA		946	100%	
NATURAL STONE		221	23%	
INSULATED METAL PANELS		725	77%	

MATERIAL USAGE (%) - EAST				
ITEM	BRAND / COLOR	AREA S.F.	PERCENT	
ELEVATION AREA		1,041		
DOORS & WINDOWS (DEDUCTED)		112		
ACCOUNTABLE AREA		929	100%	
INSULATED METAL PANELS		929	100%	




VENTURES, 415 RANCH TRAIL ROCKWALL, TEXAS 75032 ROCKWALL


PROJECT No. CHECKED BY 12/13/19 1/8"=1'-0" SHEET NO.

DRAWING NAME:


BUILDING ELEVATION




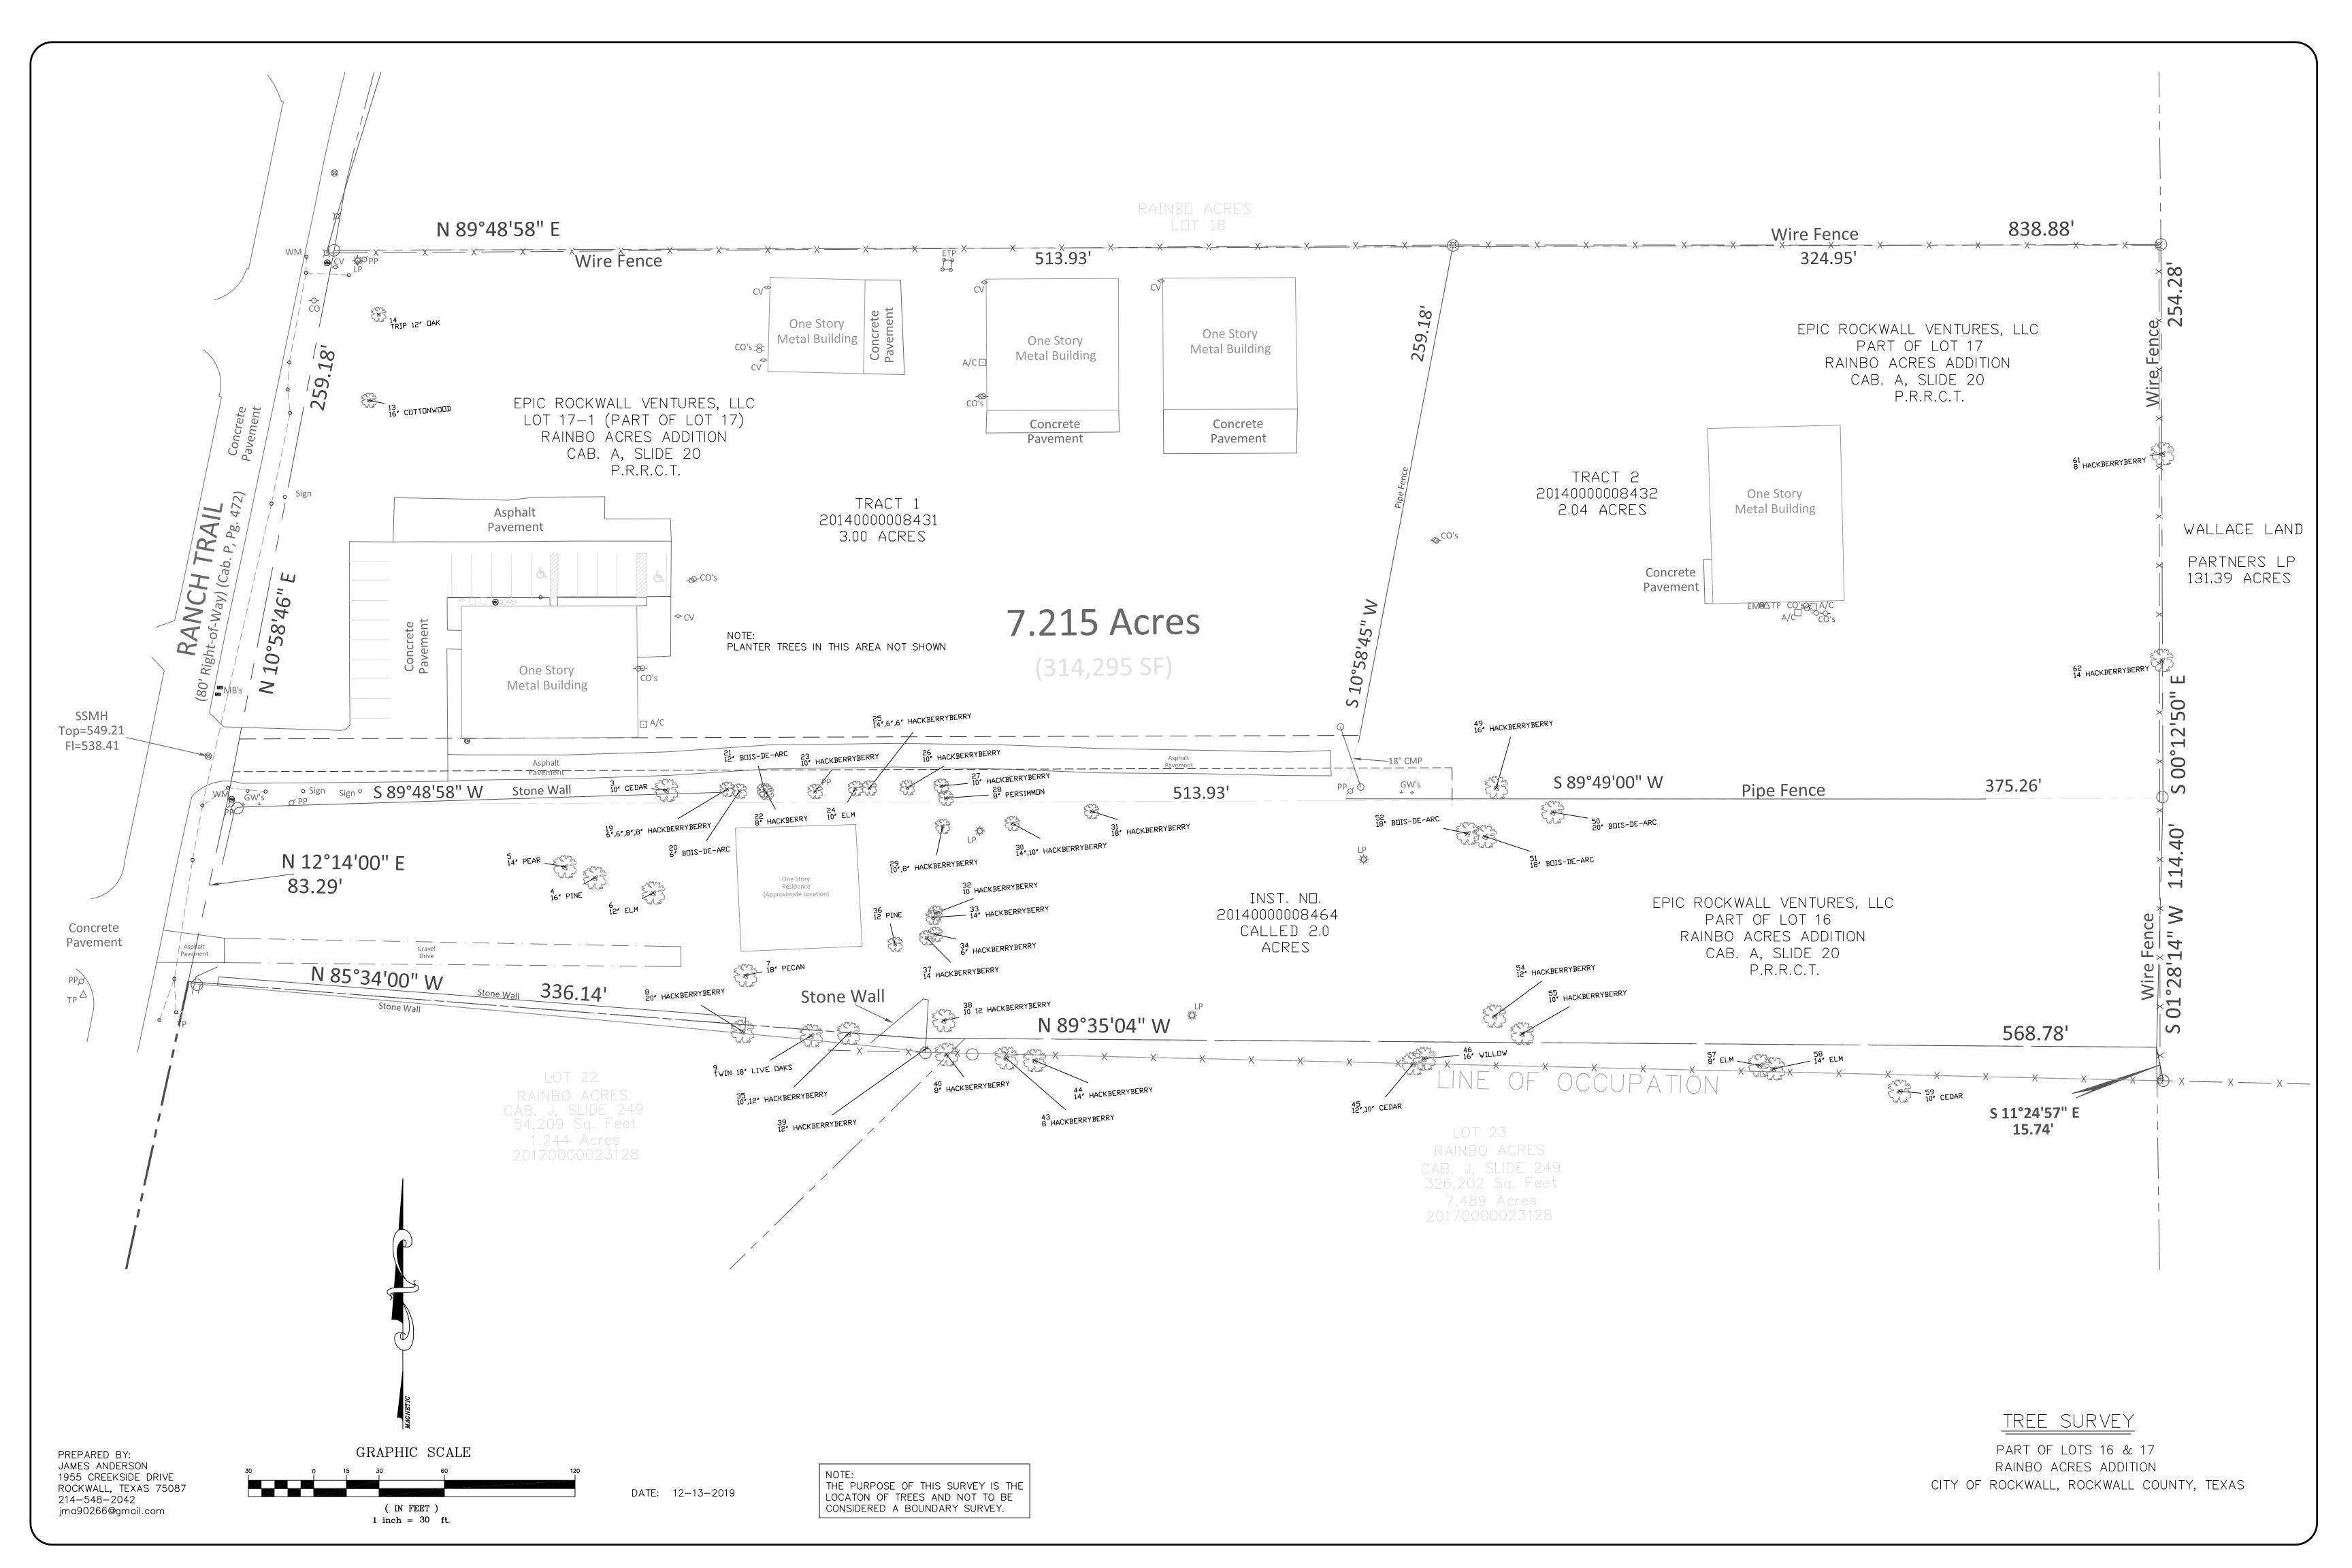

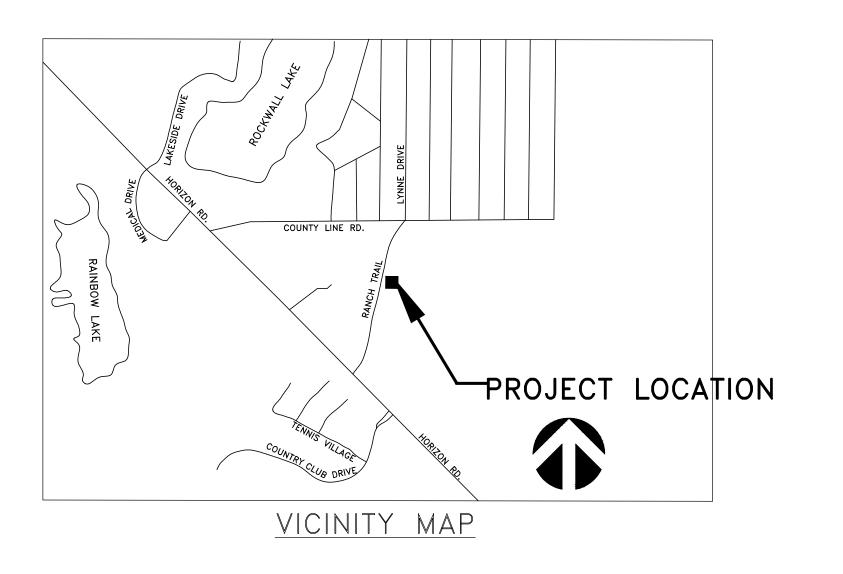

SITE SUMMARY - LIG	HT INDUSTRIAL	
DESCRIPTION		LOT PERCEN AGE
LOT	314,295 S.F.	100 %
IMPERVIOUS	125,398 S.F.	39.9%
PROPOSED BUILDING	12,139 S.F.	3.9%
EXISTING OFFICE	4,900 S.F.	1.5%
EXISTING STORAGE	3,669 S.F.	1.2%
EXISTING STORAGE	3,669 S.F.	1.2%
EXISTING STORAGE	10,900 S.F.	3.4 %
PAVEMENT AREA	41,897 S.F.	43.5 %
PERVIOUS		60.1 %
LANDSCAPE AREA	188,897 S.F.	32.5 %
BUILDING TO LOT COVERAGE	29,219 / 314,295	9.3 %
MAX. BUILDING HEIGHT PROPOSED	31'-10"	
PARKING REQUIREMENTS		
OFFICE (1:300 S.F.)	16,996 S.F.	57
PARKING PROVIDED	4 H.C.	57

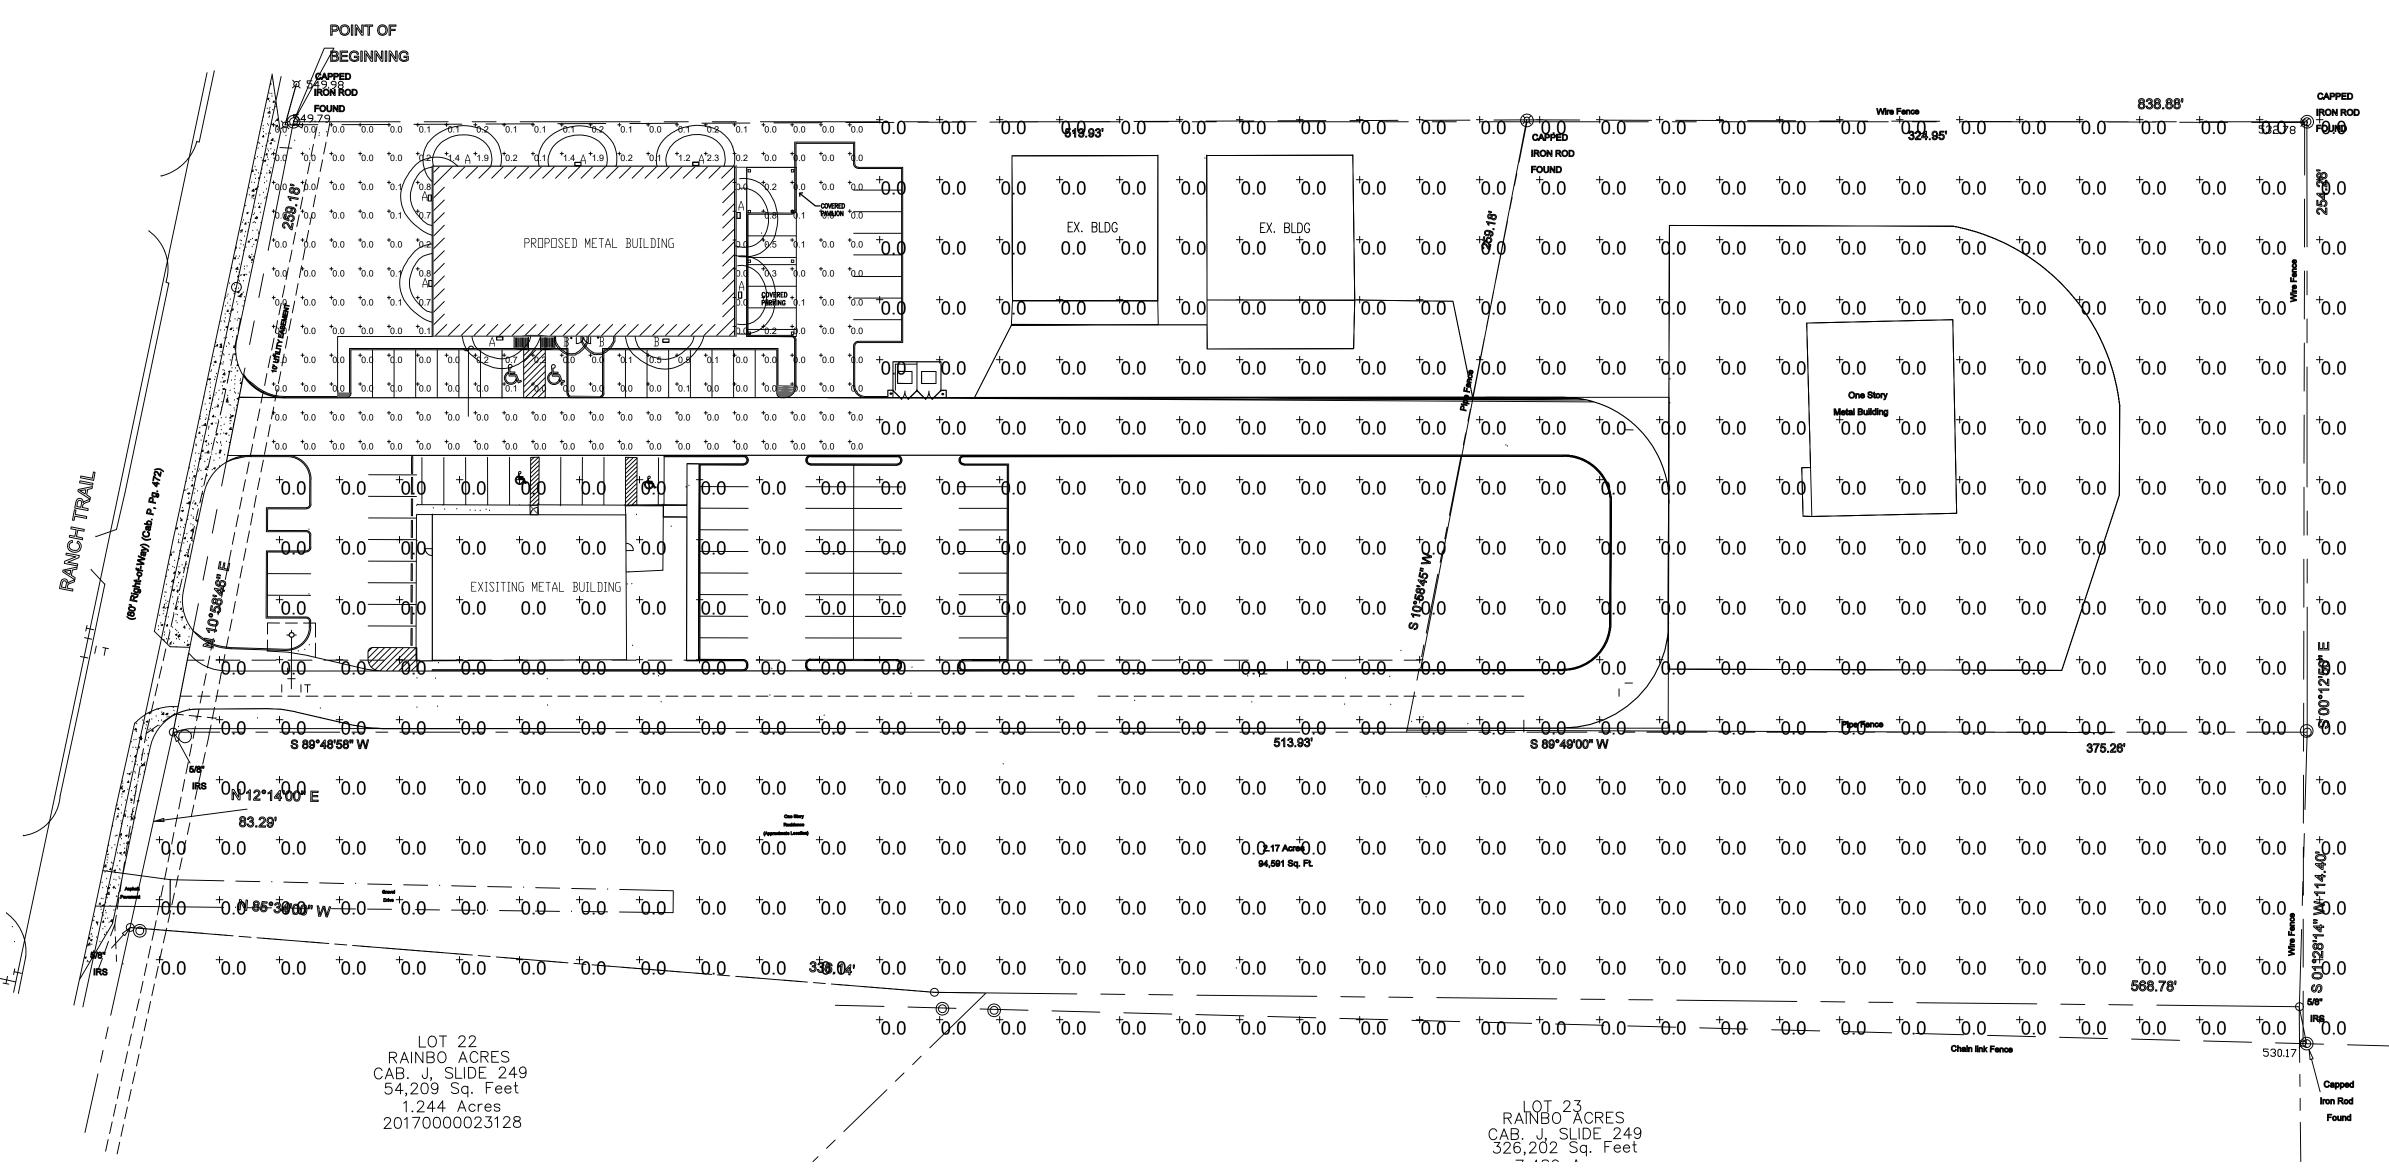

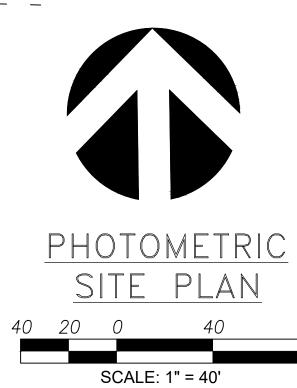



ROCKWALL, TEXAS 75032

CHECKED BY

SHEET NO.

DRAWING NAME:


PHOTOMETRIC

SITE PLAN

11.14.19

1/8"=1'-0"

of

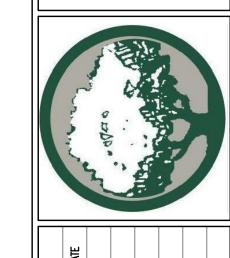

VENTUR

Ŏ

PROJECT No.

DRAWN BY

CHECKED BY

SHEET NO.

DRAWING NAME:

SCALE

AIL 75032

ANCH TEXA

415 F ROCKWALI

SR

RR

11.14.19 1/8"=1'-0"

of

FIXTURE 'B' **Security**Brands.

Page 1 of 3

**g** gotham

ONE 150-WATT PAR-38 SPOT INCANDESCENT,

LUMINOUS OPENING: CIRCULAR (DIA: 5.16") TER VALUE: 9 (BF = 1)TER CATEGORY: CYLINDER CIE CLASS: DIRECT 10,268.0 AT HORIZONTAL: 0°, VERTICAL: 0° MAX CD: SPACING CRITERION: @ 0 = 0.3 / @ 90 = 0.3


VERTICAL BASE-UP POSITION.

1 LAMP, RATED LUMENS/LAMP: 1740

ACUITY BRANDS LIGHTING CONYERS LAB

CA6 6"OPEN CYLINDER WITH BLACK MICROGROOVE

**EFFICIENCY:** 74.4% Polar Candela Distribution 180° 170° 160° 150° 140° 11,0009,167 7,333 -5,500 3,667

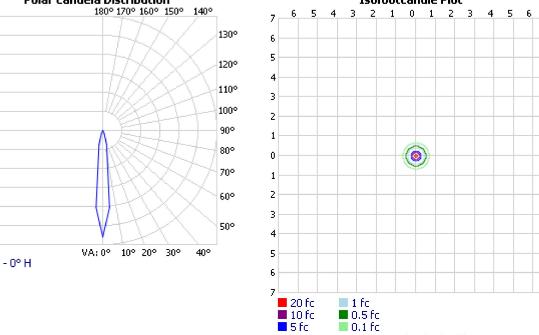

VISUAL PHOTOMETRIC TOOL 1.2.46 COPYRIGHT 2019, ACUITY BRANDS LIGHTING. THIS PHOTOMETRIC REPORT HAS BEEN GENERATED USING METHODS RECOMMENDED BY THE IESNA. CALCULATIONS ARE BASED ON PHOTOMETRIC DATA PROVIDED BY THE MANUFACTURER, AND THE ACCURACY OF THIS PHOTOMETRIC REPORT IS DEPENDENT ON THE ACCURACY OF THE DATA PROVIDED. END-USER ENVIRONMENT AND APPLICATION (INCLUDING, BUT NOT LIMITED TO, VOLTAGE VARIATION AND DIRT ACCUMULATION) CAN CAUSE ACTUAL PHOTOMETRIC PERFORMANCE TO DIFFER FROM THE PERFORMANCE CALCULATED USING THE DATA PROVIDED BY THE MANUFACTURER. THIS REPORT IS PROVIDED WITHOUT WARRANTY AS TO ACCURACY, COMPLETENESS, RELIABILITY OR OTHERWISE. IN NO EVENT WILL ACUITY BRANDS LIGHTING BE RESPONSIBLE FOR ANY LOSS RESULTING FROM ANY USE OF THIS REPORT. PUBLISH

Distance in units of mount height (20ft)

43080 VISUAL PHOTOMETRIC TOOL

LIGHT **FIXTURES** 

PAGE 1 OF 3

EXTERIOR



CA6 6MB (PAR38/SP)

TEST #:

TEST LAB:

TEST DATE:

CATALOG:

SERIES:

LAMP:

**DESCRIPTION:** 

LAMP OUTPUT:

1,833 —

1,833 —

3,667 5,500

7,333 —

9,167

11,000 🗀

0.00

INPUT WATTAGE: 150

INDOOR PHOTOMETRIC REPORT CATALOG: CA6 6MB (PAR38/SP)

43080

1/31/2008

CA6

CA6 6MB (PAR38/SP)

Light engines are available in 3000K and 4000K CCTs. See Lighting Facts label and photometry reports for specific fixture performance. LED technology provides long operating life (L70/50,000 hours at 25°C). Electronic drivers have a power factor >90% and THD <20% and a minimum 2.5kV surge rating.

One Lithonia Way • Conyers, Georgia 30012 • Phone: 800.705.7378 • www.lithonia.com

© 2017-2019 Acuity Brands Lighting, Inc. All rights reserved.

LITHONIA LIGHTING.


COMMERCIAL OUTDOOR

### 5-year limited warranty. Complete warranty terms located at:

**Note:** Actual performance may differ as a result of end-user environment and application. All values are design or typical values, measured under laboratory conditions at 25°C. Specifications subject to change without notice.

LIL LED Rev. 08/19/19

http://www.visual-3d.com/Tools/PhotometricViewer/Default.aspx?GUID=6087be34-571... 11/15/2019

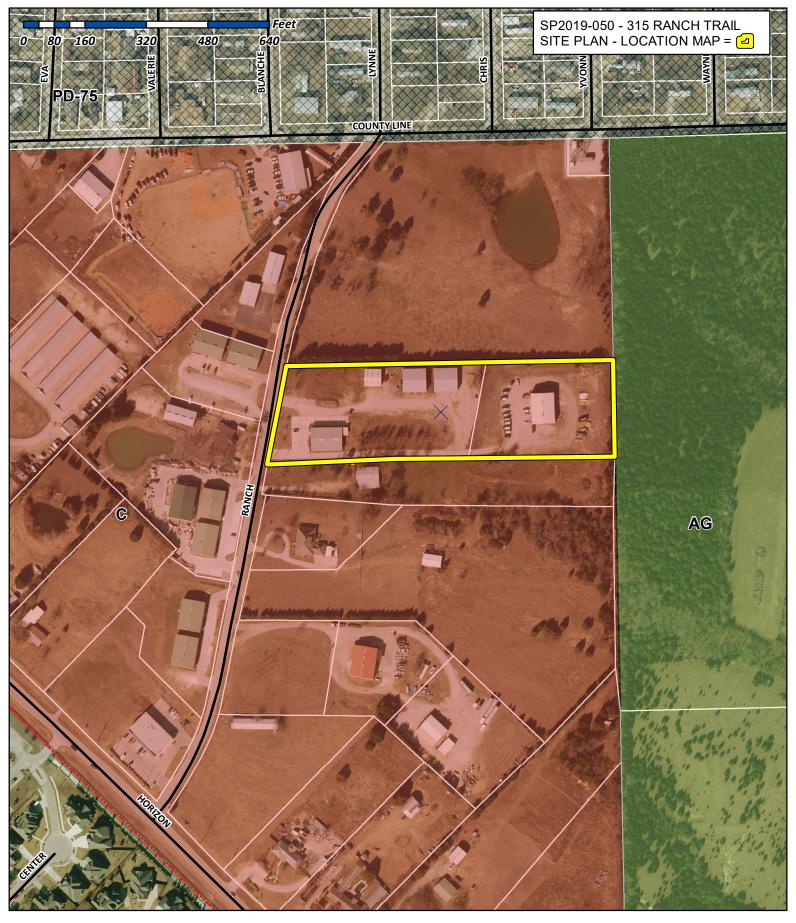



## City of Rockwall Planning & Zoning Department 385 S. Goliad Street

Planning & Zoning Department 385 S. Goliad Street Rockwall, Texas 75032 (P): (972) 771-7745 (W): www.rockwall.com The City of Rockwall GIS maps are continually under development and therefore subject to change without notice. While we endeavor to provide timely and accurate information, we make no guarantees. The City of Rockwall makes no warranty, express or implied, including warranties of merchantability and fitness for a particular purpose. Use of the information is the sole responsibility of the user.





#### **DEVELOPMENT APPLICATION**

City of Rockwall Planning and Zoning Department 385 S. Goliad Street Rockwall, Texas 75087

STA	FF	USE	ONLY	

PLANNING & ZONING CASE NO. SPZ 019

**NOTE:** THE APPLICATION IS NOT CONSIDERED ACCEPTED BY THE CITY UNTIL THE PLANNING DIRECTOR AND CITY ENGINEER HAVE SIGNED BELOW.

**DIRECTOR OF PLANNING:** 

CITY ENGINEER:


lease check the appropriate box below to indicate the typ	e of development request [SELECT ONLY ONE BOX]:
Platting Application Fees:  [] Master Plat (\$100.00 + \$15.00 Acre) <sup>1</sup> [] Preliminary Plat (\$200.00 + \$15.00 Acre) <sup>1</sup> [] Final Plat (\$300.00 + \$20.00 Acre) <sup>1</sup> [] Replat (\$300.00 + \$20.00 Acre) <sup>1</sup> [] Amending or Minor Plat (\$150.00)  [] Plat Reinstatement Request (\$100.00)	Zoning Application Fees:  [ ] Zoning Change (\$200.00 + \$15.00 Acre) <sup>1</sup> [ ] Specific Use Permit (\$200.00 + \$15.00 Acre) <sup>1</sup> [ ] PD Development Plans (\$200.00 + \$15.00 Acre) <sup>1</sup> Other Application Fees:  [ ] Tree Removal (\$75.00)


[	] Variance Request (\$1	.00.00)		
N	otes:			

Site Plan Application Fees:  [ Site Plan (\$250.00 + \$20.00 Acre) 1  [ ] Amended Site Plan/Elevations/Landscaping Plan (\$100.00)	Notes:  1: In determining the fee, please use the exact acreage when multiplying by the per acre amount. For requests on less than one acre, round up to one (1) acre.
PROPERTY INFORMATION [PLEASE PRINT]  Address Ranch Trail  Subdivision Resimbon Acres  General Location	Rachwall Tx 75032 Lot 17 Block
ZONING, SITE PLAN AND PLATTING INFORMATION [PL	LEASE PRINT)
Current Zoning Commercia	Current Use Office
Proposed Zoning Commercia	Proposed Use Office
Acreage 7,2)5 Lots [Curren	
[ ] <u>SITE PLANS AND PLATS</u> : By checking this box you acknowledge that due process, and failure to address any of staff's comments by the date provide	to the passage of <u>HB3167</u> the City no longer has flexibility with regard to its approvaled on the Development Calendar will result in the denial of your case.
OWNER/APPLICANT/AGENT INFORMATION [PLEASE PRIN	
Contact Person Wike Dalli Address 315 Ramch Trail	[] Applicant Ramsan & Renes LLC Contact Person Ross Ramsan Address ZZ35 Ridza Road
City, State & Zip ROCKWAN TY 75032	City, State & Zip Reckwan Tx 75087
Phone 469-774-2611	Phone 469 7 7 GZ CEEB
E-Mail modac/Esnapmga. Co-	E-Mail & Vamsan e yaho, com
NOTARY VERIFICATION [REQUIRED]  Before me, the undersigned authority, on this day personally appeared this application to be true and certified the following:	[Owner] the undersigned, who stated the information on
that the City of Rockwall (i.e. "City") is authorized and permitted to provide infor	ation submitted berein is true and correct; and the application fee of § $390.00$ , to $16.7$ day of December , 20 $17$ . By signing this application, I agree rmation contained within this application to the public. The City is also authorized and h this application, if such reproduction is associated or in response to a request for public
Given under my hand and seal of office on this the 16th day of Doce	ELIZABETH A. MORGAN NOTARY PUBLIC - STATE OF TEXAS

Notary Public in and for the State of Texas


My Commission Expires 0 2-25-20 21

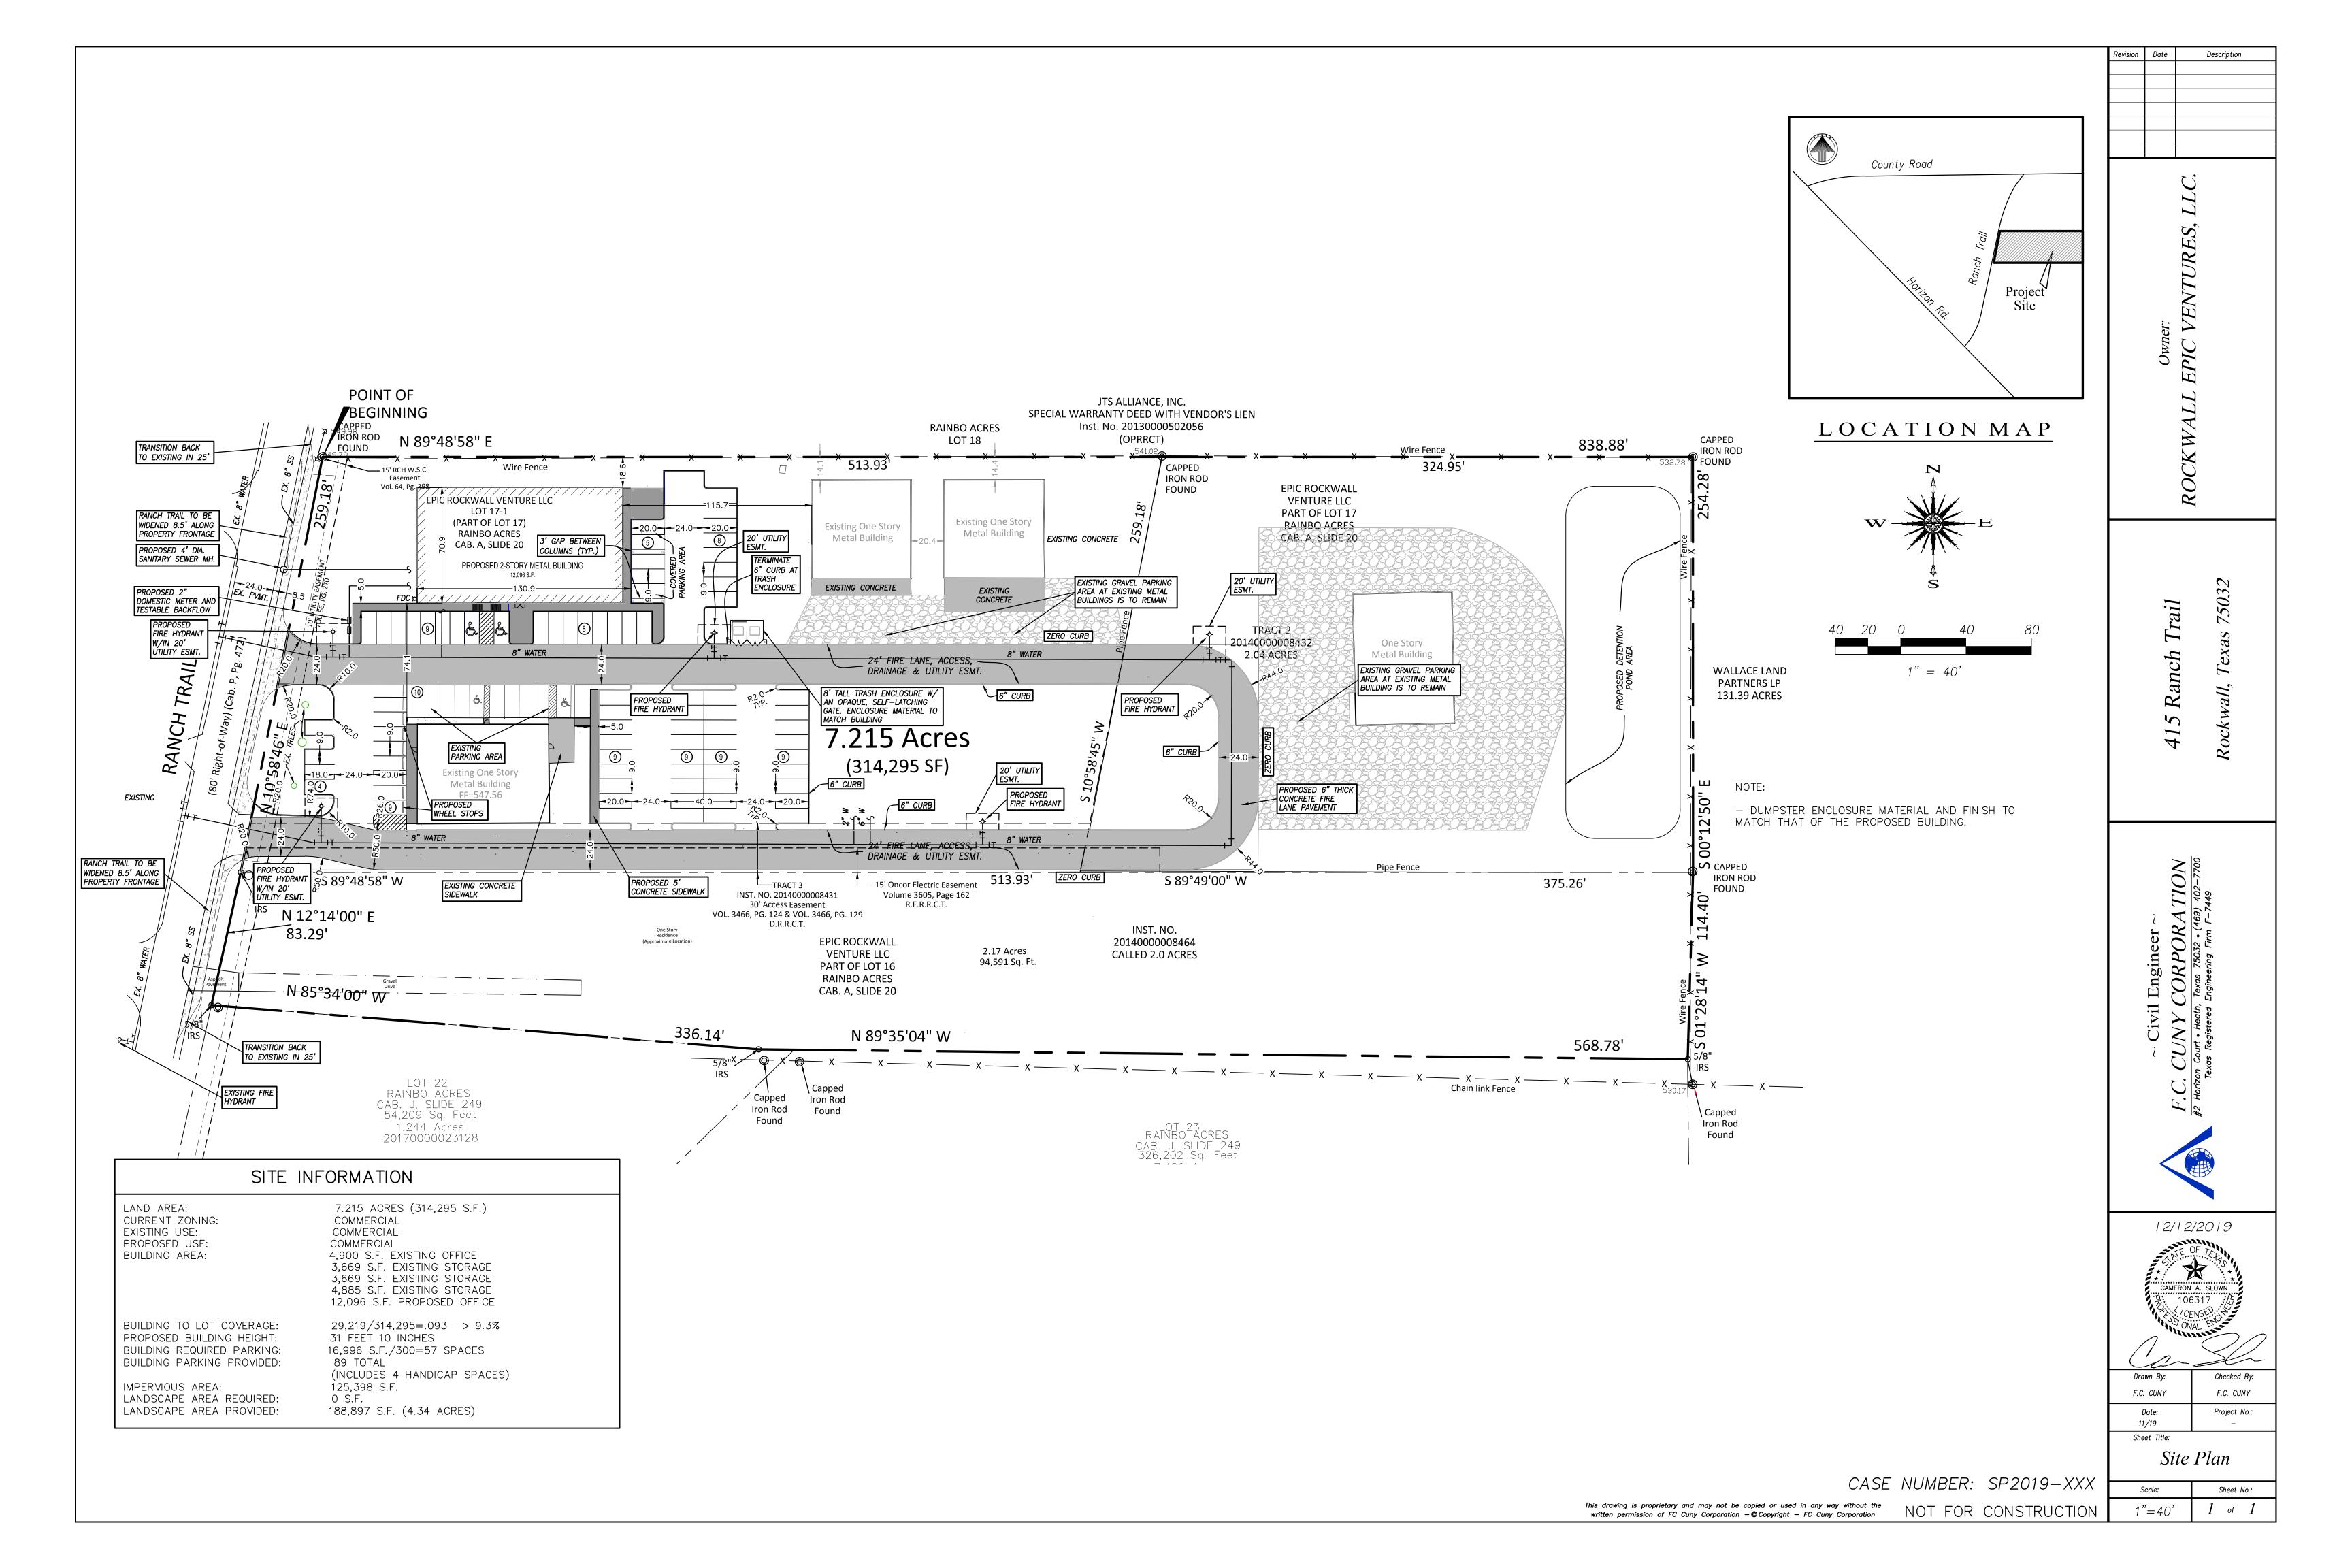

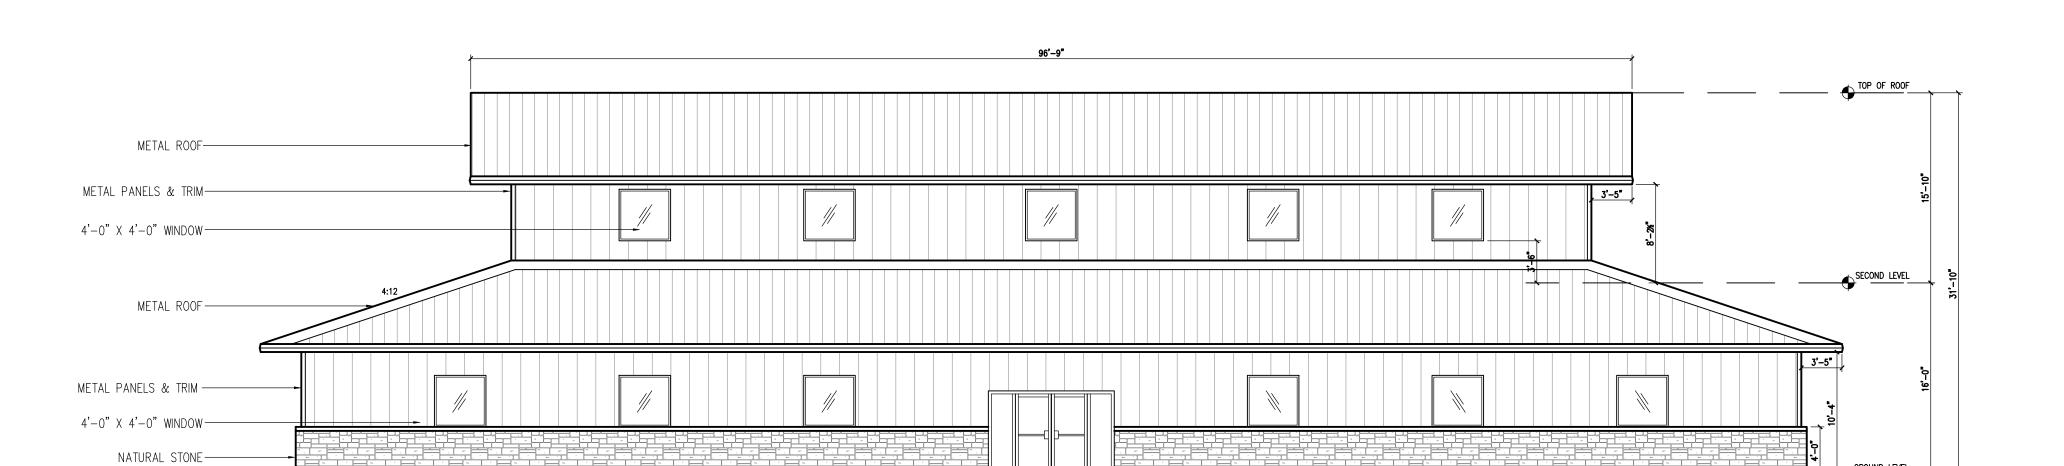


MATERIAL US	AGE (%) - SO	UTH	
ITEM	BRAND / COLOR	AREA S.F.	PERCENT
ELEVATION AREA		1,779	
DOORS & WINDOWS (DEDUCTED)		249	
ACCOUNTABLE AREA		1,530	100%
NATURAL STONE		423	28%
INSULATED METAL PANELS		1,107	72%
	•		

## SOUTH ELEVATION SCALE: 1/8" = 1'

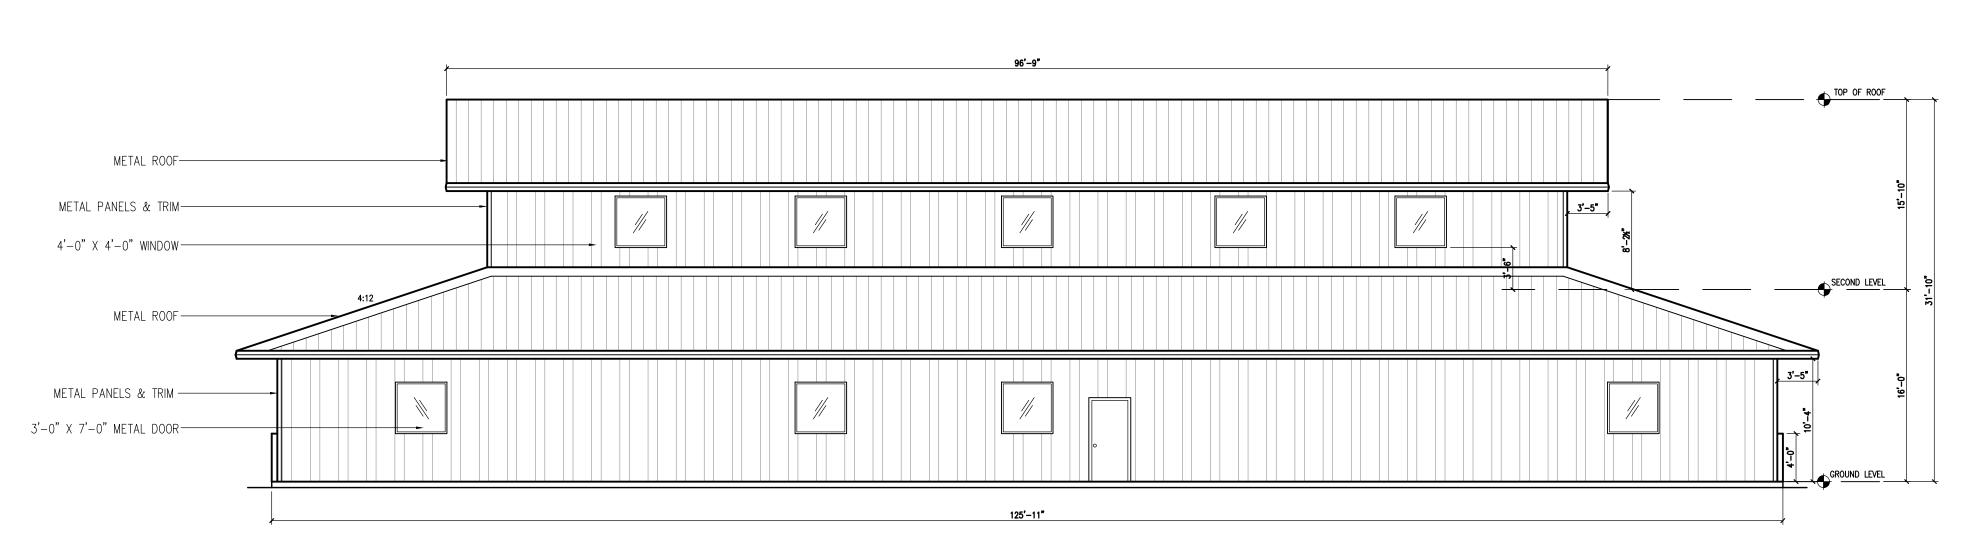

MATERIAL USAGE (%) - NORTH					
ITEM	BRAND / COLOR	AREA S.F.	PERCENT		
ELEVATION AREA		1,779			
DOORS & WINDOWS (DEDUCTED)		170			
ACCOUNTABLE AREA		1,003	100%		
INSULATED METAL PANELS		1,003	100%		

# NORTH ELEVATION SCALE: 1/8" = 1'

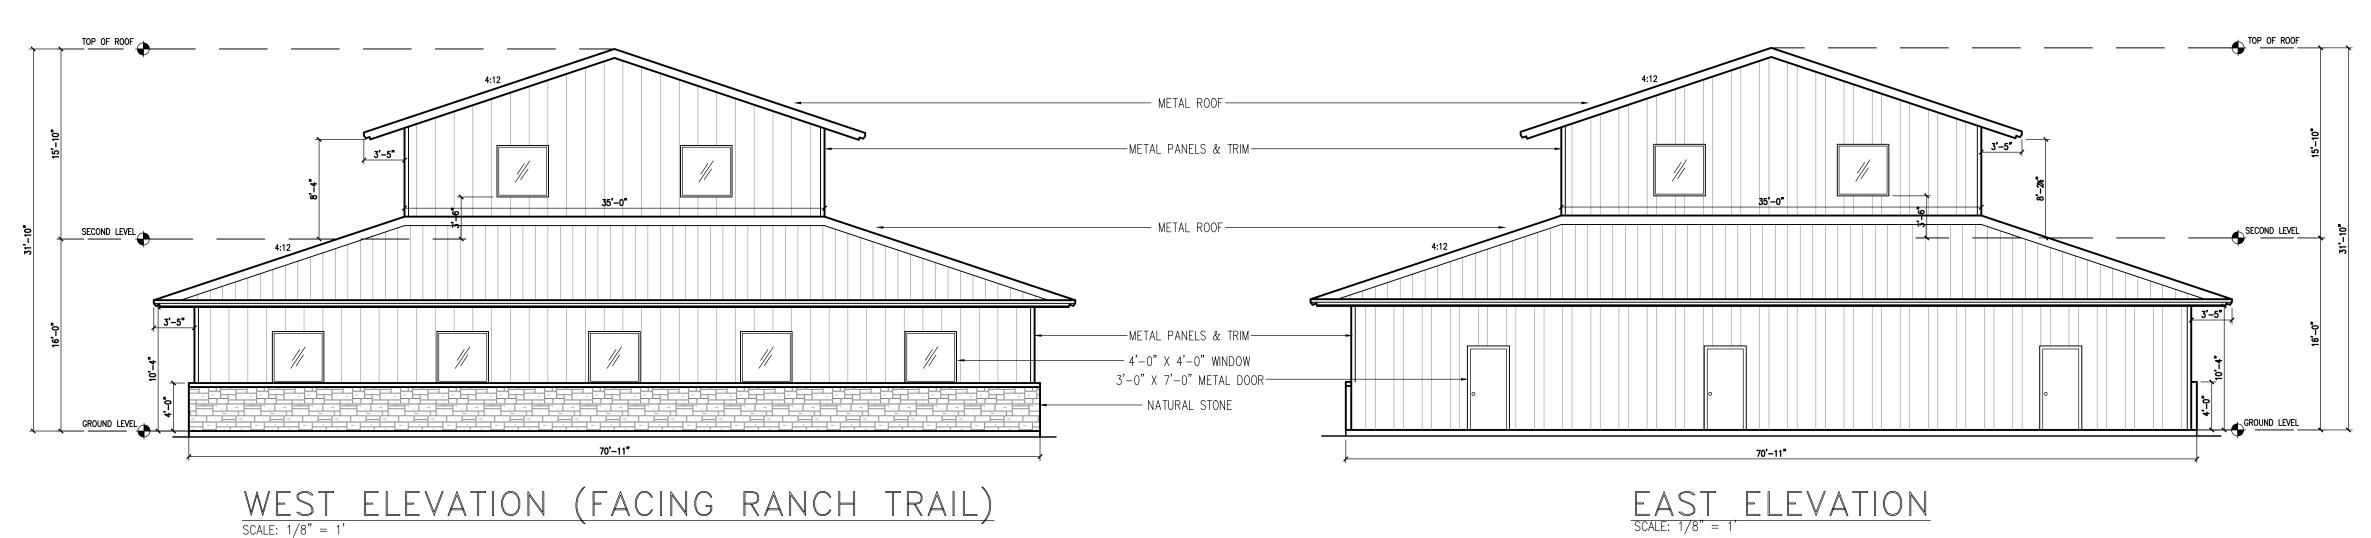

SITE SUMMARY - LIG	HT INDUSTRIAL	
DESCRIPTION		LOT PERCEN <sup>T</sup> AGE
LOT	314,295 S.F.	100 %
IMPERVIOUS	125,398 S.F.	39.9%
PROPOSED BUILDING	12,139 S.F.	3.9%
EXISTING OFFICE	4,900 S.F.	1.5%
EXISTING STORAGE	3,669 S.F.	1.2%
EXISTING STORAGE	3,669 S.F.	1.2%
EXISTING STORAGE	10,900 S.F.	3.4 %
PAVEMENT AREA	41,897 S.F.	43.5 %
PERVIOUS		60.1 %
LANDSCAPE AREA	188,897 S.F.	32.5 %
BUILDING TO LOT COVERAGE	29,219 / 314,295	9.3 %
MAX. BUILDING HEIGHT PROPOSED	31'-10"	
PARKING REQUIREMENTS		
OFFICE (1:300 S.F.)	16,996 S.F.	57
PARKING PROVIDED	4 H.C.	57

WEST	ELEVATION	(FACING	RANCH	TRAIL)
$\overline{SCALE: 1/8" = 1'}$				,

MATERIAL USAGE (%) - WEST				
ITEM	BRAND / COLOR	AREA S.F.	PERCENT	
ELEVATION AREA		1,041		
DOORS & WINDOWS (DEDUCTED)		95		
ACCOUNTABLE AREA		946	100%	
NATURAL STONE		221	23%	
INSULATED METAL PANELS		725	77%	

MATERIAL USAGE (%) - EAST				
ITEM	BRAND / COLOR	AREA S.F.	PERCENT	
ELEVATION AREA		1,041		
DOORS & WINDOWS (DEDUCTED)		112		
ACCOUNTABLE AREA		929	100%	
INSULATED METAL PANELS		929	100%	




VENTURES, 415 RANCH TRAIL ROCKWALL, TEXAS 75032 ROCKWALL


PROJECT No. CHECKED BY 12/13/19 1/8"=1'-0" SHEET NO.

DRAWING NAME:


BUILDING ELEVATION




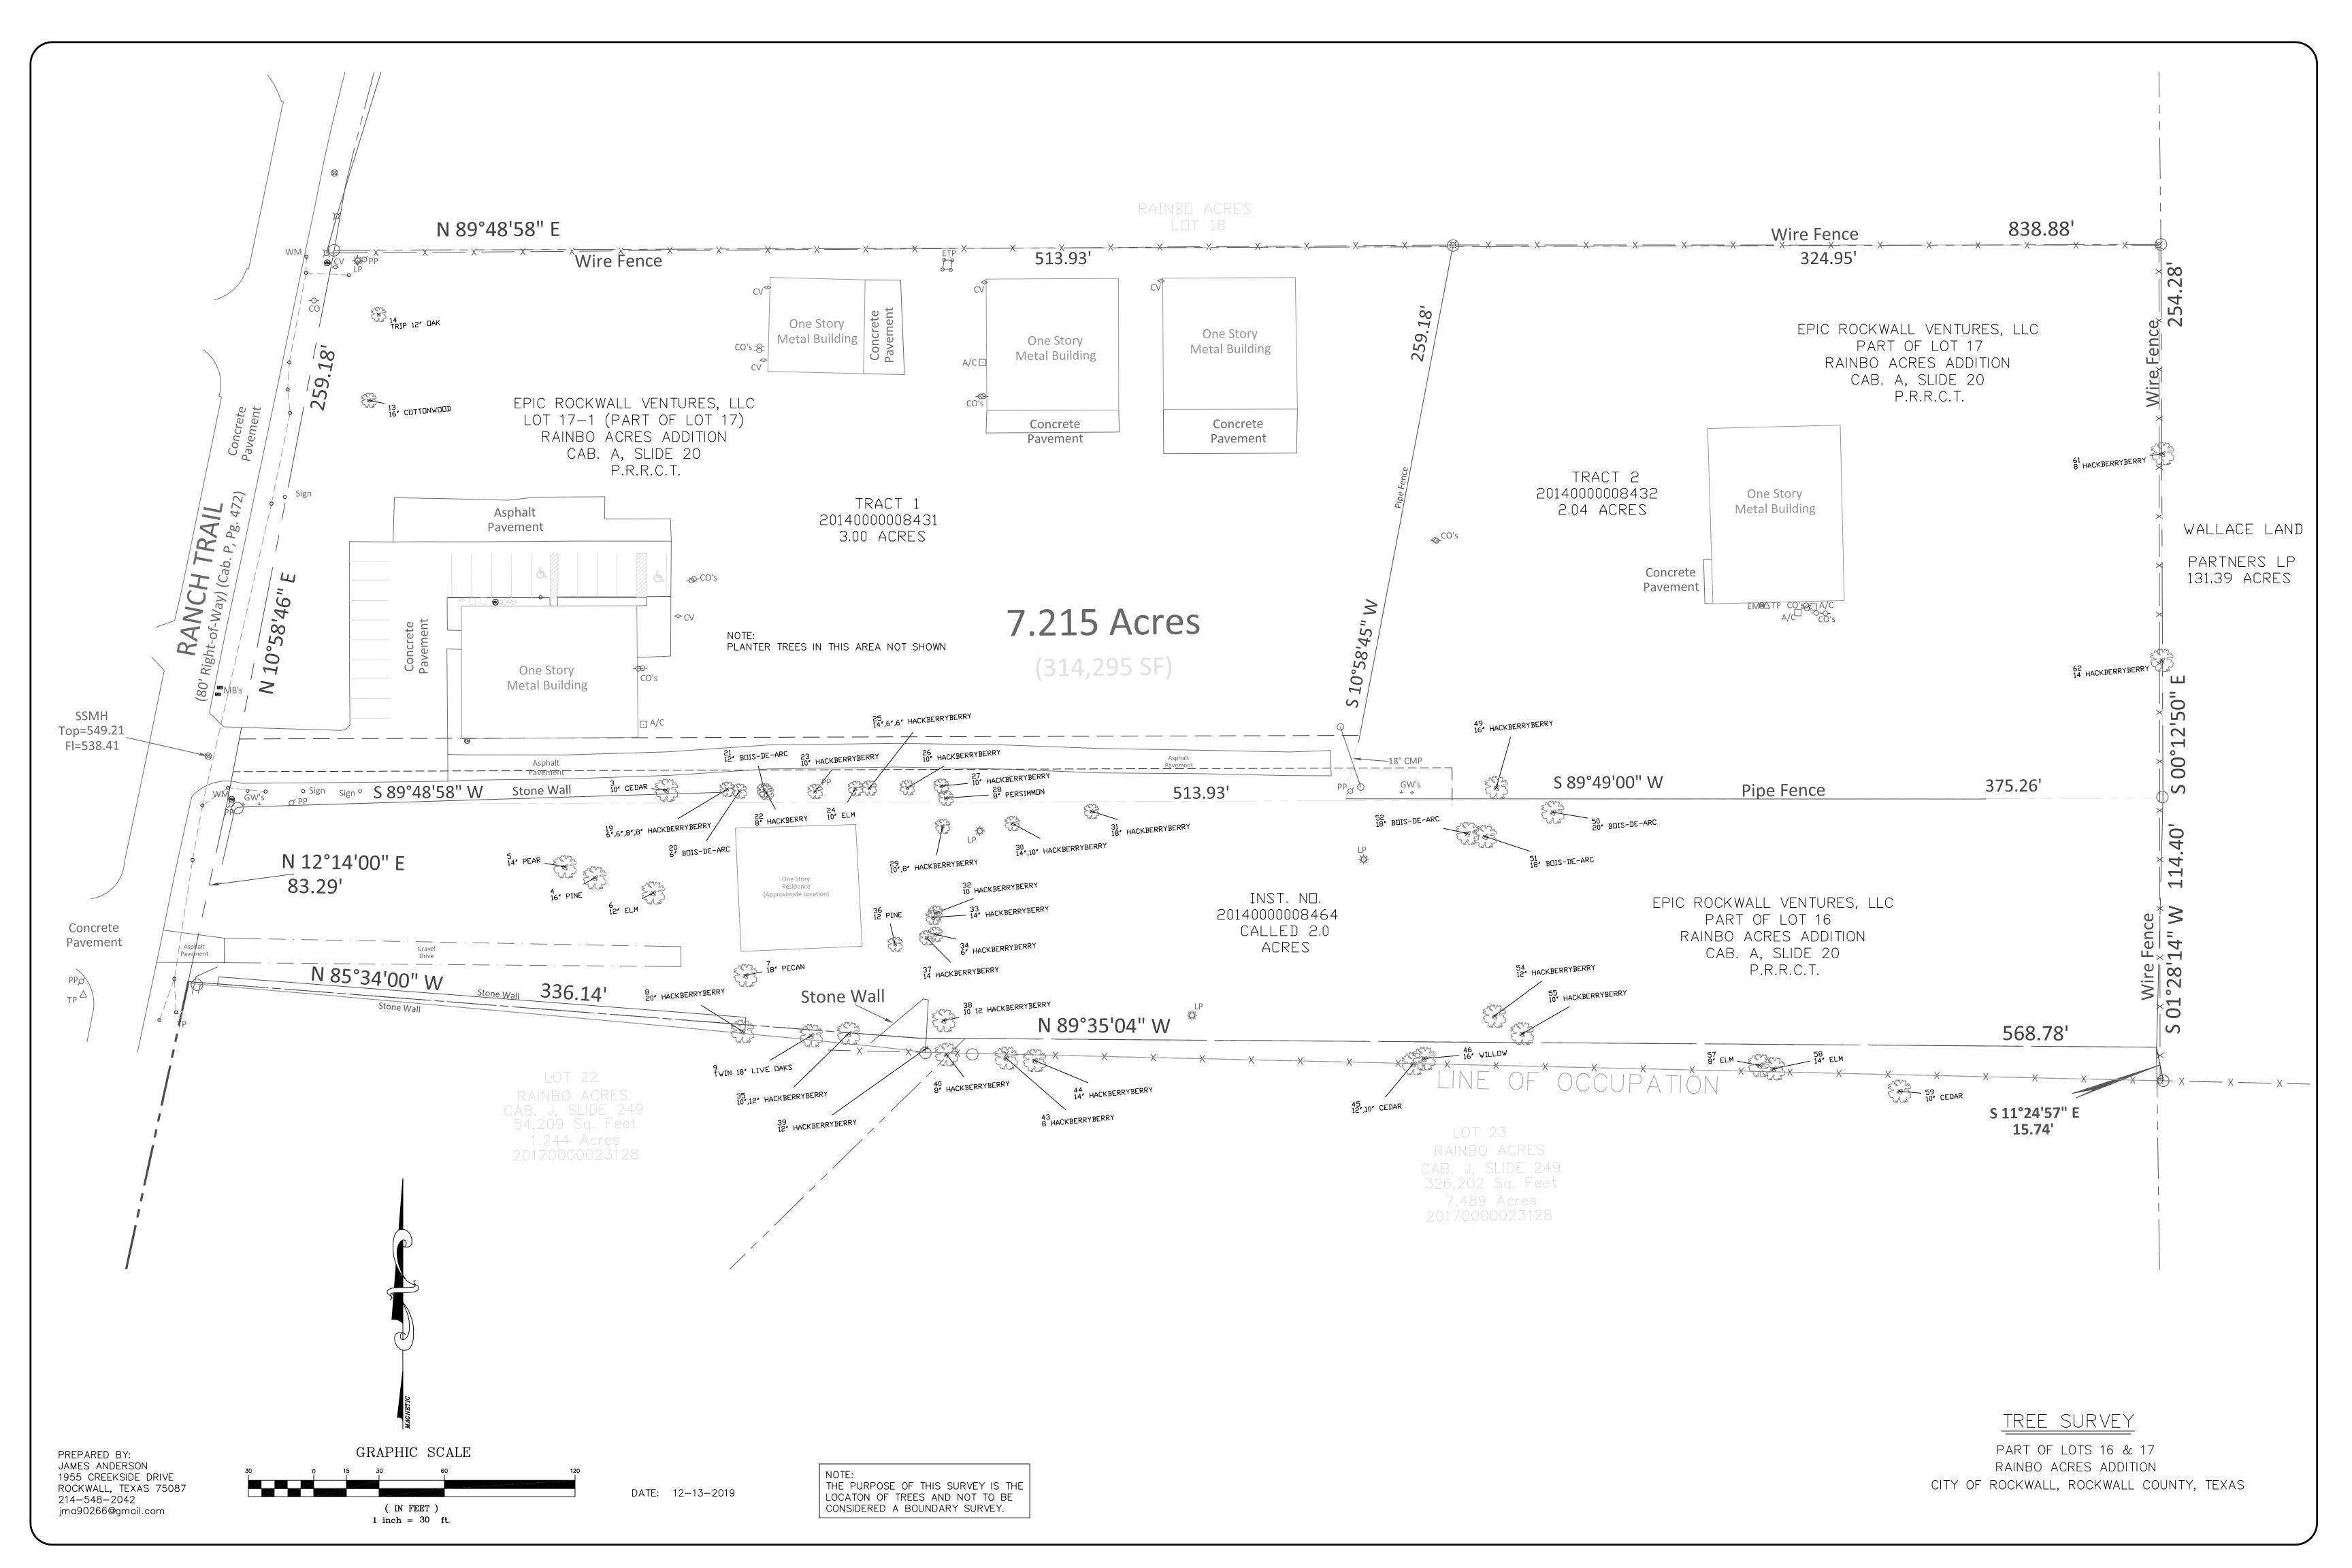

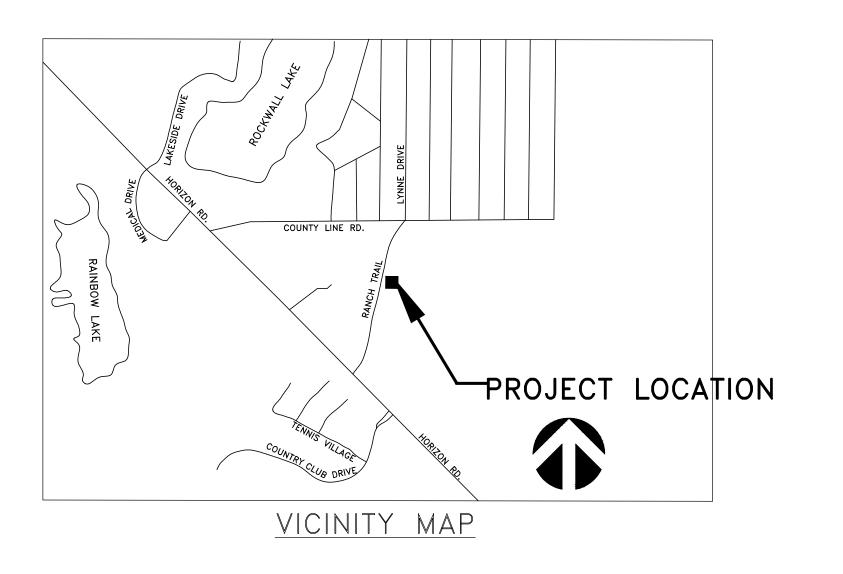

SITE SUMMARY - LIG	HT INDUSTRIAL	
DESCRIPTION		LOT PERCEN AGE
LOT	314,295 S.F.	100 %
IMPERVIOUS	125,398 S.F.	39.9%
PROPOSED BUILDING	12,139 S.F.	3.9%
EXISTING OFFICE	4,900 S.F.	1.5%
EXISTING STORAGE	3,669 S.F.	1.2%
EXISTING STORAGE	3,669 S.F.	1.2%
EXISTING STORAGE	10,900 S.F.	3.4 %
PAVEMENT AREA	41,897 S.F.	43.5 %
PERVIOUS		60.1 %
LANDSCAPE AREA	188,897 S.F.	32.5 %
BUILDING TO LOT COVERAGE	29,219 / 314,295	9.3 %
MAX. BUILDING HEIGHT PROPOSED	31'-10"	
PARKING REQUIREMENTS		
OFFICE (1:300 S.F.)	16,996 S.F.	57
PARKING PROVIDED	4 H.C.	57

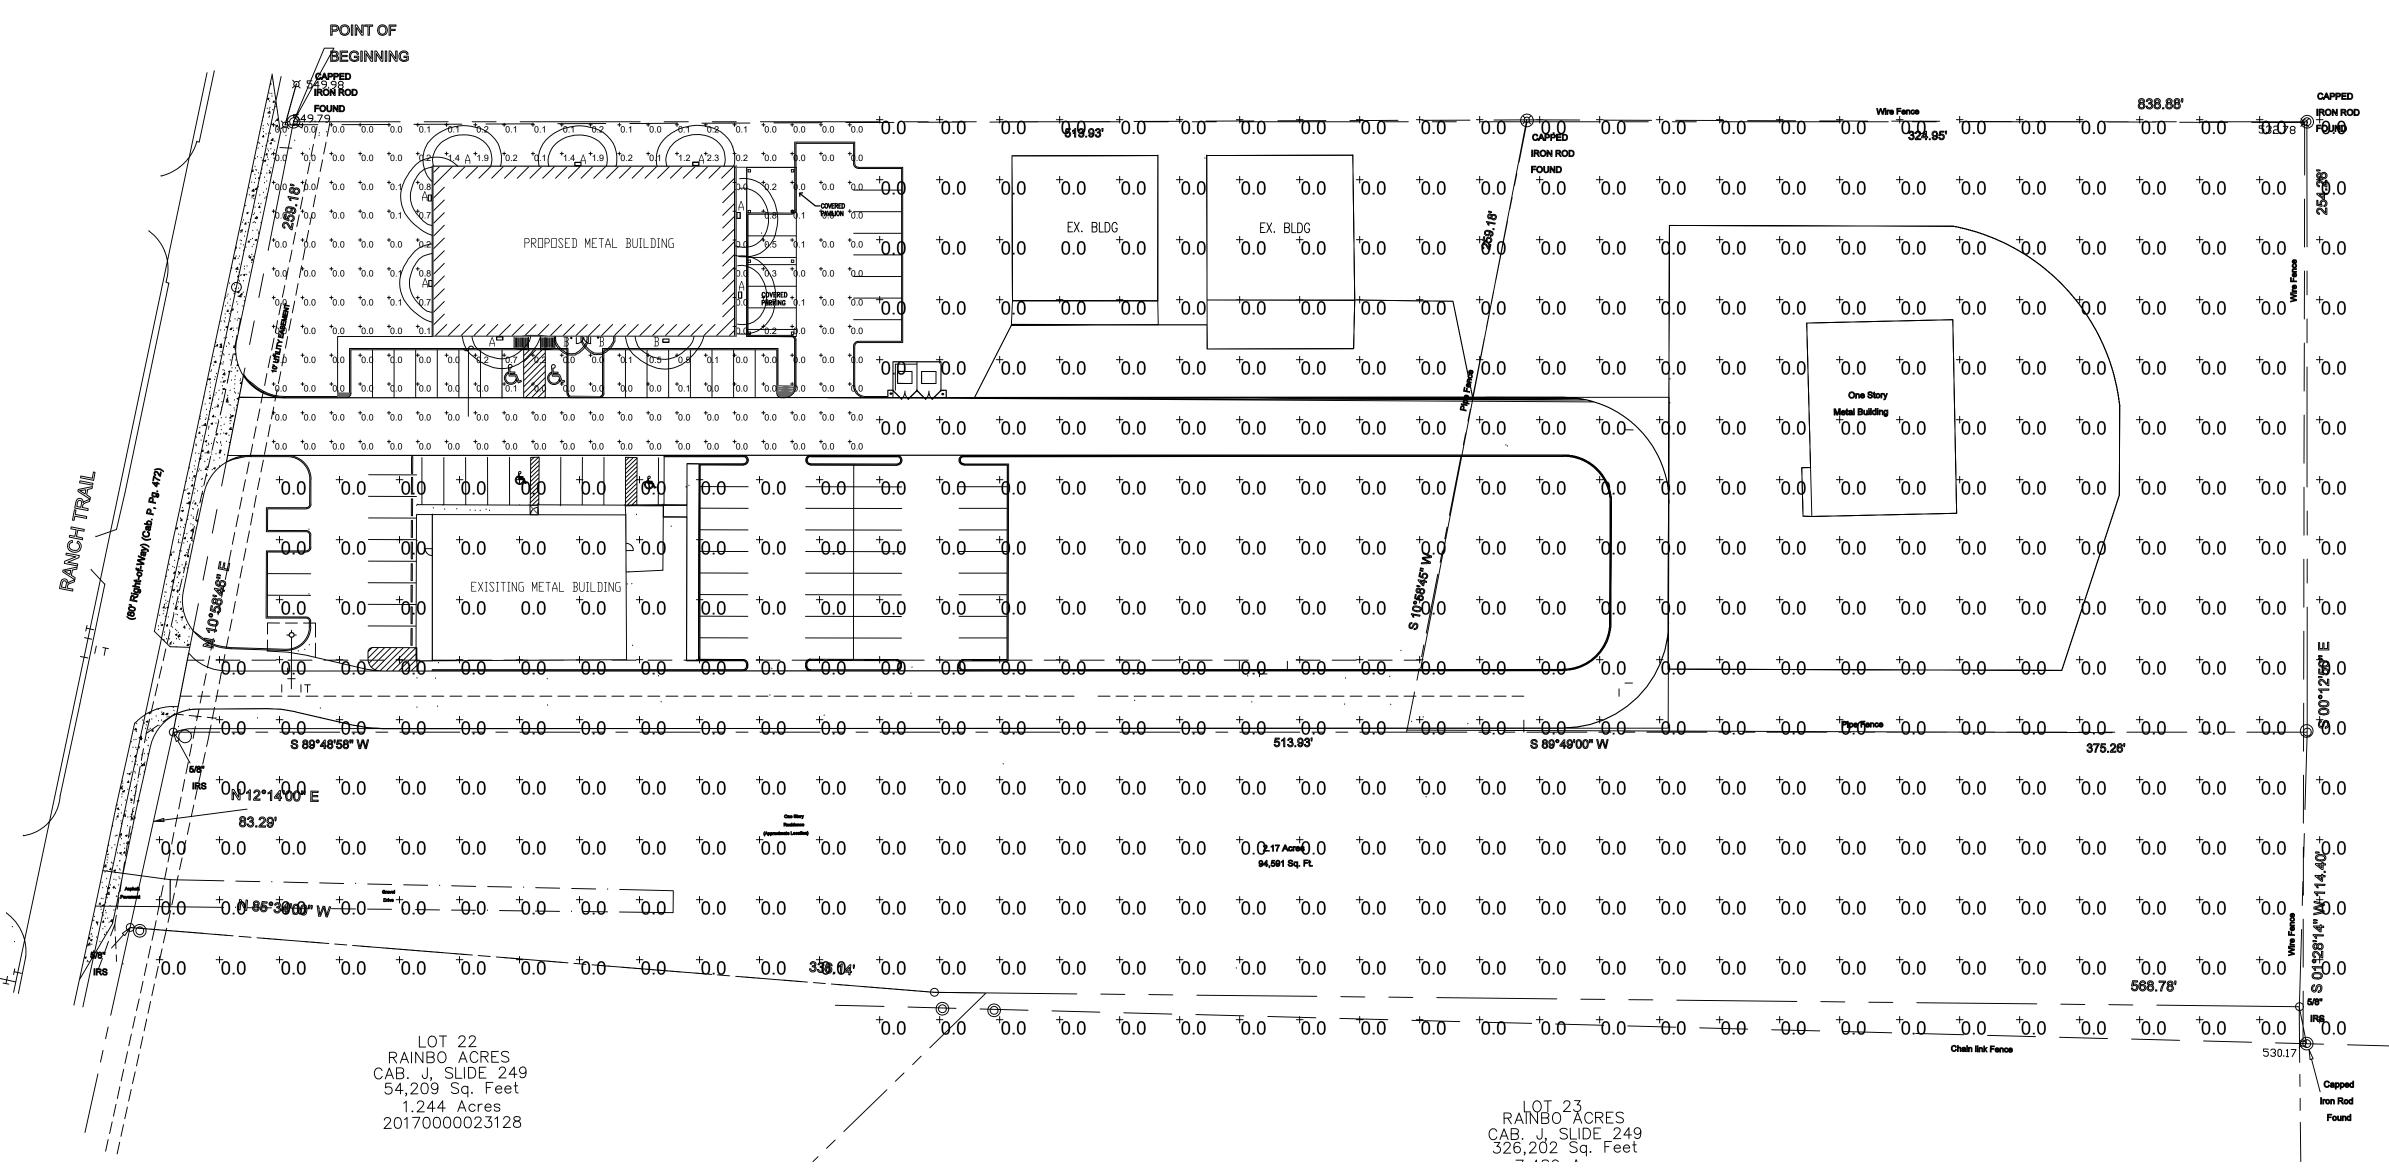

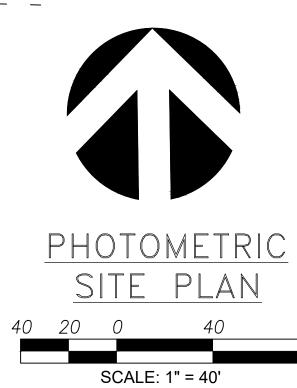



ROCKWALL, TEXAS 75032

CHECKED BY

SHEET NO.

DRAWING NAME:


PHOTOMETRIC

SITE PLAN

11.14.19

1/8"=1'-0"

of

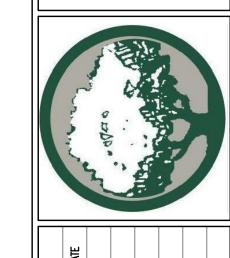

VENTUR

Ŏ

PROJECT No.

DRAWN BY

CHECKED BY

SHEET NO.

DRAWING NAME:

SCALE

AIL 75032

ANCH TEXA

415 F ROCKWALI

SR

RR

11.14.19 1/8"=1'-0"

of

FIXTURE 'B' **Security**Brands.

Page 1 of 3

**g** gotham

ONE 150-WATT PAR-38 SPOT INCANDESCENT,

LUMINOUS OPENING: CIRCULAR (DIA: 5.16") TER VALUE: 9 (BF = 1)TER CATEGORY: CYLINDER CIE CLASS: DIRECT 10,268.0 AT HORIZONTAL: 0°, VERTICAL: 0° MAX CD: SPACING CRITERION: @ 0 = 0.3 / @ 90 = 0.3


VERTICAL BASE-UP POSITION.

1 LAMP, RATED LUMENS/LAMP: 1740

ACUITY BRANDS LIGHTING CONYERS LAB

CA6 6"OPEN CYLINDER WITH BLACK MICROGROOVE

**EFFICIENCY:** 74.4% Polar Candela Distribution 180° 170° 160° 150° 140° 11,0009,167 7,333 -5,500 3,667

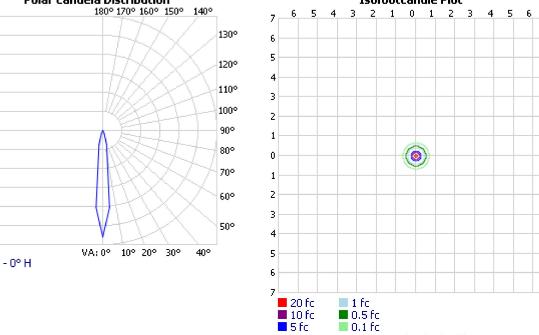

VISUAL PHOTOMETRIC TOOL 1.2.46 COPYRIGHT 2019, ACUITY BRANDS LIGHTING. THIS PHOTOMETRIC REPORT HAS BEEN GENERATED USING METHODS RECOMMENDED BY THE IESNA. CALCULATIONS ARE BASED ON PHOTOMETRIC DATA PROVIDED BY THE MANUFACTURER, AND THE ACCURACY OF THIS PHOTOMETRIC REPORT IS DEPENDENT ON THE ACCURACY OF THE DATA PROVIDED. END-USER ENVIRONMENT AND APPLICATION (INCLUDING, BUT NOT LIMITED TO, VOLTAGE VARIATION AND DIRT ACCUMULATION) CAN CAUSE ACTUAL PHOTOMETRIC PERFORMANCE TO DIFFER FROM THE PERFORMANCE CALCULATED USING THE DATA PROVIDED BY THE MANUFACTURER. THIS REPORT IS PROVIDED WITHOUT WARRANTY AS TO ACCURACY, COMPLETENESS, RELIABILITY OR OTHERWISE. IN NO EVENT WILL ACUITY BRANDS LIGHTING BE RESPONSIBLE FOR ANY LOSS RESULTING FROM ANY USE OF THIS REPORT. PUBLISH

Distance in units of mount height (20ft)

43080 VISUAL PHOTOMETRIC TOOL

LIGHT **FIXTURES** 

PAGE 1 OF 3

EXTERIOR



CA6 6MB (PAR38/SP)

TEST #:

TEST LAB:

TEST DATE:

CATALOG:

SERIES:

LAMP:

**DESCRIPTION:** 

LAMP OUTPUT:

1,833 —

1,833 —

3,667 5,500

7,333 —

9,167

11,000 🗀

0.00

INPUT WATTAGE: 150

INDOOR PHOTOMETRIC REPORT CATALOG: CA6 6MB (PAR38/SP)

43080

1/31/2008

CA6

CA6 6MB (PAR38/SP)

Light engines are available in 3000K and 4000K CCTs. See Lighting Facts label and photometry reports for specific fixture performance. LED technology provides long operating life (L70/50,000 hours at 25°C). Electronic drivers have a power factor >90% and THD <20% and a minimum 2.5kV surge rating.

One Lithonia Way • Conyers, Georgia 30012 • Phone: 800.705.7378 • www.lithonia.com

© 2017-2019 Acuity Brands Lighting, Inc. All rights reserved.

LITHONIA LIGHTING.


COMMERCIAL OUTDOOR

### 5-year limited warranty. Complete warranty terms located at:

**Note:** Actual performance may differ as a result of end-user environment and application. All values are design or typical values, measured under laboratory conditions at 25°C. Specifications subject to change without notice.

LIL LED Rev. 08/19/19

http://www.visual-3d.com/Tools/PhotometricViewer/Default.aspx?GUID=6087be34-571... 11/15/2019

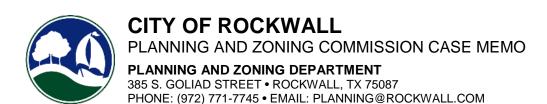

**TO:** Planning and Zoning Commission

**DATE:** January 14, 2020

APPLICANT: Ross Ramsay; Ramsay & Reyes, LLC

CASE NUMBER: SP2019-050; Site Plan for Lot 17 & 17-1, Rainbow Acres Addition

#### **SUMMARY**

Discuss and consider a request by Ross Ramsay of Ramsay & Reyes, LLC on behalf of John McKinney of Epic Rockwall Ventures for the approval of a site plan for an industrial building in an existing multi-tenant industrial park on a 9.52-acre tract of land identified as Lots 17 & 17-1, Rainbow Acres Addition, City of Rockwall, Rockwall County, Texas, zoned Commercial (C) District, addressed as 295, 315, 339, 327 & 331 Ranch Trail, and take any action necessary.

#### **BACKGROUND**

The subject property was annexed on May 17, 2004 by *Ordinance No. 04-34*. On September 7, 2004, the City Council approved a zoning change [*i.e. Case No. Z2004-027*] from Agricultural (AG) District to Commercial (C) District. Prior to annexation, the property was platted in October of 1962. Currently, there are four (4) exiting metal buildings that were under construction prior to annexation on the subject property in 2004.

#### **PURPOSE**

On December 13, 2019, the applicant -- Ross Ramsay of Ramsay & Reyes, LLC -- submitted an application requesting approval of a site plan for the purpose of constructing a ~4,900 SF, two (2)-story metal office building.

#### ADJACENT LAND USES AND ACCESS

The subject property is located on Ranch Trail, just north of 315 Ranch Trail and on the same lot. The land uses adjacent to the subject property are as follows:

North: Directly north of the subject property is a 9.76-acre vacant tract of land that is currently under site plan review [Case No. SP2019-043], and is zoned Commercial (C) District. Beyond this is vacant tract of land adjacent to County Line Road. County Line Road is identified as a Minor Collector on the City's Master Thoroughfare Plan.

<u>South</u>: Directly south of the subject property is a 7.489-acre parcel of vacant land. Recently a Specific Use Permit (SUP) was approved allowing a mini-warehouse facility on this property [Case No. Z2018-052]. Beyond this are several commercial structures that are also within the Rainbow Acres Addition. Beyond this FM-3097, which is identified as a M4D (major collector, four [4] lane, divided roadway) on the City's Master Thoroughfare Plan. These areas are zoned Commercial (C) District.

<u>East</u>: Directly east of the subject property is a 131.39-acre tract of vacant land (*i.e. Tract 43-01 of the W. W. Ford Survey, Abstract No. 80 -- commonly referred to as the Wallace Tract*). This property is zoned Agricultural (AG) District.

West.

Directly west of the subject property is Ranch Trail, which is identified as a *Minor Collector* on the City's Master Thoroughfare Plan. Beyond this are several commercial structures, that are zoned Commercial (C) District.

#### **DENSITY AND DIMENSIONAL REQUIREMENTS**

According to Section 1.1, Land Use and Buildings, of Article IV, Permissible Uses, of the Unified Development Code (UDC), an office building is permitted by-right in a Commercial (C) District and no additional approvals are necessary with regard to the proposed land use. With the exclusion of the exceptions being requested the submitted site plan, landscape plan, photometric plan, and building elevations generally conform to the technical requirements contained within the UDC for a property located within a Commercial (C) District. A summary of the density and dimensional requirements for the subject property are as follows:

Ordinance Provisions	Zoning District Standards	Conformance to the Standards
Minimum Lot Area	10,000 SF	x=9.52-acres; In Conformance
Minimum Lot Frontage	60-Feet	x>259-Feet-In Conformance
Minimum Lot Depth	100-Feet	x>838-Feet; In Conformance
Minimum Front Yard Setback	15-Feet	x=15-Feet; In Conformance
Minimum Rear Yard Setback	10-Feet	x=10-Feet; In Conformance
Minimum Side Yard Setback	10-Feet	x=10-Feet; In Conformance
Maximum Building Height	60-Feet	x=31'10"; In Conformance
Max Building/Lot Coverage	60%	x=9.3%; In Conformance
Minimum Number of Parking Spaces	Required Parking = 57	x=92 Spaces; In Conformance
Minimum Landscaping Percentage	15%	x=4.34-acres; In Conformance
Maximum Impervious Coverage	85-90%	x=39.9%; In Conformance

#### **CONFORMANCE WITH THE CITY'S CODES**

According to Subsection 4.05, Commercial (C) District, of Section 4, Commercial Districts, Article V, District Development Standards, of the Unified Development Code (UDC), the Commercial (C) District is a district "...intended to provide commercial land uses such as retail, large shopping centers, and restaurants. Commercial (C) Districts are generally situated in close proximity to an arterial or major collector that is capable of carrying the traffic generated by the land uses in the district..." In addition, these areas "...may require increased water, fire protection, and wastewater and drainage capacity. Since the Commercial (C) District is general in nature, development standards are less stringent as lower intensity districts such as Residential-Office (RO), Neighborhood Services (NS), and General Retail (GR) Districts..." In this case, the applicant's request appears to conform to the requirements of the Unified Development Code (UDC). Specifically, the subject property is adjacent to Ranch Trail Road -- identified as a Minor Collector on the City's Master Thoroughfare Plan --, and the proposed land use (i.e. office) is not typically a high-volume water/wastewater user. With regard to the land use, an office building is permitted by-right in a Commercial (C) District.

#### **EXCEPTIONS REQUESTED BY THE APPLICANT**

Based on the information submitted by the applicant, staff has identified the following exceptions to the requirements of the Unified Development Code (UDC):

- (1) Building Articulation.
  - (a) Primary Building Façades. According to Section 4.01.C.1, General Commercial District Standards, of Article V, District Development Standards, of the UDC, primary facades require projections associated with entryways, architectural elements and wall lengths. Specifically, primary architectural/entryway elements are required to extend a minimum of 25% above the

top of the wall and a minimum of 25% from the walls surface. In addition, no wall should exceed a length of three (3) time the walls height without an architectural/entryway element. In this case, the proposed building does incorporate vertical projections, but does not meet the horizontal projection standards for primary façades.

(b) Secondary Building Façades. According to Section 4.01.C.2, General Commercial District Standards, of Article V, District Development Standards, of the UDC, secondary facades require projections associated with entryways and architectural elements. Specifically, the secondary architectural/entryway elements are required to extend a minimum of 15% above the top of the wall and a minimum of 15% from the walls surface. In this case, the proposed building does incorporate vertical projections, but does not meet the horizontal projection standards for secondary façades.

According to Section 9, Exceptions and Variances, of Article XI, Development Applications and Review Procedures, of the Unified Development Code (UDC), and unless otherwise specified by the UDC, "(a)n applicant may request the Planning and Zoning Commission grant an exception to the provisions contained in the Unified Development Code (UDC), where unique or extraordinary conditions exist or where strict adherence to the technical requirements of the...(UDC) would create an undue hardship. In cases where an exception or exceptions is/are being requested, the applicant shall provide compensatory measures that directly offset the requested exception." In this case, the applicant has provided a letter explaining the exceptions and offering compensatory measures for the requested variances by including a wainscot on three (3) of the building facades and increased landscaping. The Planning and Zoning Commission is tasked with determining if the compensatory measures properly off-set the requested variance. This is a discretionary decision for the Planning and Zoning Commission and will require a super majority vote (i.e. a three-fourths vote of those members present) with a minimum of four (4) votes in the affirmative for approval. In the event that the exception is denied, the applicant has the ability to appeal the Planning and Zoning Commission's decision to the City Council by filing a written request with the Planning and Zoning Department.

#### **CONFORMANCE WITH OURHOMETOWN VISION 2040 COMPREHENSIVE PLAN**

The Future Land Use Plan adopted with the OURHometown Vision 2040 Comprehensive Plan indicates that the subject property is located in the <u>Southwest Residential District</u> and is situated within an area that is identified as a *Transitional Area*. According to the district, the *Transitional Area* is defined as, "...currently transitioning from interim land uses and building types to more permanent structures with conforming land uses. These areas should be given special consideration with regard to requests that further the establishment of uses and structures that will improve the property values of the adjacent properties..." In this case, this use and the proposed metal building are similar to the existing buildings in the area, and the proposed improvements are similar to other buildings that have been approved along Ranch Trail since this area was annexed by the City in 2004. Determining if this request meets the goals of the Comprehensive Plan along with the special exceptions requested and the compensatory measures offered by the applicant are all discretionary decisions for the City Council.

According to the policies contained under Goal #4, Commercial Building Design, of Chapter 09, Non-Residential, of the OURHometown Vision 2040 Comprehensive Plan, commercial buildings should: [1] incorporate a minimum of 20% stone of all facades of the building that face a street, public open space, trail or park; [2] be architecturally finished on all four (4) sides with the same materials, detailing, and features; and [3] should be designed to a residential scale when adjacent to residential (or residentially designated areas). Understanding that the area in question is currently in a transitioning state, staff has recommended to the applicant that the incorporation of the stone wainscot on all four (4) sides of the building would better bring this request into conformance with the Comprehensive Plan.


#### **ARCHITECTURAL REVIEW BOARD (ARB)**

On December 30, 2019, the Architectural Review Board (ARB) did not meet due to lack of a quorum; therefore, the ARB will provide the Planning and Zoning Commission with recommendations at the <u>January 14, 2020</u> Planning and Zoning Commission meeting.

#### **CONDITIONS OF APPROVAL**

If the Planning and Zoning Commission chooses to approve the applicant's request, then staff would propose the following conditions of approval:

- (1) All staff comments provided by the Planning, Engineering and Fire Department must be addressed prior to the submittal of a building permit;
- (2) Approval by the Planning and Zoning Commission of all exceptions requested as outlined in this case memo;
- (3) Any construction resulting from the approval of this site plan shall conform to the requirements set forth by the Unified Development Code (UDC), the International Building Code (IBC), the Rockwall Municipal Code of Ordinances, city adopted engineering and fire codes and with all other applicable regulatory requirements administered and/or enforced by the state and federal government.

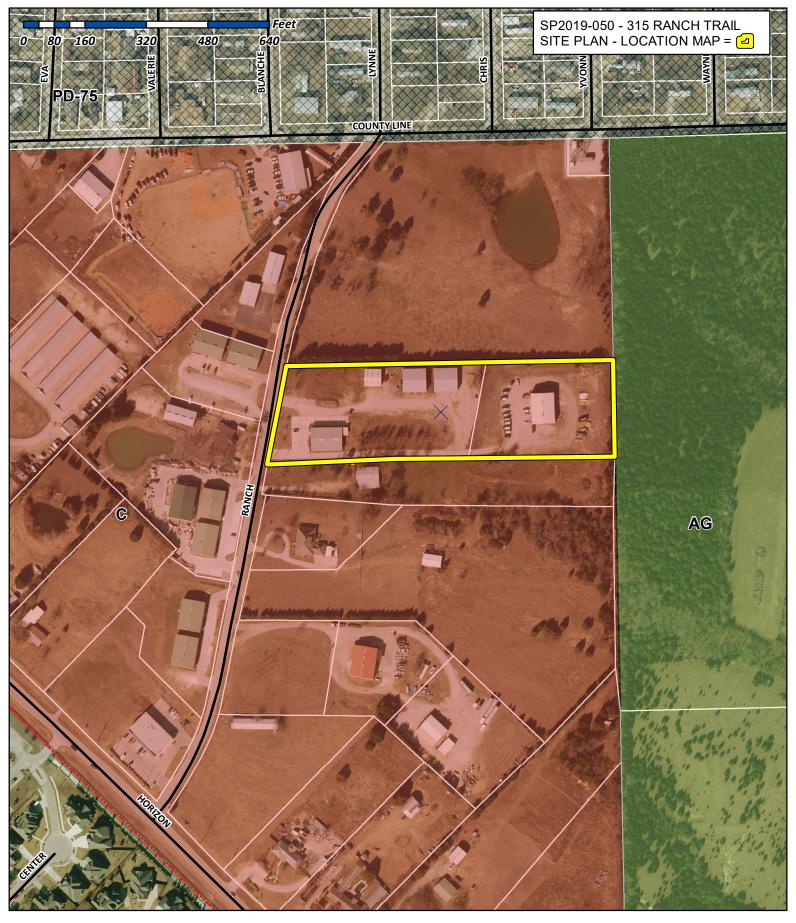



## City of Rockwall Planning & Zoning Department 385 S. Goliad Street

Planning & Zoning Department 385 S. Goliad Street Rockwall, Texas 75032 (P): (972) 771-7745 (W): www.rockwall.com The City of Rockwall GIS maps are continually under development and therefore subject to change without notice. While we endeavor to provide timely and accurate information, we make no guarantees. The City of Rockwall makes no warranty, express or implied, including warranties of merchantability and fitness for a particular purpose. Use of the information is the sole responsibility of the user.





#### **DEVELOPMENT APPLICATION**

City of Rockwall Planning and Zoning Department 385 S. Goliad Street Rockwall, Texas 75087

STA	FF	USE	ONLY	

PLANNING & ZONING CASE NO. SPZ 019

**NOTE:** THE APPLICATION IS NOT CONSIDERED ACCEPTED BY THE CITY UNTIL THE PLANNING DIRECTOR AND CITY ENGINEER HAVE SIGNED BELOW.

**DIRECTOR OF PLANNING:** 

CITY ENGINEER:


lease check the appropriate box below to indicate the typ	e of development request [SELECT ONLY ONE BOX]:
Platting Application Fees:  [] Master Plat (\$100.00 + \$15.00 Acre) <sup>1</sup> [] Preliminary Plat (\$200.00 + \$15.00 Acre) <sup>1</sup> [] Final Plat (\$300.00 + \$20.00 Acre) <sup>1</sup> [] Replat (\$300.00 + \$20.00 Acre) <sup>1</sup> [] Amending or Minor Plat (\$150.00)  [] Plat Reinstatement Request (\$100.00)	Zoning Application Fees:  [ ] Zoning Change (\$200.00 + \$15.00 Acre) <sup>1</sup> [ ] Specific Use Permit (\$200.00 + \$15.00 Acre) <sup>1</sup> [ ] PD Development Plans (\$200.00 + \$15.00 Acre) <sup>1</sup> Other Application Fees:  [ ] Tree Removal (\$75.00)

[	] Variance Request (\$1	.00.00)		
N	otes:			

Site Plan Application Fees:  [ Site Plan (\$250.00 + \$20.00 Acre) 1  [ ] Amended Site Plan/Elevations/Landscaping Plan (\$100.00)	Notes:  1: In determining the fee, please use the exact acreage when multiplying by the per acre amount. For requests on less than one acre, round up to one (1) acre.
PROPERTY INFORMATION [PLEASE PRINT]  Address Ranch Trail  Subdivision Resimbon Acres  General Location	Rachwall Tx 75032 Lot 17 Block
ZONING, SITE PLAN AND PLATTING INFORMATION [PL	LEASE PRINT)
Current Zoning Commercia	Current Use Office
Proposed Zoning Commercia	Proposed Use Office
Acreage 7,2)5 Lots [Curren	
[ ] <u>SITE PLANS AND PLATS</u> : By checking this box you acknowledge that due process, and failure to address any of staff's comments by the date provide	to the passage of <u>HB3167</u> the City no longer has flexibility with regard to its approvaled on the Development Calendar will result in the denial of your case.
OWNER/APPLICANT/AGENT INFORMATION [PLEASE PRIN	
Contact Person Wike Dalli Address 315 Ramch Trail	[] Applicant Ramsan & Renes LLC Contact Person Ross Ramsan Address ZZ35 Ridza Road
City, State & Zip ROCKWAN TY 75032	City, State & Zip Reckwan Tx 75087
Phone 469-774-2611	Phone 469 7 7 GZ CEEB
E-Mail modac/Esnapmga. Co-	E-Mail & Vamsan e yaho, com
NOTARY VERIFICATION [REQUIRED]  Before me, the undersigned authority, on this day personally appeared this application to be true and certified the following:	[Owner] the undersigned, who stated the information on
that the City of Rockwall (i.e. "City") is authorized and permitted to provide infor	ation submitted berein is true and correct; and the application fee of § $390.00$ , to $16.7$ day of December , 20 $17$ . By signing this application, I agree rmation contained within this application to the public. The City is also authorized and h this application, if such reproduction is associated or in response to a request for public
Given under my hand and seal of office on this the 16th day of Doce	ELIZABETH A. MORGAN NOTARY PUBLIC - STATE OF TEXAS

Notary Public in and for the State of Texas

My Commission Expires 0 2-25-20 21

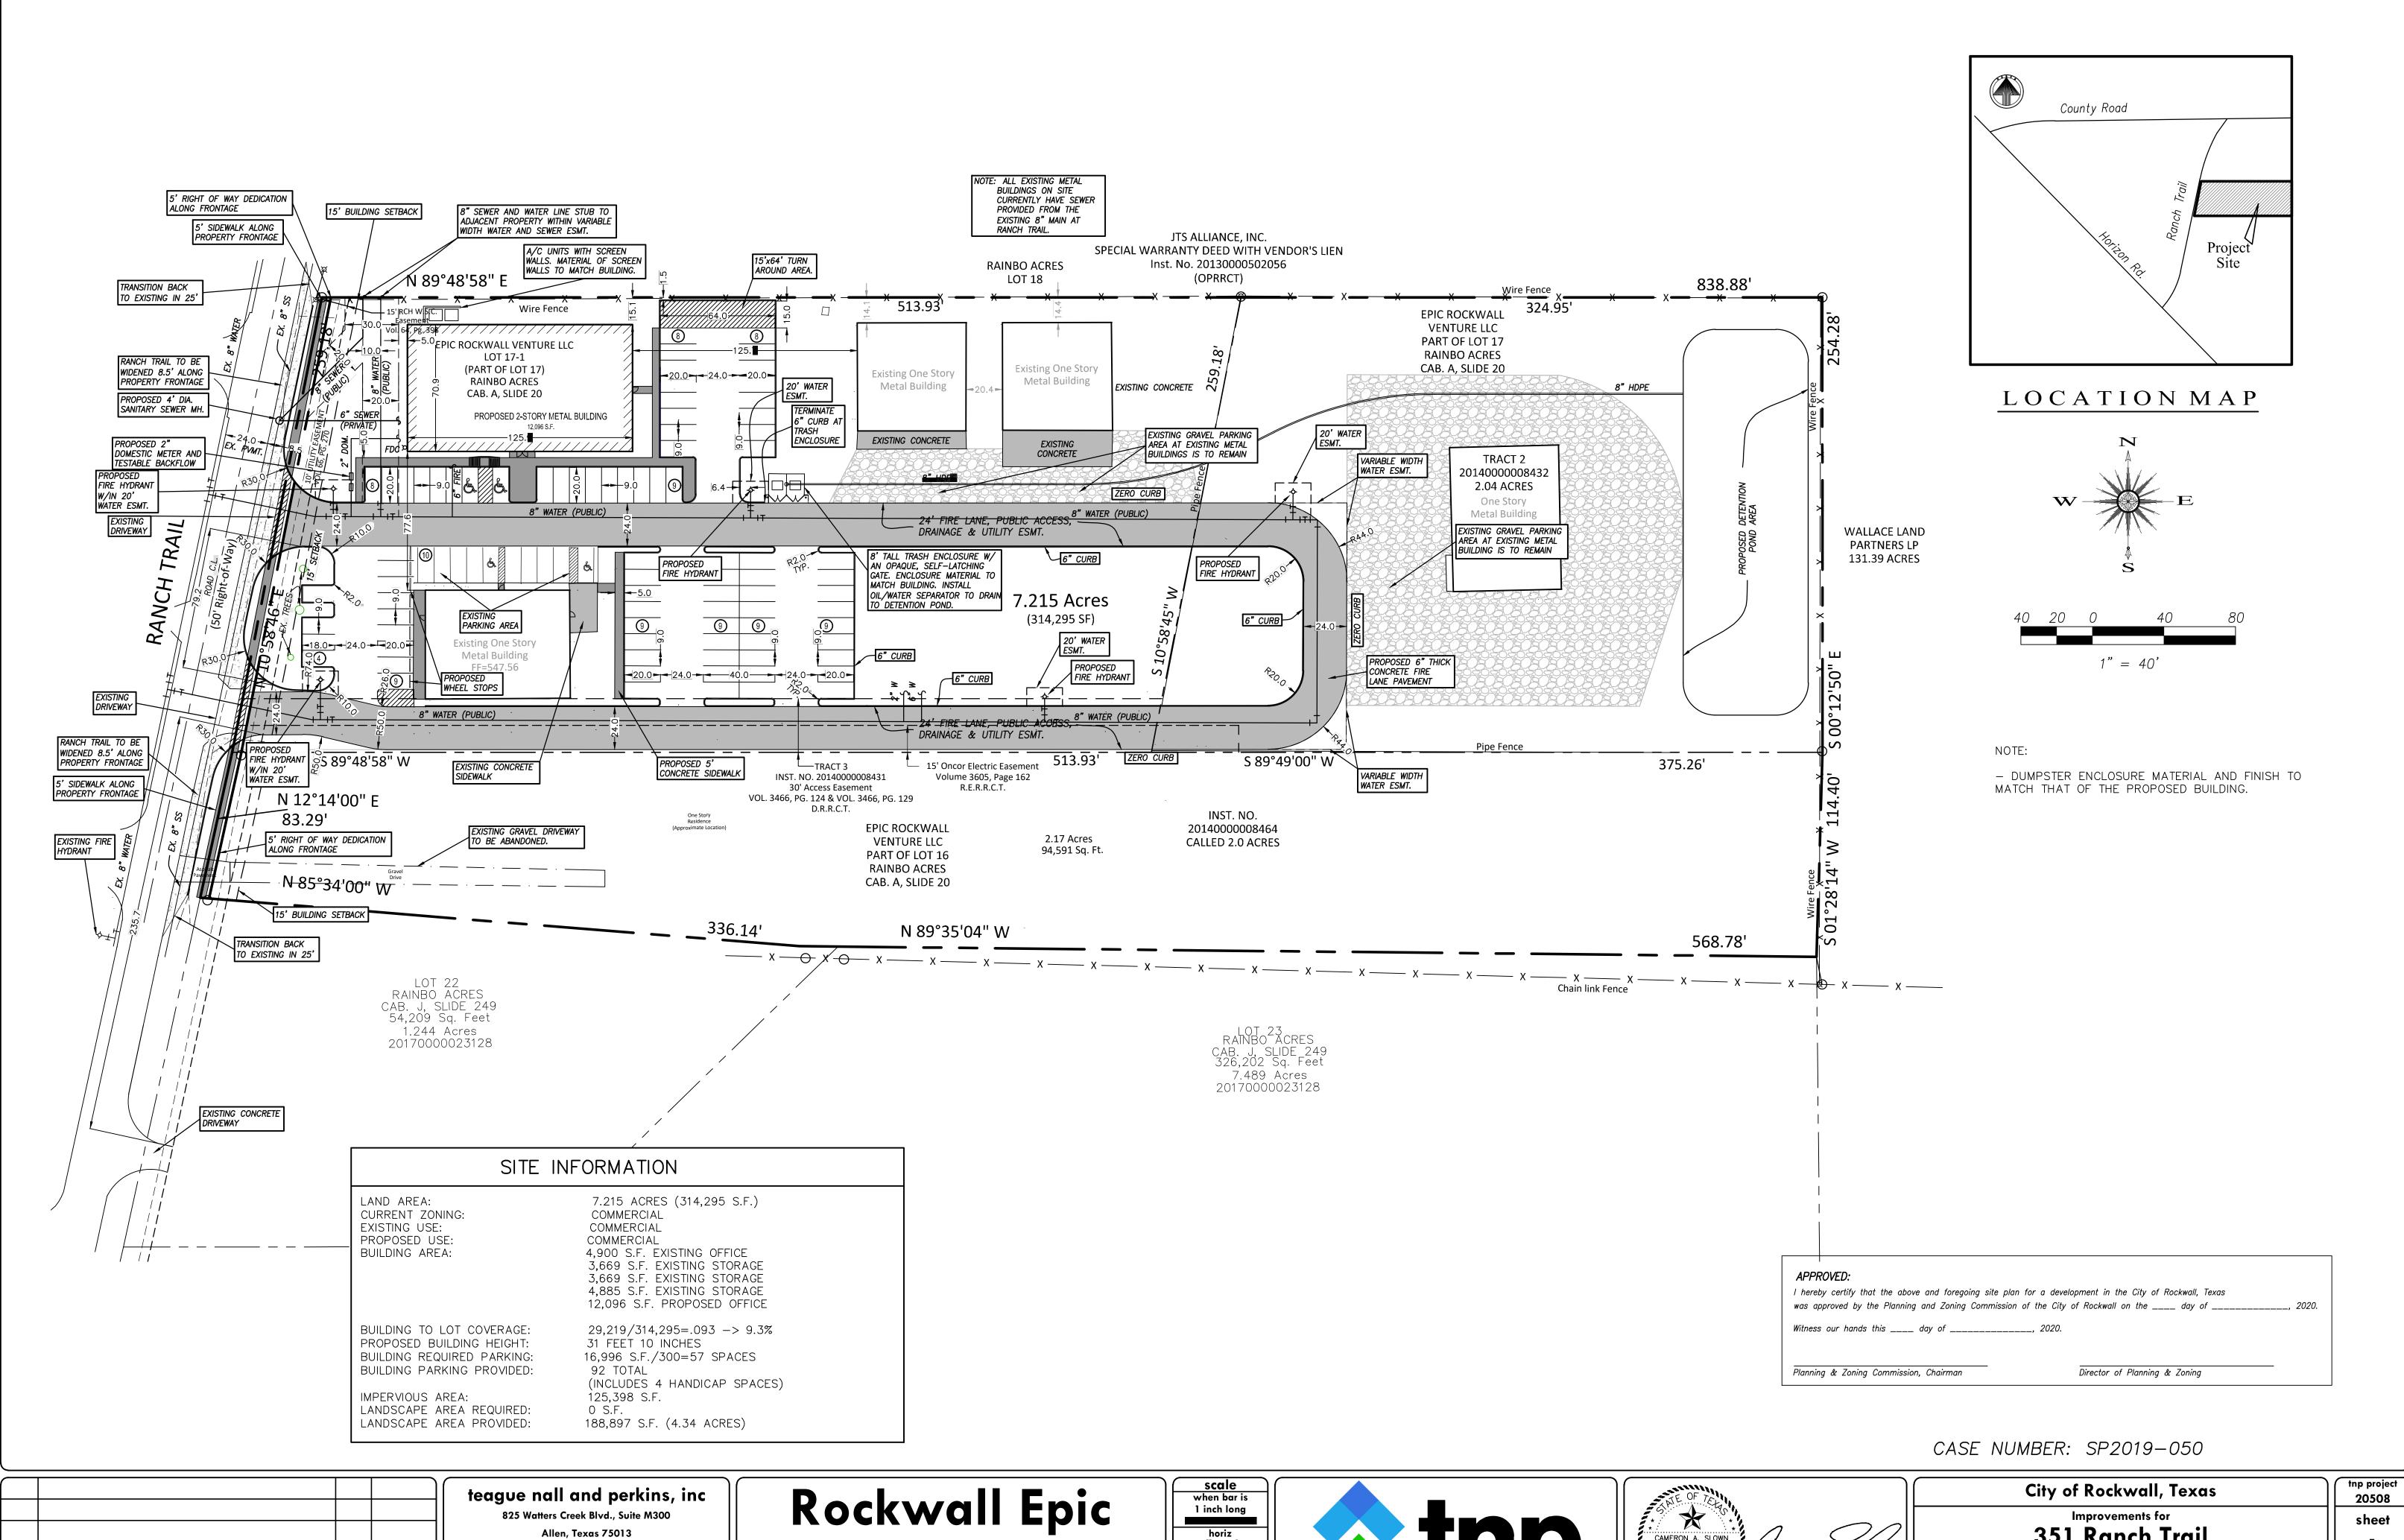


revision

by date

Allen, Texas 75013 ph 214.461.9867 www.tnpinc.com

TBPE: F-230; TBPLS: 10011600, 10194381, 10011601


Ventures, LLC.

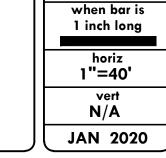






351 Ranch Trail SITE PLAN

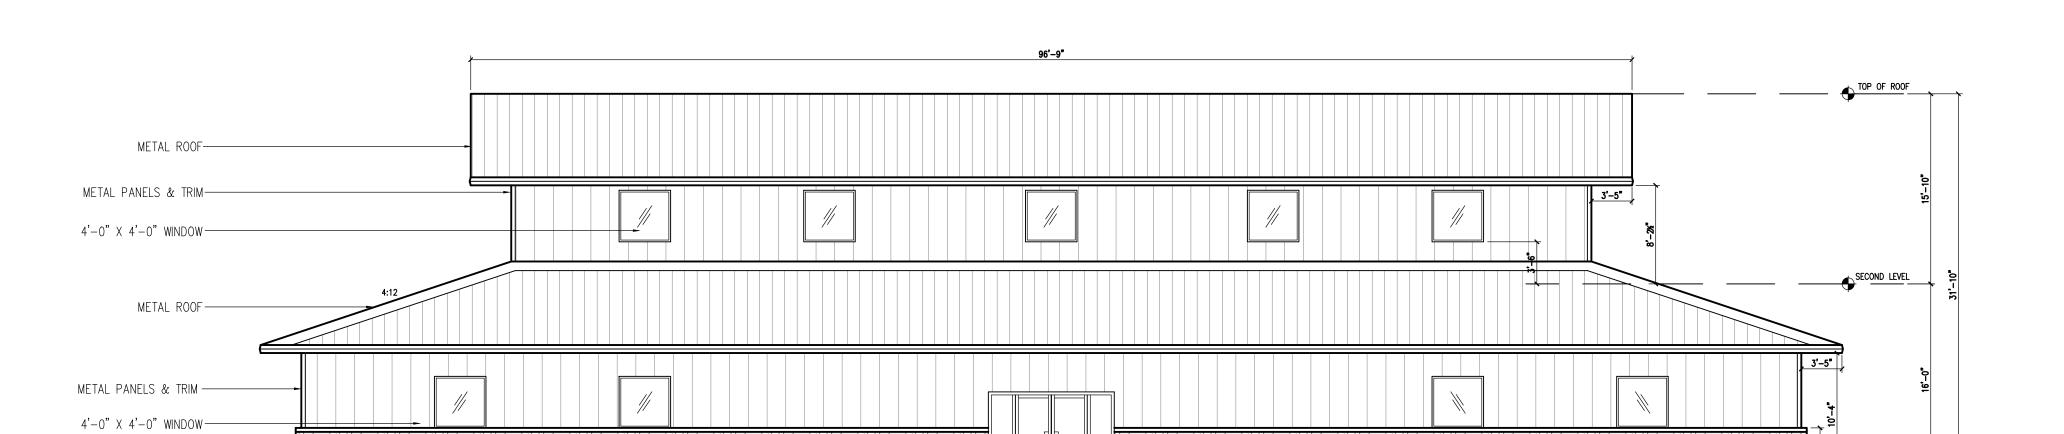


MATERIAL US	AGE (%) - SO	UTH						
ITEM BRAND / COLOR AREA S.F. PERCENT								
ELEVATION AREA		1,779						
DOORS & WINDOWS (DEDUCTED)		249						
ACCOUNTABLE AREA		1,530	100%					
NATURAL STONE		423	28%					
INSULATED METAL PANELS		1,107	72%					

# SOUTH ELEVATION SCALE: 1/8" = 1'

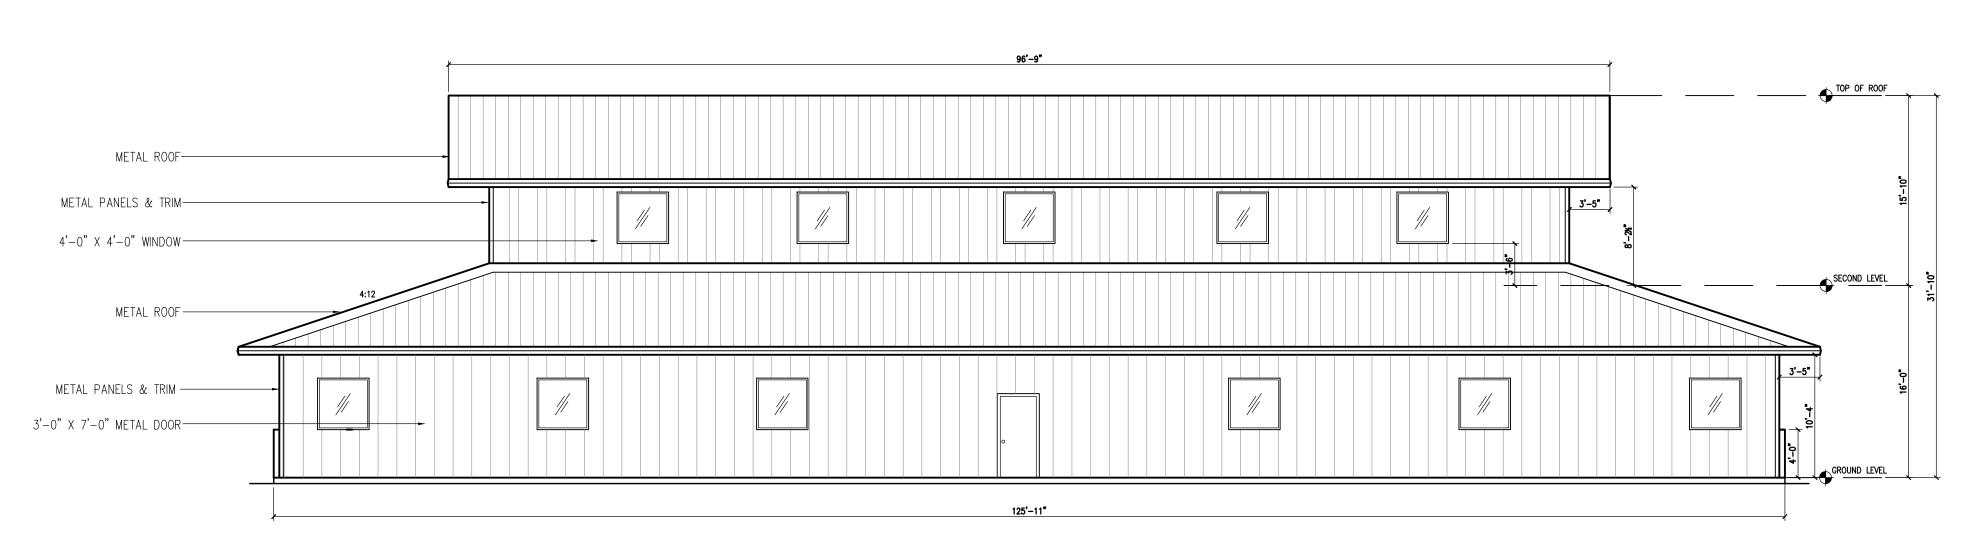

MATERIAL US	AGE (%) - NOF	RTH			
ITEM BRAND / COLOR AREA S.F. PERCENT					
ELEVATION AREA		1,779			
DOORS & WINDOWS (DEDUCTED)		170			
ACCOUNTABLE AREA		1,003	100%		
INSULATED METAL PANELS		1,003	100%		

# NORTH ELEVATION SCALE: 1/8" = 1'

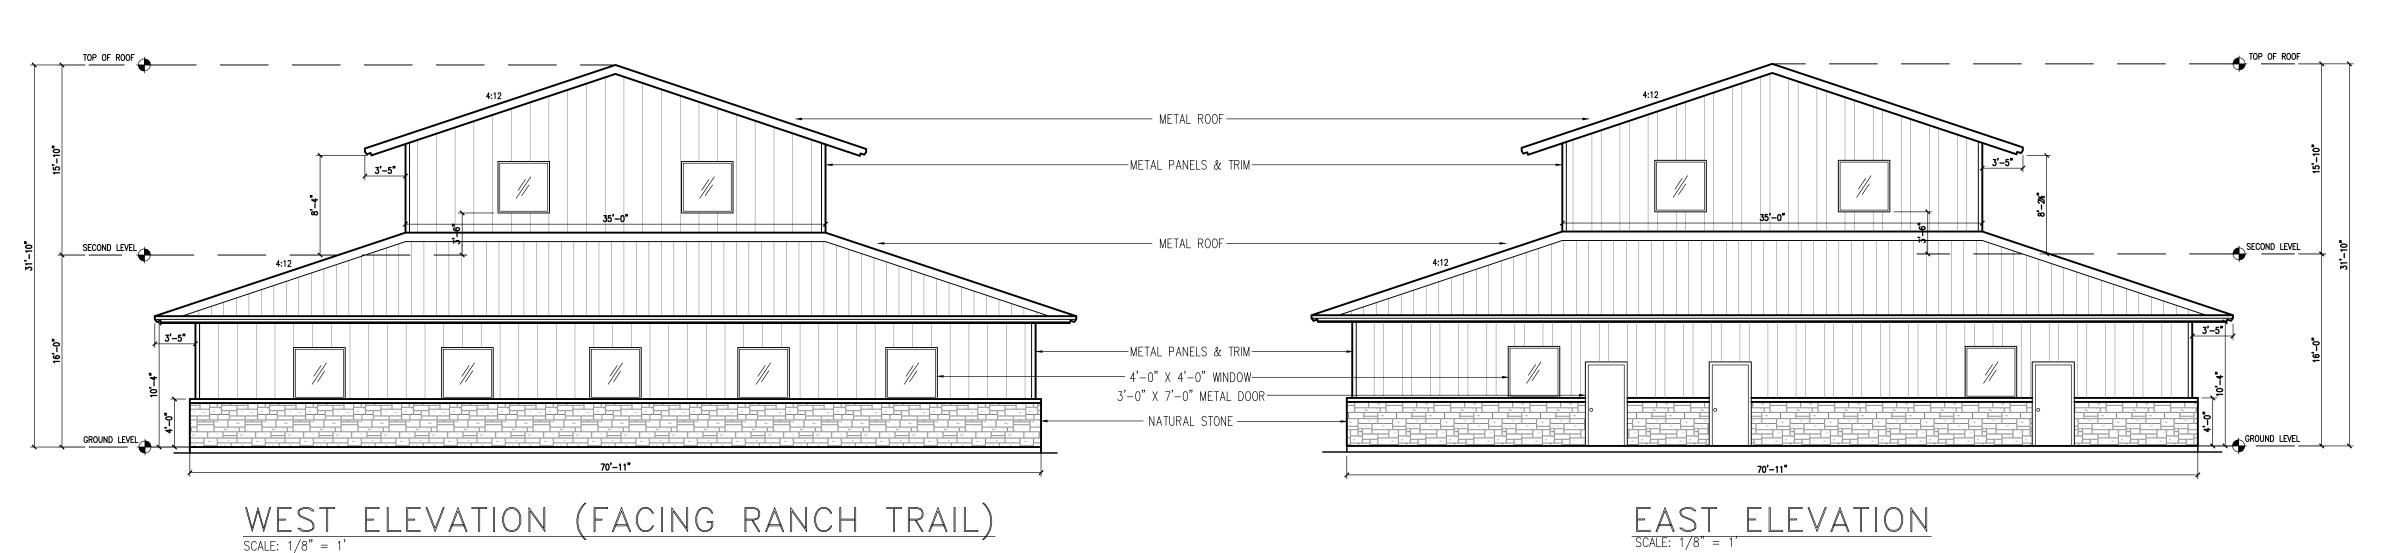


WEST	ELEVATION	(FACING	RANCH	TRAIL)
$\overline{\text{SCALE: } 1/8" = 1'}$				,

NATURAL STONE ---

MATERIAL US	SAGE (%) - WE	ST	
ITEM	BRAND / COLOR	AREA S.F.	PERCENT
ELEVATION AREA		1,041	
DOORS & WINDOWS (DEDUCTED)		95	
ACCOUNTABLE AREA		946	100%
NATURAL STONE		283	30%
INSULATED METAL PANELS		663	70%

MATERIAL USAGE (%) - EAST						
ITEM	BRAND / COLOR	AREA S.F.	PERCENT			
ELEVATION AREA		1,041				
DOORS & WINDOWS (DEDUCTED)		85				
ACCOUNTABLE AREA		956	100%			
NATURAL STONE		243	26%			
INSULATED METAL PANELS		713	74%			



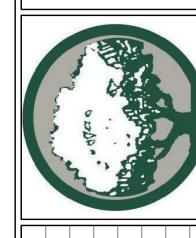

		1			
	DATE				
REVISIONS	DESCRIPTIONS/ISSUE				
	ė				
	(	$\bigcup_{i=1}^{n}$			


VENTURES, 351 RANCH TRAIL ROCKWALL, TEXAS 75032 ROCKWALL

SR
RR
01/07/2020
1/8"=1'-0"
of

DRAWING NAME:

BUILDING ELEVATION



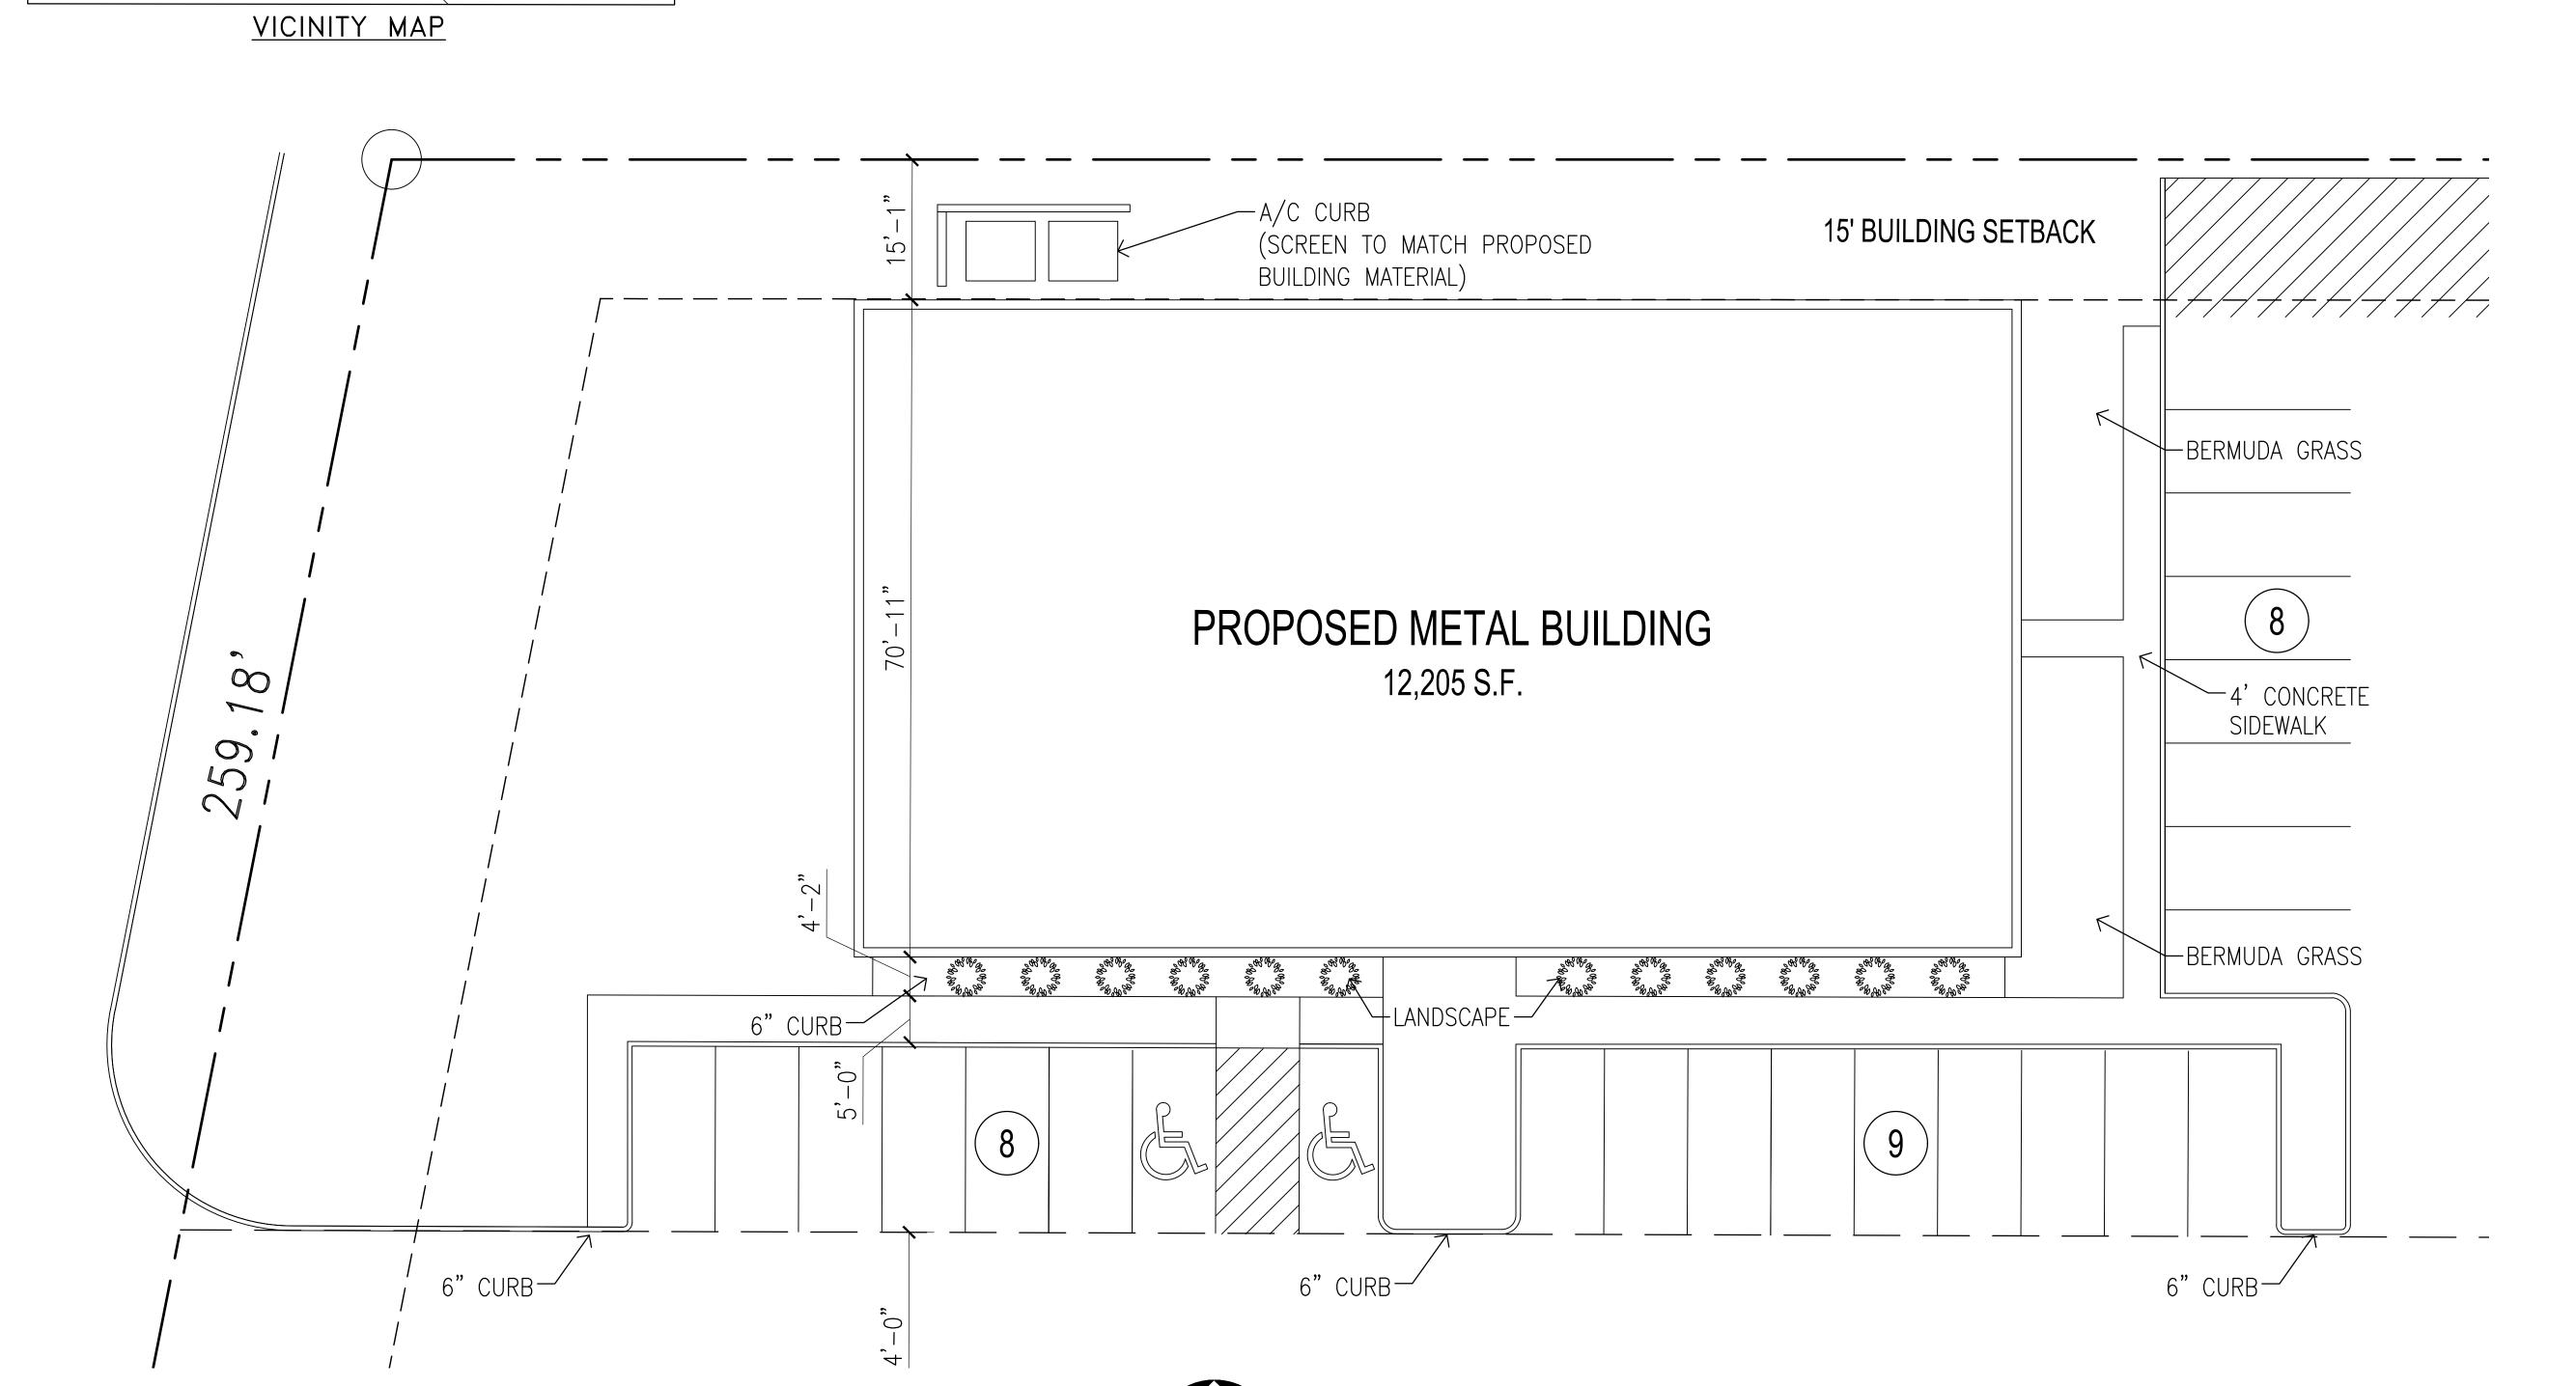

LANDSCAPE PLAN -


PROPOSED BUILDING

PLANT SCHEDULE

12 3 GALLON Texas Sage (Leucophyllum frutescent)



ARCHITECTURE - MANAGEMEN
2235 RIDGE RD. STE. 200
ROCKWALL, TEXAS 75087

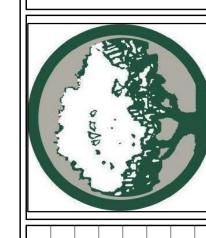

REVISIONS
No. DESCRIPTIONS/ISSUE DATE

DATE

ROCKWALL EPIC VENTURES
351 RANCH TRAIL
ROCKWALL, TEXAS 75032

PRO	JECT No.	
DRAV	WN BY	SR
CHE	CKED BY	RR
DATE		01/07/2020
SCAL	Æ	1" = 40'
SHE	ET NO.	of


LANDSCAPE
PLAN


SPACING

8'-0"

LS-1

CD2010 050

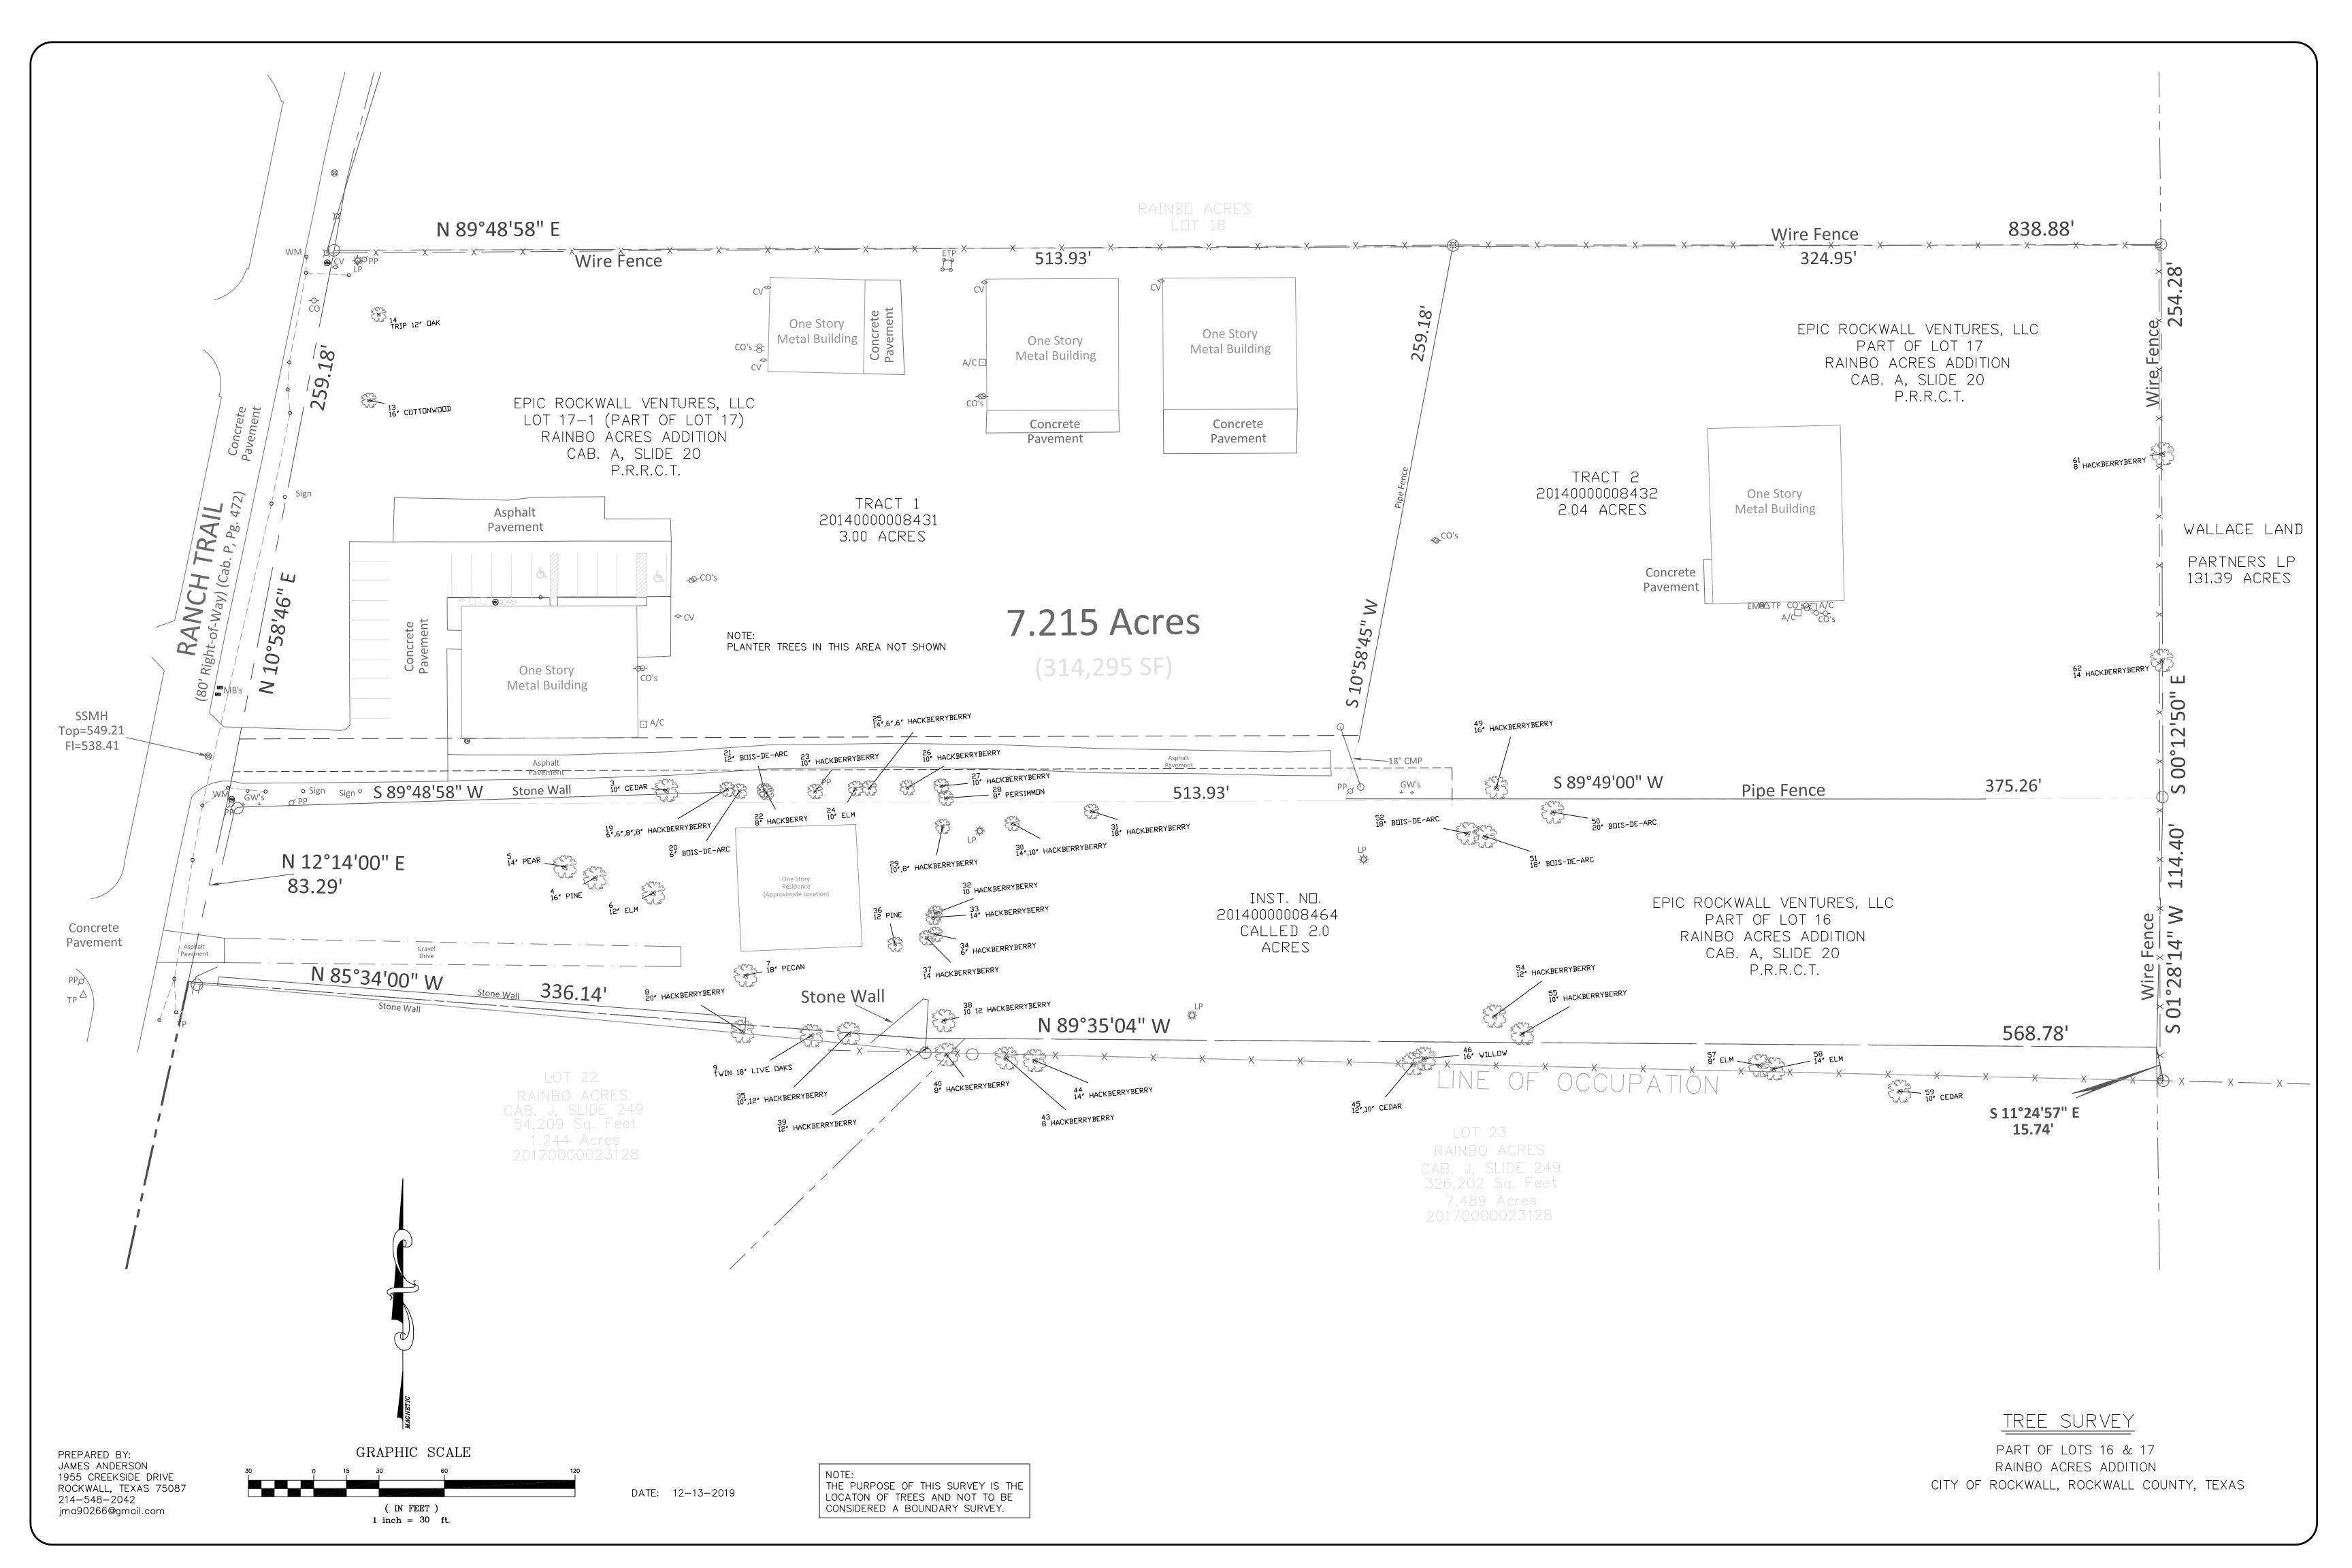

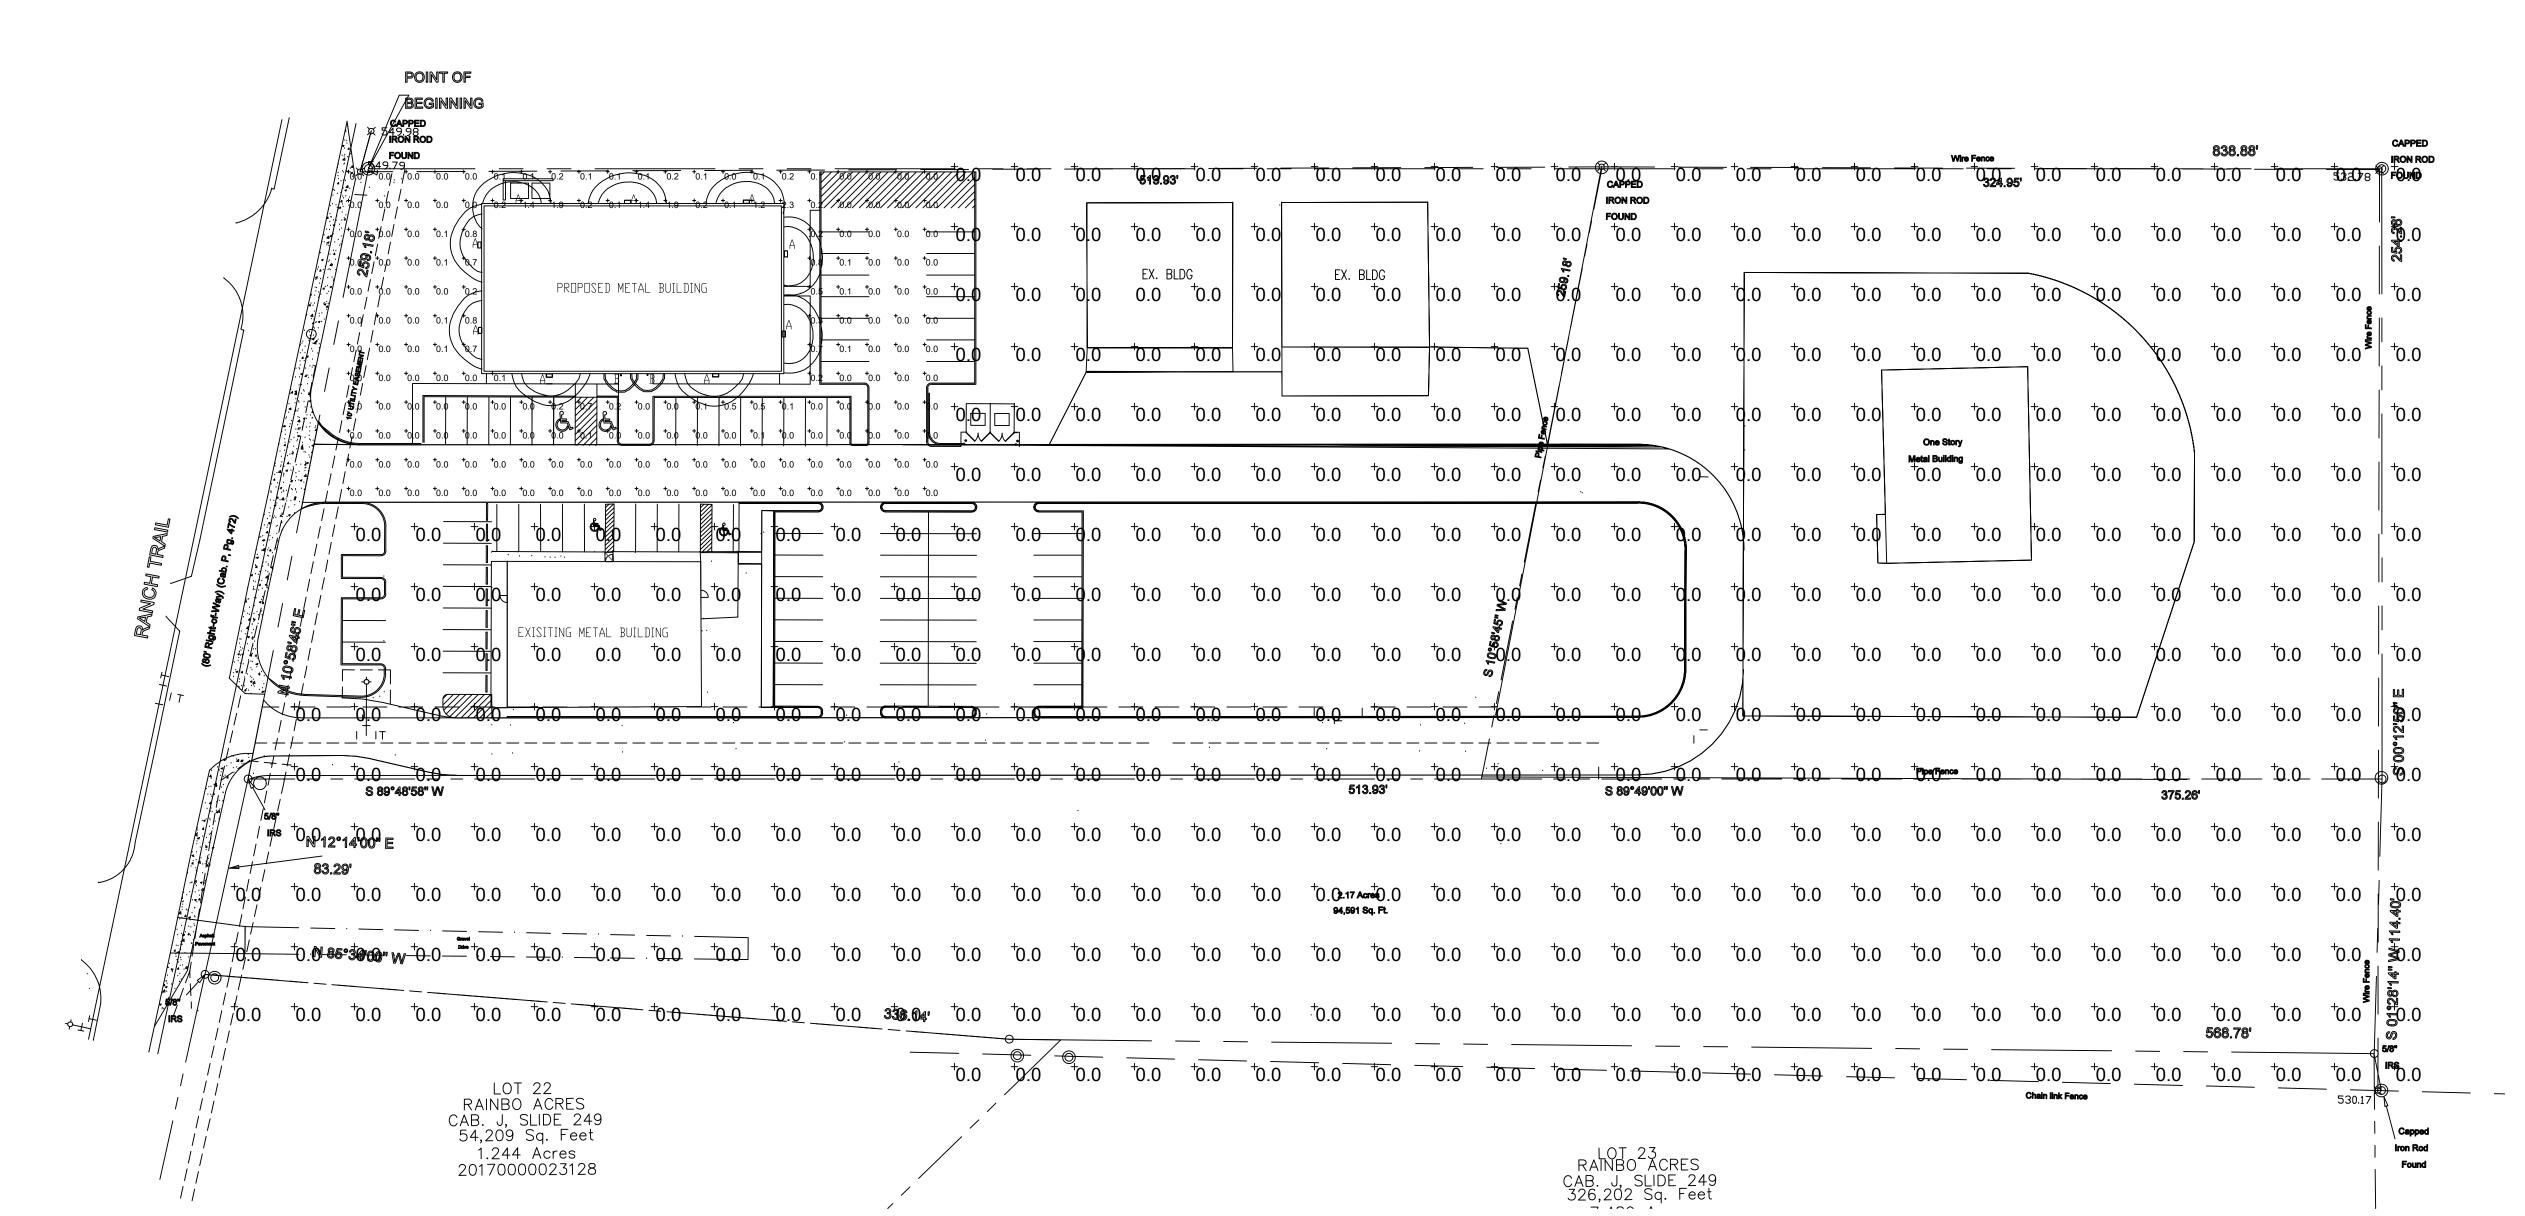



RAMSAY & REYES

ARCHITECTURE - MANAGEMENT
2235 RIDGE RD. STE. 200
ROCKWALL, TEXAS 75087

	1	- ada	T. Canal		
	DATE				
REVISIONS	DESCRIPTIONS/ISSUE				
	No.				
	(	$\overline{\bigcirc}$			

ROCKWALL EPIC VENTURES
351 RANCH TRAIL
ROCKWALL, TEXAS 75032

PROJECT No.	
DRAWN BY	SR
CHECKED BY	RR
DATE	011/107/42/0920
SCALE	1/8"=1'-0"
SHEET NO.	of
DRAWING NAME:	

DRAWING NAME:

PHOTOMETRIC


SITE PLAN

PHOTOMETRIC

SITE PLAN

SCALE: 1" = 40'

SP2019-050

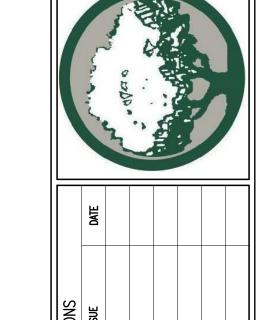

AIL 75032

ANCH , TEX,

351 F ROCKWALI

SR

RR

011/107/4210920 1/8"=1'-0"

of

VENTUR

Ŏ

PROJECT No.

DRAWN BY

CHECKED BY

SHEET NO.

DRAWING NAME:

SCALE

Page 1 of 3 FIXTURE 'B' Š.

**Acuity**Brands. gotham<sup>®</sup>

SERIES: ONE 150-WATT PAR-38 SPOT INCANDESCENT, LAMP: VERTICAL BASE-UP POSITION. LAMP OUTPUT: 1 LAMP, RATED LUMENS/LAMP: 1740 INPUT WATTAGE: 150

CA6 6MB (PAR38/SP)

ACUITY BRANDS LIGHTING CONYERS LAB

CA6 6"OPEN CYLINDER WITH BLACK MICROGROOVE

CA6 6MB (PAR38/SP)

TEST #:

TEST LAB:

CATALOG:

**DESCRIPTION:** 

**TEST DATE:** 

INDOOR PHOTOMETRIC REPORT CATALOG: CA6 6MB (PAR38/SP)

43080

1/31/2008

LUMINOUS OPENING: CIRCULAR (DIA: 5.16") TER VALUE: 9 (BF = 1)TER CATEGORY: CYLINDER CIE CLASS: DIRECT MAX CD: 10,268.0 AT HORIZONTAL: 0°, VERTICAL: 0° SPACING CRITERION: @ 0 = 0.3 / @ 90 = 0.3 **EFFICIENCY:** 74.4%

**Polar Candela Distribution** 180° 170° 160° 150° 140° 4 3 2 1 0 1 2 3 4 5 6 11,000 🗀 9,167 7,333 -5,500 3,667 — 1,833 1,833 3,667 5,500 7,333 9,167 11,000 VA: 0° 10° 20° 30° 40°

■ 1 fc ■ 0.5 fc ■ 0.1 fc Distance in units of mount height (20ft)

VISUAL PHOTOMETRIC TOOL 1.2.46 COPYRIGHT 2019, ACUITY BRANDS LIGHTING. THIS PHOTOMETRIC REPORT HAS BEEN GENERATED ÚSING METHODS RECOMMENDED BY THE IESNA. CALCULATIONS ARE BASED ON PHOTOMETRIC DATA PROVIDED BY THE MANUFACTURER, AND THE ACCURACY OF THIS PHOTOMETRIC REPORT IS DEPENDENT ON THE ACCURACY OF THE DATA PROVIDED. END-USER ENVIRONMENT AND APPLICATION (INCLUDING, BUT NOT LIMITED TO, VOLTAGE VARIATION AND DIRT ACCUMULATION) CAN CAUSE ACTUAL PHOTOMETRIC PERFORMANCE TO DIFFER FROM THE PERFORMANCE CALCULATED USING THE DATA PROVIDED BY THE MANUFACTURER. THIS REPORT IS PROVIDED WITHOUT WARRANTY AS TO ACCURACY, COMPLETENESS, RELIABILITY OR OTHERWISE. IN NO EVENT WILL ACUITY BRANDS LIGHTING BE RESPONSIBLE FOR ANY LOSS RESULTING FROM ANY USE OF THIS REPORT. **PUBLISH** 

VISUAL PHOTOMETRIC TOOL

LIGHT **FIXTURES** 

PAGE 1 OF 3

**EXTERIOR** 

**LIL LED** LED Wall Luminaire 5 g Introduction LIL LED is a compact and energy efficient wall luminaire ideal for replacing small incandescent and **Specifications** CFL luminaires. Photocell and battery pack options With Battery make LIL LED great for installations above doors, Pack(EL) balconies, garage or warehouse entrances, and 5-7/8" security applications. Whether directly mounting to a recessed junction box, or using the back box accessory for conduit entry/through wiring, LIL LED 4-1/4" has you covered! Ordering Information EXAMPLE: LIL LED 40K MVOLT WH LIL LED MVOLT 120 / 277V<sup>1</sup> **DDBTXD** Textured dark **30K** 3000 K (blank) None 40K 4000 K PE MVOLT button photocell 1,2 BB Back box accessory WH White for conduit wiring<sup>'3</sup> EL Battery pack <sup>2</sup> Accessories 1. MVOLT driver operates on 120V and 277V (50/60Hz). PE and EL cannot be ordered together. Optional accessory for conduit entry wiring. Can be ordered with the luminaire or separately. Shipped separately. BB option is not available with emergency battery pack (EL) version. Back box for conduit entry applications, dark bronze - CI Code \*249WXH LIL LED BB DDBTXD LIL LED BB WH Back box for conduit entry applications, white - CI Code \*249WXJ FEATURES & SPECIFICATIONS Easily mounts to recessed junction boxes or for surface mounting and conduit entry — with INTENDED USE The versatility of LIL LED combines a sleek, compact profile with photocell and emergency battery pack options to provide a great solution for wall mount applications. LIL LED is ideal for replacing up to 100W incandescent or 32W CFL luminaires in installations above doors, balconies, garage or warehouse entrances, and security applications. It can also be used for decorative and general This luminaire is mounted with the lens facing down. Neutral wire is required for three phase lighting in outdoor environments. UL Listed to U.S. and Canadian safety standards for wet locations. Rated for -40° C minimum to 40° C maximum ambient temperature. Battery pack versions are rated to 0° C minimum. Tested in accordance with IESNA LM-79 and LM-80 standards. Aluminum housing with white or textured dark bronze paint for lasting durability. The polycarbonate lens creates uniform light distribution, and it is UV resistant - great for outdoor

Light engines are available in 3000K and 4000K CCTs. See Lighting Facts label and photometry

LED technology provides long operating life (L70/50,000 hours at 25°C). Electronic drivers have a power factor >90% and THD <20% and a minimum 2.5kV surge rating.

One Lithonia Way • Conyers, Georgia 30012 • Phone: 800.705.7378 • www.lithonia.com

© 2017-2019 Acuity Brands Lighting, Inc. All rights reserved.

reports for specific fixture performance.

LITHONIA LIGHTING.


COMMERCIAL OUTDOOR

DesignLights Consortium® (DLC) qualified product. Not all versions of this product may be DLC qualified. Please check the DLC Qualified Products List at www.designlights.org/QPL to confirm which versions are qualified. Eligible to be submitted for Title 20 and Title 24 compliance.

5-year limited warranty. Complete warranty terms located at: **Note:** Actual performance may differ as a result of end-user environment and application. All values are design or typical values, measured under laboratory conditions at 25°C. Specifications subject to change without notice.

LIL LED Rev. 08/19/19

http://www.visual-3d.com/Tools/PhotometricViewer/Default.aspx?GUID=6087be34-571... 11/15/2019

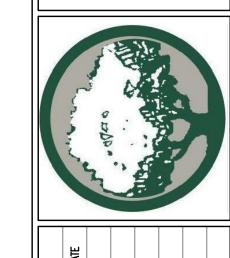

VENTUR

Ŏ

PROJECT No.

DRAWN BY

CHECKED BY

SHEET NO.

DRAWING NAME:

SCALE

AIL 75032

ANCH TEXA

415 F ROCKWALI

SR

RR

11.14.19 1/8"=1'-0"

of

FIXTURE 'B' **Security**Brands.

Page 1 of 3

**g** gotham

ONE 150-WATT PAR-38 SPOT INCANDESCENT,

LUMINOUS OPENING: CIRCULAR (DIA: 5.16") TER VALUE: 9 (BF = 1)TER CATEGORY: CYLINDER CIE CLASS: DIRECT 10,268.0 AT HORIZONTAL: 0°, VERTICAL: 0° MAX CD: SPACING CRITERION: @ 0 = 0.3 / @ 90 = 0.3


VERTICAL BASE-UP POSITION.

1 LAMP, RATED LUMENS/LAMP: 1740

ACUITY BRANDS LIGHTING CONYERS LAB

CA6 6"OPEN CYLINDER WITH BLACK MICROGROOVE

**EFFICIENCY:** 74.4% Polar Candela Distribution 180° 170° 160° 150° 140° 11,0009,167 7,333 -5,500 3,667

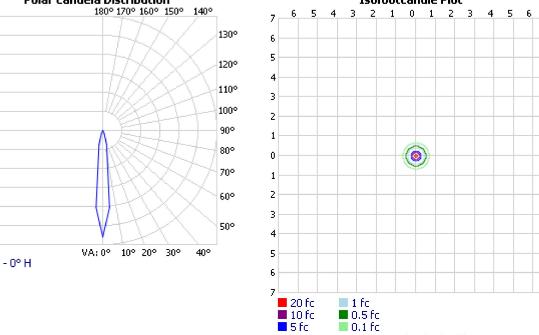

VISUAL PHOTOMETRIC TOOL 1.2.46 COPYRIGHT 2019, ACUITY BRANDS LIGHTING. THIS PHOTOMETRIC REPORT HAS BEEN GENERATED USING METHODS RECOMMENDED BY THE IESNA. CALCULATIONS ARE BASED ON PHOTOMETRIC DATA PROVIDED BY THE MANUFACTURER, AND THE ACCURACY OF THIS PHOTOMETRIC REPORT IS DEPENDENT ON THE ACCURACY OF THE DATA PROVIDED. END-USER ENVIRONMENT AND APPLICATION (INCLUDING, BUT NOT LIMITED TO, VOLTAGE VARIATION AND DIRT ACCUMULATION) CAN CAUSE ACTUAL PHOTOMETRIC PERFORMANCE TO DIFFER FROM THE PERFORMANCE CALCULATED USING THE DATA PROVIDED BY THE MANUFACTURER. THIS REPORT IS PROVIDED WITHOUT WARRANTY AS TO ACCURACY, COMPLETENESS, RELIABILITY OR OTHERWISE. IN NO EVENT WILL ACUITY BRANDS LIGHTING BE RESPONSIBLE FOR ANY LOSS RESULTING FROM ANY USE OF THIS REPORT. PUBLISH

Distance in units of mount height (20ft)

43080 VISUAL PHOTOMETRIC TOOL

LIGHT **FIXTURES** 

PAGE 1 OF 3

EXTERIOR



CA6 6MB (PAR38/SP)

TEST #:

TEST LAB:

TEST DATE:

CATALOG:

SERIES:

LAMP:

**DESCRIPTION:** 

LAMP OUTPUT:

1,833 —

1,833 —

3,667 5,500

7,333 —

9,167

11,000 🗀

0.00

INPUT WATTAGE: 150

INDOOR PHOTOMETRIC REPORT CATALOG: CA6 6MB (PAR38/SP)

43080

1/31/2008

CA6

CA6 6MB (PAR38/SP)

Light engines are available in 3000K and 4000K CCTs. See Lighting Facts label and photometry reports for specific fixture performance. LED technology provides long operating life (L70/50,000 hours at 25°C). Electronic drivers have a power factor >90% and THD <20% and a minimum 2.5kV surge rating.

One Lithonia Way • Conyers, Georgia 30012 • Phone: 800.705.7378 • www.lithonia.com

© 2017-2019 Acuity Brands Lighting, Inc. All rights reserved.

LITHONIA LIGHTING.

COMMERCIAL OUTDOOR

### 5-year limited warranty. Complete warranty terms located at:

**Note:** Actual performance may differ as a result of end-user environment and application. All values are design or typical values, measured under laboratory conditions at 25°C. Specifications subject to change without notice.

LIL LED Rev. 08/19/19

http://www.visual-3d.com/Tools/PhotometricViewer/Default.aspx?GUID=6087be34-571... 11/15/2019

### RAMSAY & REYES L.L.C.

PROJECT MANAGEMENT · ARCHITECTS · PLANNERS

RE: REQUEST FOR VARIANCE 351 Ranch Trail Rockwall, Texas 75032

To the City of Rockwall, Planning and Zoning Commission

Our intention is to develop this property to visually enhance Ranch Trail, and to not undermine what is written in the code. The building presented in this case compliments, if not exceeds the articulation of all the existing buildings along Ranch Trail. It is with our best interest to continue with the current design of the building and proceed with the site plan application, pending other conflicts. In a compensatory effort for the request, we will wainscot three visible elevations with natural stone and provide landscaping at the front of the proposed building.

Best Regards, Ross Ramsay Texas Architect #2449



2235 RIDGE ROAD ROCKWALL, TEXAS 75087



#### January 21, 2020

TO:

Ross Ramsay

Ramsay & Reyes, LLC 2235 Ridge Road Rockwall, TX 7587

CC:

Mike Dual

Epic Rockwall Ventures 315 Ranch Trail Rockwall, TX 75032

FROM:

David Gonzales, AICP

City of Rockwall Planning and Zoning Department

385 S. Goliad Street Rockwall, TX 75087

SUBJECT:

SP2019-050; Site Plan for Lot 17 & 17-1, Rainbow Acres Addition

#### Ross Ramsay:

This letter serves to notify you that the above referenced site plan case, that you submitted for consideration by the City of Rockwall, was approved by the Planning and Zoning Commission on January 14, 2020. The following is a record of all recommendations, voting records and conditions of approval:

#### Staff Recommendations

- (1) All staff comments provided by the Planning, Engineering and Fire Department must be addressed prior to the submittal of a building permit;
- (2) Approval by the Planning and Zoning Commission of all exceptions requested as outlined in this case memo;
- (3) Any construction resulting from the approval of this site plan shall conform to the requirements set forth by the Unified Development Code (UDC), the International Building Code (IBC), the Rockwall Municipal Code of Ordinances, city adopted engineering and fire codes and with all other applicable regulatory requirements administered and/or enforced by the state and federal government.

#### Planning and Zoning Commission

On January 14, 2020, the Planning and Zoning Commission's motion to approve the site plan with staff conditions and the Architectural Review Board (ARB) recommendation was approved by a vote of 6-0, with Commissioner Logan absent. Additionally, the motion included approval of the exceptions for building articulation as outlined in staff's report.

#### Outstanding Department Comments

#### Planning and Zoning

#### (1) Landscape Plan.

- Indicate the locations of all existing and proposed landscaping (including trees along Ranch Trail). (Section 3, Art. VIII, UDC)
- B. Under the plant schedule, indicate the minimum height of four (4)-feet for the 12 Texas Sage accent trees to be planted. (Section 4(A)(2), Art. VIII, UDC)

Prior to submitting your civil engineering plans to the Engineering Department, you will need to submit bonded and digital copies of the site plan showing that all outstanding comments have been addressed. Please note that site plans that have not been completed within two (2) years of the final approval date shall be deemed to have expired. An extension may be granted by the Planning and Zoning

Commission upon submission of a written request at least 90-days prior to the expiration date. Should you have any questions or concerns regarding your site plan or the site plan process, please feel free to contact me a (972) 771-7745.

Sincerely

David Gonzales, AICR

Planning and Zoning Manager