

P&Z CASE#	P&Z DATE	CC DA	ATE Approved/Denied
ARCHITECTURA	AL REVIEW BOARD DATE	HPAB DATE_	PARK BOARD DATE
☐ Zoning☐ PD Cor	: Use Permit		Copy of Ordinance (ORD#) Applications Receipt Location Map HOA Map PON Map
Building Materia Color R Platting Applica Master Prelimir Final Pl Replat	ann ape Plan ape Plan ape Plan apetric Plan g Elevations I Samples lendering ation Plat nary Plat		FLU Map Newspaper Public Notice 500-foot Buffer Public Notice Project Review Staff Report Correspondence Copy-all Plans Required Copy-Mark-Ups City Council Minutes – Laserfiche Minutes-Laserfiche Plat Filled Date Cabinet # Slide #
□ Vacatio □ Landsc			
HPAB Applicati Exhibit	on		
Miscellaneous A	Application e/Exception Request	Zoning I	Map Updated



DEVELOPMENT APPLICATION

City of Rockwall
Planning and Zoning Department
385 S. Goliad Street
Rockwall, Texas 75087

TAFF	USE	ONLY	-

PLANNING & ZONING CASE NO.

SP2027-035

NOTE: THE APPLICATION IS NOT CONSIDERED ACCEPTED BY THE CITY UNTIL THE PLANNING DIRECTOR AND CITY ENGINEER HAVE SIGNED BELOW.

DIRECTOR OF PLANNING:

CITY ENGINEER:

					-
PLEASE CHECK THE AI	PPROPRIATE BOX BELOW TO INI	DICATE THE TYPE OF	DEVELOPMENT REQ	UEST [SELECT ONLY ONE BOX]:	
☐ PRELIMINARY PL ☐ FINAL PLAT (\$300.00 ☐ REPLAT (\$300.00 ☐ AMENDING OR M ☐ PLAT REINSTATE SITE PLAN APPLICA ☑ SITE PLAN (\$250	100.00 + \$15.00 ACRE) 1 LAT (\$200.00 + \$15.00 ACRE) 1 0.00 + \$20.00 ACRE) 1 0 + \$20.00 ACRE) 1 MINOR PLAT (\$150.00) EMENT REQUEST (\$100.00)	G PLAN (\$100.00)	☐ SPECIFIC USI ☐ PD DEVELOP OTHER APPLICA ☐ TREE REMOV ☐ VARIANCE RE NOTES: □ IN DETERMINING TH PER ACRE AMOUNT. F □ A \$1,000.00 FEE W	NGE (\$200.00 + \$15.00 ACRE) 1 E PERMIT (\$200.00 + \$15.00 ACRE) 1 & 2 MENT PLANS (\$200.00 + \$15.00 ACRE) 1 ITION FEES:	I) ACRE. ST THAT
PROPERTY INFO	RMATION [PLEASE PRINT]				
ADDRESS	Moton Addition, City of Roc	kwall, Rockwall Cou	nty, Texas, situate	d within the Hillside Mixed Use Subdistrict	and
SUBDIVISION				rict 32 (PD-32), generally located at the	
GENERAL LOCATION	southwest corner of the inte	ersection of Horizon i	Koad and Summer	Lee Drive.	
ZONING, SITE PLA	AN AND PLATTING INFO	RMATION (PLEASE)	PRINT		
CURRENT ZONING	PD-32		CURRENT USE	Undeveloped	
PROPOSED ZONING	PD-32		PROPOSED USE	Condominium	
ACREAGE	3.59 Acres	LOTS [CURRENT]	N/A	LOTS [PROPOSED] N/A	
REGARD TO ITS AF RESULT IN THE DEI	PPROVAL PROCESS, AND FAILURE T NIAL OF YOUR CASE.	TO ADDRESS ANY OF ST	AFF'S COMMENTS BY	GE OF <u>HB3167</u> THE CITY NO LONGER HAS FLEXI THE DATE PROVIDED ON THE DEVELOPMENT CALL "ACT/ORIGINAL SIGNATURES ARE REQUIRED]	BILITY WI ENDAR W
	RIV Properties LLC		☑ APPLICANT	RIV Properties LLC	
CONTACT PERSON	Asher Hamilton	c	ONTACT PERSON	Asher Hamilton	
ADDRESS	PO Box 192054		ADDRESS	PO Box 192054	
CITY, STATE & ZIP	Dallas, Texas 75219		CITY, STATE & ZIP	Dallas, TX 75219	
PHONE	(214) 908-4684		PHONE	(214) 908-4684	
E-MAIL	ahamilton@realtyinvestments.c	com	E-MAIL	ahamilton@realtyinvestments.com	
TATED THE INFORMATION	IGNED AUTHORITY. ON THIS DAY PE I ON THIS APPLICATION TO BE TRUI	E AND CERTIFIED THE FO		[AGEN7] THE UNDERSIG	
321.80 TO COVER THE FORMATION CONTAINED	HE COST OF THIS APPLICATION HAS B	BEEN PAID TO THE CITY OF S APPLICATION, I AGREE PUBLIC. THE CITY IS A	FROCKWALL ON THIS TI THAT THE CITY OF RO LSO AUTHORIZED AND	CKWALL (I.E. "CITY") IS AUTHORIZED AND PERMITTED PERMITTED TO A REQUEST FOR EURISE CINFORMATIRIE A BLAKE	TO PROV
IVEN UNDER MY HAND AN	D SEAL OF OFFICE ON THIS THE	DAY OF JUNE	20 <u>7</u> 2	Notary ID #1334512 My Commission Exp November 16, 202	ires
	AGENTS SIGNATURE				
OTARY PUBLIC IN AND FO	R THE STATE OF TEXAS	i 22		MY COMMISSION EXPIRES 11/16	1909



CHECKLIST FOR SITE PLAN SUBMITTALS

City of Rockwall Planning and Zoning Department 385 S. Goliad Street Rockwall, Texas 75087

CASE NUMBER:	REVIEWED BY:
OVERLAY DISTRICT:	REVIEW DATE:

1.1 GENERAL INFORMATION FOR ALL PLANS SUBMITTED

Requirements	√= 0K	N/A	Comments	UDC Reference
Items Necessary for Site Plan Review:	_/			Per Application
✓ Site Plan	Ø			§03.04, of
✓ Landscape Plan	\square			Art. 11
√ Treescape Plan	<u> ব্</u> রদ্রদ্			-
✓ Photometric Plan	\boxtimes			-
✓ Building Elevations	⊻	П	W 1.1	-
Building Material Sample Board and Color Rendering of Building Elevations	Ø		If required the sample board should detail all building materials, with each material clearly labeled and indicating manufacturer info, color, etc. Check with Planning Staff to see which is appropriate for the submitted project.	§03.04.A, of Art. 11
Submittal Requirements	Ø		Four (4) large (24" x 36") <u>folded</u> copies and one (1) PDF digital copy of each plan is required at the time of submittal.	§03.04.A, of Art. 11
Is the property properly platted?	\square		Indicate if the property has been properly platted.	-
Title Block	/		The title block is to be located in the lower right-hand corner of	000 04 4 6
(Project Name, Legal Description and/or Address)	\square		all sheets and contain the project name, street address, and/or the lot and block designation.	§03.04.A, of Art. 11
Case Number	\square		The case number should be placed in the lower right-hand corner below the title block of all sheets.	§03.04.A, of Art. 11
Owners (Name, Address, and Phone Number)	\square		The owners name, address, and phone number are required to be in the lower right-hand corner left of the title block.	§03.04.A, of Art. 11
Developer (Name, Address, and Phone Number)			The name, address, and phone number of the person or company that prepared the plans are required in the lower right-hand corner left of the title block.	§03.04.A, of Art. 11
North Point	⊌		The north point or north arrow must be facing true north (or straight up) on all plans, unless the scale of the drawings or scope of the project requires a different position.	§03.04.A, of Art. 11
Numeric and Graphic Scale			The recommended engineering scales are $1" = 20'$, $1" = 40'$, etc with a maximum of $1" = 100'$.	§03.04.A, of Art. 11
Vicinity Map	ø.		The vicinity map should locate the site relative to the nearest major roadways in a one-half mile radius.	§03.04.A, of Art. 11
Signature Block	Ø		Standard signature block with signature space for the Planning & Zoning Chairman and Planning Director.	§03.04.A, of Art. 11
Date	Ø		The date that the plans were prepared is required on all submittals.	§03.04.A, of Art. 11
Proposed Land Use:			Indicate the proposed use for this site. Additionally, indicate the proposed use for all structures.	§03.04.A, of Art. 11
✓ Commercial	Ø		Land Uses Permitted in the RO, NS, GR, C, DT, RC & Designated Planned Development District Ordinances.	
✓ Industrial			Land Uses Permitted in the RT, LI, HI & Designated Planned Development District Ordinances.	•

2.1 SITE PLAN: MISCELLANEOUS AND DENSITY & DIMENSIONAL INFORMATION

Requirements	✓= OK	N/A	Comments	UDC Reference
Total Lot or Site Area (Acreage and Square Footage)	Ø		If the site is part of a larger tract include a key map showing the entire tract of land and the location of the site being planned.	§03.04.B, of Art. 11

Rights-of-Way & Landscape Buffers	ď		All landscape buffers and public right-of-way located adjacent to a proposed development shall be improved with grass (i.e. sod — hydro mulch shall be prohibited in these areas) prior to the issuance of a Certificate of Occupancy (CO).	§05.03.G, of Art. 08
Hydro mulch (or non-sod option)	ď		The developer shall establish grass and maintain the seeded area, including watering, until a "Permanent Stand of Grass" is obtained at which time the project will be accepted by the City. A "Stand of Grass" shall consist of 75% to 80% coverage and a minimum of one-inch (1") in height as determined by the City.	Sec. 4.2, Coverage, Engr Standards of Design and Construction
Irrigation Requirements Note	ď		Provide note indicating irrigation will meet requirements of UDC.	§05.04, of Art. 08
Tree Locations	d		Trees must be planted at least five (5) feet from water, sewer and storm sewer lines.	§05.03.E, of Art. 08
Landscape Buffer - Street Trees			Large trees (a species which normally reaches a height of 30 feet or more upon maturity) shall be provided in the required street landscape buffer in numbers equal to one (1) tree for every 50 feet of street frontage.	§05.01, of Art. 08
Identify Visibility Triangles			Identify visibility triangles on all lots for all driveway intersections and public streets.	§01.08, of Art. 05
Location of all Site Amenities	\square		Identify the size, height, location, and material of proposed seating, lighting, planter's sculptures, water features and landscape paving and other public amenities.	æS
Parking Lot Landscaping		d	Complete description of landscaping and screening to be provided in or near off-street parking and loading areas, including the information as to the amount (in sq. ft.) of landscape area to be provided internal to parking areas, the total square footage included in the parking area, and the number and location of required off-street parking and loading spaces.	§05.03.E, of Art. 08
Protected Trees (That Will Remain On-Site)		र्ज	Indicate the location and provide a description by type and size of all existing protected trees (4" or larger) proposed to be retained. Prior to any construction or land development, the developer shall clearly mark all protected and feature trees with an aluminum tag indicating the trees relationship to the treescape plan and flag (i.e. bright fluorescent red vinyl tape). In those instances where a protected tree is so close to the construction area that construction equipment could possibly damage the tree, a protective fence shall be required.	§07.01, of Art. 09
✓ Trees not allowed in Landscape Buffers	d		Silver Maple, Box Elder, Mimosa, Catalpa, Hackberry, Sugarberry, Honey Locust, Tulip Tree, Chinaberry, Sycamore, Cottonwood, Willows, American Elm, Siberian Elm, Jerusalem Thorn/Petuma, Bois D'Arc, Flowering Crabapple Tree, Ginko Tree, Peach/Plum, Mulberry, Texas Mountain Laurel, Lilac Chaste Tree, and Pine Tree.	Appendix C
✓ Trees allowed in Street Landscape Buffers	ⅎ		Cedar Elm, Texas Red Oak, Homestead Elm, Lace Bark Elm, Bald Cypress, Chinese Pistachio, October Glory Maple, Pecan, Texas Ash, Live Oak, Chinquapin Oak, and Burr Oak (Understory Trees: Texas Redbud, Mexican Plum, Downy Hawthom, Wax Myrtle, Yaupon, and Deciduous Yaupon)	Appendix C
Acceptable Landscape Materials:				Sec. 04., of Art. 08

4.1 TREESCAPE PLAN

Requirements	√= OK	N/A	Comments	UDC Reference
Provide Site Data	d		Provide the same site data information required in Section 2.1 Site Plan: Miscellaneous and Density and Dimensional Requirements of this checklist.	See Sec. 2.1 of this checklist
Buildings			Indicate the location of all existing or proposed structures, and/or the building pads as shown on the grading plan.	§03.01.A, of Art. 09
Indicate all Site Elevations, Grades, Major Contours and the Limits of Construction	d		, , , , , , , , , , , , , , , , , , ,	§03.01.C, of Art. 09

(To Remain On Site) Protected Trees (To be Removed from the Site)	⊠ ☑	retained. Such trees shall be marked and a drip line of said tress shall be protected prior to and during all construction, including dirt work. Indicate the location of all protected trees (4" or larger) that are to be removed from the site and the proposed locations of all	\$03.01.E, of Art. 09 \$03.01.F, of Art. 09
Treescape Table	d	replacement trees. Provide a table showing the total inches of trees to be removed and the total inches of trees to be replaced.	§03.01.G, of Art. 09

5.1 PHOTOMETRIC AND LIGHTING PLANS

Requirements	√= OK	N/A	Comments	UDC Reference
Provide Site Data Table	d		Provide the same site data information required in Section 2.1 Site Plan: Miscellaneous and Density and Dimensional Requirements of this checklist.	See Sec. 2.1 of this checklist -
Indicate Lighting Levels (in Foot Candles [FC])			Show lighting levels in foot-candles (FC) measured throughout the site and extended to all property lines of the subject property.	§03.03, of Art. 07
Adjacent Property with Common Lot Lines:				
✓ Residential Use	\square		The allowable maximum light intensity measured at the property line of a residential property shall be 0.2 of one foot candle.	§03.03.B, of Art. 07
✓ Commercial Use			The allowable maximum light intensity measured at the property line of a non-residential property shall be 0.2 of one foot candle. Subject to requirements in Art. VII 3.3.C.	§03.03.C, of Art. 07
Under-Canopy Lighting	☑		Under canopy lighting (i.e. fuel stations, drive through lanes and covered parking structures) shall not exceed 35 foot candles (with the exception below).	§03.03.E.1, of Art. 07
Lighting for Motor Vehicle Dealerships	☑		Shall not exceed 0.3 of one foot candle within the front yard of the development. The remainder will comply with the 0.2 of one foot candle.	§03.03.E.2, of Art. 07
Lighting in Parking Areas	d		The maximum outdoor maintained, computed and measured illumination level within any nonresidential development shall not exceed 20 FC outdoors at any point on the site, with a maximum of 0.2 FC at the property line. (Exceptions: (1) under canopy lighting and (2) motor vehicle dealerships)	§03.03.G, of Art. 07
Building and Pole Mounted Lighting	\square		Indicate the location and type of all exterior lighting, including pole mounted, wall-mounted, signage, etc.	§03.03.E, of Art. 07
Indicate the Mounting Height for all Proposed Light Fixtures	Ø		No light pole, base or combination thereof shall exceed 30 feet, unless further restricted within an Overlay District.	§03.03.D of Art. 07
Indicate the Wattage of all Light Sources	√		Provide lighting cut sheets that indicates the wattage for each exterior lighting fixture. Light sources (e.g. light bulbs) shall be oriented down and toward the center of the site or shielded so as to not be visible from the property line.	§03.03.A, of Art. 07
Proposed Light Fixtures	Ø		Provide elevation drawings and/or cut-sheets of proposed light fixtures on/with photometric plan.	§03.03, of Art. 07


6.1 BUILDING ELEVATIONS: NON-INDUSTRIAL


Requirements	✓= OK	N/A	Comments	UDC Reference
Provide Exterior Elevations	Ø		North South East West (Circle all that apply)	-
Indicate Exterior Elevations Adjacent to Public Right-of-Way	d		North South East West (Circle all that apply)	
Minimum 90% Masonry Requirement OVERLAY DISTRICTS ONLY		\square	Exterior walls should consist of 90% masonry materials excluding doors and windows.	§06.02.C, of Art. 05
Indicate Amount and Location of the Minimum 20% Stone Requirement OVERLAY DISTRICTS ONLY		\square	Applies to facades that are visible from a public right-of-way and/or open space.	§06.02.C, of Art. 05
Indicate the Surface Area of Each Facade	d		Indicate the surface area (square feet) of each façade and the percentage and square footage of each material used on that façade.	§04.01, of Art. 05
Proposed Building Materials	☑.		Specifications and description of all proposed building materials, on all proposed buildings.	§04.01, of Art. 05
Indicate the Roofing Materials and Color	Ø		,,,,,,,,,,,,,,,,,,,,,,,,,,,,,,,,,,,,,,,	


Indicate Parapet Wall Height **(If Applicable, finish the interior side of the parapet wall)			If applicable indicate the parapet wall by dashing in the top of roof deck. **Projecting elements and parapets that are visible from adjacent properties or public right-of-way shall be finished on the interior side using the same materials as the exterior facing wall.	§04.01, of Art. 05
Indicate all Roof Mounted Mechanical Equipment (If Applicable)	\square		If applicable indicate any proposed roof mounted mechanical equipment and indicate how these will be screened from view.	§01.05.C, of Art. 05
Indicate Any Additional Design Elements Proposed (If Applicable)	Ø		Indicate any additional design elements for the base, walls, or parapets (such as cornice, arcades, and covered walkways/windows). Be sure to include the location, size, color, and material of any proposed structure.	
Indicate Building Height(s)	Ø		The height of the building shall be measured from the average elevation of the finished grade along the front of the building to the highest point of the roof or parapet of the building if it is a flat, mansard or shed roof; or to the midpoint of the roof if it is gable, hip or gambrel roof.	§07.03 of Art. 05
Minimum Standards for Articulation:			Section 1 Control Cont	
Primary Facades (i.e. facades visible from a public ROW, open space/green space, public/private park, and or residential zoning district or residentially used property)	d		 Wall Height [H] = H Wall Length [L] = 3 x H Secondary Entry/Arch. Element Length = 25% x L Wall Projection = 25% x H Primary Entry/Arch. Element Width = 2 x (25% x L) Projection Height = 25% x H Primary Entry/Arch. Element Length = 2 x (25% x L) 	§04.01.C.1, of Art. 05
Secondary Facades	d	. 0	 Wall Height [H] = H Wall Length [L] = 3 x H Secondary Entry/Arch. Element Length = 15% x L Secondary Entry/Arch. Element Width = 15% x H Projection Height = 15% x H 	§04.01.C.2, of Art. 05

6.2 BUILDING ELEVATIONS: INDUSTRIAL

Requirements	✓= OK	N/A	Comments	UDC Reference
NOTE: Industrial buildings are subject to all the eler standards.	nents listed in Se	ection 6.1 E	Building Elevations: Non-Industrial with the exception of the	following
Minimum 90% Masonry Requirement			Exterior walls should consist of 90% masonry materials excluding doors and windows.	\$ §05.01.A.1, of Art. 05
Indicate Amount and Location of the Minimum 20% Stone Requirement Minimum Standards for Articulation:		Ø	Applies to facades that are visible from a public right-of-way and/or open space.	§05.01.A.1.a.1, of Art. 05
Primary Facades (i.e. facades visible from a public ROW, open space/green space, public/private park, and or residential zoning district or residentially used property)		d	 Wall Height [H] = H Wall Length [L] = 4 x H Wall Projection = 25% x H Entry/Arch. Element Length = 33% x L Projection Height = 25% x H Entry/Arch. Element Width = 2 x (25% x H) 	§05.01.C.1, of Art. 05
Secondary Facades		ⅎ	 Wall Height [H] = H Wall Length [L] = 3 x H Entry/Arch. Element Length = 15% x L Entry/Arch. Element Width = 15% x H Projection Height = 15% x H 	§05.01.C.2, of Art. 05

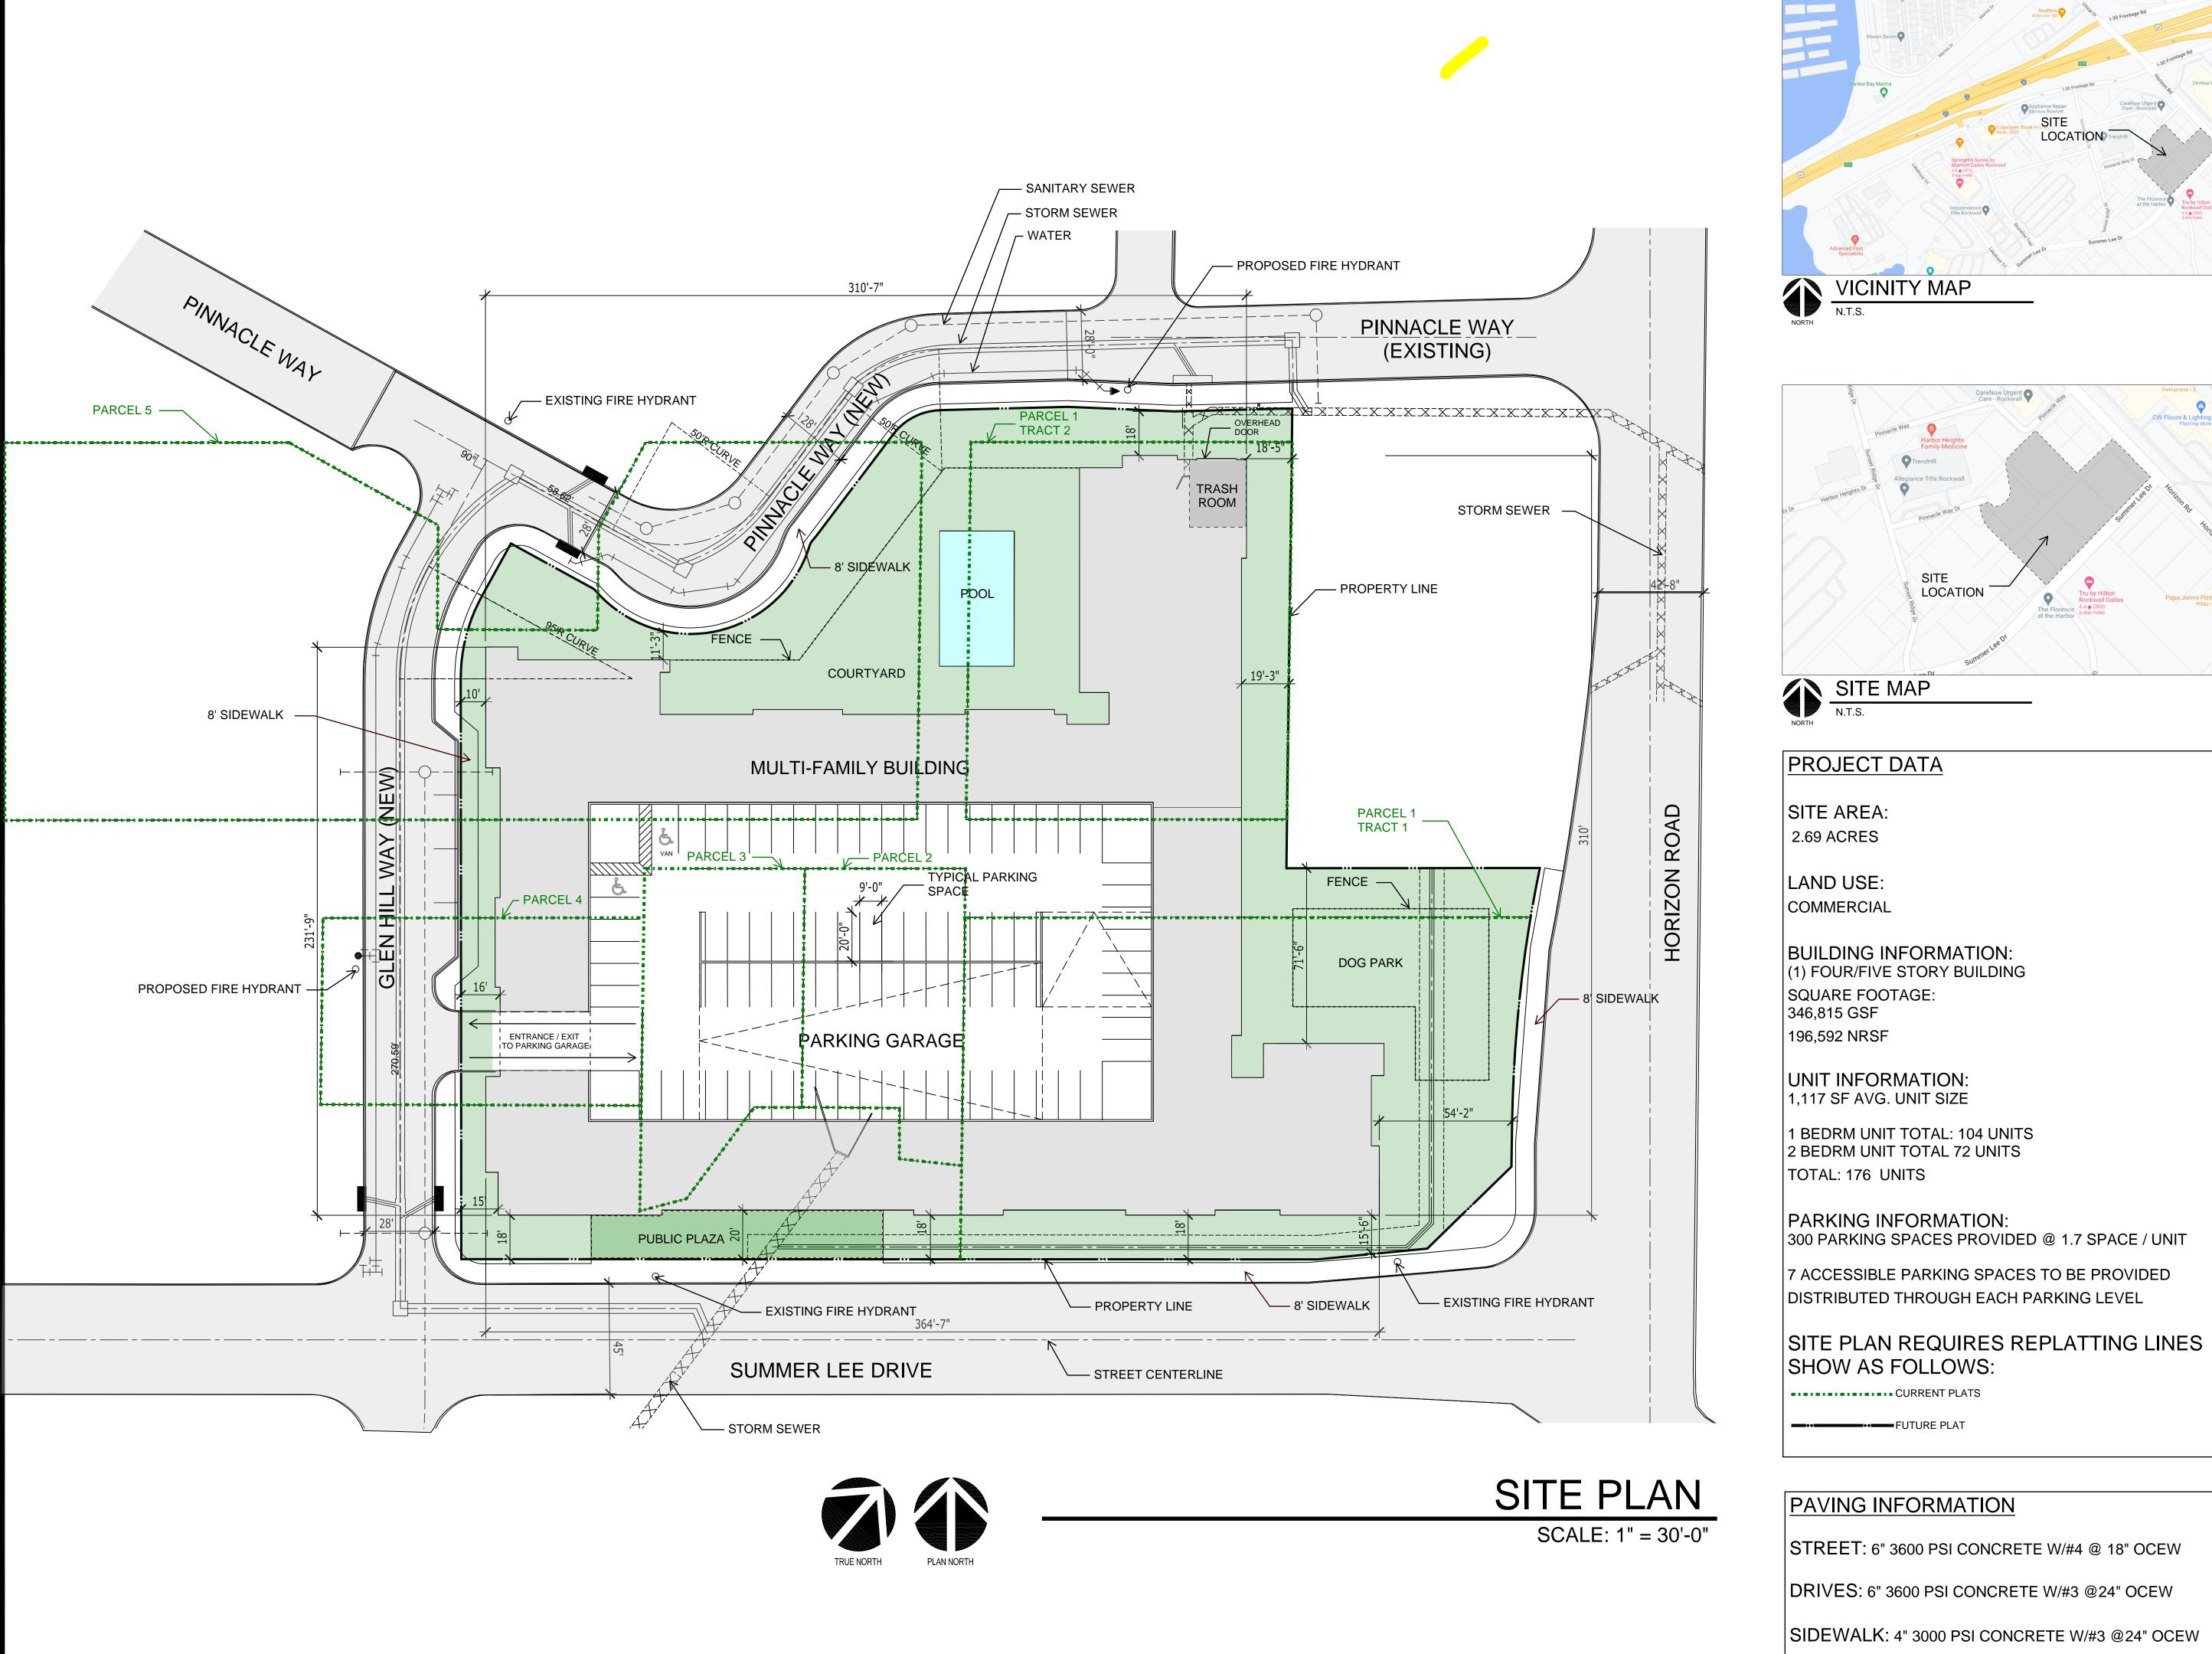

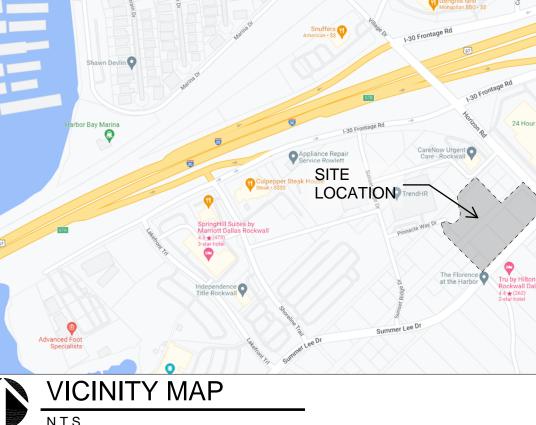

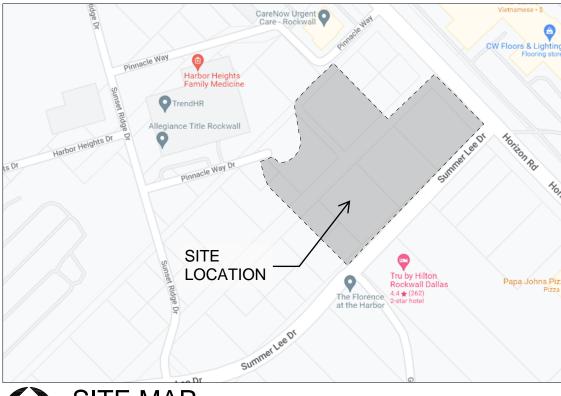

DESIGN BALANCE, INC. 2231 RIDGE ROAD, SUITE 200 ROCKWALL, TEXAS 75087 214.668.2306

RIV PROPERTIES, LLC P.O. BOX 192054 DALLAS, TX 75219 214.908.4684

HARBOR RESIDENCES:

PORTION OF THE MOTON ADDITION, CITY OF ROCKWALL ROCKWALL COUNTY, TEXAS,
SITUATED WITHIN THE HILLSIDE
MIXED USE SUBDISTRICT AND THE HORIZON/SUMMER LEE SUBDISTRICT OF PLANNED DEVELOPMENT DISTRICT 32 (PD-32), GENERALLY LOCATED AT THE SOUTHWEST CORNER OF THE INTERSECTION OF HORIZON ROAD AND SUMMER LEE DRIVE

DATE ISSUED:

06/17/2022

SHEET NUMBER AND TITLE: 2.1 SITE PLAN

CASE NUMBER:

PLANNING AND ZONING CHAIRMAN SIGNATURE:



Surface Area: 17,647 SF

Material Percentages
Brick: 32%
Stucco: 68%

O1 EAST ELEVATION
Scale: 1" = 30'-0"



Surface Area: 21,154 SF

Material Percentages
Brick: 34%
Stucco: 66%

O2 SOUTH ELEVATION

Scale: 1" = 30'-0"



Mechanical equipment to b

ROOFTOP EQUIPMENT:

Mechanical equipment to be on the rooftop. This will either be hidden by the parapets or screened

PROPOSED BUILDING MATERIAL:

Brick:

ACME Brick; Marble Grey ACME Brick; Ridgemar

Stucco Colors

tucco Colors
Sherwin Williams; SW 9165; Gossamer Veil
Sherwin Williams: SW 7066; Gray Matters

Sherwin Williams; SW 7066; Gray Matters
Sherwin Williams; SW 7069; Iron Ore

Roof Materials
BORAL Concrete Roof Tile; Saxony Country Slate; Charcoal Blend
Thermoplastic Polyolefin

Precast Stone Coronado Stone; Lompoc

03 WEST ELEVATION


Scale: 1" = 30'-0"



Surface Area: 14,488 SF

Material Percentages
Brick: 30%
Stucco: 70%

NORTH ELEVATION
Scale: 1" = 30'-0"

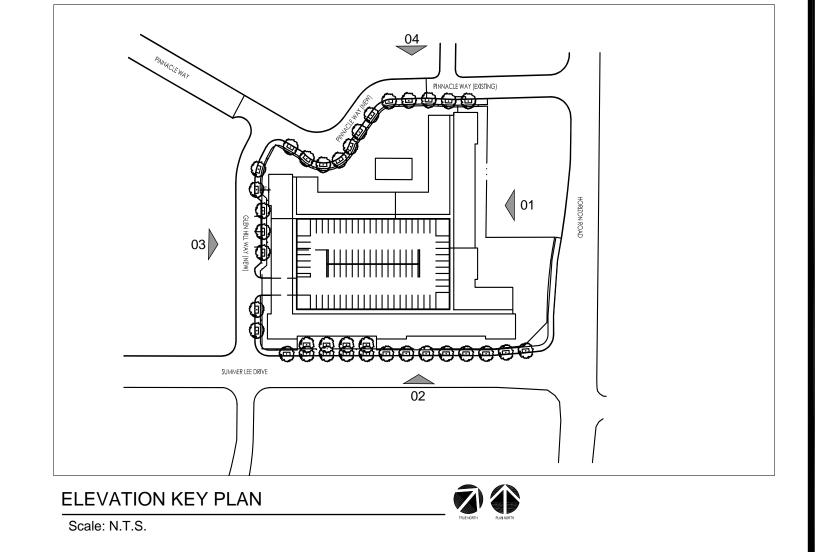

DESIGN BALANCE, INC. 2231 RIDGE ROAD, SUITE 200 ROCKWALL, TEXAS 75087 214.668.2306

WNER:

P.O. BOX 192054 DALLAS, TX 75219 214.908.4684

HARBOR RESIDENCES:

PORTION OF THE MOTON
ADDITION, CITY OF ROCKWALL,
ROCKWALL COUNTY, TEXAS,
SITUATED WITHIN THE HILLSIDE
MIXED USE SUBDISTRICT AND
THE HORIZON/SUMMER LEE
SUBDISTRICT OF PLANNED
DEVELOPMENT DISTRICT 32
(PD-32), GENERALLY LOCATED
AT THE SOUTHWEST CORNER OF
THE INTERSECTION OF HORIZON
ROAD AND SUMMER LEE DRIVE

DATE ISSUED:


06/17/2022


SHEET NUMBER AND TITLE:

6.1 BUILDING
ELEVATIONS

CASE NUMBER:


PLANNING AND ZONING CHAIRMAN SIGNATURE:

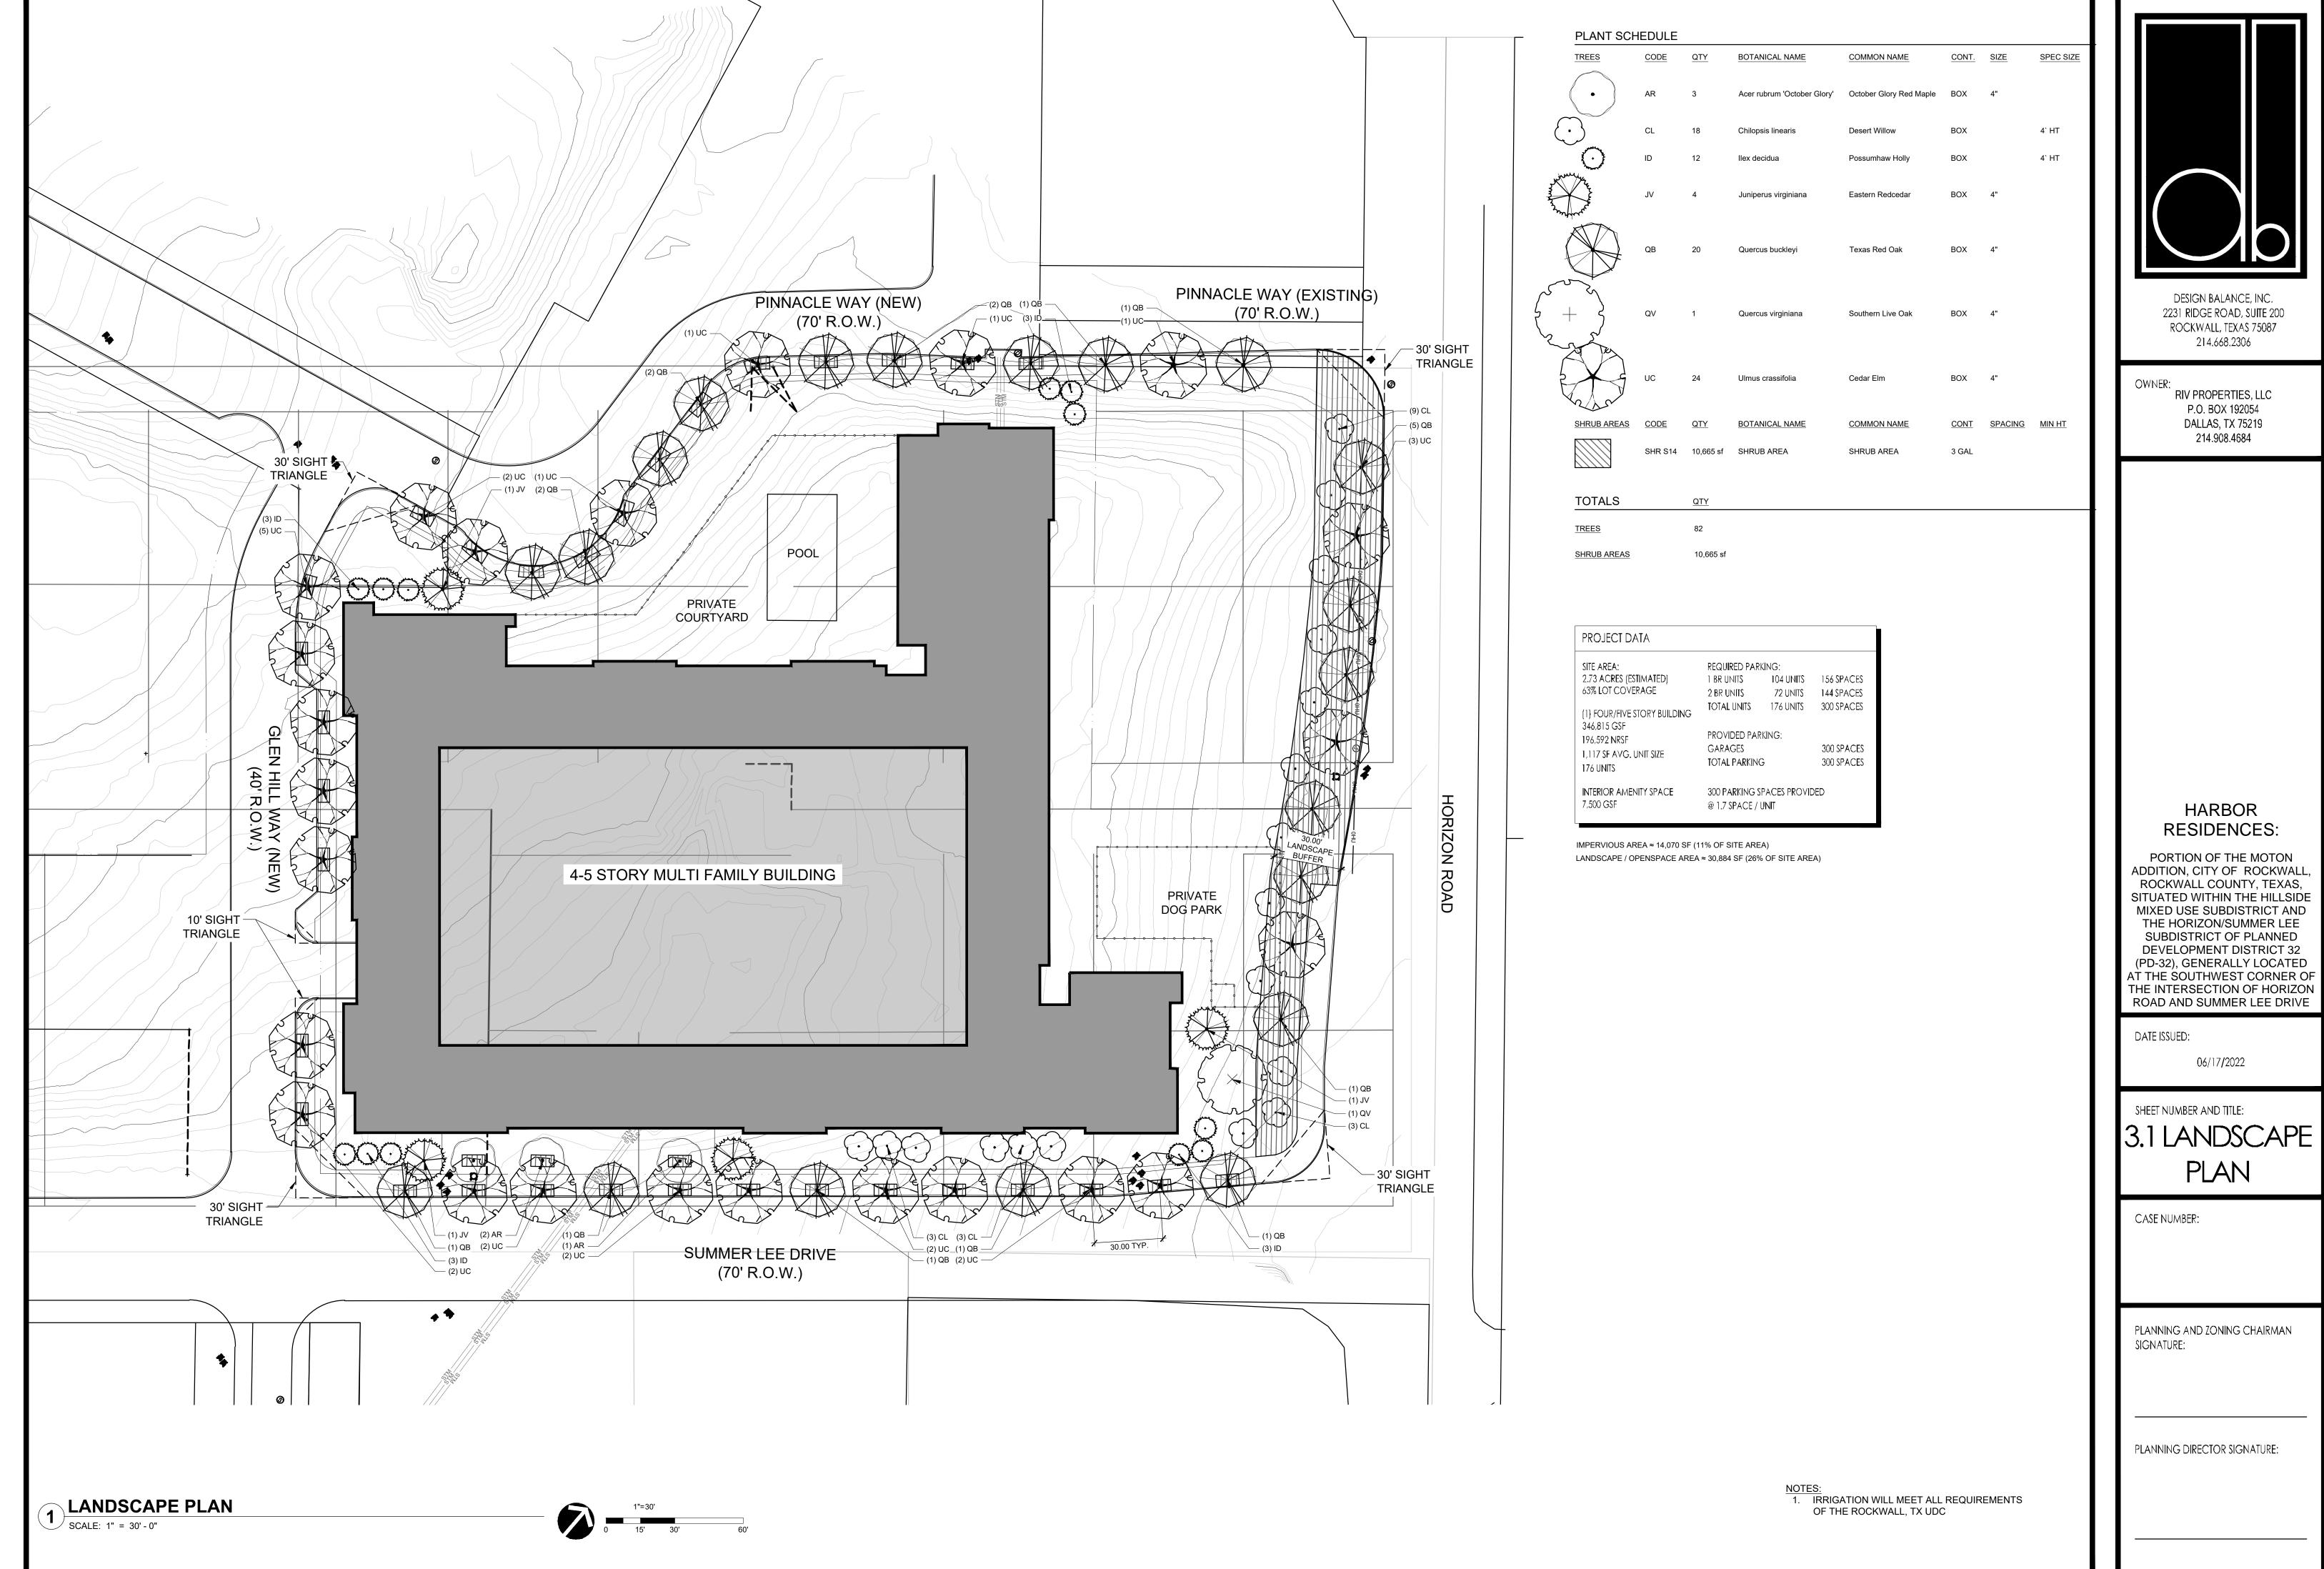

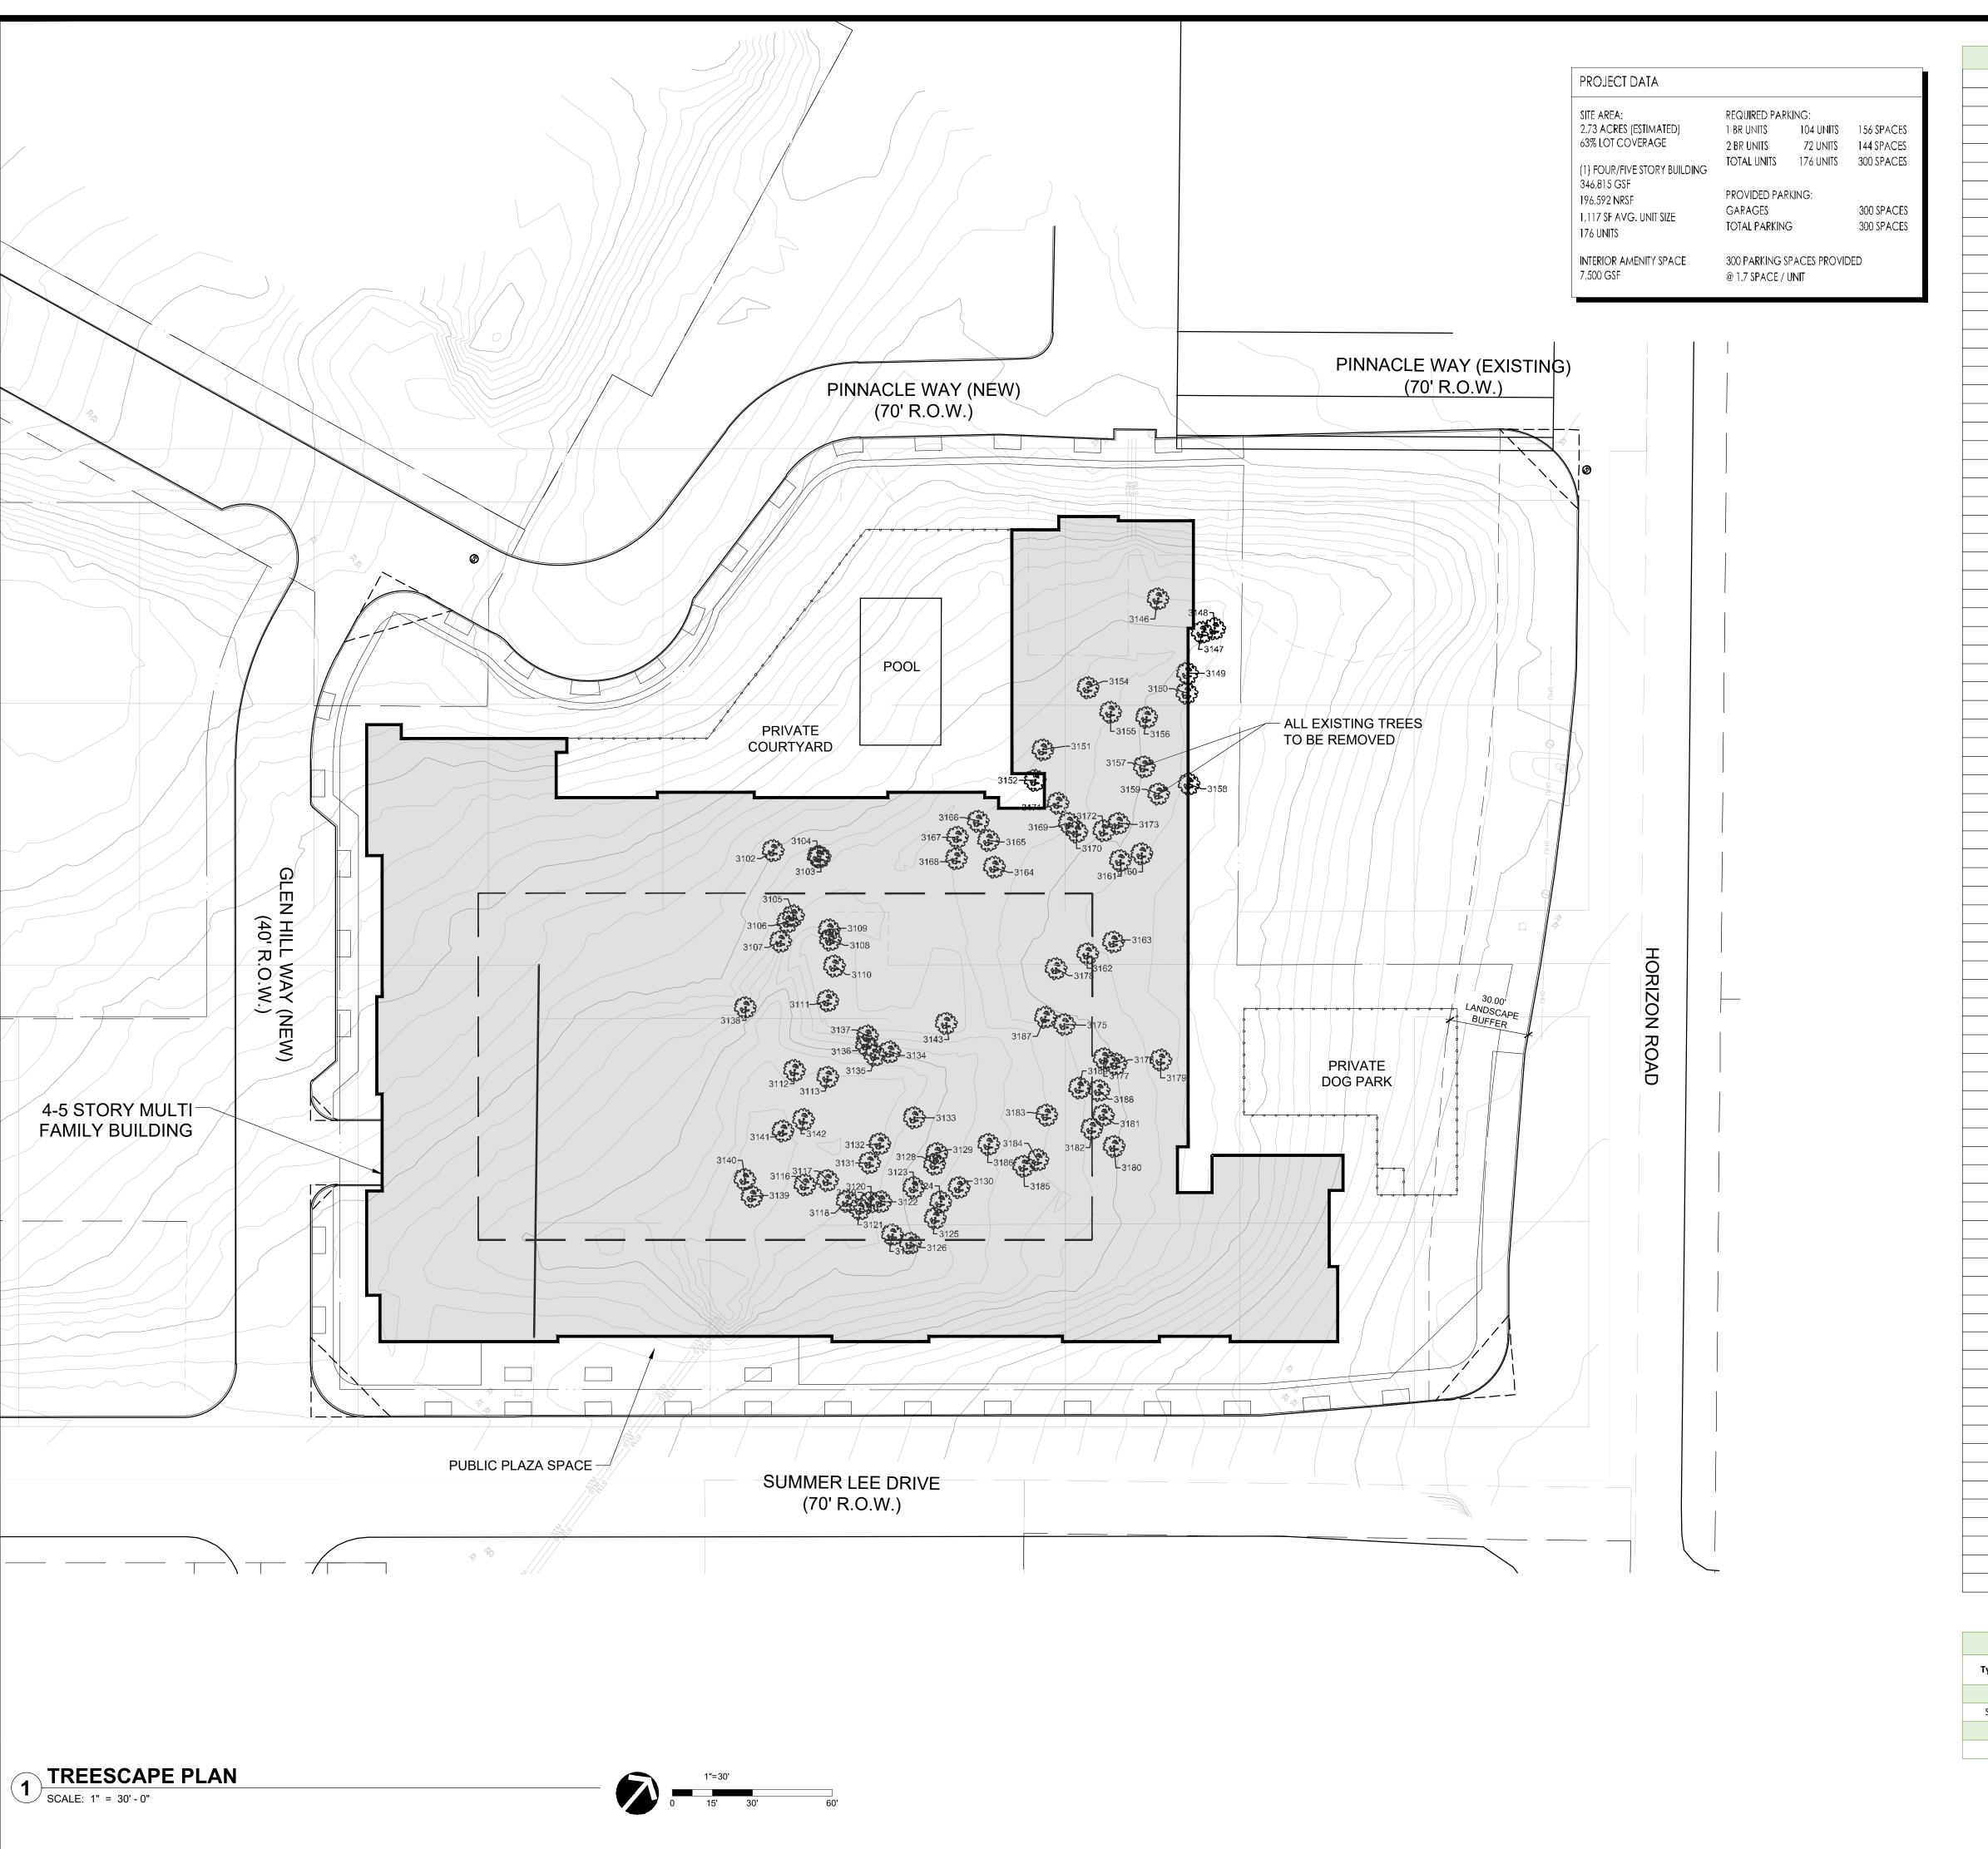

	Exi	sting Tree S	urvev	
Tree #	Family	Size	Status	Classified
3102	Oak	17"	Healthy	Protected
3102	Hackberry	9"	Healthy	Secondary
3104	Hackberry	6"	Healthy	Secondary
3105	Hackberry	11"	Healthy	Secondary
3106	Hackberry	6"	Healthy	Secondary
3107	Oak	14"	Healthy	Protected
3108	Oak	23"	Healthy	Protected
3109	Oak	13"	Healthy	Protected
3111	Oak	10"	Healthy	Protected
3112	Oak	6"	Healthy	Protected
3113	Oak	8"	Healthy	Protected
3116	Oak	9"	Healthy	Protected
3117	Oak	10"	Healthy	Protected
3117	Elm	17"	Healthy	Protected
3119		32"	Healthy	
	Oak	15"	-	Protected
3120	Hackberry		Healthy	Secondary
3121	Elm	12"	Healthy	Protected
3122	Elm	11"	Healthy	Protected
3123	Hackberry	12"	Healthy	Secondary
3124	Oak	15"	Healthy	Protected
3125	Oak	14"	Healthy	Protected
3126	Hackberry	9"	Healthy	Secondary
3127	Hackberry	13"	Healthy	Secondary
3128	Oak	9"	Healthy	Protected
3129	Elm	9"	Healthy	Protected
3130	Oak	17"	Healthy	Protected
3131	Elm	15"	Healthy	Protected
3132	Elm	12"	Healthy	Protected
3133	Oak	23"	Healthy	Protected
3134	Hackberry	13"	Healthy	Secondary
3135	Hackberry	10"	Healthy	Secondary
3136	Hackberry	13"	Healthy	Secondary
3137	Hackberry	12"	Healthy	Secondary
3138	Hackberry	8"	Healthy	Secondary
3139	Oak	12"	Healthy	Protected
3140	Oak	13"	Healthy	Protected
3141	Oak	12"	Healthy	Protected
3142	Hackberry	8"	Healthy	Secondary
3143	Hackberry	14"	Healthy	Secondary
3146	Oak	12"	Healthy	Protected
3147	Pecan	10"	Healthy	
		9"	,	Protected
3148	Elm		Healthy	Protected
3149	Oak	14"	Healthy	Protected
3150	Oak	16"	Healthy	Protected
3151	Oak	8"	Healthy	Protected
3152	Elm	11"	Healthy	Protected
3154	Elm	11"	Healthy	Protected
3155	Hackberry	9"	Healthy	Secondary
3156	Elm	11"	Healthy	Protected
3157	Oak	7"	Healthy	Protected
3158	Oak	17"	Healthy	Protected
3159	Hackberry	14"	Healthy	Secondary
3160	Oak	14"	Healthy	Protected
3161	Oak	15"	Healthy	Protected
3162	Elm	11"	Healthy	Protected
3163	Oak	8"	Healthy	Protected
3164	Elm	9"	Healthy	Protected
3165	Elm	10"	Healthy	Protected
3166	Oak	16"	Healthy	Protected
3167	Oak	13"	Healthy	Protected
3168	Oak	10"	Healthy	Protected
3169	Elm	8"	Healthy	Protected
3170	Hackberry	9"	Healthy	Secondary
3171	Hackberry	9"	Healthy	Secondary
3172	Oak	8"	Healthy	Protected
3173	Hackberry	12"	Healthy	Secondary
3175	Oak	8"	Healthy	Protected
3176	Oak	8"	Healthy	Protected
	Hackberry	9"	Healthy	Secondary
31//		8"	Healthy	Protected
3177 3178	Flm	<u> </u>	Healthy	Protected
3178	Elm Oak	17"	. IS WILLIAM	i i otetteu
3178 3179	Oak	17" 11"	-	Drotostad
3178 3179 3180	Oak Elm	11"	Healthy	Protected
3178 3179 3180 3181	Oak Elm Oak	11" 9"	Healthy Healthy	Protected
3178 3179 3180 3181 3182	Oak Elm Oak Oak	11" 9" 8"	Healthy Healthy Healthy	Protected Protected
3178 3179 3180 3181 3182 3183	Oak Elm Oak Oak Oak	11" 9" 8" 11"	Healthy Healthy Healthy Healthy	Protected Protected Protected
3178 3179 3180 3181 3182 3183 3184	Oak Elm Oak Oak Oak Oak	11" 9" 8" 11" 14"	Healthy Healthy Healthy Healthy Healthy	Protected Protected Protected Protected
3178 3179 3180 3181 3182 3183 3184 3185	Oak Elm Oak Oak Oak Oak Elm	11" 9" 8" 11" 14" 10"	Healthy Healthy Healthy Healthy Healthy Healthy	Protected Protected Protected Protected Protected
3178 3179 3180 3181 3182 3183 3184 3185 3186	Oak Elm Oak Oak Oak Elm Hackberry	11" 9" 8" 11" 14" 10" 8"	Healthy Healthy Healthy Healthy Healthy Healthy Healthy	Protected Protected Protected Protected Protected Secondary
3178 3179 3180 3181 3182 3183 3184 3185 3186 3187	Oak Elm Oak Oak Oak Oak Elm Hackberry	11" 9" 8" 11" 14" 10" 8" 11"	Healthy Healthy Healthy Healthy Healthy Healthy Healthy Healthy	Protected Protected Protected Protected Protected Secondary Protected
3178 3179 3180 3181 3182 3183 3184 3185 3186	Oak Elm Oak Oak Oak Elm Hackberry	11" 9" 8" 11" 14" 10" 8"	Healthy Healthy Healthy Healthy Healthy Healthy Healthy	Protected Protected Protected Protected Protected Secondary

Site Mitigation Requirements					
Type of Tree	Total Inches	Mitigation Requirement	Mitigated Inches		
Primary	673	1" : 1"	673		
Secondary	129	1" : 1/2"	65		
Featured	32	1":2"	64		
Total	802				

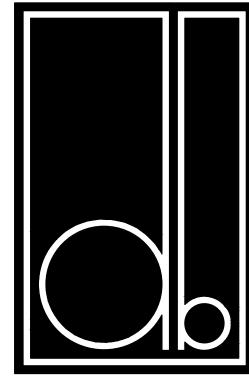

DESIGN BALANCE, INC. 2231 RIDGE ROAD, SUITE 200 ROCKWALL, TEXAS 75087 214.668.2306

ER: RIV PROPERTIES, LLC P.O. BOX 192054 DALLAS, TX 75219

214.908.4684

HARBOR RESIDENCES:

PORTION OF THE MOTON
ADDITION, CITY OF ROCKWALL,
ROCKWALL COUNTY, TEXAS,
SITUATED WITHIN THE HILLSIDE
MIXED USE SUBDISTRICT AND
THE HORIZON/SUMMER LEE
SUBDISTRICT OF PLANNED
DEVELOPMENT DISTRICT 32
(PD-32), GENERALLY LOCATED
AT THE SOUTHWEST CORNER OF
THE INTERSECTION OF HORIZON
ROAD AND SUMMER LEE DRIVE

DATE ISSUED:


06/17/2022

4.1 TREESCAPE PLAN

CASE NUMBER:

SHEET NUMBER AND TITLE:

PLANNING AND ZONING CHAIRMAN SIGNATURE:

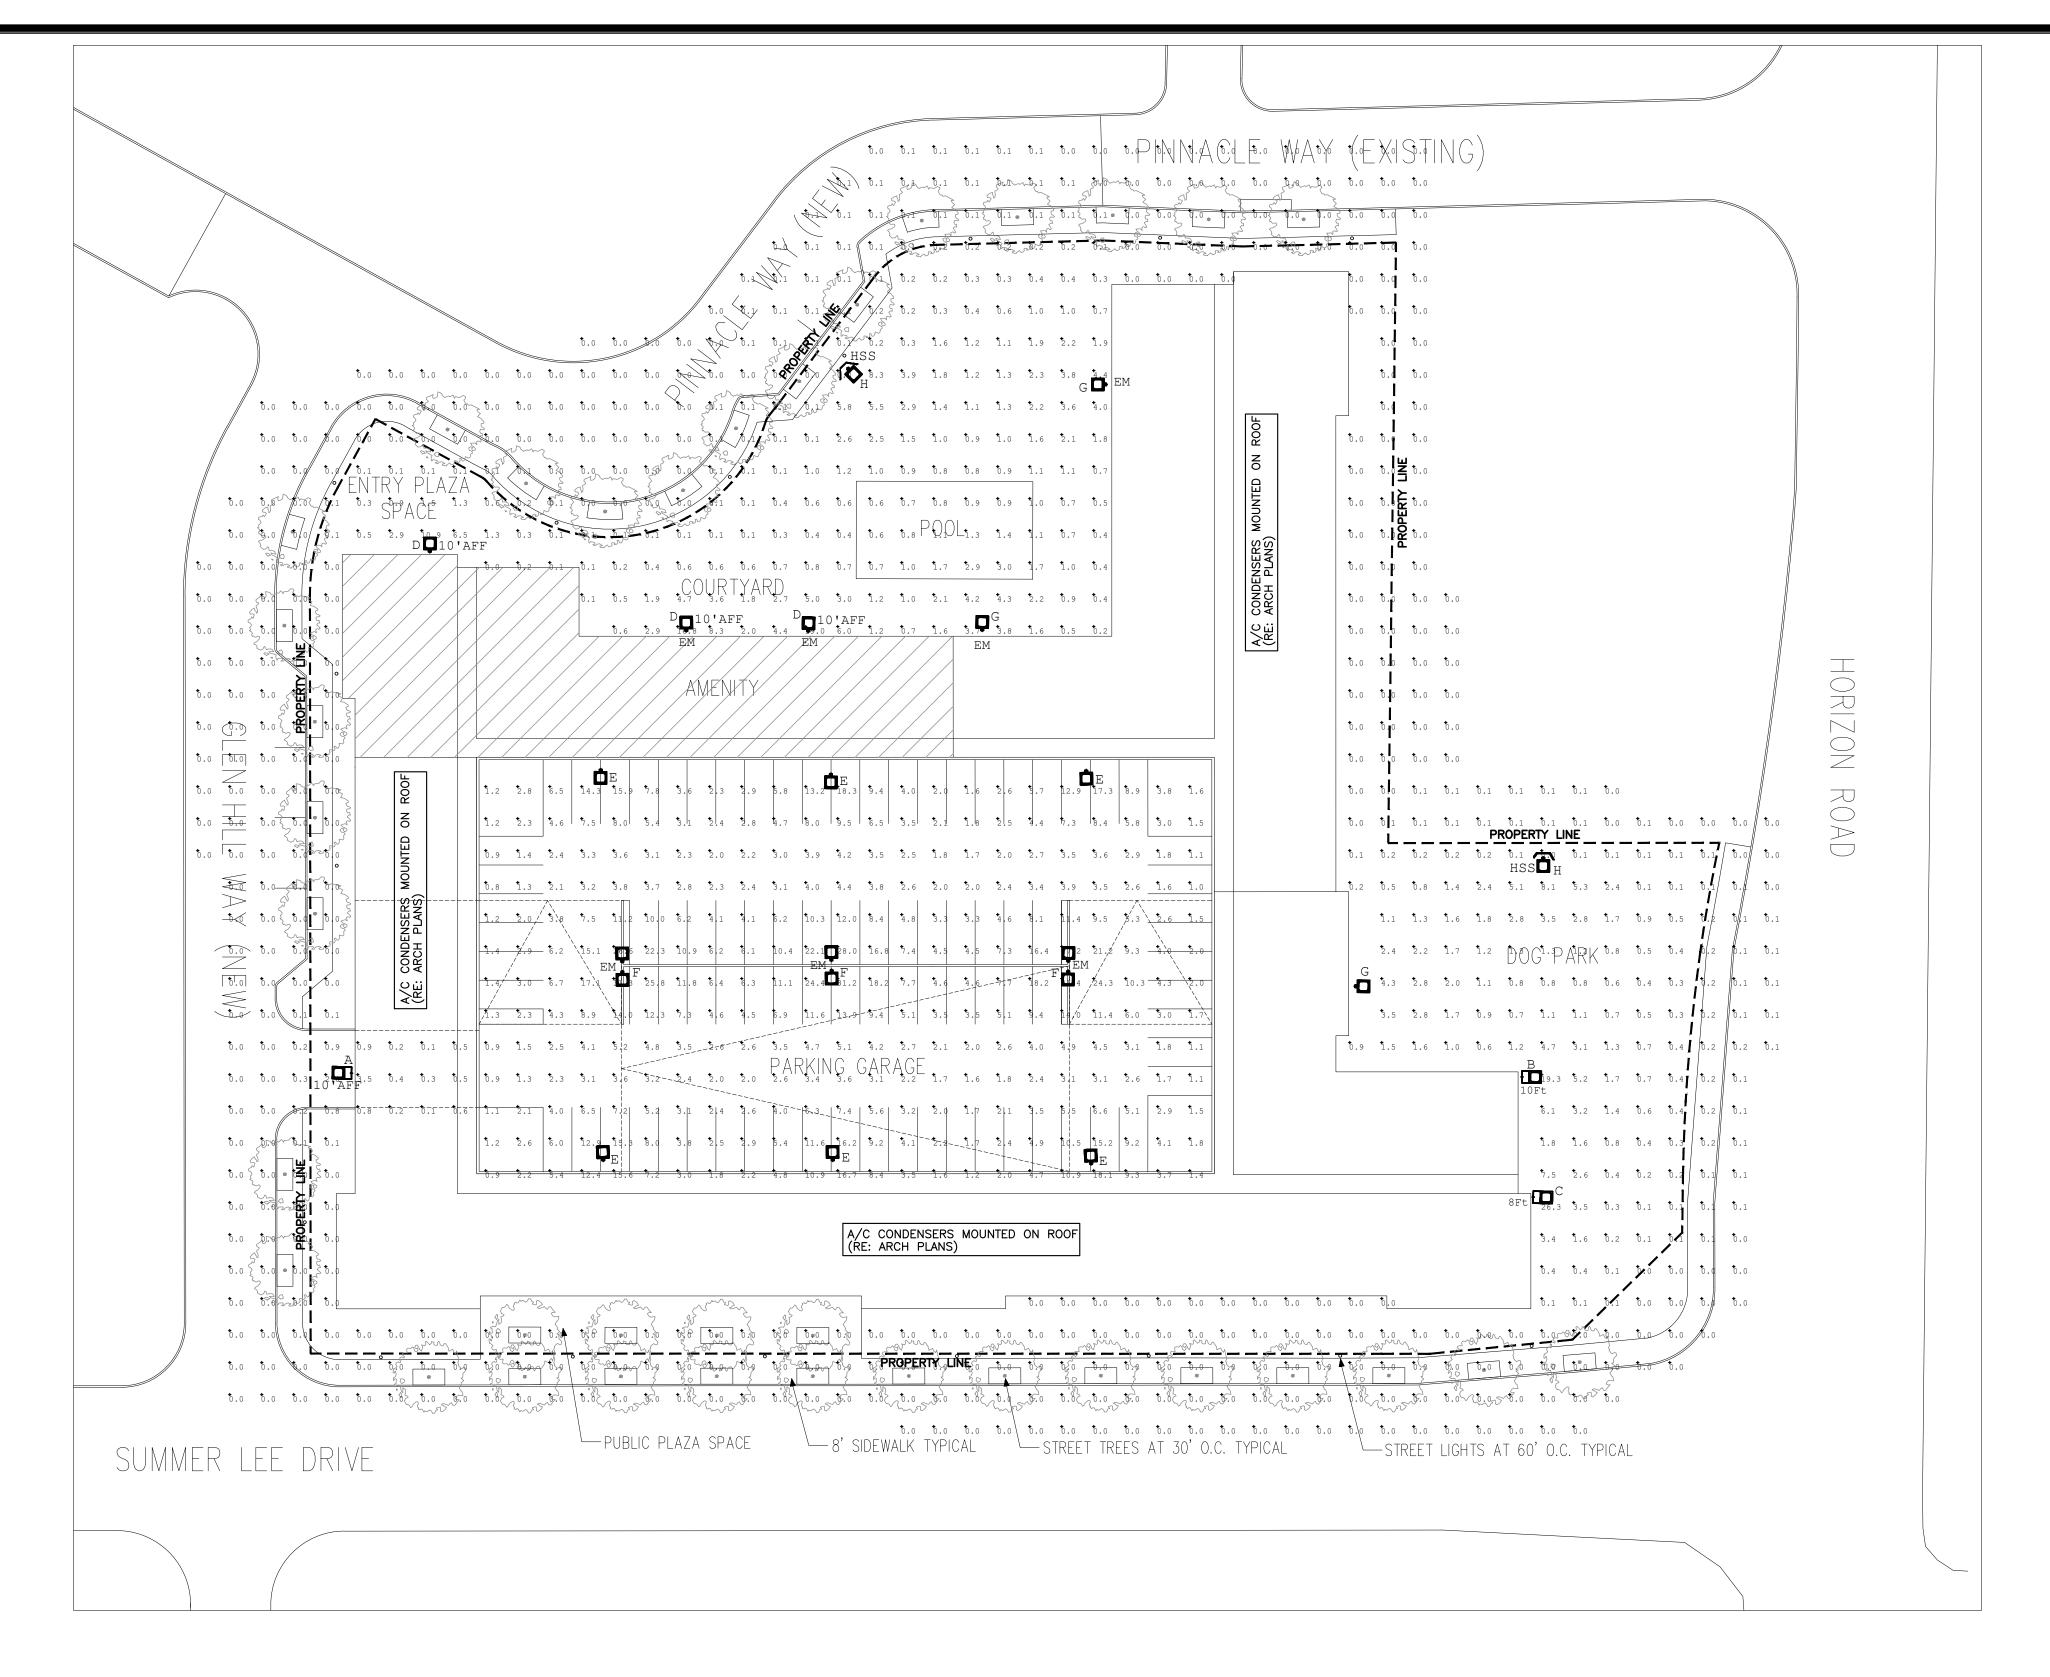

Luminaire Sche	edule							
Symbol	Qty	Label	Arrangement	LLF	Luminaire Lumens	Luminaire Watts	Total Watts	Fixture Height
• A	1	WPCP-LED10	Single	1.000	1150	11.6	11.6	10'
• 10 B	1	MWPCL-LED80-10FT	Single	1.000	8996	87.2	87.2	10'
: C	1	MWPCL-LED50-8FT	Single	0.993	4867	45.3	45.3	8'
D D	3	MWPCL-LED50	Single	0.993	4867	45.3	135.9	10'
- □ E	6	PSLM-LED150-IV	Single	1.000	17972	147.37	884.22	15'
□ ⊸□ F	3	PSLM-LED150-III	Back-Back	1.000	17786	147.41	884.46	15'
₽ G	3	MWPCL-LED80	Single	1.000	8996	87.2	261.6	20'
- □ H	2	PSLS-LED70-IV	Single	1.000	9450	72.3	144.6	15'

HSS - HOUSE SIDE SHIELD EM - 90 MINUTE INVERTER BACKUP


PHOTOMETRIC STUDY

SITE PLAN



8100 WASHINGTON AVE, SUITE 250 HOUSTON, TX. 77007 PHONE: 713-552-1777 TOMMY@SDC-MEP.COM TEXAS ENGINEERING FIRM #21385

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DESIGN BALANCE, INC. 2231 RIDGE ROAD, STE 200 ROCKWALL, TEXAS 75087 214.668.2306

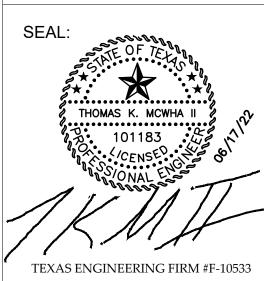OWNER:

RIV PROPERTIES, LLC P.O. BOX 192054 DALLAS, TX 75219 214.908.4684

HARBOR RESIDENCES:

PORTION OF THE MOTON
ADDITION, CITY OF ROCKWALL,
ROCKWALL COUNTY, TEXAS,
SITUATED WITHIN THE HILLSIDE
MIXED USE SUBDISTRICT AND
THE HORIZON/SUMMER LEE
SUBDISTRICT OF PLANNED
DEVELOPMENT DISTRICT 32
(PD-32), GENERALLY LOCATED
AT THE SOUTHWEST CORNER OF
THE INTERSECTION OF HORIZON
ROAD AND SUMMER LEE DRIVE


DATE ISSUED:

06/17/2022

5.1a
PHOTOMETRIC &
LIGHTING PLAN

CASE NUMBER:

PLANNING AND ZONING CHAIRMAN SIGNATURE:

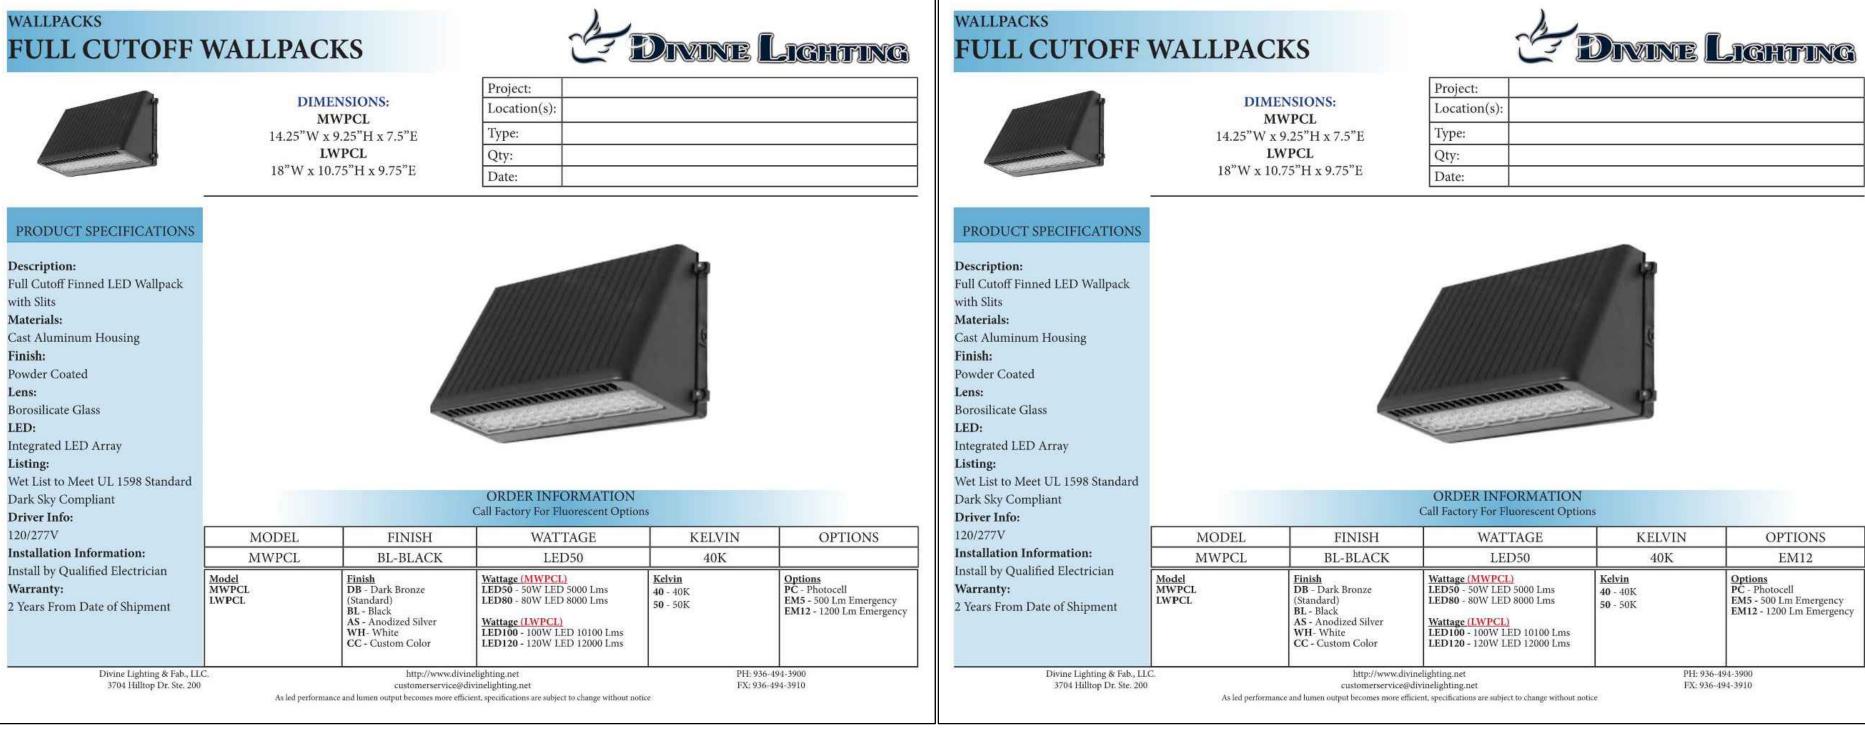

WALLPACKS

Description:

with Slits

Materials:

Powder Coated

Borosilicate Glass

Integrated LED Array

Dark Sky Compliant

Installation Information:

Install by Qualified Electrician

2 Years From Date of Shipment

Divine Lighting & Fab., LLC. 3704 Hilltop Dr. Ste. 200

Driver Info:

120/277V

Warranty:

Wet List to Meet UL 1598 Standard

Finish:

Lens:

LED:

Listing:

PRODUCT SPECIFICATIONS

Full Cutoff Finned LED Wallpack

Cast Aluminum Housing

FULL CUTOFF WALLPACKS

DIMENSIONS:

MWPCL

14.25"W x 9.25"H x 7.5"E

LWPCL

18"W x 10.75"H x 9.75"E

MODEL

MWPCL

FINISH

BL-BLACK

http://www.divinelighting.net customerservice@divinelighting.net

As led performance and lumen output becomes more efficient, specifications are subject to change without notice

Finish DB - Dark Bronze

BL - Black AS - Anodized Silver

CC - Custom Color

Location(s)

ORDER INFORMATION

Call Factory For Fluorescent Options

WATTAGE

LED80

Wattage (MWPCL) LED50 - 50W LED 5000 Lms

LED80 - 80W LED 8000 Lms

Wattage (LWPCL) LED100 - 100W LED 10100 Lms

LED120 - 120W LED 12000 Lms

KELVIN

50 - 50K

40K

FX: 936-494-3910

Type:

Date:

C DIVINE LIGHTING

KELVIN

40K

FX: 936-494-3910

OPTIONS

Options
PC - Photocell
EM5 - 500 Lm Emergency

EM12 - 1200 Lm Emergeno

WALLPACKS

PRODUCT SPECIFICATION:

Full Cutoff Finned LED Wallpack

Cast Aluminum Housing

with Slits

Materials:

LED:

Listing:

Driver Info:

120/277V

Warranty:

Powder Coated

Borosilicate Glass

Integrated LED Array

Dark Sky Compliant

Installation Information:

Install by Qualified Electrician

2 Years From Date of Shipment

Divine Lighting & Fab., LLC. 3704 Hilltop Dr. Ste. 200

Wet List to Meet UL 1598 Standard

FULL CUTOFF WALLPACKS

DIMENSIONS:

MWPCL

14.25"W x 9.25"H x 7.5"E

LWPCL

18"W x 10.75"H x 9.75"E

MODEL

MWPCL

Model MWPCL

FINISH

BL-BLACK

http://www.divinelighting.net customerservice@divinelighting.net

As led performance and lumen output becomes more efficient, specifications are subject to change without notice

Finish DB - Dark Bronze

(Standard)
BL - Black
AS - Anodized Silver

CC - Custom Color

Location(s):

ORDER INFORMATION

Call Factory For Fluorescent Options

WATTAGE

LED80

LED80 - 80W LED 8000 Lms


Wattage (LWPCL) LED100 - 100W LED 10100 Lms

LED120 - 120W LED 12000 Lms

Date:



LIGHTING SPECIFICATIONS

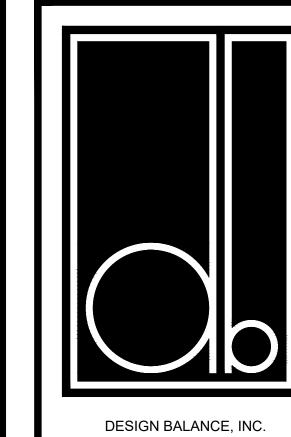

Engineers, LLC MEP CONSULTANTS

8100 WASHINGTON AVE, SUITE 250 HOUSTON, TX. 77007 PHONE: 713-552-1777 TOMMY@SDC-MEP.COM TEXAS ENGINEERING FIRM #21385

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THOMAS K. MCWHA II

TEXAS ENGINEERING FIRM #F-10533

SEAL:

2231 RIDGE ROAD, STE 200 ROCKWALL, TEXAS 75087 214.668.2306

OWNER:

RIV PROPERTIES, LLC P.O. BOX 192054 DALLAS, TX 75219 214.908.4684

HARBOR RESIDENCES:

PORTION OF THE MOTON ADDITION, CITY OF ROCKWALL ROCKWALL COUNTY, TEXAS, SITUATED WITHIN THE HILLSIDE MIXED USE SUBDISTRICT AND THE HORIZON/SUMMER LEE SUBDISTRICT OF PLANNED **DEVELOPMENT DISTRICT 32** (PD-32), GENERALLY LOCATED AT THE SOUTHWEST CORNER OF THE INTERSECTION OF HORIZON ROAD AND SUMMER LEE DRIVE

DATE ISSUED:

06/17/2022

SHEET NUMBER AND TITLE: 5.1b PHOTOMETRIC & LIGHTING PLAN

CASE NUMBER:

PLANNING AND ZONING CHAIRMAN SIGNATURE:



EDIMINE LIGHTING

SITE LIGHTING

PSLS / PSLL

PRODUCT SPECIFICATION:

Flat Top Site Light with Low to High

Heat-Resistant Clear Polycarbonate

Wet List to Meet UL1598 Standard

MODEL

PSLS

Die Cast Aluminum Housing

Output

LED:

Listing:

IP65 Rated

Driver Info:

120/277V

Materials:

Powder Coated

Integrated LED Array

Installation Information:

Install by Qualified Electrician

2 Years From Date of Shipment

Divine Lighting & Mfg., LLC

DIMENSIONS:

PSLS 3.5"H x 13"W x 17.5"E (No Arm)

5.6"W x 13"W x 25.2"E (Staright Arm)

PSLL 3.5"H x 13"W x 21.1"E (No Arm)

5.6"W x 13"W x 28.8"E (Staright Arm)

FINISH

BL-BLACK

Finish DB - Dark Bronze

BL - Black AS - Anodized Silver WH- White

CC - Custom Color

Location(s):

Call Factory For Fluorescent Options

KELVIN TYPE

IV

| Type | III - Type III | PC - Photocell | MOT - Motion | DIMO-10 - 0-10V | TRUN - Trunnio

40K

OPTIONS

DIM0-10 - 0-10V Dimmable TRUN - Trunnion Mount

MA - Mouting Arm SF - Slip Fitter EM5 - Emergency Backup500 Lms

EM12 - Emergency Backup 1200Lms

LSF - Large Slip Fitter

FX: 936-494-3910

WATTAGE

150LED


Wattage (PSLL) LED220 - 220W LED 30200-31000 lms LED310 - 310W LED 36800-38400 lms

customerservice@divinelighting.net

As led performance and lumen output becomes more efficient, specifications are subject to change without notice

| Wattage (PSLS) | LED70 - 70W LED 9300-10000 lms | LED100 - 100W LED 12300-13500 lms | LED150 - 150W LED 17700-18500 lms | LED180 - 180W LED 20600-12500 lms | LED180 - 180W LED 20600-12500 lms

Qty:

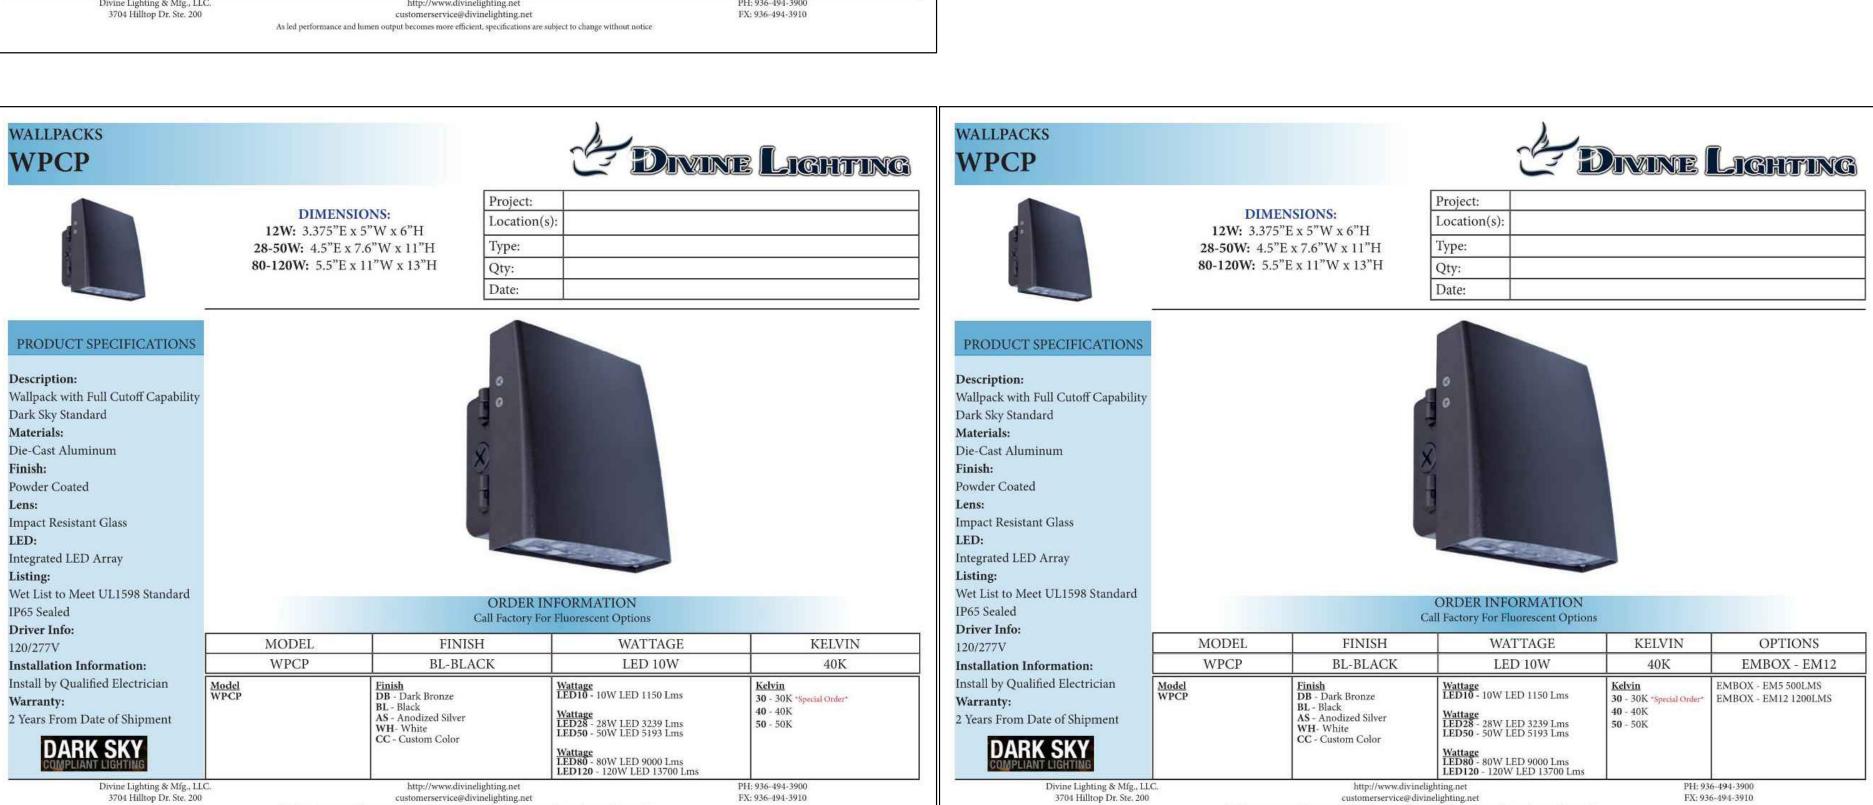

FX: 936-494-3910

customerservice@divinelighting.net


As led performance and lumen output becomes more efficient, specifications are subject to change without notice

LIGHTING SPECIFICATIONS (CONTINUED)

FX: 936-494-3910

customerservice@divinelighting.net

As led performance and lumen output becomes more efficient, specifications are subject to change without notice

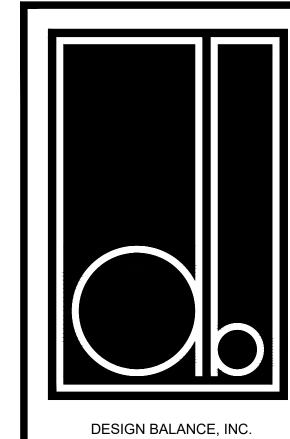

Engineers, LLC MEP CONSULTANTS

8100 WASHINGTON AVE, SUITE 250 HOUSTON, TX. 77007 PHONE: 713-552-1777 TOMMY@SDC-MEP.COM TEXAS ENGINEERING FIRM #21385

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THOMAS K. MCWHA II

TEXAS ENGINEERING FIRM #F-10533

SEAL:

2231 RIDGE ROAD, STE 200 ROCKWALL, TEXAS 75087 214.668.2306

OWNER:

RIV PROPERTIES, LLC P.O. BOX 192054 DALLAS, TX 75219 214.908.4684

HARBOR RESIDENCES:

PORTION OF THE MOTON ADDITION, CITY OF ROCKWALL ROCKWALL COUNTY, TEXAS, SITUATED WITHIN THE HILLSIDE MIXED USE SUBDISTRICT AND THE HORIZON/SUMMER LEE SUBDISTRICT OF PLANNED **DEVELOPMENT DISTRICT 32** (PD-32), GENERALLY LOCATED AT THE SOUTHWEST CORNER OF THE INTERSECTION OF HORIZON ROAD AND SUMMER LEE DRIVE

DATE ISSUED:

06/17/2022

SHEET NUMBER AND TITLE: 5.1c PHOTOMETRIC & LIGHTING PLAN

CASE NUMBER:

PLANNING AND ZONING CHAIRMAN SIGNATURE:



DEVELOPMENT APPLICATION

City of Rockwall
Planning and Zoning Department
385 S. Goliad Street
Rockwall, Texas 75087

TAFF	USE	ONLY	-

PLANNING & ZONING CASE NO.


SP2027-035

NOTE: THE APPLICATION IS NOT CONSIDERED ACCEPTED BY THE CITY UNTIL THE PLANNING DIRECTOR AND CITY ENGINEER HAVE SIGNED BELOW.

DIRECTOR OF PLANNING:

CITY ENGINEER:

					-
PLEASE CHECK THE AI	PPROPRIATE BOX BELOW TO INI	DICATE THE TYPE OF	DEVELOPMENT REQ	UEST [SELECT ONLY ONE BOX]:	
☐ PRELIMINARY PL ☐ FINAL PLAT (\$300.00 ☐ REPLAT (\$300.00 ☐ AMENDING OR M ☐ PLAT REINSTATE SITE PLAN APPLICA ☑ SITE PLAN (\$250	100.00 + \$15.00 ACRE) 1 LAT (\$200.00 + \$15.00 ACRE) 1 0.00 + \$20.00 ACRE) 1 0 + \$20.00 ACRE) 1 MINOR PLAT (\$150.00) EMENT REQUEST (\$100.00)	G PLAN (\$100.00)	☐ SPECIFIC USI ☐ PD DEVELOP OTHER APPLICA ☐ TREE REMOV ☐ VARIANCE RE NOTES: □ IN DETERMINING TH PER ACRE AMOUNT. F □ A \$1,000.00 FEE W	NGE (\$200.00 + \$15.00 ACRE) 1 E PERMIT (\$200.00 + \$15.00 ACRE) 1 & 2 MENT PLANS (\$200.00 + \$15.00 ACRE) 1 ITION FEES:	I) ACRE. ST THAT
PROPERTY INFO	RMATION [PLEASE PRINT]				
ADDRESS	Moton Addition, City of Roc	kwall, Rockwall Cou	nty, Texas, situate	d within the Hillside Mixed Use Subdistrict	and
SUBDIVISION				rict 32 (PD-32), generally located at the	
GENERAL LOCATION	southwest corner of the inte	ersection of Horizon i	Koad and Summer	Lee Drive.	
ZONING, SITE PLA	AN AND PLATTING INFO	RMATION (PLEASE)	PRINT		
CURRENT ZONING	PD-32		CURRENT USE	Undeveloped	
PROPOSED ZONING	PD-32		PROPOSED USE	Condominium	
ACREAGE	3.59 Acres	LOTS [CURRENT]	N/A	LOTS [PROPOSED] N/A	
REGARD TO ITS AF RESULT IN THE DEI	PPROVAL PROCESS, AND FAILURE T NIAL OF YOUR CASE.	TO ADDRESS ANY OF ST	AFF'S COMMENTS BY	GE OF <u>HB3167</u> THE CITY NO LONGER HAS FLEXI THE DATE PROVIDED ON THE DEVELOPMENT CALL "ACT/ORIGINAL SIGNATURES ARE REQUIRED]	BILITY WI ENDAR W
	RIV Properties LLC		☑ APPLICANT	RIV Properties LLC	
CONTACT PERSON	Asher Hamilton	c	ONTACT PERSON	Asher Hamilton	
ADDRESS	PO Box 192054		ADDRESS	PO Box 192054	
CITY, STATE & ZIP	Dallas, Texas 75219		CITY, STATE & ZIP	Dallas, TX 75219	
PHONE	(214) 908-4684		PHONE	(214) 908-4684	
E-MAIL	ahamilton@realtyinvestments.c	com	E-MAIL	ahamilton@realtyinvestments.com	
TATED THE INFORMATION	IGNED AUTHORITY. ON THIS DAY PE I ON THIS APPLICATION TO BE TRUI	E AND CERTIFIED THE FO		[AGEN7] THE UNDERSIG	
321.80 TO COVER THE FORMATION CONTAINED	HE COST OF THIS APPLICATION HAS B	BEEN PAID TO THE CITY OF S APPLICATION, I AGREE PUBLIC. THE CITY IS A	FROCKWALL ON THIS TI THAT THE CITY OF RO LSO AUTHORIZED AND	CKWALL (I.E. "CITY") IS AUTHORIZED AND PERMITTED PERMITTED TO A REQUEST FOR EURISE CINFORMATIRIE A BLAKE	TO PROV
IVEN UNDER MY HAND AN	D SEAL OF OFFICE ON THIS THE	DAY OF JUNE	20 <u>7</u> 2	Notary ID #1334512 My Commission Exp November 16, 202	ires
	AGENTS SIGNATURE				
OTARY PUBLIC IN AND FO	R THE STATE OF TEXAS	i 22		MY COMMISSION EXPIRES 11/16	1909

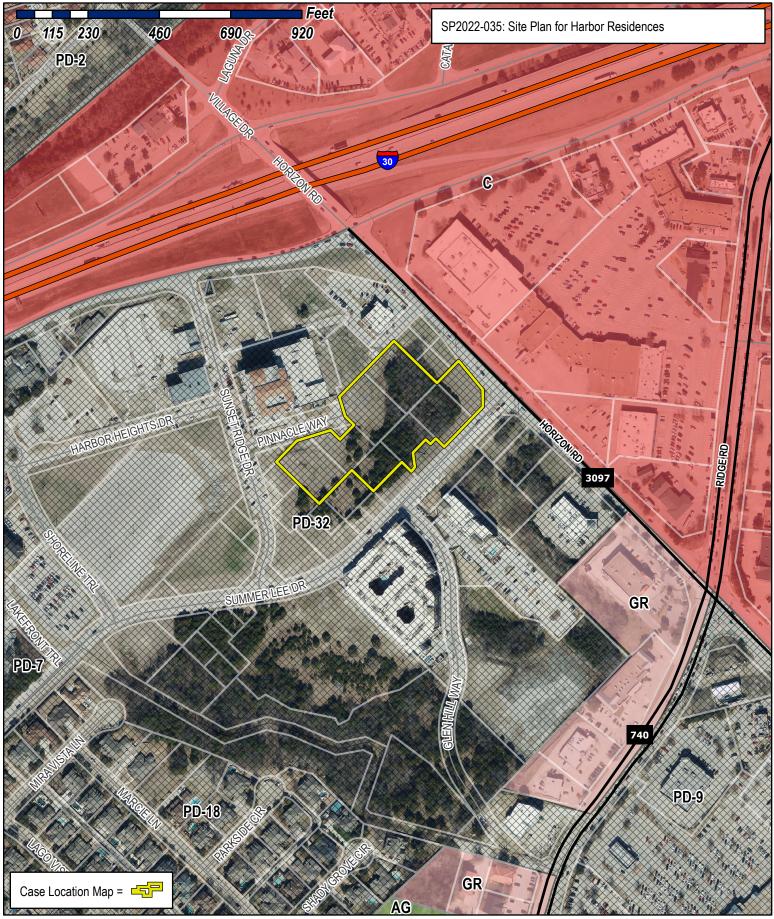






City of Rockwall Planning & Zoning Department 385 S. Goliad Street

Planning & Zoning Department 385 S. Goliad Street Rockwall, Texas 75032 (P): (972) 771-7745 (W): www.rockwall.com The City of Rockwall GIS maps are continually under development and therefore subject to change without notice. While we endeavor to provide timely and accurate information, we make no guarantees. The City of Rockwall makes no warranty, express or implied, including warranties of merchantability and fitness for a particular purpose. Use of the information is the sole responsibility of the user.



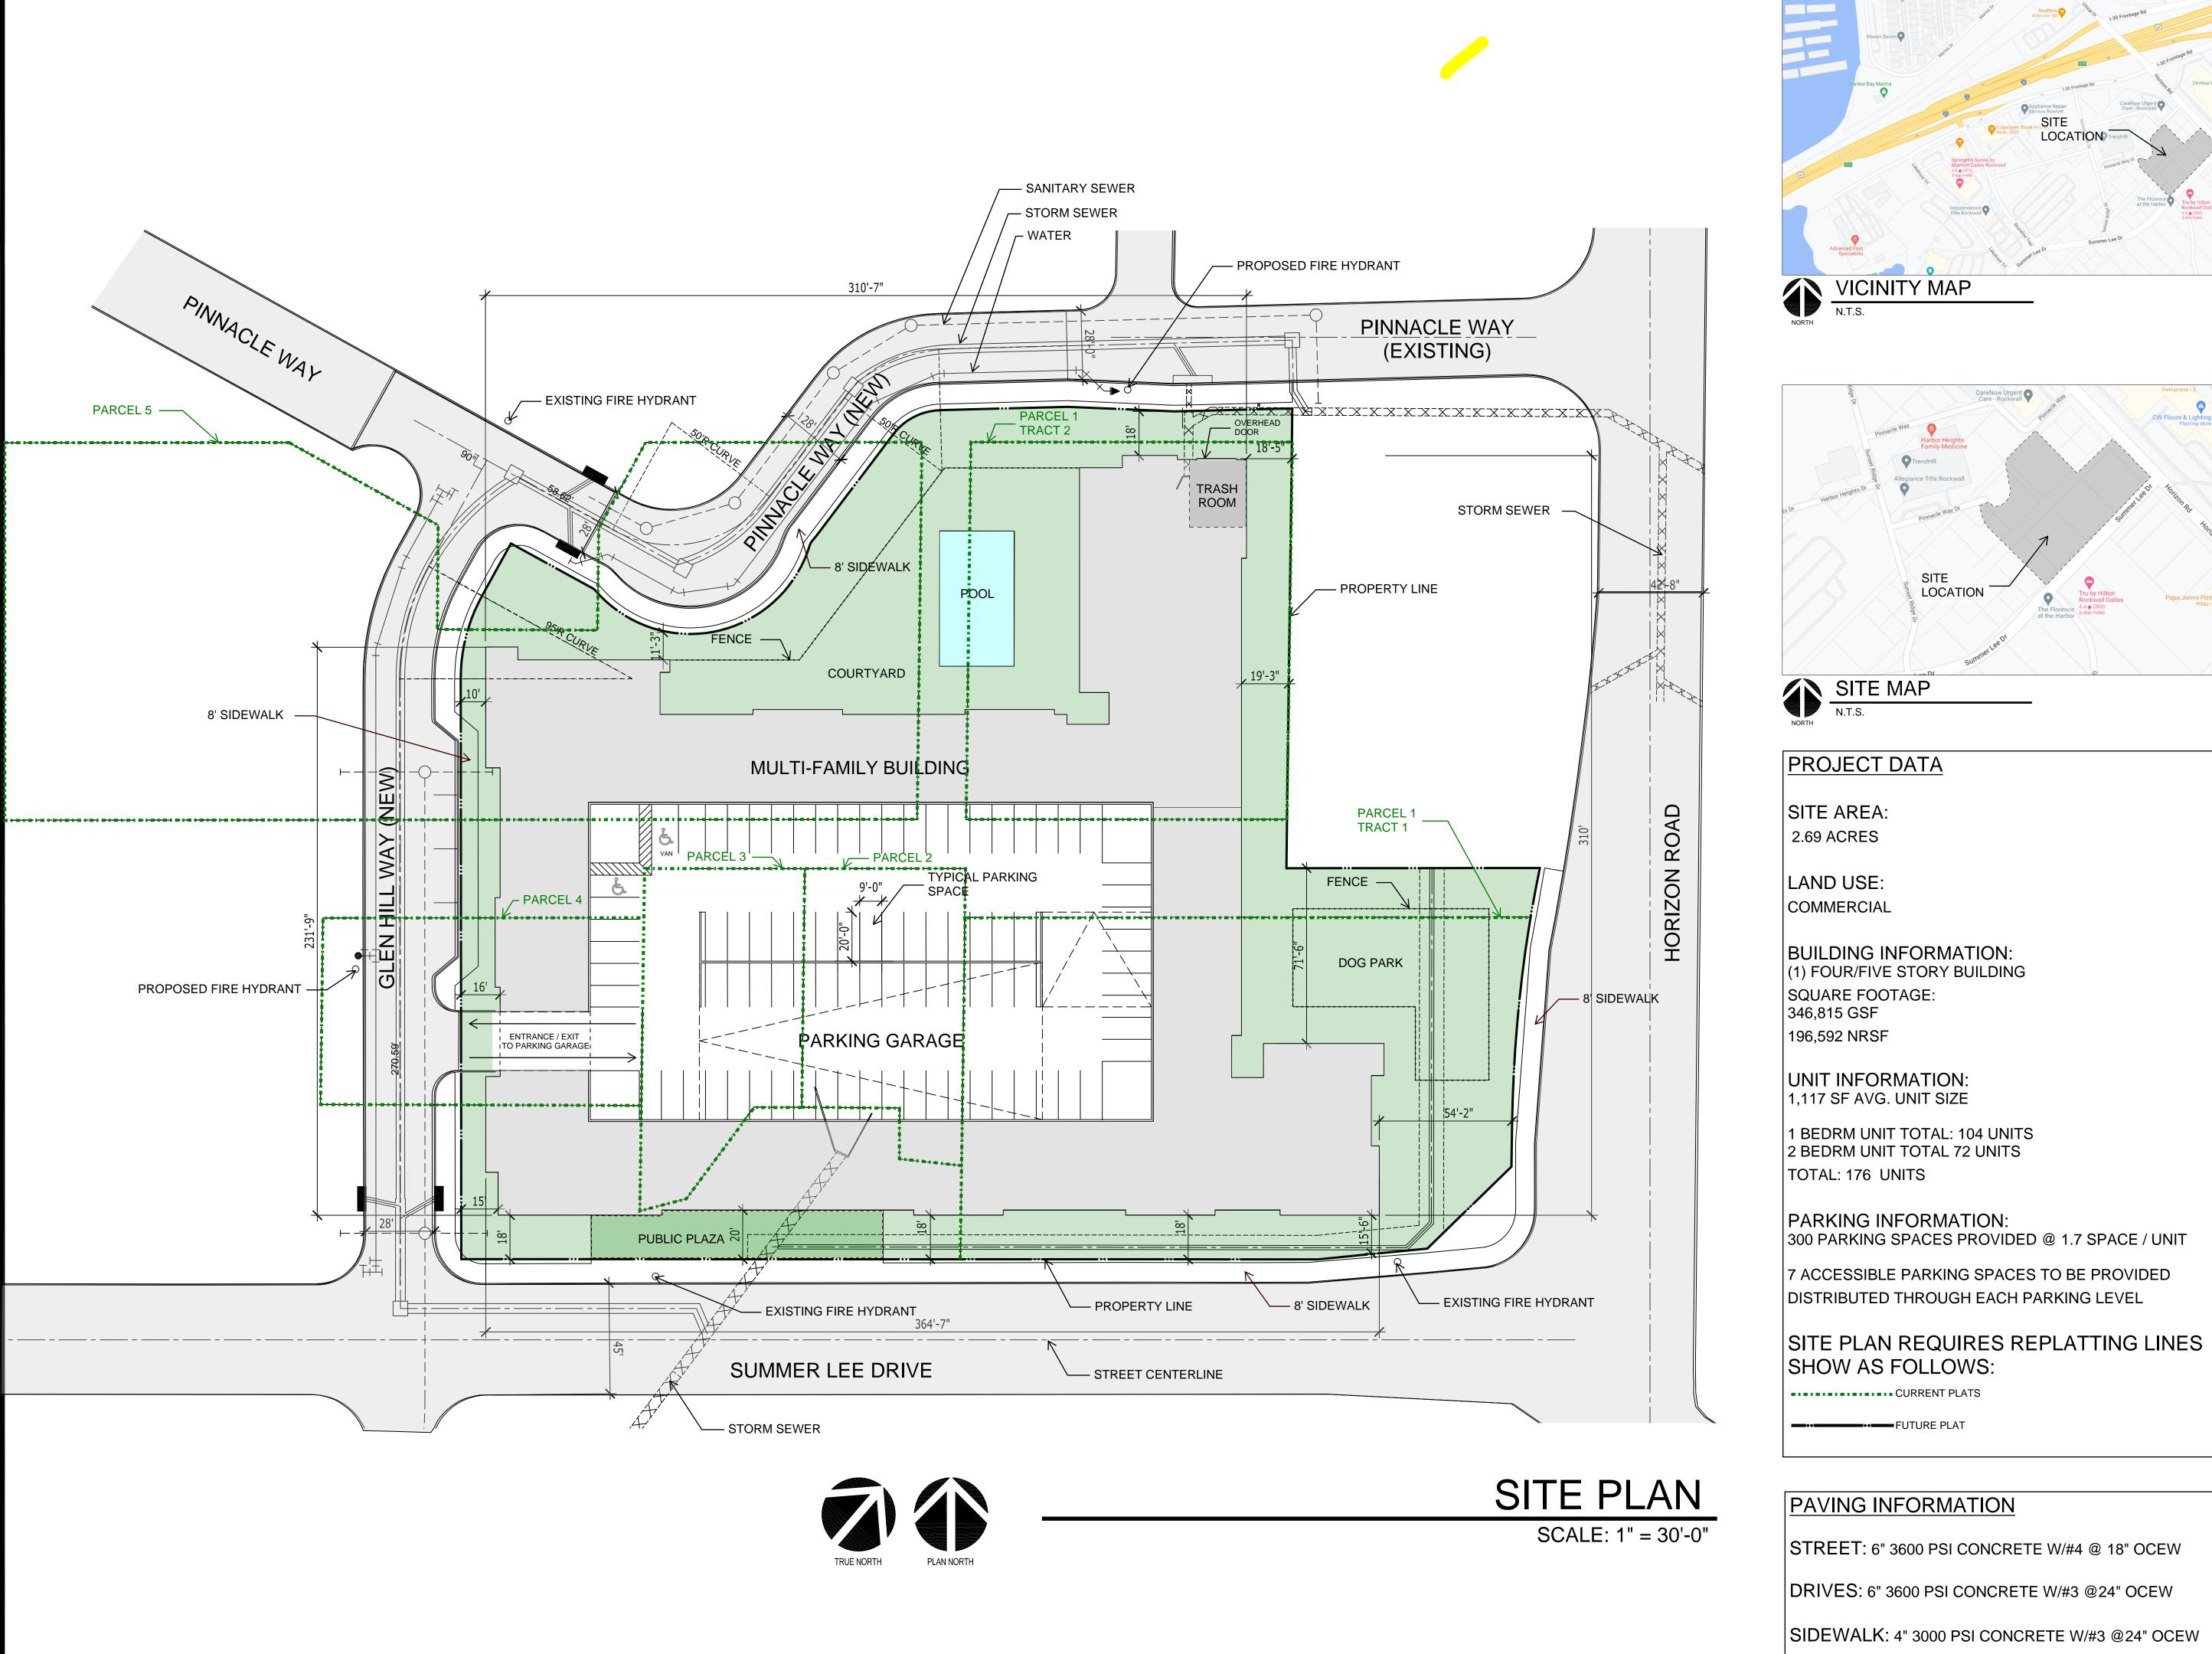

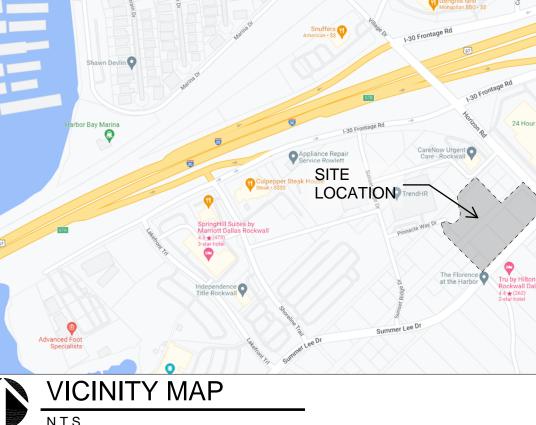

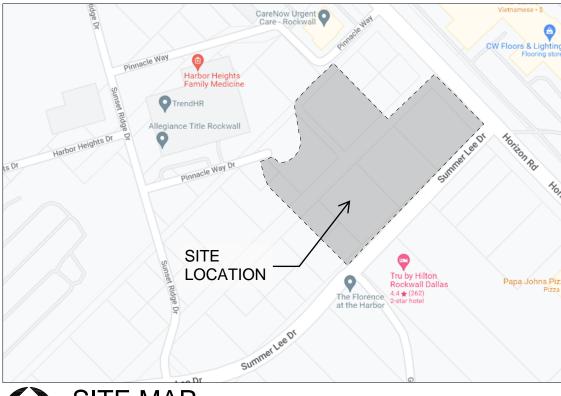

DESIGN BALANCE, INC. 2231 RIDGE ROAD, SUITE 200 ROCKWALL, TEXAS 75087 214.668.2306

RIV PROPERTIES, LLC P.O. BOX 192054 DALLAS, TX 75219 214.908.4684

HARBOR RESIDENCES:

PORTION OF THE MOTON ADDITION, CITY OF ROCKWALL ROCKWALL COUNTY, TEXAS,
SITUATED WITHIN THE HILLSIDE
MIXED USE SUBDISTRICT AND THE HORIZON/SUMMER LEE SUBDISTRICT OF PLANNED DEVELOPMENT DISTRICT 32 (PD-32), GENERALLY LOCATED AT THE SOUTHWEST CORNER OF THE INTERSECTION OF HORIZON ROAD AND SUMMER LEE DRIVE

DATE ISSUED:

06/17/2022

SHEET NUMBER AND TITLE: 2.1 SITE PLAN

CASE NUMBER:

PLANNING AND ZONING CHAIRMAN SIGNATURE:



Surface Area: 17,647 SF

Material Percentages
Brick: 32%
Stucco: 68%

O1 EAST ELEVATION
Scale: 1" = 30'-0"



Surface Area: 21,154 SF

Material Percentages
Brick: 34%
Stucco: 66%

O2 SOUTH ELEVATION

Scale: 1" = 30'-0"



Mechanical equipment to b

ROOFTOP EQUIPMENT:

Mechanical equipment to be on the rooftop. This will either be hidden by the parapets or screened

PROPOSED BUILDING MATERIAL:

Brick:

ACME Brick; Marble Grey ACME Brick; Ridgemar

Stucco Colors

tucco Colors
Sherwin Williams; SW 9165; Gossamer Veil
Sherwin Williams: SW 7066; Gray Matters

Sherwin Williams; SW 7066; Gray Matters
Sherwin Williams; SW 7069; Iron Ore

Roof Materials
BORAL Concrete Roof Tile; Saxony Country Slate; Charcoal Blend
Thermoplastic Polyolefin

Precast Stone Coronado Stone; Lompoc

03 WEST ELEVATION


Scale: 1" = 30'-0"



Surface Area: 14,488 SF

Material Percentages
Brick: 30%
Stucco: 70%

NORTH ELEVATION
Scale: 1" = 30'-0"

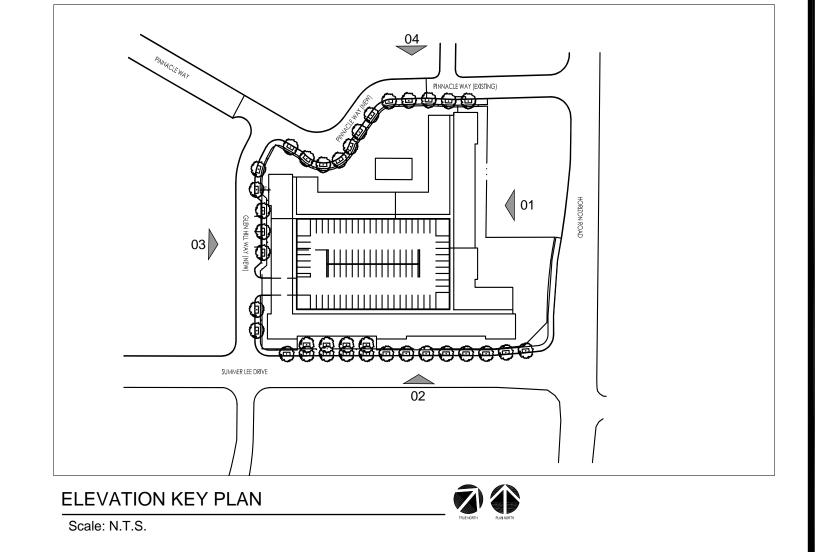

DESIGN BALANCE, INC. 2231 RIDGE ROAD, SUITE 200 ROCKWALL, TEXAS 75087 214.668.2306

WNER:

P.O. BOX 192054 DALLAS, TX 75219 214.908.4684

HARBOR RESIDENCES:

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ADDITION, CITY OF ROCKWALL,
ROCKWALL COUNTY, TEXAS,
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DEVELOPMENT DISTRICT 32
(PD-32), GENERALLY LOCATED
AT THE SOUTHWEST CORNER OF
THE INTERSECTION OF HORIZON
ROAD AND SUMMER LEE DRIVE

DATE ISSUED:


06/17/2022


SHEET NUMBER AND TITLE:

6.1 BUILDING
ELEVATIONS

CASE NUMBER:

PLANNING AND ZONING CHAIRMAN SIGNATURE:

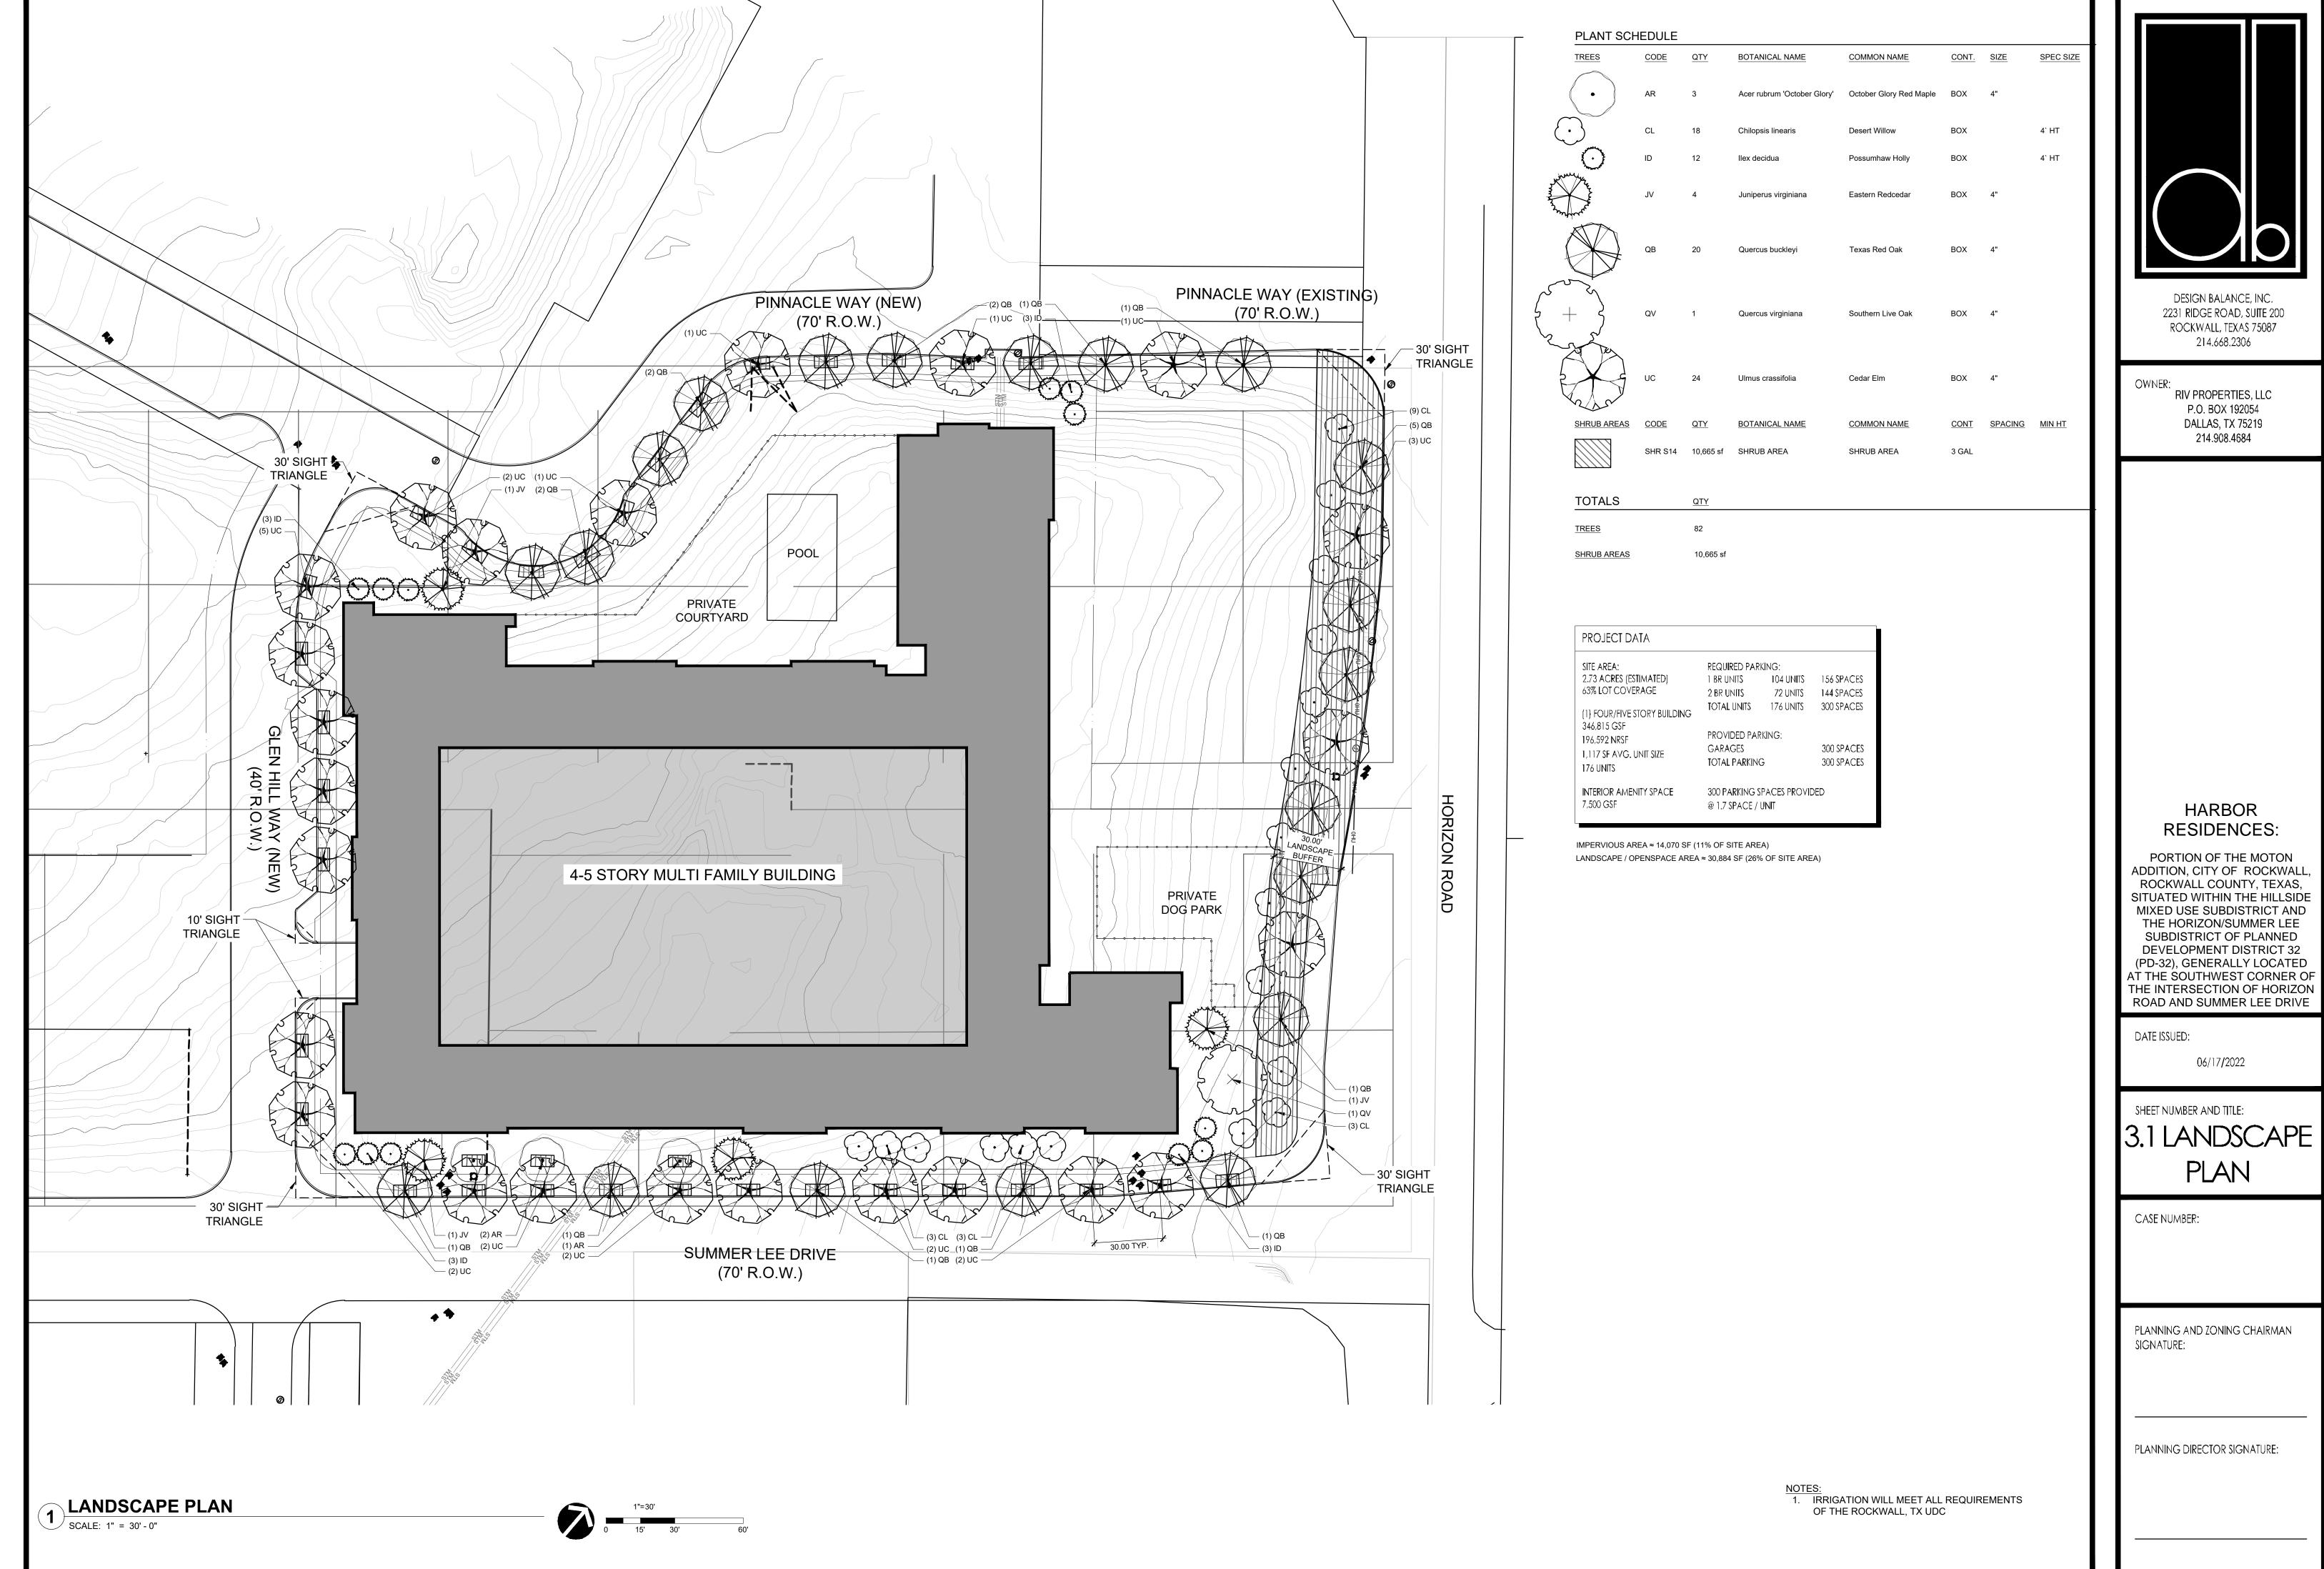

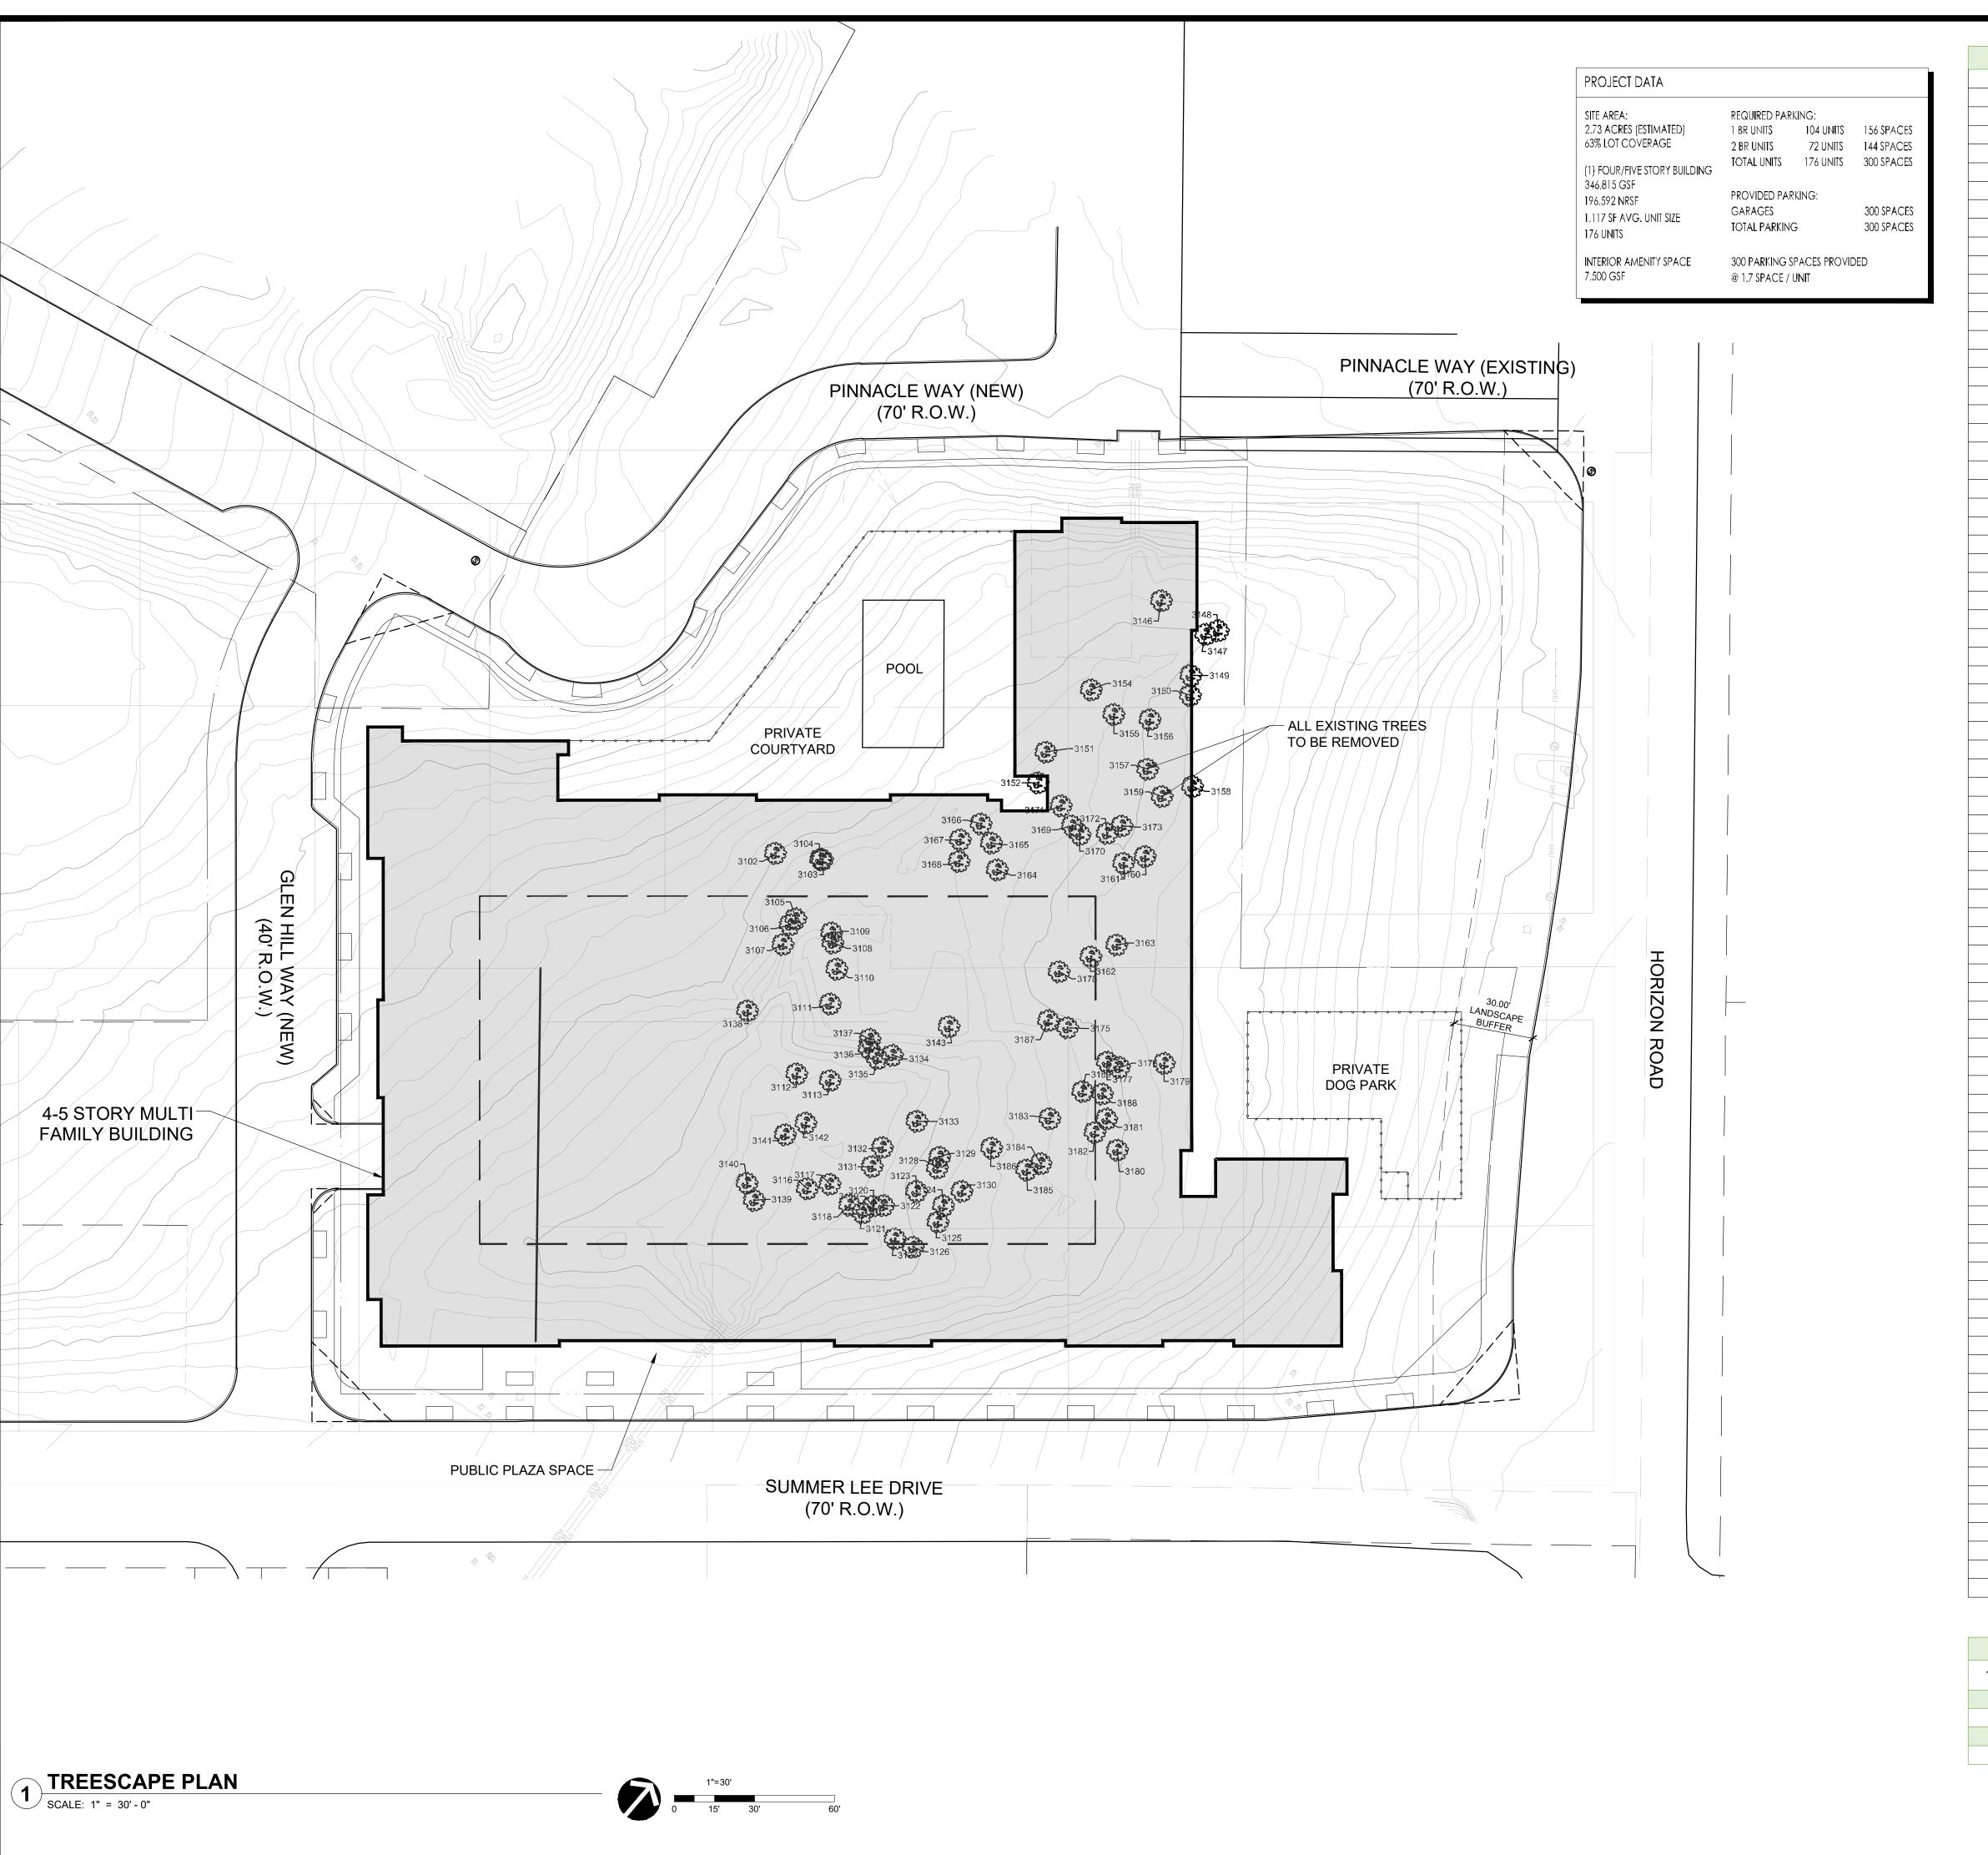

	Exis	ting Tree S	Survey	
Tree #	Family	Size	Status	Classified
3102	Oak	17"	Healthy	Protected
3103	Hackberry	9"	Healthy	Secondary
3104	Hackberry	6"	Healthy	Secondary
3105	Hackberry	11"	Healthy	Secondary
3106	Hackberry	6"	Healthy	Secondary
3107	Oak	14"	Healthy	Protected
3108	Oak	23"	Healthy	Protected
3109	Oak	13"	Healthy	Protected
3111	Oak	10"	Healthy	Protected
3112	Oak	6"	Healthy	Protected
3113	Oak	8"	Healthy	Protected
3116	Oak	9"	Healthy	Protected
3117	Oak	10"	Healthy	Protected
3118	Elm	17"	Healthy	Protected
3119	Oak	32"	Healthy	Protected
3120	Hackberry	15"	Healthy	Secondary
3121	Elm	12"	Healthy	Protected
3122	Elm	11"	Healthy	Protected
3123	Hackberry	12"	Healthy	Secondary
3124	Oak	15"	Healthy	Protected
3125	Oak	14"	Healthy	Protected
3126	Hackberry	9"	Healthy	Secondary
3127	Hackberry	13"	Healthy	Secondary
3128	Oak	9"	Healthy	Protected
3129	Elm	9"	Healthy	Protected
3130	Oak	17"	Healthy	Protected
3131	Elm	15"	Healthy	Protected
3132	Elm	12"	Healthy	Protected
3133	Oak	23"	Healthy	Protected
3133	Hackberry	13"	Healthy	Secondary
3134	Hackberry	10"	Healthy	Secondary
3136	Hackberry	13"	Healthy	Secondary
3137	Hackberry	12"	Healthy	Secondary
	Hackberry	8"	 	
3138		12"	Healthy	Secondary
3139	Oak		Healthy	Protected
3140	Oak	13"	Healthy	Protected
3141	Oak		Healthy	Protected
3142	Hackberry	8"	Healthy	Secondary
3143	Hackberry	14"	Healthy	Secondary
3146	Oak	12"	Healthy	Protected
3147	Pecan	10"	Healthy	Protected
3148	Elm	9"	Healthy	Protected
3149	Oak	14"	Healthy	Protected
3150	Oak	16"	Healthy	Protected
3151	Oak	8"	Healthy	Protected
3152	Elm	11"	Healthy	Protected
3154	Elm	11"	Healthy	Protected
3155	Hackberry	9"	Healthy	Secondary
3156	Elm	11"	Healthy	Protected
3157	Oak	7"	Healthy	Protected
3158	Oak	17"	Healthy	Protected
3159	Hackberry	14"	Healthy	Secondary
3160	Oak	14"	Healthy	Protected
3161	Oak	15"	Healthy	Protected
3162	Elm	11"	Healthy	Protected
3163	Oak	8"	Healthy	Protected
3164	Elm	9"	Healthy	Protected
3165	Elm	10"	Healthy	Protected
3166	Oak	16"	Healthy	Protected
3167	Oak	13"	Healthy	Protected
3168	Oak	10"	Healthy	Protected
3169	Elm	8"	Healthy	Protected
3170	Hackberry	9"	Healthy	Secondary
3171	Hackberry	9"	Healthy	Secondary
3172	Oak	8"	Healthy	Protected
3173	Hackberry	12"	Healthy	Secondary
3175	Oak	8"	Healthy	Protected
3176	Oak	8"	Healthy	Protected
3177	Hackberry	9"	Healthy	Secondary
3178	Elm		Healthy	Protected
3178	Oak	17"	Healthy	Protected
		11"	Healthy	
3180	Elm			Protected
3181	Oak	9"	Healthy	Protected
3182	Oak	8"	Healthy	Protected
3183	Oak	11"	Healthy	Protected
3184	Oak	14"	Healthy	Protected
3185	Elm	10"	Healthy	Protected
3186	Hackberry	8"	Healthy	Secondary
3187	Oak	11"	Healthy	Protected
3188	Hackberry	8"	Healthy	Secondary
2100	Oak	۵"	Healthy	Protected


Site Mitigation Requirements					
Type of Tree	Total Inches	Mitigation Requirement	Mitigated Inches		
Primary	673	1":1"	673		
Secondary	129	1" : 1/2"	65		
Featured	32	1":2"	64		
Total	802				

9"

Healthy

Protected

3189

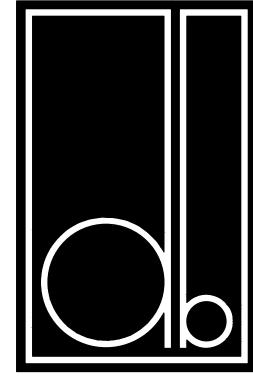

DESIGN BALANCE, INC. 2231 RIDGE ROAD, SUITE 200 ROCKWALL, TEXAS 75087 214.668.2306

RIV PROPERTIES, LLC P.O. BOX 192054 DALLAS, TX 75219

214.908.4684

HARBOR RESIDENCES:

PORTION OF THE MOTON
ADDITION, CITY OF ROCKWALL,
ROCKWALL COUNTY, TEXAS,
SITUATED WITHIN THE HILLSIDE
MIXED USE SUBDISTRICT AND
THE HORIZON/SUMMER LEE
SUBDISTRICT OF PLANNED
DEVELOPMENT DISTRICT 32
(PD-32), GENERALLY LOCATED
AT THE SOUTHWEST CORNER OF
THE INTERSECTION OF HORIZON
ROAD AND SUMMER LEE DRIVE

DATE ISSUED:

06/17/2022


SHEET NUMBER AND TITLE:

4.1 TREESCAPE

PLAN

CASE NUMBER:

PLANNING AND ZONING CHAIRMAN SIGNATURE:

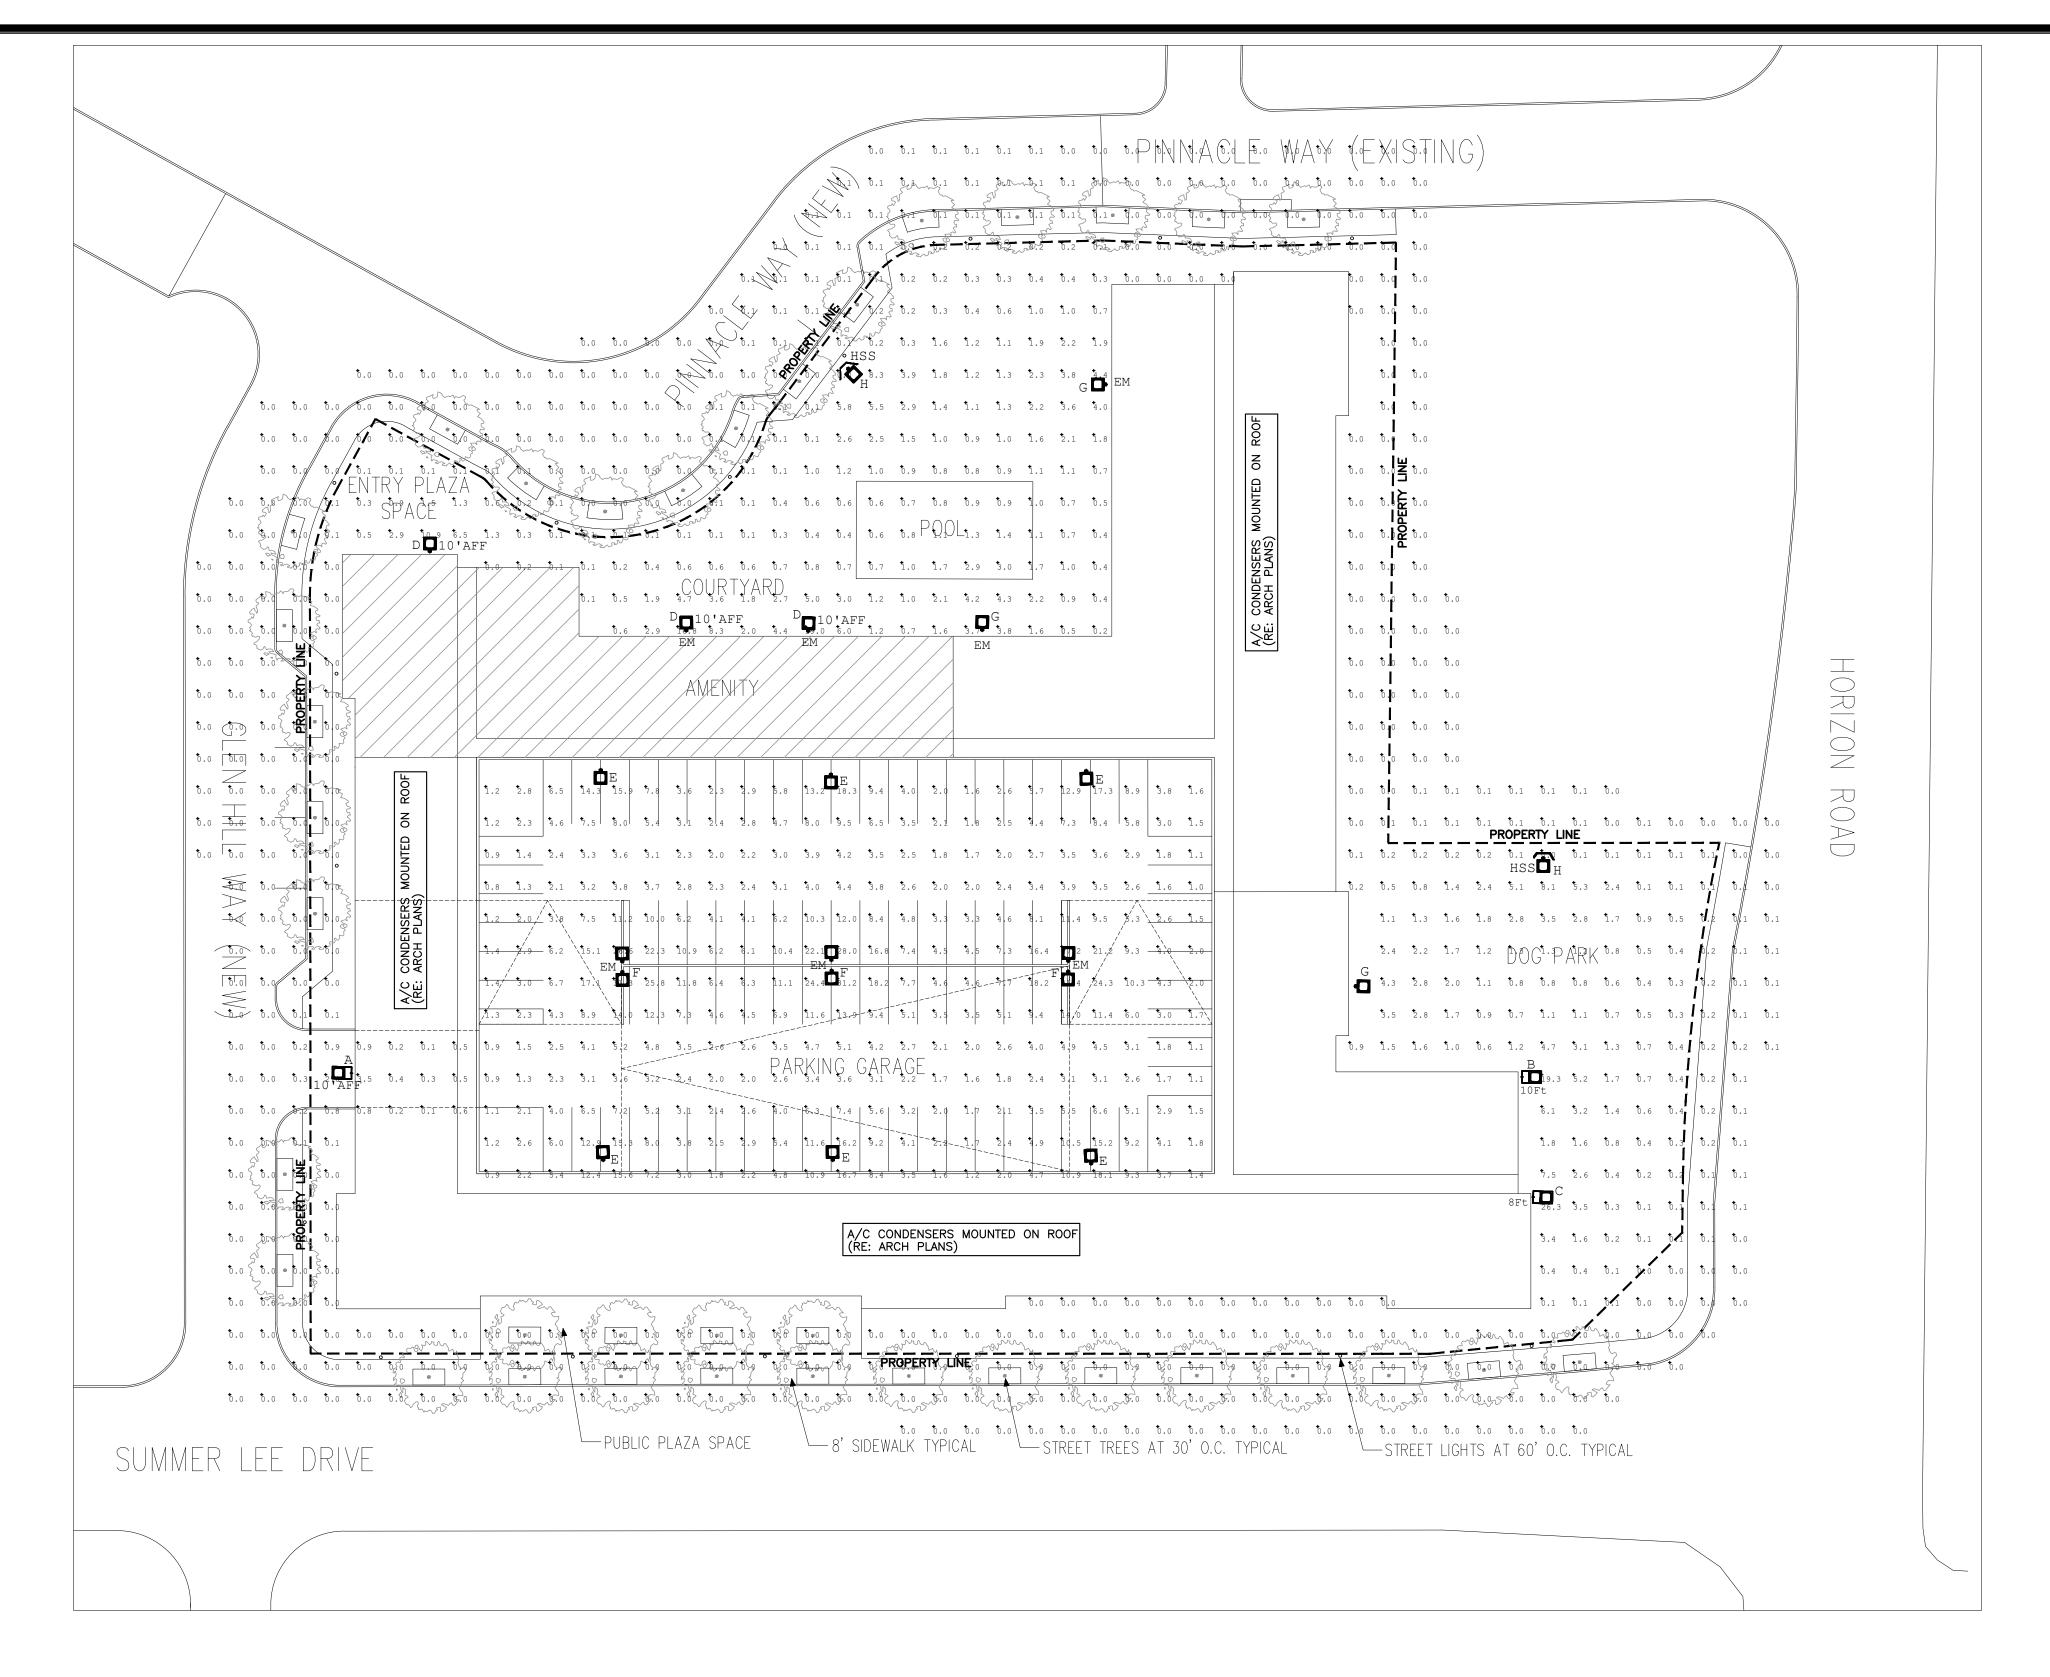

Luminaire Sche	edule							
Symbol	Qty	Label	Arrangement	LLF	Luminaire Lumens	Luminaire Watts	Total Watts	Fixture Height
• A	1	WPCP-LED10	Single	1.000	1150	11.6	11.6	10'
• 10 B	1	MWPCL-LED80-10FT	Single	1.000	8996	87.2	87.2	10'
: C	1	MWPCL-LED50-8FT	Single	0.993	4867	45.3	45.3	8'
D D	3	MWPCL-LED50	Single	0.993	4867	45.3	135.9	10'
- □ E	6	PSLM-LED150-IV	Single	1.000	17972	147.37	884.22	15'
□ ⊸□ F	3	PSLM-LED150-III	Back-Back	1.000	17786	147.41	884.46	15'
₽ G	3	MWPCL-LED80	Single	1.000	8996	87.2	261.6	20'
- □ H	2	PSLS-LED70-IV	Single	1.000	9450	72.3	144.6	15'

HSS - HOUSE SIDE SHIELD EM - 90 MINUTE INVERTER BACKUP


PHOTOMETRIC STUDY

SITE PLAN



8100 WASHINGTON AVE, SUITE 250 HOUSTON, TX. 77007 PHONE: 713-552-1777 TOMMY@SDC-MEP.COM TEXAS ENGINEERING FIRM #21385

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DESIGN BALANCE, INC. 2231 RIDGE ROAD, STE 200 ROCKWALL, TEXAS 75087 214.668.2306

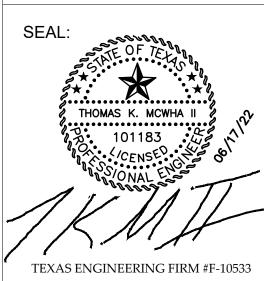OWNER:

RIV PROPERTIES, LLC P.O. BOX 192054 DALLAS, TX 75219 214.908.4684

HARBOR RESIDENCES:

PORTION OF THE MOTON
ADDITION, CITY OF ROCKWALL,
ROCKWALL COUNTY, TEXAS,
SITUATED WITHIN THE HILLSIDE
MIXED USE SUBDISTRICT AND
THE HORIZON/SUMMER LEE
SUBDISTRICT OF PLANNED
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(PD-32), GENERALLY LOCATED
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THE INTERSECTION OF HORIZON
ROAD AND SUMMER LEE DRIVE


DATE ISSUED:

06/17/2022

5.1a
PHOTOMETRIC &
LIGHTING PLAN

CASE NUMBER:

PLANNING AND ZONING CHAIRMAN SIGNATURE:

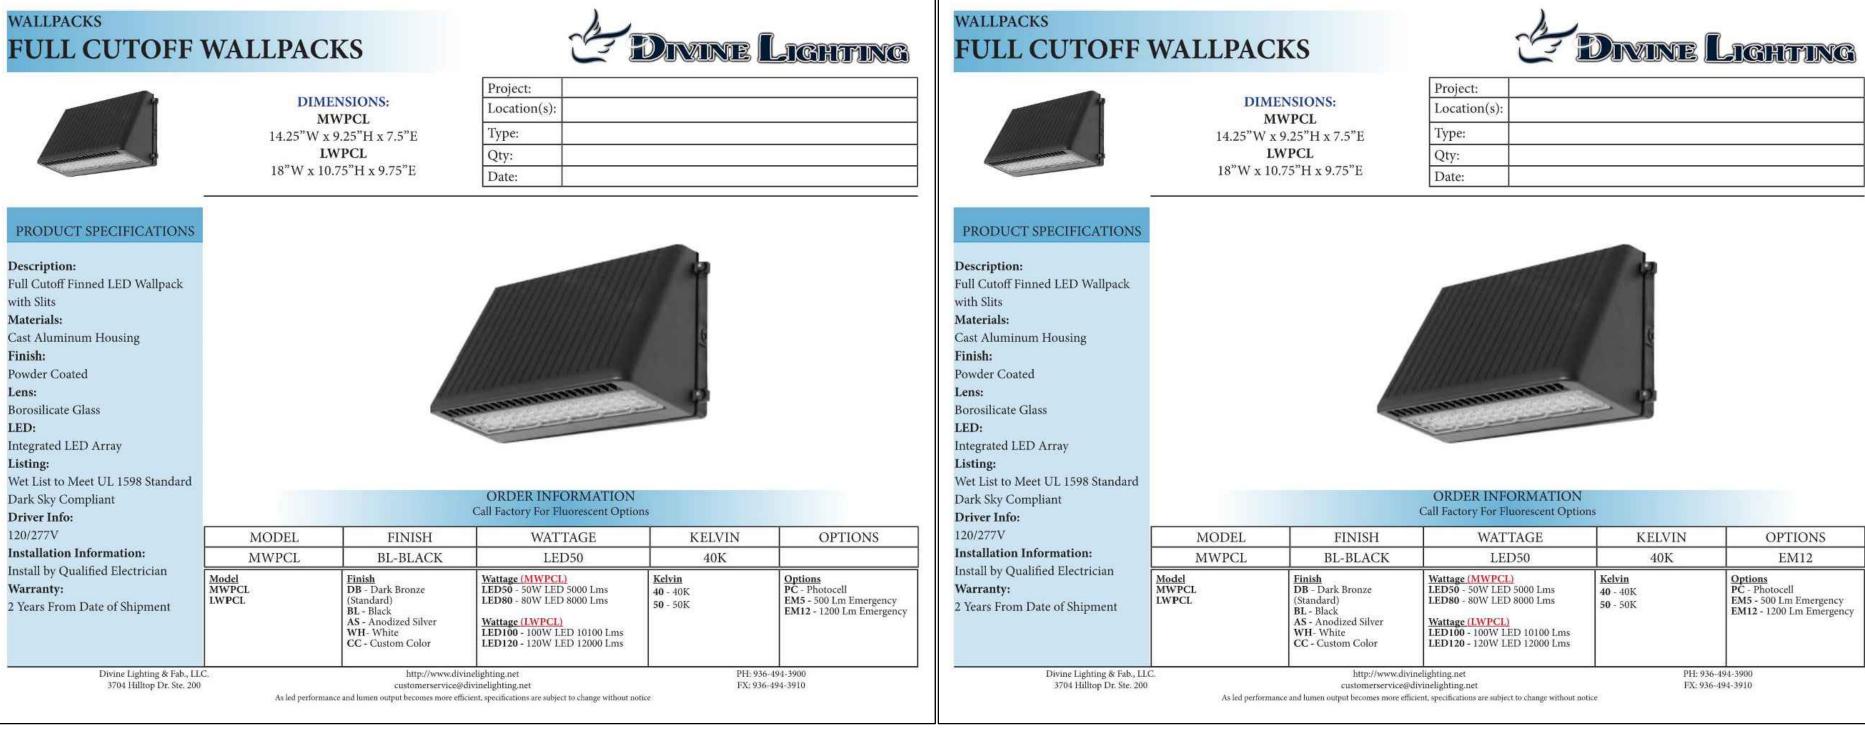

WALLPACKS

Description:

with Slits

Materials:

Powder Coated

Borosilicate Glass

Integrated LED Array

Dark Sky Compliant

Installation Information:

Install by Qualified Electrician

2 Years From Date of Shipment

Divine Lighting & Fab., LLC. 3704 Hilltop Dr. Ste. 200

Driver Info:

120/277V

Warranty:

Wet List to Meet UL 1598 Standard

Finish:

Lens:

LED:

Listing:

PRODUCT SPECIFICATIONS

Full Cutoff Finned LED Wallpack

Cast Aluminum Housing

FULL CUTOFF WALLPACKS

DIMENSIONS:

MWPCL

14.25"W x 9.25"H x 7.5"E

LWPCL

18"W x 10.75"H x 9.75"E

MODEL

MWPCL

FINISH

BL-BLACK

http://www.divinelighting.net customerservice@divinelighting.net

As led performance and lumen output becomes more efficient, specifications are subject to change without notice

Finish DB - Dark Bronze

BL - Black AS - Anodized Silver

CC - Custom Color

Location(s)

ORDER INFORMATION

Call Factory For Fluorescent Options

WATTAGE

LED80

Wattage (MWPCL) LED50 - 50W LED 5000 Lms

LED80 - 80W LED 8000 Lms

Wattage (LWPCL) LED100 - 100W LED 10100 Lms

LED120 - 120W LED 12000 Lms

KELVIN

50 - 50K

40K

FX: 936-494-3910

Type:

Date:

C DIVINE LIGHTING

KELVIN

40K

FX: 936-494-3910

OPTIONS

Options
PC - Photocell
EM5 - 500 Lm Emergency

EM12 - 1200 Lm Emergeno

WALLPACKS

PRODUCT SPECIFICATION:

Full Cutoff Finned LED Wallpack

Cast Aluminum Housing

with Slits

Materials:

LED:

Listing:

Driver Info:

120/277V

Warranty:

Powder Coated

Borosilicate Glass

Integrated LED Array

Dark Sky Compliant

Installation Information:

Install by Qualified Electrician

2 Years From Date of Shipment

Divine Lighting & Fab., LLC. 3704 Hilltop Dr. Ste. 200

Wet List to Meet UL 1598 Standard

FULL CUTOFF WALLPACKS

DIMENSIONS:

MWPCL

14.25"W x 9.25"H x 7.5"E

LWPCL

18"W x 10.75"H x 9.75"E

MODEL

MWPCL

Model MWPCL

FINISH

BL-BLACK

http://www.divinelighting.net customerservice@divinelighting.net

As led performance and lumen output becomes more efficient, specifications are subject to change without notice

Finish DB - Dark Bronze

(Standard)
BL - Black
AS - Anodized Silver

CC - Custom Color

Location(s):

ORDER INFORMATION

Call Factory For Fluorescent Options

WATTAGE

LED80

LED80 - 80W LED 8000 Lms


Wattage (LWPCL) LED100 - 100W LED 10100 Lms

LED120 - 120W LED 12000 Lms

Date:



LIGHTING SPECIFICATIONS

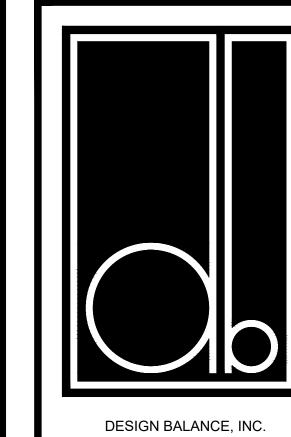

Engineers, LLC MEP CONSULTANTS

8100 WASHINGTON AVE, SUITE 250 HOUSTON, TX. 77007 PHONE: 713-552-1777 TOMMY@SDC-MEP.COM TEXAS ENGINEERING FIRM #21385

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THOMAS K. MCWHA II

TEXAS ENGINEERING FIRM #F-10533

SEAL:

2231 RIDGE ROAD, STE 200 ROCKWALL, TEXAS 75087 214.668.2306

OWNER:

RIV PROPERTIES, LLC P.O. BOX 192054 DALLAS, TX 75219 214.908.4684

HARBOR RESIDENCES:

PORTION OF THE MOTON ADDITION, CITY OF ROCKWALL ROCKWALL COUNTY, TEXAS, SITUATED WITHIN THE HILLSIDE MIXED USE SUBDISTRICT AND THE HORIZON/SUMMER LEE SUBDISTRICT OF PLANNED **DEVELOPMENT DISTRICT 32** (PD-32), GENERALLY LOCATED AT THE SOUTHWEST CORNER OF THE INTERSECTION OF HORIZON ROAD AND SUMMER LEE DRIVE

DATE ISSUED:

06/17/2022

SHEET NUMBER AND TITLE: 5.1b PHOTOMETRIC & LIGHTING PLAN

CASE NUMBER:

PLANNING AND ZONING CHAIRMAN SIGNATURE:



EDIMINE LIGHTING

SITE LIGHTING

PSLS / PSLL

PRODUCT SPECIFICATION:

Flat Top Site Light with Low to High

Heat-Resistant Clear Polycarbonate

Wet List to Meet UL1598 Standard

MODEL

PSLS

Die Cast Aluminum Housing

Output

LED:

Listing:

IP65 Rated

Driver Info:

120/277V

Materials:

Powder Coated

Integrated LED Array

Installation Information:

Install by Qualified Electrician

2 Years From Date of Shipment

Divine Lighting & Mfg., LLC

DIMENSIONS:

PSLS 3.5"H x 13"W x 17.5"E (No Arm)

5.6"W x 13"W x 25.2"E (Staright Arm)

PSLL 3.5"H x 13"W x 21.1"E (No Arm)

5.6"W x 13"W x 28.8"E (Staright Arm)

FINISH

BL-BLACK

Finish DB - Dark Bronze

BL - Black AS - Anodized Silver WH- White

CC - Custom Color

Location(s):

Call Factory For Fluorescent Options

KELVIN TYPE

IV

| Type | III - Type III | PC - Photocell | MOT - Motion | DIMO-10 - 0-10V | TRUN - Trunnio

40K

OPTIONS

DIM0-10 - 0-10V Dimmable TRUN - Trunnion Mount

MA - Mouting Arm SF - Slip Fitter EM5 - Emergency Backup500 Lms

EM12 - Emergency Backup 1200Lms

LSF - Large Slip Fitter

FX: 936-494-3910

WATTAGE

150LED


Wattage (PSLL) LED220 - 220W LED 30200-31000 lms LED310 - 310W LED 36800-38400 lms

customerservice@divinelighting.net

As led performance and lumen output becomes more efficient, specifications are subject to change without notice

| Wattage (PSLS) | LED70 - 70W LED 9300-10000 lms | LED100 - 100W LED 12300-13500 lms | LED150 - 150W LED 17700-18500 lms | LED180 - 180W LED 20600-12500 lms | LED180 - 180W LED 20600-12500 lms

Qty:

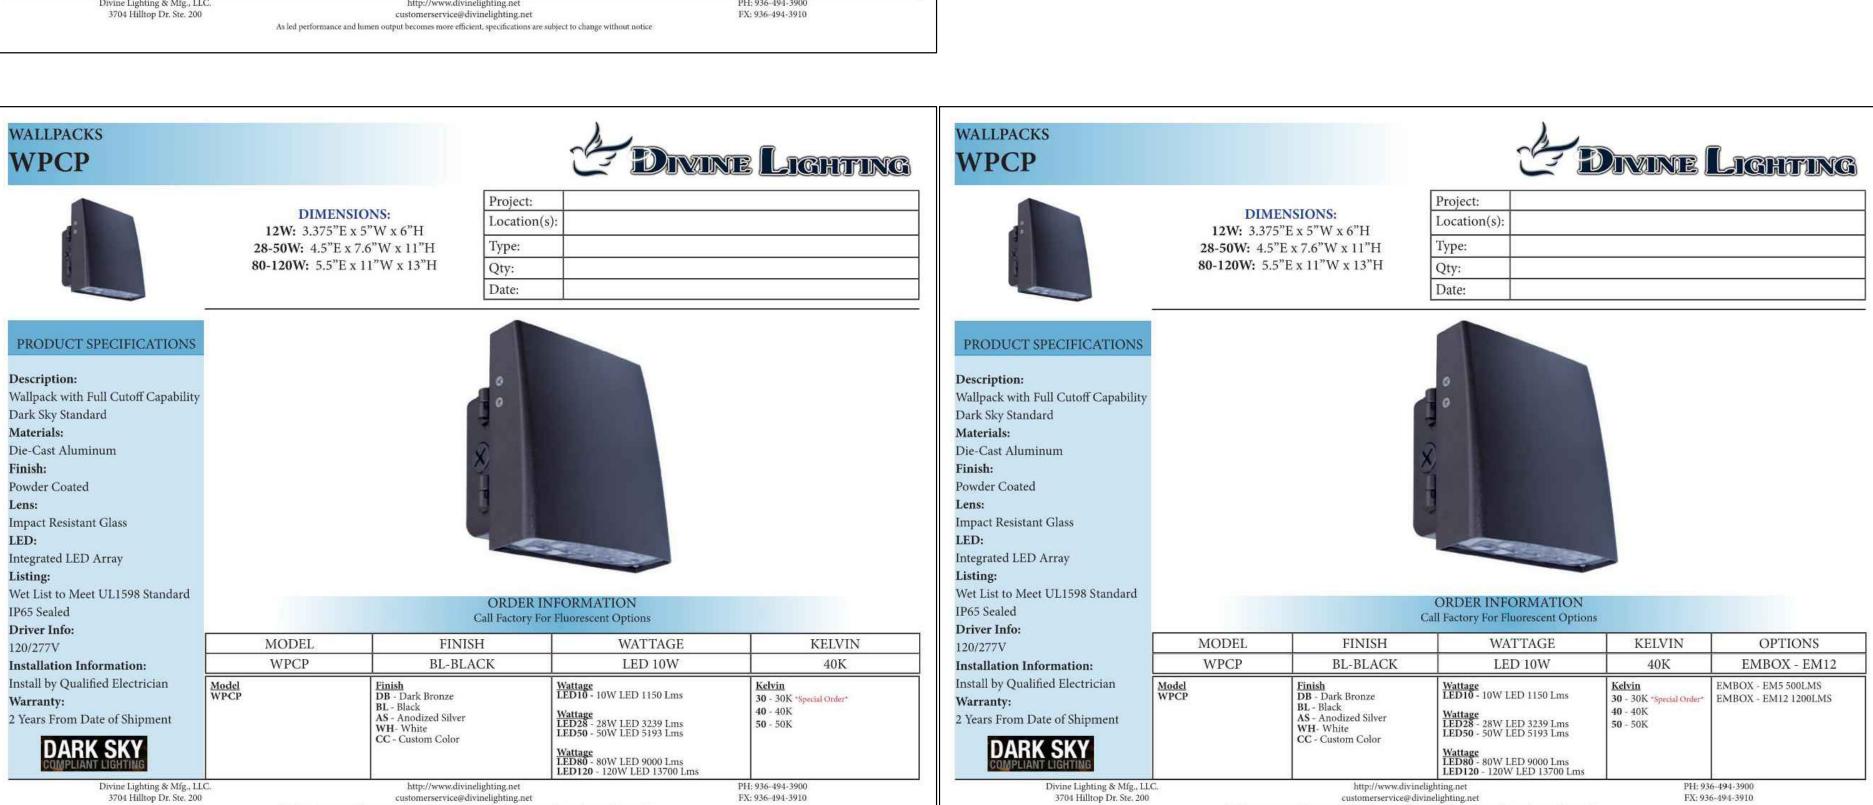

FX: 936-494-3910

customerservice@divinelighting.net


As led performance and lumen output becomes more efficient, specifications are subject to change without notice

LIGHTING SPECIFICATIONS (CONTINUED)

FX: 936-494-3910

customerservice@divinelighting.net

As led performance and lumen output becomes more efficient, specifications are subject to change without notice

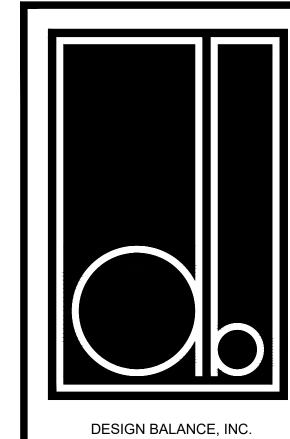

Engineers, LLC MEP CONSULTANTS

8100 WASHINGTON AVE, SUITE 250 HOUSTON, TX. 77007 PHONE: 713-552-1777 TOMMY@SDC-MEP.COM TEXAS ENGINEERING FIRM #21385

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THOMAS K. MCWHA II

TEXAS ENGINEERING FIRM #F-10533

SEAL:

2231 RIDGE ROAD, STE 200 ROCKWALL, TEXAS 75087 214.668.2306

OWNER:

RIV PROPERTIES, LLC P.O. BOX 192054 DALLAS, TX 75219 214.908.4684

HARBOR RESIDENCES:

PORTION OF THE MOTON ADDITION, CITY OF ROCKWALL ROCKWALL COUNTY, TEXAS, SITUATED WITHIN THE HILLSIDE MIXED USE SUBDISTRICT AND THE HORIZON/SUMMER LEE SUBDISTRICT OF PLANNED **DEVELOPMENT DISTRICT 32** (PD-32), GENERALLY LOCATED AT THE SOUTHWEST CORNER OF THE INTERSECTION OF HORIZON ROAD AND SUMMER LEE DRIVE

DATE ISSUED:


06/17/2022

SHEET NUMBER AND TITLE: 5.1c PHOTOMETRIC & LIGHTING PLAN

CASE NUMBER:

PLANNING AND ZONING CHAIRMAN SIGNATURE:

PROJECT COMMENTS

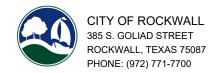

DATE: 6/24/2022

PROJECT NUMBER: SP2022-035

PROJECT NAME: Site Plan for Harbor Residences CASE MANAGER PHONE:

SITE ADDRESS/LOCATIONS:

CASE MANAGER EMAIL: hlee@rockwall.com

Henry Lee

972.772.6434

CASE MANAGER:

CASE CAPTION: Discuss and consider a request by Asher Hamilton of RIV Properties, LLC for the approval of a Site Plan for a 176-unit condominium

building on a 3.59-acre tract of land identified as Lots 1, 2, 3, & 4, Block 2; Lots 1, 2, 3, & 4, Block 3; Lots 1, 2, 3, & 4, Block 5; Lots 1 & 2 and a portion of Lots 3 & 4, Block 6; Lots 2, 3, & 4, Block 7; Lots 1 & 2, Block 8; and Lots 1, 2, 3, & 4, Block 9, Moton Addition, City of

Rockwall, Rockwall County, Texas, situated within the Hillside Mixed Use Subdistrict and the Horizon/Summer Lee Subdistrict of Planned Development District 32 (PD-32), generally located at the southwest corner of the intersection of Horizon Road and

Summer Lee Drive, and take any action necessary.

DEPARTMENT	REVIEWER	DATE OF REVIEW	STATUS OF PROJECT	
PLANNING	Henry Lee	06/24/2022	Needs Review	

06/24/2022: Please address the following comments (M= Mandatory Comments; I = Informational Comments)

- I.1 This is a request for the approval of a Site Plan for a 176-unit condominium building on a 3.59-acre tract of land identified as Lots 1, 2, 3, & 4, Block 2; Lots 1, 2, 3, & 4, Block 3; Lots 1, 2, 3, & 4, Block 5; Lots 1 & 2 and a portion of Lots 3 & 4, Block 6; Lots 2, 3, & 4, Block 7; Lots 1 & 2, Block 8; and Lots 1, 2, 3, & 4, Block 9, Moton Addition, City of Rockwall, Rockwall County, Texas, situated within the Hillside Mixed Use Subdistrict and the Horizon/Summer Lee Subdistrict of Planned Development District 32 (PD-32), generally located at the southwest corner of the intersection of Horizon Road and Summer Lee Drive.
- 1.2 For guestions or comments concerning this case please contact Henry Lee in the Planning Department at (972) 772-6434 or email hlee@rockwall.com.
- M.3 For reference, include the case number (SP2022-035) in the lower right-hand corner of all pages of all revised plan submittals. (Subsection 01.02(D), Article 11, UDC)
- I.4 This project is subject to all requirements stipulated by the Unified Development Code (UDC), the Planned Development District 32 (PD-32), the PD-32 Design Guidelines (Resolution No. 10-40), the IH-30 Overlay District Standards, and the Development Standards of Article 05, that are applicable to the subject property.
- M.5 The subject property will be required to plat to establish the new easements. (Subsection 03.04. A, of Article 11)
- M.6 Provide the standard signature block with signature space for the Planning and Zoning Chairman and the Planning Director on all pages of the plans. Also remove the red placeholder text from the signature block. (Subsection 03.04. A, of Article 11)

APPROVED:

I hereby certify that the above and foregoing site plan for a development in the City of Rockwall, Texas, was approved by the Planning & Zoning Commission of the City of Rockwall on the ____ day of ______.

WITNESS OUR HANDS, this ____ day of ______, ____.

Planning & Zoning Commission, Chairman

Director of Planning and Zoning

M.7 Provide a physical material sample board. (Subsection 03.04. A, of Article 11)

M.8 Provide a Streetscape Plan, that includes the right-of-way (ROW), sidewalks, light fixtures, landscaping, benches, trash receptacles, seat wells, bike racks, etc. Examples of a Streetscape Plan can be found within the PD-32 zoning ordinance, Ordinance No. 17-22.

M.9 Site Plan:

- 1. Provide a numeric and graphic scale. (Subsection 03.04. A, of Article 11)
- 2. Please include the lot square footage. (Subsection 03.04. B, of Article 11)
- 3. Please indicate the dimensions of the site in feet. (Subsection 03.04. B, of Article 11)
- 4. Please indicate all wall lengths. (Subsection 03.04. B, of Article 11)
- 5. Please indicate the distance between the building and all property line. (Subsection 03.04. B, of Article 11)
- 6. Please indicate all existing lot property lines. These may be ghosted. (Subsection 03.04. B, of Article 11)
- 7. Please indicate all building setbacks adjacent to public ROW. The building setbacks were changed as part of the PD Development Plan from the previously approved case (Case No. Z2022-001), so use these setbacks. (Subsection 03.04. B, of Article 11)
- 8. Please indicate all existing and proposed easements. (Subsection 03.04. B, of Article 11)
- 9. Please label all proposed fire lanes. (Subsection 03.04. B, of Article 11)
- 10. Please indicate all adjacent streets ROW. (Subsection 03.04. B, of Article 11)
- 11. Please only provide the parking table on the site plan. (Subsection 03.04. B, of Article 11)
- 12. Please indicate the type and height of all proposed fencing. (Subsection 03.04. B, of Article 11)
- 13. If there is any ground mounted equipment it must indicated on the site plan with the subsequent screening. (Subsection 01.05. C, of Article 05)
- 14. Please crosshatch all the roof mounted utility equipment on the building elevations. (Subsection 01.05. C, of Article 05)
- 15. Please indicate the dog park as private. (Subsection 03.04. B, of Article 11)

M.10 Landscape Plan:

- 1. Provide the same site data as the site plan site data table. (See Sec. 2.1 of this checklist)
- 2. Provide the impervious vs. landscaped area within the site data table. Verify the impervious area as the building is included in that calculation. (Subsection 01.01. B, of Article 05)
- 3. All shrubs shall be 5-gallon (Subsection 05.03. B, of Article 08)
- 4. Provide more detail on the "shrub area:" include the species and location of the planting. (Subsection 05.03, of Article 08)
- 5. The October Glory Red Maple, Possumhaw Holly, and Eastern Red Cedar are not approved trees for PD-32. PD-32 includes a master planting list that you should consult it. (Ordinance No. 17-22)

M.11 Treescape Plan:

- 1. Provide the same site data as the site plan site data table. (See Sec. 2.1 of this checklist)
- 2. The total mitigation is 801.5 caliper inches. Based on the current landscape plan you are replanting 208 caliper inches, which leaves a mitigation balance of 593.5. This does not meet our 80/20 replanting vs. payment ratio. You will need to request an Alternative Tree Mitigation Settlement Agreement is conjunction with this case. The agreement requires approval from both the Planning and Zoning Commission and City Council. I will just need a letter requesting the agreement, which outlines the total mitigation balance, the remaining mitigation balance, and why you are requesting the agreement. Payment for the remaining inches will be \$100.00 per inch.

M.12 Photometric Plan:

- 1. Provide the same site data information required in Section 2.1 Site Plan: Miscellaneous and Density and Dimensional Requirements of this checklist. (Section 2.1 of this checklist)
- 2. Please provide the Foot-candles at the to confirm that the 0.2 FC is being met. Currently it appears that some of the light levels might run afoul from this requirement. (Subsection 03.03. G, of Article 07)
- 3. Please indicate the height that the lighting fixtures will be mounted; this includes both wall mounted and pole mounted. (Subsection 03.03. D, of Article 07)

M.13 Building Elevations:

- Please remove all of the signage from the building elevations. (Subsection 06.02. F, of Article 05)
- 2. Please indicate where the dumpster enclosure is on the elevations. (Subsection 01.05. B, of Article 05)
- 3. Please provide callouts for the materials on the building. (Subsection 04.04, of Article 05)
- 4. 20% natural or quarried stone is required on each façade of the proposed building. (Subsection 06.02. C, of Article 05)
- a. If you do not end up meeting this requirement it should be noted that the overlay district standards also indicate that "(a)|| buildings within a common...development shall incorporate complementary architectural styles, materials, and colors." In this case, if you are generally matching the architectural styles of the adjacent buildings then there is justification for a variance to the material requirement.
- 5. 90% masonry materials are required on each façade of the proposed building. (Subsection 06.02. C, of Article 05)
- 6. Include a note that the parapet will be finished on both sides with the same material as the external facing façade. Also, indicate the parapet height. (Subsection 04.01, of Article 05)
- 7. Please crosshatch the roof mounted utility equipment. (Subsection 01.05. C, of Article 05)
- 8. Please indicate any design elements on the proposed building. (Subsection 04.01, of Article 05)
- 9. Provide the vertical projection heights to confirm conformance with the vertical articulation standards (i.e. vertical wall projections shall be 25% of the wall height). Currently the vertically projecting elements do not appear to meet. (Subsection 04.01, of Article 05)
- 10. The wall projections do not meet our articulation standards (i.e. wall projections must be 25% of the wall height). That being said they appear to meet the articulation standards of the Horizon/Summer Lee Subdistrict within PD-32. Please show conformance to the PD-32 articulation requirements. (Subsection 06.02, of Article 05 and Ordinance 17-22)

M.14 PD-32 Design Guidelines:

- 1. Review the PD-32 design guidelines that were attached with these comments. Make note to the text outlined by a pink box. These design guidelines contain more specific requirements that are applicable to the subject property and the architectural style selected for the project. (Resolution No. 10-40)
- M.15 All franchise utilities must be underground. (Subsection 06.02, of Article 05)
- I.16 Should you decide to request any variances, please provide a letter that lists the variances, why they are being requested, and the subsequent compensatory measures. For each variance requested you must provide two (2) compensatory measures (Subsection 09.01, of Article 11). Examples of compensatory measures include the increased use of masonry material or stone, increased articulation, increased landscaping, increased architectural elements, more pedestrian amenity, etc.
- I.17 Please note that failure to address all comments provided by staff by 3:00 PM on July 6, 2022 will result in the automatic denial of the case on the grounds of an incomplete submittal. No refund will be given for cases that are denied due to an incomplete submittal, and a new application and fee will be required to resubmit the case.
- I.18 Staff has identified the aforementioned items necessary to continue the submittal process. Please make these revisions and corrections, and provide any additional information that is requested. Revisions for this case will be due on July 6, 2022; however, it is encouraged for applicants to submit revisions as soon as possible to give staff ample time to review the case prior to the July 12, 2022 Planning & Zoning Meeting.
- I.19 Please note the scheduled meetings for this case:
- 1) Planning & Zoning Work Session meeting will be held on June 28, 2022.
- 2) Planning & Zoning meeting/public hearing meeting will be held on July 12, 2022.
- I.20 All meetings will be held in person and in the City's Council Chambers. All meetings listed above are scheduled to begin at 6:00 p.m. (P&Z). The City prefers that a representative(s) be present for these meetings. During the upcoming work session meeting with the Planning and Zoning Commission, representative(s) are expected to present their case and answer any questions the Planning Commission may have regarding this request.

DEPARTMENT	REVIEWER	DATE OF REVIEW	STATUS OF PROJECT
ENGINEERING	Sarah Johnston	06/23/2022	Needs Review

06/23/2022: - Need to show and label ex. water and sewer.

- Parallel parking to be 22x9' min.
- Show proposed 8" water connecting to 12" water.
- 8" minimum water and sewer size

- Parking to be 20'x9' with 24' wide drive isles.

The following items are informational for the engineering design process.

General Items:

- Must meet City Standards of Design and Construction
- 4% Engineering Inspection Fees
- Impact Fees (Water, Wastewater & Roadway)
- Minimum easement width is 20' for new easements. No structures allowed in easements.
- Retaining walls 3' and over must be engineered.
- All retaining walls 18" and taller must be rock or stone face. No smooth concrete walls.

Drainage Items:

- Dumpster to drain to an oil/water separator and then to the storm lines.
- Storm Pro-Rata \$7226.59/acre.
- Will require WOUS and wetland study for creek

Water and Wastewater Items:

- All electrical/franchise utility line to be underground.
- No structures in easements. Min. easement width is 20'.
- Minimum public utilities to be 8-inch.
- 12" water line to be installed in Glen Hill Way to connect to ex. 12" water

Roadway Paving Items:

- All parking including parking garage are required to be a minimum of 20'x9' and no dead end parking (must have approved turnaround or hammerhead)
- No dead end parking allowed.
- Fire Lane turn radii must be 30' minimum.
- Need offsite fire line and accessibility easement.
- Traffic Impact Analysis is required
- Need PD-32 required sidewalks along Summer Lee, Pinnacle Way and New Street and "new' street with landscaping and lighting

Landscaping:

- No trees to be with 10' of any public water, sewer or storm line that is 10" in diameter or larger.
- No trees to be with 5' of any public water, sewer, or storm line that is less than 10".

<u>DEPARTMENT</u>	REVIEWER	DATE OF REVIEW	STATUS OF PROJECT	
BUILDING	Rusty McDowell	06/23/2022	Approved	
No Comments				
DEPARTMENT	REVIEWER	DATE OF REVIEW	STATUS OF PROJECT	
FIRE	Ariana Kistner	06/23/2022	Needs Review	

06/23/2022: Review landscape plans for obstruction caused by tree branches/limbs of required clear height above all fire apparatus roadway. A minimum clear vertical height clearance of 14 feet is required.

Review landscape plans for obstruction caused by tree branches/limbs of fire aerial apparatus access to the building. Buildings or portions of buildings or facilities three or more stories or 30 feet or more in height above the lowest level of fire department vehicle access shall be provided with an aerial apparatus access a minimum of 15 feet to a maximum of 30 feet from the building and shall be positioned parallel to one entire side of the building. Provide exhibit showing available access with proposed landscaping at mature heights.

Show the location of the proposed fire department connection and fire pump control room.

Fire lane cannot exceed 10% in grade change, with a cross slope not exceeding 5%. The angles of approach and departure shall not exceed 12 %.


DEPARTMENT	REVIEWER	DATE OF REVIEW	STATUS OF PROJECT	
GIS	Lance Singleton	06/21/2022	Approved w/ Comments	
06/21/2022: Please let us know	w what side of the building you would like to be	addressed off of.		_
Also please provide an interior	unit addressing plan following our requirements	http://www.rockwall.com/pz/GIS/AddressingStanda	rds.pdf	
DEPARTMENT	REVIEWER	DATE OF REVIEW	STATUS OF PROJECT	
POLICE	Chris Cleveland	06/20/2022	Approved	
No Comments				
DEPARTMENT	REVIEWER	DATE OF REVIEW	STATUS OF PROJECT	
PARKS	Travis Sales	06/20/2022	Approved w/ Comments	

06/20/2022: Tree Mitigation Plan:

What is the plan for the balance of the 802' of mitigation required

Landscape Plan:

Approved

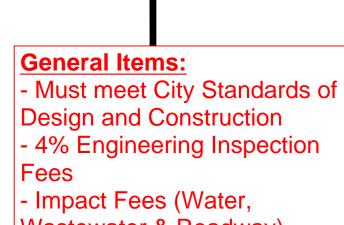

Impact Fees (Water, Wastewater & Roadway)

- Minimum easement width is 20' for new easements. No structures allowed in easements.

- Retaining walls 3' and over must be engineered.

- All retaining walls 18" and taller must be rock or stone face. No smooth concrete walls.

Drainage Items:

- Dumpster to drain to an oil/water separator and then to the storm lines.

Storm Pro-Rata \$7226.59/acre.

8-inch.

- Will require WOUS and wetland study for creek

Water and Wastewater Items:

- All electrical/franchise utility line to be underground.

 No structures in easements. Min. easement width is 20'. - Minimum public utilities to be

- 12" water line to be installed in Glen Hill Way to connect to ex. 12" water

Roadway Paving Items:

 All parking including parking garage are required to be a minimum of 20'x9' and no dead end parking (must have approved turnaround or hammerhead)

No dead end parking allowed.

Fire Lane turn radii must be 30' minimum.

Need offsite fire line and accessibility easement.


- Traffic Impact Analysis is required


Need PD-32 required sidewalks along Summer Lee, Pinnacle Way and New Street and "new' street with landscaping and lighting


Landscaping:


No trees to be with 10' of any public water, sewer or storm line that is 10" in diameter or

No trees to be with 5' of any public water, sewer, or storm line that is less than 10".

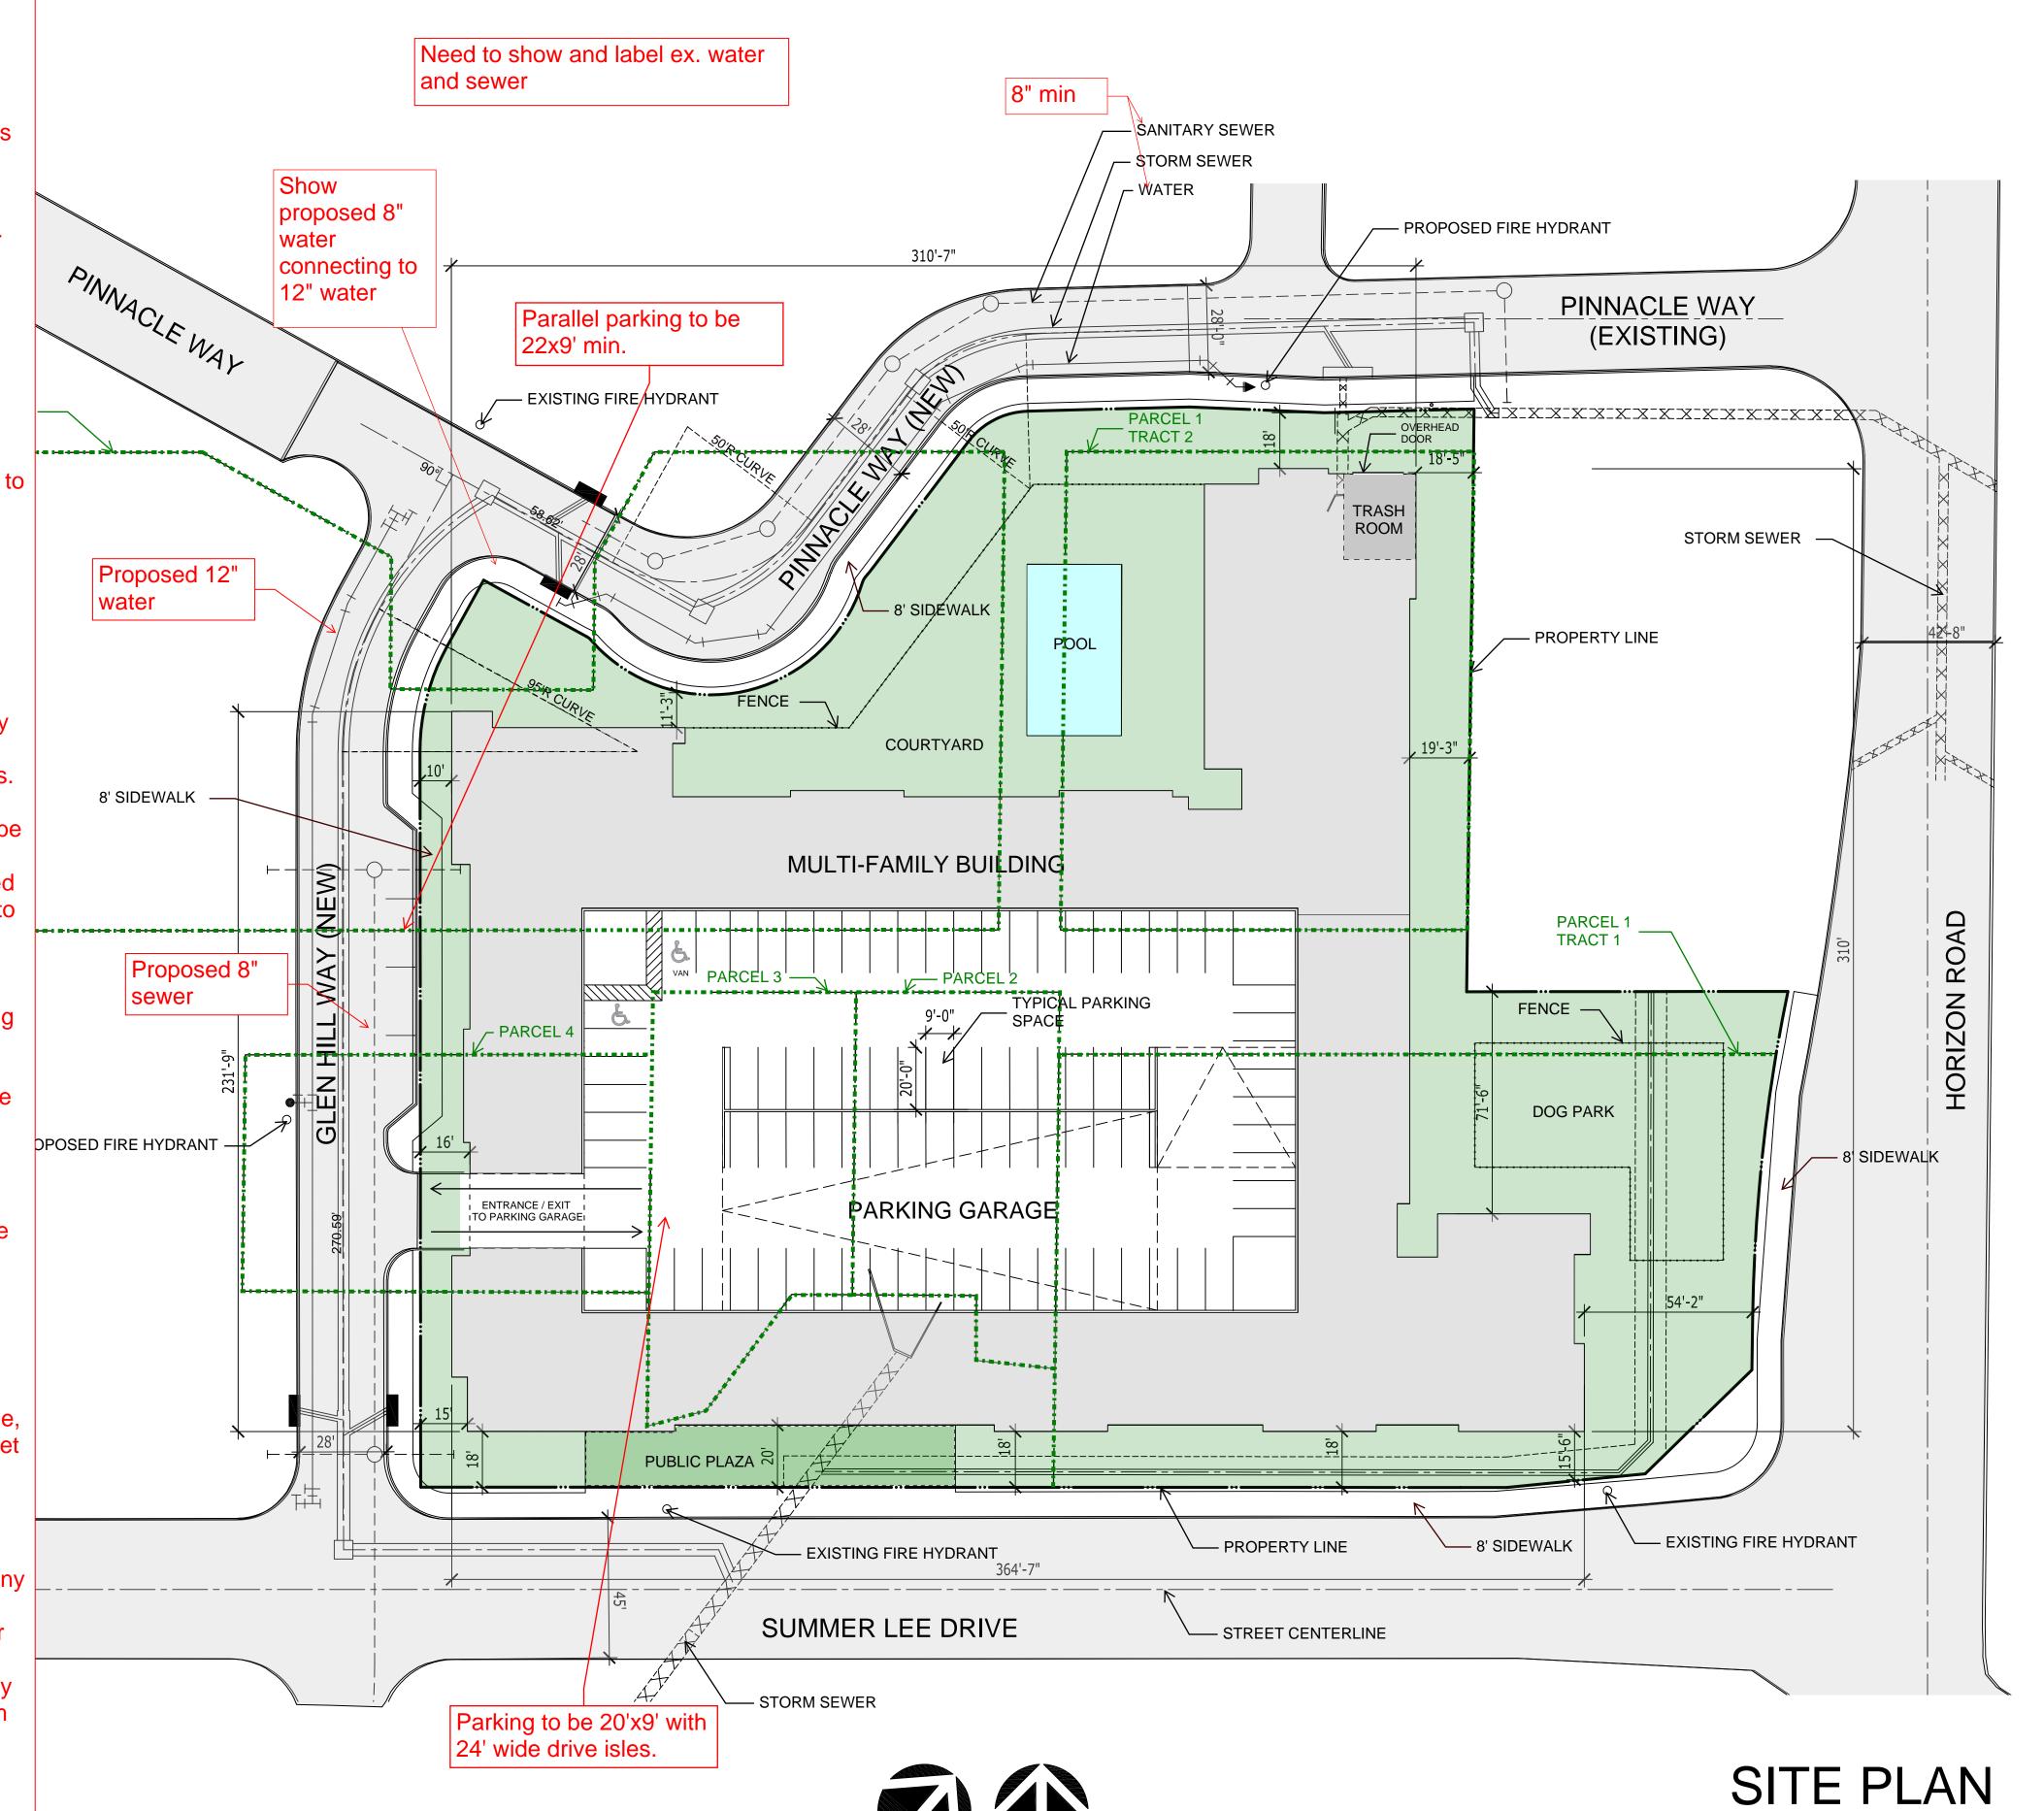

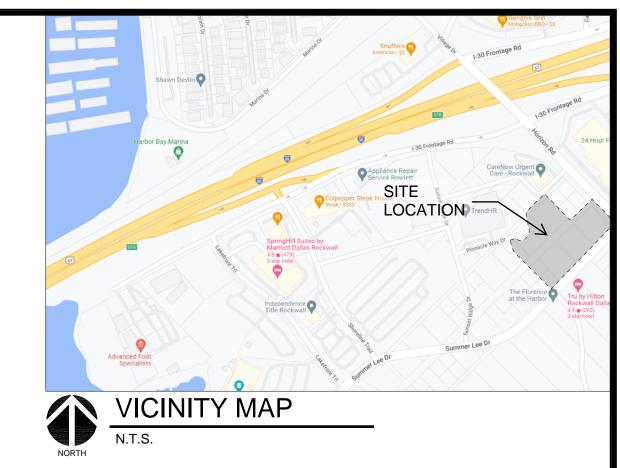

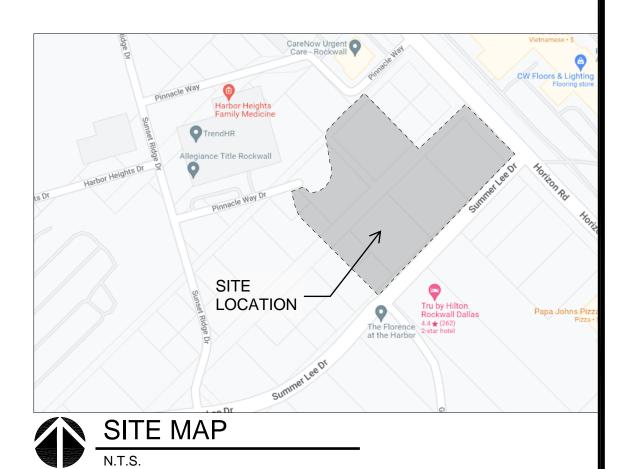

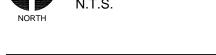

PROJECT DATA

SITE AREA: 2.69 ACRES

LAND USE:

COMMERCIAL

BUILDING INFORMATION: (1) FOUR/FIVE STORY BUILDING SQUARE FOOTAGE: 346,815 GSF

196,592 NRSF UNIT INFORMATION:

1,117 SF AVG. UNIT SIZE 1 BEDRM UNIT TOTAL: 104 UNITS

2 BEDRM UNIT TOTAL 72 UNITS TOTAL: 176 UNITS

PARKING INFORMATION: 300 PARKING SPACES PROVIDED @ 1.7 SPACE / UNIT

7 ACCESSIBLE PARKING SPACES TO BE PROVIDED DISTRIBUTED THROUGH EACH PARKING LEVEL

SITE PLAN REQUIRES REPLATTING LINES SHOW AS FOLLOWS:

··-·-· CURRENT PLATS

SCALE: 1" = 30'-0"


PAVING INFORMATION

FUTURE PLAT

STREET: 6" 3600 PSI CONCRETE W/#4 @ 18" OCEW

DRIVES: 6" 3600 PSI CONCRETE W/#3 @24" OCEW

SIDEWALK: 4" 3000 PSI CONCRETE W/#3 @24" OCEW

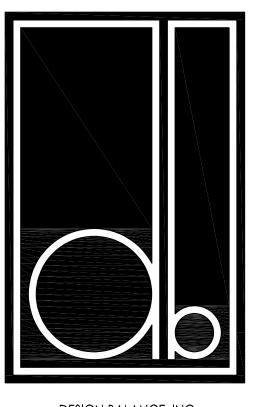

DESIGN BALANCE, INC. 2231 RIDGE ROAD, SUITE 200 ROCKWALL, TEXAS 75087 214.668.2306

RIV PROPERTIES, LLC P.O. BOX 192054 DALLAS, TX 75219 214.908.4684

HARBOR RESIDENCES:

PORTION OF THE MOTON ADDITION, CITY OF ROCKWALL ROCKWALL COUNTY, TEXAS, SITUATED WITHIN THE HILLSIDE MIXED USE SUBDISTRICT AND THE HORIZON/SUMMER LEE SUBDISTRICT OF PLANNED **DEVELOPMENT DISTRICT 32** (PD-32), GENERALLY LOCATED AT THE SOUTHWEST CORNER OF THE INTERSECTION OF HORIZON ROAD AND SUMMER LEE DRIVE

DATE ISSUED:

06/17/2022

SHEET NUMBER AND TITLE: 2.1 SITE PLAN

CASE NUMBER:

PLANNING AND ZONING CHAIRMAN SIGNATURE:



DEVELOPMENT APPLICATION

City of Rockwall
Planning and Zoning Department
385 S. Goliad Street
Rockwall, Texas 75087

TAFF	USE	ONLY	-

PLANNING & ZONING CASE NO.


SP2027-035

NOTE: THE APPLICATION IS NOT CONSIDERED ACCEPTED BY THE CITY UNTIL THE PLANNING DIRECTOR AND CITY ENGINEER HAVE SIGNED BELOW.

DIRECTOR OF PLANNING:

CITY ENGINEER:

PLEASE CHECK THE AI	PPROPRIATE BOX BELOW TO IND	DICATE THE TYPE OF L	DEVELOPMENT REQ	UEST [SELECT ONLY ONE BOX]:		
PLATTING APPLICATION FEES: ☐ MASTER PLAT (\$100.00 + \$15.00 ACRE) ¹ ☐ PRELIMINARY PLAT (\$200.00 + \$15.00 ACRE) ¹ ☐ FINAL PLAT (\$300.00 + \$20.00 ACRE) ¹ ☐ REPLAT (\$300.00 + \$20.00 ACRE) ¹ ☐ AMENDING OR MINOR PLAT (\$150.00) ☐ PLAT REINSTATEMENT REQUEST (\$100.00) SITE PLAN APPLICATION FEES: ☑ SITE PLAN (\$250.00 + \$20.00 ACRE) ¹ ☐ AMENDED SITE PLAN/ELEVATIONS/LANDSCAPING PLAN (\$100.00)			ZONING APPLICATION FEES: ZONING CHANGE (\$200.00 + \$15.00 ACRE) 1 SPECIFIC USE PERMIT (\$200.00 + \$15.00 ACRE) 1 PD DEVELOPMENT PLANS (\$200.00 + \$15.00 ACRE) 1 OTHER APPLICATION FEES: TREE REMOVAL (\$75.00) VARIANCE REQUEST/SPECIAL EXCEPTIONS (\$100.00) 2 NOTES: IN DETERMINING THE FEE, PLEASE USE THE EXACT ACREAGE WHEN MULTIPLYING BY THE PER ACRE AMOUNT. FOR REQUESTS ON LESS THAN ONE ACRE. ROUND UP TO ONE (1) ACRE. A \$1,000.00 FEE WILL BE ADDED TO THE APPLICATION FEE FOR ANY REQUEST THAT INVOLVES CONSTRUCTION WITHOUT OR NOT IN COMPLIANCE TO AN APPROVED BUILDING PERMIT.			
PROPERTY INFO	RMATION [PLEASE PRINT]					
ADDRESS	Moton Addition, City of Rock	wall, Rockwall Cou	nty, Texas, situate	d within the Hillside Mixed Use Subdistrict and		
SUBDIVISION				trict 32 (PD-32), generally located at the		
GENERAL LOCATION	southwest corner of the inte	rsection of Horizon i	Road and Summer	r Lee Drive.		
ZONING, SITE PLA	AN AND PLATTING INFO	RMATION (PLEASE)	RINT			
CURRENT ZONING	PD-32		CURRENT USE	Undeveloped		
PROPOSED ZONING	PD-32		PROPOSED USE	Condominium		
ACREAGE	3.59 Acres	LOTS [CURRENT]	N/A	LOTS [PROPOSED] N/A		
REGARD TO ITS AF RESULT IN THE DEI	PPROVAL PROCESS, AND FAILURE T NIAL OF YOUR CASE:	O ADDRESS ANY OF STA	AFF'S COMMENTS BY	IGE OF <u>HB3167</u> THE CITY NO LONGER HAS FLEXIBILITY W THE DATE PROVIDED ON THE DEVELOPMENT CALENDAR W "ACT/ORIGINAL SIGNATURES ARE REQUIRED]		
	RIV Properties LLC		☑ APPLICANT	RIV Properties LLC		
CONTACT PERSON	Asher Hamilton	C	ONTACT PERSON	Asher Hamilton		
ADDRESS	PO Box 192054		ADDRESS	PO Box 192054		
CITY, STATE & ZIP	Dallas, Texas 75219		CITY, STATE & ZIP	Dallas, TX 75219		
PHONE	(214) 908-4684		PHONE	(214) 908-4684		
E-MAIL	ahamilton@realtyinvestments.c	om	E-MAIL	ahamilton@realtyinvestments.com		
TATED THE INFORMATION	IGNED AUTHORITY. ON THIS DAY PE N ON THIS APPLICATION TO BE TRUE	AND CERTIFIED THE FO		[AGENT] THE UNDERSIGNED, WI		
321.80 TO COVER THE FORMATION CONTAINED	HE COST OF THIS APPLICATION HAS B	EEN PAID TO THE CITY OF APPLICATION, I AGREE PUBLIC. THE CITY IS AL	ROCKWALL ON THIS TO THAT THE CITY OF ROC SO AUTHORIZED AND	CKWALL (I.E. "CITY") IS AUTHORIZED AND PERMITTED TO PROV		
IVEN UNDER MY HAND AN	ID SEAL OF OFFICE ON THIS THE	DAY OF JUNE	20 <u>7</u> 2	Notary ID #133451281 My Commission Expires November 16, 2025		
	AGENTS SIGNATURE					
OTARY PUBLIC IN AND FO	R THE STATE OF TEXAS	i 2~		MY COMMISSION EXPIRES 11/16/202		

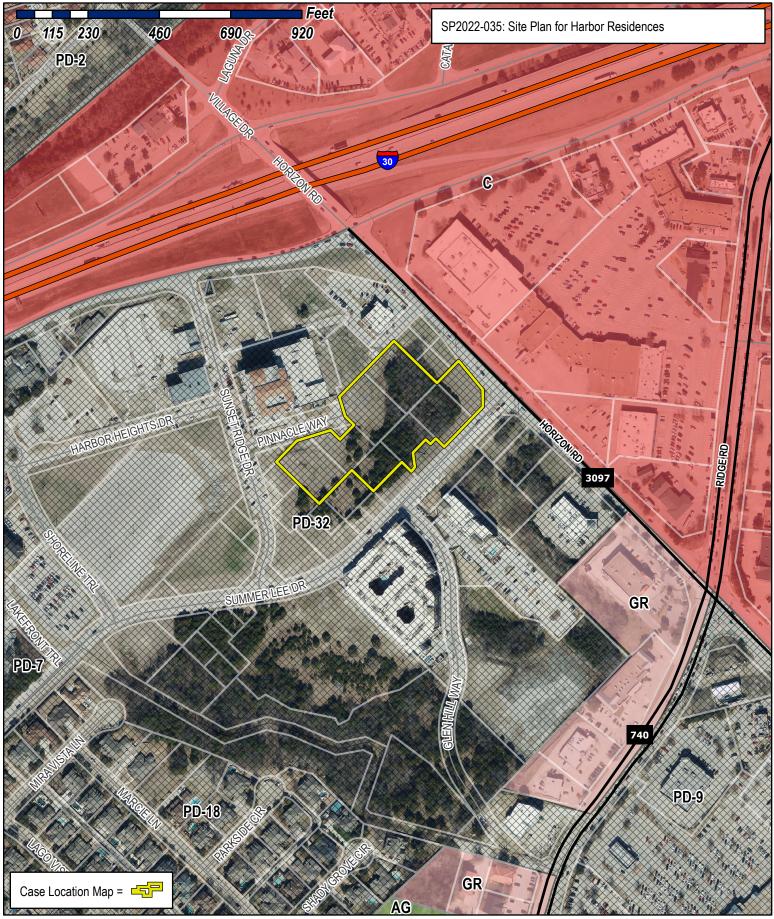






City of Rockwall Planning & Zoning Department 385 S. Goliad Street

Planning & Zoning Department 385 S. Goliad Street Rockwall, Texas 75032 (P): (972) 771-7745 (W): www.rockwall.com The City of Rockwall GIS maps are continually under development and therefore subject to change without notice. While we endeavor to provide timely and accurate information, we make no guarantees. The City of Rockwall makes no warranty, express or implied, including warranties of merchantability and fitness for a particular purpose. Use of the information is the sole responsibility of the user.



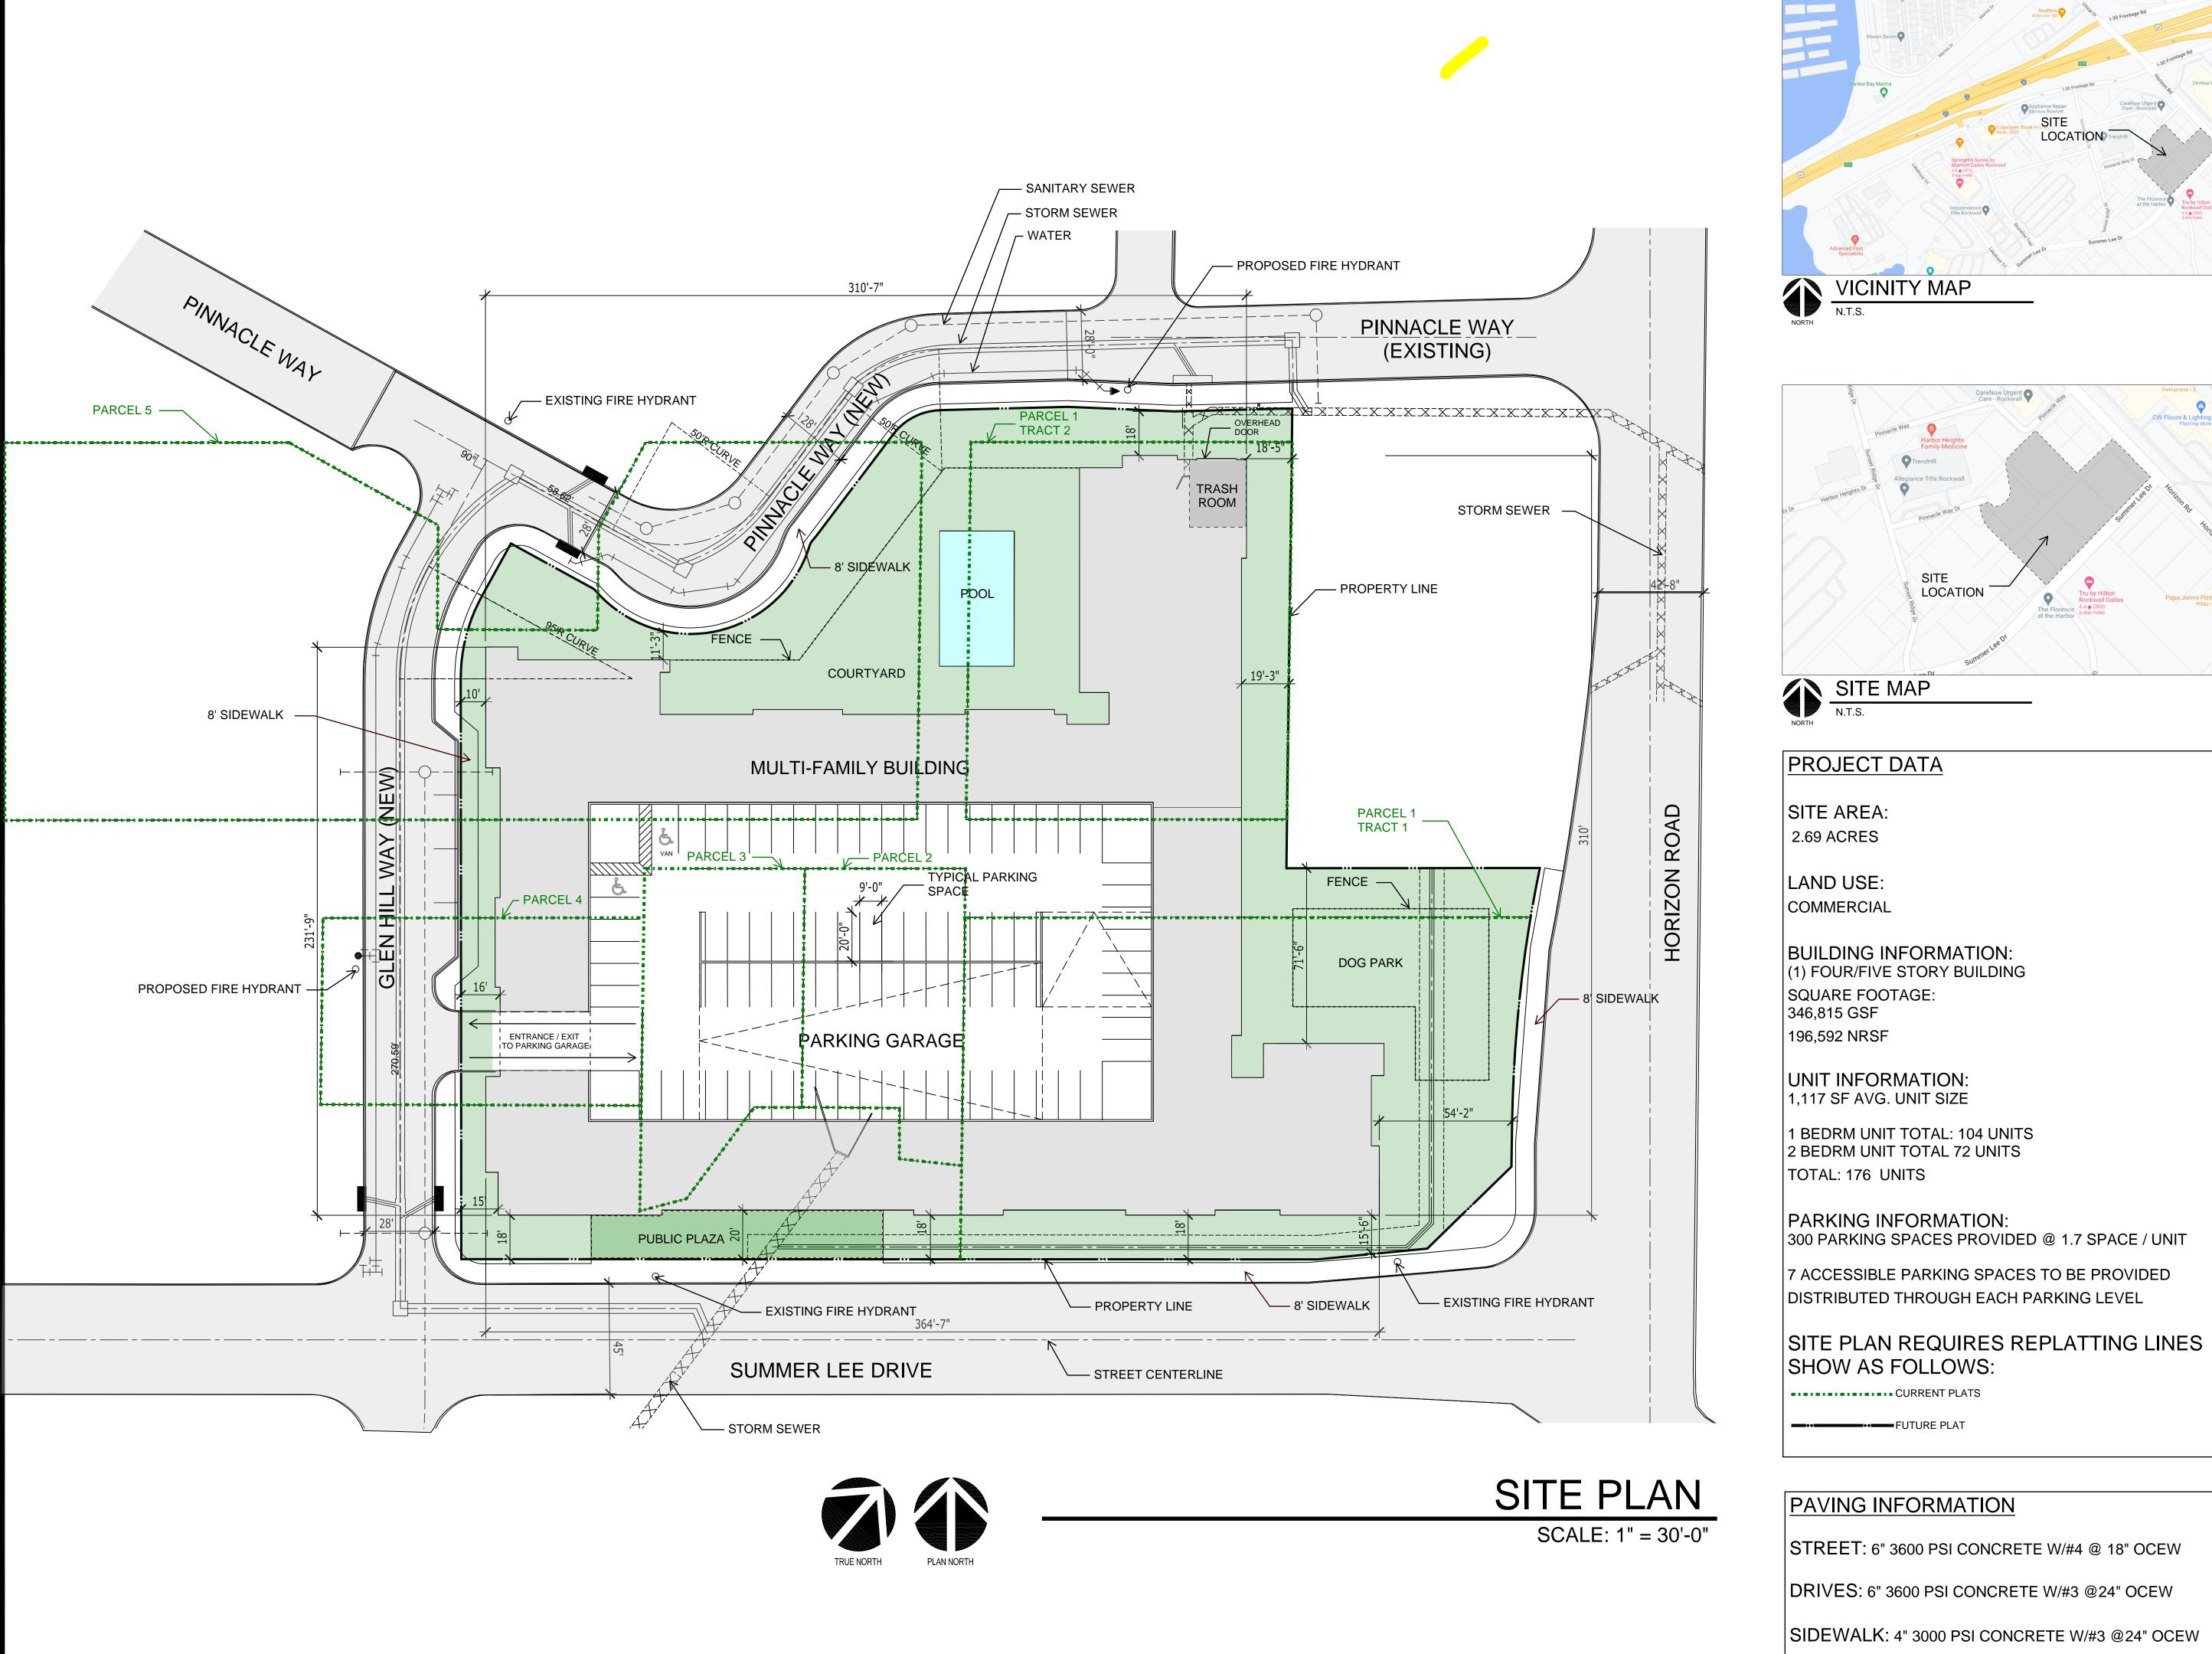

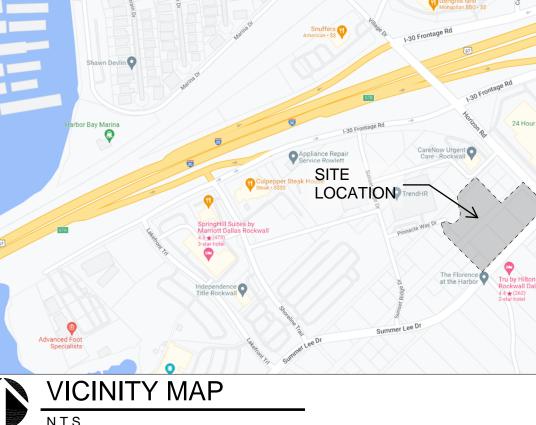

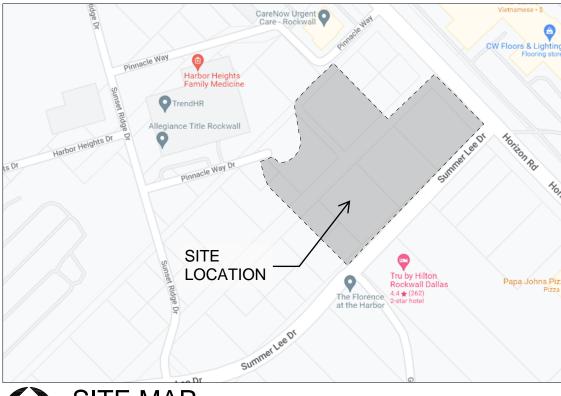

DESIGN BALANCE, INC. 2231 RIDGE ROAD, SUITE 200 ROCKWALL, TEXAS 75087 214.668.2306

RIV PROPERTIES, LLC P.O. BOX 192054 DALLAS, TX 75219 214.908.4684

HARBOR RESIDENCES:

PORTION OF THE MOTON ADDITION, CITY OF ROCKWALL ROCKWALL COUNTY, TEXAS,
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DATE ISSUED:

06/17/2022

SHEET NUMBER AND TITLE: 2.1 SITE PLAN

CASE NUMBER:

PLANNING AND ZONING CHAIRMAN SIGNATURE:



Surface Area: 17,647 SF

Material Percentages
Brick: 32%
Stucco: 68%

O1 EAST ELEVATION
Scale: 1" = 30'-0"



Surface Area: 21,154 SF

Material Percentages
Brick: 34%
Stucco: 66%

O2 SOUTH ELEVATION

Scale: 1" = 30'-0"



Mechanical equipment to b

ROOFTOP EQUIPMENT:

Mechanical equipment to be on the rooftop. This will either be hidden by the parapets or screened

PROPOSED BUILDING MATERIAL:

Brick:

ACME Brick; Marble Grey ACME Brick; Ridgemar

Stucco Colors

tucco Colors
Sherwin Williams; SW 9165; Gossamer Veil
Sherwin Williams: SW 7066; Gray Matters

Sherwin Williams; SW 7066; Gray Matters
Sherwin Williams; SW 7069; Iron Ore

Roof Materials
BORAL Concrete Roof Tile; Saxony Country Slate; Charcoal Blend
Thermoplastic Polyolefin

Precast Stone Coronado Stone; Lompoc

03 WEST ELEVATION


Scale: 1" = 30'-0"



Surface Area: 14,488 SF

Material Percentages
Brick: 30%
Stucco: 70%

NORTH ELEVATION
Scale: 1" = 30'-0"

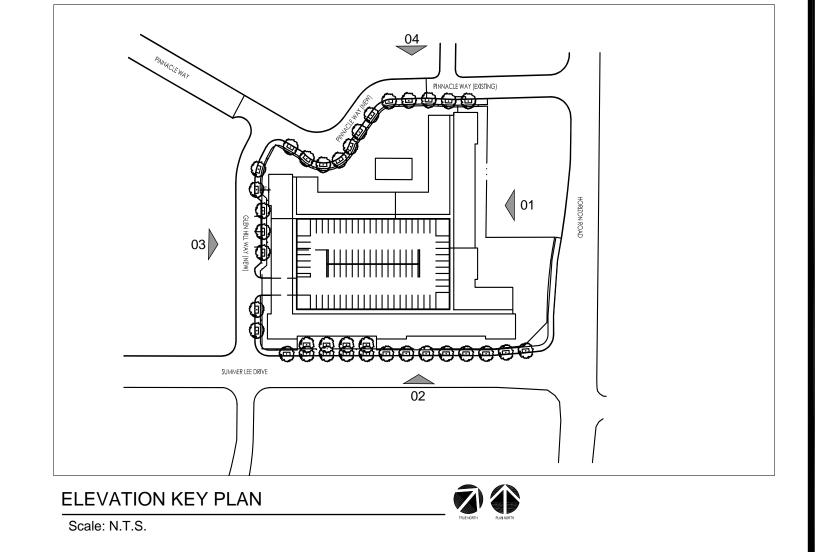

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WNER:

P.O. BOX 192054 DALLAS, TX 75219 214.908.4684

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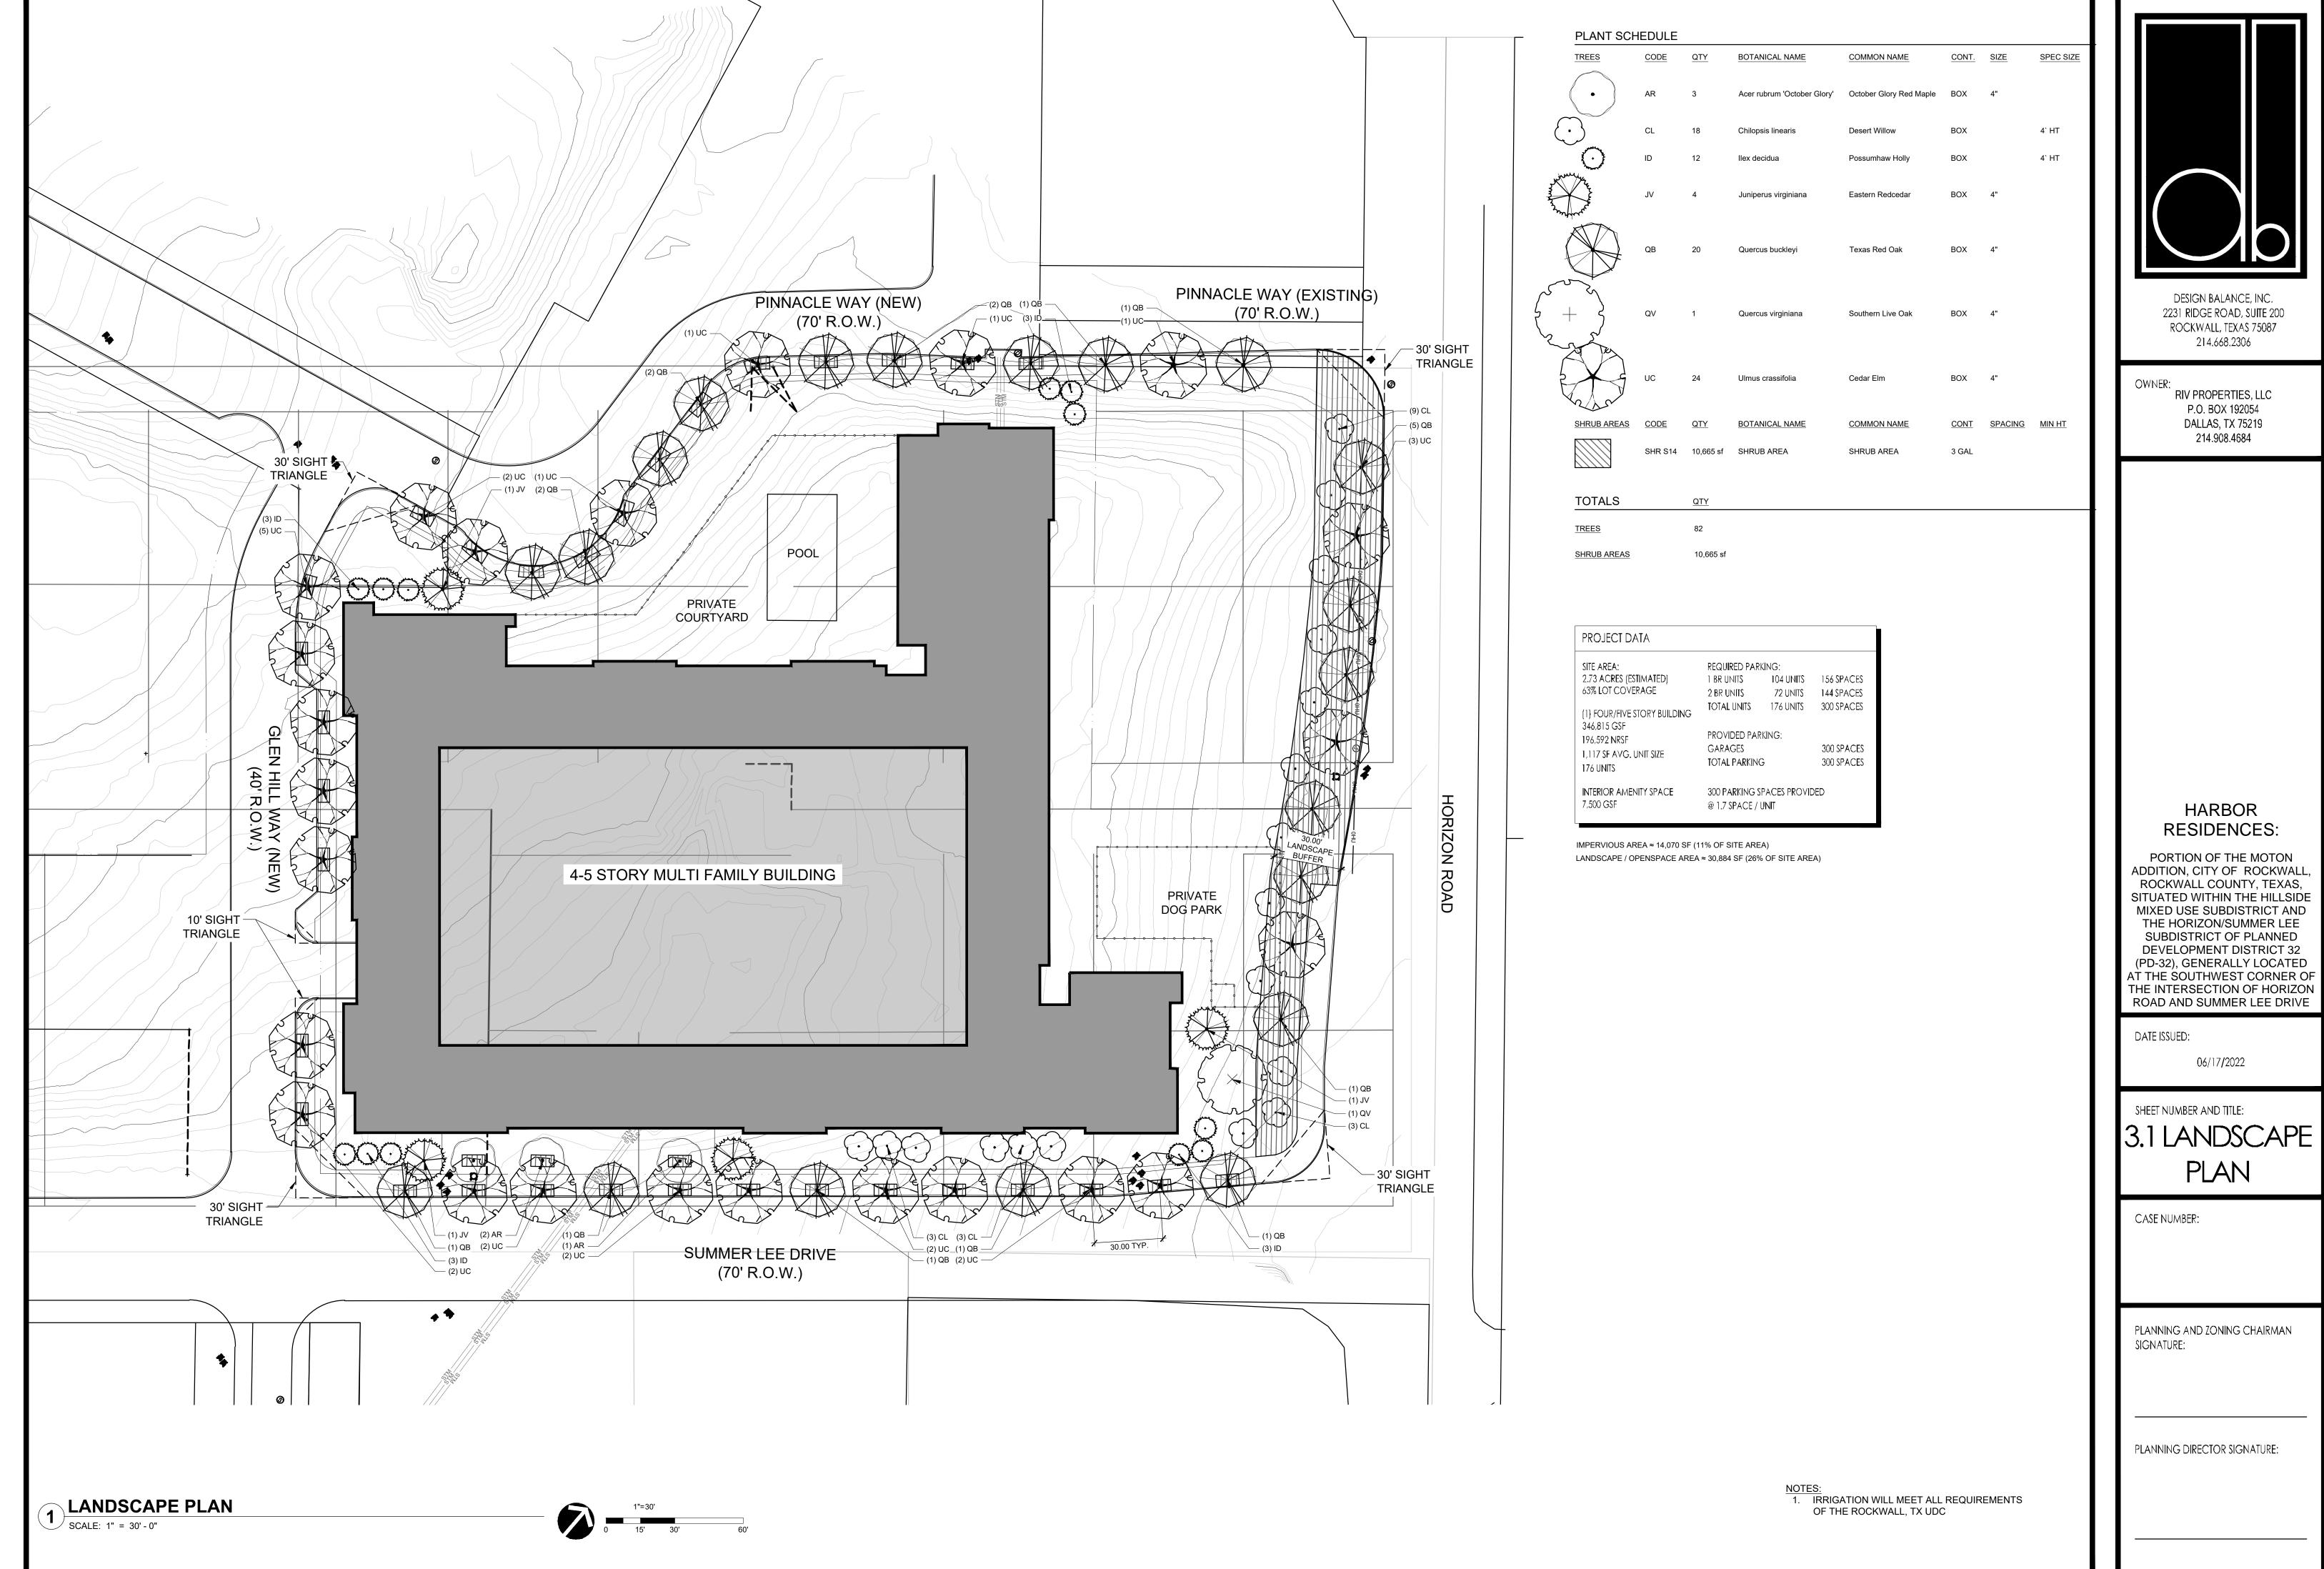
06/17/2022


SHEET NUMBER AND TITLE:

6.1 BUILDING
ELEVATIONS

CASE NUMBER:

PLANNING AND ZONING CHAIRMAN SIGNATURE:



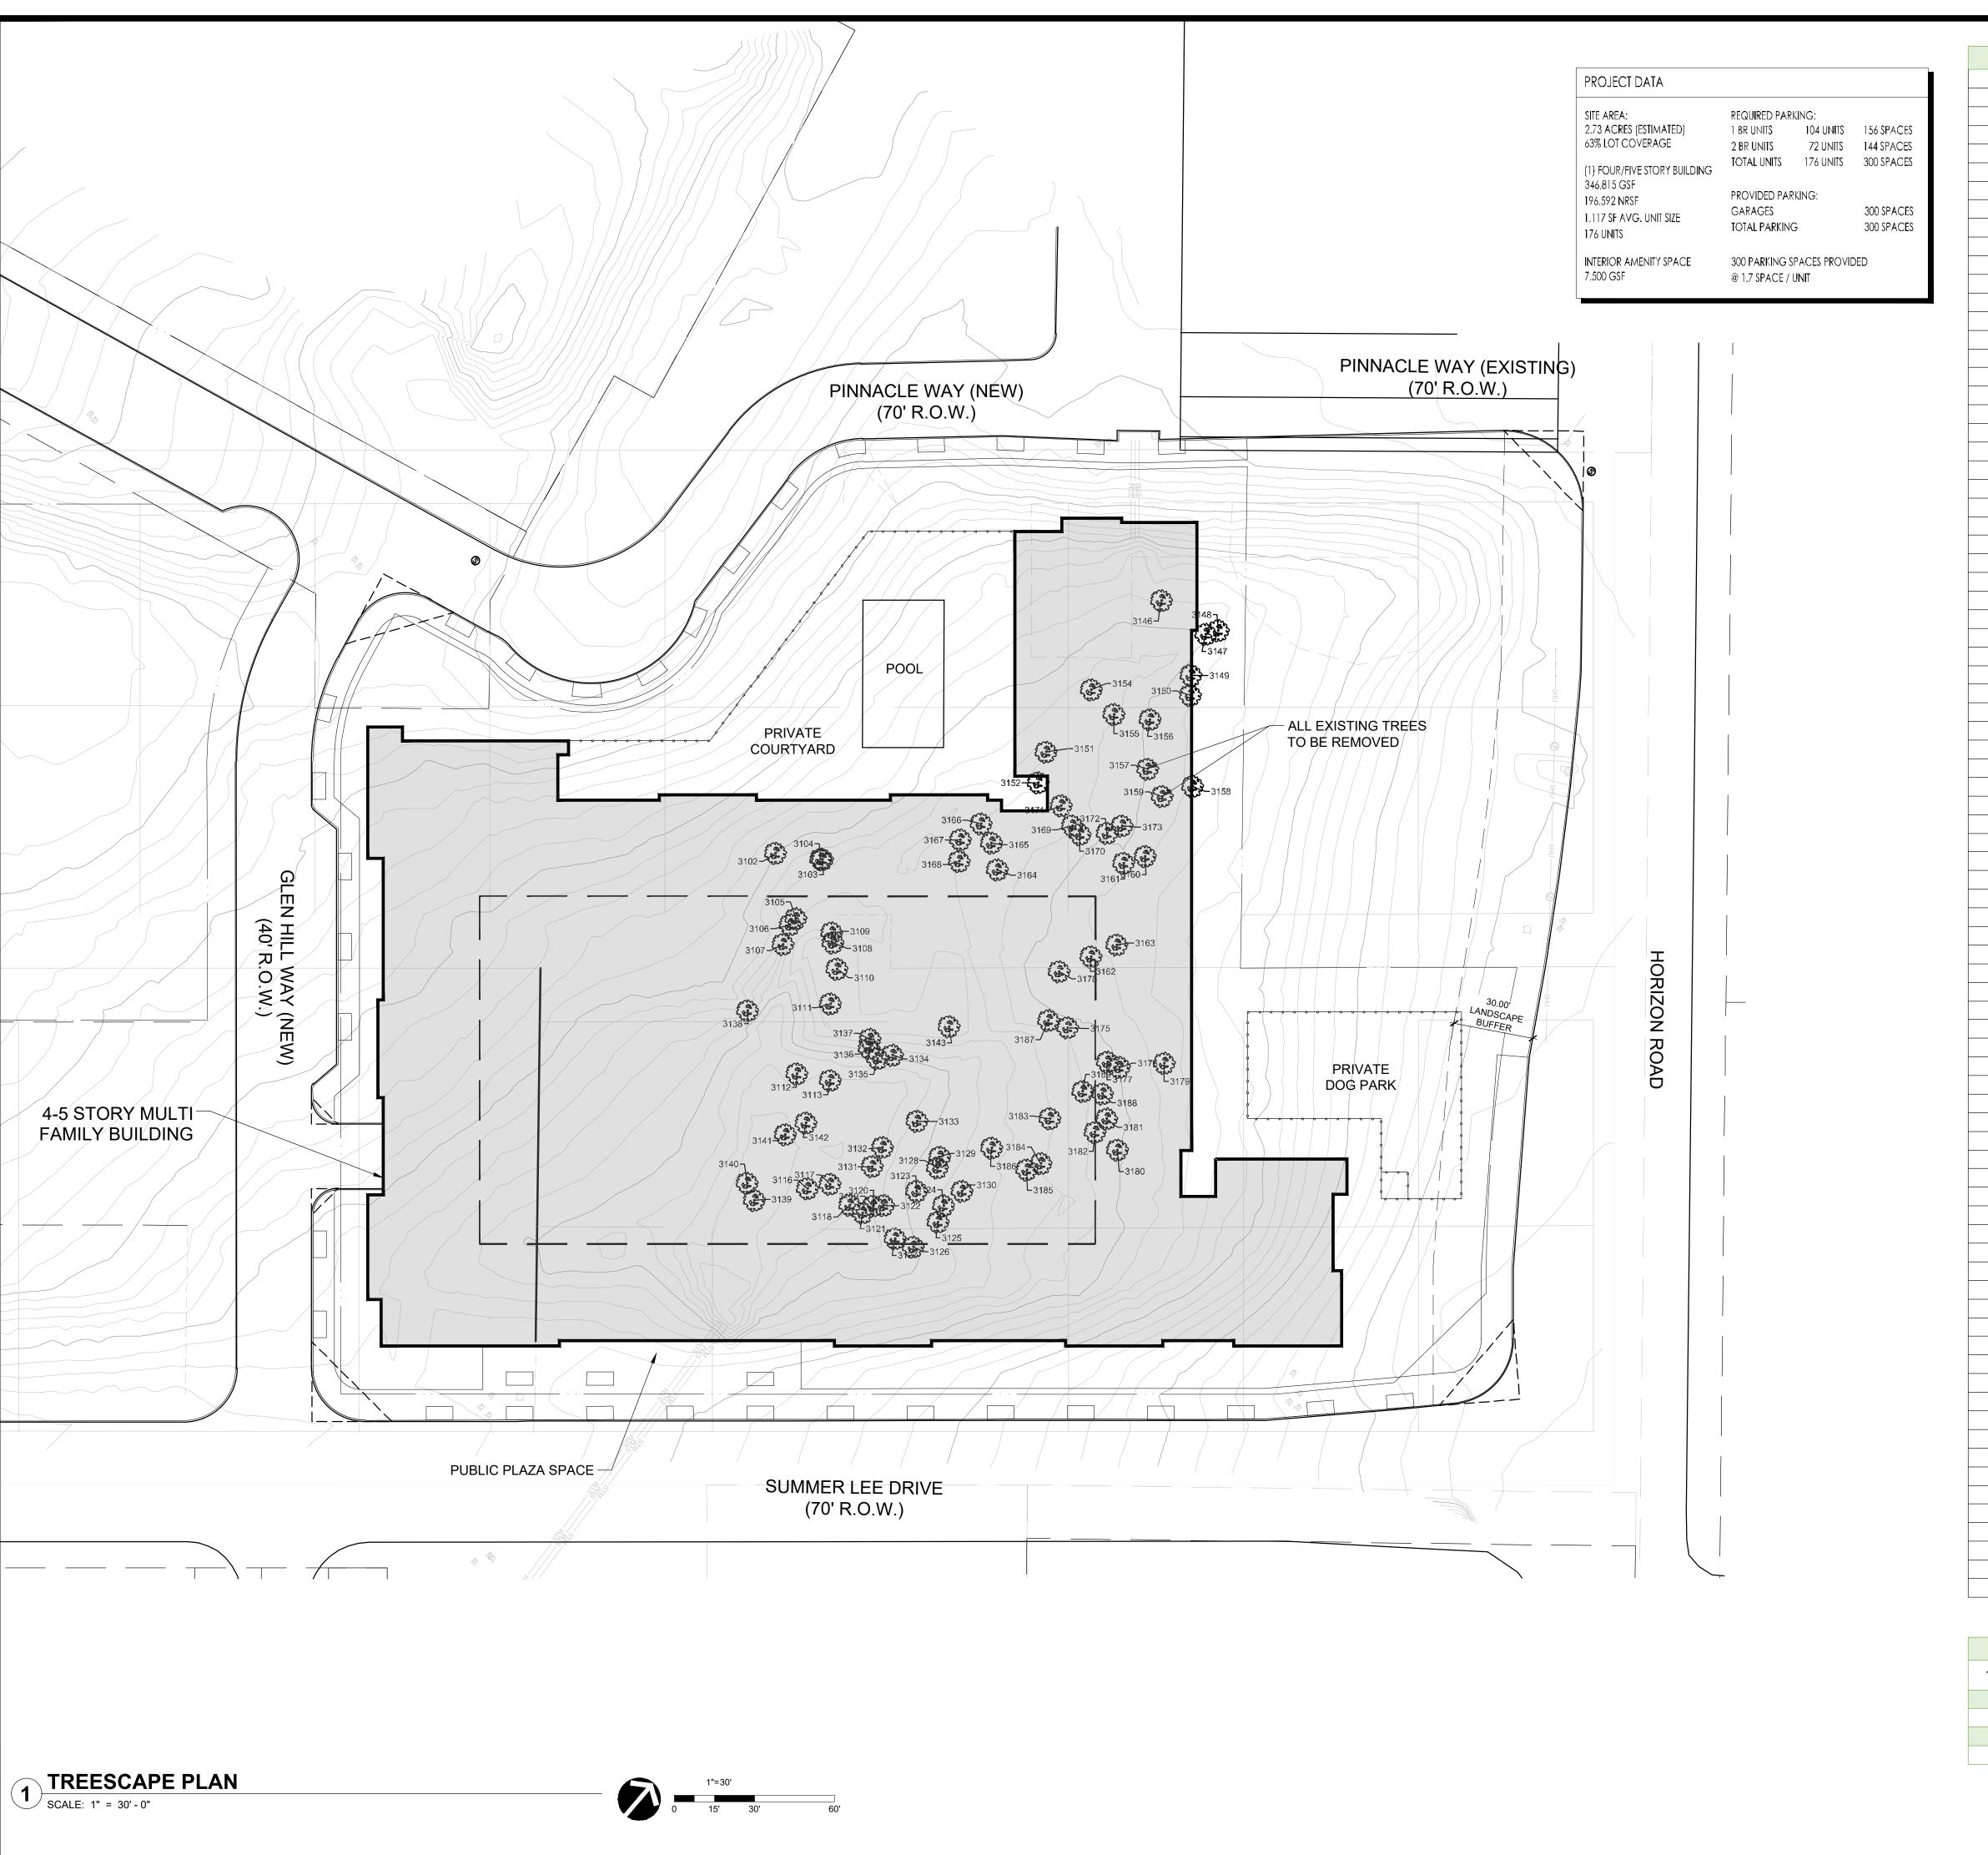

	Exis	ting Tree S	Survey	
Tree #	Family	Size	Status	Classified
3102	Oak	17"	Healthy	Protected
3103	Hackberry	9"	Healthy	Secondary
3104	Hackberry	6"	Healthy	Secondary
3105	Hackberry	11"	Healthy	Secondary
3106	Hackberry	6"	Healthy	Secondary
3107	Oak	14"	Healthy	Protected
3108	Oak	23"	Healthy	Protected
3109	Oak	13"	Healthy	Protected
3111	Oak	10"	Healthy	Protected
3112	Oak	6"	Healthy	Protected
3113	Oak	8"	Healthy	Protected
3116	Oak	9"	Healthy	Protected
3117	Oak	10"	Healthy	Protected
3118	Elm	17"	Healthy	Protected
3119	Oak	32"	Healthy	Protected
3120	Hackberry	15"	Healthy	Secondary
3121	Elm	12"	Healthy	Protected
3122	Elm	11"	Healthy	Protected
3123	Hackberry	12"	Healthy	Secondary
3124	Oak	15"	Healthy	Protected
3125	Oak	14"	Healthy	Protected
3126	Hackberry	9"	Healthy	Secondary
3127	Hackberry	13"	Healthy	Secondary
3128	Oak	9"	Healthy	Protected
3129	Elm	9"	Healthy	Protected
3130	Oak	17"	Healthy	Protected
3131	Elm	15"	Healthy	Protected
3132	Elm	12"	Healthy	Protected
3133	Oak	23"	Healthy	Protected
3134	Hackberry	13"	Healthy	Secondary
3135	Hackberry	10"	Healthy	Secondary
3136	Hackberry	13"	Healthy	Secondary
3137	Hackberry	12"	Healthy	Secondary
3138	Hackberry	8"	Healthy	Secondary
3139	Oak	12"	Healthy	Protected
3140	Oak	13"	Healthy	Protected
3141	Oak	12"	Healthy	Protected
3142	Hackberry	8"	Healthy	Secondary
3143	Hackberry	14"	Healthy	Secondary
3146	Oak	12"	Healthy	Protected
3147	Pecan	10"	Healthy	Protected
3148	Elm	9"	Healthy	Protected
3149	Oak	14"	Healthy	Protected
3150	Oak	16"	Healthy	Protected
3151	Oak	8"	Healthy	Protected
3152	Elm	11"	Healthy	Protected
3154	Elm	11"	Healthy	Protected
3155	Hackberry	9"	Healthy	Secondary
3156	Elm	11"	Healthy	Protected
3157	Oak	7"	Healthy	Protected
3158	Oak	17"	Healthy	Protected
	Hackberry	14"	<u> </u>	
3159 3160	Oak	14"	Healthy Healthy	Secondary Protected
		15"	Healthy	
3161	Oak			Protected
3162	Elm	11" 8"	Healthy	Protected
3163	Oak	8" 	Healthy	Protected
3164	Elm	-	Healthy	Protected
3165	Elm	10"	Healthy	Protected
3166	Oak	16"	Healthy	Protected
3167	Oak	13"	Healthy	Protected
3168	Oak	10"	Healthy	Protected
3169	Elm	8"	Healthy	Protected
3170	Hackberry	9"	Healthy	Secondary
3171	Hackberry	9"	Healthy	Secondary
3172	Oak	8"	Healthy	Protected
3173	Hackberry	12"	Healthy	Secondary
3175	Oak	8"	Healthy	Protected
3176	Oak	8"	Healthy	Protected
3177	Hackberry	9"	Healthy	Secondary
3178	Elm	8"	Healthy	Protected
3179	Oak	17"	Healthy	Protected
3180	Elm	11"	Healthy	Protected
3181	Oak	9"	Healthy	Protected
3182	Oak	8"	Healthy	Protected
3183	Oak	11"	Healthy	Protected
3184	Oak	14"	Healthy	Protected
3185	Elm	10"	Healthy	Protected
3186	Hackberry	8"	Healthy	Secondary
3187	Oak	11"	Healthy	Protected
3188	Hackberry	8"	Healthy	Secondary
	,		-	
2190	Oak	۵"	Healthy	Protected


Site Mitigation Requirements						
Type of Tree	Total Inches Mitigation Requirement Mitigated Inches					
Primary 673		1":1"	673			
Secondary	Secondary 129		65			
Featured	32	1":2"	64			
Total	802					

9"

Healthy

Protected

3189

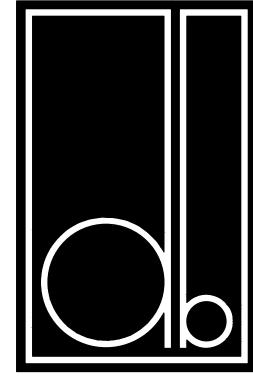

DESIGN BALANCE, INC. 2231 RIDGE ROAD, SUITE 200 ROCKWALL, TEXAS 75087 214.668.2306

RIV PROPERTIES, LLC P.O. BOX 192054 DALLAS, TX 75219

214.908.4684

HARBOR RESIDENCES:

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DATE ISSUED:

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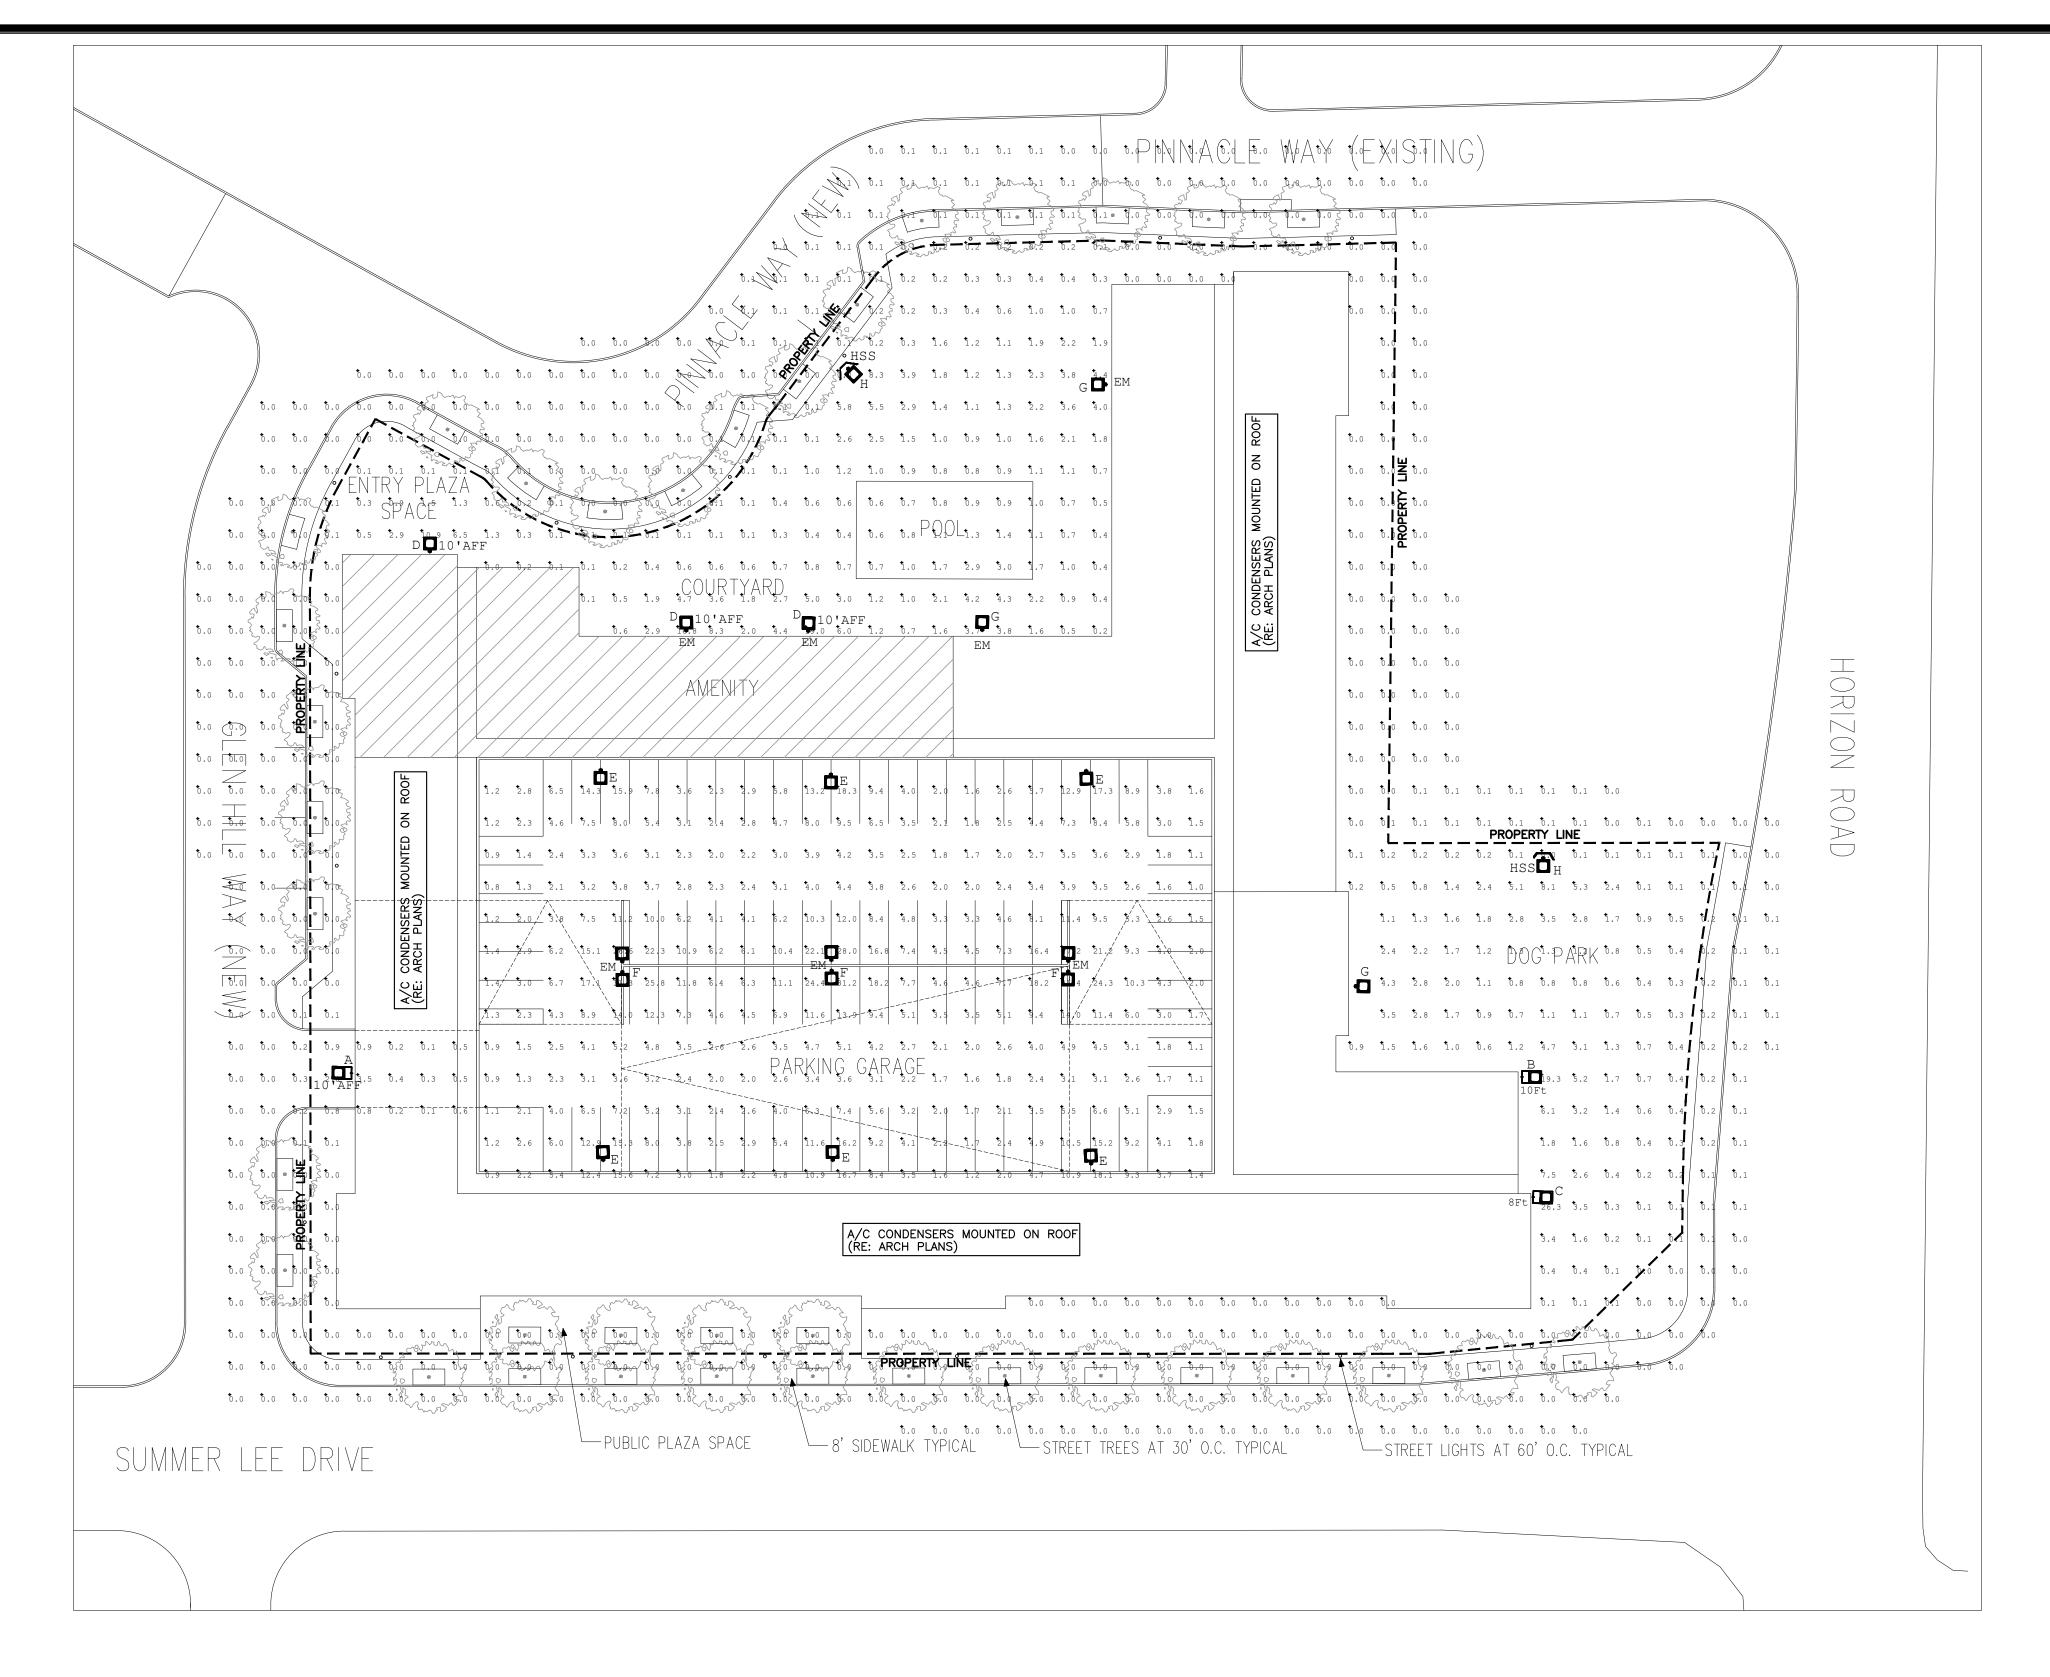
SHEET NUMBER AND TITLE:

4.1 TREESCAPE

PLAN

CASE NUMBER:

PLANNING AND ZONING CHAIRMAN SIGNATURE:



Luminaire Schedule								
Symbol	Qty	Label	Arrangement	LLF	Luminaire Lumens	Luminaire Watts	Total Watts	Fixture Height
• A	1	WPCP-LED10	Single	1.000	1150	11.6	11.6	10'
• 10 B	1	MWPCL-LED80-10FT	Single	1.000	8996	87.2	87.2	10'
• 10 C	1	MWPCL-LED50-8FT	Single	0.993	4867	45.3	45.3	8'
D D	3	MWPCL-LED50	Single	0.993	4867	45.3	135.9	10'
- □ E	6	PSLM-LED150-IV	Single	1.000	17972	147.37	884.22	15'
□ ⊸□ F	3	PSLM-LED150-III	Back-Back	1.000	17786	147.41	884.46	15'
₽ G	3	MWPCL-LED80	Single	1.000	8996	87.2	261.6	20'
- □ H	2	PSLS-LED70-IV	Single	1.000	9450	72.3	144.6	15'

HSS - HOUSE SIDE SHIELD EM - 90 MINUTE INVERTER BACKUP


PHOTOMETRIC STUDY

SITE PLAN



8100 WASHINGTON AVE, SUITE 250 HOUSTON, TX. 77007 PHONE: 713-552-1777 TOMMY@SDC-MEP.COM TEXAS ENGINEERING FIRM #21385

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DESIGN BALANCE, INC. 2231 RIDGE ROAD, STE 200 ROCKWALL, TEXAS 75087 214.668.2306

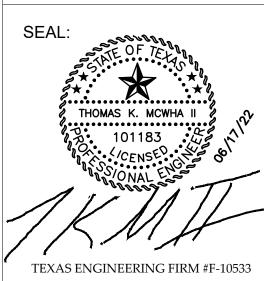OWNER:

RIV PROPERTIES, LLC P.O. BOX 192054 DALLAS, TX 75219 214.908.4684

HARBOR RESIDENCES:

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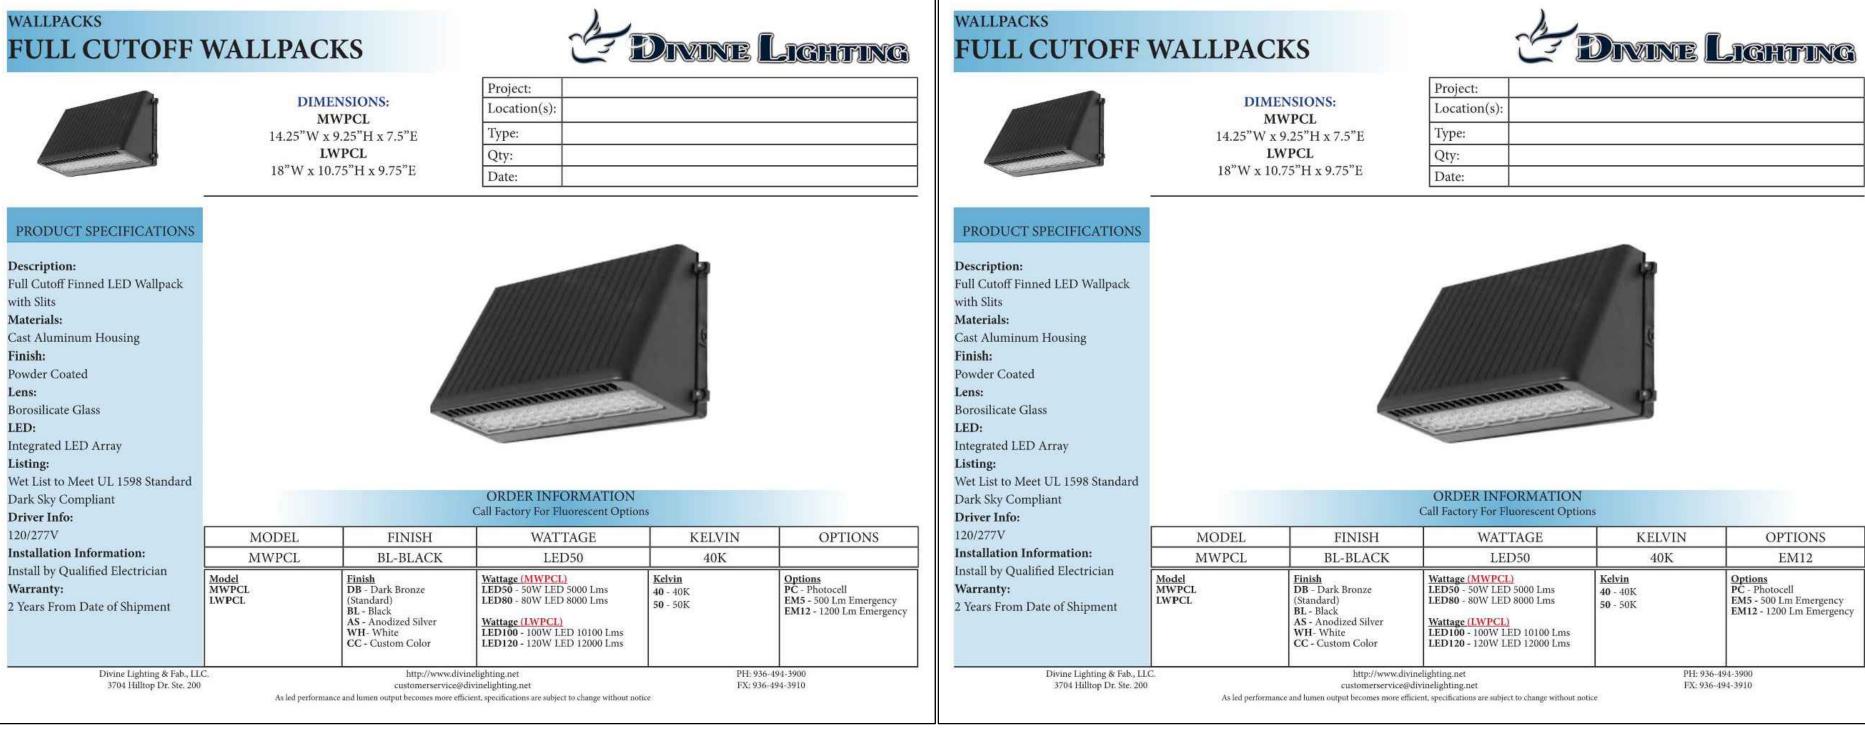
DATE ISSUED:

06/17/2022

5.1a
PHOTOMETRIC &
LIGHTING PLAN

CASE NUMBER:

PLANNING AND ZONING CHAIRMAN SIGNATURE:



WALLPACKS

Description:

with Slits

Materials:

Powder Coated

Borosilicate Glass

Integrated LED Array

Dark Sky Compliant

Installation Information:

Install by Qualified Electrician

2 Years From Date of Shipment

Divine Lighting & Fab., LLC. 3704 Hilltop Dr. Ste. 200

Driver Info:

120/277V

Warranty:

Wet List to Meet UL 1598 Standard

Finish:

Lens:

LED:

Listing:

PRODUCT SPECIFICATIONS

Full Cutoff Finned LED Wallpack

Cast Aluminum Housing

FULL CUTOFF WALLPACKS

DIMENSIONS:

MWPCL

14.25"W x 9.25"H x 7.5"E

LWPCL

18"W x 10.75"H x 9.75"E

MODEL

MWPCL

FINISH

BL-BLACK

http://www.divinelighting.net customerservice@divinelighting.net

As led performance and lumen output becomes more efficient, specifications are subject to change without notice

Finish DB - Dark Bronze

BL - Black AS - Anodized Silver

CC - Custom Color

Location(s)

ORDER INFORMATION

Call Factory For Fluorescent Options

WATTAGE

LED80

Wattage (MWPCL) LED50 - 50W LED 5000 Lms

LED80 - 80W LED 8000 Lms

Wattage (LWPCL) LED100 - 100W LED 10100 Lms

LED120 - 120W LED 12000 Lms

KELVIN

50 - 50K

40K

FX: 936-494-3910

Type:

Date:

C DIVINE LIGHTING

KELVIN

40K

FX: 936-494-3910

OPTIONS

Options
PC - Photocell
EM5 - 500 Lm Emergency

EM12 - 1200 Lm Emergeno

WALLPACKS

PRODUCT SPECIFICATION:

Full Cutoff Finned LED Wallpack

Cast Aluminum Housing

with Slits

Materials:

LED:

Listing:

Driver Info:

120/277V

Warranty:

Powder Coated

Borosilicate Glass

Integrated LED Array

Dark Sky Compliant

Installation Information:

Install by Qualified Electrician

2 Years From Date of Shipment

Divine Lighting & Fab., LLC. 3704 Hilltop Dr. Ste. 200

Wet List to Meet UL 1598 Standard

FULL CUTOFF WALLPACKS

DIMENSIONS:

MWPCL

14.25"W x 9.25"H x 7.5"E

LWPCL

18"W x 10.75"H x 9.75"E

MODEL

MWPCL

Model MWPCL

FINISH

BL-BLACK

http://www.divinelighting.net customerservice@divinelighting.net

As led performance and lumen output becomes more efficient, specifications are subject to change without notice

Finish DB - Dark Bronze

(Standard)
BL - Black
AS - Anodized Silver

CC - Custom Color

Location(s):

ORDER INFORMATION

Call Factory For Fluorescent Options

WATTAGE

LED80

LED80 - 80W LED 8000 Lms


Wattage (LWPCL) LED100 - 100W LED 10100 Lms

LED120 - 120W LED 12000 Lms

Date:



LIGHTING SPECIFICATIONS

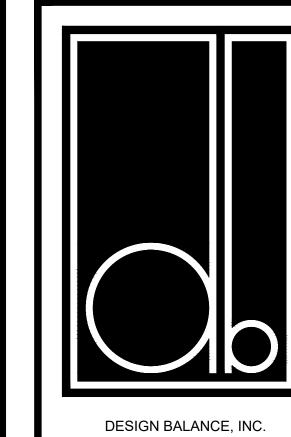

Engineers, LLC MEP CONSULTANTS

8100 WASHINGTON AVE, SUITE 250 HOUSTON, TX. 77007 PHONE: 713-552-1777 TOMMY@SDC-MEP.COM TEXAS ENGINEERING FIRM #21385

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THOMAS K. MCWHA II

TEXAS ENGINEERING FIRM #F-10533

SEAL:

2231 RIDGE ROAD, STE 200 ROCKWALL, TEXAS 75087 214.668.2306

OWNER:

RIV PROPERTIES, LLC P.O. BOX 192054 DALLAS, TX 75219 214.908.4684

HARBOR RESIDENCES:

PORTION OF THE MOTON ADDITION, CITY OF ROCKWALL ROCKWALL COUNTY, TEXAS, SITUATED WITHIN THE HILLSIDE MIXED USE SUBDISTRICT AND THE HORIZON/SUMMER LEE SUBDISTRICT OF PLANNED **DEVELOPMENT DISTRICT 32** (PD-32), GENERALLY LOCATED AT THE SOUTHWEST CORNER OF THE INTERSECTION OF HORIZON ROAD AND SUMMER LEE DRIVE

DATE ISSUED:

06/17/2022

SHEET NUMBER AND TITLE: 5.1b PHOTOMETRIC & LIGHTING PLAN

CASE NUMBER:

PLANNING AND ZONING CHAIRMAN SIGNATURE:



EDIMINE LIGHTING

SITE LIGHTING

PSLS / PSLL

PRODUCT SPECIFICATION:

Flat Top Site Light with Low to High

Heat-Resistant Clear Polycarbonate

Wet List to Meet UL1598 Standard

MODEL

PSLS

Die Cast Aluminum Housing

Output

LED:

Listing:

IP65 Rated

Driver Info:

120/277V

Materials:

Powder Coated

Integrated LED Array

Installation Information:

Install by Qualified Electrician

2 Years From Date of Shipment

Divine Lighting & Mfg., LLC

DIMENSIONS:

PSLS 3.5"H x 13"W x 17.5"E (No Arm)

5.6"W x 13"W x 25.2"E (Staright Arm)

PSLL 3.5"H x 13"W x 21.1"E (No Arm)

5.6"W x 13"W x 28.8"E (Staright Arm)

FINISH

BL-BLACK

Finish DB - Dark Bronze

BL - Black AS - Anodized Silver WH- White

CC - Custom Color

Location(s):

Call Factory For Fluorescent Options

KELVIN TYPE

IV

| Type | III - Type III | PC - Photocell | MOT - Motion | DIMO-10 - 0-10V | TRUN - Trunnio

40K

OPTIONS

DIM0-10 - 0-10V Dimmable TRUN - Trunnion Mount

MA - Mouting Arm SF - Slip Fitter EM5 - Emergency Backup500 Lms

EM12 - Emergency Backup 1200Lms

LSF - Large Slip Fitter

FX: 936-494-3910

WATTAGE

150LED


Wattage (PSLL) LED220 - 220W LED 30200-31000 lms LED310 - 310W LED 36800-38400 lms

customerservice@divinelighting.net

As led performance and lumen output becomes more efficient, specifications are subject to change without notice

| Wattage (PSLS) | LED70 - 70W LED 9300-10000 lms | LED100 - 100W LED 12300-13500 lms | LED150 - 150W LED 17700-18500 lms | LED180 - 180W LED 20600-12500 lms | LED180 - 180W LED 20600-12500 lms

Qty:

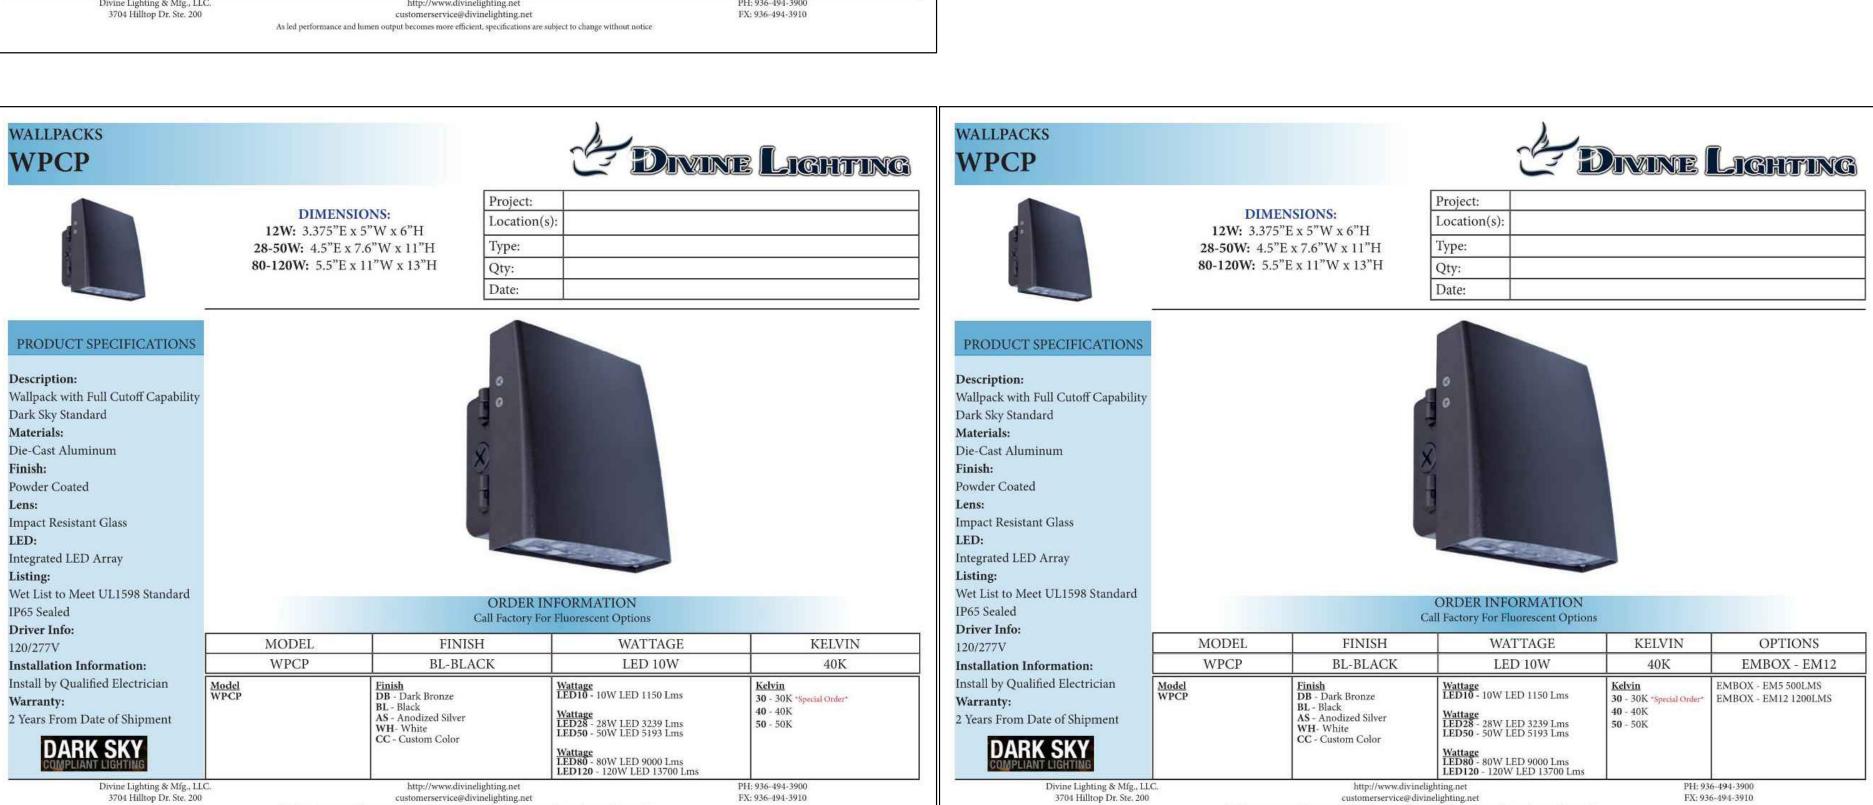

FX: 936-494-3910

customerservice@divinelighting.net


As led performance and lumen output becomes more efficient, specifications are subject to change without notice

LIGHTING SPECIFICATIONS (CONTINUED)

FX: 936-494-3910

customerservice@divinelighting.net

As led performance and lumen output becomes more efficient, specifications are subject to change without notice

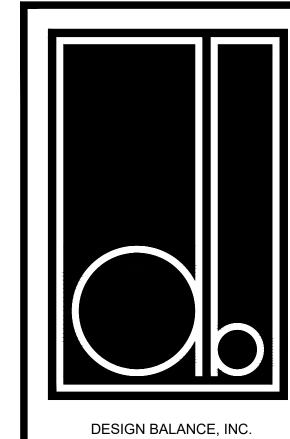

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THOMAS K. MCWHA II

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DATE ISSUED:

06/17/2022

SHEET NUMBER AND TITLE: 5.1c PHOTOMETRIC & LIGHTING PLAN

CASE NUMBER:

PLANNING AND ZONING CHAIRMAN SIGNATURE:

From: <u>John Womble</u>

To: <u>Miller, Ryan</u>; <u>Lee, Henry</u>

 Cc:
 Gabriela Blake; Brad Boswell; Asher Hamilton

 Subject:
 RE: Case SP2022-035_due date for drawings

 Date:
 Wednesday, July 27, 2022 4:40:12 PM

Attachments: <u>image002.jpg</u>

image003.jpg image004.png image005.png image006.png image007.jpg

Ryan,

Based on our conversation last night, please withdraw our case. We will resubmit once we are ready to proceed.

John Womble, AIA

Design Balance, Inc

 $\underline{\mathsf{designbalance}.\mathsf{com}}$

214.668.2306

From: Miller, Ryan < RMiller@rockwall.com>

Sent: Tuesday, July 26, 2022 4:06 PM

To: John Womble <john@designbalance.com>; Lee, Henry <HLee@rockwall.com>

Cc: Gabriela Blake <gabriela@designbalance.com>; Brad Boswell

<bboswell@realtyinvestments.com>; Asher Hamilton <ahamilton@realtyinvestments.com>

Subject: RE: Case SP2022-035_due date for drawings

John ... You are going to have to withdraw since this pushes you out past the 60-day mark. We can talk more about it tonight. Thanks.

Ryan C. Miller, AICP

DIRECTOR OF PLANNING & ZONING • PLANNING & ZONING DIVISION • CITY OF ROCKWALL 972.772.6441 OFFICE

RMILLER@ROCKWALL.COM

385 S. GOLIAD STREET • ROCKWALL, TX 75087

helpful links | <u>City of Rockwall Website</u> | <u>Planning & Zoning Division Website</u> | <u>Municipal Code Website</u> | <u>GIS Division Website</u> | <u>City of Rockwall Interactive Maps</u> | <u>UNIFIED DEVELOPMENT CODE</u>

NOTES

1) <u>APPOINTED AND ELECTED OFFICIALS</u>: BY <u>REPLYING ALL</u> TO THIS EMAIL YOU MAY BE IN VIOLATION OF THE TEXAS OPEN MEETINGS ACT. PLEASE REPLY ONLY TO THE SENDER.

2) PLEASE NOTE THAT ANY CORRESPONDENCE SENT TO CITY STAFF MAY BECOME PUBLIC RECORD

From: John Womble < john@designbalance.com >

Sent: Tuesday, July 26, 2022 1:55 PM

To: Lee, Henry < <u>HLee@rockwall.com</u>>; Miller, Ryan < <u>RMiller@rockwall.com</u>>

Cc: Gabriela Blake <<u>gabriela@designbalance.com</u>>; Brad Boswell

<bboswell@realtyinvestments.com>; Asher Hamilton ahamilton@realtyinvestments.com>

Subject: RE: Case SP2022-035_due date for drawings

Ryan / Lee:

My client is in the process of having the current design priced, so we will a little more time. We want to be sure what is presented to the City matches the budget. Please move our case to the September work session agenda and let us know when the resubmittal will be due.

John Womble, AIA **Design Balance, Inc**<u>designbalance.com</u>

214.668.2306

From: Lee, Henry < HLee@rockwall.com > Sent: Tuesday, July 26, 2022 10:49 AM

To: Gabriela Blake <<u>gabriela@designbalance.com</u>> **Cc:** John Womble <<u>john@designbalance.com</u>>

Subject: RE: Case SP2022-035_due date for drawings

Good Morning,

I would need corrected plans by 3:00PM on the 2^{nd} . That being said if they are done sooner you can send them over. Let me know if you have any other questions.

Thank you,



From: Gabriela Blake <gabriela@designbalance.com>

Sent: Monday, July 25, 2022 10:55 AM **To:** Lee, Henry < <u>HLee@rockwall.com</u>>

Cc: John Womble < <u>john@designbalance.com</u>> **Subject:** Case SP2022-035_due date for drawings

Good morning Henry,

By when do we need to resubmit our drawings in order to be in the August 9th agenda?



Gabriela Blake

Design Balance, Inc 915.861.2247 gabriela@designbalance.com www.designbalance.com

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