




City of Rockwall

Planning & Zoning Department 385 S. Goliad Street Rockwall, Texas 75032 (P): (972) 771-7745 (W): www.rockwall.com The City of Rockwall GIS maps are continually under development and therefore subject to change without notice. While we endeavor to provide timely and accurate information, we make no guarantees. The City of Rockwall makes no warranty, express or implied, including warranties of merchantability and fitness for a particular purpose. Use of the information is the sole responsibility of the user.

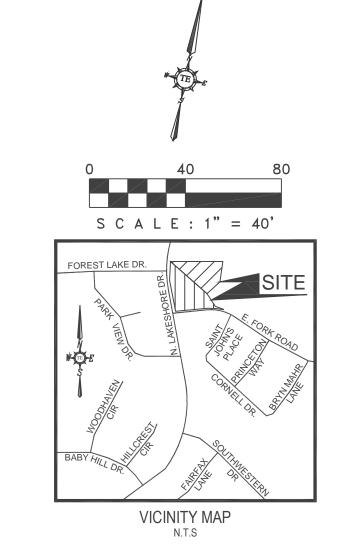



LEGEND

PROPERTY LINE -W--- EXISTING WATER LANE — W — PROPOSED WATER LINE ____s <u>fx 10° s.s.</u> s _____ s ____ EX.SANITARY SEWER LINE PROP. 8" S.S. S — PROP, SANITARY SEWER LINE PROPOSED STORM SEWER

PROPOSED FIRE HYDRANT ∞F.D.C. PROPOSED FIRE CONNECTION PROPOSED WATER METERS PROPOSED BACK FLOW PREVENTER PEDESTERIAN SIGNT &

P.S.&V.E.

S.S.E.

D.E.

V.E.

-**⊹**- FH Τ_{W. ∨.}

UTILITY EASEMENT

VISIBILITY EASEMENT

SANITARY SEWER EASEMENT DRAINAGE EASEMENT FIRE LANE, PUBLIC ACCESS

PROPOSED FIRE LANE

F.A.W.E. & WATER EASEMENT VISIBILITY EASEMENT

B.S. FRONT SET BACK LANDSCAPE SET BACK BARRIER FREE RAMP

> EXISTING STORM SEWER EXISTING PAVEMENT/CURB

EXISTING SEWER MANHOLE PROPOSED HANDICAP PARKING SPACE EXISTING POWER POLE

> EXISTING STORM INLETS EXISTING FIRE HYDRANT EXISTING WATER VALVE PROPOSED BOLLARDS PROPOSED CAR STACKING

PROP.6' HIGH WROUGHT IRON FENCE EXISTING TREE TRANSFORMER

FIRE LANE, PUBLIC ACCESS & F.A.U.E. UTILITY EASEMENT 0 0 GREASE TRAP

SAMPLING WELL SINGLE CLEAN OUT • C.O. ∞ C.O. DOUBLE CLEAN OUT MONUMENT/POLE SIGN PROPOSED WHEEL STOP PROPOSED HANDICAP SIGN

GENERAL NOTES

1. ALL CONSTRUCTION SHALL BE IN STRICT ACCORDANCE WITH THE STANDARDS OF THE CITY OF ROCKWALL.

2. A PERMIT IS REQUIRED TO CUT A CITY STREET OR WORK WITHIN THE RIGHT-OF-WAY. THE PERMIT IS ISSUED BY THE PUBLIC WORKS DEPARTMENT.

3. THE LOCATION OF UNDERGROUND UTILITIES INDICATED ON THE PLANS IS TAKEN FROM PUBLIC RECORDS. IT IS THE CONTRACTOR'S RESPONSIBILITY TO MAKE ARRANGEMENTS WITH THE OWNERS OF SUCH UNDERGROUND UTILITIES PRIOR TO WORKING IN THE AREA TO CONFIRM THEIR EXACT LOCATION AND TO DETERMINE WHETHER ANY ADDITIONAL UTILITIES OTHER THAN THOSE SHOWN ON THE PLANS MAY BE PRESENT. THE CONTRACTOR SHALL PRESERVE AND PROTECT ALL UNDERGROUND UTILITIES. IF EXISTING UNDERGROUND UTILITIES ARE DAMAGED, THE CONTRACTOR WILL BE RESPONSIBLE FOR THE COST OF REPAIRING THE

4. WHERE EXISTING UTILITIES OR SERVICE LINES ARE CUT, BROKEN OR DAMAGED, THE CONTRACTOR SHALL REPLACE OR REPAIR THE UTILITIES OR SERVICE LINES WITH THE SAME TYPE OF ORIGINAL MATERIAL AND CONSTRUCTION, OR BETTER, UNLESS OTHERWISE SHOWN OR NOTED ON THE PLANS, AT HIS OWN COST AND EXPENSE. THE CONTRACTOR SHALL IMMEDIATELY NOTIFY THE ENGINEER AT ONCE OF ANY CONFLICTS IN GRADES AND ALIGNMENT.

5. ALL EXCAVATIONS, TRENCHING AND SHORING OPERATIONS SHALL COMPLY WITH THE REQUIREMENTS OF THE U. S. DEPARTMENT OF LABOR, OSHA, "CONST. SAFETY AND HEALTH REGULATIONS.", VOL. 29, SUBPART P. PG. 128 -137, AND ANY AMENDMENTS THERETO.


6. ADEQUATE MEASURES SHALL BE TAKEN TO PREVENT EROSION. IN THE EVENT THAT SIGNIFICANT EROSION OCCURS AS A RESULT OF CONSTRUCTION THE CONTRACTOR SHALL RESTORE THE ERODED AREA TO ORIGINAL CONDITION OR BETTER.

7. THE CONTRACTOR SHALL RESTORE ALL AREAS DISTURBED BY CONSTRUCTION TO ORIGINAL CONDITION OR BETTER. RESTORED AREAS INCLUDE, BUT ARE NOT LIMITED TO TRENCH BACKFILL, SIDE SLOPES, FENCES, CULVERT PIPES, DRAINAGE DITCHES, DRIVEWAYS, PRIVATE YARDS AND ROADWAYS.

8. ANY CHANGES NEEDED AFTER CONSTRUCTION PLANS HAVE BEEN RELEASED, SHALL BE APPROVED BY THE CITY ENGINEER. THESE CHANGES MUST BE RECEIVED IN WRITING FROM THE FROM THE DESIGN ENGINEER. THE DIRECTOR OF PUBLIC WORKS SHALL APPROVE ANY DEVIATIONS FROM STATE REGULATIONS.

9. THE CONTRACTOR SHALL PROVIDE "RED LINED" MARKED PRINTS TO THE ENGINEER PRIOR TO FINAL INSPECTION INDICATING ALL CONSTRUCTION WHICH DEVIATED FROM THE PLANS OR WAS CONSTRUCTED IN ADDITION TO THAT INDICATED ON THE PLANS.

BOUNDARY LINE DATA				
LINE NO.	BEARING	DISTANCE		
L1	S 78°34'14" W	102.41'		
L2	N 11°25'13" W	201.02'		
L3	N 01°10'03" W	31.12'		
L4	N 58°45'59" W	50.79'		
L5	S 89°38'31" E	471.62'		
L6	S 13°21'59" W	186.68'		
L7	S 44°51'38" W	145.74'		
L8	S 43°32'33" E	88.95'		
L9	S 56°56'31" E	43.84'		

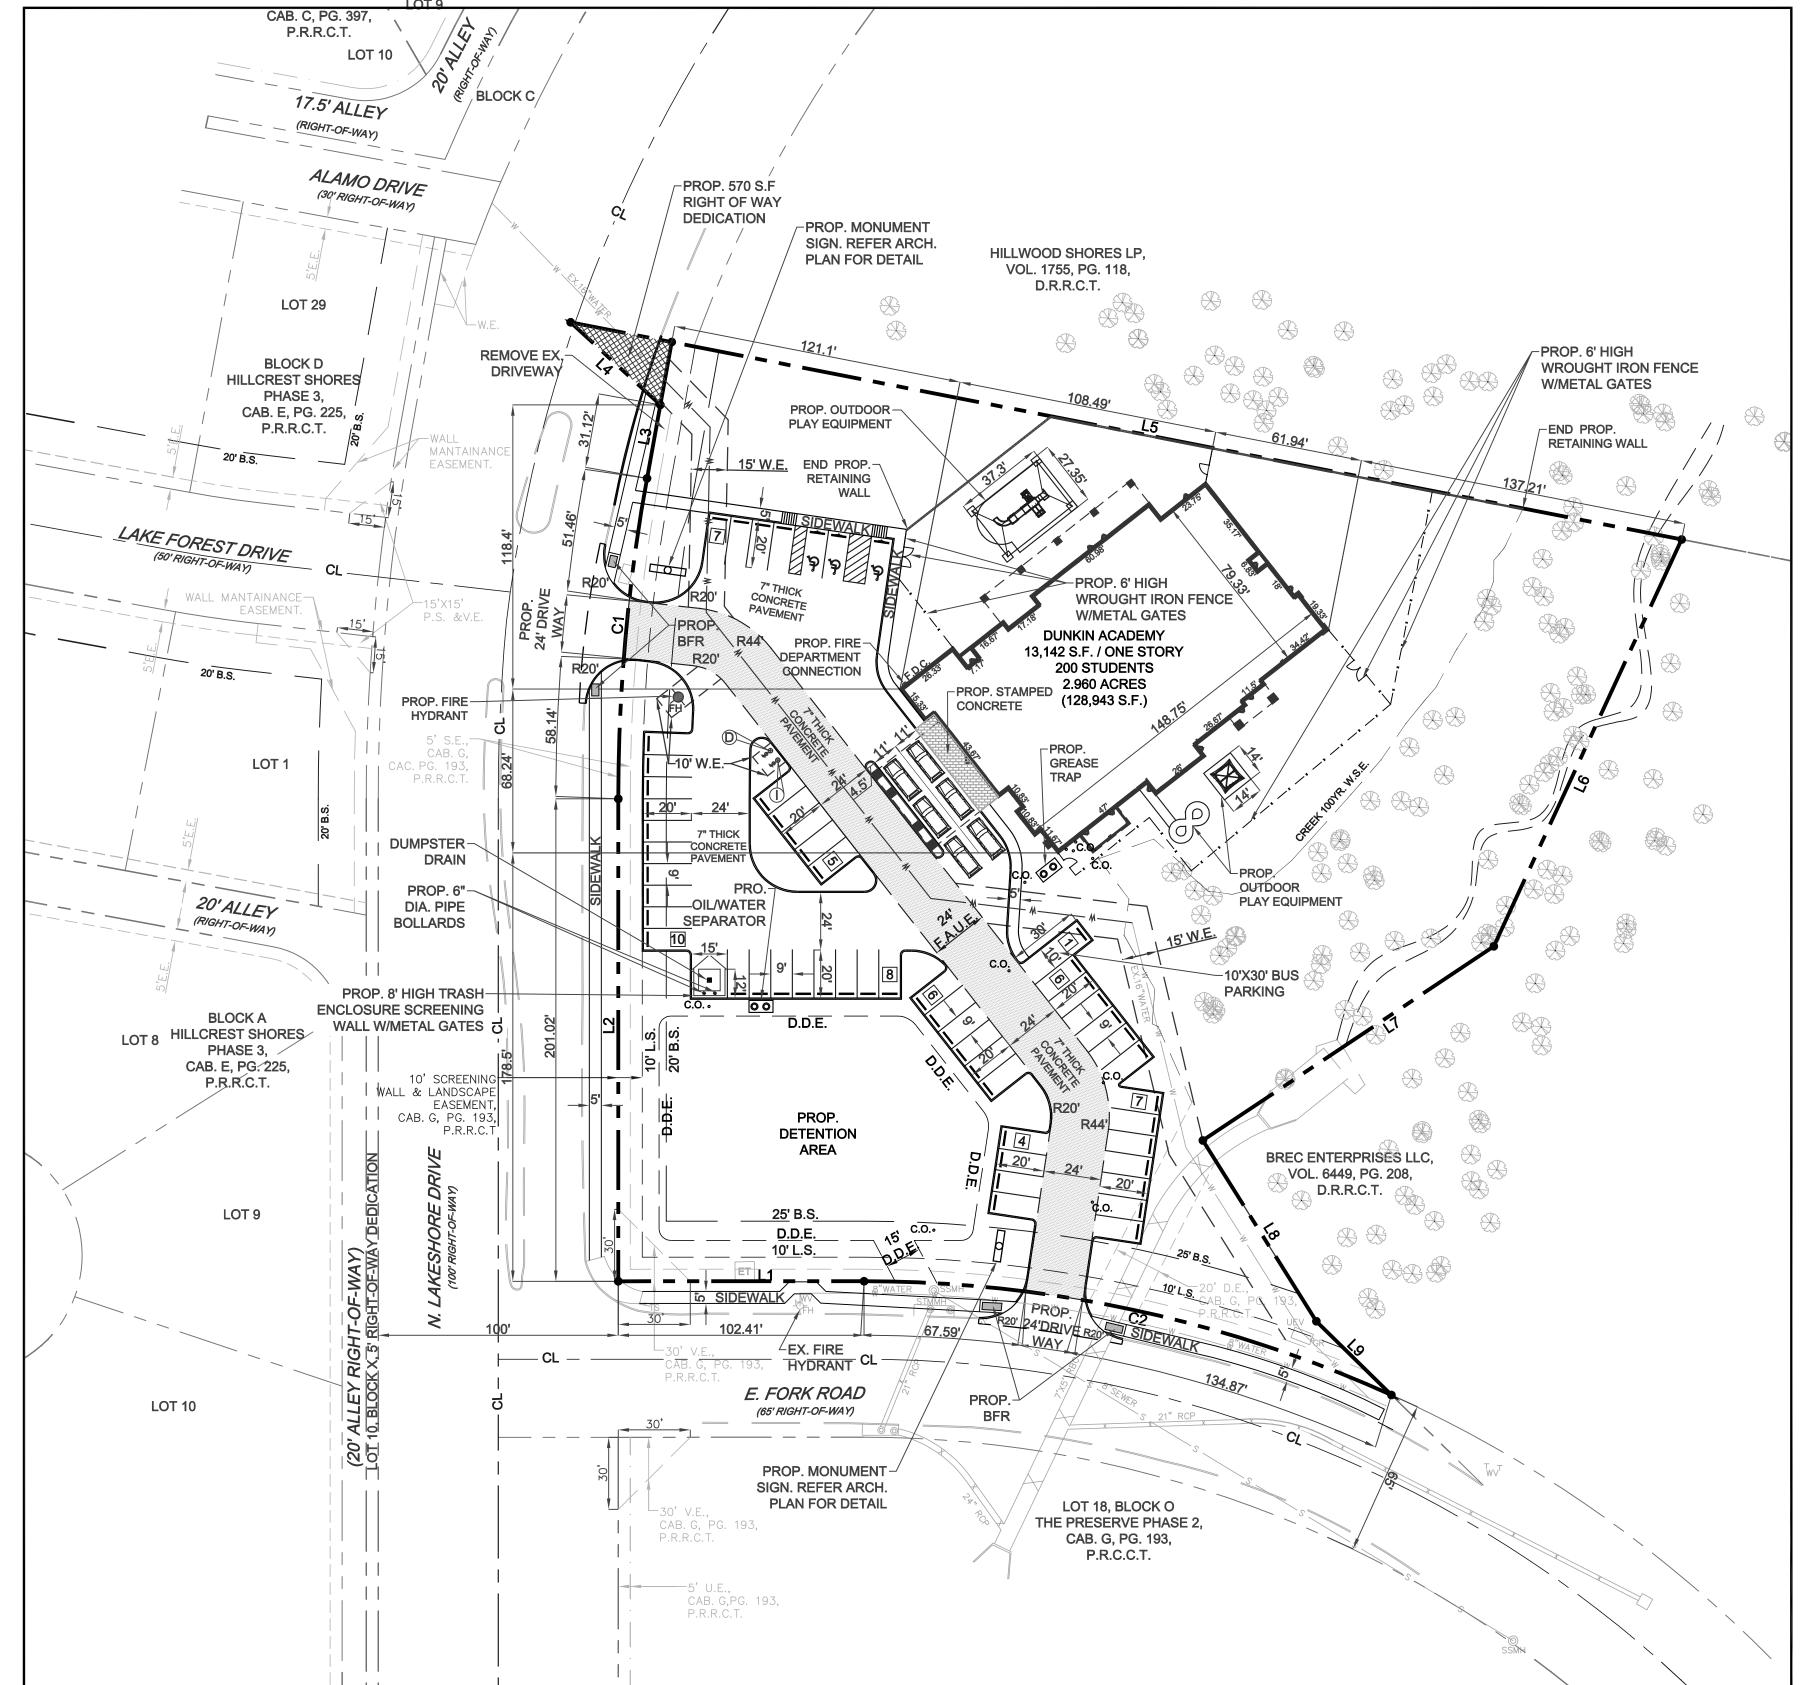

LEGEND	
UTILITY EASEMENT	U.E.
SANITARY SEWER EASEMNET	S.S.E.
DRAINAGE EASEMENT	D.E.
WATERLINE EASEMENT	W.E.
VISIBILITY EASEMENT	V.E.
SIDEWALK EASEMENT	S.E.
ELECTRICAL EASEMENT	E.E.
CLEAN OUT	C.O.
GAS METER	GM
ELECTRICAL VAULT	EV
LIGHT POLE	LP
TRAFFIC SIGN	TS
ELECTRICAL TRANSFORMER	ET
FIRE HYDRANT	FH
SANITARY SEWER MANHOLE	SSMH
STORM SEWER MANHOLE	STMMH
BUILDING SET BACK	B.S.
LANDSCAPE BUFFER	L.B.
PRESSURE REDUCING VALVE	PRV
FIRE DEPARTMENT CONNECTION	F.D.C.
PEDESTERIAN SIGHT &	P.S.&V.E.
VISIBILITYESAEMENT	
BARRIER FREE RAMP	BFR

0.== = . 0			
SITE DATA SUI	MMARY TA	BLE	
PHYSICAL ADDRESS	TO BE DETE	RMINED	
GROSS SITE AREA	2.960 ACRES	(128,943 S.F.)	
NET AREA	2.960 ACRES	(128,943 S.F.)	
ZONING	PD-41		
CURRENT USE	VACANT		
PROPOSED USE	DAYCARE		
LOT COVE	RAGE DATA		
BUILDING COVERAGE	13,142 S.F. (1	0.19%)	
IMPERVIOUS COVERAGE	82,111 S.F. (63.68%)		
PERVIOUS COVERAGE	46,832 S.F. (36.32%)		
PARKING	SUMMERY		
PARKING REQUIREMENT	REQUIRED	PROVIDED	
1 SPACE PER 300 GFA	44	54	
TOTAL PARKING	44	54	
BUILDI	NG DATA		
BUILDING	1		
PEAK HEIGHT	29'-0"		
TOTAL SQUARE FOOTAGE	13,142 S.F.		

DETENTION NOTE

1. ONSITE DETENTION WILL BE PROVIDED.

WATER METER & SANITARY SEWER SCHEDULE							
ID	TYPE	SIZE	NO.	SAN. SEW.			
D	DOM.	2"	1	6"			
	IRR.	1"	1	N/A			

CASE # SP2017-.....

REDESIGNED SITE PLAN **DUNKIN ACADEMY** NEC OF N. LAKESHORE DRIVE & E. FORK ROAD CITY OF ROCKWALL ROCKWALL COUNTY, TEXAS



T: 214.609.92711 F: 469.359.6709 | E: kpatel@triangle-engr.com W: triangle-engr.com | O: 1333 McDermott Drive, Suite 200, Allen, TX 75013

"White	Plann	Vanagement				
	DESIGN	DRAWN	DATE	SCALE	PROJECT NO.	SHEET NO.
	KP	DS	08/23/16	SEE SCALE BAR	028-16	C
		J				

KARTAVYA S. PATEL

97534

CURVE DATA TABLE							
NO.	LENGTH	RADIUS	DELTA	CH BEARING	CH LENGTH		
C1	134.21'	750.00'	10°15'10"	N 06°17'38" W	134.03'		
C2	226.46'	532.50'	24°21'59"	N 89°14'47" W	224.76		

OWNER/DEVELOPER DUNKIN ACADEMY ROCKWALL LLC 320 N TOWN EAST BLVD SUNNYVALE, TEXAS 75182 CONTACT:JOHN DUNKIN	TRIA 1333 M
CONTACT:JOHN DUNKIN TEL: (469) 358-5590	CON
1 LL. (409) 330-3390	

10. DATE

09/16/16

10/04/16

11/09/16

4 | 04/14/17

DESCRIPTION

REDESIGNED SITE PLAN SUBMITTAL


1st ENGINEERING SUBMITTAL


1st CITY SUBMITTAL

2nd CITY SUBMITTAL

DUNKIN ACADEMY SITE DE ELOPMENT

2. □6 □ ACRES OF LAND □EIN□ A REPLAT OF LOT 1, □LOCK S OF THE PRESER□E PHASE □, AN ADDITION TO THE CITY OF ROCKWALL, ROCKWALL COUNTY, TEXAS

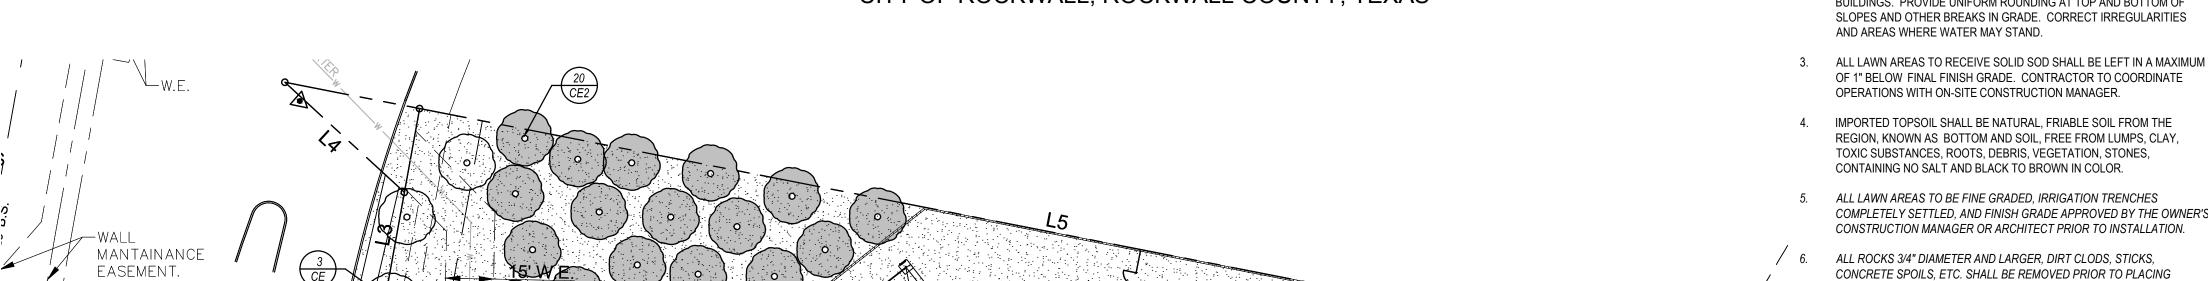

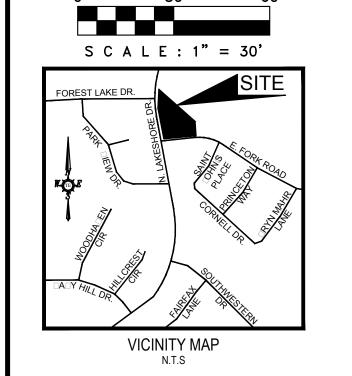

15' VISIBILITY

TURF AREAS

□OUNDARY LINE DATA

DISTANCE

1□2.□1□

□1.12□

5 🗆 🗆 🗆 🗆

1□6.6□□

1 □5. □□□

□□.□5□

□□1.62□

2□1.□2□

INE NO.

□EARIN□

N 78°34'14" W

N 01°10'03" W

N 58°45'59" W

S 13°21'59" W

S 44°51'38" W

S 43°32'33" E

S 56°56'31" E

L2 N 11°25'13" W

L5 | S 89°38'31" E

15' VISIBILITY TRIANGLE-

P.S. &V.E. SOLID SOD BERMUDA GRASS TYPICAL FOR ALL

CAB. G,

CAC. PG. 193,

WATER METER SANITARY SEWER SCHEDULE							
ID	TYPE	SI□E	NO.	SAN. SEW.			
D	DOM.	1"	1	6"			

LANDSCAPE TABULATIONS:

SITE REQUIREMENTS 12,000 0.00 Rooman acceptance

 $Pr \Box d \Box d$ $R \square \square r \square d$

FRONT YARD RE UIREMENTS

RPr□□d□d _,6______**5**___ **1**__,_____

STREET RE□UIREMENTS Rooma all d'ara d'all ar 5 ... alland

N LAKESHORE DRI□E Ⅲ66.□5 L.F.□

 $R \square \square r \square d$ $Pr \square d \square d$

E FORK ROAD 112 11 11 11

 $Pr \square \square d \square d$

 $R \square \square r \square d$

PARKINO LOT 50 000000

Pr□□d□d

TREE MITI ATION □□□5" □□□□r r□□□

10' SCREENING-WALL & LANDSCAPE EASEMENT, CAB. G, PG. 193, P.R.R.C.T DETENTION AREA SOLID SOD BERMUDA GRASS TYPICAL FOR ALL TURF AREAS BREC ENTERPRISES LLC, VOL. 6449, PG. 208, D.R.R.C.T. SOLID SOD BERMUDA GRASS TYPICAL FOR ALL-TURF AREAS NO TREES TO BE REMOVED −30' V.E., PAST THIS LINE CAB. G, PG. 193, P.R.R.C.T. E. FORK ROAD (65' RIGHT-OF-WAY)

SHRUBS PLANTED ADJACENT

TO PARKING TO BE PLANTED 4' FROM BACK OF CURB. TYPICAL

CUR E DATA TA LE 1 🗆 21 🗎 | 🗅 5 🗆 🗆 🗆 | 10°15'10" | N 06°17'38" W C2 | 226. □6 □ | 5 □2.5 □□ | 24°21'59" | N 89°14'47" W |

COOPER GENERAL CONTRACTORS 2560 TECHNOLOGY DRIVE SUITE 100 PLANO, TEXAS 75074 CONTACT DOU ALLOWAY

TRIAN LE EN INEERIN LLC □ M DERMOTT ROAD STE 2 □ ALLEN, TEXAS □5□1□ CONTACT KARTA YA PATEL TEL 21 6 0 12 1

A□W SUR□EYORS INC. P.O. □OX □□□□2□ MES□UITE, TEXAS □515□ CONTACT OHN TURNER, R.P.L.S.

RAY WOOD ARCHITECTS □6□6 PARK SPRIN□S □L□D. SUITE 11 ARLIN□ON,TEXAS □6□1□ CONTACTⅢRAY WOOD

SOLID SOD BERMUDA

GRASS TYPICAL FOR ALL TURF AREAS

> DESCRIPTION NO. DATE 1 04/03/17 CITY SUBMITTAL

LANDSCAPE NOTES

- 1. CONTRACTOR SHALL VERIFY ALL EXISTING AND PROPOSED SITE ELEMENTS AND NOTIFY ARCHITECT OF ANY DISCREPANCIES. SURVEY DATA OF EXISTING CONDITIONS WAS SUPPLIED BY OTHERS
- CONTRACTOR SHALL LOCATE ALL EXISTING UNDERGROUND UTILITIES AND NOTIFY ARCHITECT OF ANY CONFLICTS. CONTRACTOR SHALL EXERCISE CAUTION WHEN WORKING IN THE
- CONTRACTOR IS RESPONSIBLE FOR OBTAINING ALL REQUIRED LANDSCAPE AND IRRIGATION PERMITS.

VICINITY OF UNDERGROUND UTILITIES.

- 4. CONTRACTOR TO PROVIDE A MINIMUM 2% SLOPE AWAY FROM ALL STRUCTURES.
- 5. ALL PLANTING BEDS AND LAWN AREAS TO BE SEPARATED BY STEE EDGING. NO STEEL TO BE INSTALLED ADJACENT TO SIDEWALKS OR
- 6. ALL LANDSCAPE AREAS TO BE 100% IRRIGATED WITH AN UNDERGROUND AUTOMATIC IRRIGATION SYSTEM AND SHALL INCLUDE RAIN AND FREEZE SENSORS.
- 7. ALL LAWN AREAS TO BE SOLID SOD BERMUDAGRASS, UNLESS OTHERWISE NOTED ON THE DRAWINGS.

SOLID SOD NOTES

GENERAL LAWN NOTES

- FINE GRADE AREAS TO ACHIEVE FINAL CONTOURS INDICATED.
- ADJUST CONTOURS TO ACHIEVE POSITIVE DRAINAGE AWAY FROM BUILDINGS. PROVIDE UNIFORM ROUNDING AT TOP AND BOTTOM OF SLOPES AND OTHER BREAKS IN GRADE. CORRECT
- ALL LAWN AREAS TO RECEIVE SOLID SOD SHALL BE LEFT IN A MAXIMUM OF 1" BELOW FINAL FINISH GRADE. CONTRACTOR TO COORDINATE OPERATIONS WITH ON-SITE CONSTRUCTION
- CONTRACTOR TO COORDINATE WITH ON-SITE CONSTRUCTION
- PLANT SOD BY HAND TO COVER INDICATED AREA COMPLETELY
- 6. ROLL GRASS AREAS TO ACHIEVE A SMOOTH, EVEN SURFACE, FREE
- 7. WATER SOD THOROUGHLY AS SOD OPERATION PROGRESSES.
- ACCEPTANCE. THIS SHALL INCLUDE, BUT NOT LIMITED TO: MOWING, WATERING, WEEDING, CULTIVATING, CLEANING AND REPLACING DEAD OR BARE AREAS TO KEEP PLANTS IN A VIGOROUS, HEALTHY CONDITION.

CONTRACTOR SHALL PROVIDE (1") ONE INCH OF IMPORTED TOPSOIL ON

ALL AREAS TO RECEIVE LAWN.

TOPSOIL AND ANY LAWN INSTALLATION

LEAVE AREAS TO RECEIVE TOPSOIL 3" BELOW FINAL DESIRED GRADE IN PLANTING AREAS AND 1" BELOW FINAL GRADE IN TURF

FINE GRADE AREAS TO ACHIEVE FINAL CONTOURS INDICATED ON CIVIL

ADJUST CONTOURS TO ACHIEVE POSITIVE DRAINAGE AWAY FROM

AND AREAS WHERE WATER MAY STAND.

BUILDINGS. PROVIDE UNIFORM ROUNDING AT TOP AND BOTTOM OF SLOPES AND OTHER BREAKS IN GRADE. CORRECT IRREGULARITIES

OF 1" BELOW FINAL FINISH GRADE. CONTRACTOR TO COORDINATE

REGION, KNOWN AS BOTTOM AND SOIL, FREE FROM LUMPS, CLAY, TOXIC SUBSTANCES, ROOTS, DEBRIS, VEGETATION, STONES,

COMPLETELY SETTLED, AND FINISH GRADE APPROVED BY THE OWNER'S

CONSTRUCTION MANAGER OR ARCHITECT PRIOR TO INSTALLATION.

ALL ROCKS 3/4" DIAMETER AND LARGER, DIRT CLODS, STICKS,

CONCRETE SPOILS, ETC. SHALL BE REMOVED PRIOR TO PLACING

OPERATIONS WITH ON-SITE CONSTRUCTION MANAGER.

CONTAINING NO SALT AND BLACK TO BROWN IN COLOR.

- IRREGULARITIES AND AREAS WHERE WATER MAY STAND.
- MANAGER FOR AVAILABILITY OF EXISTING TOPSOIL.
- INSURE EDGES OF SOD ARE TOUCHING. TOP DRESS JOINTS BY HAND WITH TOPSOIL TO FILL VOIDS.
- FROM UNNATURAL UNDULATIONS.
- CONTRACTOR SHALL MAINTAIN ALL LAWN AREAS UNTIL FINAL
- CONTRACTOR SHALL GUARANTEE ESTABLISHMENT OF AN ACCEPTABLE TURF AREA AND SHALL PROVIDE REPLACEMENT FROM LOCAL SUPPLY IF NECESSARY.
- 10. IF INSTALLATION OCCURS BETWEEN SEPTEMBER 1 AND MARCH 1. ALL SOD AREAS TO BE OVER-SEEDED WITH WINTER RYEGRASS, AT A RATE OF (4) POUNDS PER ONE THOUSAND (1000) SQUARE FEET.

PLANT MATERIAL SCHEDULE

TREES					
TYPE	□TY	COMMON NAME	BOTANICAL NAME	SI□E	REMARKS
□C	21		Taxodium distichum	5" □□.	000, 1600., 000rood 0 M., 0000r Good
CE		C d E	Ulmus crassifolia	□" □□□	000, 1000, 500rod 0 m, 5000r m
CE2	2□	C d r E	Ulmus crassifolia	5" □□.	000, 1600, 000rod 0 00, 0000r 0000
CM	5	Cr C M Cr	Lagerstroemia indica	6□□.	
LO	16	LIIIO	Quercus virginiana	□" □□□.	, 1, 6r, 5
SHRUBS		1			
TYPE	□TY.	COMMON NAME	BOTANICAL NAME	SI□E	REMARKS
DYH		Dor You Hou	llex vomitoria 'nana'		, 2_"rod
IH	12		Rhaphiolepis indica 'clara'		r, 1c" cc., 1c" ccrccd
NPH	216	NodmondHom	llex cornuta "Needlepoint'	5 🗆	, 2_", 2_"r_d
GROUNI	DCOVERS				
TYPE	□TY	COMMON NAME	BOTANICAL NAME	SI□E	REMARKS
SC	25	S			
WC	55□	Poro Woordroom	Eunoymus fortunei 'Colortus'		,15" rr_, 12"
			Cynodon dactylon '419'		
NOTE	P				omom acd aracdo ara a mm ac a. Amana

SP-2016----

L.




ALL TREES TO BE LOCATED A MINIMUM OF 5' FROM PUBLIC UTILITIES. ALL SHRUBS ADJACENT FROM HEAD IN PARKING SHALL BE PLANTED 4' FROM BACK OF CURB

IRRIGATION IS REQUIRED PER THE UDC

LANDSCAPE PLAN **DUNKIN ACADEMY** NEC OF N. LAKESHORE DRIVE & E. FORK ROAD CITY OF ROCKWALL ROCKWALL COUNTY, TEXAS



-	Plann	ning	<i>M</i> anagement			
	DESIGN	DRAWN	DATE	SCALE	PROJECT NO.	SHEET NO.
	KP	DS	_ _			
			L. ∠			

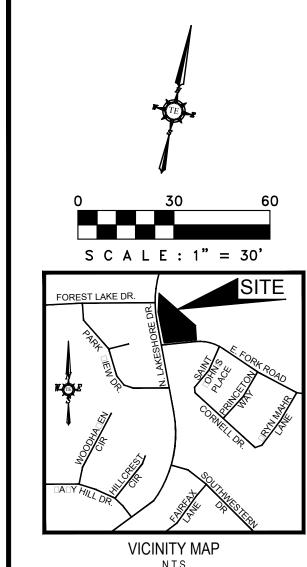

EXISTING TREE NOTES

- Existing trees to remain shall be protected during construction from tree structure damage and compaction of soil under and around dripline (canopy)
- . If any root structure is damaged during adjacent excavation/construction, notify the Architect immediately. It is recommended that a licensed Arborist be secured for the treatment of any possible tree wounds.
- . No disturbance of the soil greater than 4" shall be located closer to the tree trunk than 1/2 the distance of the drip line to the tree trunk. A minimum of 75% of the drip line and root zone shall be preserved at natural grade.
- Any fine grading done within the critical root zones of the protected trees must be done with light machinery such as a bobcat or light tractor. No earth moving equipment with tracks is allowed within the critical root zone of the
- Material Storage: No materials intended for use in construction or waste materials accumulated due to excavation or demolition shall be placed within the limits of the dripline of any tree.
- Equipment Cleaning/Liquid Disposal: No equipment may be cleaned, toxic solutions, or other liquid chemicals shall be deposited within the limits of the dripline of a tree. This would include but not be limited to paint, oil, solvents, asphalt, concrete, mortar, primers, etc.
- 7. Tree Attachments: No signs, wires or other attachments, other than those of a protective nature shall be attached to any tree.

Vehicular Traffic: No vehicular and construction equipment traffic or parking is

- allowed within the limits of the dripline of trees. 9. Boring of Utilities: May be permitted under protected trees in certain circumstances. The minimum length of the bore shall be the width of the
- tree's canopy and shall be a minimum depth of forty-eight (48") inches. 10. Trenching: Any irrigation trenching which must be done within the critical root
- zone of a tree shall be dug by hand and enter the area in a radial manner. 11. Tree Flagging: All trees to be removed from the site shall be flagged by the
- Contractor with bright red vinyl tape (3" width) wrapped around the main trunk at a height of four (4') feet above grade. Flagging shall be approved by Landscape Architect prior to any tree removal. Contractor shall contact Landscape Architect with 72 hour notice to schedule on-site meeting.

12. Protective Fencing: All trees to remain, as noted on drawings, shall have

- protective fencing located at the tree's dripline. The protective fencing may be comprised of snow fencing, orange vinyl construction fencing, chain link fence or other similar fencing with a four (4') foot approximate height. The protective fencing will be located as indicated on the Tree Protection Detail(s).
- 13. Bark Protection: In situations where a tree remains in the immediate area of intended construction, the tree shall be protected by enclosing the entire circumference of the tree's trunk with lumber encircled with wire or other means that does not damage the tree. Refer to Tree Protection Detail(s).
- 14. Construction Pruning: In a case where a low hanging limb is broken during the course of construction, the Contractor shall notify the Landscape Architect immediately. In no instance shall the Contractor prune any portion of the damaged tree without the prior approval by the Landscape Architect.

	□OUNDARY LINE DATA					
LINE NO.	□EARIN□	DISTANCE				
L1	N 78°34'14" W	1□2.□1□				
L2	N 11°25'13" W	2□1.□2□				
L	N 01°10'03" W	□1.12□				
L	N 58°45'59" W	5 🗆 🗆 🗆 🗆				
L5	S 89°38'31" E	□□1.62□				
L6	S 13°21'59" W	1□6.6□□				
L	S 44°51'38" W	1 🗆 5. 🗆 🗆 🗆				
L	S 43°32'33" E	□□.□5□				
L	S 56°56'31" E					

NO.	DIA. INCHES	SPECIES (COMMON NAME)	REMARKS	MITIGATION REQUIRED	NO.	DIA. INCHES	SPECIES (COMMON NAME)	REMARKS	MITIGATION REQUIRED
101	0	CEDAD	TO BE DEMOVED		151	6	CEDAR	TO DE DEMOVED	
101 102	8 8	CEDAR CEDAR	TO BE REMOVED TO BE REMOVED		151 152	6 7	CEDAR CEDAR	TO BE REMOVED TO BE REMOVED	
103	8	CEDAR	TO BE REMOVED		153	8	CEDAR	TO BE REMOVED	
103	13	CEDAR	PROTECTED- TO BE REMOVED	6.5	154	6	CEDAR	TO BE REMOVED	
105	7	CEDAR	TO BE REMOVED	0.0	155	6	CEDAR ELM	PROTECTED- TO BE REMOVED	6
106	6	CEDAR	TO BE REMOVED		156	6	TEXAS ASH	PROTECTED- TO BE REMOVED	-
107	6	CEDAR	TO BE REMOVED		157	6	TEXAS ASH	PROTECTED- TO BE REMOVED	-
108	7	CEDAR	TO BE REMOVED		158	8	TEXAS ASH	PROTECTED- TO BE REMOVED	_
109	6	CEDAR	TO BE REMOVED		159	7	CEDAR ELM	PROTECTED- TO BE REMOVED	
110	7	CEDAR	TO BE REMOVED		160	6	CEDAR ELM	PROTECTED- TO BE REMOVED	
111	6	CEDAR	TO BE REMOVED		161	6	CEDAR ELM	PROTECTED- TO BE REMOVED	
112	6	CEDAR	TO BE REMOVED		162	12	CEDAR ELM	PROTECTED- TO BE REMOVED	12
113	8	CEDAR	TO BE REMOVED		163	8	AMERICAN ELM	PROTECTED- TO BE REMOVED	8
114	6	CEDAR	TO BE REMOVED		164	10	AMERICAN ELM	PROTECTED- TO BE REMOVED	10
115	7	CEDAR	TO BE REMOVED		165	11	CEDAR	PROTECTED- TO BE REMOVED	5.5
116	6	CEDAR	TO BE REMOVED		166	9	CEDAR	TO BE REMOVED	
117	12	CEDAR	PROTECTED- TO BE REMOVED	6	167	10	HACKBERRY	TO BE REMOVED	
118	10	CEDAR	TO BE REMOVED		168	31	AMERICAN ELM	PROTECTED- TO BE REMOVED	62
119	6	CEDAR ELM	TO BE REMOVED		169	6	CEDAR ELM	PROTECTED- TO BE REMOVED	6
120	7	CEDAR	TO BE REMOVED		170	8	CEDAR ELM	PROTECTED- TO BE REMOVED	8
121	6	HACKBERRY	TO BE REMOVED		171	13	CEDAR ELM	PROTECTED- TO BE REMOVED	13
122	7	CEDAR	TO BE REMOVED		172	8	CEDAR ELM	PROTECTED- TO BE REMOVED	8
123	8	CEDAR	TO BE REMOVED		173	13	CEDAR ELM	PROTECTED- TO BE REMOVED	13
124	8	CEDAR	TO BE REMOVED		174	8	HACKBERRY	TO REMAIN	
125	8	CEDAR	TO BE REMOVED		175	7	HACKBERRY	TO REMAIN	
126	8	CEDAR	TO BE REMOVED		176	8	HACKBERRY	TO BE REMOVED	
127	7	HACKBERRY	TO BE REMOVED		177	14	CEDAR ELM	PROTECTED- TO BE REMOVED	14
128	9	HACKBERRY	TO BE REMOVED		178	9	CEDAR ELM	TO REMAIN	4.4
129	8	CEDAR	TO BE REMOVED		179	14	CEDAR ELM	PROTECTED- TO BE REMOVED	14
130	9	CEDAR	TO BE REMOVED		180	8	HACKBERRY	TO REMAIN	
131	6	CEDAR	TO BE REMOVED TO BE REMOVED		181	7	HACKBERRY	TO REMAIN TO REMAIN	
132	8	DEAD			182	8 7	CEDAR ELM		
133	6 10	HACKBERRY HACKBERRY	TO BE REMOVED TO BE REMOVED		183 184	8	CEDAR ELM CEDAR ELM	TO REMAIN TO REMAIN	
134 135	9	HACKBERRY	TO BE REMOVED		185	9	CEDAR ELM	TO REMAIN	
136	10	HACKBERRY	TO BE REMOVED		186	6	CEDAR ELM	TO REMAIN	
137	6	HACKBERRY	TO BE REMOVED		187	7	CEDAR ELM	TO REMAIN	
138	7	CEDAR	TO BE REMOVED		188	7	CEDAR ELM	TO REMAIN	
139	8	CEDAR	TO BE REMOVED		189	8	HACKBERRY	TO REMAIN	
140	7	CEDAR	TO BE REMOVED		190	7	HACKBERRY	TO REMAIN	
141	10	HACKBERRY	TO BE REMOVED		191	7	HACKBERRY	TO REMAIN	
142	7	HACKBERRY	TO BE REMOVED		192	8	HACKBERRY	TO REMAIN	
143	8	CEDAR	TO BE REMOVED		193	6	HACKBERRY	TO REMAIN	
144	7	HACKBERRY	TO BE REMOVED		194	6	HACKBERRY	TO REMAIN	
145	6	CEDAR	TO BE REMOVED		195	9	HACKBERRY	TO REMAIN	
146	6	CEDAR	TO BE REMOVED		196	7	HACKBERRY	TO REMAIN	
147	6	CEDAR	TO BE REMOVED		197	13	AMERICAN ELM	TO REMAIN	
148	6	CEDAR	TO BE REMOVED		198	10	AMERICAN ELM	TO REMAIN	
149	6	CEDAR	TO BE REMOVED		199	12	AMERICAN ELM	TO REMAIN	
150	6	CEDAR	TO BE REMOVED		200	11	CEDAR ELM	TO REMAIN	
NO.	DIA. INCHES	SPECIES (COMMON NAME)	REMARKS	MITIGATION REQUIRED	NO.	DIA. INCHES	SPECIES (COMMON NAME)	REMARKS	MITIGATION REQUIRED
201	7	CEDAR ELM	TO REMAIN		251	10	HACKBERRY	TO REMAIN	
201	8	CEDAR ELM	TO REMAIN		251 252	6	HACKBERRY	TO REMAIN	
203	7	CEDAR ELM	TO REMAIN		253	7	HACKBERRY	TO REMAIN	
204	8	WILLOW	TO REMAIN		254	10	HACKBERRY	TO BE REMOVED	
205	6	WILLOW	TO REMAIN		255	7	CEDAR	TO BE REMOVED	
206	16	AMERICAN ELM	TO REMAIN		256	6	CEDAR	TO BE REMOVED	
207	21	AMERICAN ELM	TO REMAIN		257	7	CEDAR	TO BE REMOVED	
208	12	AMERICAN ELM	TO REMAIN		258	9	CEDAR	TO BE REMOVED	
209	9	AMERICAN ELM	TO REMAIN		259	10	CEDAR	TO BE REMOVED	
210	36	AMERICAN ELM	TO REMAIN		260	6	CEDAR	TO BE REMOVED	
211	24	AMERICAN ELM	TO REMAIN		261	7	CEDAR	TO BE REMOVED	
212	6	TEXAS ASH	TO REMAIN		262	8	CEDAR	TO BE REMOVED	
213	11	TEXAS ASH	TO REMAIN		263	7	CEDAR	TO BE REMOVED	
214	6	TEXAS ASH	TO REMAIN		264	6	CEDAR	TO BE REMOVED	
215	12	AMERICAN ELM	TO REMAIN		265	15	CEDAR	PROTECTED- TO BE REMOVED	7.5
216	7	HACKBERRY	TO REMAIN		266	6	CEDAR	TO BE REMOVED	
217	14	AMERICAN ELM	TO REMAIN		267	7	CEDAR	TO BE REMOVED	
218	12	CEDAR ELM	TO REMAIN		268	6	CEDAR	TO BE REMOVED	

CEDAR

CEDAR CEDAR

CEDAR

CEDAR

CEDAR

CEDAR CEDAR CEDAR

CEDAR

TO BE REMOVED

/ED 6 /ED 8 /ED 7 /ED 6 /ED 6	ANTAINANCE ASEMENT.		103 'W.E.	117-PROTECTED	272 275 277 277 270 270	264 263
/ED 12 /ED 8 /ED 10 /ED 5.5				119 121 100 A	269 269 270	264 263 265 1 262 1 269 260 261 1
/ED 62 /ED 6 /ED 8 /ED 13 /ED 8 /ED 13	X15' 3. &V.E.	5	31	122	147 148 258 258 147 149 150 151 152	257 256 255 1
/ED 14 /ED 14		132		120 127 127 142	4 154 153 145 155 158 157	254
	S.E., AB. G, 193, R.C.T.	1 1 34 34 135 136V.E.			160 161 162 164 163	252
					168 169 170 171	189 190
				2Å J.E. 139		183 182 186 187 188 196 210
MITIGA REQUI	ATION IRED			C.O.	15' W.E193 194 195 200 201	198 208 209 210 199 206 206
	- -	10'L.S. 20'B.S.	D.D.E.		202 203 204	207
/ED 7.5	CREENING ANDSCAPE ASEMENT, PG. 193, P.R.R.C.T	→	PROP. DETENTION	O.D.M.	205	
	F-WAY)		AREA 25' B.S.	D.D.E.	В	REC ENTERPRISES LLC, VOL. 6449, PG. 208, D.R.R.C.T.
	(100' RIGHT-0)	ET		SSMH	25'B.S. 10'L.S. 20' D.E.,	
	TREE CL	30' V.E., CAB. G, PG. 19		STMMH S	10'L.S. 20' D.E., CAB. G, PG. P.R.R.C. J.	93,
	TRUNK	AND REPORTED IN THE PROPERTY OF THE PROPERTY O	E. FORK ROAD		1 8 SEWER -	
	ROOT PROTECTION ZONE (RPZ) TREE CANOPY	ROOT PROTECTION ZONE (RPZ)	EXISTING TREE L			NE
	6" MULCH INSIDE RPZ	NOTE: FENCIN: SHOWN A:O:E IS DIA:RAI	EXISTING TREES TO	BE REMOVED		
	SEE NOTES TREE PROTECTION FENCE	AND WILL CONFORM TO THE DRIP LI TO PRO⊡ECT ⊡OUNDARY	NE AND LIMITED	TE DESCE	RIPTION	

NO. DATE

104- PROTECTED

256 CALIPER INCHES OF TREES REQUIRED TO BE MITIGATED ON SITE.

CEDAR ELM

CEDAR ELM

AMERICAN ELM

CEDAR ELM

CEDAR ELM

CEDAR ELM

HACKBERRY

CEDAR ELM

238

240

249

AMERICAN ELM

HACKBERRY

CEDAR ELM

CEDAR ELM

232 CALIPER INCHES OF TREES TO BE PLANTED ON SITE-REFER TO SHEET L.2 FOR PROPOSED TREE LOCATIONS 24 TREE CREDITS TO BE PAID TO THE CITY OF ROCKWALL TREE REFORESTATION FUND (24 X 125= \$3,000.00)

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PROTECTED- TO BE REMOVED 7

PROTECTED- TO BE REMOVED 10

CUR DATA TA LE						
NO.	LEN□TH			CH DEARIND	CH LEN□TH	
C1	1 🗆 21 🗆	5	10°15'10"	N 06°17'38" W	1	
C2	226.□6□	5□2.5□□	24°21'59"	N 89°14'47" W	22□.□6	

TREE PROTECTION FENCE A

ARCHITECT

RAY WOOD ARCHITECTS TRIAN LE EN INEERIN LLC COOPER GENERAL CONTRACTORS A W SUR EYORS INC. 2560 TECHNOLOGY DRIVE SUITE 100 P.O. _OX ____2_ □6□6 PARK SPRIN□S □L□D. SUITE 11 $\square\square$ M \square DERMOTT ROAD STE 2 \square ALLEN, TEXAS □5□1□ MES□UITE, TEXAS □515□ ARLIN□ON,TEXAS □6□1□ PLANO, TEXAS 75074 CONTACT KARTA YA PATEL CONTACTIDOU | | ALLOWAY CONTACTⅢRAY WOOD CONTACT OHN TURNER, R.P.L.S. TEL 21 6 1121 TEL ::: 16 :: 12 :: 12 : TEL215

DESCRIPTION 1 04/13/17 CITY SUBMITTAL



ROCKWALL COUNTY, TEXAS

EXISTIN TREE PLAN

DUNKIN ACADEMY


NEC OF N. LAKESHORE DRIVE & E. FORK ROAD


CITY OF ROCKWALL

SP2017----

Planning | Civil Engineering | Construction Management DESIGN DRAWN DATE SCALE PROJECT NO. SHEET NO. KP DS 08/23/16 SEE SCALE BAR 028-16

TX PE FIRM #11525

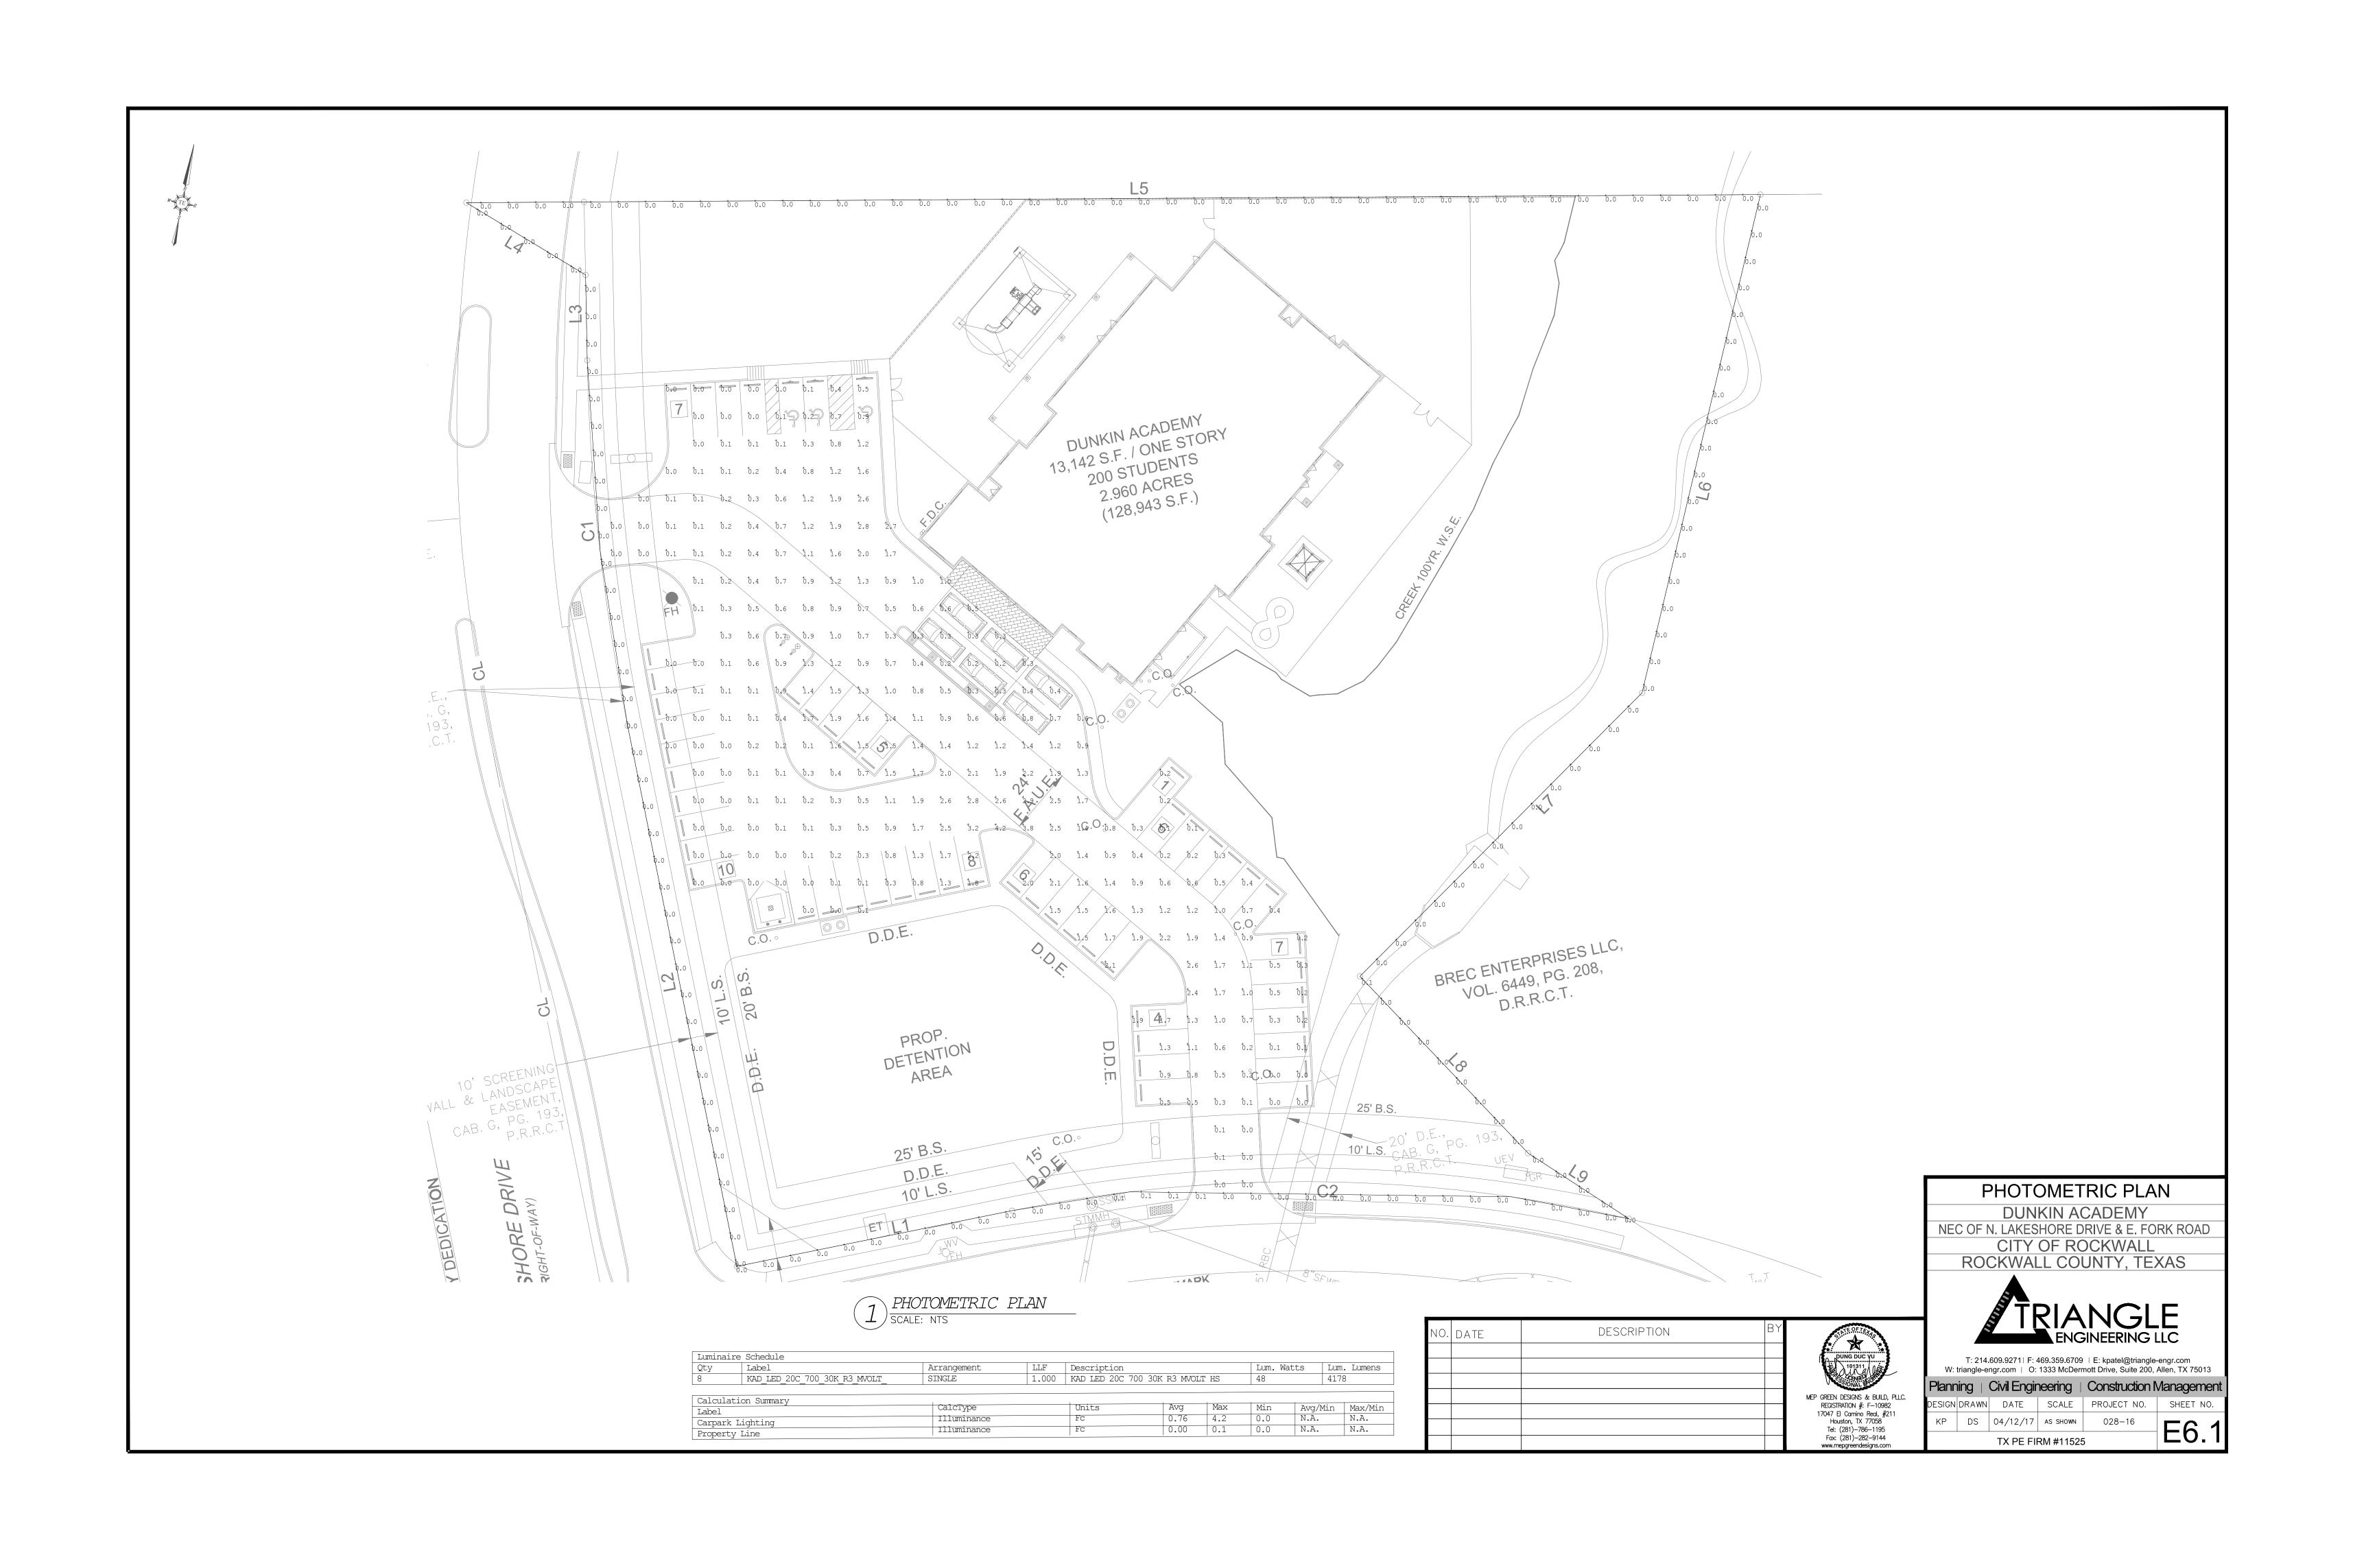

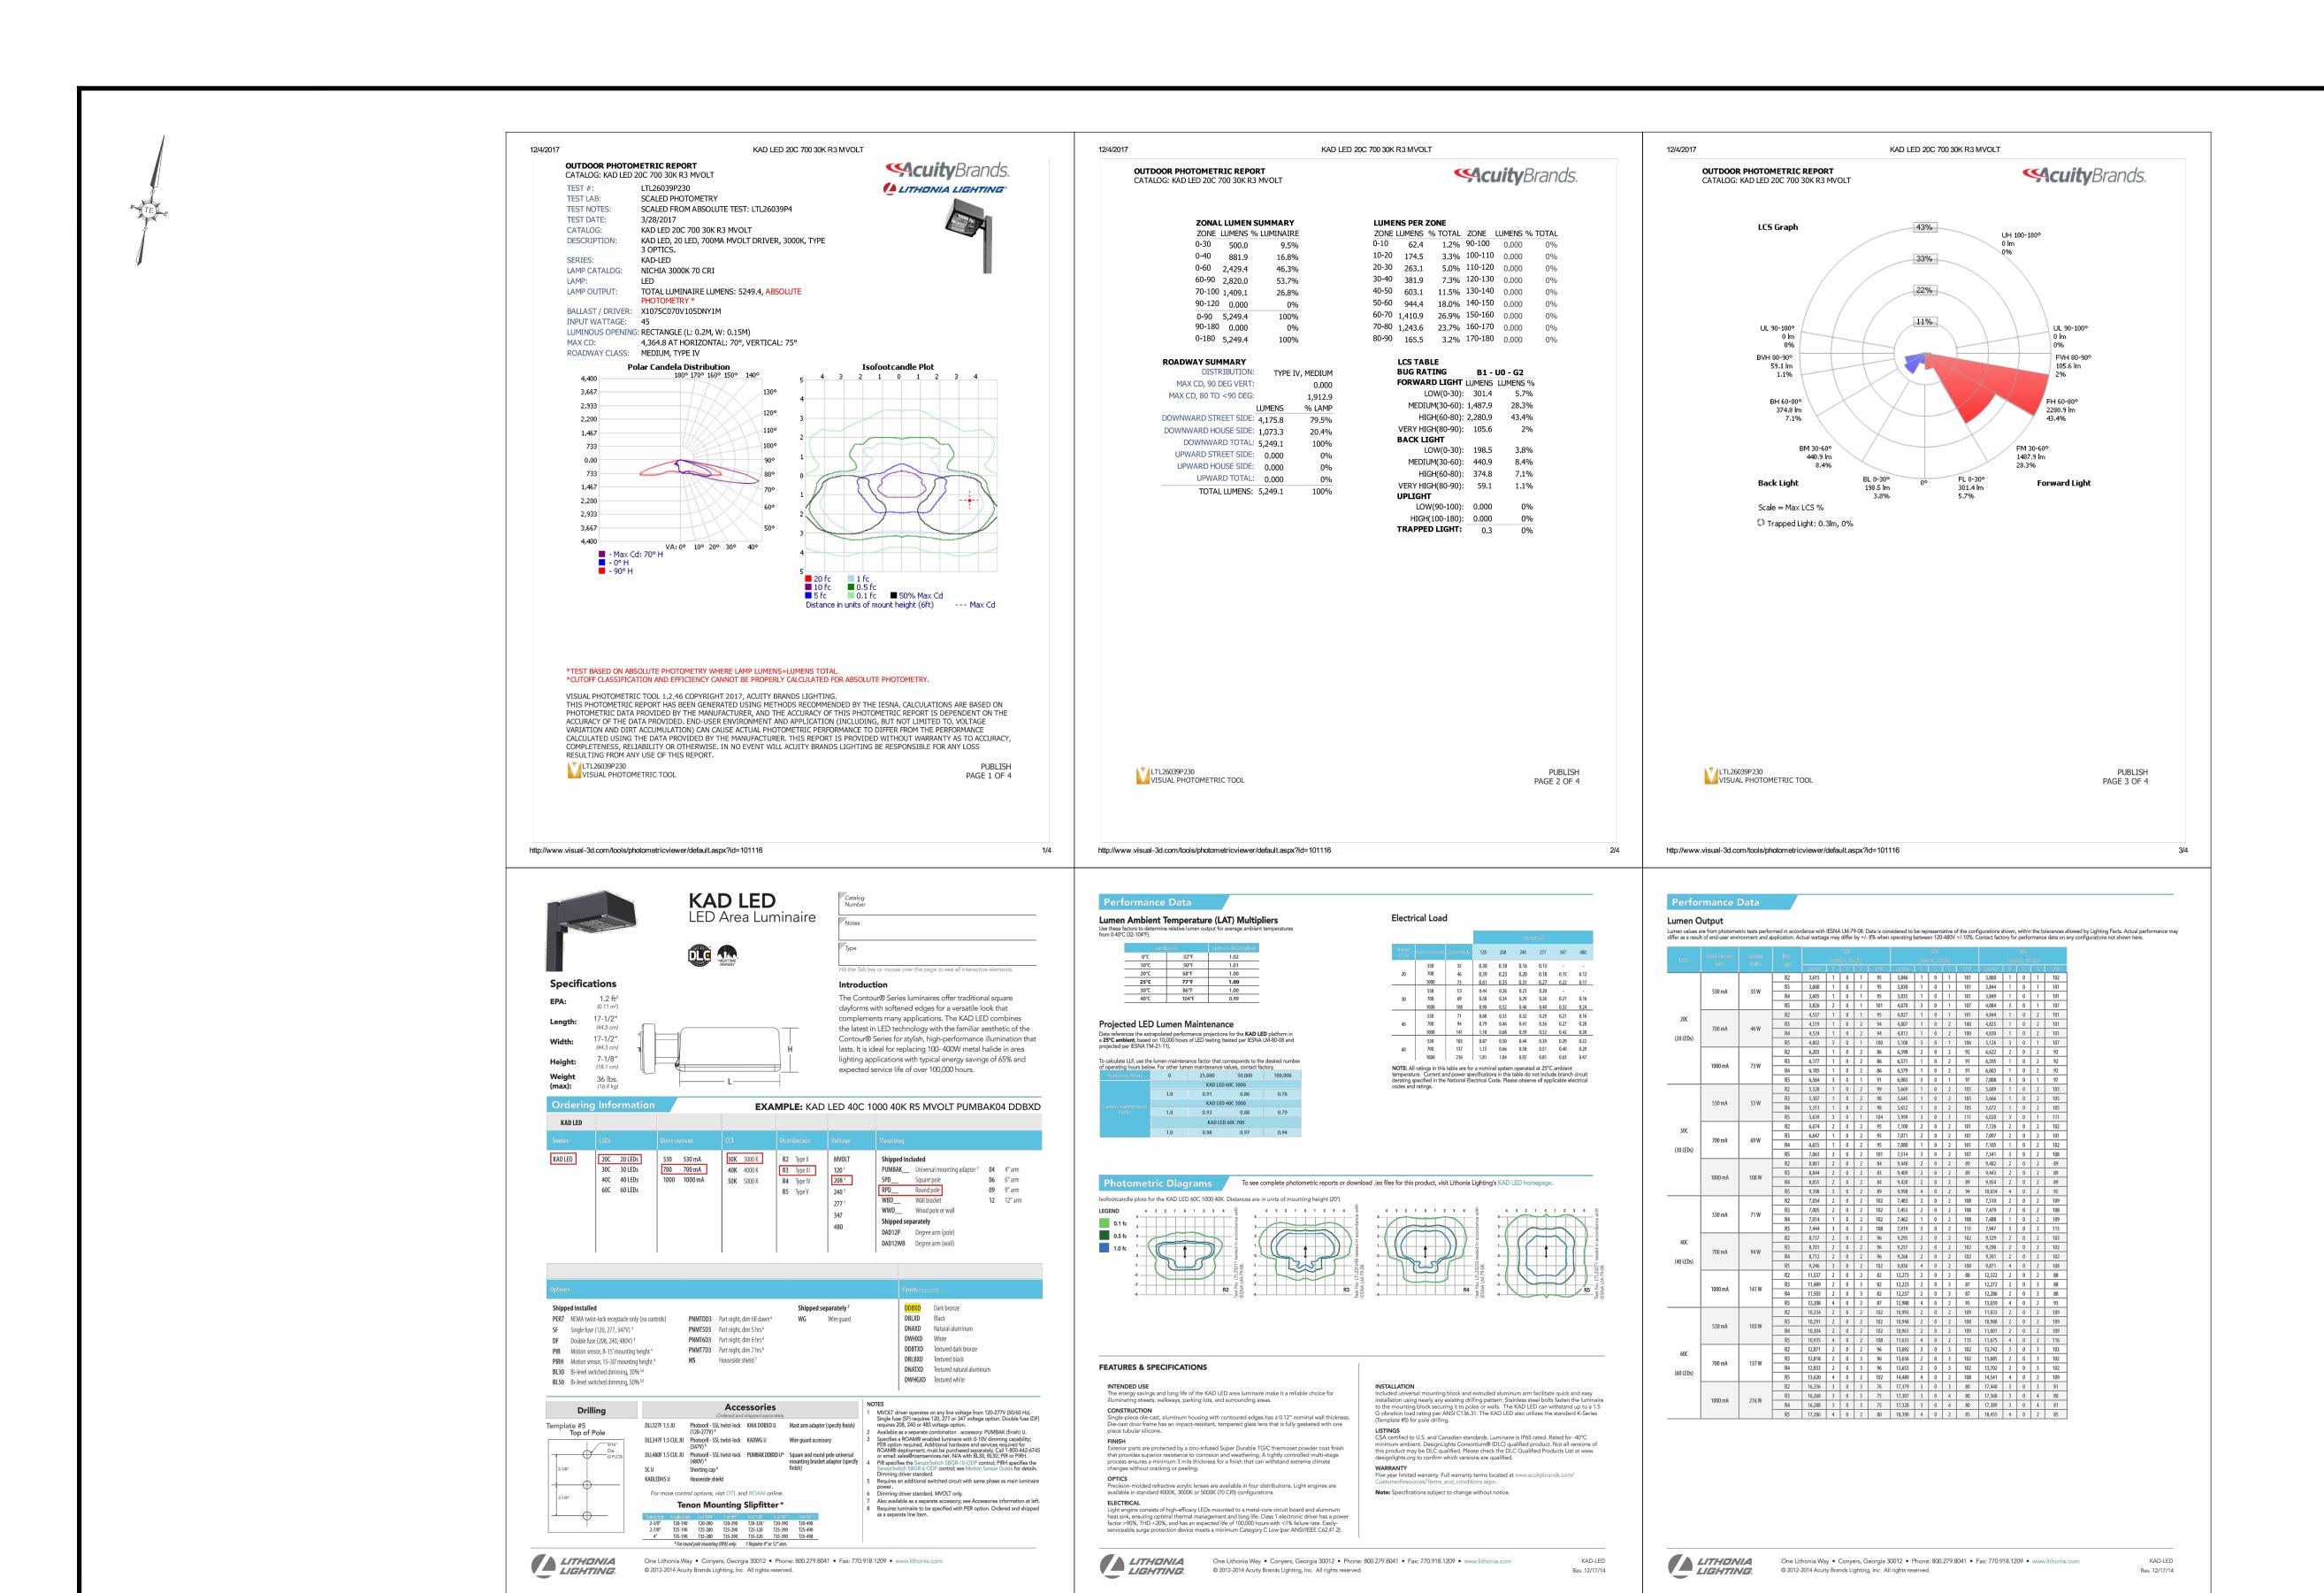

1 LIGHTING CUT SHEETS
SCALE: NTS


BY	DESCRIPTION	DATE	NO.
		1	



PHOTOMETRIC PLAN DUNKIN ACADEMY NEC OF N. LAKESHORE DRIVE & E. FORK ROAD CITY OF ROCKWALL ROCKWALL COUNTY, TEXAS



W. thangle-engl.com O. 1333 McDermott Drive, Suite 200, Allen, 1X 73013						
Plann	Management					
DESIGN	DRAWN	DATE	SCALE	PROJECT NO.	SHEET NO.	
KP	DS	04/12/17	AS SHOWN	028-16	E6.2	

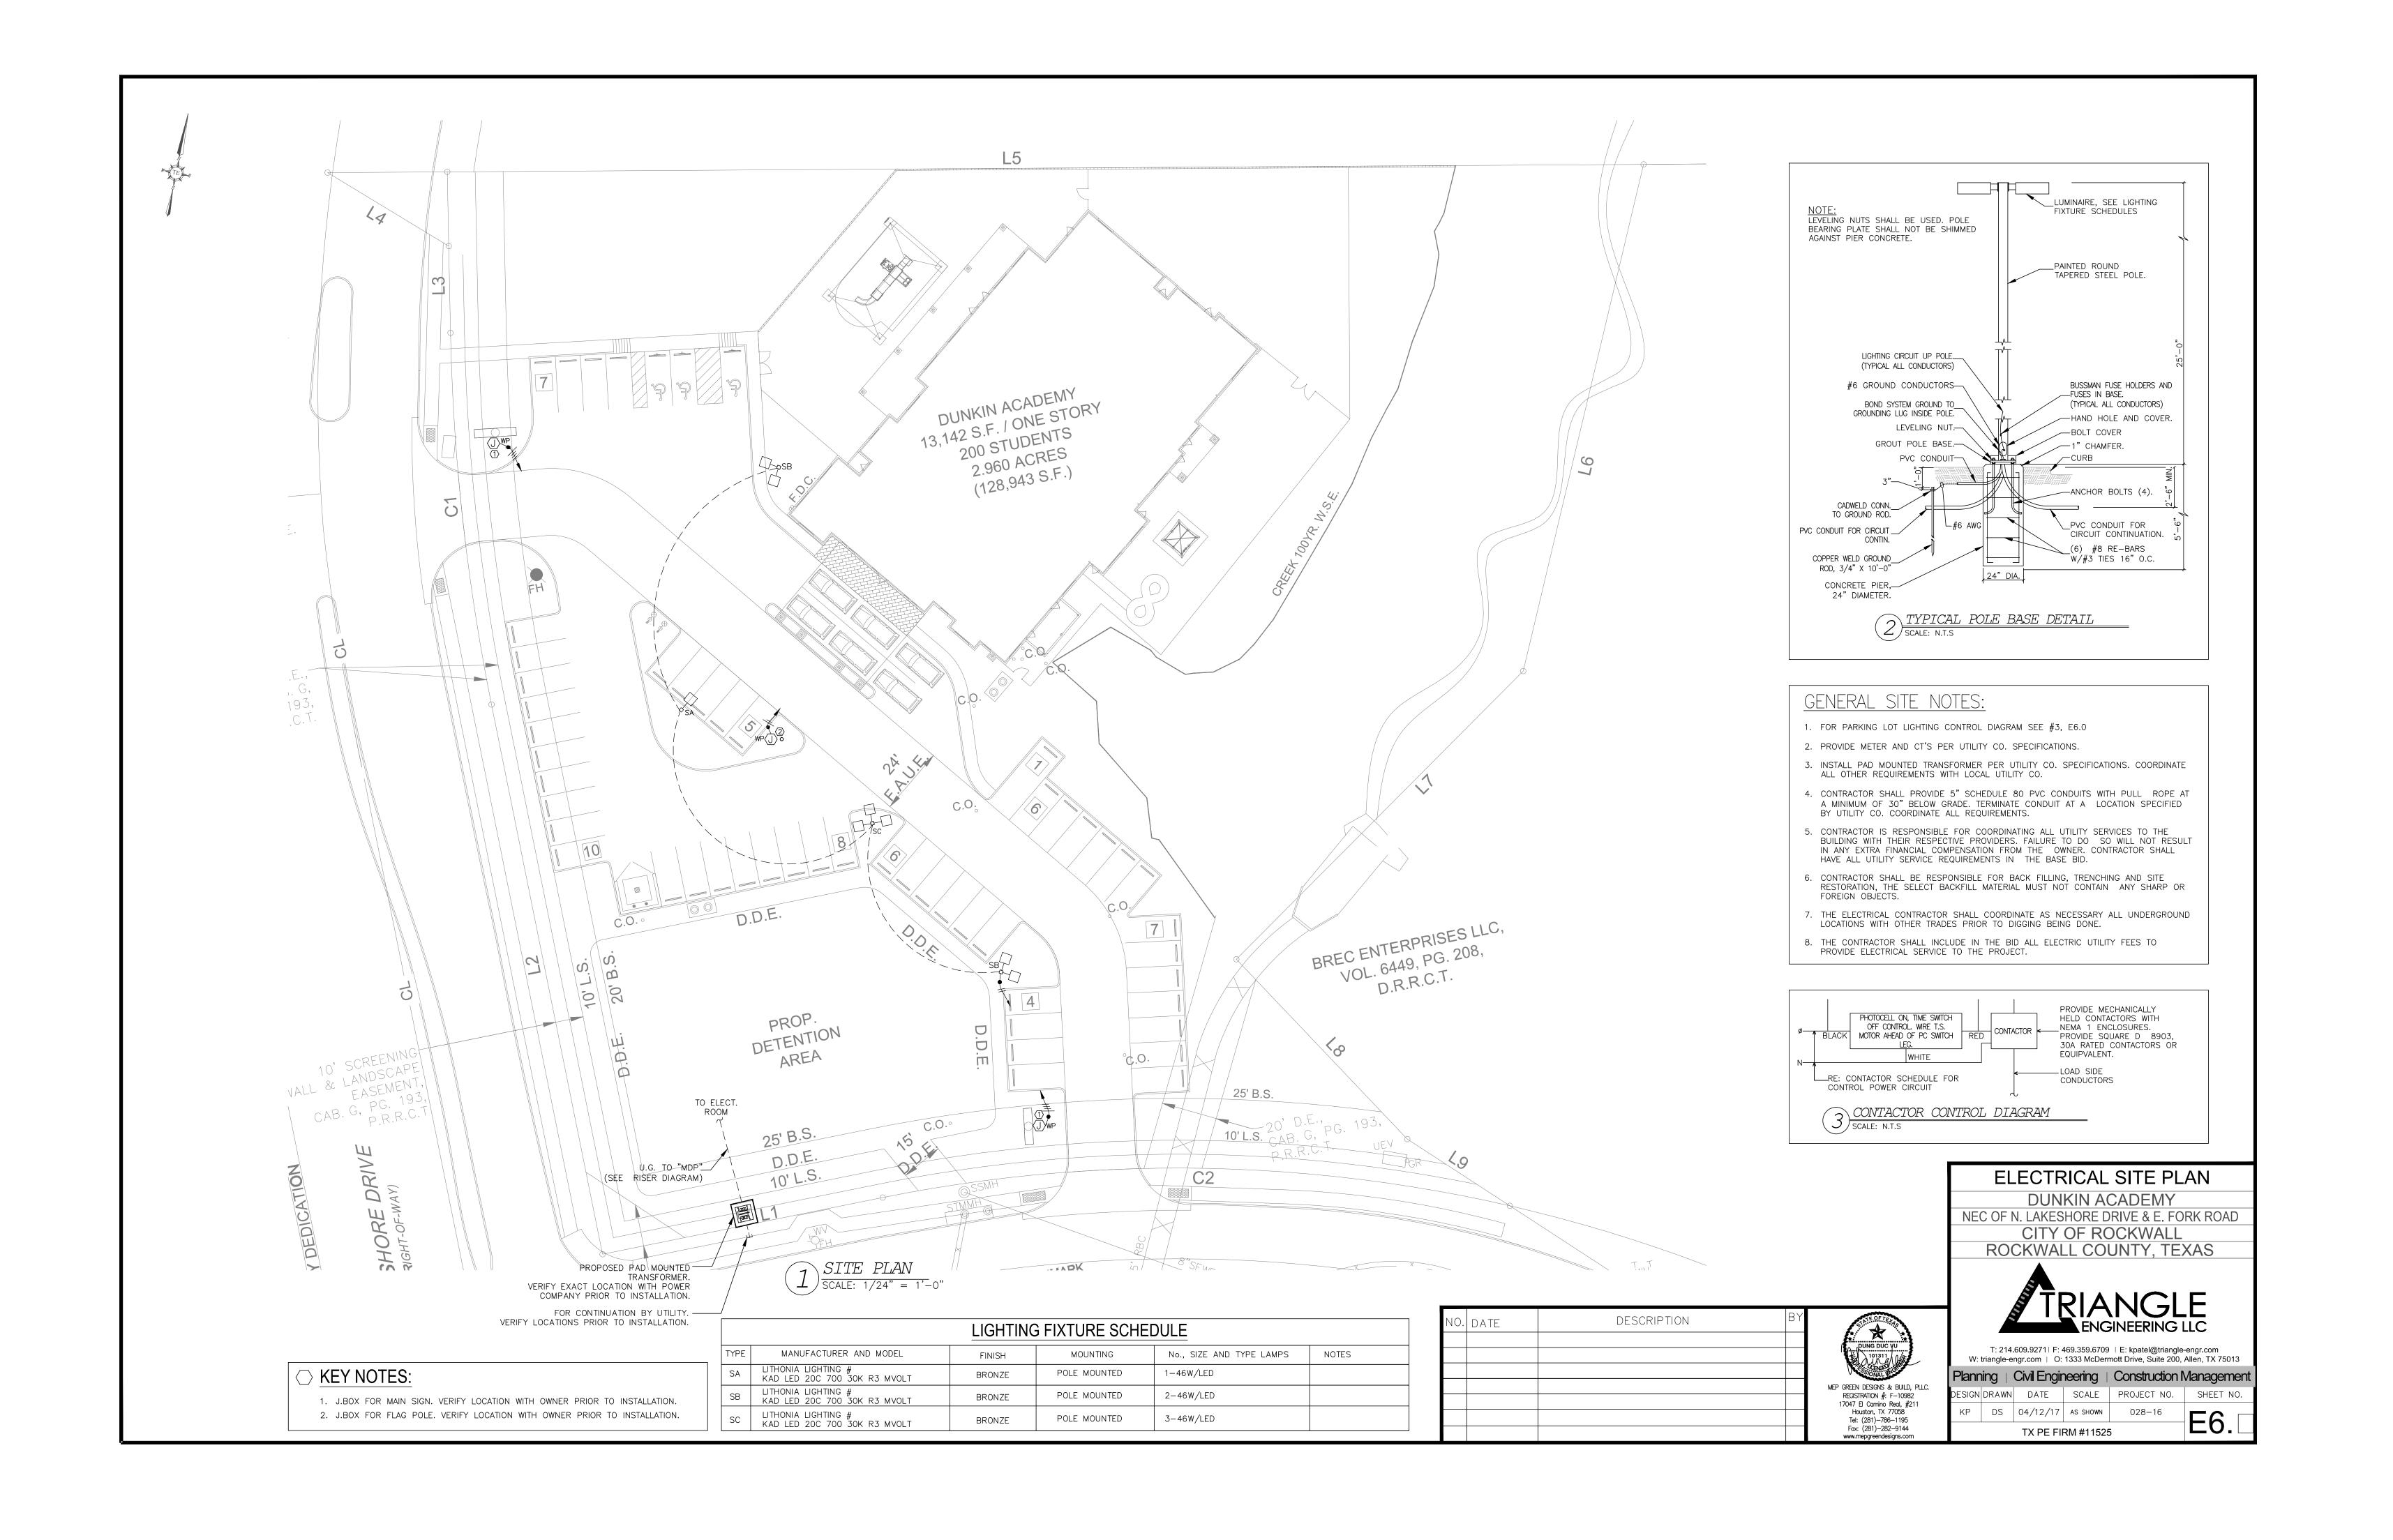

WOOD BRACKETS — SHINGLE SIDING AS SPEC. -PLATE • 0 HORIZONTAL SIDING, AS SPEC. PLATE STONE, AS SPEC. AS SPÉC. FIN. FLR.

> HORIZONTAL SIDING AS SPEC._ WOOD BRACKETS -SHINGLE SIDING AS SPEC. — PLATE PLATE PLATE -BRICK, AS SPEC. — STONE, AS SPEC. FIN. FLR. NOTE: LANDSCAPING SHOWN FOR CONCEPTUAL PURPOSES ONLY 2 REAR ELEVATION
>
> SCALE: 1/8" = 1'-0" (NORTH)

SHINGLE SIDING AS SPEC. HORIZONTAL SIDING AS SPEC. WOOD BRACKETS — METAL ROOF. AS SPEC. PLATE + 0 PLATE PLATE PLATE NOTE: LANDSCAPING SHOWN FOR CONCEPTUAL PURPOSES ONLY 1 FRONT ELEVATION
SCALE: 1/8" = 1'-0" (SOUTH)

FACADE MATERIAL AREA. FRONT ELEVATION (SOUTH) MASONRY: 799 SF = 69% BRICK: 369 SF = 46% STONE: 430 SF = 54% CEMENTITIOUS SIDING/SHINGLES: 357 SF TOTAL SURFACE AREA: 1,156 SF = 31% REAR ELEVATION (NORTH) MASONRY: 573 SF = 8*0*% CEMENTITIOUS SIDING/SHINGLES: 141 SF TOTAL SURFACE AREA: 714 SF = 2*0*% = 1*00*% LEFT ELEVATION (WEST) MASONRY: 1,069 SF = 85% BRICK: 814 SF = 76% STONE: 255 SF = 24% CEMENTITIOUS SIDING/SHINGLES: 182 SF TOTAL SURFACE AREA: 1,251 SF = 15% = 100% RIGHT ELEVATION (EAST) MASONRY: 982 SF = 74% CEMENTITIOUS SIDING/SHINGLES: 342 SF TOTAL SURFACE AREA: 1,324 SF = 26% = 100%

NOTE: LANDSCAPING SHOWN FOR CONCEPTUAL PURPOSES ONLY

FACADE MATERIAL SPECS.

BRICK: 'ACME' - CEDAR VALLEY STONE: GRANBURY REGULAR CHOPPED GRAY PAINT FOR HORIZONTAL SIDING: 'SHERWIN WILLIAMS' - SW 6424 PAINT FOR SHINGLE SIDING: 'SHERWIN WILLIAMS' - SW 6366 PAINT FOR TRIM: 'SHERWIN WILLIAMS' - SW 6700 WINDOWS: 'YINYL' - ALMOND COMPOSTION SHINGLE ROOF: WEATHERED WOOD AUNINGS: 'STANDING SEAM METAL' - ALUMINUM GUTTERS: 'ALUMINUM' - PEBBLESTONE CLAY

FACADE NOTES

• ALL MECHANICAL UNITS SHALL BE SCREENED FROM PUBLIC VIEW AS REQUIRED BY THE COMPREHENSIVE ZONING ORDINANCE.

• WHEN PERMITTED, EXPOSED UTILITY BOXES AND CONDUITS SHALL BE PAINTED TO MATCH THE BUILDING.

• ANY/ALL SIGNAGE IS SUBJECT TO FNAL APPROVAL UNDER SEPARATE APPLICATTION/PERMIT BY THE CHIEF BUILDING OFFICIAL OR DESGINEE. • MONUMENT SIGN TO BE CONSTRUCTED OF SAME MATERIALS & COLORS AS BUILDINGS.

SEE LANDSCAPE PLAN FOR MASONRY SCREENING (COLORS & MATERIALS TO MATCH BUILDING).

ARCHITECT

ARCHON CORPORATION ARCHITECTS & PLANNERS 2929 CARLISLE, STE 130 DALLAS, TX 75204 817-975-9767 ATTN: GARY WOOD

OWNER

DUNKIN ACADEMY ROCKWALL LLC 320 N TOWN EAST BLVD SUNNYVALE, TX 75182 469-358-5590 ATT: JOHN DUNKIN

A CHILD CARE FACILITY IN ROCKWALL, TEXAS FACADE/ELEY. PLAN

3 LEFT ELEVATION

SCALE: 1/8" = 1'-0"

N. LAKESHORE DRIVE & E. FORK ROAD

A 2.960 acre tract of land situated in the A. Hanna Survey, Abstract Number 98, Rockwall County, Texas

REVISIONS BY

DUNKIN ACADEMY
. LAKE SHORE DRIVE
ROCKWALL, TEXAS

ADEMY DUNKIN AROCKWALL,


(WEST

(FACING FORK ROAD)

(FACING LAKESHORE DRIVE)

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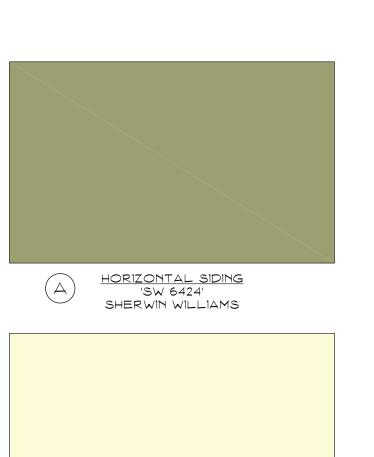



Date: 3-28-17

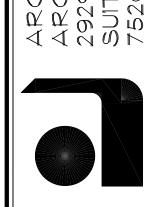Drawn: Job:

Sheet


ELEVS Sheets



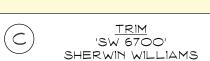





ROOF 'WEATHERED WOOD' COMPOSITION SHINGLE

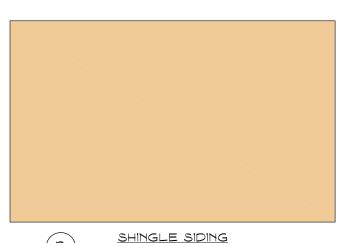


B SHINGLE SIDING
'SW 6366'
SHERWIN WILLIAMS

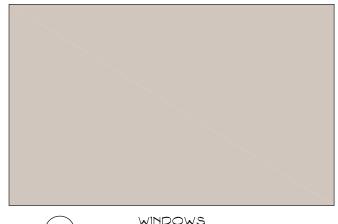

WINDOWS 'ALMOND' VINYL

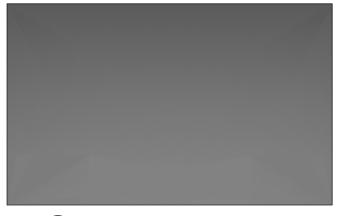


G AWNINGS 'ALUMINUM'
STANDING SEAM METAL

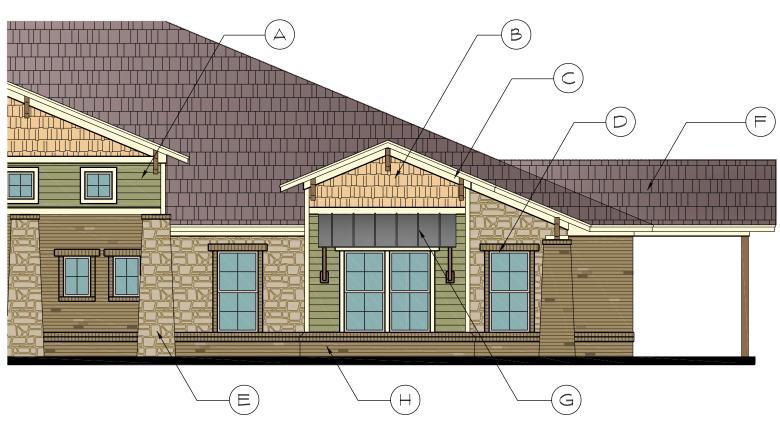



STONE
GRANBURY REGULAR
CHOPPED GRAY

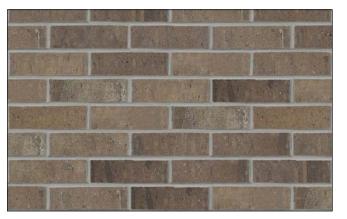

BRICK CEDAR VALLEY' ACME BRICK

<u>ARCHITECT</u>

ARCHON CORPORATION
ARCHITECTS & PLANNERS
2929 CARLISLE, STE 130
DALLAS, TX 75204
817-975-9767
ATTN: GARY WOOD

OWNER

DUNKIN ACADEMY ROCKWALL LLC 320 N TOWN EAST BLVD SUNNYVALE, TX 75182 469-358-5590 ATT: JOHN DUNKIN

DUNKIN ACADEMY Case no.