

DEVELOPMENT APPLICATION

City of Rockwall Planning and Zoning Department 385 S. Goliad Street Rockwall, Texas 75087


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PLANNING & ZONING CASE NO. SP262 (919

NOTE: THE APPLICATION IS NOT CONSIDERED ACCEPTED BY THE CITY UNTIL THE PLANNING DIRECTOR AND CITY ENGINEER HAVE SIGNED BELOW.

DIRECTOR OF PLANNING:

		,,,,,,,,,,,,,,,,,,,,,,,,,,,,,,,,,,,,,,,			CITY ENGINEER:			
PLEASE CHECK THE A	APPROPRIATE BOX	BELOW TO IND	ICATE THE TYPE OF	DEVELOPMENT	T REQUEST [SELEC	T ONLY ONE	BOXJ:	
PLATTING APPLIC. MASTER PLAT (PRELIMINARY P FINAL PLAT (\$30.0 REPLAT (\$300.0	ATION FEES: \$100.00 + \$15.00 AC PLAT (\$200.00 + \$15.00 00.00 + \$20.00 ACRE) 0 + \$20.00 ACRE) MINOR PLAT (\$150.0 EMENT REQUEST (ATION FEES: 0.00 + \$20.00 ACRE)	CRE) 1 00 ACRE) 1 E) 1 00) (\$100.00)		ZONING A ZONIN SPECI PD DE OTHER A TREE I VARIAI NOTES: II N DETE MULTIPLYIN	APPLICATION FEES G CHANGE (\$200.0 FIC USE PERMIT (\$ VELOPMENT PLAN PPLICATION FEES REMOVAL (\$75.00) NCE REQUEST (\$10 ERMINING THE FEE, IG BY THE PER ACRE ND UP TO ONE (1) ACRE	0 + \$15.00 ACF 200.00 + \$15.0 S (\$200.00 + \$ 00.00)	RE) 1 0 ACRE) 1 15.00 ACRE) 1	AGE WHEN S THAN ONE
PROPERTY INFO	RMATION IPLEA	SE PRINTI						
ADDRESS								
SUBDIVISION	Meadowe	creek Bu	siness Cent	er Phase	2 LOT	627	BLOCK	1
GENERAL LOCATION	SE Corn	ur of S	H 205 &	SH 27	6	-27		-
ZONING, SITE PL	AN AND PLAT	TING INFOR	MATION IPLEASE	PRINTI				
CURRENT ZONING			The state of the s	CURRENT	USE Conve	nience	Store	
PROPOSED ZONING	С			PROPOSED		rience		
ACREAGE	8.24 Ac		LOTS [CURRENT]	6 27		TS [PROPOSE		
NEGOLI IN THE DE	ENIAL OF YOUR CASE.		ADDRESS ANT OF ST	AFF 3 COMMENT	S BY THE DATE PRO	VIDED ON THE	DEVELOPMENT C	EXIBILITY WITH ALENDAR WILL
OWNER/APPLICA	NT/AGENT INF	FORMATION	[PLEASE PRINT/CHEC	K THE PRIMARY	CONTACT/ORIGINAL	SIGNATURES A	RE REQUIRED]	
☑ OWNER	Gingerere			M APPLICA				
CONTACT PERSON	Andrew		С	ONTACT PERSO	ON David	Engin Bond	σ	
ADDRESS	P.O. Box 2	1437		ADDRES		uster R		
OITY					Ste. 10	0		
CITY, STATE & ZIP	Smyrna,	GA 300	81	CITY, STATE & Z	IP Plano,	TX 75	075	
PHONE	770-431			PHON		422-00	77	
E-MAIL	amalzere		c.com	E-MA	all david.	ond@sp	iarsengine	eving.co
NOTARY VERIFIC BEFORE ME, THE UNDERS STATED THE INFORMATIO	SIGNED AUTHORITY C	ON THIS DAY PER	SONALLY APPEARED AND CERTIFIED THE FO	Max E. /	n Braye,	_	ER] THE UNDERS	Ū
"I HEREBY CERTIFY THAT I	AM THE OWNER FOR THE	HE PURPOSE OF T	THIS APPLICATION; ALL I HIS APPLICATION, HAS E	NFORMATION SUB	MITTED HEREIN IS TR	UE AND CORREC	CT; AND THE APPLIC	
INFORMATION CONTAINED SUBMITTED IN CONJUNCTION	WITHIN THIS APPLICA	BY SIGNING THIS I ATION TO THE PI	APPLICATION, I AGREE IBLIC. THE CITY IS AL RODUCTION IS ASSOCI	THAT THE CITY OF	ROCKWALL (I.E. "CIT	Y") IS AUTHORIZ	MIL ADDIVIDIOUSED	DAY OF TO PROVIDE INFORMATION
GIVEN UNDER MY HAND A	ND SEAL OF OFFICE (11111	DAY OF HO	20	- 12	NO NO	O GFE	
NOTARY PUBLIC IN AND F		XAS	ton	- Ing	Dya.	MMISSION EXPI	2 2 2 b	2022
DEVELOPMEN	T APPLICATION > CIT	Y OF ROCKWALL	« 385 SOUTH GOUAD	STREET ROCKY	VAII, TX 75007 Q 17	TY, GEOR	(N-1 (992) 771-7	727



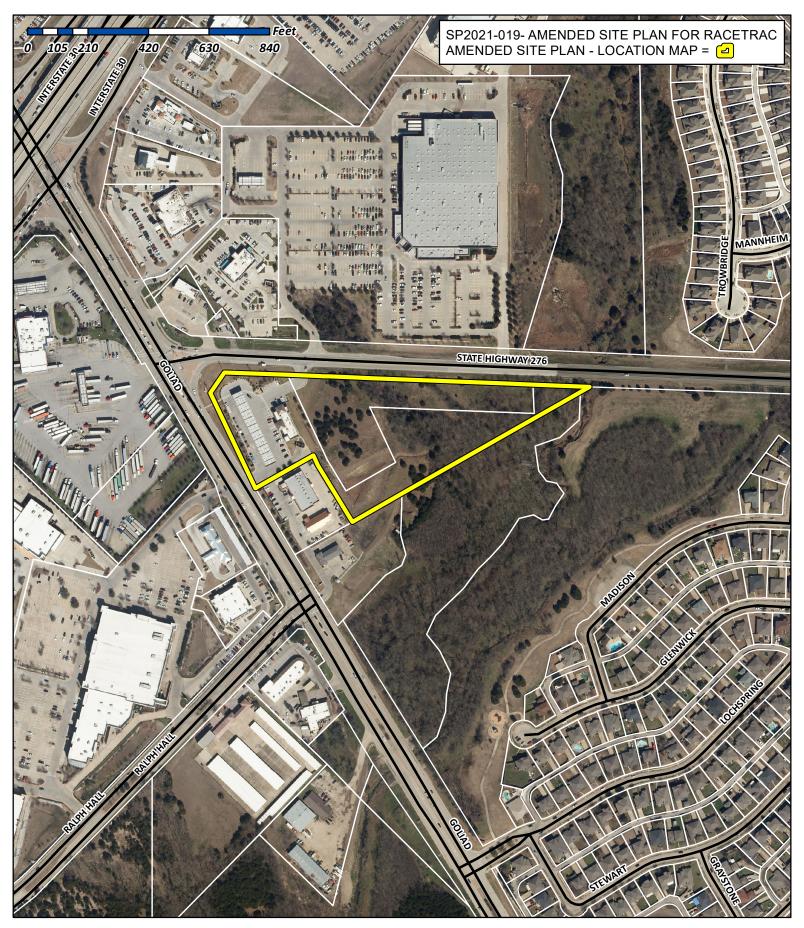

City of Rockwall

Planning & Zoning Department 385 S. Goliad Street Rockwall, Texas 75032 (P): (972) 771-7745 (W): www.rockwall.com The City of Rockwall GIS maps are continually under development and therefore subject to change without notice. While we endeavor to provide timely and accurate information, we make no guarantees. The City of Rockwall makes no warranty, express or implied, including warranties of merchantability and fitness for a particular purpose. Use of the information is the sole responsibility of the user.





Mr. David Gonzales City of Rockwall – Planning & Zoning 385 S. Goliad Street Rockwall, Texas 75087

01/05/2021

Dear Mr. Gonzales:

Please accept this letter of request for a waiver to the street tree requirement for the Amended Site Plan associated with the RaceTrac convenience store located at 2301 S. Goliad Street. The waiver seeks relief from the requirement for planting 2 canopy and 4 ornamental trees along the **entire** frontage of SH 276. The prescribed 15' buffer and associated plantings are being provided on the existing site and will be added within the area of work, but we do not feel that it is in the best interest of the project or the City to remove existing vegetation from the natural treescape that exists moving east from the area of work.

In consideration of this request, please note that the proposed site is 67% vegetated. Netting out the floodplain, we still are providing 24% of Landscape Area and maintaining all but one of the existing 135 protected trees, which total over 1,000 caliper inches remaining. Additionally, we have taken staff's comment and planted additional trees along the west side of the proposed fueling canopy to add additional screening from the roadway. We feel that these compensatory measures, along with our existing and recently updated masonry building, provide a more than adequate positive impact on the project and ask your support of this variance request.

Regards,

Mulew Mulys

Engineering Project Manager RaceTrac Petroleum, Inc.



DEVELOPMENT APPLICATION SUBMITTAL REQUIREMENTS

City of Rockwall Planning and Zoning Department 385 S. Goliad Street Rockwall, Texas 75087

PLATTING APPLICATION SUBMITTAL REQUIREMENTS [ALL PLAT TYPES]

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	[]	PLAT TYPE.
		[] MINOR/AMENDING PLAT. [] MASTER PLAT. [] PRELIMINARY PLAT. [] FINAL PLAT. [] REPLAT. [] VACATION PLAT.
		Staff requires two (2), 18" x 24" copies be submitted at the time the application is submitted. See Folding Requirements in this development packet.
	[]	DIGITAL COPY OF THE PLAT. The following is required with all plat submittals:
		[] ONE (1) PDF COPY OF THE PLAT [] ONE (1) SURVEY BOUNDARY CLOSURE REPORT.
		* AFTER APPROVAL STAFF WILL REQUIRE ONE (1) AUTOCAD/ESRI (DWG, DXF, OR SHP FILE FORMAT) FILE
	[]	TREESCAPE PLAN [IF APPLICABLE].
	[]	LANDSCAPE PLAN [IF APPLICABLE].
	[]	APPLICATION AND APPLICATION FEE.
SI'	TE PL	AN APPLICATION SUBMITTAL REQUIREMENTS
	W	PLAN SET. A plan set is composed of the following items (failure to submit all of the items required shall constitute an incomplete application):
		SITE PLAN. LANDSCAPE PLAN. TREESCAPE PLAN. PHOTOMETRIC PLAN. BUILDING ELEVATIONS. Staff requires the submittal of two (2) complete plan sets and one (1) digital copy in .pdf format with a site plan application. All sheets submitted to staff
		shall be 24" x 36", arranged into sets, and be folded to a 9" x 12" <i>Tri-Fold</i> with the project title or identifier facing out.
	ANA	PHYSICAL BUILDING MATERIAL SAMPLE BOARD (11" x 17"). See the Material Sample Board Design Guidelines in this development packet. Individual material samples or sample boards that are larger than 11" x 17" will not be accepted.
	MA	VARIANCE REQUEST LETTER. The letter must indicate the variance being requested, the reason for the variance, <u>and the two (2) required compensatory measures being offered to off-set the variance</u> in accordance with the requirements of the UDC.
	M	APPLICATION AND APPLICATION FEE.
ZC	NING	CHANGE APPLICATION SUBMITTAL REQUIREMENTS
	[]	LEGAL DESCRIPTION. A legal description consists of written words that delineate a specific piece of real property. A legal description may be a metes and bounds description or, if the property is platted, a copy of the plat may be submitted to verify the lot and block survey system.
	[]	ZONING EXHIBIT OR CONCEPT PLAN. A zoning exhibit is generally a survey, plat, concept plan or other visual description of the property [Specific Use Permit (SUP) exhibits can be a site plan or building elevations; check with staff for prior to submitting an application for what is appropriate]. Staff requires two (2), 24" x 36" copies and one digital copy (PDF preferred) be submitted at the time the application is submitted. All submittals should be folded individually so that the project title or identifier is facing out. In order to reduce the applicant's costs and to conserve paper, staff may accept other sheet sizes for a submittal if an appropriate scale and level of detail is maintained. Check with staff prior to submitting a small or larger drawing size.
	[]	LETTER OF EXPLANATION. A letter from the applicant or property owner explaining the purpose of the zoning application.
	[]	APPLICATION AND APPLICATION FEE.

IT IS IMPORTANT TO YOU AS AN APPLICANT TO RETURN A FULLY COMPLETED APPLICATION PACKAGE. INCOMPLETE APPLICATION PACKAGES WILL NOT BE ACCEPTED BY STAFF AND WILL BE RETURNED TO APPLICANTS. DUE TO THE PASSAGE OF HB3167, APPLICATIONS AND APPLICATION PACKAGES WILL ONLY BE ACCEPTED ON THE SUBMITTAL DATE AND EARLY AND/OR LATE APPLICATIONS WILL BE RETURNED.



CHECKLIST FOR SITE PLAN SUBMITTALS

City of Rockwall Planning and Zoning Department 385 S. Goliad Street Rockwall, Texas 75087

CASE NUMBER:	REVIEWED BY:	
OVERLAY DISTRICT:	REVIEW DATE:	

1.1 GENERAL INFORMATION FOR ALL PLANS SUBMITTED

Requirements	✓= OK	N/A	Comments	UDC Reference
Items Necessary for Site Plan Review: ✓ Site Plan	⊠′			Per Application §03.04, of Art. 11
✓ Landscape Plan✓ Treescape Plan✓ Photometric Plan✓ Building Elevations		্র ক্র		
Building Material Sample Board and Color Rendering of Building Elevations	'		If required the sample board should detail all building materials, with each material clearly labeled and indicating manufacturer info, color, etc. Check with Planning Staff to see which is appropriate for the submitted project.	§03.04.A, of Art. 11
Submittal Requirements	☑		Four (4) large (24" x 36") <u>folded</u> copies and one (1) PDF digital copy of each plan is required at the time of submittal.	§03.04.A, of Art. 11
Is the property properly platted?	ď		Indicate if the property has been properly platted.	
Title Block (Project Name, Legal Description and/or Address)	₽		The title block is to be located in the lower right-hand corner of all sheets and contain the project name, street address, and/or the lot and block designation.	§03.04.A, of Art. 11
Case Number	Y		The case number should be placed in the lower right-hand corner below the title block of all sheets.	§03.04.A, of Art. 11
Owners (Name, Address, and Phone Number)			The owners name, address, and phone number are required to be in the lower right-hand corner left of the title block.	§03.04.A, of Art. 11
Developer (Name, Address, and Phone Number)	Ø		The name, address, and phone number of the person or company that prepared the plans are required in the lower right-hand corner left of the title block.	§03.04.A, of Art. 11
North Point	ď		The north point or north arrow must be facing true north (or straight up) on all plans, unless the scale of the drawings or scope of the project requires a different position.	§03.04.A, of Art. 11
Numeric and Graphic Scale	Y		The recommended engineering scales are $1" = 20'$, $1" = 40'$, etc with a maximum of $1" = 100'$.	§03.04.A, of Art. 11
Vicinity Map	·		The vicinity map should locate the site relative to the nearest major roadways in a one-half mile radius.	§03.04.A, of Art. 11
Signature Block			Standard signature block with signature space for the Planning & Zoning Chairman and Planning Director.	§03.04.A, of Art. 11
Date			The date that the plans were prepared is required on all submittals.	§03.04.A, of Art. 11
Proposed Land Use:			Indicate the proposed use for this site. Additionally, indicate the proposed use for all structures.	§03.04.A, of Art. 11
✓ Commercial			Land Uses Permitted in the RO, NS, GR, C, DT, RC & Designated Planned Development District Ordinances.	-
✓ Industrial			Land Uses Permitted in the RT, LI, HI & Designated Planned Development District Ordinances.	•

2.1 SITE PLAN: MISCELLANEOUS AND DENSITY & DIMENSIONAL INFORMATION

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Requirements	✓= OK	N/A	Comments	UDC Reference
Total Lot or Site Area (Acreage and Square Footage)	ø'		If the site is part of a larger tract include a key map showing the entire tract of land and the location of the site being planned.	§03.04.B, of Art. 11

Perimeter Dimensions of the Site	☑′	Indicate the perimeter dimensions of the site in feet.	§03.04.B, of Art. 11
Buildings (Square Footage)	ď	Indicate the location and total square footage of all existing and planned buildings on the site.	§03.04.B, of Art. 11
Perimeter Dimensions of all Buildings	U	Indicate the wall lengths of all buildings on the site.	§03.04.B, of Art. 11
Distance Between Buildings	d	Indicate the distance between all existing and planned buildings located on the site.	§03.04.B, of Art. 11
Distance Between Buildings and Property Lines	☑′	Indicate the distance between all property lines and existing and planned buildings located on the site.	§03.04.B, of Art. 11
Indicate all Property Lines	Ø	Indicate all existing property lines. If the site plan requires a platting case that will alter the property lines show the proposed changes in a different line weight.	§03.04.B, of Art. 11
Indicate all Building Setbacks	⊡ ′	Indicate all building setbacks adjacent to right-of-way.	§03.04.B, of Art. 11
Indicate all Easements	V	Additionally, indicate all utilities both existing and proposed.	§03.04.B, of Art. 11
Indicate all Drive/Turning Radii	₩.		§03.04.B, of Art. 11
Indicate all Drive Widths	8		§03.04.B, of Art, 11
Indicate all Fire Lanes	☑⁄	Indicate and label the widths of all fire lanes existing and proposed for the site.	§03.04.B, of Art. 11
Indicate location of all Fire Hydrants	☑′		§03.04.B, of Art. 11
Indicate all Sidewalks	☑	Indicate and label the widths of all sidewalks existing and proposed for the site,	§03.04.B, of Art. 11
Adjacent Street Right-Of-Way		Reference the City's Master Transportation Plan for right-of- way information.	§03.04.B, of Art. 11
Label all Adjacent Street Name	Y	Label all adjacent existing and proposed street names.	§03.04.B, of Art. 11
Adjacent Street Centerlines	☑	Indicate the street centerline for all existing and proposed streets.	§03.04.B, of Art. 11
Median Breaks in Adjacent Streets			§03.04.B, of Art. 11

2.2 SITE PLAN: PARKING INFORMATION

Requirements	✓= OK	N/A	Comments	UDC Reference
Dimension of a Typical Parking Space	Ø		See the comment section in Adequate Parking and Maneuvering below.	§05.03, of Art. 06
Parking Table	⊡		Provide parking table indicating the total number of required parking spaces by use, the total number of required handicapped parking spaces and the total parking provided.	§05.01, of Art. 06
Handicap Parking Spaces Shown	ď			§05.04, of Art. 06
Adequate Parking	\square		Reference Table 3 of Article VI.	Table 5, Art. 06
Adequate Parking and Maneuvering	☑′		All parking spaces and aisle dimensions shall conform to the off-street parking requirements in section 2.19 of the City's Standards of Design and Construction (Check w/ the Engineering Department).	§05.03.C, of Art. 06
Adequate Loading Area	Ø		Loading spaces shall be a minimum of 12 feet in width, 65 feet in length, and 14 feet in height except as may otherwise be approved by the city engineer (Art. VI 6.5 Loading Requirements).	§06.04, of Art. 06
Adequate Loading Maneuvering	⊠ ′		It is also the purpose of this Article to require allocation of sufficient off-street/on-site loading facilities by businesses and industry to ensure that the loading and unloading of vehicles will not interfere with traffic flow or block roadways or fire lanes.	§01.02, of Art. 06
Type and Depth of Paving Material	ď		Indicate the type and depth of the paving material and provide a detail or cut-sheet. All required parking and loading areas shall be constructed of concrete, but may have a surface treatment of brick, stone or other similar material.	§03.02, of Art. 06

2.3 SITE PLAN: SIGNAGE

Requirements ✓= OK N/A Comments UDC Reference

NOTE: All signage shall conform to Chapter 32 of the Rockwall Municipal Code of Ordinance, unless otherwise specified in an Overlay District or Planned Development District with specific signage requirements.

Proposed or Existing Signage	o d		Indicate the location and type of all proposed and/or existing signage on the site plan. Additionally, provide a detail or cutsheet showing the elevations, lighting and dimensions of the proposed signage.	§06.02.F, of Art. 05
2.4 SITE PLAN: SCREENING				
Requirements	√= 0K	N/A	Comments	UDC Reference
Indicate the Type and Location of any Existing and/or Proposed Fences			Label the height and type of fence proposed or existing.	§08,02.F, of Art. 08
Utility Equipment Screening (Pad or Ground Mounted)		Ľ ∀	Pad mounted utility equipment, and air conditioning units, shall be screened from horizontal view from any adjacent public street and from any adjacent property. Utility equipment and air conditioning units shall be screened utilizing plantings, berms, or walls matching the main structure.	§01.05.C, of Art. 05
Utility Equipment Screening (Roof Mounted)			All buildings must be designed such that no roof mounted mechanical equipment, HVAC, or satellite dishes shall be visible from any direction.	§01.05.C, of Art. 05
Above Ground Storage Tanks		T	Aboveground storage tanks shall be screened utilizing walls matching the main structure. Screening plans for above ground storage tanks shall generally conform to the diagram below (i.e. incorporate primary screening — screening wall — and secondary screening) and be approved by the Planning and Zoning Commission in conjunction with a site plan.	§01.05.D, of Art. 05
Dumpster Screening	'		Trash/Recycling enclosures shall be four (4) sided. These receptacles shall be screened by a minimum six (6) foot, solid masonry dumpster enclosure that utilizes the same masonry materials as the primary building and incorporates an opaque, self-latching gate. Dumpster storage should be located to the rear of the buildings with proper access. Trash dumpster shall not be located in any required parking space and shall allow proper access by service trucks. The minimum enclosure area shall be 12'x10'. A minimum of 6" bollards will be required at potential impact zones and the pad site shall be paved to city standards.	§01.05.B, of Art. 05
Outside Storage				
Off-Street Loading Dock Screening		ď	Off-street loading docks must be screened from all public streets and any residential district that abuts or is directly across a public street or alley from the lot. The screening must be at least six feet in height and may be provided by using a masonry fence, berms, plantings or a combination of the above.	§01.05.A, of Art. 05
Residential Adjacency Standards		ď	The director may require wing walls, landscape screens, changes in building orientation, and/or other architectural elements to minimize the impact of uses adjacent to residential property within 150 feet (also reference Art. VIII 5.2).	§01.06, of Art. 05
3.1 LANDSCAPE PLAN				
Requirements	√ = 0K	N/A	Comments	UDC Reference
	OF SERVICE PROPERTY.		Provide the same site data information required in Section 2.1	Son Son 21

Requirements	√ = 0K	N/A	Comments	UDC Reference
Provide Site Data	U		Provide the same site data information required in Section 2.1 Site Plan: Miscellaneous and Density and Dimensional Requirements of this checklist.	See Sec. 2.1 of this checklist
Impervious Area vs. Landscape/Open Space Area Provided and Required (As Per Zoning District)	Ø		Indicate the applicable zoning district percentage of landscaping required and provided, and the impervious area vs. the amount of landscaping and open spaces required and provided.	§01.01.B, of Art. 05
Landscape Table	ď		Provide a landscape table showing plant materials, quantities, size and spacing for existing and proposed landscaping. Complete description of plant materials shown on the plan, including names, locations, qualities, container or caliper sizes at installation, heights, spread, and spacing requirements should also be listed on the plan.	§05.03.B, of Art. 08
Indicate all Landscaping	\square		Indicate the locations of all existing and proposed landscaping.	§05.03.B, of Art. 08
Location of Water Courses and Significant Drainage Features	匠		Indicate the locations of all existing and/or proposed water courses and the location of any existing and/or proposed significant drainage features.	
Indicate all Landscape Buffers	旦		Indicate the locations and dimensions of the required landscape buffers.	§05.01, of Art. 08

Acceptable Landscape Materials:			Sec. 04., of Art. 08
✓ Trees allowed in Street Landscape Buffers	12	Cedar Elm, Texas Red Oak, Homestead Elm, Lace Bark Elm, Bald Cypress, Chinese Pistachio, October Glory Maple, Pecan, Texas Ash, Live Oak, Chinquapin Oak, and Burr Oak (Understory Trees: Texas Redbud, Mexican Plum, Downy Hawthorn, Wax Myrtle, Yaupon, and Deciduous Yaupon)	Appendix C
✓ Trees not allowed in Landscape Buffers	⊡ ′	Silver Maple, Box Elder, Mimosa, Catalpa, Hackberry, Sugarberry, Honey Locust, Tulip Tree, Chinaberry, Sycamore, Cottonwood, Willows, American Elm, Siberian Elm, Jerusalem Thorn/Petuma, Bois D'Arc, Flowering Crabapple Tree, Ginko Tree, Peach/Plum, Mulberry, Texas Mountain Laurel, Lilac Chaste Tree, and Pine Tree.	Appendix C
Protected Trees (That Will Remain On-Site)	☑′	Indicate the location and provide a description by type and size of all existing protected trees (4" or larger) proposed to be retained. Prior to any construction or land development, the developer shall clearly mark all protected and feature trees with an aluminum tag indicating the trees relationship to the treescape plan and flag (i.e. bright fluorescent red vinyl tape). In those instances where a protected tree is so close to the construction area that construction equipment could possibly damage the tree, a protective fence shall be required.	§07.01, of Art. 09
Parking Lot Landscaping	ď	Complete description of landscaping and screening to be provided in or near off-street parking and loading areas, including the information as to the amount (in sq. ft.) of landscape area to be provided internal to parking areas, the total square footage included in the parking area, and the number and location of required off-street parking and loading spaces.	§05.03.E, of Art. 08
Location of all Site Amenities	M	Identify the size, height, location, and material of proposed seating, lighting, planter's sculptures, water features and landscape paving and other public amenities.	
Identify Visibility Triangles	4	Identify visibility triangles on all lots for all driveway intersections and public streets,	§01.08, of Art. 05
Landscape Buffer - Street Trees		Large trees (a species which normally reaches a height of 30 feet or more upon maturity) shall be provided in the required street landscape buffer in numbers equal to one (1) tree for every 50 feet of street frontage.	§05.01, of Art. 08
Tree Locations	☑′	Trees must be planted at least five (5) feet from water, sewer and storm sewer lines.	§05.03.E, of Art. 08
Irrigation Requirements Note	Z ′	Provide note indicating irrigation will meet requirements of UDC.	§05.04, of Art. 08
Hydro mulch (or non-sod option)	ď	The developer shall establish grass and maintain the seeded area, including watering, until a "Permanent Stand of Grass" is obtained at which time the project will be accepted by the City. A "Stand of Grass" shall consist of 75% to 80% coverage and a minimum of one-inch (1") in height as determined by the City.	Sec. 4.2, Coverage, Engr Standards of Design and Construction
Rights-of-Way & Landscape Buffers	ď	All landscape buffers and public right-of-way located adjacent to a proposed development shall be improved with grass (i.e. sod hydro mulch shall be prohibited in these areas) prior to the issuance of a Certificate of Occupancy (CO).	§05.03.G, of Art. 08

4.1 TREESCAPE PLAN


Requirements	√ = 0K	N/A	Comments	UDC Reference
Provide Site Data	ď		Provide the same site data information required in Section 2.1 Site Plan: Miscellaneous and Density and Dimensional Requirements of this checklist.	See Sec. 2.1 of this checklist
Buildings	Y		Indicate the location of all existing or proposed structures, and/or the building pads as shown on the grading plan.	§03.01.A, of Art. 09
Indicate all Site Elevations, Grades, Major Contours and the Limits of Construction	ď			§03.01.C, of Art. 09


Protected Trees (To Remain On Site)	凹		Indicate the location and provide a description by type and size of all existing protected trees (4" or larger) proposed to be retained. Such trees shall be marked and a drip line of said tress shall be protected prior to and during all construction, including dirt work.	§03.01.E, of Art. 09
Protected Trees (To be Removed from the Site)	ď		Indicate the location of all protected trees (4" or larger) that are to be removed from the site and the proposed locations of all replacement trees.	§03.01.F, of Art. 09
Treescape Table	g		Provide a table showing the total inches of trees to be removed and the total inches of trees to be replaced.	§03.01.G, of Art. 09
5.1 PHOTOMETRIC AND LIGHTING PLA	NS			
Requirements	✓= 0K	N/A	Comments	UDC Reference
Provide Site Data Table		P	Provide the same site data information required in Section 2.1 Site Plan: Miscellaneous and Density and Dimensional Requirements of this checklist.	See Sec. 2.1 of this checklist -
Indicate Lighting Levels (in Foot Candles [FC])		þ	Show lighting levels in foot-candles (FC) measured throughout the site and extended to all property lines of the subject property.	§03.03, of Art. 07
Adjacent Property with Common Lot Lines:				
✓ Residential Use		ф	The allowable maximum light intensity measured at the property line of a residential property shall be 0.2 of one foot candle.	§03.03.B, of Art. 07
✓ Commercial Use		4	The allowable maximum light intensity measured at the property line of a non-residential property shall be 0.2 of one foot candle. Subject to requirements in Art. VII 3.3.C.	§03.03.C, of Art. 07
Under-Canopy Lighting		4	Under canopy lighting (i.e. fuel stations, drive through lanes and covered parking structures) shall not exceed 35 foot candles (with the exception below).	§03.03.E.1, of Art. 07
Lighting for Motor Vehicle Dealerships		+	Shall not exceed 0.3 of one foot candle within the front yard of the development. The remainder will comply with the 0.2 of one foot candle.	§03.03.E.2, of Art. 07
Lighting in Parking Areas			The maximum outdoor maintained, computed and measured illumination level within any nonresidential development shall not exceed 20 FC outdoors at any point on the site, with a maximum of 0.2 FC at the property line. (Exceptions: (1) under canopy lighting and (2) motor vehicle dealerships)	§03.03.G, of Art. 07
Building and Pole Mounted Lighting		ф	Indicate the location and type of all exterior lighting, including	§03.03.E, of
Indicate the Mounting Height for all Proposed Light Fixtures		þ	pole mounted, wall-mounted, signage, etc. No light pole, base or combination thereof shall exceed 30 feet, unless further restricted within an Overlay District.	Art. 07 §03.03.D of Art. 07
Indicate the Wattage of all Light Sources			Provide lighting cut sheets that indicates the wattage for each exterior lighting fixture. Light sources (e.g. light bulbs) shall be oriented down and toward the center of the site or shielded so as to not be visible from the property line.	§03.03.A, of Art. 07
Proposed Light Fixtures		ф	Provide elevation drawings and/or cut-sheets of proposed light fixtures on/with photometric plan.	§03.03, of Art. 07
6.1 BUILDING ELEVATIONS: NON-INDU	STRIAL	C	inopy Elevations Provided	
Requirements	√ = 0K	N/A	Comments	UDC Reference
Provide Exterior Elevations			North South East West	-
Indicate Exterior Elevations Adjacent to Public Right-of-Way			(Circle all that apply) North South East West (Circle all that apply)	-
Minimum 90% Masonry Requirement OVERLAY DISTRICTS ONLY Indicate Amount and Location of the Minimum			Exterior walls should consist of 90% masonry materials excluding doors and windows.	§06.02.C, of Art. 05
20% Stone Requirement OVERLAY DISTRICTS ONLY			Applies to facades that are visible from a public right-of-way and/or open space.	§06.02.C, of Art. 05
Indicate the Surface Area of Each Facade			Indicate the surface area (square feet) of each façade and the percentage and square footage of each material used on that façade.	§04.01, of Art. 05
Proposed Building Materials			Specifications and description of all proposed building materials, on all proposed buildings.	§04.01, of Art. 05
Indicate the Roofing Materials and Color			machais, on all proposed buildings.	AII. 00


Indicate Parapet Wall Height **(If Applicable, finish the interior side of the parapet wall)		If applicable indicate the parapet wall by dashing in the top of roof deck. **Projecting elements and parapets that are visible from adjacent properties or public right-of-way shall be finished on the interior side using the same materials as the exterior facing wall.	§04.01, of Art. 05
Indicate all Roof Mounted Mechanical Equipment (If Applicable)		If applicable indicate any proposed roof mounted mechanical equipment and indicate how these will be screened from view.	§01.05.C, of Art. 05
Indicate Any Additional Design Elements Proposed (If Applicable)		Indicate any additional design elements for the base, walls, or parapets (such as cornice, arcades, and covered walkways/windows). Be sure to include the location, size, color, and material of any proposed structure.	
Indicate Building Height(s)		The height of the building shall be measured from the average elevation of the finished grade along the front of the building to the highest point of the roof or parapet of the building if it is a flat, mansard or shed roof; or to the midpoint of the roof if it is gable, hip or gambrel roof.	§07.03 of Art. 05
Minimum Standards for Articulation:			
Primary Facades (i.e. facades visible from a public ROW, open space/green space, public/private park, and or residential zoning district or residentially used property)		 Wall Height [H] = H Wall Length [L] = 3 x H Secondary Entry/Arch. Element Length = 25% x L Wall Projection = 25% x H Primary Entry/Arch. Element Width = 2 x (25% x L) Projection Height = 25% x H Primary Entry/Arch. Element Length = 2 x (25% x L) 	§04.01.C.1, of Art. 05
Secondary Facades	🗖	 Wall Height [H] = H Wall Length [L] = 3 x H Secondary Entry/Arch. Element Length = 15% x L Secondary Entry/Arch. Element Width = 15% x H Projection Height = 15% x H 	§04.01.C.2, of Art. 05


6.2 BUILDING ELEVATIONS: INDUSTRIAL

Requirements	✓= OK	N/A	Comments	UDC Reference
NOTE: Industrial buildings are subject to all the eler standards.	nents listed in Se	ction 6.1 E	Building Elevations: Non-Industrial with the exception of the	following
Minimum 90% Masonry Requirement			Exterior walls should consist of 90% masonry materials excluding doors and windows.	\$ §05.01.A.1, of Art. 05
Indicate Amount and Location of the Minimum 20% Stone Requirement Minimum Standards for Articulation:			Applies to facades that are visible from a public right-of-way and/or open space.	§05.01.A.1.a.1, of Art. 05
Primary Facades (i.e. facades visible from a public ROW, open space/green space, public/private park, and or residential zoning district or residentially used property)			 Wall Height [H] = H Wall Length [L] = 4 x H Wall Projection = 25% x H Entry/Arch. Element Length = 33% x L Projection Height = 25% x H Entry/Arch. Element Width = 2 x (25% x H) Wall Height [H] = H 	§05.01.C.1, of Art. 05
Secondary Facades			2. Wall Length [L] = 3 x H 3. Entry/Arch. Element Length = 15% x L 4. Entry/Arch. Element Width = 15% x H 5. Projection Height = 15% x H	§05.01.C.2, of Art. 05

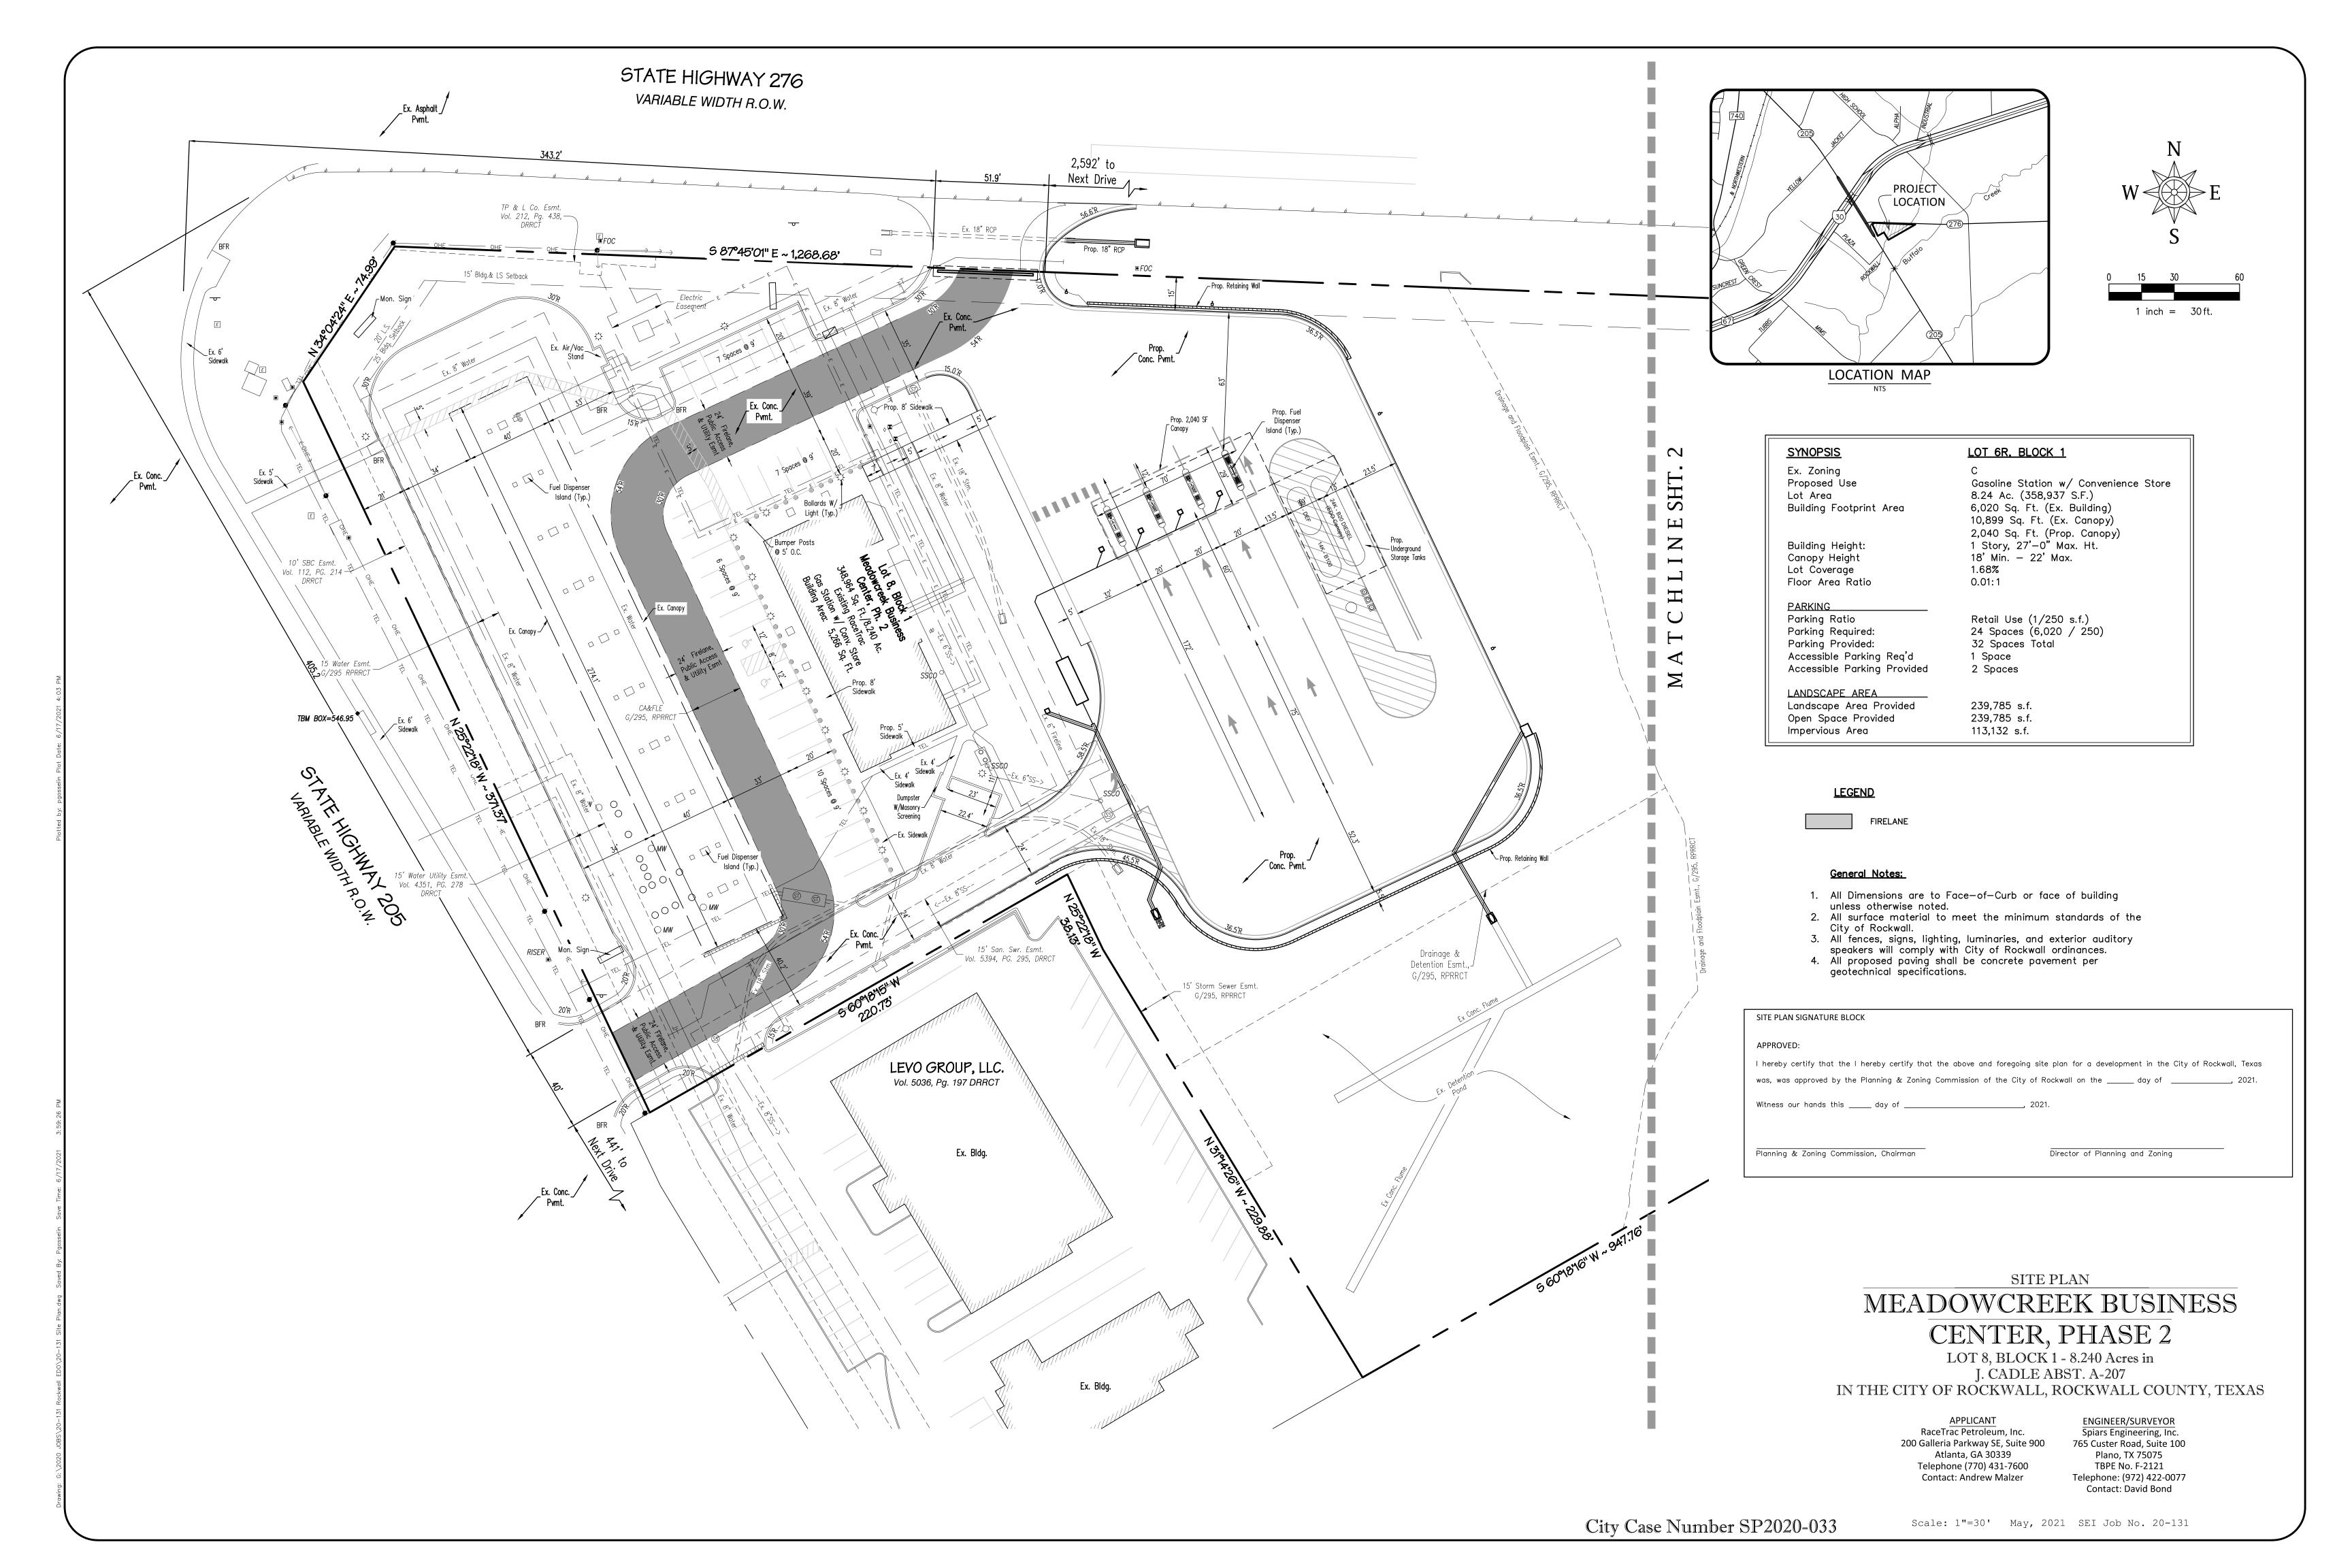

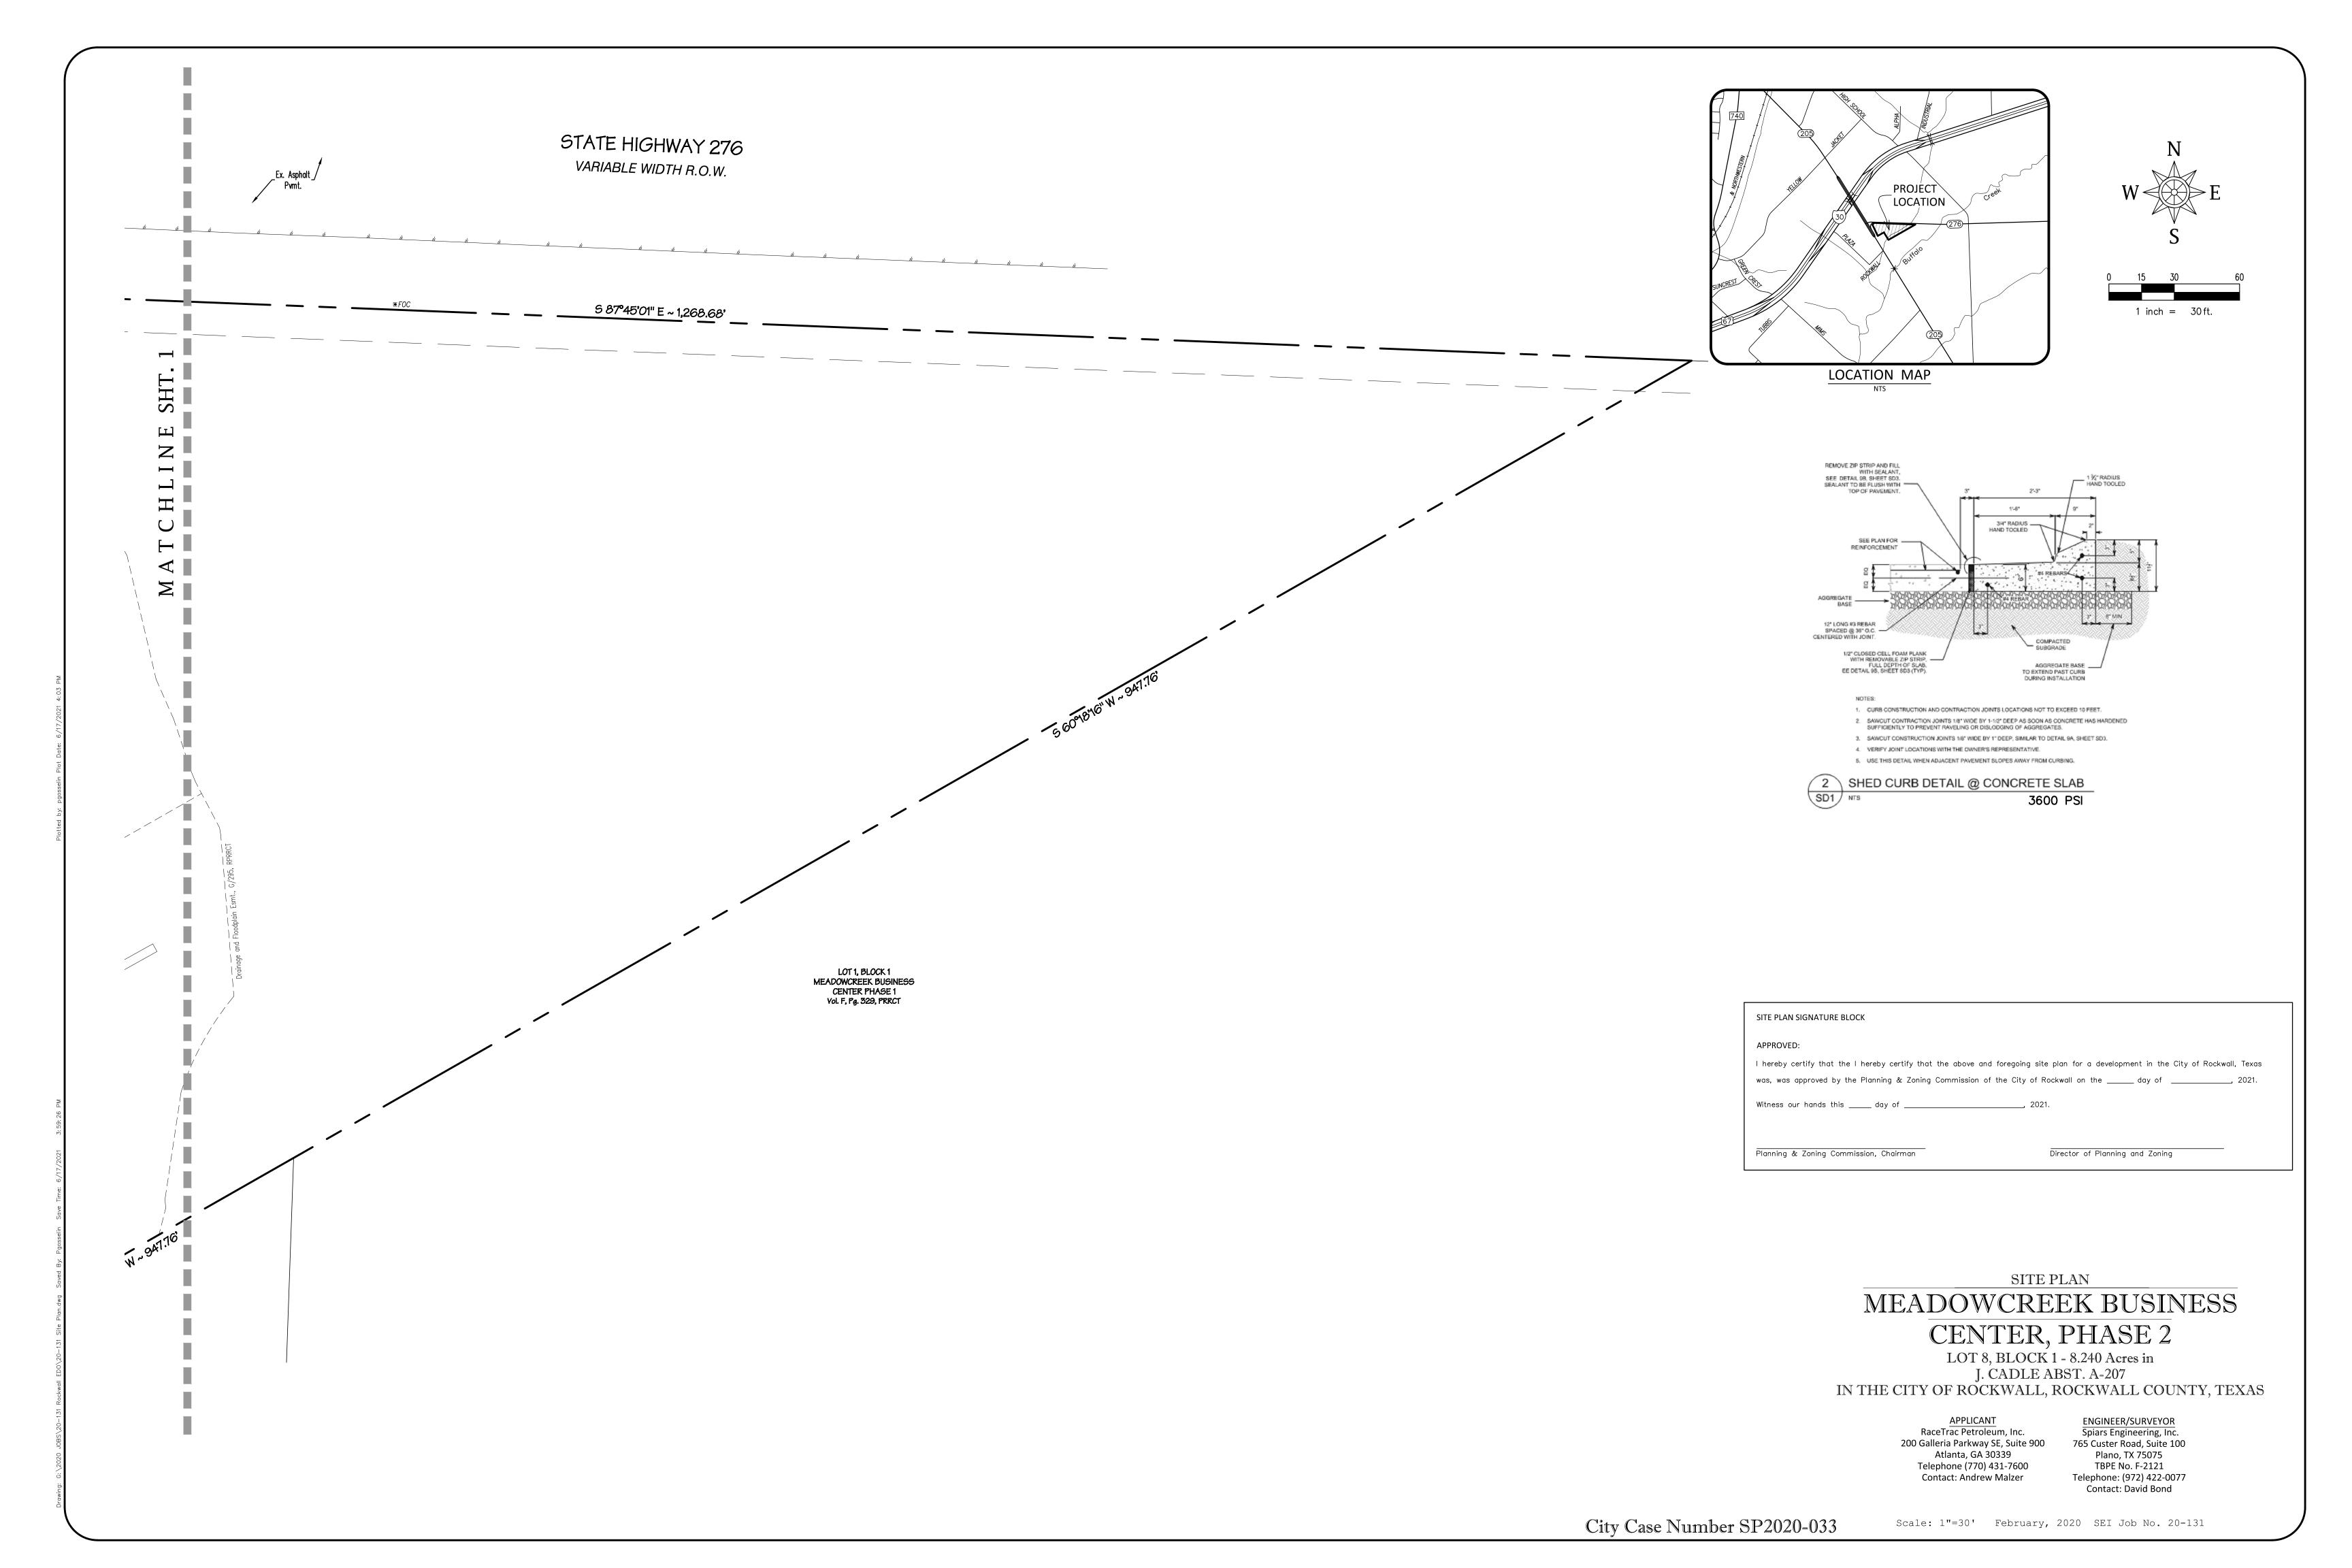


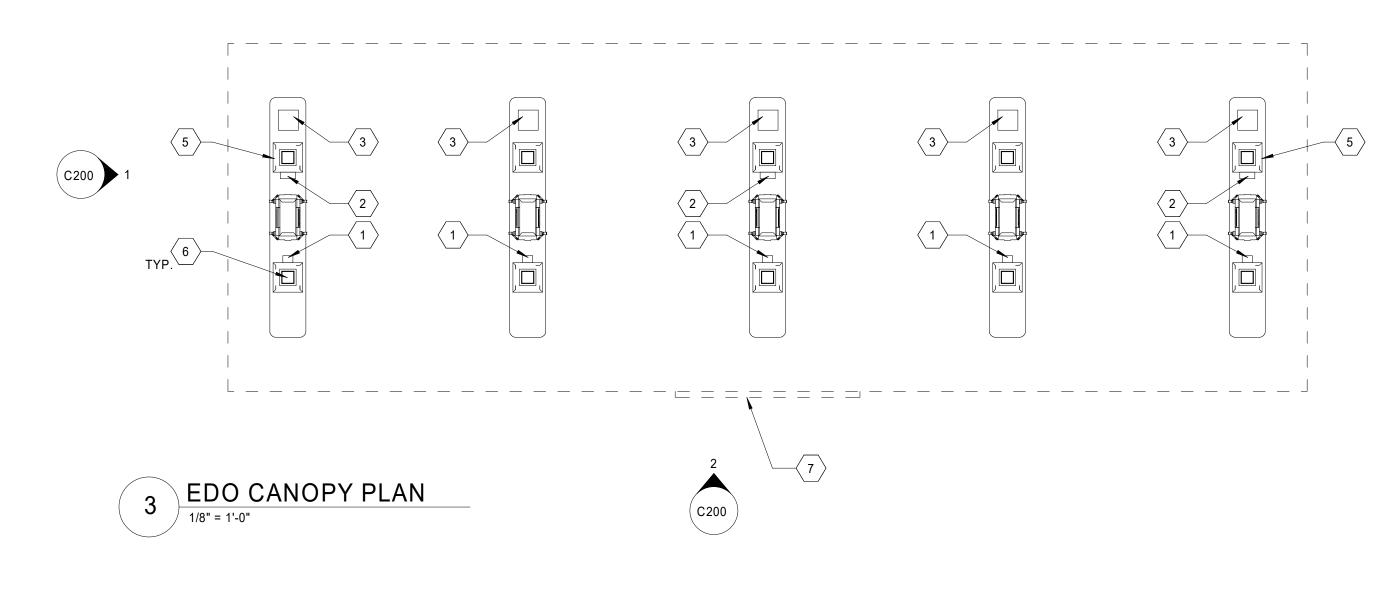

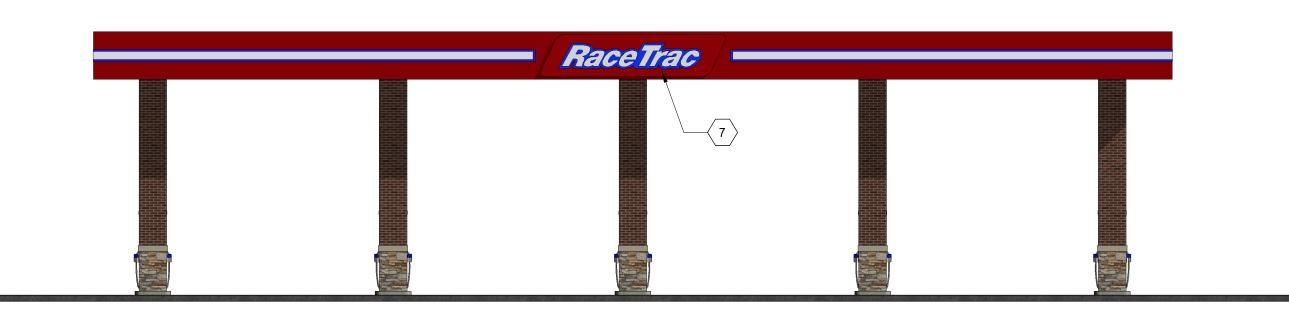

EDO CANOPY FRONT ELEVATION

1/8" = 1'-0"

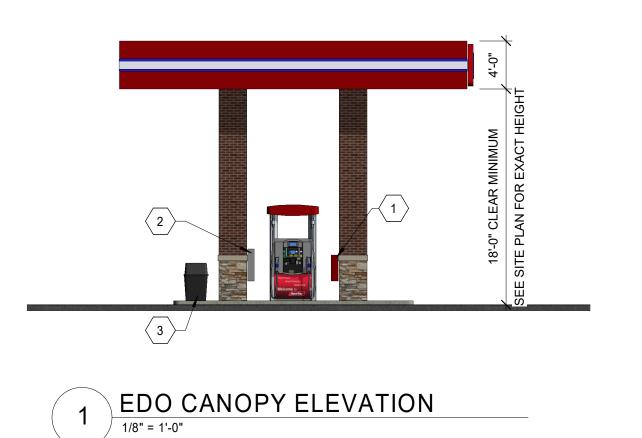

"This submittal is for general informational purposes only and is preliminary in nature. As such, any other use or reliance is strictly prohibited."

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DESIGN PROFESSIONALS



GPD Group, Professional Corporation Texas Registration No. 19819

ISSUE/REVISION RECORD DESCRIPTION 12/08/20 PRELIM. PACKAGE

RaceTrac.

SHEET KEYNOTES M2M RED MARK II CABINET WITH RED COVER, ON BACK SIDE
OF COLUMN COVER. PROVIDE ONE 80-B RATED
EXTINGUISHER.

TOWEL DISPENSER "DCI MARKETING" ITEM NUMBER SBWC BLACK. 3 TRASH CAN. REFER TO SITE PLANS.

4 NOT USED.

5 WOODFORD Y-34 FREEZERLESS IOWA YARD HYDRANT

EDO FUEL CANOPY MATERIAL SCHEDULE

FUEL CANOPY FINISH SCHEDULE

ID MANUF. MATERIAL

EP-1 SHERWIN EXTERIOR PAINT WILLIAMS TO SW #7020

"BLACK FOX"

STONE BAND

STANDARD CANOPY FASCIA COLOR

MANUFACTURER

LANE CANOPIES

LANE CANOPIES

McGEE CANOPIES

McGEE CANOPIES

MADISON CANOPIES

CANOPY

BR-1 MATCH

STACKED STONE

EXISTING

EXISTING

SPECIFICATION CHART

SS-1 MATCH

STONE BAND

COLOR

"TAN"

"RED"

CALLOUT

SB-1 MATCH

FASCIA

RED

WHITE

EXISTING

COMMENTS

MORTAR COLOR TO MATCH EXISTING

SPECIFICATION CHART ON SHEET C100 8" WHITE STRIPE

2" BLUE STRIPE

MATCH EXISTING

MORTAR COLOR TO MATCH EXISTING

STANDARD COLOR

SPECIFICATION

ETT TAN FASCIA

ETT TAN FASCIA

TRD RED FASCIA

TRD RED FASCIA

PROGRAM RED

MADISON CANOPIES PROGRAM RED FASCIA

REFER TO

STACKED STONE MORTAR COLOR TO

6 STEEL CANOPY COLUMN, PAINTED EP-1 7 RACETRAC LOGO; REFER TO SIGN PLAN

RACETRAC PETROLEUM, INC. 200 Galleria Parkway Southeast SUITE 900 ATLANTA, GEORGIA 30339 (770) 431-7600

PROJECT NAME **ROCKWALL** -**EDO ADDITION**

ROCKWALL TX 75032 2301 SOUTH GOLIAD

STREET

RACETRAC STORE NUMBER #0574

PROTOTYPE SERIES TBSL REMODEL

PLAN MODIFICATION NOTICE SPB NO. DATE

STANDARD PLAN BULLETINS (SPB) MODIFY THE PROTOTYPE SERIES SET NOTED ABOVE. THE LISTED SPB REPRESENTS THE LATEST MODIFICATION INCORPORATED TO THIS LISTS ANY REVISIONS OR SPB INCORPORATED IN THIS SET AFTER THE ORIGINAL RELEASE.

PROFESSIONAL SEAL

CONTACT RACETRAC ENGINEERING AND CONSTRUCTION FOR ANY SUBSEQUENT BULLETINS NOT INCORPORATED HEREIN.





PROJECT NUMBER 2020127.18


SHEET TITLE **EDO FUEL CANOPY** PLANS AND


ELEVATIONS

SHEET NUMBER PUEBLO TAN FASCIA

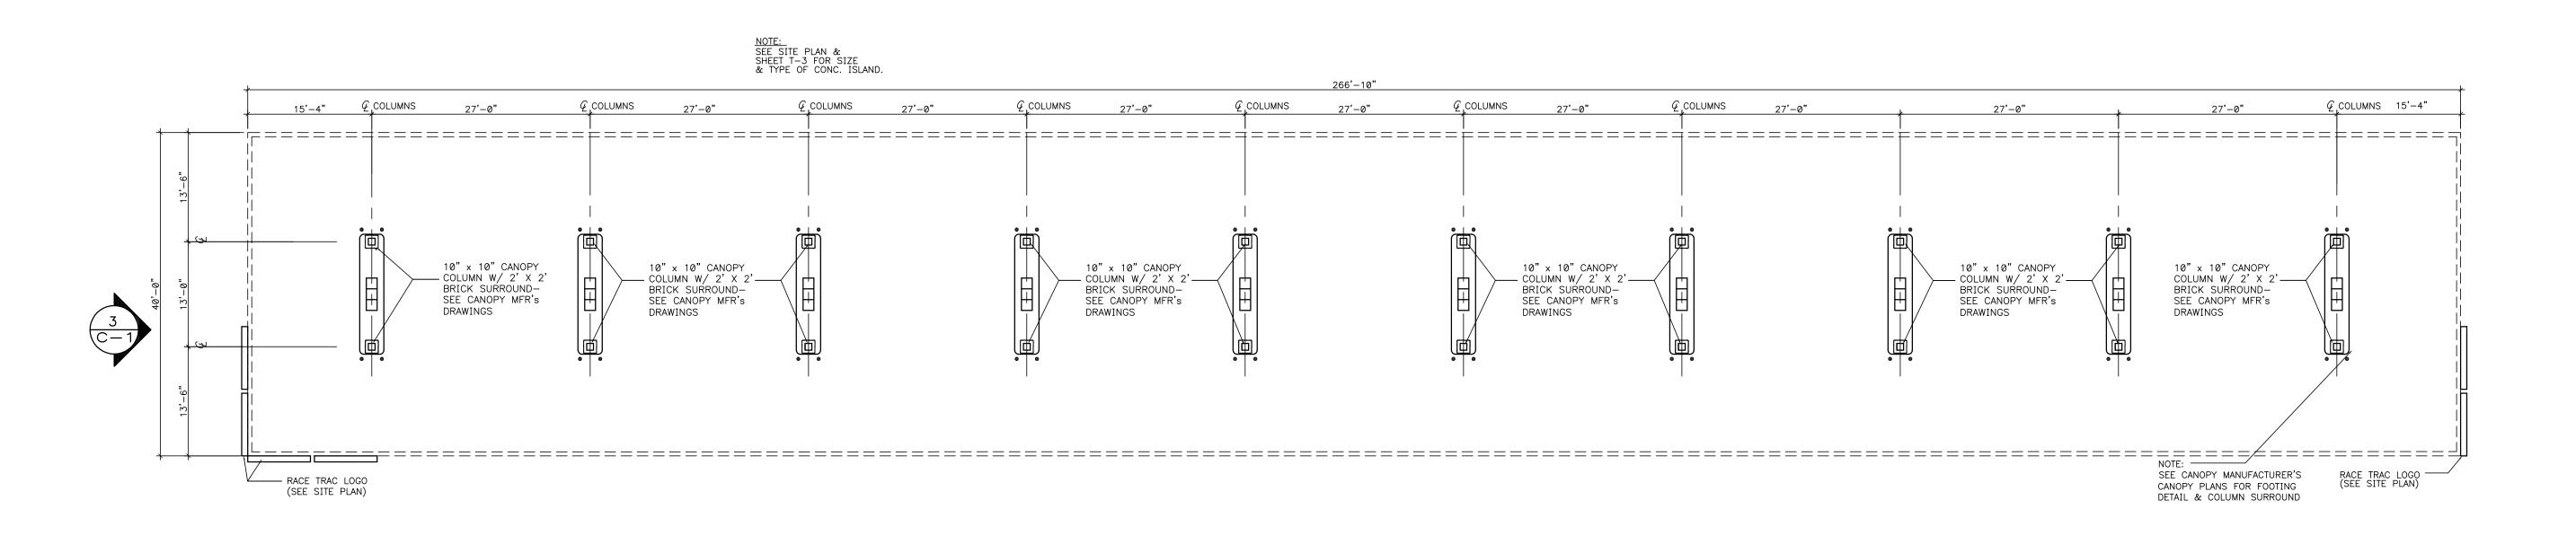

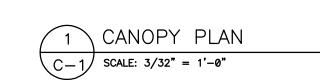

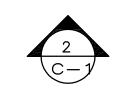

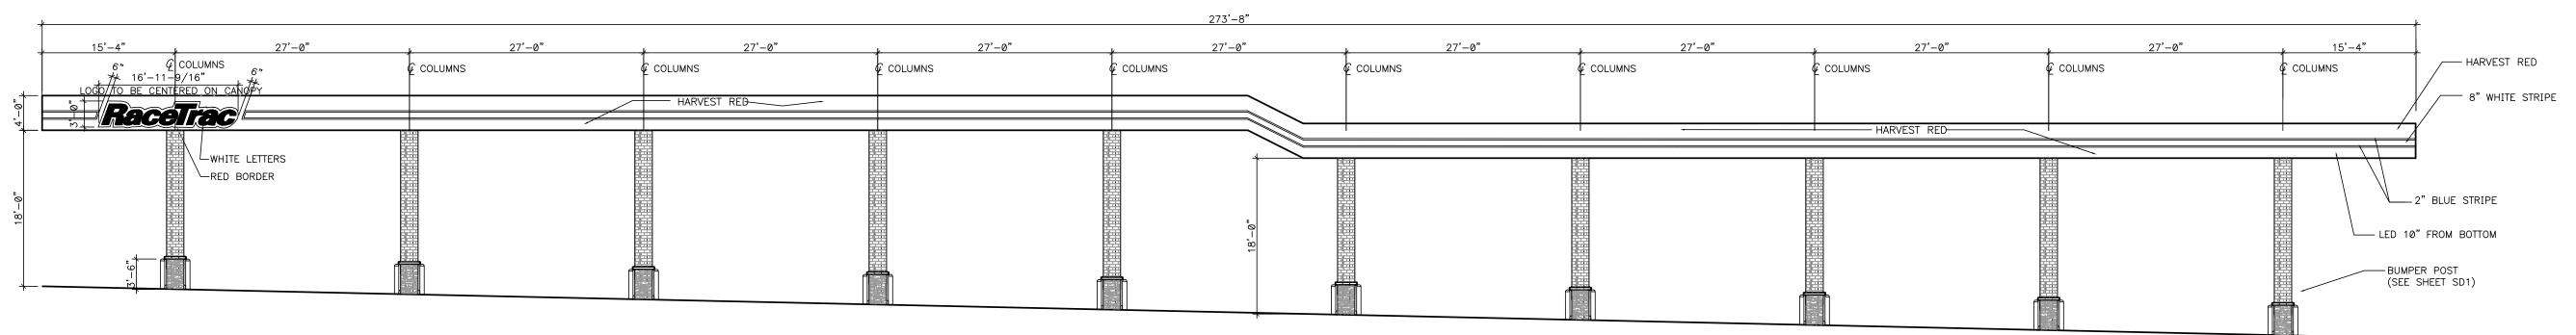


2 CANOPY FRONT ELEVATION SCALE: 3/32" = 1'-0" SEE SITE PLAN FOR THE NUMBER OF LOGO'S TO BE PLACED ON THE CANOPY

GENERAL NOTE:


- 1. ALL CANOPY LIGHTING CIRCUITS SHALL BE #10 CU-AWG. SEE CANOPY MANUFACTURER'S DRAWINGS FOR CANOPY LIGHTS AND CIRCUITS.
- AREA WITHIN 18" OF DISPENSER AND UP TO 18" ABOVE DISPENSER IS CLASS I, DIVISION 2.
- EXTINGUISHERS SHALL BE PROVIDED AND SO LOCATED THAT NO PUMP DISPENSER OF FILL-PIPE OPENING SHALL BE A GREATER DISTANCE THAN 75 FT. FROM SUCH EXTINGUISHER.
- NO SMOKING SIGNS POSTED IN ACCORDANCE WITH SECTION 907.10 SFPC 1997 TAS
- STANDARDS 4.2.6 AND 4.2.7 COLUMN TREATMENTS (IE; BRICK OR STONE) SHALL REST ON TOP OF ISLAND. UNDER NO CIRCUMSTANCES ARE THEY TO EXTEND DOWN TO COLUMN FOOTINGS. SEE CANOPY MANUFACTURERS DETAILS FOR COLUMN WRAPS.



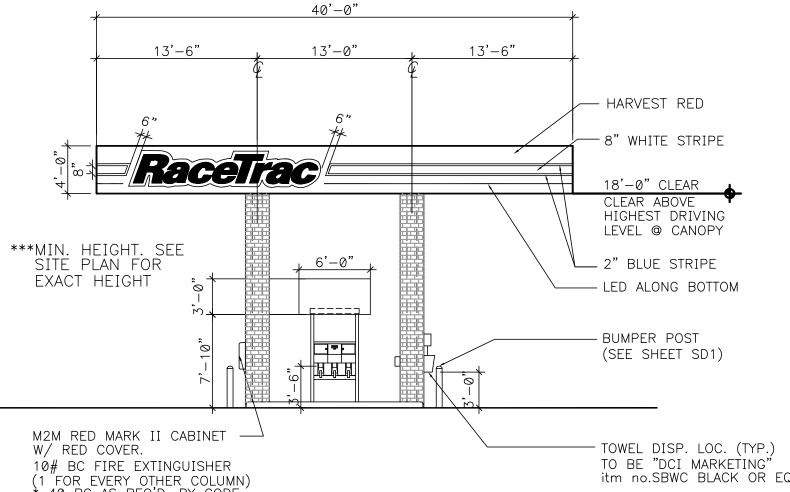

CANOPY SIDE ELEVATION C-1 SCALE: 1/8" = 1'-0"

TOWEL DISP. LOC. (TYP.)
TO BE "DCI MARKETING"
itm no.SBWC BLACK OR EQUAL. 10# BC FIRE EXTINGUISHER (1 FOR EVERY OTHER COLUMN) * 40 BC AS REQ'D. BY CODE.

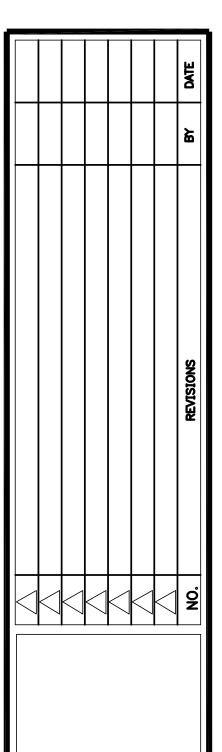

NTERPLANS

ARCHITECTURE ENGINEERING INTERIOR DESIGN PROJECT MANAGEMENT

> AA 003420 CA 8660

604 COURTLAND STREET ORLANDO, FLORIDA 32804 PH 407.645.5008 FX 407.629.9124

IP# 2010.0208

CANOPY PLAN

SERVICE STATION - STORE #


SEC of SH 276 & SH 205

Rockwall, TX

FUEL SITE


REV.

SHEET NO.

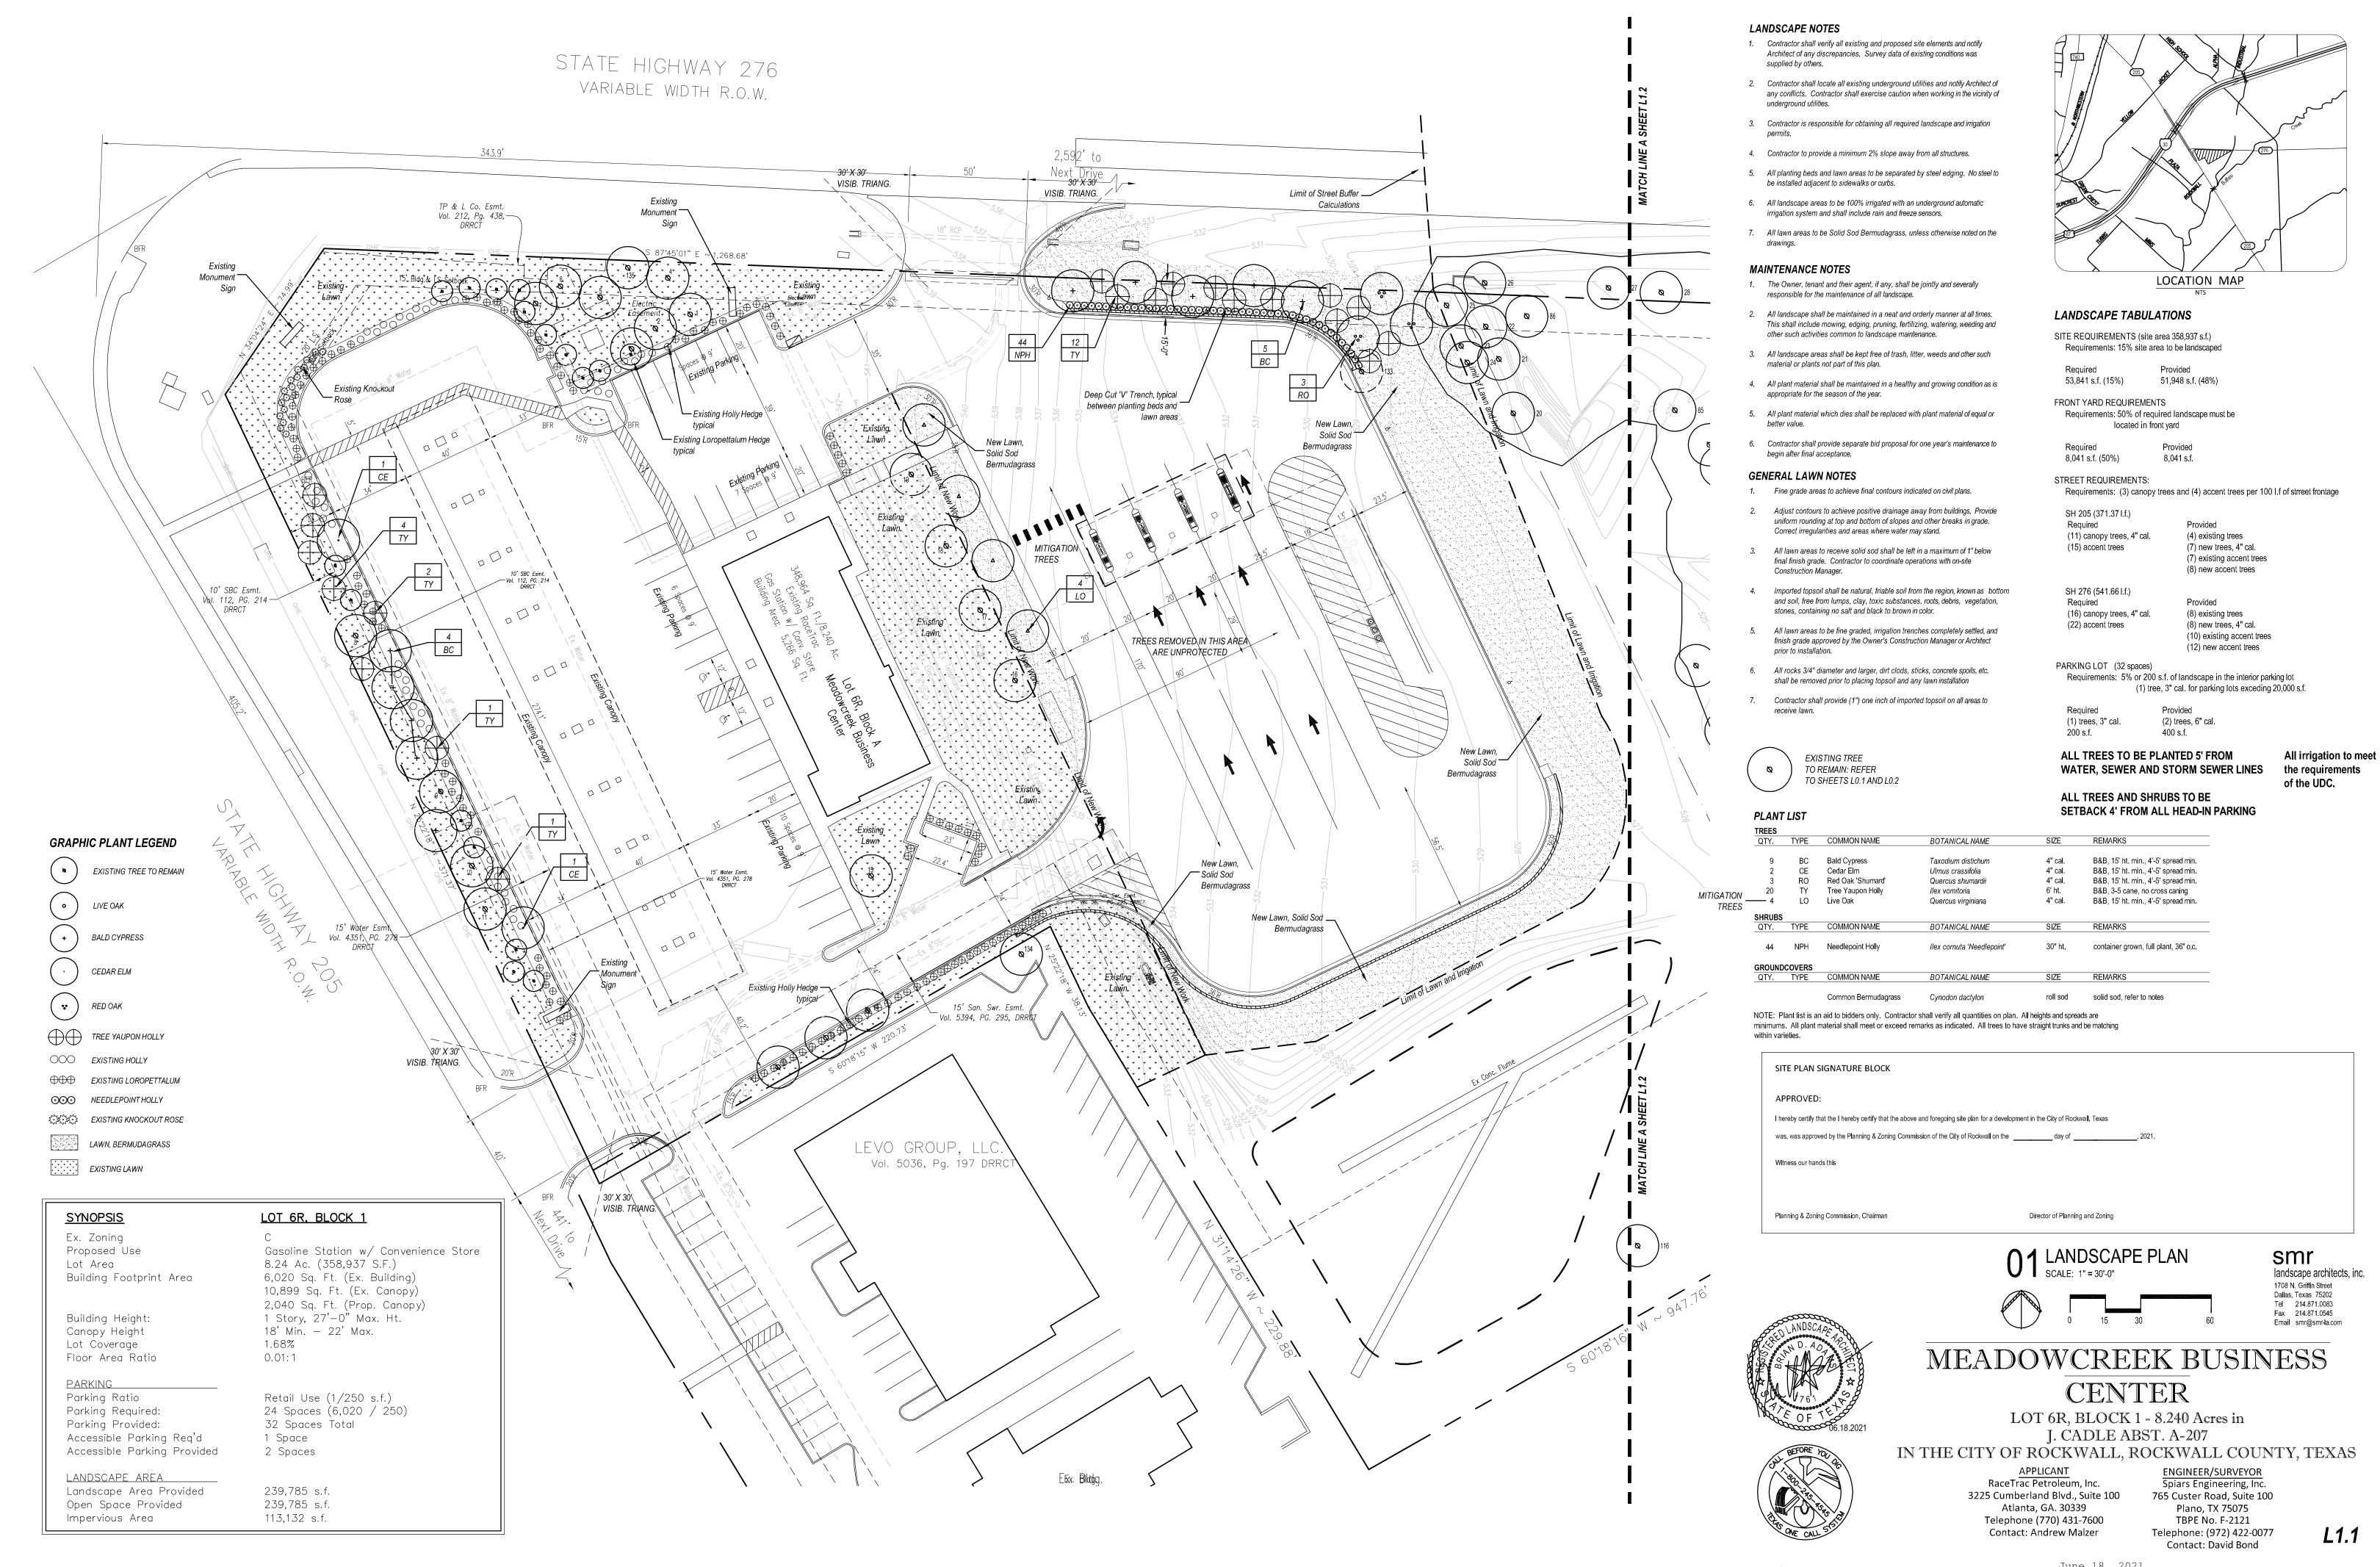


City Case Number SP2020-033

June 18, 2021 Scale: 1"=30' December 30, 2020 SEI Job No. 20-131

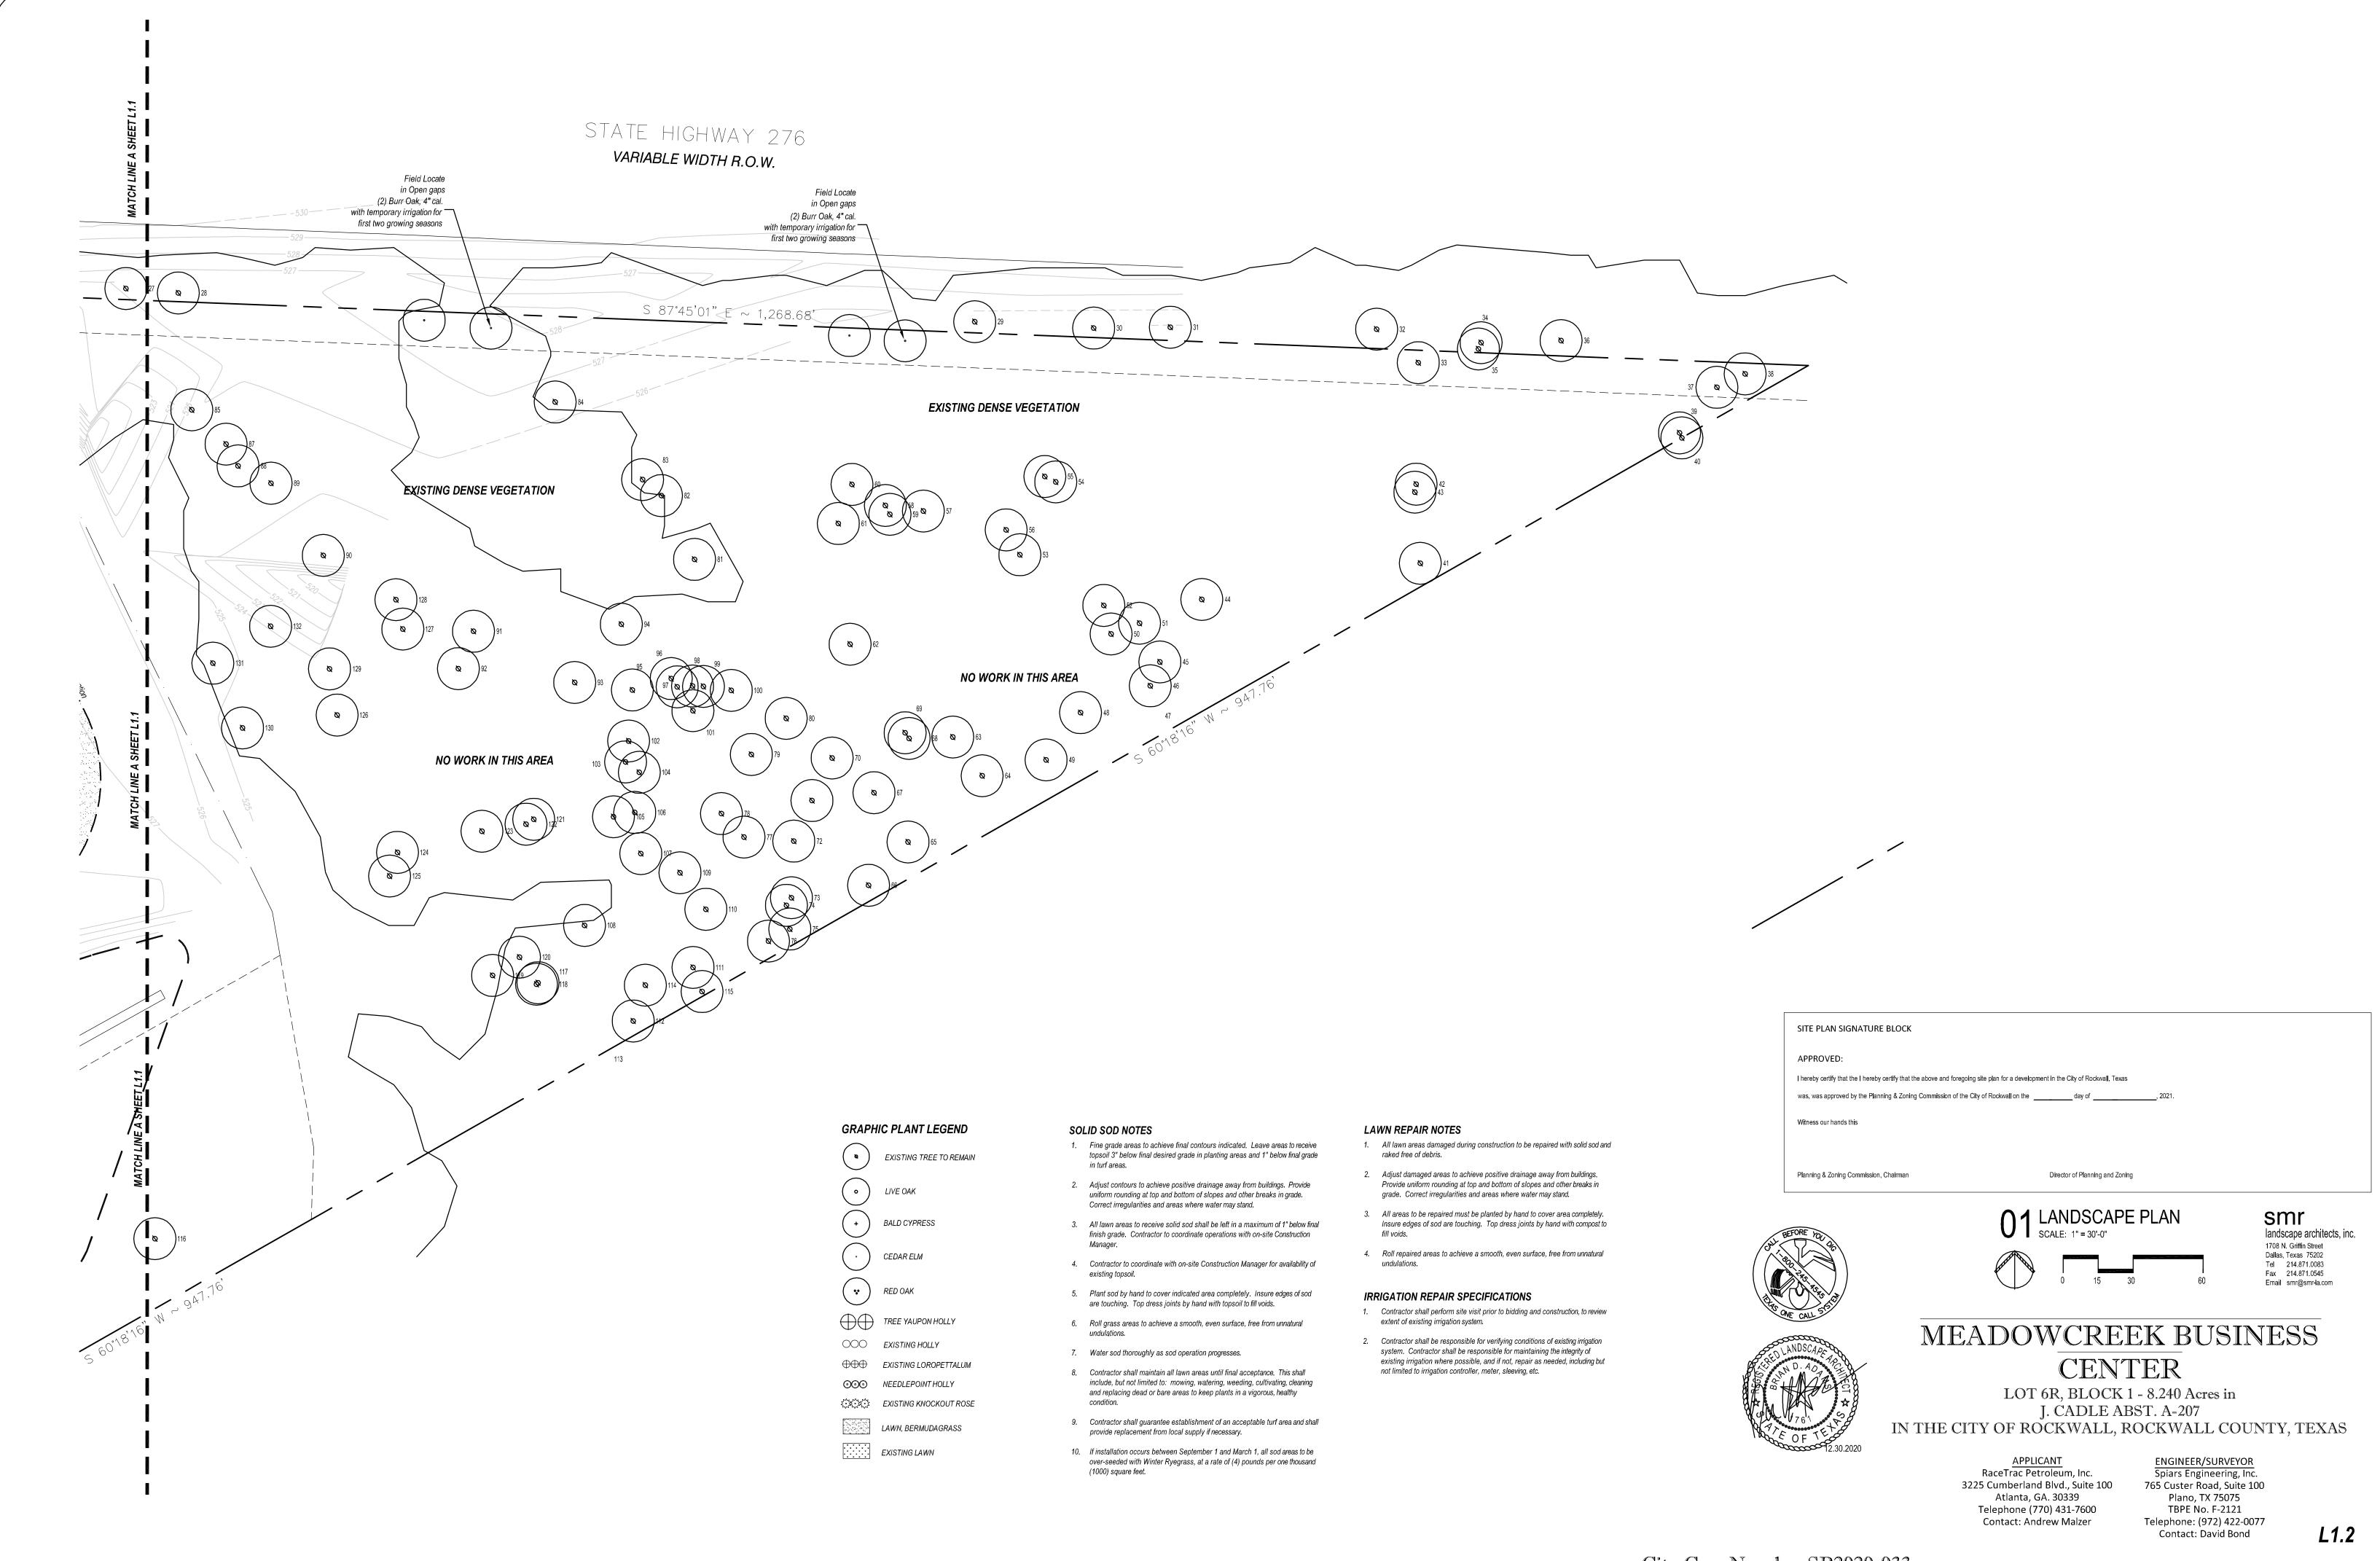


City Case Number SP2020-033


Scale: 1"=30' December 30, 2020 SEI Job No. 20-131

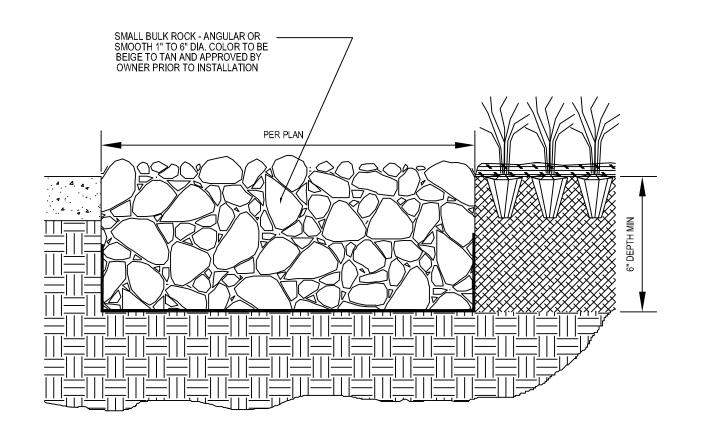


SIGNATURE RIVER ROCK MULCH

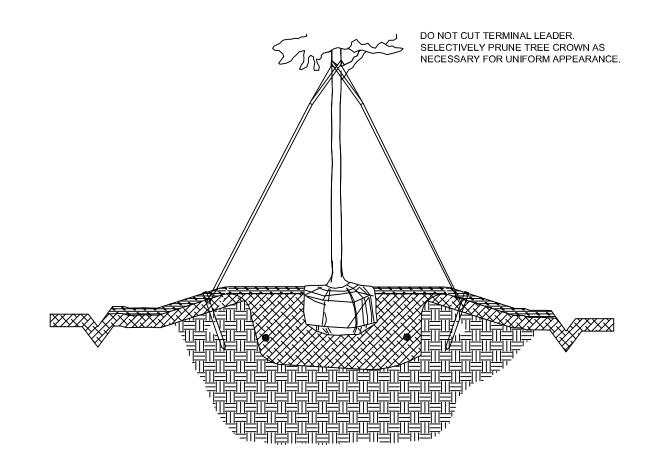

4 STAKED TREE (GENERAL)

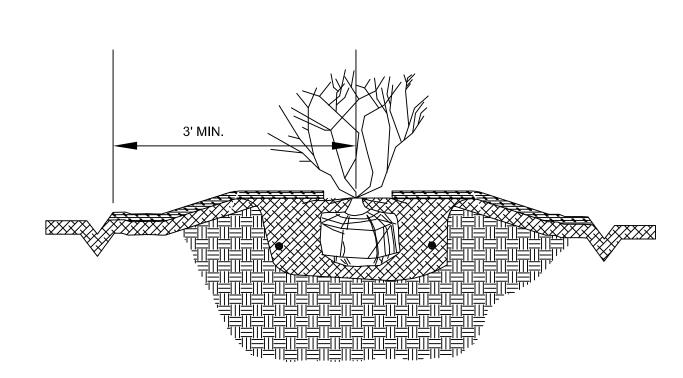

8 SHRUB (GENERAL)
NTS

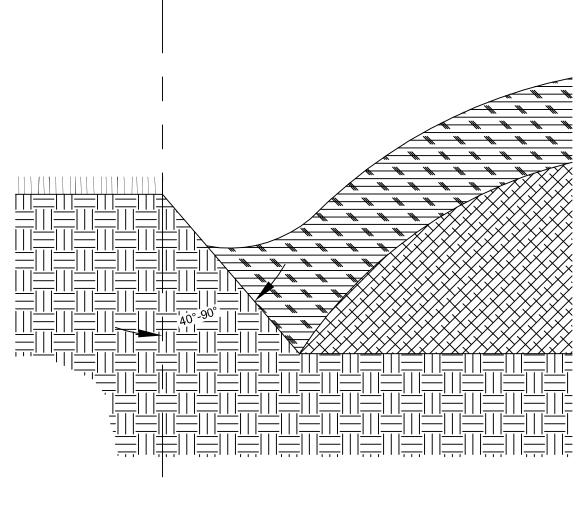


2 SHOVEL CUT BED EDGE


A = ROW SPACING

B = ON CENTER SPACING

INDICATED ON PLANT LIST.

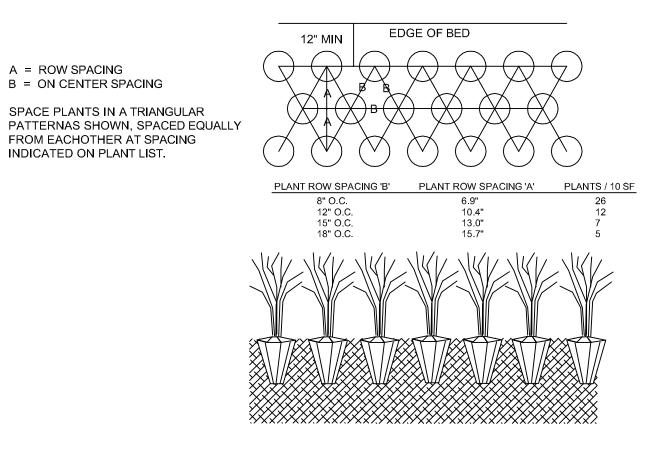


5 GROUNDCOVER PLANTING

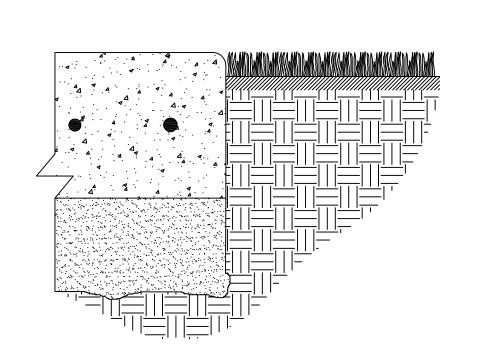


CONTRACTOR TO GRADE AREAS ADJACENT TO SIDEWALK AND


PAVEMENT SO THAT INSTALLED SOD OR LANDSCAPING DOES NOT

PREVENT POSITIVE DRAINAGE OFF OF SIDEWALK OR PAVEMENT.

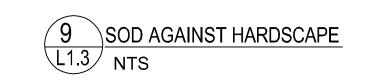


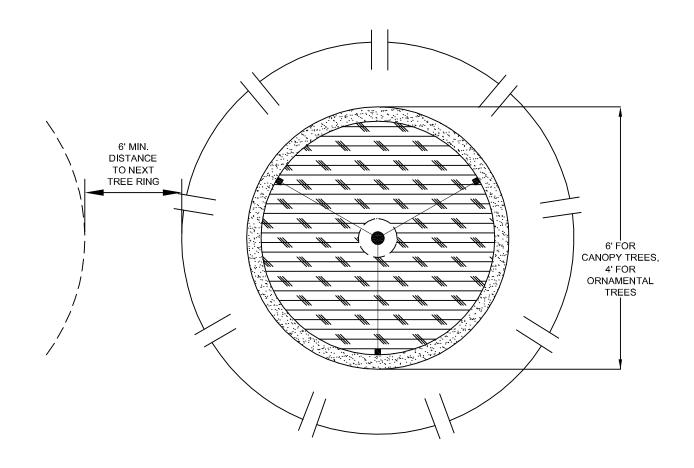

MULCHING RING AT TREES

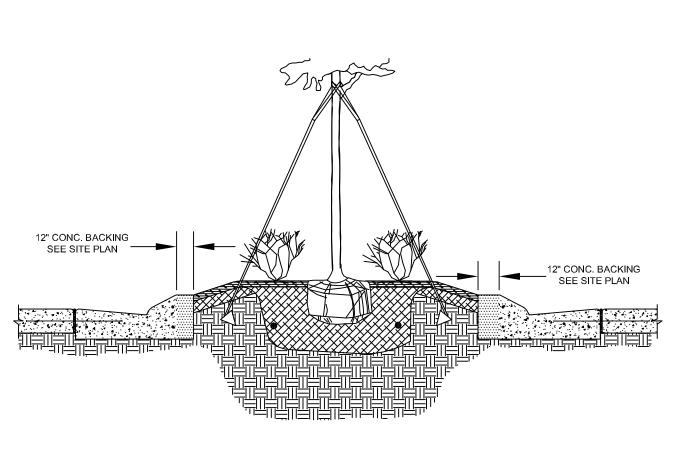

6 LANDSCAPE ISLAND BED (TYP)

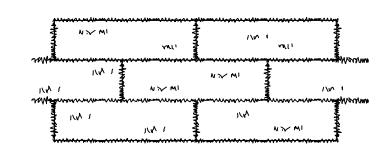

TIGHTLY AGAINST EACH OTHER. DO NOT LEAVE SPACES AND DO NOT OVERLAP A SHARPENED MASON'S TROWEL IS A HANDY TOOL FOR TUCKING DOWN THE ENDS AND TRIMMING PIECES.

NOTE: NO ROLLED SOD IN FLORIDA

FERTILIZER REQUIREMENTS FOR

SOIL SURFACE APPLICATION

(lbs/acre)

RATE RATE (lbs/sq SEASON

LAY SOD IN A STAGGERED PATTERN. BUTT THE STRIPS

APPEARANCE OF GOOD SOD

SHOOTS - OR GRASS BLADES. GRASS SHOULD BE GREEN AND HEALTHY, MOWED AT A 2"-3" CUTTING HEIGHT.
THATCH - GRASS CLIPPINGS AND DEAD LEAVES, UP TO 1/2" THICK.
ROOT ZONE - SOIL AND ROOTS SHOULD BE 1/2" - 3/4" THICK, WITH

BERMUDA GRASS DENSE ROOT MAT FOR TIFGREEN TIFLAWN FERTILIZER REQUIREMENTS FOR SOD PLANTING YEAR (N-P-K) RATE (lbs/acre) NITROGEN TOP DRESSING RATE CENTIPEDE WARM WEATHER ST. AUGUSTINE | BITTERBLUE | FIRST FERTILIZER FERTILIZER FERTILIZER RALEIGH SECOND RASSES MAINTENANCE 10-10-10 EMERALD WARM ZOYSIA MYER FIRST 6-12-12 1500 50-100 50-100 30 SEASON SECOND 10-10-10 1000 GRASSES MAINTENANCE | 10-10-10 |

10 SOD L1.3 NTS

SOD PLANTING REQUIREMENTS

AGENDA ITEMS: LANDSCAPE PRE-CON

- SCHEDULE a. ARE THE CONSTRUCTION PROJECT MANAGER, ENGINEERING PROJECT MANAGER, LANDSCAPE
- CONTRACTOR PRESENT? b. HAS A START DATE BEEN TARGETED AND TIME FRAMES LAID OUT?
- c. HAVE THE OTHER REQUIRED ON-SITE MEETINGS BEEN DISCUSSED?
- d. IS EVERYONE ON THE SAME PAGE MOVING FORWARD?

- a. WHO IS BRINGING IT TO THE SITE? b. WHEN SHOULD IT BE BROUGHT TO THE SITE?
- c. WHERE WILL IT BE STOCKPILED?

PLAN REVIEW


- a. HAS IT BEEN STRESSED THAT WE PREFER ROLLED SOD OVER SQUARE PALLETS WHERE
- b. ARE THE IRRIGATION SLEEVES IN THEIR PROPER LOCATION?
- c. WILL STRUCTURES / UTILITIES PREVENT THE IRRIGATION MAINLINE FROM BEING THREE (3) FEET OFF OF CURB?
- d. IS EVERYONE CLEAR ON HOW THE IRRIGATION TIES IN AND OUT OF THE BUILDING?

4. SUBMITTALS / APPROVALS


- a. IS THE LANDSCAPE CONTRACTOR CLEAR ON WHAT ALL NEEDS TO BE SELECTED (TAGGED) AND SEEN BEFORE SHOWING UP ON SITE? a.1. PICTURES OF SHRUBS, SOD, INDIVIDUAL TREES, ROCK MULCH, AND WOOD MULCH.
- PRICE SIGN LOCATION
- a. HAS THE SIGN SPOTTING BEEN DONE AND IS THE CURRENT LOCATION CONFIRMED? b. IF THE LOCATION MAY CHANGE, HAS IT BEEN DISCUSSED HOW EVERYONE WILL BE NOTIFIED?

c. DOES ANY LANDSCAPING AFFECT THE VISIBILITY OF THE SIGN?

- 6. MISCELLANEOUS
- a. HAVE CIRCUMSTANCES UNIQUE TO THE SITE BEEN DISCUSSED? b. DOES ANYONE AT THE MEETING HAVE ANY QUESTIONS OR CONCERNS ABOUT THEIR RESPONSIBILITIES MOVING FORWARD WITH THE PROJECT?

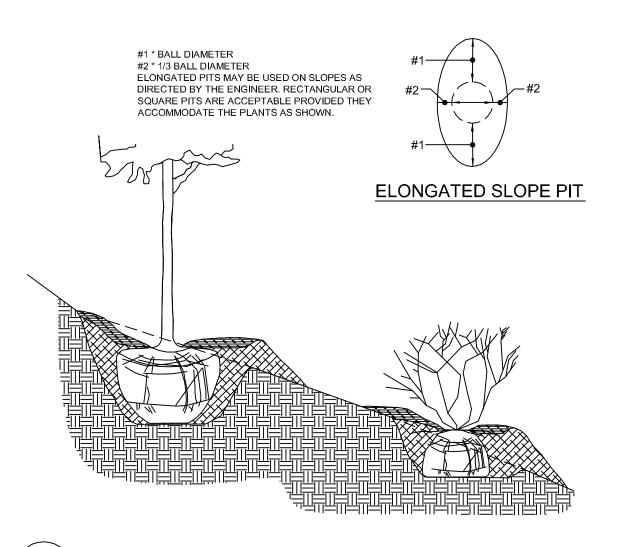

7 PLANT PLACEMENT ON SLOPE

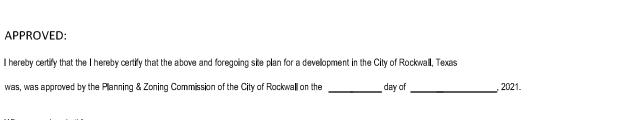

Witness our hands this

SITE PLAN SIGNATURE BLOCK

Planning & Zoning Commission, Chairman

Director of Planning and Zoning

landscape architects, inc. 1708 N. Griffin Street Dallas, Texas 75202 Tel 214.871.0083 Fax 214.871.0545 Email smr@smr-la.com


MEADOWCREEK BUSINESS CENTER


LOT 6R, BLOCK 1 - 8.240 Acres in J. CADLE ABST. A-207 IN THE CITY OF ROCKWALL, ROCKWALL COUNTY, TEXAS

> RaceTrac Petroleum, Inc. 3225 Cumberland Blvd., Suite 100 Atlanta, GA. 30339 Telephone (770) 431-7600 Contact: Andrew Malzer

ENGINEER/SURVEYOR Spiars Engineering, Inc. 765 Custer Road, Suite 100 Plano, TX 75075 TBPE No. F-2121 Telephone: (972) 422-0077 Contact: David Bond

L1.3

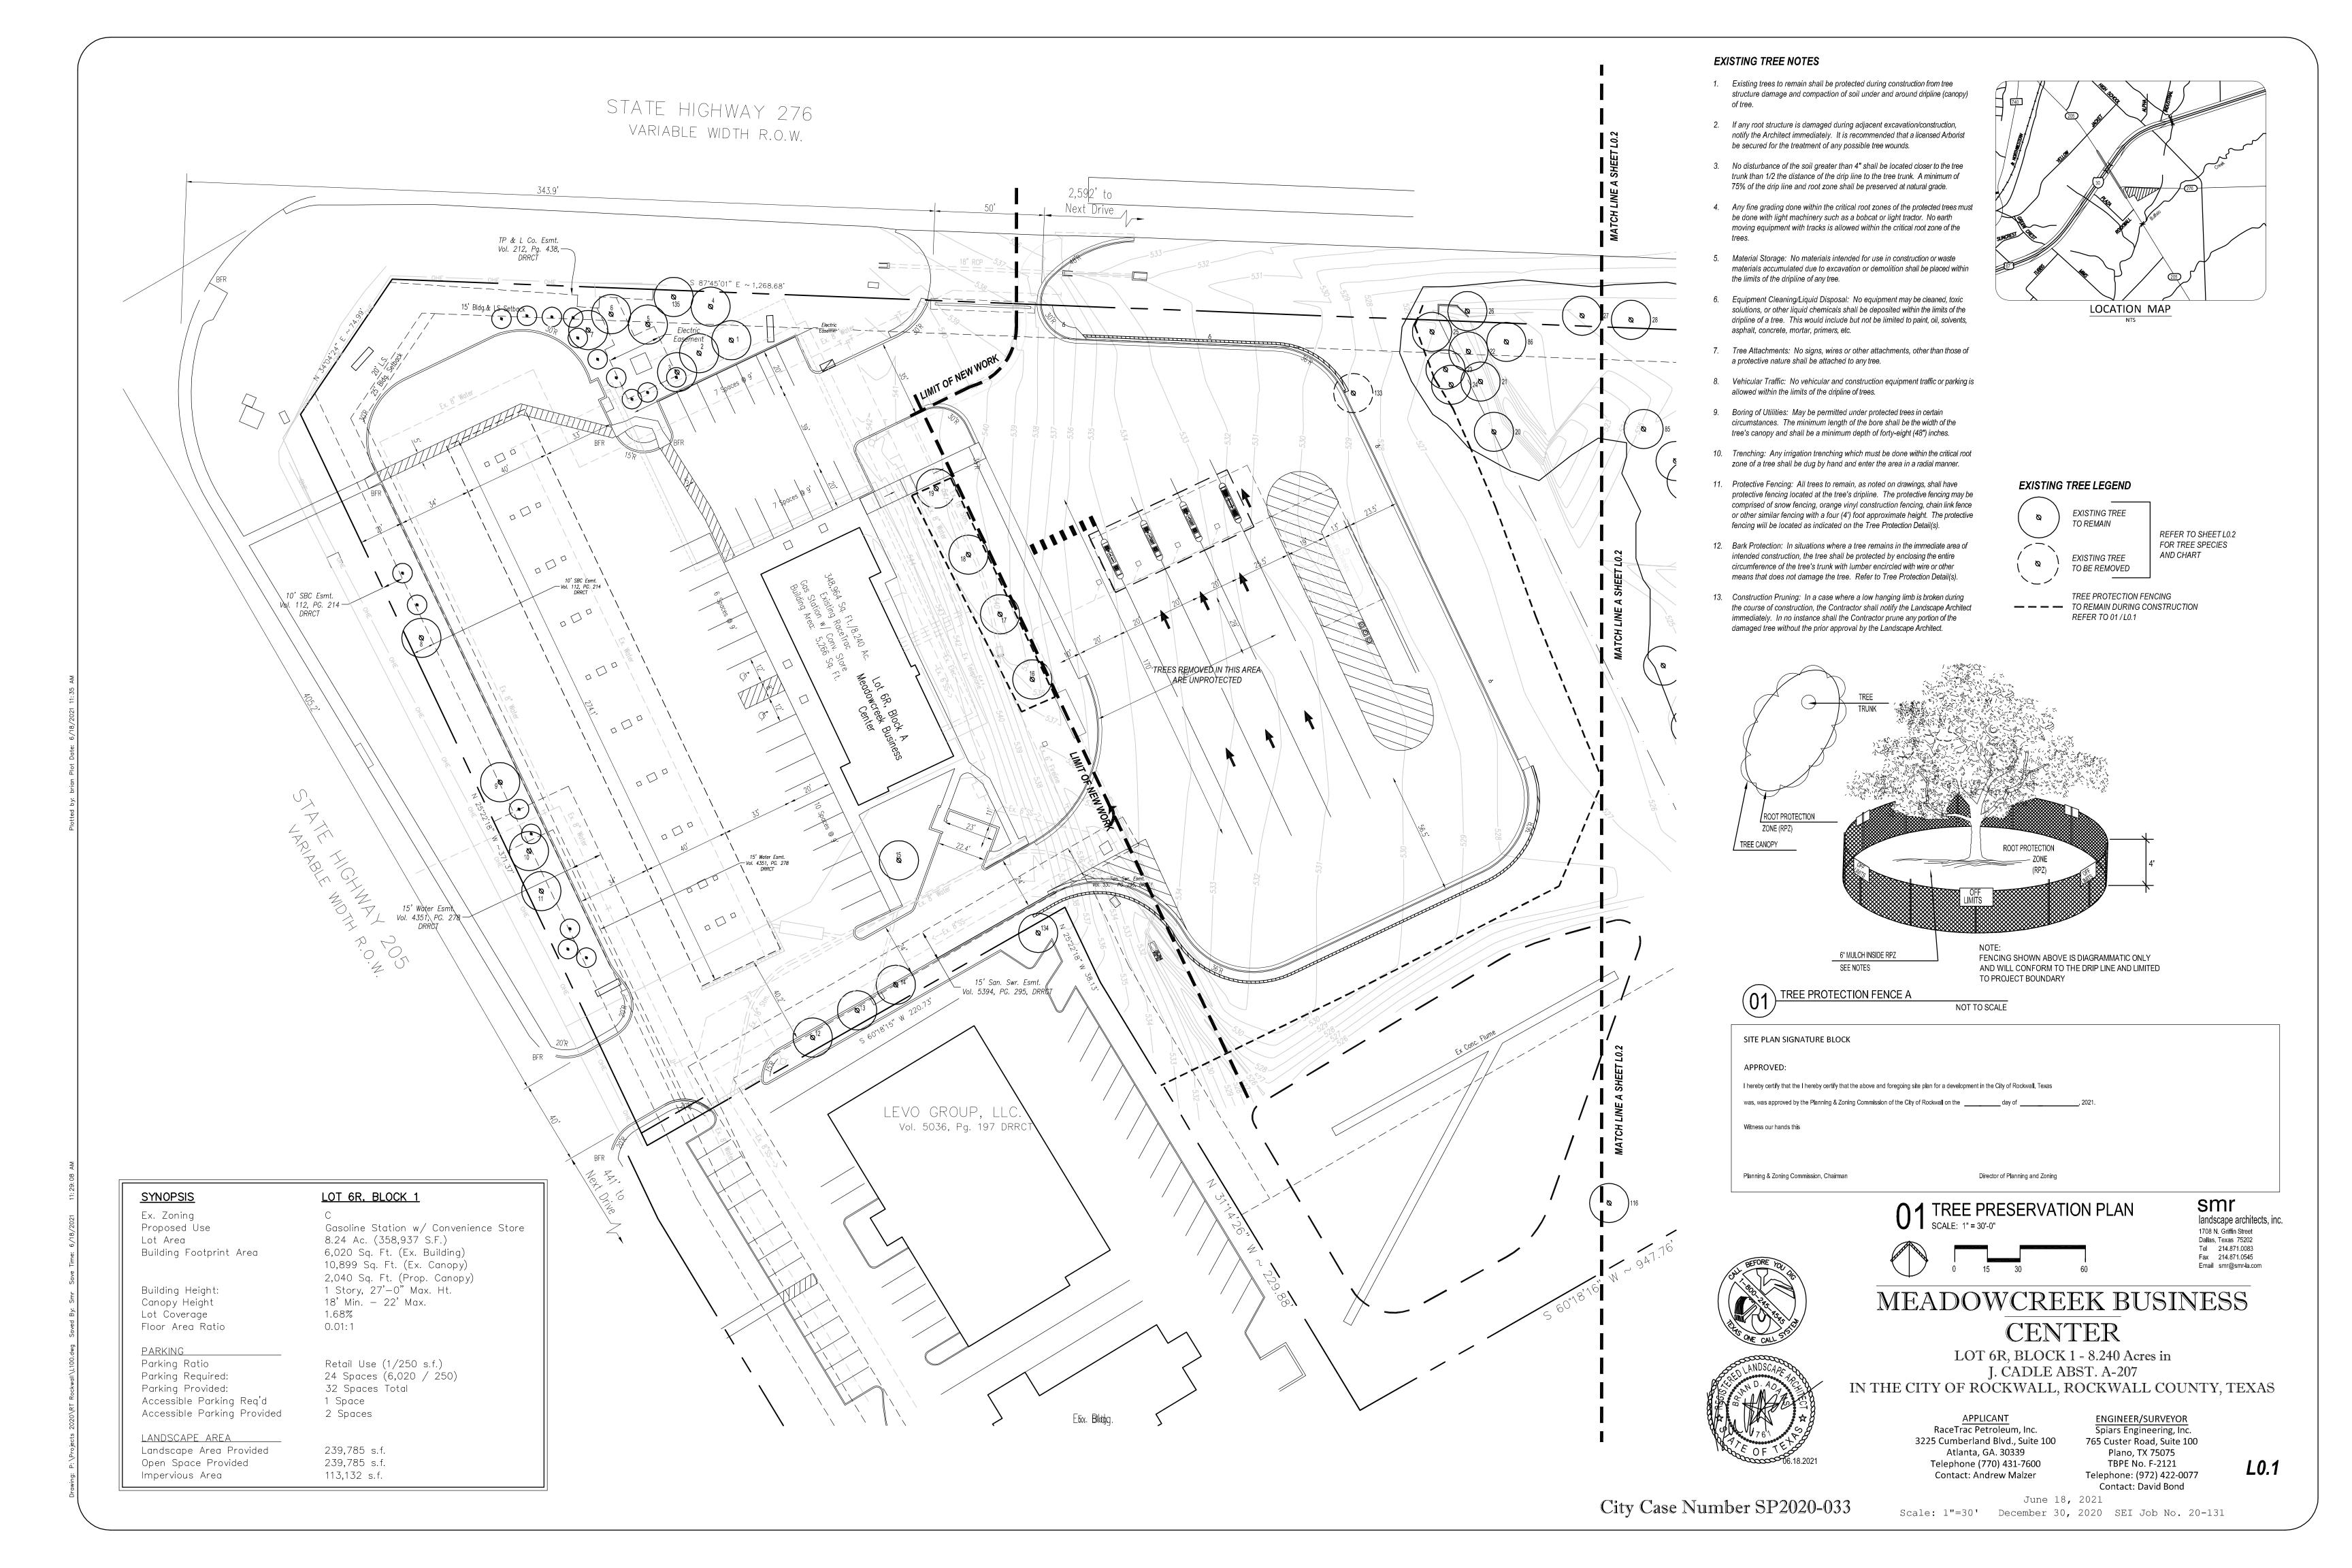

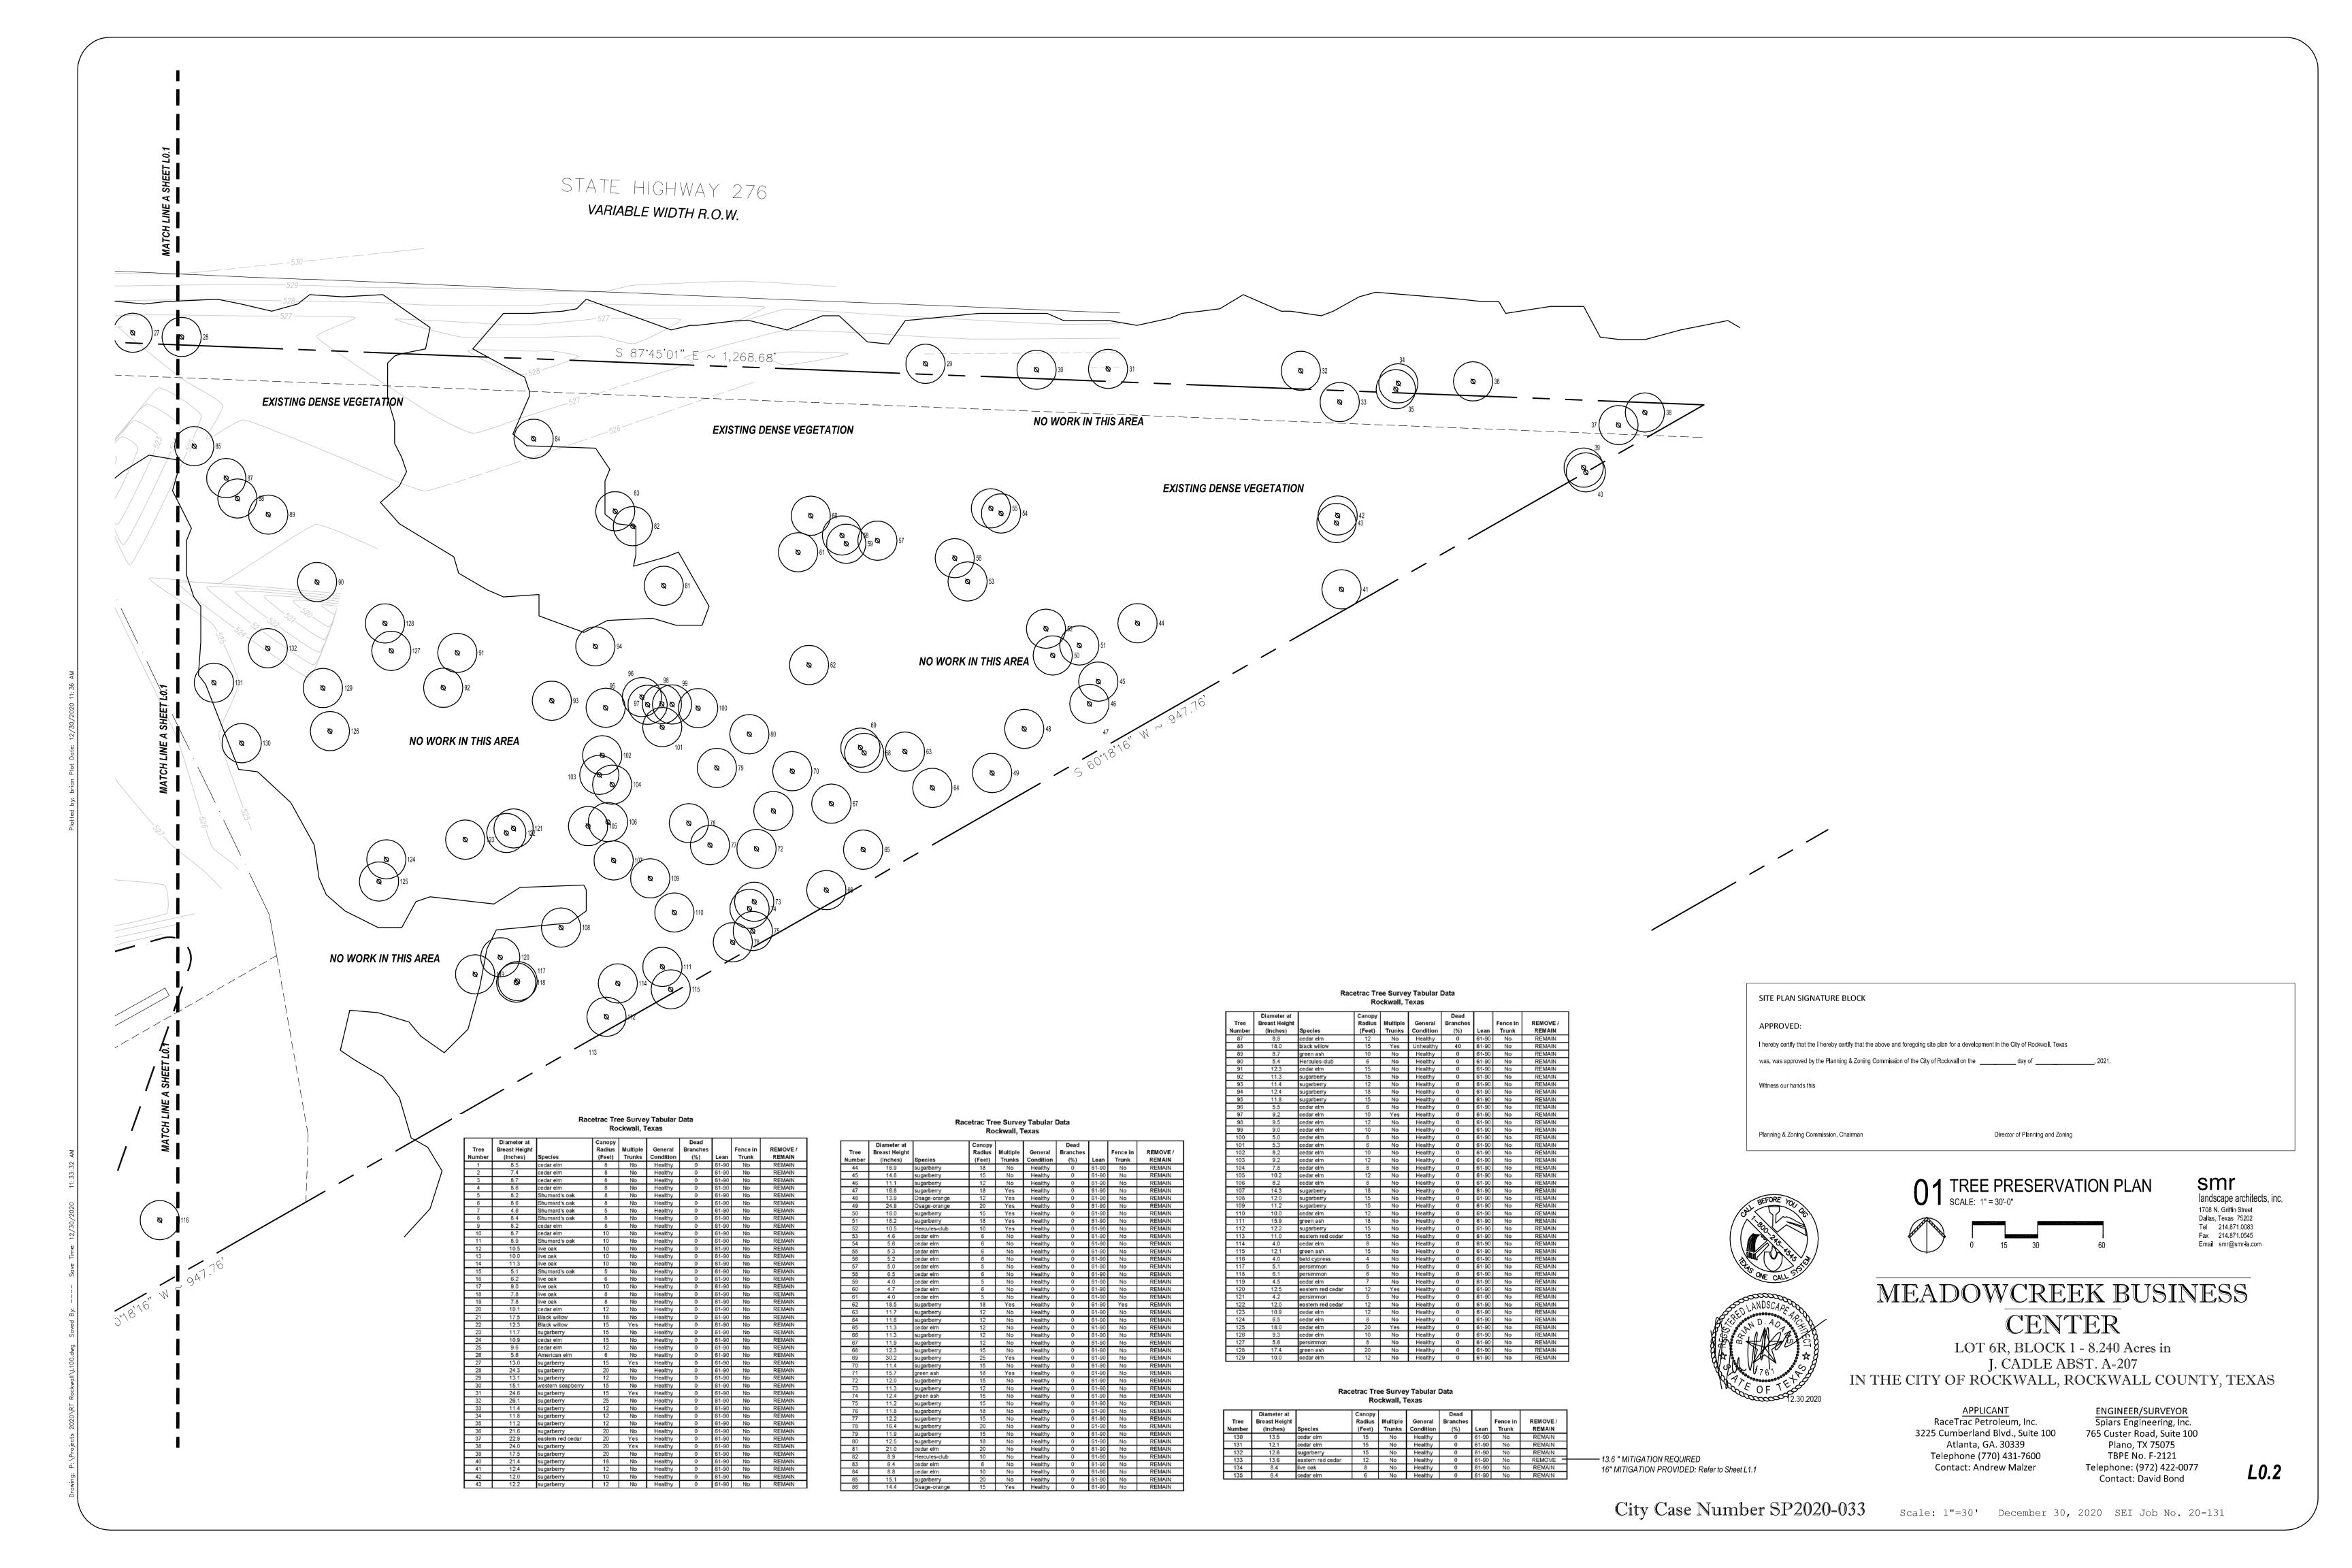

LUMINAIRE SCHEDULE								LUMII	NAIRE S	SCHE	DULE (C	ONT.)									
Symbol Label Qty Catalog Number	Description	Lamp	File	Lumens	LLF	Watts		Symbol	Label	Qty	Catalog Numb	er	Descripti	on		La	amp				File
705 40 SCV-LED-13L- SC-UNV-DIM- 50-WHT	SCOTTSDALE VERTEX PETROLEUM CANOPY LED LUMINAIRE	LEDS.	SCV-LED-13L -SC-50.IES	Absolute	1.00	84.3		â	702S (5 EXISTIN	8	MRM-LED-30L -SIL-FT-UNIV- -50-70CRI-IL	DIM	OUTDO	A - MRM OR LED A SHIELDED		LE	EDS.			-SIL	M-LED-30 FT-50 CRI-IL.IES
705B 8 SCV-LED-13L- 50-BRZ	SCOTTSDALE VERTEX PETROLEUM CANOPY LED LUMINAIRE WITH DARK BRONZE FINISH	LEDS.	SCV-LED-13L -SC-50.IES	Absolute	1.00	84.3		Â	501 (EXISTING	3	XWM-FT-LED- -50-UE-BRZ		MIRAND (XWM)	A WALL S	CONCE	LE	EDS.			LSI	XWM-FT
101EM 12 A2/B1-05 (EXISTING)	WITH BLACK TRIM AND RECESSED WHITE PLASTIC LENS	LEDS. LUMEN RATING = 648 LMS.	LR6.IES	647	1.00	11.5			502		XWM-FT-LED- -50-UE-BRZ		MIRAND (XWM)	A WALL S	CONCE	LE	EDS.				XWM-FT
507 10 SP2-STR-Y4.2050 (EXISTING) -FCO-MOD(KR6- -12LED)-DB	SPECTRA SMALL SCALE POST TOP LUMINAIRE FROSTED GLASS	12 LED ARRAY	SP2-STR-Y4-2050 -FCO-MOD (KB6 LED) -DB.IES	1517)	1.00	20			(EXISTING		-30-UE-BRZ		(AVVIVI)								-04-50.IE
		/+0.0 **0.0		JE SP-2	6.0	0.4	0.4		0.00					0.0			0.0			0.4	0.4
		+9.0 ×0.0 ×0.0	MATCHLIN ************************************	IE SP-1	+0.0 0.0 +0.1	+0.1	+0.2 +0.2	+0.3 ×0.	3 × ^{0.4} ×).4 x ^{0.4}	**************************************	* +	0.3 +0.3	+0.2 +0.2	.2 0.2	+0.2	+0.2	+0.2 +0	.2 +0.2	+0.2	+0.2 +0.2
		+ ** **	x0.0 x0.0 +0.0 +0.0 +0.	.0 1.0 +0	+0.2	+0.3	+0.4 +0.4	₩ ^{0.5} ж ^{0.}	6 x ^{0.6} x).6 x 0.6	3 x ^{0.5} x ^{0.4}	x ⁰ / ₄ +).3 +0.3	+0.2 +0	0.2	+0.2	+0.2	+0.2 +0	.2 +0.2	+0.2	+0.3 +0.3
		0.0 _0.0 _0.0 _0.0	*** + * + * + * + * * + * * * * * * * *	0.0 + ^{0.0} + ⁰	0.1 + 0.3	+0.5	+0.7 +0.8	1 0.8 x 0.	9 x ^{1.0} x).9 x 0.8	3 x ^{0.6} x ^{0.5}	x ^{0.4} +).3 + 0.3	+0.2 +0	0.2	+0.2	+0.2	+0.2 +0	.3 +0.3	+0.3	+0.4 +0.4
		* * * * * * * * * * * * * * * * * * *	2 5.0	+0.0 +0).2 + ^{0.7}	+1.0	+1.1 +1.2	1.3 x 1.	4 x ^{1.4} x	.3 x 1.0	x ^{0.8} x ^{0.5}	* \	+0.3	+0.3 +0	0.2	+0.2	+0.2	+0.3 +0.	.3 +0.4	+0.5	+0.5 +0.6
			0.0+0.0	+0.0 +0	D.3 +1.1	+1.5	+1.8 +2.	2.0 x 2.	1 x ^{1.9} x	1.7 x 1.3	x ^{0.9} x ^{0.6}	* +	0.4 + ^{0.3}	+0.3 +0	.3 0.3	+0.3	+0.3	+0.3 +0.	.4 +0.5	+0.7	+0.9 +0.9

DULE (CONT.)			GENERAL NOTES	STATISTICS						
Catalog Number	Description	Lamp	File Lumens LLF Watts	SERE WE HOTES	Description	Symbol	Avg	Max	Min	Max/Min	Avg/Min
MRM-LED-30L -SIL-FT-UNIV-DIM	MIRANDA - MRM OUTDOOR LED AREA	LEDS.	MRM-LED-30L -SIL-FT-50 Absolute 1.00 247	ALL FIXTURES UTILIZED IN THIS SITE PHOTOMETRIC PLAN ARE FULL CUTOFF.	Beyond Property Line	+	0.0 fc	0.3 fc	0.0 fc	N / A	N / A
-50-70CRI-IL	LIGHT (SHIELDED) -70CRI-IL.IES 2. MOUNT AREA LUMINAIRE TYPE '702S	2. MOUNT AREA LUMINAIRE TYPE '702S' AT 20'-0" AFG (INCLUDING POLE BASE)	Canopy	+	33.6 fc	49.0 fc	7.3 fc	6.7:1	4.6:1		
XWM-FT-LED-06L	MIRANDA WALL SCONCE	LEDS.		3. FILE NUMBERS PROVIDED FOR PHOTOMETRY REFERENCE ONLY. CATALOG NUMBERS SHALL BE UTILIZED FOR ORDERING FIXTURES.	Site	+	2.1 fc	25.5 fc	0.0 fc	N/A	N/A
-50-UE-BRZ	(XWM)		LSI XWM-FT-LED Absolute 1.00 59 -06-50.IES	4. COLOR TEMPERATURE OF FIXTURES SHALL BE PROVIDED AS FOLLOWS	Vehicle	ж	5.1 fc	25.5 fc	0.0 fc	N/A	N/A
XWM-FT-LED-04L	MIRANDA WALL SCONCE	LEDS		4.1. AREA LIGHTING - 5700K 4.2. BUILDING MOUNTED - 5700K	Property Line	+	0.1 fc	1.2 fc	0.0 fc	N/A	N/A
-50-UE-BRZ	(XWM)	4.1. AREA LIGHTING - 5700K	4.4. CANOPY - 5700K	EDO Canopy	+	20.6 fc	26.4 fc	8.9 fc	3.0:1	2.3:1	
					Vehicle (EDO)	ж	2.5 fc	19.7 fc	0.0 fc	N/A	N/A
II	I	ı			1					N. I. N. E. O.D. O.	

STATISTICS						
Description	Symbol	Avg	Max	Min	Max/Min	Avg/Min
Beyond Property Line	+	0.0 fc	0.3 fc	0.0 fc	N/A	N/A
Canopy	+	33.6 fc	49.0 fc	7.3 fc	6.7:1	4.6:1
Site	+	2.1 fc	25.5 fc	0.0 fc	N/A	N/A
Vehicle	ж	5.1 fc	25.5 fc	0.0 fc	N/A	N/A
Property Line	+	0.1 fc	1.2 fc	0.0 fc	N/A	N/A
EDO Canopy	+	20.6 fc	26.4 fc	8.9 fc	3.0:1	2.3:1
Vehicle (EDO)	*	2.5 fc	19.7 fc	0.0 fc	N/A	N/A

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GPD Group, Professional Corporation Texas Registration No. 16477

ISSUE/REVISION RECORD DATE DESCRIPTION 04/10/20 PERMIT SET

05/26/20 REFRESH FOR CONST

200 GALLERIA PARKWAY SOUTHEAST SUITE 900 ATLANTA, GEORGIA 30339 (770) 431-7600

PROJECT NAME

ROCKWALL

ROCKWALL

2301 S GOLIAD ST

TBSL REMODEL

SPB NO.

RACETRAC STORE NUMBER

PROTOTYPE SERIES 5.5K 2.0

PLAN MODIFICATION NOTICE

STANDARD PLAN BULLETINS (SPB) MODIFY THE

LISTS ANY REVISIONS OR SPB INCORPORATED IN

PROFESSIONAL SEAL

STEVEN P. SCHAUB

PROJECT NUMBER 2020127.18

PHOTOMETRY

SHEET NUMBER

SHEET TITLE


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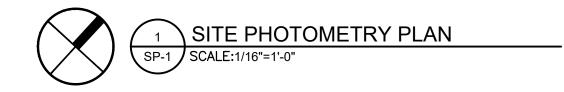
PLAN

DATE

#0585

TX 75032



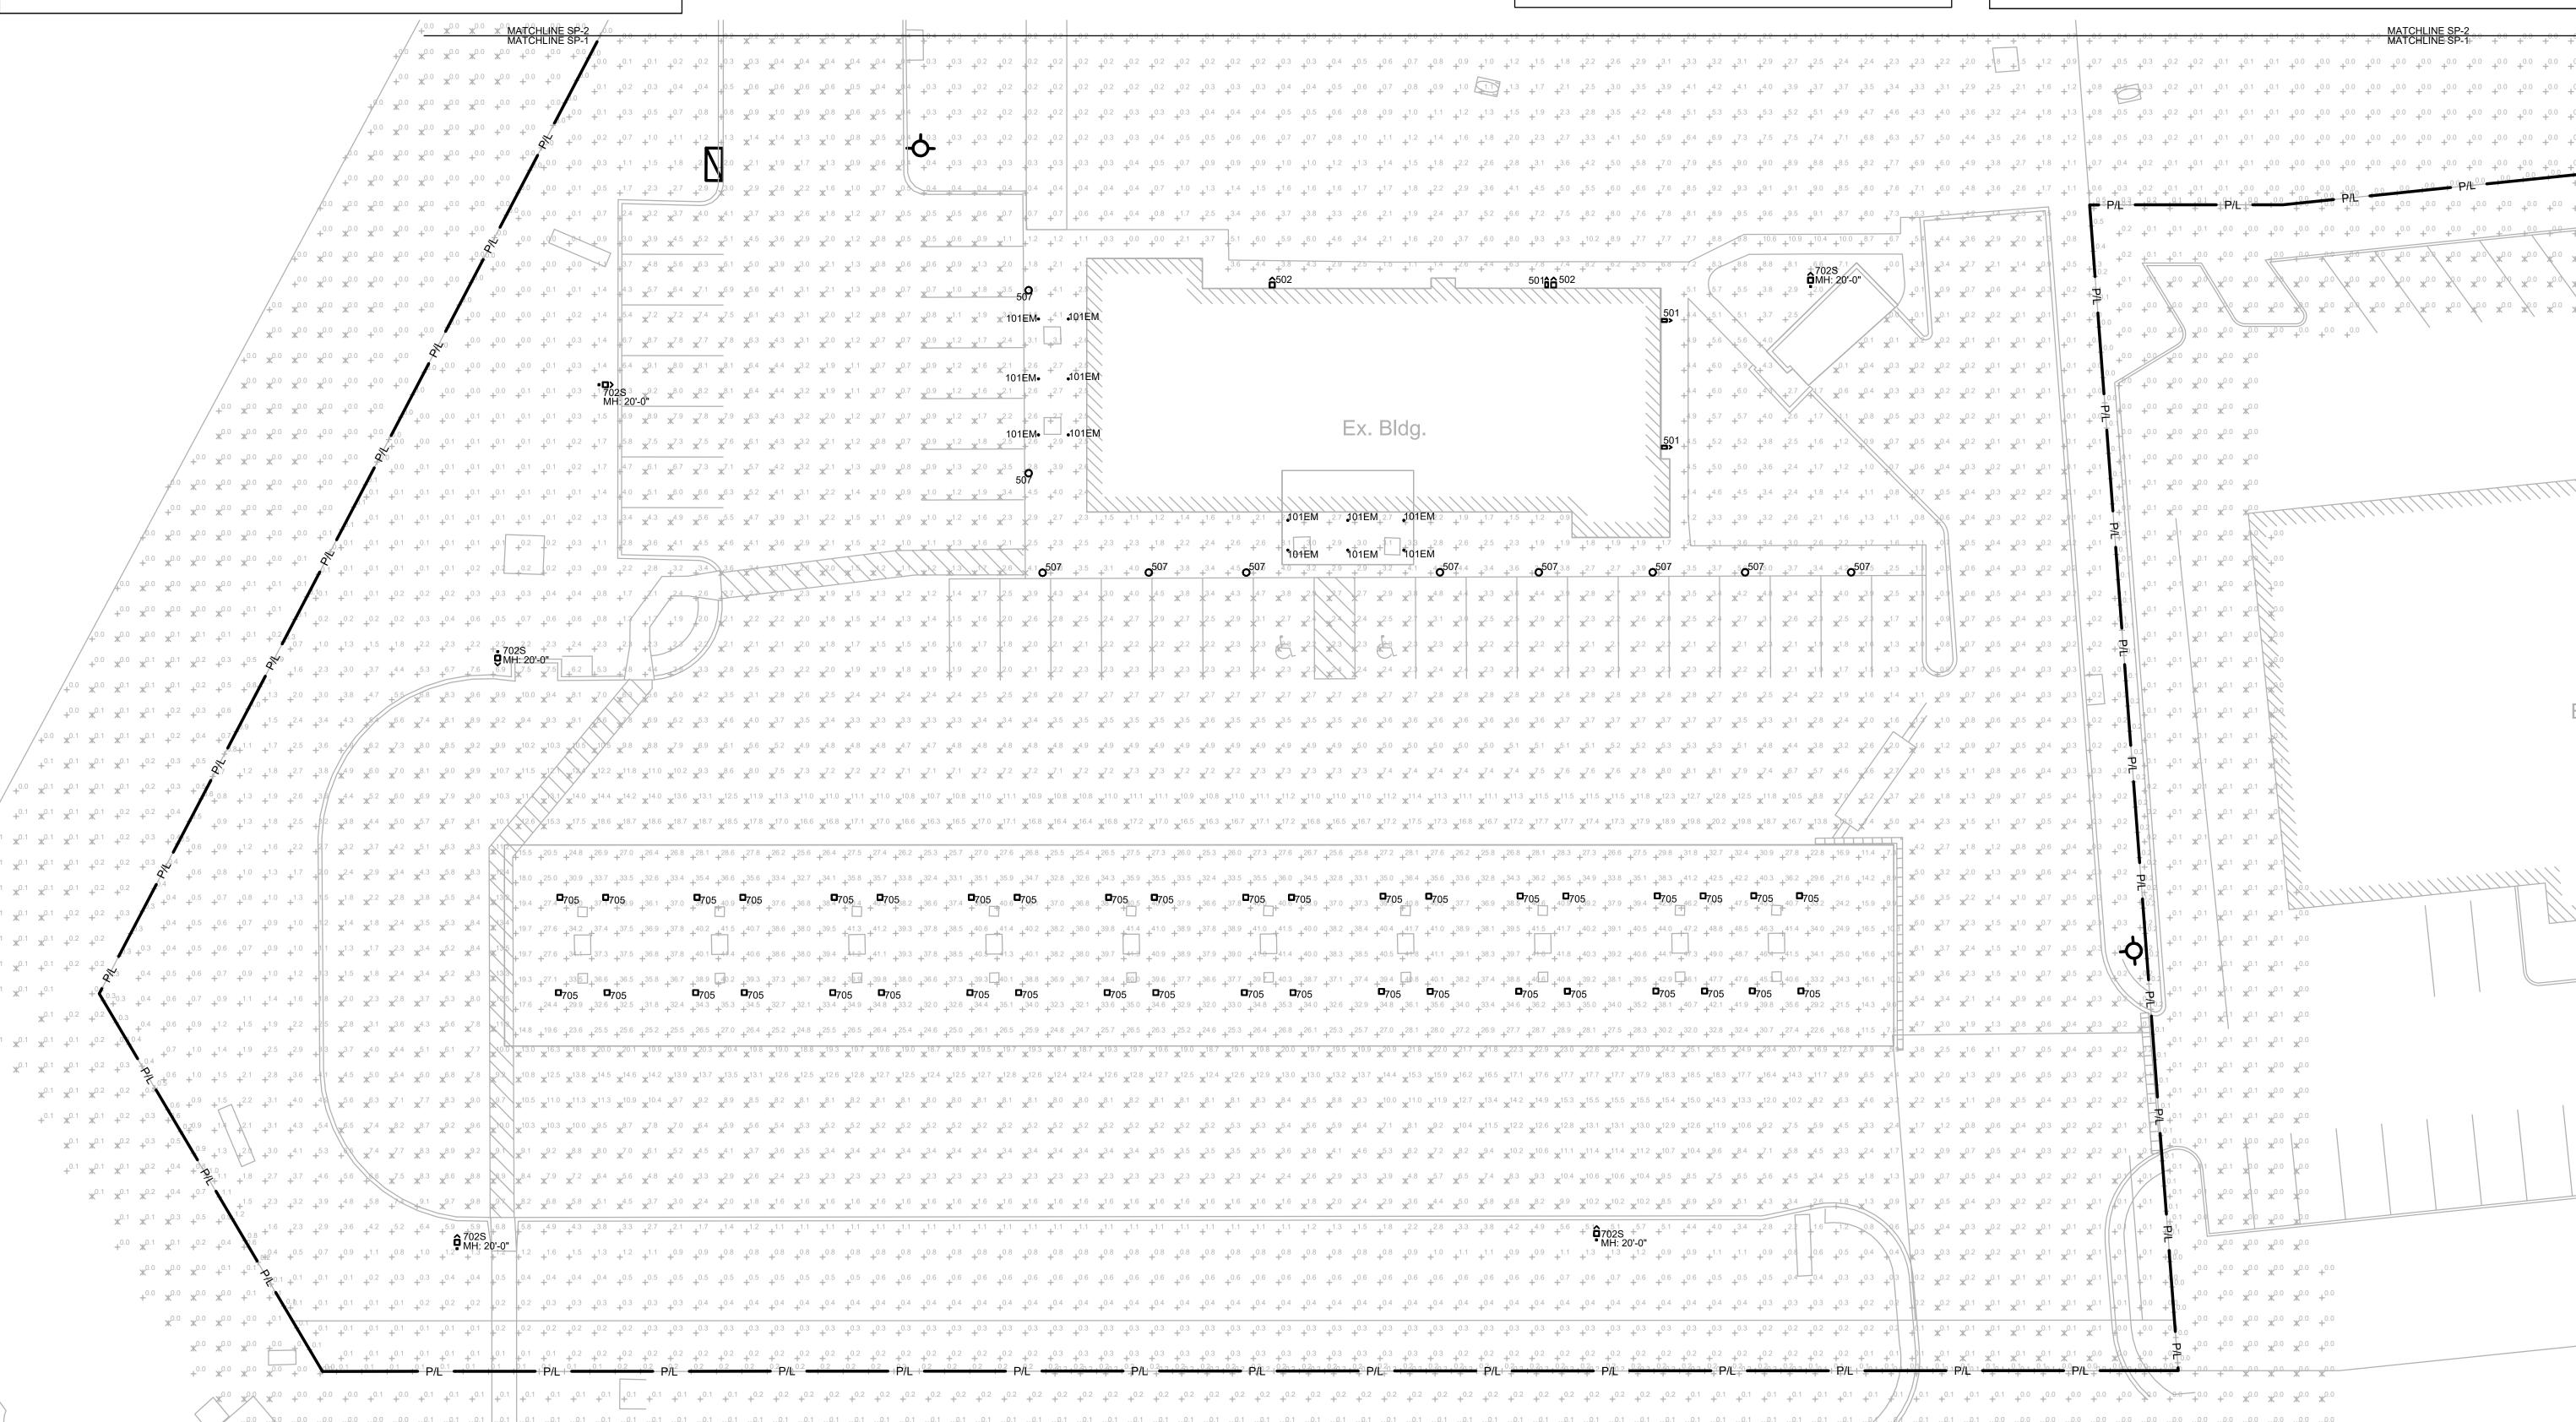


"This submittal is for general informational purposes only and is preliminary in nature. As such, any other use or reliance is strictly prohibited."


CITY CASE NUMBER: SP2020-033

LUMINAIRE SCHEDULE		LUMINAIRE SCHEDULE (CONT.)			GENERAL NOTES	STATISTICS					Pacellac. COPYRIGHT NOTICE THESE PLANS ARE SUBJECT TO FEDERAL
Symbol Label Qty Catalog Number Description Lamp SCV-LED-13L- SCOTTSDALE VERTEX LEDS.	File Lumens LLF Watts	MRMJ ED 301 M	Description Lamp MIRANDA - MRM LEDS.	File Lumens LLF Watts MRM-LED-30L -SII -FT-50 Absolute 1.00 247	ALL FIXTURES UTILIZED IN THIS SITE PHOTOMETRIC PLAN ARE FULL CUTOFF.	Description Beyond Property Line	Symbol Avg + 0.0 fc	0.3 fc	Min Max/Min 0.0 fc N / A	Avg/Min N / A	COPYRIGHT LAWS: ANY USE OF SAME WITHOUT THE EXPRESSED WRITTEN PERMISSION OF RACETRAC PETROLEUM,
(EXISTING) 40 SC-UNV-DIM- PETROLEUM CANOPY LED LUMINAIRE	SCV-LED-13L Absolute 1.00 84.3 -SC-50.IES	702S 8 -SIL-FT-UNIV-DIM O (5 EXISTING) -50-70CRI-IL LI	OUTDOOR LED AREA LIGHT (SHIELDED)	-SIL-FT-50 Absolute 1.00 247 -70CRI-IL.IES	2. MOUNT AREA LUMINAIRE TYPE '702S' AT 20'-0" AFG (INCLUDING POLE BASE)	Canopy	+ 33.6 fc	49.0 fc	7.3 fc 6.7:1	4.6:1	INC. IS PROHIBITED. 2016 RACETRAC PETROLEUM INC.
SCV-LED-13L- SCOTTSDALE VERTEX LEDS. 705B 8 SC-UNV-DIM- PETROLEUM CANOPY 50-BRZ LED LUMINAIRE WITH DARK BRONZE FINISH	SCV-LED-13L Absolute 1.00 84.3 -SC-50.IES	XWM-FT-LED-06L M 501 3 -50-UE-BRZ ()	MIRANDA WALL SCONCE LEDS.	LSI XWM-FT-LED Absolute 1.00 59	FILE NUMBERS PROVIDED FOR PHOTOMETRY REFERENCE ONLY. CATALOG NUMBERS SHALL BE UTILIZED FOR ORDERING FIXTURES.	Site	+ 2.1 fc	25.5 fc	0.0 fc N/A	N/A	DESIGN PROFESSIONALS
WITH BLACK TRIM AND LEDS. LUMEN RATING = 101EM 12 A2/B1-05 RECESSED WHITE 648 LMS.	: LR6.IES 647 1.00 11.5	(EXISTING)	(XVVM)	-06-50.IES	4. COLOR TEMPERATURE OF FIXTURES SHALL BE PROVIDED AS FOLLOWS 4.1. AREA LIGHTING - 5700K 4.2. BUILDING MOUNTED - 5700K	Vehicle Property Line	+ 0.1 fc	25.5 fc 1.2 fc	0.0 fc N/A 0.0 fc N/A	N/A N/A	
	CD2 CTD VA 2050 4547 4 00 20	$\begin{array}{c ccccccccccccccccccccccccccccccccccc$	MIRANDA WALL SCONCE LEDS. (XWM)	LSI XWM-FT-LED Absolute 1.00 40 -04-50.IES	4.2. BOILDING MOUNTED - 5700K 4.3. DECORATIVE POLE - 5000K 4.4. CANOPY - 5700K 4.5. CANOPY DOWNLIGHTS - 4000K	EDO Canopy	+ 20.6 fc	26.4 fc	8.9 fc 3.0:1	2.3:1	
507 10 SP2-STR-Y4.2050 FCO-MOD(KR6-12LED)-DB SPECTRA SMALL SCALE POST TOP LUMINAIRE FROSTED GLASS	SP2-STR-Y4-2050 1517 1.00 20 -FCO-MOD (KB6 LED) -DB.IES					Vehicle (EDO)	★ 2.5 fc	19.7 fc	0.0 fc N/A	N/A	GPD GROUP Professional Corporation
$\begin{array}{cccccccccccccccccccccccccccccccccccc$	+0.0		0.0	400 400 400 400 400 400 400 400 400 400	25. 45. 56. 76. 45. 56. 56. 56. 56. 56. 56. 56. 56. 56. 5	**************************************	**************************************	+0.0 +0.0 +0.0 +0.0 +0.0 +0.0 +0.0 +0.0			GPD Group, Professional Corporation Texas Registration No. 16477 ISSUE/REVISION RECORD DATE DESCRIPTION 04/10/20 PERMIT SET 05/26/20 REFRESH FOR CONST. 01/05/21 PHOTOMETRIC PLAN RAGETRAC PETROLEUM, INC. 200 GALLERIA PARKWAY SOUTHEAST SUITE 800 ATLANTA, GEORGIA 30339 (770) 431-7600 PROJECT NAME ROCKWALL TX 75032 2301 S GOLIAD ST RAGETRAC STORE NUMBER #0585 PROTOTYPE SERIES 5.5K 2.0 TBSL REMODEL PLAN MODIFICATION NOTICE SPB NO. DATE STANDAD PLAN BULLETIS (SPB) MODIFY THE PROTOTYPE SERIES SET AT ORIGINAL RELEASE. THE ISSUE SET AT ORIGINAL RELEASE. CONTACT RACETRAC BY INCOMPORATED IN THIS PROTOTYPE SERIES SET AT ORIGINAL RELEASE. CONTACT RACETRAC BY INCOMPORATED IN THIS PROTOTYPE SERIES SET AT ORIGINAL RELEASE. CONTACT RACETRAC HORIGINERIUM AND CONSTRUCTION FOR ANY SUSSEQUENT BULLETIS ONT HOROPORATED HEREIN. PROFESSIONAL SEAL E OF 7 C. STEVEN P SCHAUB 114023 114023 114023 114023 SHEET TITLE SHEET TITLE




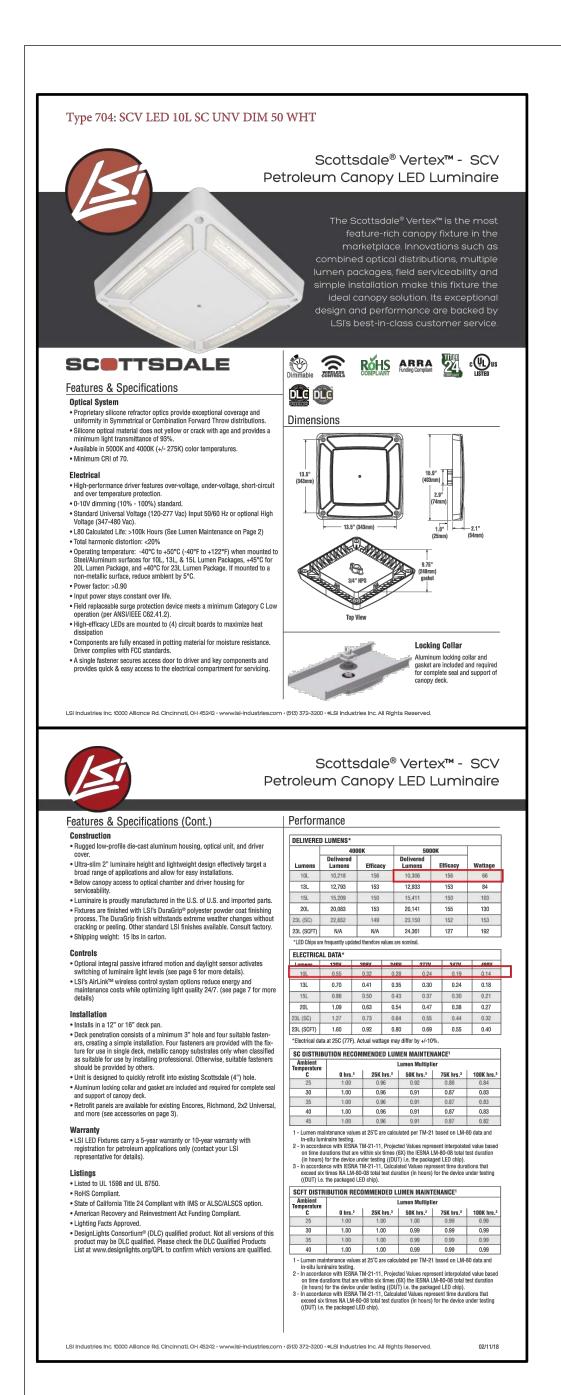



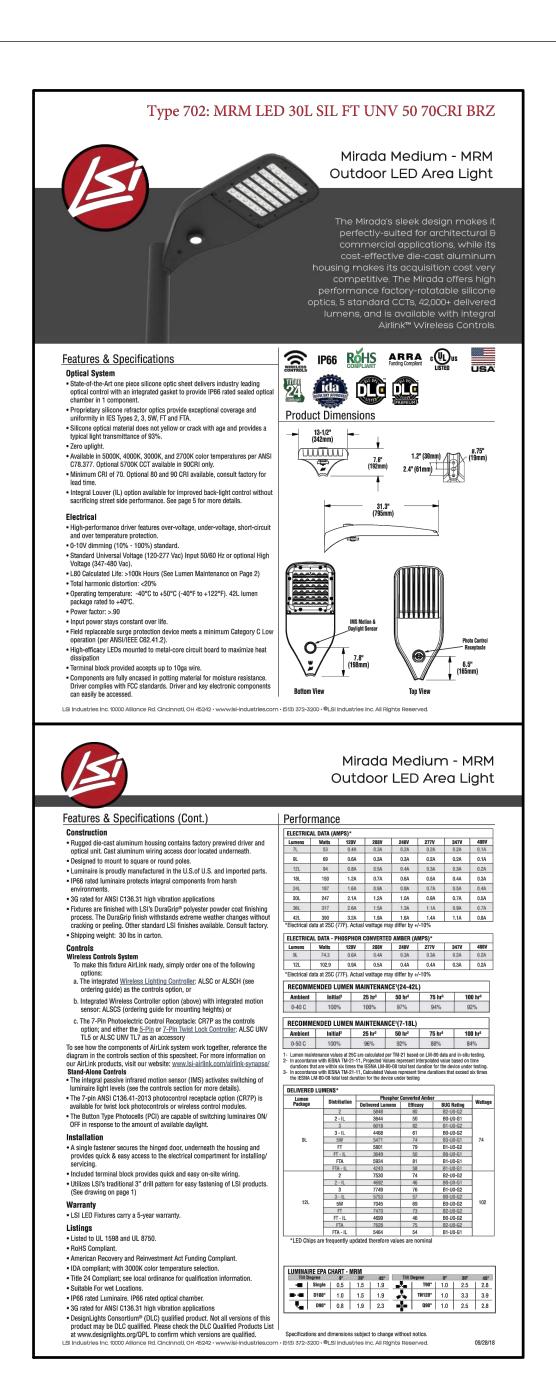



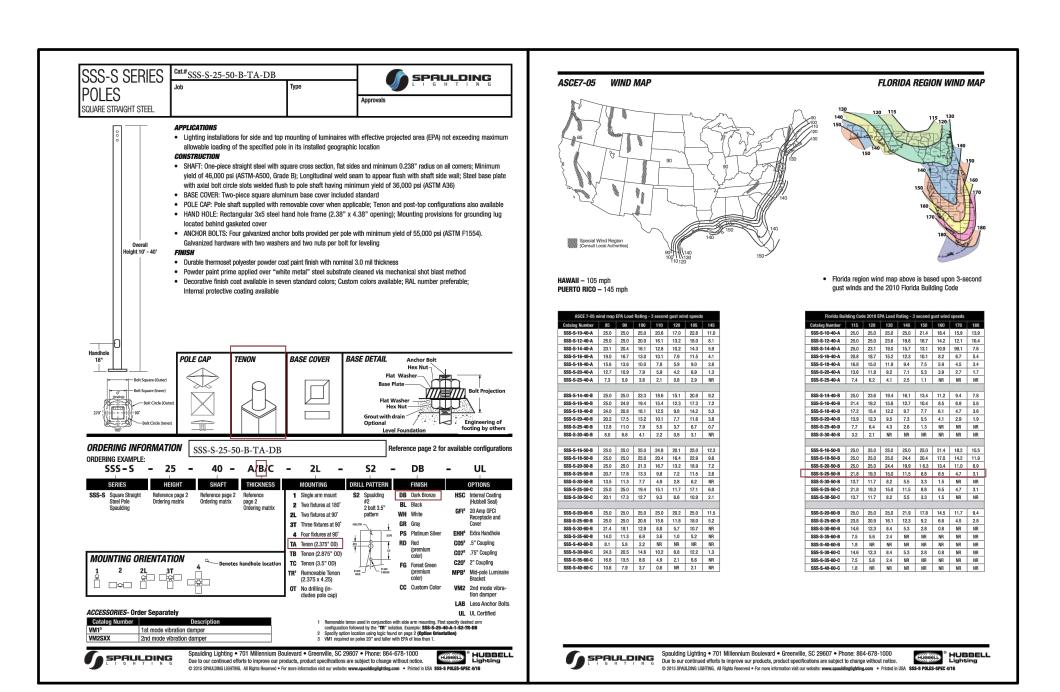



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DESIGN PROFESSIONALS



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ISSUE/REVISION RECORD

DATEDESCRIPTION04/10/20PERMIT SET

05/26/20 REFRESH FOR CONST. 01/05/21 PHOTOMETRIC PLAN

Deceller

RACETRAC PETROLEUM, INC. 200 GALLERIA PARKWAY SOUTHEAST SUITE 900 ATLANTA, GEORGIA 30339 (770) 431-7600

PROJECT NAME

ROCKWALL

ROCKWALL TX 75032

2301 S GOLIAD ST

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PROTOTYPE SERIES 5.5K 2.0

TBSL REMODEL

PLAN MODIFICATION NOTICE SPB NO. DATE

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BULLETINS NOT INCORPORATED HEREIN.

PROFESSIONAL SEAL

FOR REFERENCE ONLY

PROJECT NUMBER 2020|27.|8

SHEET TITLE

SITE PHOTOMETRY CUT SHEETS

SHEET NUMBER

SP-3