


DEVELOPMENT APPLICATION

City of Rockwall
Planning and Zoning Department
385 S. Goliad Street
Rockwall, Texas 75087

STAFF USE ONLY PLANNING & ZONING CASE	NO.
NOTE: THE APPLICATION IS CITY UNTIL THE PLANNING SIGNED BELOW.	NOT CONSIDERED ACCEPTED BY THE DIRECTOR AND CITY ENGINEER HAVE
DIRECTOR OF PLANWING:	
CITY ENGINEER:	

PLEASE CHECK THE	APPROPRIATE BOX BELOW T	O INDICATE THE TYPE O	F DEVELOPMENT REC	UEST ISE	LECT OF	VLY ONE BOX	Q:	
☐ PRELIMINARY II ☐ FINAL PLAT (83 ☐ REPLAT (8300.0 ☐ AMENDING OR ☐ PLAT REINSTA*	(\$100.00 + \$15.00 ACRE) 1 PLAT (\$200.00 + \$15.00 ACRE) 00.00 + \$20.00 ACRE) 1 10 + \$20.00 ACRE) 1 MINOR PLAT (\$150.00) TEMENT REQUEST (\$100.00)	ZONING APPLICATION FEES: ZONING CHANGE (\$200.00 + \$15.00 ACRE) SPECIFIC USE PERMIT (\$200.00 + \$15.00 ACRE) PD DEVELOPMENT PLANS (\$200.00 + \$15.00 ACRE) OTHER APPLICATION FEES: TREE REMOVAL (\$75.00) VARIANCE REQUEST/SPECIAL EXCEPTIONS (\$100.00) HOTES						
	CATION FEES: 0.00 + \$20.00 ACRE) PLAN/ELEVATIONS/LANDSC/	PER ACRE AMOUNT A \$1,000.00 FEE W	THE DETERMINING THE FEE PLEASE USE THE EXACT ACREAGE WHEN MULTIPLYING BY THE PER ACRE AMOUNT, FOR REQUESTS ON LESS THAN ONE ACRE, ROUND UP TO ONE (1) ACRE. A 11.000.09 FEE WILL BE ADDED TO THE APPLICATION FEE FOR ANY REDUEST THAT INVOLVES CONSTRUCTION WITHOUT OR NOT IN COMPLIANCE TO AN APPROVED BUILDING					
PROPERTY INFO	RMATION (PLEASE PRINT)							
ADDRES	950 & 962 E	. Ralph Hall Pkw	y. Rockwall, T	X 7503	32			
SUBDIVISION	ROCKWALL BUS	SINESS PARK EAS	ST	L	ОТ	13	BLOCK	
GENERAL LOCATION	RALPH HALL	PKWY, TX						
ZONING. SITE PI	LAN AND PLATTING IN	IFORMATION IPLEAS	E PRINTI					
CURRENT ZONIN			CURRENT USE	С				
PROPOSED ZONING			PROPOSED USE	1777				
ACREAGI	2.649	LOTS [CURRENT]	1		LOTS	PROPOSEDI		
REGARD TO ITS RESULT IN THE D	<u>D PLATS</u> : BY CHECKING THIS B APPROVAL PROCESS. AND FAIL DENIAL OF YOUR CASE.	URE TO ADDRESS ANY OF	STAFF'S COMMENTS BY	THE DATE	PROVIDI	ED ON THE DE	VELOPMENT C	EXIBILITY WITH ALENDAR WIL
	ANT/AGENT INFORMA		4					
TOWNER		ROPERTIES LLC	M APPLICANT				eal Estate L	LC.
CONTACT PERSON	Naomi Freeman		CONTACT PERSON	14/12	ada Nev			
ADDRESS	12050 Research Rd		ADDRESS	8113	Central	Expresswa	y. Suite 306	
A.T. A.T. A. T. A. T. A.	#9305		COLUCTATE & 21D	Disk and		v 76000		
CITY, STATE & ZIP	Frisco, TX 75033		CITY, STATE & ZIP PHONE		ason, 17 396-373	X- 75080		
PHONE E-MAIL	4692334774 afreeman@pinnaclem	nontessori com	E-MAIL			fbuilding.co	m	
NOTARY VERIFI BEFORE ME, THE UNDE STATED THE INFORMAT THEREBY CERTIFY THAT MECCH WECQUATOM CONTAINS	CATION [REQUIRED] RSIGNED AUTHORITY, ON THIS E HON ON THIS APPLICATION TO BE TAM THE OWNER FOR THE PURPL TO COVER THE CO 22 Y SY SIGNING THIS APPLICATION TO SEE	DAY PERSONALLY APPEARE: E TRUE AND CERTIFIED THE OSE OF THIS APPLICATION: AL OST OF THIS APPLICATION, HA WE THIS APPLICATION, I AGRI	D NAOYNI FU FOLLOWING: LL INFORMATION SUBMIT IS BEEN PAID TO THE CITY OF BO LA SO AUTHORIZED AND	(<u> </u>	AYALLONTE. CITY	AND CORRECT. HIS THE IS AUTHORIZED PRODUCE ANY	AND THE APPL O AND PERMITI Y COPYRISHTE	ICATION FEE O DAY O ED TO PROVID
	TION WITH THIS APPLICATION, IF S AND SEAL OF OFFICE ON THIS OWNER'S SIGNATURE	1 1	2	TO A REOL	Соти	nonwealth of PATRICIA LA Bu	Pennsylvania PORTA - Notai Icks County Expires Mare	y Public
NOTARY PUBLIC IN AND	FOR THE STATE OF TEXAS	Poten N. Las	Park				ng Number 13	

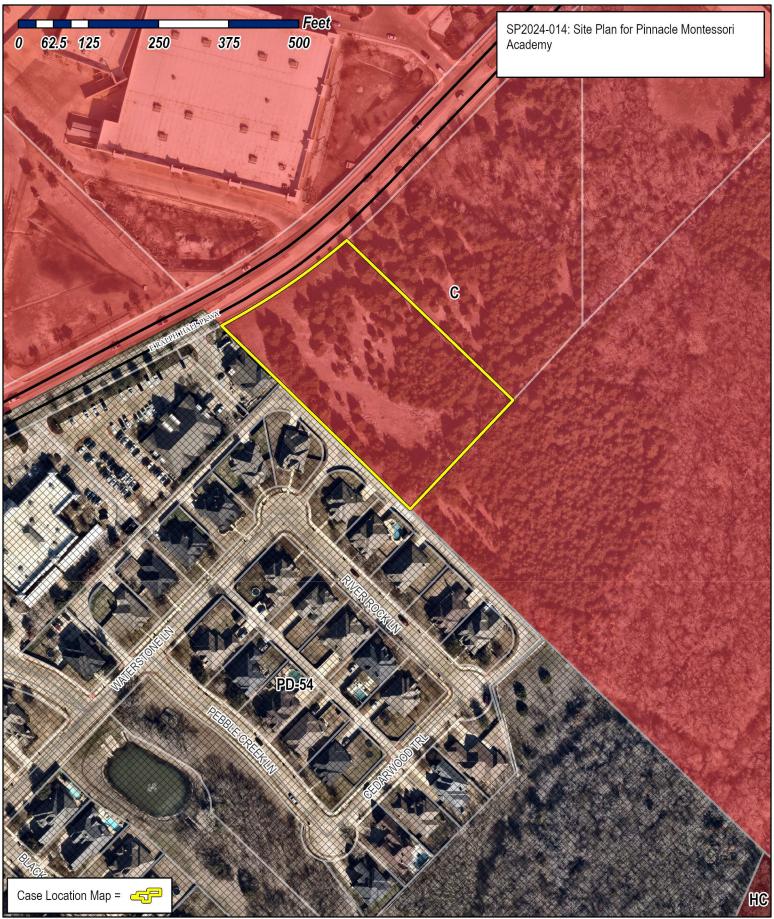




City of Rockwall Planning & Zoning Department 385 S. Goliad Street Rockwall, Texas 75087 (P): (972) 774 7745

(P): (972) 771-7745 (W): www.rockwall.com

The City of Rockwall GIS maps are continually under development and therefore subject to change without notice. While we endeavor to provide timely and accurate information, we make no guarantees. The City of Rockwall makes no warranty, express or implied, including warranties of merchantability and fitness for a particular purpose. Use of the information is the sole responsibility of the user.



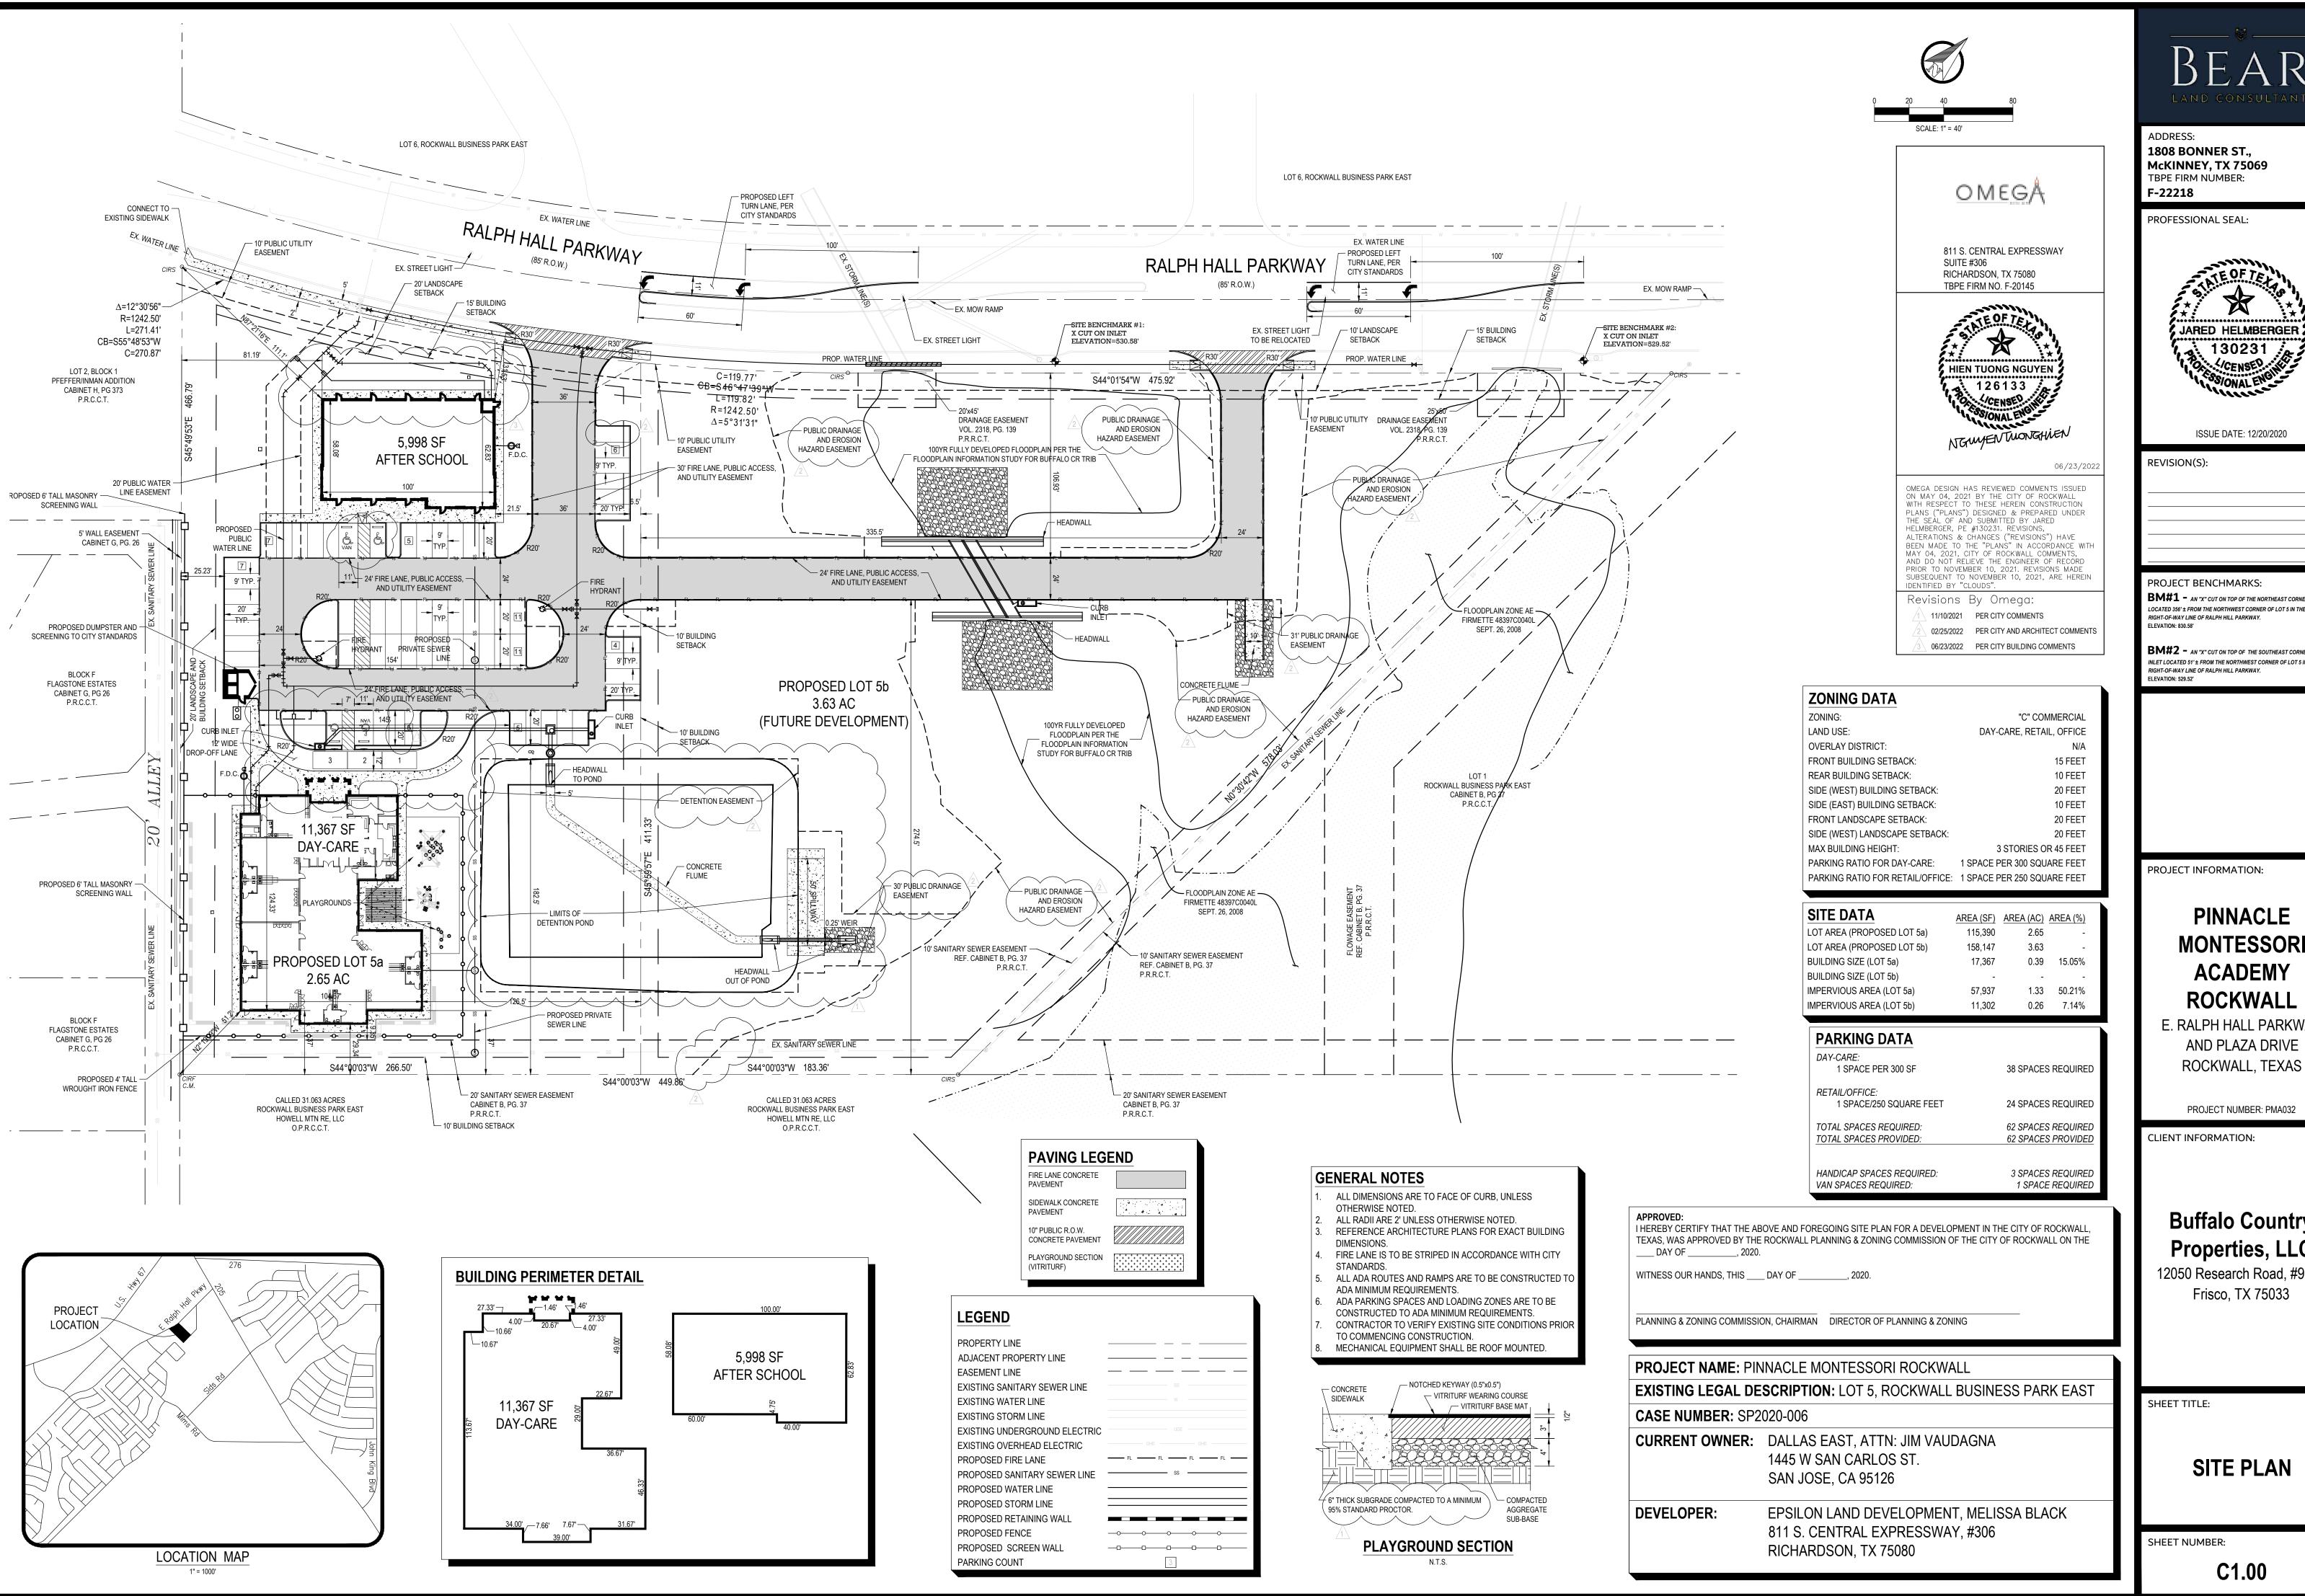





ISSUE DATE: 12/20/2020

BM#1 - AN "X" CUT ON TOP OF THE NORTHEAST CORNER OF A INLE LOCATED 356' ± FROM THE NORTHWEST CORNER OF LOT 5 IN THE EAST RIGHT-OF-WAY LINE OF RALPH HILL PARKWAY.

BM#2 – an "x" cut on top of the southeast corner of an INLET LOCATED 51' ± FROM THE NORTHWEST CORNER OF LOT 5 IN THE EAST

PROJECT INFORMATION:

PINNACLE MONTESSORI ACADEMY ROCKWALL


E. RALPH HALL PARKWAY AND PLAZA DRIVE

Buffalo Country Properties, LLC


12050 Research Road, #9305

SITE PLAN


C1.00

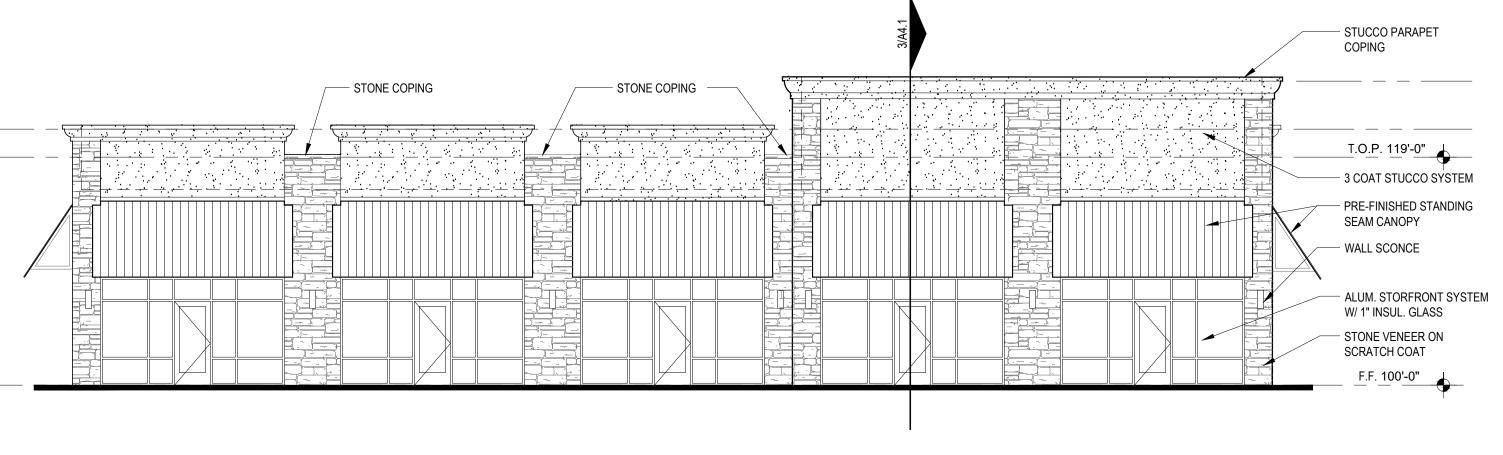

1 WEST ELEVATION

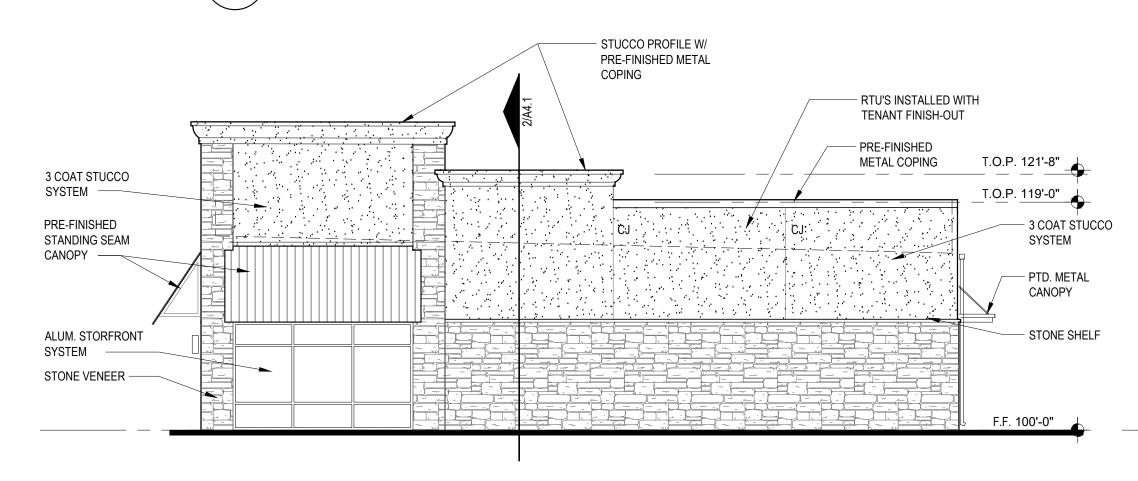

3 EAST ELEVATION
SCALE: 1/8= 1'-0"

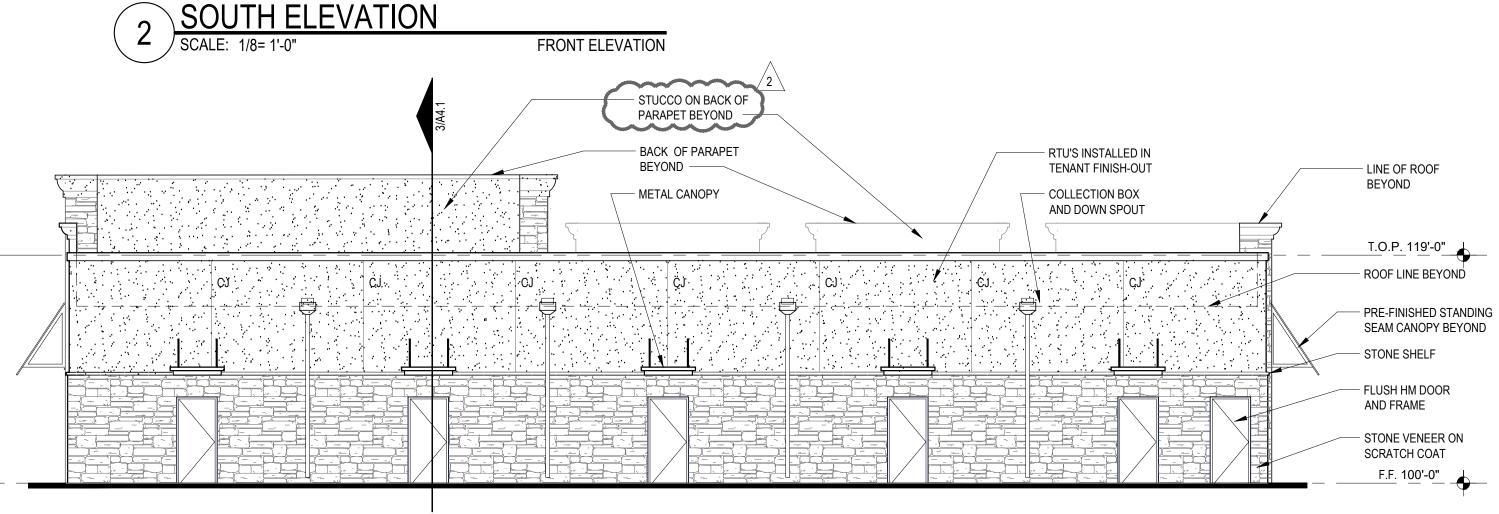

STREET ELEVATION

NORTH ELEVATION

SHELL BUILDING										
BUILDING	NOI	RTH	SOL	JTH	EA	ST	WE	ST	ТОТ	ALS
MATERIALS	SF	%	SF	%	SF	%	SF	%	SF	%
STUCCO	498	39.4 %	498	39.4 %	798	16 %	916	48.5 %	2,710	27.9 %
STONE VENEER	519	41 %	519	41 %	206	4 %	741	39.3 %	1,985	20.4 %
ALUM. WINDOWS	135	10.6 %	135	10.6 %	3,450	68 %	0	0 %	3,951	40.7 %
DOORS	0	0 %	0	0 %	105	6.7 %	126	6.7 %	231	2.4 %
METAL CANOPY	102	8 %	102	8 %	500	24 %	70	3.7 %	774	8 %

11 1% 11 1% 4 0% 33 1.8% 59 0.6%

TOTALS 1,265 100 % 1,265 100 % 5,060 100 % 1,886 100 % 9,710 100 %

NOTE:

STONE SHELF

ALL MECHANICAL EQUIPMENT SHALL BE SCREENED FROM PUBLIC VIEW IN ACCORDANCE WITH THE COMPREHENSIVE ZONING ORDINANCE.

WHEN PERMITTED EXPOSED UTILITY BOXES AND CONDUITS SHALL BE PAINTED TO MATCH BUILDING.

ALL SIGNAGE AREA AND LOCATIONS ARE SUBJECT TO APPROVAL BY BUILDING INSPECTION DEPARTMENT.

OMEGA

OMEGA DESIGN LLC

4516 EMERSON AV. #B ·
DALLAS, TEXAS 75205
214 462 7330

Revis	sions:	
#	DATE	COMMENTS
/1	5 - 6 - 2020	CITY COMMENTS
/2\	2 - 22 - 2022	CITY COMMENTS



SEPTEMBER 30, 2021

© Copyright 2021, Omega Design LLC

Anyone coming into possession of this copyrighted material other than by agreement with Omega Design LLC is hereby warned that use of such without written consent of Omega Design LLC is in violation of United States copyright law and user may be liable to Omega Design LLC for

PROJECT

PINNACLE MONTESSORI SHELL BUILDING

Site Address:
E. Ralph Hall and Plaza Drive
Rockwall, Texas 75087

PROJECT # SRC 032

OWNER

Lakeside Kids, LLC

5909 Beth Drive Plano, Texas 75093

SHEET TITL

AFTER SCHOOL SHELL BLDG. -EXTERIOR ELEVATIONS

SHEET NO.

A3.2

— CEDAR TRELLIS

EAST ELEVATION - SCHOOL

SCALE: 1/8" = 1'-0"

— STONE SILL

\------

√ A3.1

COAT

- 33.5 SF SIGNAGE AREA

- STUCCO @ HIGH

SCHOOL BUILDING EXTERIOR FINISHES

ANODIZED ALUMINUM STORFRONT

PELLA, POWDER COAT FINISH, COLOR WHITE

WHITE LIMESTONE - HARD WHITE W/ 30% NICOTINE ACCENTS

COLOR - STO #16041

COLOR - STO #16031

WHITE LIMESTONE

SW 6141, SOFTER TAN

WHITE SG

CORNICE STUCCO

STONE ACCENT BAND &

WAINSCOT STONE VENEER

STUCCO

T.O.<u>P.</u> = 123'-8"

T.O.P. = 122'-4"

STONE SILL

STOREFRONT

OMEGA DESIGN LLC 4516 EMERSON AV. #B DALLAS, TEXAS 75205

214 462 7330

DATE COMMENTS



SEPTEMBER 30, 2021

TOP OF PLATE

TOP OF DECK

TOP OF SLAB

FINISH FLOOR

T.O.S. 100'-0" XTH FLOOR

F.F. 100'-0"

____ WALL SECTION TAG

DETAIL SECTION TAG

© Copyright 2021, Omega Design LLC agreement with Omega Design LLC is hereby warned that use of such without written consent of Omega Design LLC is in violation of United States copyright law and user may be liable to Omega Design LLC for damages or other remedies.

PROJECT

PINNACLE MONTESSORI OF ROCKWALL

Site Address: E. Ralph Hall and Plaza Drive Rockwall, Texas 75087

> PROJECT# SRC 032

OWNER

Lakeside Kids, LLC

5909 Beth Drive Plano, Texas 75093

SCHOOL BUILDING -**EXTERIOR ELEVATIONS**

SHEET NO.

A3.0



ELEVATION NOTES

PROVIDE 1/2" MINIMUM OF SLOPE AWAY FROM WALL ON TOP SURFACE OF WALL PROJECTIONS. WHERE EXTERIOR WALL MOUNTED LIGHTING PROTRUDES GREATER THAN 4" FROM WALL, BOTTOM

OMEGA DESIGN LLC

4516 EMERSON AV. #B · DALLAS, TEXAS 75205 214 462 7330

#	DATE	COMMENTS			
1	MAR 11, 2022	CITY COMMENTS			

TOP OF PLATE

TOP OF DECK

TOP OF SLAB

FINISH FLOOR



SEPTEMBER 30, 2021

© Copyright 2021, Omega Design LLC

Anyone coming into possession of this copyrighted material other than by agreement with Omega Design LLC is hereby warned that use of such without written consent of Omega Design LLC is in violation of United States copyright law and user may be liable to Omega Design LLC for damages or other remedies.

PROJECT

PINNACLE MONTESSORI OF **ROCKWALL**

Site Address: E. Ralph Hall and Plaza Drive Rockwall, Texas 75087

> PROJECT# SRC 032

OWNER

Lakeside Kids, LLC

5909 Beth Drive Plano, Texas 75093

ENLARGED SCHOOL -EXTERIOR ELEVATIONS

SHEET NO.

A3.1

SHELL BUILDING										
BUILDING	NORTH		SOUTH		EAST		WEST		TOTALS	
MATERIALS	SF	%	SF	%	SF	%	SF	%	SF	%
STUCCO	498	39.4 %	498	39.4 %	798	16 %	916	48.5 %	2,710	27.9 %
STONE VENEER	519	41 %	519	41 %	206	4 %	741	39.3 %	1,985	20.4 %
ALUM. WINDOWS	135	10.6 %	135	10.6 %	3,450	68 %	0	0 %	3,951	40.7 %
DOORS	0	0 %	0	0 %	105	6.7 %	126	6.7 %	231	2.4 %
METAL CANOPY	102	8 %	102	8 %	500	24 %	70	3.7 %	774	8 %
STONE SHELF	11	1 %	11	1 %	4	0 %	33	1.8 %	59	0.6 %
TOTALS	1,265	100 %	1,265	100 %	5,060	100 %	1,886	100 %	9,710	100 %


NOTE:

ALL MECHANICAL EQUIPMENT SHALL BE SCREENED FROM PUBLIC VIEW IN ACCORDANCE WITH THE COMPREHENSIVE ZONING ORDINANCE.

WHEN PERMITTED EXPOSED UTILITY BOXES AND CONDUITS SHALL BE PAINTED TO MATCH BUILDING.

ALL SIGNAGE AREA AND LOCATIONS ARE SUBJECT TO APPROVAL BY BUILDING INSPECTION DEPARTMENT.




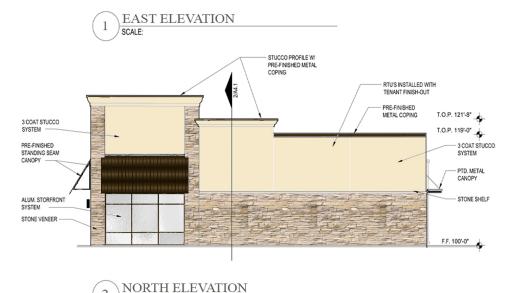


ELEVATION NOTES

- PROVIDE 1/2" MINIMUM OF SLOPE AWAY FROM WALL ON TOP SURFACE OF WALL PROJECTIONS.
- WHERE EXTERIOR WALL MOUNTED LIGHTING PROTRUDES GREATER THAN 4" FROM WALL, BOTTOM OF FIXTURE TO BE 6'-8" A.F.F. MAXIMUM.
 REFER TO CIVIL FOR FINISH FLOOR ELEVATIONS
- REFER TO STRUCTURAL DRAWINGS FOR SLAB BREAKS
- FLASHING, WATERPROOF MEMBRANES, PROPER CAULKS AND SEALANTS (BACKER RODS AS REQUIRED) SHALL BE INSTALLED AROUND ALL WINDOWS, DOORS, ROOF OPENINGS, HORIZONTAL AND VERTICAL JOINTS OF DISSIMILAR MATERIALS, MATERIAL TRANSITIONS, TRIMS AND OTHER WEATHER EXPOSED AREAS.
- ALL PATIOS, AND SIDEWALKS TO BE SLOPED 1/4 PER FOOT / 2% MAXIMUM IN DIRECTION INDICATED ON PLANS AND AWAY FROM EXTERIOR WALLS.
 GRADES AROUND ALL EXTERIOR WALLS OF THE BUILDING TO BE 8 INCHES MINIMUM BELOW THE
- FINISHED FLOOR AND IS TO SLOPE AWAY FROM THE BUILDING.
- GRADE ELEVATIONS ARE APPROXIMATE. REFER TO CIVIL & DRAWINGS FOR FINAL GRADING. PROJECT ADDRESS SIGNAGE TO BE 12" HT. INDIVIDUAL MOUNT, METAL REVERSE PAN CHANNEL
- SIGNS ARE FOR REFERENCE ONLY. ALL SIGNS SHALL BE REVIEWED AND INSTALLED UNDER

SYMBOL LEGEND - ELEVATIONS

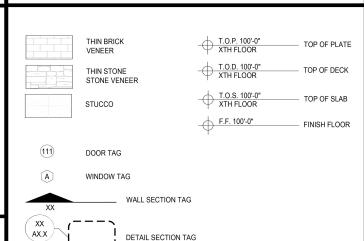



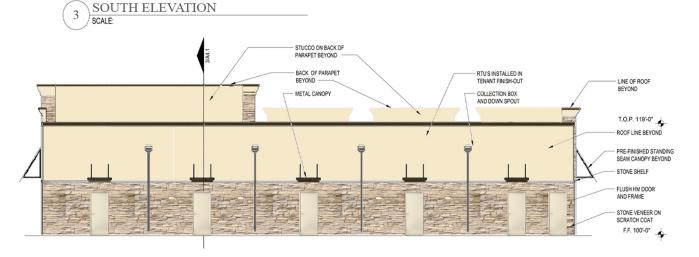

WEST ELEVATION

OMEGÂ

OMEGA DESIGN LLC

4516 EMERSON AV. #B -DALLAS, TEXAS 75205 214 462 7330

Revi	Revisions:								
#	DATE	COMMENTS							



REG # 29302 - 3/01/2024

© Copyright 2021, Omega Design LLC

PROJECT

PINNACLE **MONTESSORI** SHELL **BUILDING**

Site Address: E. Ralph Hall and Plaza Drive Rockwall, Texas 75087

PROJECT#

OWNER

Lakeside Kids, LLC


> 5909 Beth Drive Plano, Texas 75093

SHEET TITLE:

MATERIAL SHEET

SHEET NO.

A01

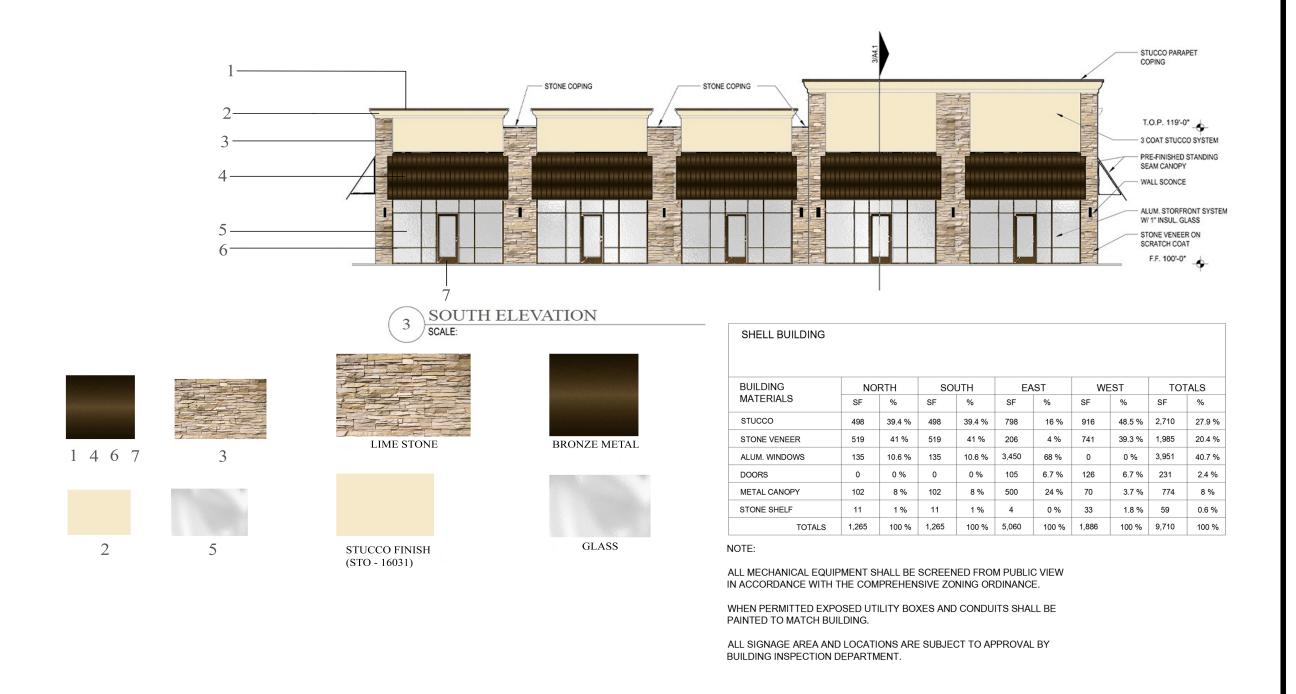



OMEGA DESIGN LLC

4516 EMERSON AV. #B -DALLAS, TEXAS 75205 214 462 7330

Revi	Revisions:							
#	DATE	COMMENTS						



REG # 29302 - 3/01/2024

© Copyright 2021, Omega Design LLC

PROJECT

PINNACLE MONTESSORI SHELL BUILDING

Site Address: E. Ralph Hall and Plaza Drive Rockwall, Texas 75087

> PROJECT# SRC 032

OWNER

Lakeside Kids, LLC

5909 Beth Drive Plano, Texas 75093


SHEET TITLE:

MATERIAL SHEET

A01


ISSUE DATE:

SEPTEMBER 30, 202

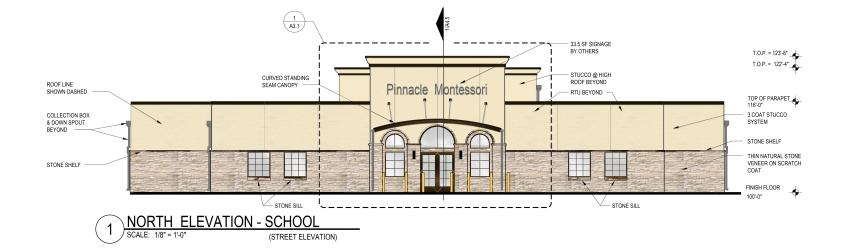




WEST ELEVATION - SCHOOL SCALE: 1/8" = 1'-0"

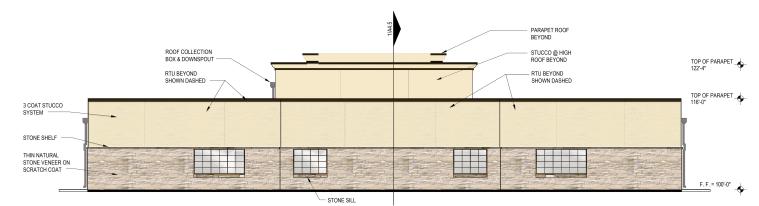

SOUTH ELEVATION - SCHOOL

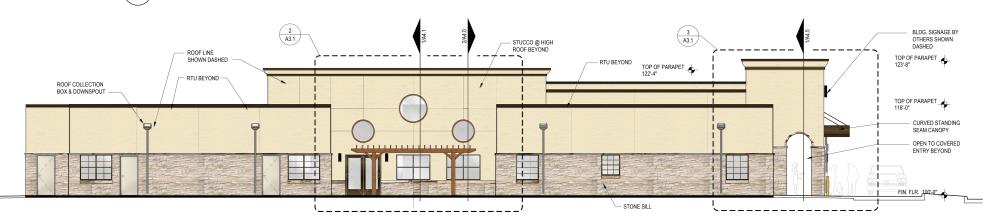


EAST ELEVATION - SCHOOL

ELEVATION NOTES

- 1. PROVIDE 1/2" MINIMUM OF SLOPE AWAY FROM WALL ON TOP SURFACE OF WALL PROJECTIONS.
 2. WHERE EXTERIOR WALL MOUNTED LIGHTING PROTRUDES GREATER THAN 4" FROM WALL, BOTTOM OF FIXTURE TO BE 6"4" AF F. MAXIMUM.
 3. REFER TO CHILL FOR HISH FLOOR ELEVATIONS
 3. REFER TO STRUCTURAL DRAWINGS FOR SLAB BREAKS
 4. FLASHING, WATERPROOP, BRUBBANES, PROPER CAULKS AND SEALANTS (BACKER RODS AS REQUIRED) SHALL BE INSTALLED AROUND ALL WINDOWS, DOORS, ROOF OPENINGS, HORIZONTAL AND VERTICAL, JOINTS OF DISSIMILAR MATERIALS, MATERIAL TRANSITIONS, TRIMS AND OTHER WEATHER EXPOSED AREAS.
 5. ALL PATIOS, AND SIDEWAKS TO BE SLOPED 1/4 PER FOOT / 2% MAXIMUM IN DIRECTION INDICATED ON PLANS AND AWAY FROM EXTERIOR WALLS
 6. GRADES AROUND ALL EXTERIOR WALLS OF THE BUILDING TO BE 8 INCHES MINIMUM BELOW THE FINISHED FLOOR AND IS TO SLOPE AWAY FROM THE BUILDING.
 7. GRADE SAROUND ALL EXTERIOR WALLS OF THE BUILDING TO BE 8 INCHES MINIMUM BELOW THE FINISHED FLOOR AND IS TO SLOPE AWAY FROM THE BUILDING.
 7. GRADE ELEVATIONS ARE APPROXIMATE. REFER TO CIVIL 8 DRAWINGS FOR FINAL GRADING.
 8. PROJECT ADDRESS SIGNAGE TO BE 12" HT. INDIVIDUAL MOUNT, METAL REVERSE PAN CHANNEL NUMBER, STREET NUMBERS ONLY.
 9. SIGNS ARE FOR REFERENCE ONLY. ALL SIGNS SHALL BE REVIEWED AND INSTALLED UNDER SEPARATE PERMIT.

SYMBOL LEGEND - ELEVATIONS

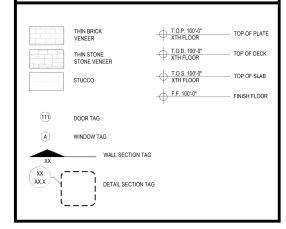

SCHOOL BUILDING						
BUILDING	SOUTH	NORTH	EAST	WEST	TOT	ALS
MATERIALS	SF	SF	SF	SF	SF	%
STUCCO	1,006	972	1,480	1,529	4,987	57 %
THIN STONE VENEER	600	613	631	601	2,445	28 %
DOORS	0	42	105	168	315	4 %
WINDOWS	134	115	290	146	685	8 %
STONE WINDOW SILLS	17	9	12	18	56	1 %
STONE SHELF	27	25	34	35	121	1 %
STANDING SEAM CANOPY	0	12	9	9	30	1 %
TOTALS	1,784	1,845	2,579	2,524	8,732	100 %

NOTE:

THIS FACADE PLAN IS FOR CONCEPTUAL PURPOSES ONLY.

ALL MECHANICAL EQUIPMENT SHALL BE SCREENED FROM PUBLIC VIEW

WHEN PERMITTED EXPOSED UTILITY BOXES AND CONDUITS SHALL BE PAINTED TO MATCH BUILDING.

ALL SIGNAGE AREA AND LOCATIONS ARE SUBJECT TO APPROVAL BY BUILDING INSPECTION DEPARTMENT.



OMEGA DESIGN LLC

Revisions:					
#	DATE	COMMENTS			
_					
_					



REG # 29302 - 3/01/2024

© Copyright 2021, Omega Design LLC

PROJECT

PINNACLE MONTESSORI OF **ROCKWALL**

Site Address: E. Ralph Hall and Plaza Drive Rockwall, Texas 75087

> PROJECT# SRC 032


OWNER

Lakeside Kids, LLC

5909 Beth Drive Plano, Texas 75093

SHEET TITLE: SCHOOL BUILDING -EXTERIOR ELEVATIONS

A3.0

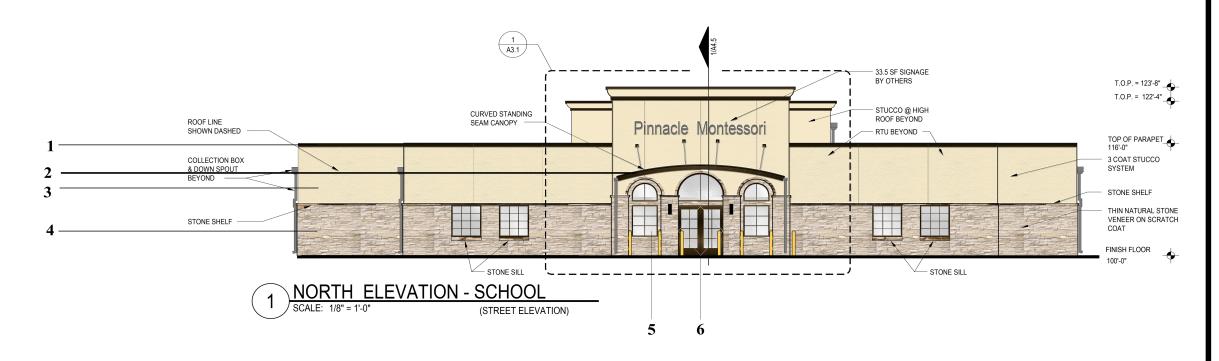

SCHOOL BUILDING

THIN STONE VENEER

STONE WINDOW SILLS

STANDING SEAM CANOPY

TOTALS

SOUTH

1,006

600

0

134

17

27

0

1,784

NORTH

972

613

42

115

9

25

12

1,845

SF

WEST

1,529

601

168

146

18

35

9

2,524

TOTALS

4,987

2,445

315

685

56

121

30

8,732

%

57 %

28 %

4 %

8 %

1 %

1 %

1 %

100 %

EAST

SF

1,480

631

105

290

12

34

9

2,579

BUILDING

STUCCO

DOORS

WINDOWS

STONE SHELF

MATERIALS





GLASS - 5

BRONZE METAL - 1 2 6





LIMESTONE - 4

STUCCO FINISH - 3



WOOD TEXTURE AT BACK SIDE OF ELEVATION

OME CA

OMEGA DESIGN

4516 EMERSON AV. #B · DALLAS, TEXAS 75205 214 462 7330

#	DATE	COMMENTS
\dashv		
\dashv		
\dashv		
\dashv		
\dashv		



REG # 29302 - 3/01/2024

© Copyright 2021, Omega Design LLC

Anyone coming into possession of this copyrighted material other than to agreement with Omega Design LLC is hareby warmed that use of such without written consent of Omega Design LLC is in violation of United States cooperfulls war on user may be lable to Omega Design LLC for

PROJECT

PINNACLE MONTESSORI SCHOOL BUILDING

Site Address: E. Ralph Hall and Plaza Drive Rockwall, Texas 75087

> PROJECT # SRC 032

OWNER

Lakeside Kids, LLC


5909 Beth Drive Plano, Texas 75093

SHEET TITLE:

MATERIAL SHEET

SHEET NO.

A01

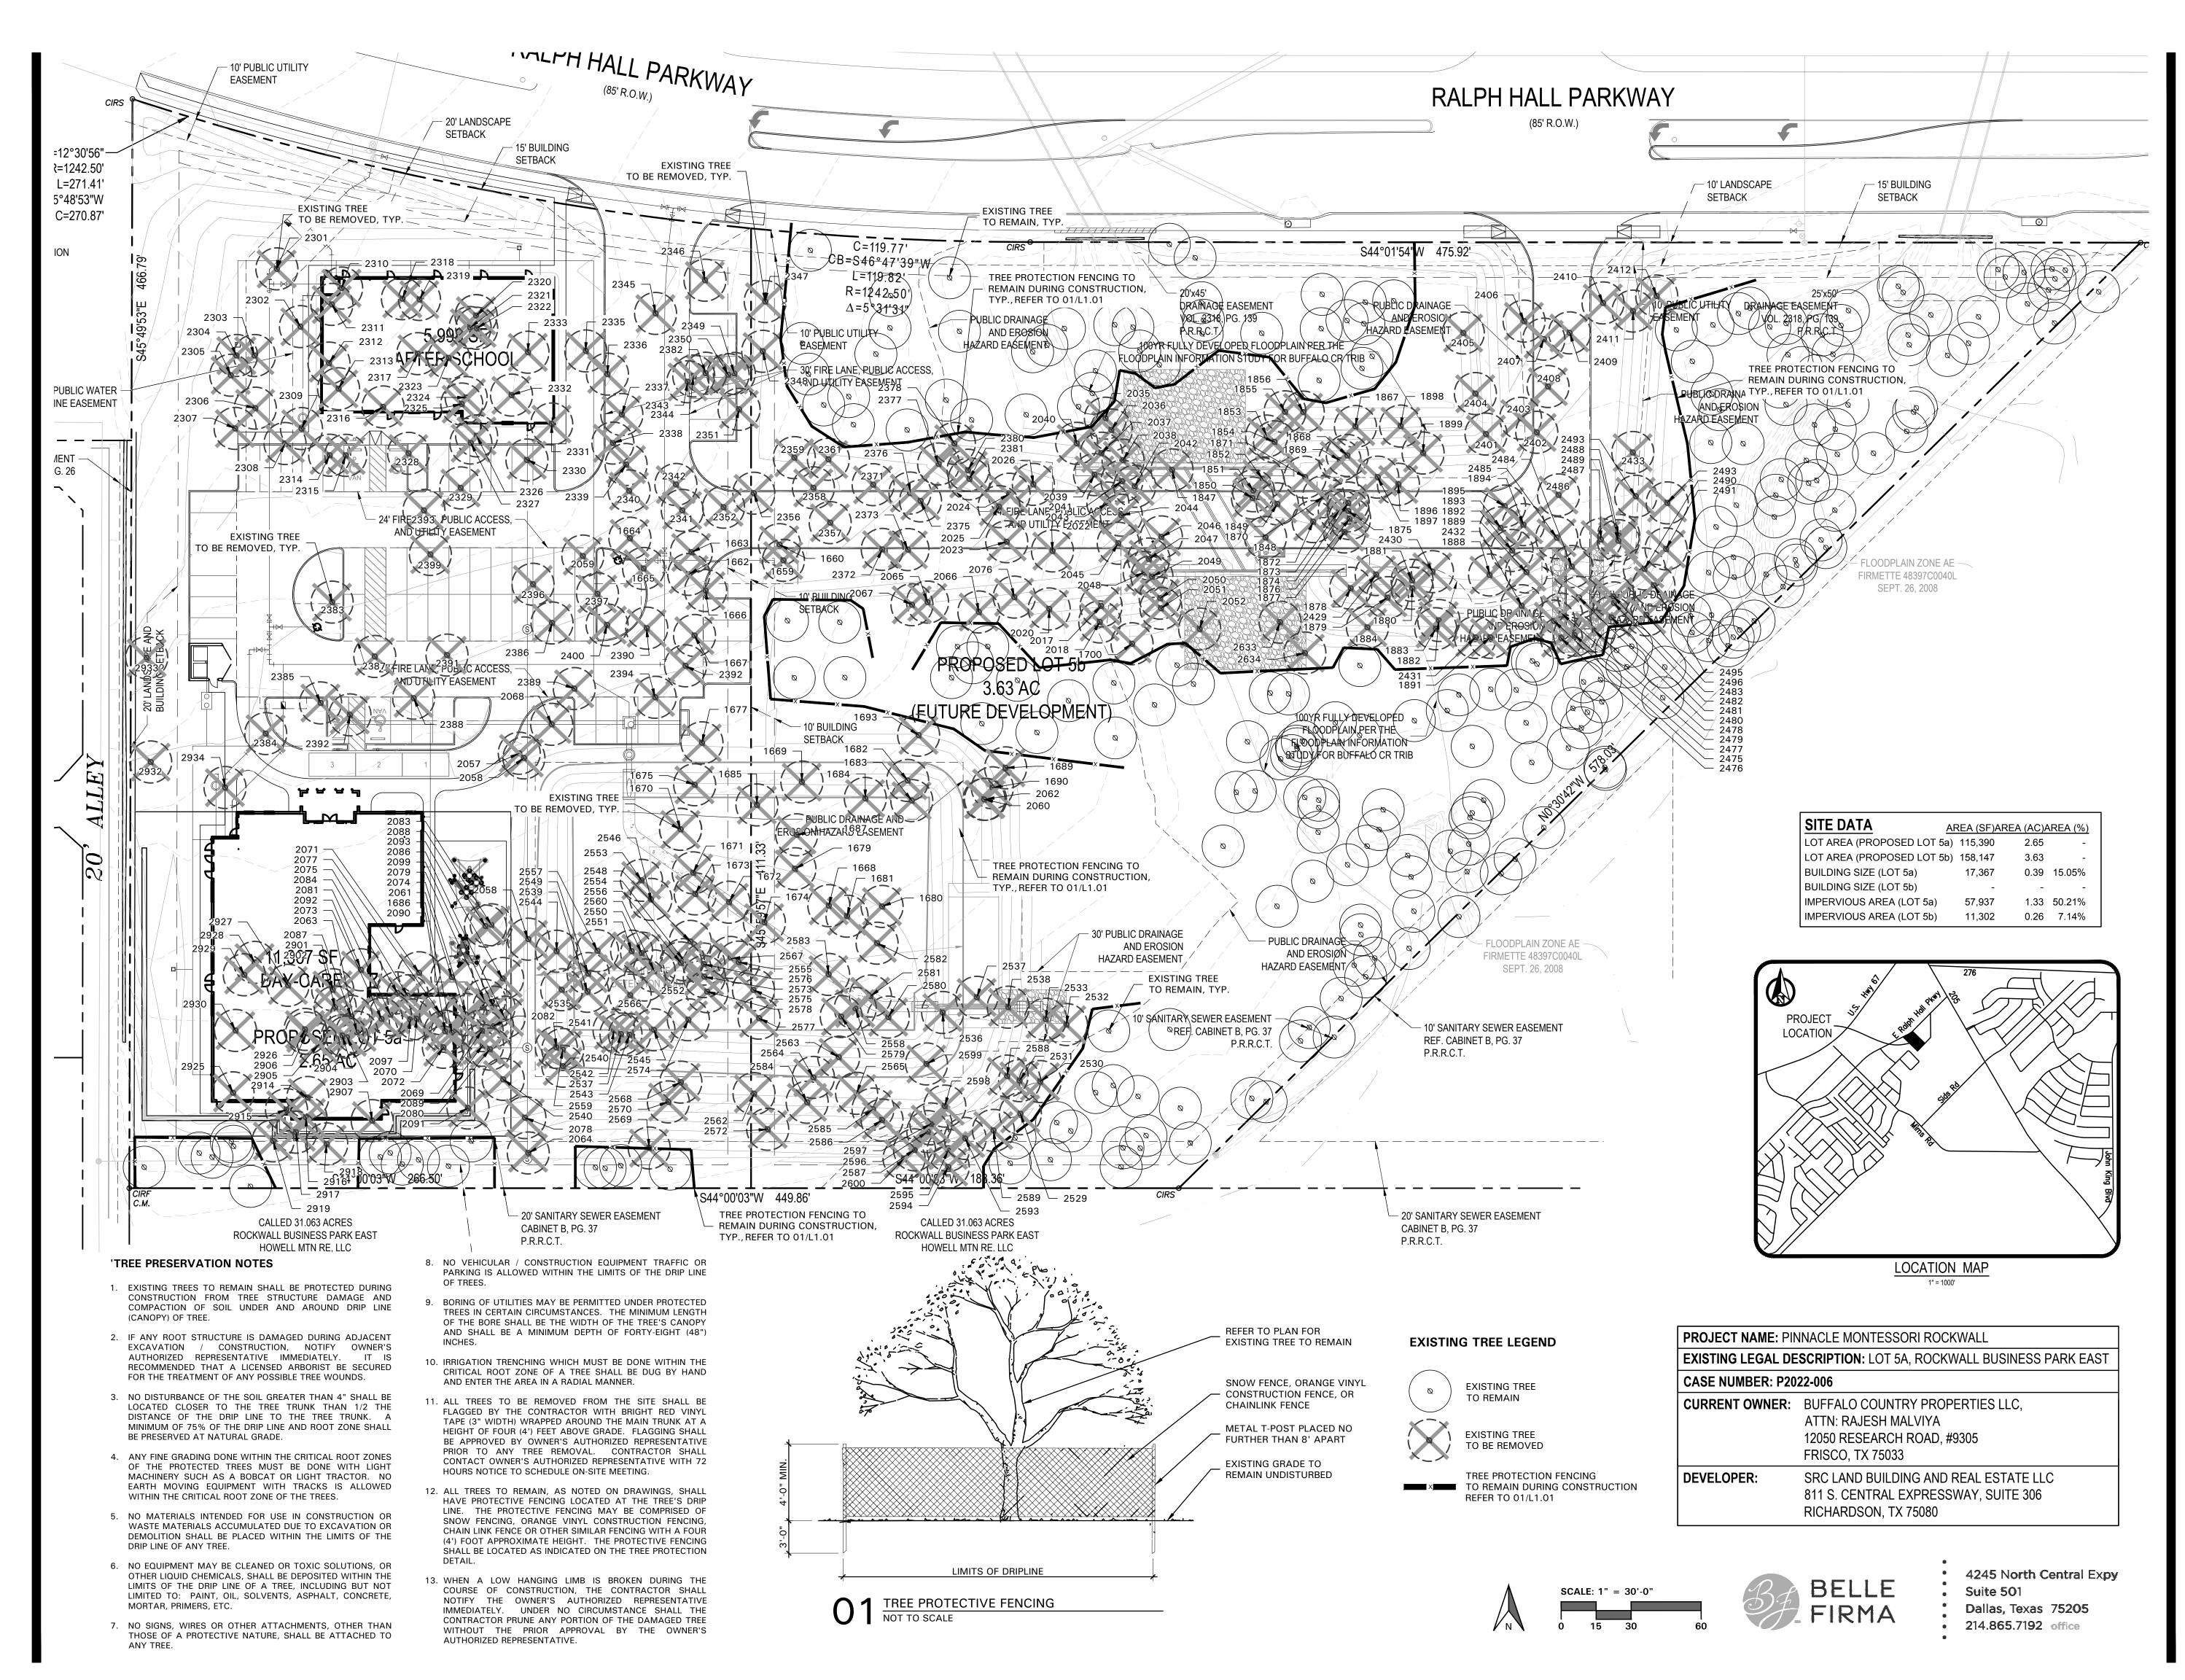

OMEGA DESIGN, LLC 811 S. CENTRAL EXPRESSWA SUITE 306

> RICHARDSON, TX 75080 TBPE FIRM NO. F-20145

REVISIONS # DATE COMMENTS 1 05.06.20 City Comments City Comments 2 10.13.20 City Comments 4 12.06.21 City Comments City Comments 6 08.05.22 City Comments



OWNER INFORMATION

PROJECT INFORMATION

PRESERVATION PLAN

SHEET NUMBER

No.	Dia.	Species	Status	Mitigation
1659	(inches)	(common name) Cedar	TO BE REMOVED	(inches)
1660	8	Cedar	TO BE REMOVED	
1661 1662	18 6	Cedar Cedar	TO REMAIN TO BE REMOVED	
1663	6	Cedar	TO BE REMOVED	
1664	6	Cedar	TO BE REMOVED	
1665 1666	6	Cedar Cedar	TO BE REMOVED TO BE REMOVED	
1667	6	Cedar	TO BE REMOVED	
1668 1669	6	Cedar Cedar	TO BE REMOVED TO BE REMOVED	
1670	6	Cedar	TO BE REMOVED	
1671	8	Cedar	TO BE REMOVED	
1672 1673	6	Cedar Cedar	TO BE REMOVED	
1674	6	Cedar	TO BE REMOVED	
1675	12	Cedar	TO BE REMOVED	6
1676 1677	8 12	Cedar Cedar	TO REMAIN TO BE REMOVED	6
1678	6	Cedar	TO REMAIN	
1679 1680	6	Cedar Cedar	TO BE REMOVED TO BE REMOVED	
1681	6	Cedar	TO BE REMOVED	
1682	6	Cedar	TO BE REMOVED	
1683 1684	6	Cedar Cedar	TO BE REMOVED TO BE REMOVED	
1685	12	Cedar	TO BE REMOVED	6
1686	6	Cedar	TO REMAIN	
1687 1688	10 6	Cedar Cedar	TO BE REMOVED TO REMAIN	
1689	6	Cedar	TO BE REMOVED	
1690	6	Cedar	TO BE REMOVED	
1691 1692	6	Cedar Cedar	TO REMAIN TO REMAIN	
1693	14	Cedar	TO BE REMOVED	7
1694	10	Cedar	TO REMAIN	
1695 1695	8	Cedar Cedar	TO REMAIN TO REMAIN	
1696	6	Cedar	TO REMAIN	
1697	16 6	Cedar Cedar	TO REMAIN TO REMAIN	
1698 1699	6	Cedar	TO REMAIN	
1700	18	Cedar	TO BE REMOVED	9
1838 1839	12 12	Hackberry Hackberry	TO REMAIN TO REMAIN	
1840	8	Green Ash	TO REMAIN	
1841	10	Hackberry	TO REMAIN	
1842 1843	10 12	Hackberry Gulf Black Willow	TO REMAIN TO REMAIN	
1844	10	Gulf Black Willow	TO REMAIN	
1845	10	Cottonwood	TO REMAIN	
1846 1847	6	Green Ash Cottonwood	TO REMAIN TO REMAIN	
1848	6	Hackberry	TO BE REMOVED	DECLINE
1849 1850	12 8	Hackberry Hackberry	TO BE REMOVED TO BE REMOVED	6 DECLINE
1851	6	Green Ash	TO BE REMOVED	6
1852	6	American Elm	TO BE REMOVED	6
1853 1854	6 12	Hackberry Hackberry	TO BE REMOVED TO BE REMOVED	6
1855	8	Hackberry	TO BE REMOVED	DECLINE
1856	6	Hackberry	TO BE REMOVED	DECLINE
1857 1858	12 12	Hackberry Cedar Elm	TO REMAIN TO REMAIN	
1859	6	Hackberry	TO REMAIN	
1860	10	Hackberry	TO REMAIN	
1861 1862	8	American Elm Cedar Elm	TO REMAIN TO REMAIN	
1863	8	Cedar	TO REMAIN	
1864 1865	10 6	American Elm Hackberry	TO REMAIN TO REMAIN	
1866	6	Hackberry	TO REMAIN	
1867	10	Cottonwood	TO BE REMOVED	
1868 1869	8	Hackberry Hackberry	TO BE REMOVED TO BE REMOVED	DECLINE DECLINE
1870	6	Hackberry	TO BE REMOVED	DEOLINE
1871	10	Hackberry	TO BE REMOVED	
1872 1873	6 10	Hackberry American Elm	TO BE REMOVED TO BE REMOVED	10
1874	8	Hackberry	TO BE REMOVED	4 1
1875	6	Hackberry	TO BE REMOVED	
1876 1877	8	Cedar Hackberry	TO BE REMOVED TO BE REMOVED	
1878	6	Cedar	TO BE REMOVED	
1879 1880	8	Hackberry	TO BE REMOVED TO BE REMOVED	
1880	8	Hackberry Hackberry	TO BE REMOVED	
1882	6	Hackberry	TO BE REMOVED	
1883 1884	6	Hackberry Hackberry	TO BE REMOVED TO BE REMOVED	
1885	12	Cedar	TO REMAIN	
1886	10	Cedar	TO REMAIN	
1887 1888	12 8	Cedar American Elm	TO REMAIN TO BE REMOVED	8
1889	8	Cedar	TO BE REMOVED	
1890	12 6	Cedar	TO REMAIN	
1891 1892	8	Hackberry Cedar	TO BE REMOVED TO BE REMOVED	
1893	6	Cedar	TO BE REMOVED	
1894 1895	10 6	Green Ash Cedar	TO BE REMOVED TO BE REMOVED	10
1895	22	Cedar	TO BE REMOVED	
1897	8	Hackberry	TO BE REMOVED	•
1898 1899	12 10	Cedar Cedar	TO BE REMOVED TO BE REMOVED	6
2017	6	Cedar	TO BE REMOVED	
2018	6	Cedar	TO BE REMOVED	
2020 2022	6 14	Cedar Cedar	TO BE REMOVED TO BE REMOVED	7
2023	10	Cedar	TO BE REMOVED	
2024	6	Cedar Cedar	TO BE REMOVED	
2025 2026	6	Cedar Cedar	TO BE REMOVED TO BE REMOVED	
2027	24	Cedar	TO REMAIN	
2028 2029	6 10	Cedar Cedar	TO REMAIN TO REMAIN	
2029	6	Cedar	TO REMAIN	
2031	8	Cedar	TO REMAIN	
2032 2033	10 20	Cedar Cedar	TO REMAIN TO REMAIN	
2033	6	Cedar	TO REMAIN	
2034			TO DE DEMOVED	
2035 2036	6	Cedar Cedar	TO BE REMOVED TO BE REMOVED	

2038	6	Cedar	TO BE REMOVED	
2039	6	Cedar Cedar	TO BE REMOVED TO BE REMOVED	
2041	6	Cedar	TO BE REMOVED	
2042	6	Cedar	TO BE REMOVED TO BE REMOVED	
2043	6	Cedar Cedar	TO BE REMOVED	
2045	6	Cedar	TO BE REMOVED	
2046 2047	10 6	American Elm Cedar	TO BE REMOVED TO BE REMOVED	10
2048	12	Green Ash	TO BE REMOVED	12
2049	8	Cedar	TO BE REMOVED	
2050	10 10	Green Ash Pecan	TO BE REMOVED	10
2052	6	Cedar	TO BE REMOVED	
2053	10	Cedar	TO REMAIN	
2054	6	Cedar	TO REMAIN	
2055 2056	10 6	Cedar Cedar	TO REMAIN TO REMAIN	
2057	6	Cedar	TO BE REMOVED	
2058	6	Cedar	TO BE REMOVED	
2059	6	Cedar Cedar	TO BE REMOVED TO BE REMOVED	
2061	6	Cedar	TO BE REMOVED	
2062	6	Cedar	TO BE REMOVED	
2063 2064	6 10	Cedar Cottonwood	TO BE REMOVED TO BE REMOVED	
2065	6	Cedar	TO BE REMOVED	
2066	8	Cedar	TO BE REMOVED	
2067 2068	6	Cedar Cedar	TO BE REMOVED TO BE REMOVED	
2069	6	Cedar	TO BE REMOVED	
2070	6	Cedar	TO BE REMOVED	
2071 2072	6	Cedar Cedar	TO BE REMOVED	
2072	6	Cedar	TO BE REMOVED	
2074	6	Cedar	TO BE REMOVED	
2075	6	Cedar	TO BE REMOVED	
2076 2077	10 6	Cedar Cedar	TO BE REMOVED TO BE REMOVED	
2078	14	Cedar	TO BE REMOVED	7
2079	6	Cedar	TO BE REMOVED	
2080 2081	6	Cedar Cedar	TO BE REMOVED TO BE REMOVED	
2082	6	Cedar	TO BE REMOVED	
2083	6	Cedar	TO BE REMOVED	
2084 2085	6 8	Cedar Cedar	TO BE REMOVED TO REMAIN	
2086	6	Cedar	TO BE REMOVED	
2087	6	Cedar	TO BE REMOVED	
2088 2089	6	Cedar Cedar	TO BE REMOVED TO BE REMOVED	
2090	6	Cedar	TO BE REMOVED	
2091	6	Cedar	TO BE REMOVED	
2092 2093	16 6	Cedar Cedar	TO BE REMOVED TO BE REMOVED	8
2095	6	Cedar	TO REMAIN	
2096	16	Cedar	TO REMAIN	
2097	6	Cedar	TO BE REMOVED	
2098	6	Cedar Cedar	TO REMAIN TO BE REMOVED	
2301	10	Cedar	TO BE REMOVED	
2302	8	Cedar	TO BE REMOVED	
2303 2304	8	Cedar Cedar	TO BE REMOVED	
2305	6	Cedar	TO BE REMOVED	
2306	6	Cedar	TO BE REMOVED	
2307 2308	6	Cedar Cedar	TO BE REMOVED TO BE REMOVED	
2309	6	Cedar	TO BE REMOVED	
2310	10	Cedar	TO BE REMOVED	
2311	6 8	Cedar Cedar	TO BE REMOVED TO BE REMOVED	
2313	6	Cedar	TO BE REMOVED	
2314	6	Cedar	TO BE REMOVED	
2315 2316	6 10	Cedar Cedar	TO BE REMOVED TO BE REMOVED	
2317	10	Cedar	TO BE REMOVED	
2318	6	Cedar	TO BE REMOVED	
2319	8	Cedar	TO BE REMOVED	
2320 2321	6 10	Cedar Cedar	TO BE REMOVED TO BE REMOVED	
2322	6	Cedar	TO BE REMOVED	
2323	10	Cedar	TO BE REMOVED	
2324	12	Cedar Cedar	TO BE REMOVED	6
2325 2326	6	Cedar	TO BE REMOVED TO BE REMOVED	
2327	6	Cedar	TO BE REMOVED	
2328 2329	12	Cedar Cedar	TO BE REMOVED TO BE REMOVED	6
2329	6 8	Cedar Cedar	TO BE REMOVED	
2331	6	Cedar	TO BE REMOVED	
2332	22	Cedar	TO BE REMOVED	11
2333 2335	6 8	Cedar Cedar	TO BE REMOVED TO BE REMOVED	
2336	6	Cedar	TO BE REMOVED	
2337	8	Cedar	TO BE REMOVED	
2338 2339	6 12	Cedar Cedar	TO BE REMOVED TO BE REMOVED	6
2340	10	Cedar	TO BE REMOVED	5
2341	6	Cedar	TO BE REMOVED	
2342 2343	6	Cedar Cedar	TO BE REMOVED TO BE REMOVED	
2343	6	Cedar	TO BE REMOVED	
2345	10	Cedar	TO BE REMOVED	
2346 2347	12 14	Cedar	TO BE REMOVED TO BE REMOVED	6 7
2347	14 8	Cedar Cedar	TO BE REMOVED	r
2349	12	Cedar	TO BE REMOVED	6
2350	6	Cedar	TO BE REMOVED	0
2351 2352	12 18	Cedar Cedar	TO BE REMOVED TO BE REMOVED	6 9
2353	14	Cedar	TO BE REMOVED	7
2354	12	Cedar	TO BE REMOVED	6
2355 2356	14 16	Cedar Cedar	TO REMAIN TO REMAIN	
2357	8	Cedar	TO BE REMOVED	
2358	8	Cedar	TO BE REMOVED	
2359	8	Cedar	TO BE REMOVED TO BE REMOVED	
2360 2361	8	Cedar Cedar	TO BE REMOVED TO REMAIN	
2362	6	Cedar	TO BE REMOVED	
	6	Cedar	TO REMAIN	
2363		0-1-	TO DEMAN	
2363 2364 2365	10 10	Cedar Cedar	TO REMAIN TO REMAIN	

2368	8	Cedar	TO REMAIN	
2368	16	Cedar	TO REMAIN	
2370	8	Cedar	TO REMAIN	
2371 2372	6 8	Cedar Cedar	TO REMAIN TO BE REMOVED	
2373	6	Cedar	TO BE REMOVED	
2375	10	Cedar	TO BE REMOVED	_
2376 2377	18 10	Cedar Cedar	TO BE REMOVED	9
2378	6	Cedar	TO BE REMOVED	
2379	6	Cedar	TO REMAIN	
2380 2381	6	Cedar	TO BE REMOVED	
2382	6	Cedar Cedar	TO BE REMOVED	
2383	6	Cedar	TO BE REMOVED	
2384	6	Cedar	TO BE REMOVED	
2385 2386	6	Cedar Cedar	TO BE REMOVED TO BE REMOVED	
2387	6	Cedar	TO BE REMOVED	
2388	8	Cedar	TO BE REMOVED	
2389 2390	6	Cedar Cedar	TO BE REMOVED	
2391	6	Cedar	TO BE REMOVED	
2392	6	Cedar	TO BE REMOVED	
2393 2394	6 8	Cedar Cedar	TO BE REMOVED	
2394	6	Cedar	TO BE REMOVED	
2397	6	Cedar	TO BE REMOVED	
2399	6	Cedar	TO BE REMOVED	
2400 2401	6 12	Cedar Cedar	TO BE REMOVED	6
2402	6	Cedar	TO BE REMOVED	-
2403	8	Cedar	TO BE REMOVED	
2404	8	Cedar	TO BE REMOVED	0
2405 2406	18 6	Cedar Cedar	TO BE REMOVED TO BE REMOVED	9
2407	6	Cedar	TO BE REMOVED	
2408	8	Cedar	TO BE REMOVED	
2409 2410	8 10	Cedar Cedar	TO BE REMOVED TO BE REMOVED	
2411	8	Cedar	TO BE REMOVED	
2412	12	Cedar	TO BE REMOVED	6
2413 2414	8 6	Cedar Cedar	TO REMAIN TO REMAIN	
2414	6	Cedar	TO REMAIN	
2416	6	Cedar	TO REMAIN	
2417 2418	6 8	Cedar Cedar	TO REMAIN TO REMAIN	
2418	10	Cedar	TO REMAIN	
2420	10	Cedar	TO REMAIN	
2421	6	Cedar	TO REMAIN	
2422 2423	8 12	Cedar Cedar	TO REMAIN TO REMAIN	
2424	8	Cedar	TO REMAIN	
2425	16	Cedar	TO REMAIN	
2426	14 8	Cedar	TO REMAIN	
2427 2428	10	Cedar Cedar	TO REMAIN TO REMAIN	
2429	10	Hackberry	TO REMAIN	
2430	8	Hackberry	TO REMAIN	
2431 2432	10 14	Hackberry American Elm	TO BE REMOVED TO REMAIN	
2433	6	Cedar	TO BE REMOVED	DECLINE
2434	6	Cedar	TO REMAIN	
2435	6	Cedar	TO REMAIN	
2436 2438	8	Cedar Cedar	TO REMAIN TO REMAIN	
2439	6	Cedar	TO REMAIN	
2440	6	Cedar	TO REMAIN	
2441 2442	6	Cedar Cedar	TO REMAIN TO REMAIN	
2442	6	Cedar	TO REMAIN	
2444	6	Cedar	TO REMAIN	
2445	6	Cedar	TO REMAIN	
2446 2447	14 6	Cedar Cedar	TO REMAIN TO REMAIN	
2448	12	Cedar	TO REMAIN	
2449	6	Cedar	TO REMAIN	
2450	8	Cedar	TO REMAIN	
2451 2452	8	Cedar Cedar	TO REMAIN TO REMAIN	
2453	8	Cedar	TO REMAIN	
2454	6	Cedar	TO REMAIN	
2455 2456	6	Cedar Cedar	TO REMAIN TO REMAIN	
2456	8	Cedar	TO REMAIN	
2458	8	Cedar	TO REMAIN	
2459	16 6	Cedar Cedar	TO REMAIN TO REMAIN	
2460 2461	6	Cedar	TO REMAIN	
2462	6	Cedar	TO REMAIN	
2463	10	Cedar	TO REMAIN	
2464 2465	6 10	Cedar Cedar	TO REMAIN TO REMAIN	
2466	8	Cedar	TO REMAIN	
2467	6	Cedar	TO REMAIN	
2468 2469	6	Cedar Cedar	TO REMAIN TO REMAIN	
2469	8	Cedar	TO REMAIN	
2471	8	Cedar	TO REMAIN	
2472	6	Cedar	TO REMAIN	
2473 2474	14 6	Cedar Cedar	TO REMAIN TO REMAIN	
2475	8	Green Ash	TO BE REMOVED	8
2476	6	Cedar	TO BE REMOVED	
2477	6 8	Cedar	TO BE REMOVED TO BE REMOVED	
2478 2479	6	Cedar Cedar	TO BE REMOVED	
2480	8	Cedar	TO BE REMOVED	
2481	6	Cedar	TO BE REMOVED	
2482 2483	8	Cedar Cedar	TO BE REMOVED TO BE REMOVED	
2483	10	Cedar	TO BE REMOVED	
2485	8	Cedar	TO BE REMOVED	
2486	6	Cedar	TO BE REMOVED	
2487	6	Cedar Cedar	TO BE REMOVED TO BE REMOVED	
	6	Cedar	TO BE REMOVED	
2488 2489	8	Cedar	TO BE REMOVED	
2488 2489 2490		Cadar	TO BE REMOVED	
2488 2489 2490 2491	8	Cedar		
2488 2489 2490 2491 2492	6	Cedar	TO REMAIN TO BE REMOVED	
2488 2489 2490 2491			TO BE REMOVED TO REMAIN	
2488 2489 2490 2491 2492 2493 2494 2495	6 8 6 6	Cedar Cedar Cedar Cedar	TO BE REMOVED TO REMAIN TO BE REMOVED	
2488 2489 2490 2491 2492 2493 2494 2495 2496	6 8 6 6 8	Cedar Cedar Cedar Cedar Cedar	TO BE REMOVED TO REMAIN TO BE REMOVED TO BE REMOVED	
2488 2489 2490 2491 2492 2493 2494 2495	6 8 6 6	Cedar Cedar Cedar Cedar	TO BE REMOVED TO REMAIN TO BE REMOVED	

2500	6	Cedar	TO REMAIN	
2501	6	Cedar	TO REMAIN	
2502	8	Cedar	TO REMAIN	
2503 2504	6 8	Cedar	TO REMAIN TO REMAIN	
2504	8	Cedar Cedar	TO REMAIN	
2507	6	Cedar	TO REMAIN	
2508	8	Cedar	TO REMAIN	
2509	6	Cedar	TO REMAIN	
2510	6	Cedar	TO REMAIN	
2511	6	Cedar	TO REMAIN	
2512	8	Cedar	TO REMAIN	
2513 2514	10	Cedar Cedar	TO REMAIN TO REMAIN	
2515	12	Cedar	TO REMAIN	
2516	8	Cedar	TO REMAIN	
2517	6	Cedar	TO REMAIN	
2519	6	Cedar	TO REMAIN	
2520	6	Cedar	TO REMAIN	
2521	6	Cedar	TO REMAIN TO REMAIN	
2522 2523	8	Cedar Cedar	TO REMAIN	
2524	8	Cedar	TO REMAIN	
2525	6	Cedar	TO REMAIN	
2526	6	Cedar	TO REMAIN	
2527	6	Cedar	TO REMAIN	
2528	6	Cedar	TO REMAIN	
2529 2530	6 8	Cedar Cedar	TO BE REMOVED TO BE REMOVED	
2531	6	Cedar	TO BE REMOVED	
2532	6	Cedar	TO BE REMOVED	
2533	6	Cedar	TO BE REMOVED	
2535	6	Cedar	TO BE REMOVED	
2536	10	Cedar	TO BE REMOVED	
2537	10	Cedar	TO BE REMOVED	
2537 2538	8	Cedar Cedar	TO BE REMOVED TO BE REMOVED	
2538 2539	10	Cedar	TO BE REMOVED	
2540	6	Cedar	TO BE REMOVED	
2540	6	Cedar	TO BE REMOVED	
2541	6	Cedar	TO BE REMOVED	
2542	6	Cedar	TO BE REMOVED	
2543	12	Cedar	TO BE REMOVED	6
2544 2545	6 8	Cedar Cedar	TO BE REMOVED	
2545 2546	10	Cedar	TO BE REMOVED	
2548	6	Cedar	TO BE REMOVED	
2549	8	Cedar	TO BE REMOVED	
2550	8	Cedar	TO BE REMOVED	
2551	8	Cedar	TO BE REMOVED	
2552	6	Cedar	TO BE REMOVED	
2553	6	Cedar Cedar	TO BE REMOVED TO BE REMOVED	
2554 2555	6	Cedar	TO BE REMOVED	
2556	6	Cedar	TO BE REMOVED	
2557	6	Cedar	TO BE REMOVED	
2558	6	Cedar	TO BE REMOVED	
2559	6	Cedar	TO BE REMOVED	
2560	8	Cedar	TO BE REMOVED	
2562	12	Cedar	TO BE REMOVED	6
2563 2564	14 6	Cedar Cedar	TO BE REMOVED TO BE REMOVED	7
2565	12	Cedar	TO BE REMOVED	6
2566	10	Cedar	TO BE REMOVED	
2567	8	Cedar	TO BE REMOVED	
2568	12	Cedar	TO BE REMOVED	6
2569	10	Cedar	TO BE REMOVED	
2570	6	Cedar	TO BE REMOVED	
2571 2572	12	Cedar Cedar	TO REMAIN TO BE REMOVED	6
2572	6	Cedar	TO BE REMOVED	0
2574	8	Cedar	TO BE REMOVED	
2575	8	Cedar	TO BE REMOVED	
2576	8	Cedar	TO BE REMOVED	
2577	12	Cedar	TO BE REMOVED	6
2578	6	Cedar	TO BE REMOVED	7
2579 2580	14 10	Cedar Cedar	TO BE REMOVED TO BE REMOVED	7
2581	6	Cedar	TO BE REMOVED	
2582	10	Cedar	TO BE REMOVED	
2583	10	Cedar	TO BE REMOVED	
2584	12	Cedar	TO BE REMOVED	6
2585	10	Cedar	TO BE REMOVED	_
2586	12	Cedar	TO BE REMOVED	6
2587 2588	8	Cedar Cedar	TO BE REMOVED TO BE REMOVED	
2589	8	Cedar	TO BE REMOVED	
2591	6	Cedar	TO REMAIN	
2592	6	Cedar	TO REMAIN	
2593	12	Cedar	TO BE REMOVED	6
2594 2595	8	Cedar Cedar	TO REMAIN TO REMAIN	
2596	8	Cedar	TO REMAIN	
2597	8	Cedar	TO REMAIN	
2598	8	Cedar	TO BE REMOVED	
2599	10	Cedar	TO BE REMOVED	
2600	8	Cedar	TO BE REMOVED	
2601	6 12	Cedar Cedar	TO REMAIN TO REMAIN	
2602 2603	12 12	Cedar	TO REMAIN	
2604	24	Cedar	TO REMAIN	
2605	10	Cedar	TO REMAIN	
2606	10	Cedar	TO REMAIN	
2607	10	Cedar	TO REMAIN	
2608	8	Cedar	TO REMAIN	
2609 2610	10	Cedar	TO REMAIN	
2610 2611	12 8	Cedar Cedar	TO REMAIN TO REMAIN	
2612	12	Cedar	TO REMAIN	
2613	6	Cedar	TO REMAIN	
2614	6	Cedar	TO REMAIN	
2615	12	Cedar	TO REMAIN	
2616	12	Cedar	TO REMAIN	
2617	8	Cedar	TO REMAIN	
2618 2619	8	Cedar Cedar	TO REMAIN TO REMAIN	
2620	6	Cedar	TO REMAIN	
2621	6	Cedar	TO REMAIN	
2622	8	Cedar	TO REMAIN	
2623	10	Cedar	TO REMAIN	
2624	10	Cedar	TO REMAIN	
2625	6	Cedar	TO REMAIN	
2626 2627	8	Cedar	TO REMAIN	
2627 2628	8 12	Cedar Cedar	TO REMAIN TO REMAIN	
2628	12	Cedar	TO REMAIN	
2630	6	Cedar	TO REMAIN	
2000				

6	Cedar	TO REMAIN		2631	10	Cedar	TO REMAIN
6	Cedar	TO REMAIN		2632	2 10	Cedar	TO REMAIN
8	Cedar	TO REMAIN		2633	6	Gulf Black Willow	TO BE REMOVED
6 8	Cedar Cedar	TO REMAIN TO REMAIN		2634	1 6	Cedar	TO BE REMOVED
8	Cedar	TO REMAIN		2635	5 8	Cedar	TO REMAIN
6	Cedar	TO REMAIN		2636	6	Cedar	TO REMAIN
8	Cedar	TO REMAIN		2637	7 6	Cedar	TO REMAIN
6	Cedar	TO REMAIN		2638	3 6	Cedar	TO REMAIN
6	Cedar	TO REMAIN		2639	8	Cedar	TO REMAIN
6	Cedar	TO REMAIN		2640		Cedar	TO REMAIN
8	Cedar	TO REMAIN		2641		Cedar	TO REMAIN
8	Cedar	TO REMAIN		2642		Cedar	TO REMAIN
10	Cedar	TO REMAIN		2643		Cedar	TO REMAIN
12	Cedar	TO REMAIN		2644		Cedar	TO REMAIN
8	Cedar Cedar	TO REMAIN		2645		Cedar	TO REMAIN
6	Cedar	TO REMAIN TO REMAIN		2646		Cedar	TO REMAIN
6	Cedar	TO REMAIN		2647		Cedar	TO REMAIN
6	Cedar	TO REMAIN		2648		Cedar	TO REMAIN
8	Cedar	TO REMAIN		2649		Cedar	TO REMAIN
8	Cedar	TO REMAIN		2650		Cedar	TO REMAIN
8	Cedar	TO REMAIN		2651		Cedar	TO REMAIN
6	Cedar	TO REMAIN		2652		Cedar	TO REMAIN
6	Cedar	TO REMAIN		2653		Cedar	TO REMAIN
6	Cedar	TO REMAIN		2654		Cedar	TO REMAIN
6	Cedar Cedar	TO REMAIN TO BE REMOVED		2655		Cedar	TO REMAIN
6 8	Cedar	TO BE REMOVED		2656		Cedar	TO REMAIN
6	Cedar	TO BE REMOVED		2657		Cedar	TO REMAIN
6	Cedar	TO BE REMOVED		2658		Cedar	TO REMAIN
6	Cedar	TO BE REMOVED		2659		Cedar	TO REMAIN
6	Cedar	TO BE REMOVED		2660		Cedar	TO REMAIN
10	Cedar	TO BE REMOVED		2661		Cedar	TO REMAIN
10	Cedar	TO BE REMOVED		2662		Cedar	TO REMAIN
8	Cedar	TO BE REMOVED		2663		Cedar	TO REMAIN
8	Cedar	TO BE REMOVED		2664		Cedar	TO REMAIN
10	Cedar	TO BE REMOVED					TO REMAIN
6	Cedar Cedar	TO BE REMOVED TO BE REMOVED		2665 2666		Cedar	TO REMAIN
6	Cedar	TO BE REMOVED				Cedar	10 7020 10 70 10 70 70 70 70
6	Cedar	TO BE REMOVED		2667		Cedar	TO REMAIN
12	Cedar	TO BE REMOVED	6	2668		Cedar	TO REMAIN
6	Cedar	TO BE REMOVED		2669		Cedar	TO REMAIN
8	Cedar	TO BE REMOVED		2670		Cedar	TO REMAIN
10	Cedar	TO BE REMOVED		2671		Cedar	TO REMAIN
6	Cedar	TO BE REMOVED		2672		Cedar	TO REMAIN
8	Cedar	TO BE REMOVED		2673		Cedar	TO REMAIN
8	Cedar	TO BE REMOVED		2674		Cedar	TO REMAIN
8	Cedar	TO BE REMOVED		2675	6	Cedar	TO REMAIN
6	Cedar	TO BE REMOVED		2676	6	Cedar	TO REMAIN
6	Cedar	TO BE REMOVED		2677	7 6	Cedar	TO REMAIN
6	Cedar	TO BE REMOVED		2678	6	Cedar	TO REMAIN
6	Cedar	TO BE REMOVED		2679	9 6	Cedar	TO REMAIN
6	Cedar Cedar	TO BE REMOVED TO BE REMOVED		2680	12	Cedar	TO REMAIN
6	Cedar	TO BE REMOVED		2681	10	Cedar	TO REMAIN
6	Cedar	TO BE REMOVED		2682		Cedar	TO REMAIN
8	Cedar	TO BE REMOVED		2683		Cedar	TO REMAIN
12	Cedar	TO BE REMOVED	6	2684		Cedar	TO REMAIN
14	Cedar	TO BE REMOVED	7	2685		Cedar	TO REMAIN
6	Cedar	TO BE REMOVED		2686		Cedar	TO REMAIN
12	Cedar	TO BE REMOVED	6	2687		Cedar	TO REMAIN
10	Cedar	TO BE REMOVED		2688		Cedar	TO REMAIN
8	Cedar	TO BE REMOVED		2689		Cedar	TO REMAIN
12	Cedar	TO BE REMOVED	6	2690		Cedar	TO REMAIN
10	Cedar	TO BE REMOVED		2691		Cedar	TO REMAIN
6	Cedar	TO BE REMOVED		2692		Cedar	TO REMAIN
6 12	Cedar Cedar	TO REMAIN TO BE REMOVED	6	2693		Cedar	TO REMAIN
6	Cedar	TO BE REMOVED	0	2694		Cedar	TO REMAIN
8	Cedar	TO BE REMOVED		2695		Cedar	TO REMAIN
8	Cedar	TO BE REMOVED					The second secon
8	Cedar	TO BE REMOVED		2696		Cedar	TO REMAIN
12	Cedar	TO BE REMOVED	6	2697		Cedar	TO REMAIN
6	Cedar	TO BE REMOVED		2698		Cedar	TO REMAIN
14	Cedar	TO BE REMOVED	7	2699		Cedar	TO REMAIN
10	Cedar	TO BE REMOVED		2700		Cedar	TO REMAIN
6	Cedar	TO BE REMOVED		2901		Cedar	TO BE REMOVED
10	Cedar	TO BE REMOVED		2902		Cedar	TO BE REMOVED
10 12	Cedar Cedar	TO BE REMOVED TO BE REMOVED	6	2903		Cedar	TO BE REMOVED
12	Cedar	TO BE REMOVED	<u> </u>	2904		Cedar	TO BE REMOVED
12	Cedar	TO BE REMOVED	6	2905		Cedar	TO BE REMOVED
8	Cedar	TO BE REMOVED		2906		Cedar	TO BE REMOVED
6	Cedar	TO BE REMOVED		2907		Cedar	TO BE REMOVED
8	Cedar	TO BE REMOVED		2908		Cedar	TO REMAIN
6	Cedar	TO REMAIN		2909		Cottonwood	TO REMAIN
6	Cedar	TO REMAIN		2910		Cedar	TO REMAIN
12	Cedar	TO BE REMOVED	6	2911		Cedar	TO REMAIN
8	Cedar	TO REMAIN		2913		Cedar	TO REMAIN
6 8	Cedar Cedar	TO REMAIN TO REMAIN		2914		Cedar	TO BE REMOVED
8	Cedar	TO REMAIN		2915		Cedar	TO BE REMOVED
8	Cedar	TO REMAIN TO BE REMOVED		2916		Cedar	TO BE REMOVED
10	Cedar	TO BE REMOVED		2917		Cedar	TO BE REMOVED
8	Cedar	TO BE REMOVED		2918	6	Cedar	TO BE REMOVED
6	Cedar	TO REMAIN		2919	8	Cedar	TO BE REMOVED
12	Cedar	TO REMAIN		2920	8	Cedar	TO REMAIN
12	Cedar	TO REMAIN		2921	6	Cedar	TO REMAIN
24	Cedar	TO REMAIN		2922	2 8	Cedar	TO REMAIN
10	Cedar	TO REMAIN		2923		Cedar	TO REMAIN
10	Cedar	TO REMAIN		2924		Cottonwood	TO REMAIN
10	Cedar	TO REMAIN		2925		Cedar	TO BE REMOVED
8	Cedar	TO REMAIN		2926		Cedar	TO BE REMOVED
10	Cedar	TO REMAIN		2927		Cedar	TO BE REMOVED
12 8	Cedar Cedar	TO REMAIN TO REMAIN		2928		Cedar	TO BE REMOVED
12	Cedar	TO REMAIN TO REMAIN		2929		Cedar	TO BE REMOVED
6	Cedar	TO REMAIN		2930		Cedar	TO BE REMOVED
6	Cedar	TO REMAIN		2930		Cottonwood	TO REMAIN
12	Cedar	TO REMAIN		2937		Cottonwood	TO BE REMOVED
12	Cedar	TO REMAIN					
8	Cedar	TO REMAIN		2933		Cedar	TO BE REMOVED
8	Cedar	TO REMAIN		2934		Cedar	TO BE REMOVED
6	Cedar	TO REMAIN		2935		Cedar	TO REMAIN
6	Cedar	TO REMAIN			liper Inches		
6	Cedar	TO REMAIN			liper Inches I		
8	Cedar	TO REMAIN			tigation Inche		
10	Cedar	TO REMAIN				es Provided - (57) 4"	cal. trees
10	Cedar	TO REMAIN			_	s Remaining	
6	Cedar	TO REMAIN			tigation Cost		
8	Cedar	TO REMAIN					

• 4245 North Central Expy Suite 501 Dallas, Texas 75205 • 214.865.7192 office

\$7,100

OMEGA DESIGN, LLC 811 S. CENTRAL EXPRESSWAY SUITE 306

RICHARDSON, TX 75080 TBPE FIRM NO. F-20145

RE	REVISIONS				
#	DATE	COMMENTS			
1	05.06.20	City Comments			
2	10.13.20	City Comments			
3	11.19.21	City Comments			
4	12.06.21	City Comments			
5	03.03.22	City Comments			
6	08.05.22	City Comments			

PROFESSIONAL SEAL



OWNER INFORMATION

TLC Lakeside Kids, I 5909 Beth Drive Plano, TX 75093


PROJECT INFORMATION

PINNACLE MONTESSORI
ACADEMY ROCKWALL
E. RALPH HALL PARKWAY AND PLAZA DRIV
ROCKWALL, TEXAS

SHEET TITLE

TREE PRESERVATION NOTES

> SHEET NUMBER L1.02

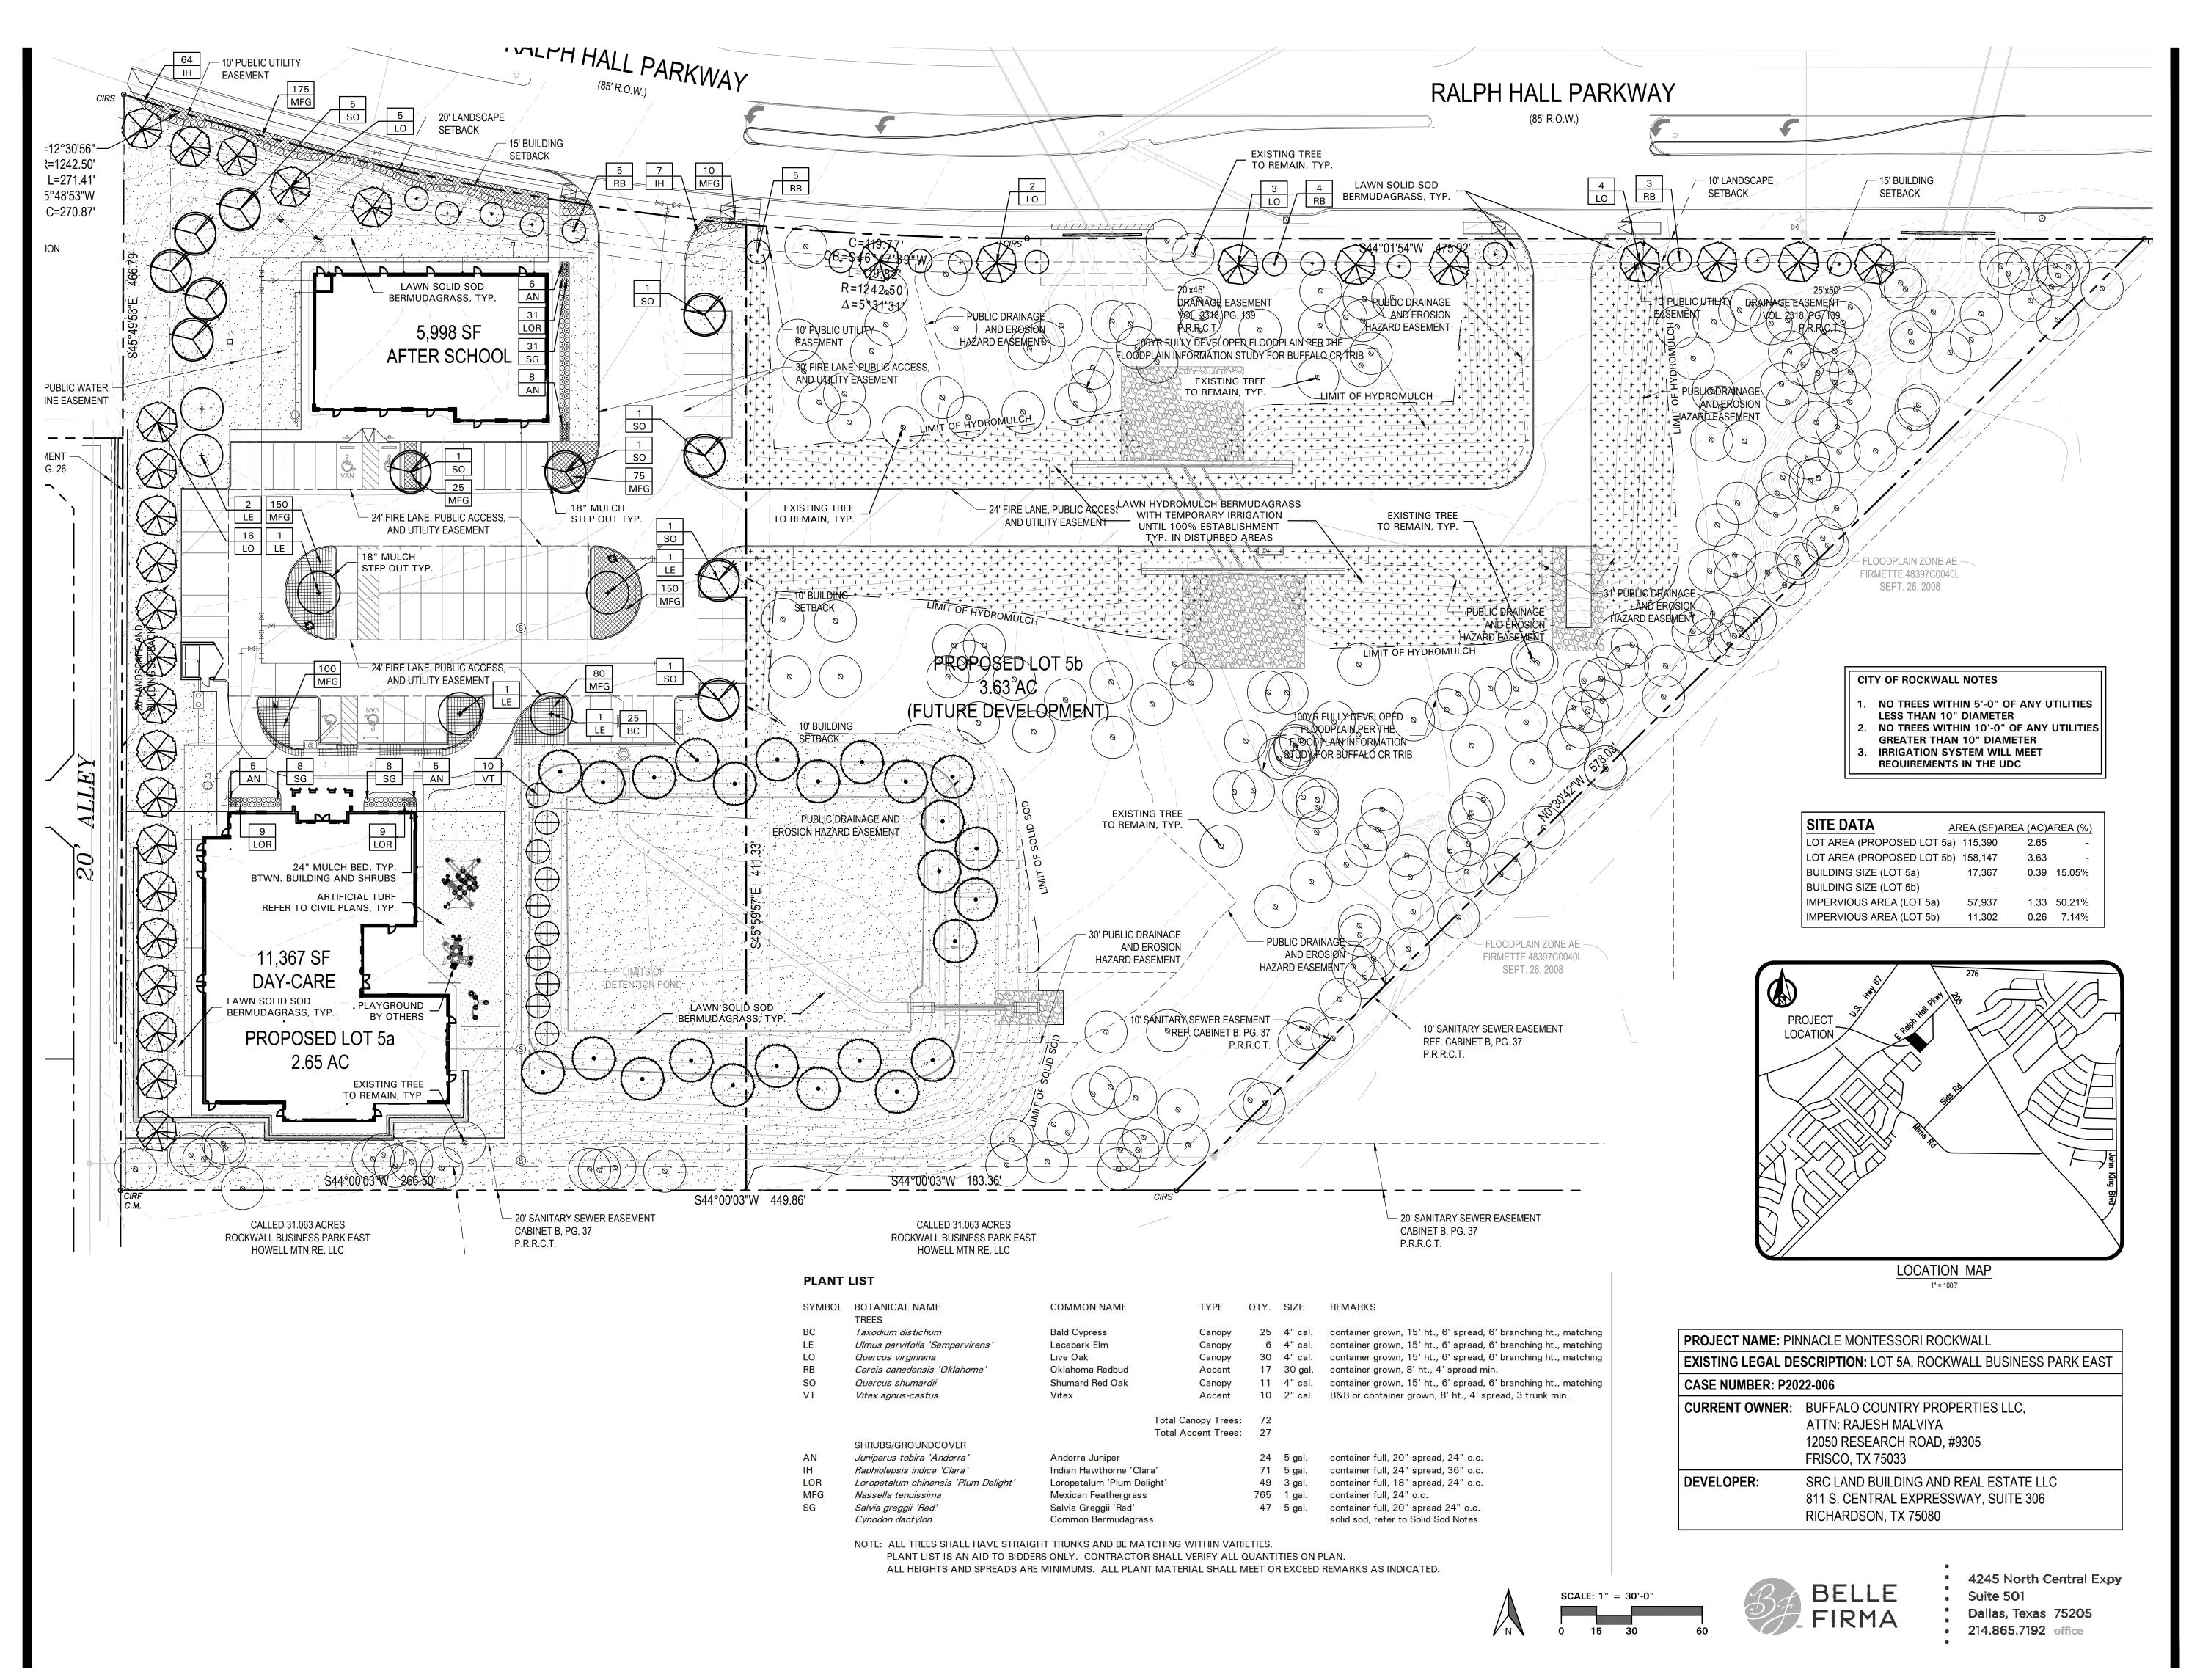

OMEGA DESIGN, LLC 811 S. CENTRAL EXPRESSWA

SUITE 306 RICHARDSON, TX 75080

TBPE FIRM NO. F-20145

	RE	VISIONS	6
Γ	#	DATE	COMMENTS
Γ	1	05.06.20	City Comments
Γ	2	10.13.20	City Comments
Ī	3	11.19.21	City Comments
Γ	4	12.06.21	City Comments
Γ	5	03.03.22	City Comments
Γ	6	08.05.22	City Comments
Γ			
Γ			
Γ			
Ī			
Г			



OWNER INFORMATION

PROJECT INFORMATION

LANDSCAPE

SHEET NUMBER L2.01

LANDSCAPE NOTES

- 1. CONTRACTOR SHALL VERIFY ALL EXISTING AND PROPOSED SITE ELEMENTS AND NOTIFY LANDSCAPE ARCHITECT OF ANY DISCREPANCIES. SURVEY DATA OF EXISTING CONDITIONS WAS SUPPLIED BY OTHERS.
- 2. CONTRACTOR SHALL LOCATE ALL EXISTING UNDERGROUND UTILITIES AND NOTIFY LANDSCAPE ARCHITECT OF ANY CONFLICTS. CONTRACTOR SHALL EXERCISE CAUTION WHEN WORKING IN THE VICINITY OF UNDERGROUND UTILITIES.
- 3. CONTRACTOR SHALL PROVIDE A MINIMUM 2% SLOPE AWAY FROM ALL STRUCTURES.
- 4. CONTRACTOR SHALL FINE GRADE AREAS TO ACHIEVE FINAL CONTOURS AS INDICATED. LEAVE AREAS TO RECEIVE TOPSOIL 3" BELOW FINAL FINISHED GRADE IN PLANTING AREAS AND 1" BELOW FINAL FINISHED GRADE IN LAWN AREAS.
- 5. CONTRACTOR SHALL CROWN ALL LANDSCAPE ISLANDS TO 6" HEIGHT, TYPICAL AND UNIFORM THROUGHOUT THE SITE.
- 6. CONTRACTOR SHALL OBTAIN LANDSCAPE ARCHITECT'S APPROVAL OF FINE GRADING, CROWNS, AND BERMS PRIOR TO INSTALLING LANDSCAPE. NOTIFY LANDSCAPE ARCHITECT 72 HOURS IN ADVANCE TO SCHEDULE A SITE VISIT.
- 7. ALL PLANTING BEDS AND LAWN AREAS SHALL BE SEPARATED BY STEEL EDGING. NO STEEL EDGING SHALL BE INSTALLED ADJACENT TO BUILDINGS, WALKS, OR CURBS. CUT STEEL EDGING AT 45 DEGREE ANGLE WHERE IT INTERSECTS WALKS AND CURBS.
- 8. TOP OF MULCH SHALL BE 1/2" MINIMUM BELOW THE TOP OF WALKS AND CURBS.
- 9. ALL LAWN AREAS SHALL BE SOLID SOD BERMUDAGRASS, UNLESS OTHERWISE NOTED ON THE DRAWINGS.
- 10. ALL REQUIRED LANDSCAPE AREAS SHALL BE PROVIDED WITH AN AUTOMATIC UNDERGROUND IRRIGATION SYSTEM WITH RAIN AND FREEZE SENSORS AND EVAPOTRANSPIRATION (ET) WEATHER-BASED CONTROLLERS AND SAID IRRIGATION SYSTEM SHALL BE DESIGNED BY A QUALIFIED PROFESSIONAL AND INSTALLED BY A LICENSED IRRIGATOR.
- 11. CONTRACTOR SHALL PROVIDE BID PROPOSAL LISTING UNIT PRICES FOR ALL MATERIAL PROVIDED.
- 12. CONTRACTOR SHALL BE RESPONSIBLE FOR OBTAINING ALL REQUIRED LANDSCAPE AND IRRIGATION PERMITS.

MAINTENANCE NOTES

- 1. THE OWNER, TENANT AND THEIR AGENT, IF ANY, SHALL BE JOINTLY AND SEVERALLY RESPONSIBLE FOR THE MAINTENANCE OF ALL LANDSCAPE.
- 2. ALL LANDSCAPE SHALL BE MAINTAINED IN A NEAT AND ORDERLY MANNER AT ALL TIMES. THIS SHALL INCLUDE MOWING, EDGING, PRUNING, FERTILIZING, WATERING, WEEDING AND OTHER SUCH ACTIVITIES COMMON TO LANDSCAPE MAINTENANCE.
- 3. ALL LANDSCAPE AREAS SHALL BE KEPT FREE OF TRASH, LITTER, WEEDS AND OTHER SUCH MATERIAL OR PLANTS NOT PART OF THIS PLAN.
- 4. ALL PLANT MATERIAL SHALL BE MAINTAINED IN A HEALTHY AND GROWING CONDITION AS IS APPROPRIATE FOR THE SEASON OF THE YEAR.
- 5. ALL PLANT MATERIAL WHICH DIES SHALL BE REPLACED WITH PLANT MATERIAL OF EQUAL OR BETTER VALUE.
- 6. CONTRACTOR SHALL PROVIDE SEPARATE BID PROPOSAL FOR ONE YEAR'S MAINTENANCE TO BEGIN AFTER FINAL ACCEPTANCE.

GENERAL LAWN NOTES

- 1. CONTRACTOR SHALL COORDINATE OPERATIONS AND AVAILABILITY OF EXISTING TOPSOIL WITH ON-SITE CONSTRUCTION MANAGER.
- 2. CONTRACTOR SHALL LEAVE LAWN AREAS 1" BELOW FINAL FINISHED GRADE PRIOR TO TOPSOIL INSTALLATION.
- 3. CONTRACTOR SHALL FINE GRADE AREAS TO ACHIEVE FINAL CONTOURS AS INDICATED ON CIVIL PLANS. ADJUST CONTOURS TO ACHIEVE POSITIVE DRAINAGE AWAY FROM BUILDINGS. PROVIDE UNIFORM ROUNDING AT TOP AND BOTTOM OF SLOPES AND OTHER BREAKS IN GRADE. CORRECT IRREGULARITIES AND AREAS WHERE WATER MAY STAND.
- 4. ALL LAWN AREAS SHALL BE FINE GRADED, IRRIGATION TRENCHES COMPLETELY SETTLED AND FINISH GRADE APPROVED BY THE OWNER'S CONSTRUCTION MANAGER OR LANDSCAPE ARCHITECT PRIOR TO LAWN INSTALLATION.
- 5. CONTRACTOR SHALL REMOVE ALL ROCKS 3/4" DIAMETER AND LARGER, DIRT CLODS, STICKS, CONCRETE SPOILS, ETC. PRIOR TO PLACING TOPSOIL AND LAWN INSTALLATION.
- 6. CONTRACTOR SHALL PROVIDE AN ADD ALTERNATE PRICE TO INSTALL (2") TWO INCHES OF IMPORTED TOPSOIL ON ALL LAWN AREAS IN LIEU OF USING EXISTING TOPSOIL ON-SITE. IMPORTED TOPSOIL SHALL BE NATURAL, FRIABLE SOIL FROM THE REGION, KNOWN AS BOTTOM LAND SOIL, FREE FROM LUMPS, CLAY, TOXIC SUBSTANCES, ROOTS, DEBRIS, VEGETATION, STONES, CONTAINING NO SALT AND BLACK TO BROWN IN COLOR.
- 7. CONTRACTOR SHALL MAINTAIN ALL LAWN AREAS UNTIL FINAL ACCEPTANCE. THIS SHALL INCLUDE, BUT NOT BE LIMITED TO: MOWING, WATERING, WEEDING, CULTIVATING, CLEANING AND REPLACING DEAD OR BARE AREAS TO KEEP PLANTS IN A VIGOROUS, HEALTHY CONDITION.
- 8. CONTRACTOR SHALL GUARANTEE ESTABLISHMENT OF ACCEPTABLE TURF AREA AND SHALL PROVIDE REPLACEMENT FROM LOCAL SUPPLY IF NECESSARY.

SOLID SOD NOTES

- 1. PLANT SOD BY HAND TO COVER INDICATED AREAS COMPLETELY. ENSURE EDGES OF SOD ARE TOUCHING. TOP DRESS JOINTS BY HAND WITH TOPSOIL TO FILL
- 2. ROLL GRASS AREAS TO ACHIEVE A SMOOTH, EVEN SURFACE, FREE FROM UNNATURAL UNDULATIONS.
- 3. WATER SOD THOROUGHLY AS SOD OPERATION PROGRESSES.
- 4. IF INSTALLATION OCCURS BETWEEN SEPTEMBER 1 AND MARCH 1. OVER-SEED BERMUDAGRASS SOD WITH WINTER RYEGRASS, AT A RATE OF FOUR (4) POUNDS PER ONE THOUSAND (1000) SQUARE FEET.

HYDROMULCH NOTES

- 1. CONTRACTOR SHALL SCARIFY, RIP AND LOOSEN ALL AREAS TO BE HYDROMULCHED TO A MINIMUM DEPTH OF 4" PRIOR TO TOPSOIL AND HYDROMULCH INSTALLATION.
- BERMUDAGRASS SEED SHALL BE EXTRA HULLED AND TREATED LAWN TYPE, SHALL BE DELIVERED TO THE SITE IN ITS ORIGINAL UNOPENED CONTAINER AND SHALL MEET STATE LAW REQUIREMENTS.
- 3. FIBER SHALL BE ONE HUNDRED PERCENT (100%) WOOD CELLULOSE FIBER, DELIVERED TO THE SITE IN ITS ORIGINAL UNOPENED CONTAINER AS

'TERRO-TACK ONE', AS MANUFACTURED BY

- MANUFACTURED BY 'CONWEB' OR EQUAL. 4. FIBER TACK SHALL BE DELIVERED TO THE SITE IN ITS ORIGINAL UNOPENED CONTAINER AND SHALL BE
- 5. HYDROMULCH WITH BERMUDAGRASS SEED AT A RATE OF TWO (2) POUNDS PER ONE THOUSAND (1000) SQUARE FEET.

GROWERS, INC. OR EQUAL.

- 6. USE A 4'X8' BATTER BOARD AGAINST ALL BED AREAS.
- 7. IF INSTALLATION OCCURS BETWEEN SEPTEMBER 1 AND MAY 1, ALL HYDROMULCH AREAS TO BE WINTER RYEGRASS, AT A RATE OF FOUR (4) POUNDS PER ONE THOUSAND (1000) SQUARE FEET. CONTRACTOR SHALL BE REQUIRED TO RE-HYDROMULCH WITH BERMUDAGRASS THE FOLLOWING GROWING SEASON AS PART OF THIS CONTRACT.
- 8. ALL LAWN AREAS TO BE HYDROMULCHED SHALL HAVE ONE HUNDRED PERCENT (100%) COVERAGE PRIOR TO FINAL ACCEPTANCE.

LANDSCAPE TABULATIONS - Lot 5a THE CITY OF ROCKWALL, TEXAS

NON-RESIDENTIAL R.O.W. BUFFER

1. Ten (10') foot-wide landscape buffer with one tree per fifty (50) l.f. and one accent tree per (50) l.f., to include groundcover, berm, and shrubbery

RALPH HALL PARKWAY: 272 I.f. Required Provided 10' wide buffer 20' wide buffer (5) trees, 4" cal. (5) trees, 4" cal. (5) accent trees (5) accent trees

RESIDENTIAL BUFFER 1. Twenty (20') foot-wide landscape buffer with one tree per twenty (20) l.f.

Residential Adjacency: 320 l.f. Required 20' wide buffer 20' wide buffer (16) trees, 4" cal. (16) trees, 4" cal.

PARKING LOT LANDSCAPING 1. Five (5%) percent of the interior parking lot shall be 2. One tree per ten (10) spaces for lots over 20,000 s.f.

Total interior parking lot area: 23,980 s.f.

Total parking spaces: 64 spaces

Required 1,199 s.f. (5%) 4,288 s.f.

(7) trees, 4" cal. (12) trees, 4" cal.

SITE LANDSCAPING 1. Fifteen (15%) percent of the total site shall be landscaped

for COMMERCIAL. 2. Fifty (50%) percent of the total requirements shall be located in the front of and along side buildings for COMMERCIAL.

Total site: 273,538 s.f.

Required 41,031 s.f. (15%) 56,373 s.f. (21%) 20,516 s.f. (50%) 24,603 s.f. (60%)

DETENTION BASIN LANDSCAPING

1. One (1) canopy tree and (1) accent tree per 750 s.f. of dry area.

Detention Basin Area: 8,051 s.f.

Required Provided (10) trees, 4" cal. (10) trees, 4" cal. (10) accent trees (10) accent trees

LANDSCAPE TABULATIONS - Lot 5b THE CITY OF ROCKWALL, TEXAS

NON-RESIDENTIAL R.O.W. BUFER 1. Ten (10') foot-wide landscape buffer with one tree per fifty (50) l.f. and one accent tree per (50) l.f.

RALPH HALL PARKWAY: 596 l.f. Required Provided 10' wide buffer 10' wide buffer (12) trees, 4" cal. (9) trees, 4" cal. (12) accent trees (12) accent trees (3) existing trees

CITY OF ROCKWALL NOTES

- 1. NO TREES WITHIN 5'-0" OF ANY UTILITIES LESS THAN 10" DIAMETER
- 2. NO TREES WITHIN 10'-0" OF ANY UTILITIES **GREATER THAN 10" DIAMETER** IRRIGATION SYSTEM WILL MEET
 - REQUIREMENTS IN THE UDC





 4245 North Central Expy Suite 501 Dallas, Texas 75205

• 214.865.7192 office

OMEGA DESIGN, LLC 811 S. CENTRAL EXPRESSWAY

SUITE 306 RICHARDSON, TX 75080

TBPE FIRM NO. F-20145

RE	VISIONS	3
#	DATE	COMMENTS
1	05.06.20	City Comments
2	10.13.20	City Comments
3	11.19.21	City Comments
4	12.06.21	City Comments
5	03.03.22	City Comments
6	08.05.22	City Comments

PROFESSIONAL SEAL



OWNER INFORMATION

Kids, eth Drive TX 75093 മ **Ö** 8

PROJECT INFORMATION

PINNACLE MONTESS
ACADEMY ROCKWA
RALPH HALL PARKWAY AND PLA
ROCKWALL, TEXAS

SHEET TITLE

LANDSCAPE NOTES

SHEET NUMBER L2.02

1.1 REFERENCED DOCUMENTS

A. Refer to Landscape Plans, notes, details, bidding requirements, special provisions, and schedules for additional requirements.

1.2 DESCRIPTION OF WORK

- A. Work included: Furnish all supervision, labor, materials, services, equipment and appliances required to complete the work covered in conjunction with the landscaping covered in these specifications and landscaping plans, including:
- 1. Planting (trees, shrubs and grasses)
- 2. Bed preparation and fertilization
- 3. Notification of sources
- 4. Water and maintenance until final acceptance
- Guarantee

1.3 REFERENCE STANDARDS

- A. American Standard for Nursery Stock published by American Association of Nurserymen: April 14, 2014 Edition; by American National Standards Institute, Inc. (Z60.1) – plant material
- B. American Joint Committee on Horticultural Nomenclature: 1942 Edition of Standardized Plant Names.
- C. Texas Association of Nurserymen, Grades and Standards
- D. Hortis Third, 1976 Cornell University

1.4 NOTIFICATION OF SOURCES AND SUBMITTALS

A. Samples: Provide representative quantities of sandy loam soil mulch, bed mix material, gravel, crushed stone, steel edging and tree stakes. Samples shall be approved by Owner's Authorized Representative before use on the project.

1.5 JOB CONDITIONS

- A. General Contractor to complete the following punch list: Prior to Landscape Contractor initiating any portion of landscape 1.7 QUALITY ASSURANCE installation, General Contractor shall leave planting bed areas three (3") inches below final finish grade of sidewalks, drives and curbs as shown on the drawings. All lawn areas to receive solid sod shall be left one (1") inch below the final finish grade of sidewalks, drives and curbs. All construction debris shall be removed prior to Landscape Contractor beginning any work.
- B. Storage of materials and equipment at the job site will be at the risk of the Landscape Contractor. The Owner cannot be held responsible for theft or damage.

1.6 MAINTENANCE AND GUARANTEE

A. Maintenance:

- 1. The Landscape Contractor shall be held responsible for the maintenance of all work from the time of planting until final acceptance by the Owner. No trees, shrubs, groundcover or grass will be accepted unless they show healthy growth and satisfactory foliage conditions.
- Maintenance shall include watering of trees and plants, cultivation, weeding spraying, edging, pruning of trees, mowing of grass, cleaning up and all other work necessary of maintenance.
- 3. A written notice requesting final inspection and acceptance should be submitted to the Owner at least seven (7) days prior to completion. An on-site inspection by the Owner's Authorized Representative will be completed prior to written acceptance.

B. Guarantee:

- 1. Trees, shrubs and groundcover shall be guaranteed for a twelve (12) month period after final acceptance. The Contractor shall replace all dead materials as soon as weather permits and upon notification of the Owner. Plants, including trees, which have partially died so that shape, size, or symmetry have been damaged, shall be considered subject to replacement. In such cases, the opinion of the Owner shall be final.
- a. Plants used for replacement shall be of the same size and kind as those originally planted and shall be planted as originally specified. All work, including materials. labor and equipment used in replacements, shall carry a twelve (12) month guarantee. Any damage, including ruts in lawn or bed areas, incurred as a result of making replacements shall be immediately repaired.
- b. At the direction of the Owner, plants may be replaced at the start of the next year's planting season. In such cases, dead plants shall be removed from the premises 1.8 PRODUCT DELIVERY, STORAGE AND HANDLING immediately.
- c. When plant replacements are made, plants, soil mix, fertilizer and mulch are to be utilized as originally specified and re-inspected for full compliance with the contract requirements. All replacements are to be included under "Work" of this section.
- 2. The Owner agrees that for the guarantee to be effective, he will water plants at least twice a week during dry periods and cultivate beds once a month after final acceptance.
- 3. The above guarantee shall not apply where plants die after acceptance because of injury from storms, hail, freeze, insects, diseases, injury by humans, machines or theft.
- 4. Acceptance for all landscape work shall be given after final inspection by the Owner provided the job is in a complete, undamaged condition and there is a stand of grass in all lawn areas. At that time, the Owner will assume maintenance on the accepted work.
- Repairs: Any necessary repairs under the Guarantee must be made within ten (10) days after receiving notice, weather permitting. In the event the Landscape Contractor does not make repairs accordingly, the Owner, without further notice to Contractor, may provide materials and men to make such repairs at the expense to the Landscape Contractor.

- A. General: Comply with applicable federal, state, county and local regulations governing landscape materials and work.
- B. Personnel: Employ only experienced personnel who are familiar with the required work. Provide full time supervision by a qualified foreman acceptable to Landscape Architect.
- Selection of Plant Material:
- 1. Make contact with suppliers immediately upon obtaining notice of contract acceptance to select and book materials. Develop a program of maintenance (pruning and fertilization) which will ensure the purchased materials will meet and / or exceed project specifications.
- Substitutions: Do not make plant material substitutions. If the specified landscape material is not obtainable, submit proof of non-availability to Landscape Architect, together with proposal for use of equivalent material. At the time bids are submitted, the Contractor is assumed to have located the materials necessary to complete the job as specified.
- 3. Landscape Architect will provide a key identifying each tree location on site. Written verification will be required to document material selection, source and delivery schedules to site.
- 4. Measurements: Measure trees with branches and trunks or canes in their normal position. Do not prune to obtain required sizes. Take caliper measurements six inches above ground for trees up to and including 4" caliper size, and twelve inches above ground for larger sizes. Measure main body of all plant material of height and spread dimensions,

do not measure from branch or root tip-to-tip.

- 5. Owner's Authorized Representative shall inspect all plant material with requirements for genus, species, cultivar / variety size and quality.
- 6. Owner's Authorized Representative retains the right to further inspect all plant material upon arrival to the site and during installation for size and condition of root balls and root systems, limbs, branching habit, insects, injuries and latent defects.
- 7. Owner's Authorized Representative may reject unsatisfactory or defective material at any time during the process work. Remove rejected materials immediately from the site and replace with acceptable material at no additional cost to the Owner. Plants damaged in transit or at job site shall be rejected.

A. Preparation:

- 1. Balled and Burlapped (B&B) Plants: Dig and prepare shipment in a manner that will not damage roots, branches, shape and future development.
- 2. Container Grown Plants: Deliver plants in rigid container to hold ball shape and protect root mass.

- 1. Deliver packaged materials in sealed containers showing weight, analysis and name of manufacturer. Protect materials from deterioration during delivery and while stored
- 2. Deliver only plant materials that can be planted in one day unless adequate storage and watering facilities are available
- 3. Protect root balls by heeling in with sawdust or other approved moisture retaining material if not planted within 24
- 4. Protect plants during delivery to prevent damage to root balls or desiccation of leaves. Keep plants moist at all
- times. Cover all materials during transport. 5. Notify Owner's Authorized Representative of delivery schedule 72 hours in advance job site.
- 6. Remove rejected plant material immediately from job site.
- 7. To avoid damage or stress, do not lift, move, adjust to plumb, or otherwise manipulate plants by trunk or stems.

PART 2 - PRODUCTS

2.1 PLANTS

- A. General: Well-formed No. 1 grade or better nursery grown stock. Listed plant heights are from tops of root balls to nominal tops of plants. Plant spread refers to nominal outer width of the plant, not to the outer leaf tips. Plants will be individually approved by the Owner's Authorized Representative and his decision as to their acceptability shall be final.
- B. Quantities: The drawings and specifications are complimentary. 2.3 MISCELLANEOUS MATERIALS Anything called for on one and not the other is as binding as if shown and called for on both. The plant schedule is an aid to bidders only. Confirm all quantities on plan.
- C. Quality and size: Plant materials shall conform to the size given on the plan, and shall be healthy, symmetrical, well-shaped, full branched and well rooted. The plants shall be free from injurious insects, diseases, injuries to the bark or roots, broken branches, objectionable disfigurements, insect eggs and larvae, and are to
- D. Approval: All plants which are found unsuitable in growth, or are in any unhealthy, badly shaped or undersized condition will be rejected by the Owner's Authorized Representative either before or after planting and shall be removed at the expense of the Landscape Contractor and replaced with acceptable plant as

specified at no additional cost to the Owner.

- Trees shall be healthy, full-branched, well-shaped, and shall meet the minimum trunk and diameter requirements of the plant schedule. Balls shall be firm, neat, slightly tapered and well wrapped in burlap. Any tree loose in the ball or with a broken PART 3 - EXECUTION root ball at time of planting will be rejected. Balls shall be ten (10") inches in diameter for each one (1") inch of trunk diameter, 3.1 BED PREPARATION & FERTILIZATION measured six (6") inches above ball. (Nomenclature confirms to the customary nursery usage. For clarification, the term "multi-trunk" defines a plant having three (3) or more trunks of nearly equal diameter.)
- Pruning: All pruning of trees and shrubs, as directed by the Landscape Architect prior to final acceptance, shall be executed by the Landscape Contractor at no additional cost to the Owner.

2.2 SOIL PREPARATION MATERIALS

A. Sandy Loam:

- 1. Friable, fertile, dark, loamy soil, free of clay lumps, subsoil, stones and other extraneous material and reasonably free of weeds and foreign grasses. Loam containing Dallasgrass or Nutgrass shall be rejected.
- Physical properties as follows: a. Clay - between 7-27 percent b. Silt – between 15-25 percent c. Sand – less than 52 percent
- 3. Organic matter shall be 3%-10% of total dry weight.
- 4. If requested, Landscape Contractor shall provide a certified soil analysis conducted by an approved soil testing laboratory verifying that sandy loam meets the above requirements.
- Organic Material: Compost with a mixture of 80% vegetative matter and 20% animal waste. Ingredients should be a mix of 3.2 INSTALLATION course and fine textured material
- Premixed Bedding Soil as supplied by Vital Earth Resources, Gladewater, Texas; Professional Bedding Soil as supplied by Living Earth Technology, Dallas, Texas or Acid Gro Municipal Mix as supplied by Soil Building Systems, Dallas, Texas or approved
- D. Sharp Sand: Sharp sand must be free of seeds, soil particles and
- E. Mulch: Double Shredded Hardwood Mulch, partially decomposed, dark brown. Living Earth Technologies or approved equal.
- F. Organic Fertilizer: Fertilaid, Sustane, or Green Sense or equal as recommended for required applications. Fertilizer shall be delivered to the site in original unopened containers, each bearing the manufacturer's guaranteed statement of analysis.
- G. Commercial Fertilizer: 10-20-10 or similar analysis. Nitrogen source to be a minimum 50% slow release organic Nitrogen (SCU or UF) with a minimum 8% sulfur and 4% iron, plus
- H. Peat: Commercial sphagnum peat moss or partially decomposed shredded pine bark or other approved organic material.

- Steel Edging: All steel edging shall be 3/16" thick x 4" deep x 16' long with 6 stakes per section, painted black at the factory as manufactured by The J.D. Russell Company and under its trade name DURAEDGE Heavy Duty Steel.
- B. Staking Material for Shade Trees: refer to details
- C. Gravel: Washed native pea gravel, graded 1 inch to 1-1/2 inch.
- D. Filter Fabric: 'Mirafi Mirascape' by Mirafi Construction Products available at Lone Star Products, Inc., (469) 523-0444 or approved equal.
- E. River Rock: 'Colorado' or native river rock, 2" 4" dia.

F. Decomposed Granite: Base material shall consist of a natural material mix of granite aggregate not to exceed 1/8" diameter in size and shall be composed of various stages of decomposed

- A. Landscape Contractor to inspect all existing conditions and report any deficiencies to the Owner.
- B. All planting areas shall be conditioned as follows:
- 1. Prepare new planting beds by scraping away existing grass and weeds as necessary. Till existing soil to a depth of six (6") inches prior to placing compost and fertilizer. Apply fertilizer as per Manufacturer's recommendations. Add six (6") inches of compost and till into a depth of six (6") inches of the topsoil. Apply organic fertilizer such as Sustane or Green Sense at the rate of twenty (20) pounds per one thousand (1,000) square feet.
- 2. All planting areas shall receive a two (2") inch layer of specified mulch.
- 3. Backfill for tree pits shall be as follows: Use existing top soil on site (use imported topsoil as needed) free from large clumps, rocks, debris, caliche, subsoils, etc., placed in nine (9") inch layers and watered in thoroughly.

1. Blocks of sod should be laid joint to joint (staggered joints) after fertilizing the ground first. Roll grass areas to achieve a smooth, even surface. The joints between the blocks of sod should be filled with topsoil where they are evidently gaped open, then watered thoroughly.

- A. Maintenance of plant materials shall begin immediately after each plant is delivered to the site and shall continue until all construction has been satisfactorily accomplished.
- B. Plant materials shall be delivered to the site only after the beds are prepared and areas are ready for planting. All shipments of nursery materials shall be thoroughly protected from the drying winds during transit. All plants which cannot be planted at once, after delivery to the site, shall be well protected against the possibility of drying by wind and Balls of earth of B & B plants shall be kept covered with soil or other acceptable material. All plants remain the property of the Contractor until final
- C. Position the trees and shrubs in their intended location as per
- D. Notify the Owner's Authorized Representative for inspection and approval of all positioning of plant materials.
- Excavate pits with vertical sides and horizontal bottom. Tree pits shall be large enough to permit handling and planting without injury to balls of earth or roots and shall be of such depth that, when planted and settled, the crown of the plant shall bear the same relationship to the finish grade as it did to soil surface in original place of growth.
- F. Shrub and tree pits shall be no less than twenty-four (24") inches wider than the lateral dimension of the earth ball and six (6") inches deeper than it's vertical dimension. Remove and haul from site all rocks and stones over three-quarter $(\frac{3}{4})$ inch in diameter. Plants should be thoroughly moist before removing 3.3 CLEANUP AND ACCEPTANCE
- G. Dig a wide, rough sided hole exactly the same depth as the height of the ball, especially at the surface of the ground. The sides of the hole should be rough and jagged, never slick or
- H. Percolation Test: Fill the hole with water. If the water level does not percolate within 24 hours, the tree needs to move to another END OF SECTION location or have drainage added. Install a PVC stand pipe per

- tree planting detail as approved by the Landscape Architect if the percolation test fails.
- Backfill only with 5 parts existing soil or sandy loam and 1 part bed preparation. When the hole is dug in solid rock, topsoil from the same area should not be used. Carefully settle by watering to prevent air pockets. Remove the burlap from the top $\frac{1}{2}$ of the ball, as well as all nylon, plastic string and wire. Container trees will usually be root bound, if so follow standard nursery practice
- of 'root scoring'. J. Do not wrap trees.
- K. Do not over prune.
- Mulch the top of the ball. Do not plant grass all the way to the trunk of the tree. Leave the area above the top of the ball and mulch with at least two (2") inches of specified mulch.
- M. All plant beds and trees to be mulched with a minimum settled thickness of two (2") inches over the entire bed or pit.
- N. Obstruction below ground: In the event that rock, or underground construction work or obstructions are encountered in any plant pit excavation work to be done under this section, alternate locations may be selected by the Owner. Where locations cannot be changed, the obstructions shall be removed to a depth of not less than three (3') feet below grade and no less than six (6") inches below the bottom of ball when plant is properly set at the required grade. The work of this section shall include the removal from the site of such rock or underground obstructions encountered at the cost of the Landscape
- Trees and large shrubs shall be staked as site conditions require. Position stakes to secure trees against seasonal prevailing winds.
- P. Pruning and Mulching: Pruning shall be directed by the Landscape Architect and shall be pruned in accordance with standard horticultural practice following Fine Pruning, Class I pruning standards provided by the National Arborist Association.
- 1. Dead wood, suckers, broken and badly bruised branches shall be removed. General tipping of the branches is not permitted. Do not cut terminal branches.
- 2. Pruning shall be done with clean, sharp tools.
- 3. Immediately after planting operations are completed, all tree pits shall be covered with a layer of organic material two (2") inches in depth. This limit of the organic material for trees shall be the diameter of the plant pit.

Q. Steel Curbing Installation:

- 1. Curbing shall be aligned as indicated on plans. Stake out limits of steel curbing and obtain Owners approval prior to
- 2. All steel curbing shall be free of kinks and abrupt bends.
- 3. Top of curbing shall be $\frac{1}{2}$ " maximum height above final
- 4. Stakes are to be installed on the planting bed side of the curbing, as opposed to the grass side.
- Do not install steel edging along sidewalks or curbs.
- 6. Cut steel edging at 45 degree angle where edging meets sidewalks or curbs.

A. Cleanup: During the work, the premises shall be kept neat and orderly at all times. Storage areas for all materials shall be so organized so that they, too, are neat and orderly. All trash and debris shall be removed from the site as work progresses. Keep paved areas clean by sweeping or hosing them at end of each

work day.

PROJECT INFORMATION

SHEET TITLE

AND DETAILS

SHEET NUMBER

1 TREE PLANTING DETAIL NOT TO SCALE

C. ROOT BALL: REMOVE TOP $\frac{1}{3}$ BURLAP AND ANY OTHER FOREIGN OBJECT;

TREE PLANTING DETAIL LEGEND

A. TREE: TREES SHALL CONFORM WITH

B. TREE PIT: WIDTH TO BE AT LEAST TWO

NURSERY STOCK. www.anla.org

LATEST AMERICAN STANDARD FOR

(2) TIMES THE DIAMETER OF THE ROOT

BALL CENTER TREE IN HOLE & REST

ROOT BALL ON UNDISTURBED NATIVE

CONTAINER GROWN STOCK TO BE

AND NOTES

SOIL.

- INSPECTED FOR GIRDLING ROOTS. D. ROOT FLARE: ENSURE THAT ROOT FLARE IS EXPOSED, FREE FROM MULCH, AND AT LEAST TWO INCHES ABOVE GRADE. TREES SHALL BE REJECTED WHEN GIRDLING ROOTS ARE PRESENT &
- ROOT FLARE IS NOT APPARENT. E. ROOTBALL ANCHOR RING: REFER TO MANUFACTURER'S GUIDELINES FOR SIZING. PLACE ROOTBALL ANCHOR RING ON BASE OF ROOTBALL, TRUNK SHOULD BE IN THE CENTER OF THE
- F. ROOT ANCHOR BY TREE STAKE SOLUTIONS.
- G. NAIL STAKE: REFER TO MANUFACTURER'S GUIDELINES FOR SIZING. INSTALL NAIL STAKES WITH HAMMER OR MALLET FIRMLY INTO UNDISTURBED GROUND. DRIVE NAIL STAKES FLUSH WITH "U" BRACKET ADJACENT TO ROOTBALL (DO NOT DISTURB ROOTBALL).

- H. BACKFILL: USE EXISTING NATIVE SOIL (no amendments) WATER THOROUGHLY TO ELIMINATE AIR POCKETS.
- MULCH: DOUBLE SHREDDED HARDWOOD MULCH 2 INCH SETTLED THICKNESS, WITH 2" HT. WATERING
- TREE STAKES: TREE STAKE SOLUTIONS 'SAFETY STAKE' BELOW GROUND MODEL AVAILABLE FROM: Tree Stake Solutions
- jeff@treestakesolutions.com www.treestakesolutions.com OR APPROVED EQUAL. TREES SHALL BE STAKED BELOW GROUND WHERE NECESSARY; ABOVE GROUND STAKING
- K. IT SHALL BE THE RESPONSIBILITY OF THE CONTRACTOR TO OBTAIN A COPY MANUFACTURER'S SPECIFICATIONS INSTALLATION OF TREE STAKES. CONTRACTOR SHALL ADHERE TO MANUFACTURER'S INSTALLATION GUIDELINES, SPECIFICATIONS, AND OTHER REQUIREMENTS FOR TREE STAKE INSTALLATION.

- RING; ENSURE THAT ROOT FLARE IS EXPOSED. BELOW GROUND STAKE SHOULD NOT BE VISIBLE.

ATTN: Jeff Tuley (903) 676-6143

IS EXPRESSLY PROHIBITED.

SHRUBS / GROUNDCOVER; REFER TO LANDSCAPE PLAN TOPDRESS MULCH PER SPECIFICATIONS; 2" MINIMUM-SETTLED THICKNESS TOP OF MULCH 1/2" 3/16" X 4" BLACK EDGING, MINIMUM BELOW TOP OF-STAKES ON INSIDE; EDGING SHALL CONCRETE WALK / CURB BE 1/2" MAXIMUM HEIGHT ABOVE FINISH GRADE SCARIFY SIDES--LAWN / FINISH GRADE CONCRETE WALK-POCKET PLANTING NOT ALLOWED PREPARED SOIL MIX PER NO STEEL EDGING SHALL SPECIFICATIONS; TILL 6" MINIMUM BE INSTALLED ALONG OF PREPARED SOIL MIX INTO SIDEWALKS OR CURBS 6" DEPTH OF EXISTING SOIL REFER TO LANDSCAPE PLAN -NATIVE SOIL FOR SPACING

SHRUB / GROUNDCOVER DETAIL
NOT TO SCALE



DO NOT DISTURB

4245 North Central Expy Suite 501 Dallas, Texas 75205 214.865.7192 office

OMEGA DESIGN, LLC 811 S. CENTRAL EXPRESSWAY SUITE 306

RICHARDSON, TX 75080

TBPE FIRM NO. F-20145

RE	REVISIONS				
#	DATE	COMMENTS			
1	05.06.20	City Comments			
2	10.13.20	City Comments			
3	11.19.21	City Comments			
4	12.06.21	City Comments			
5	03.03.22	City Comments			
6	08.05.22	City Comments			

PROFESSIONAL SEAL




OWNER INFORMATION

Kids, Ф **Ö**

LANDSCAPE **SPECIFICATIONS**

L2.03

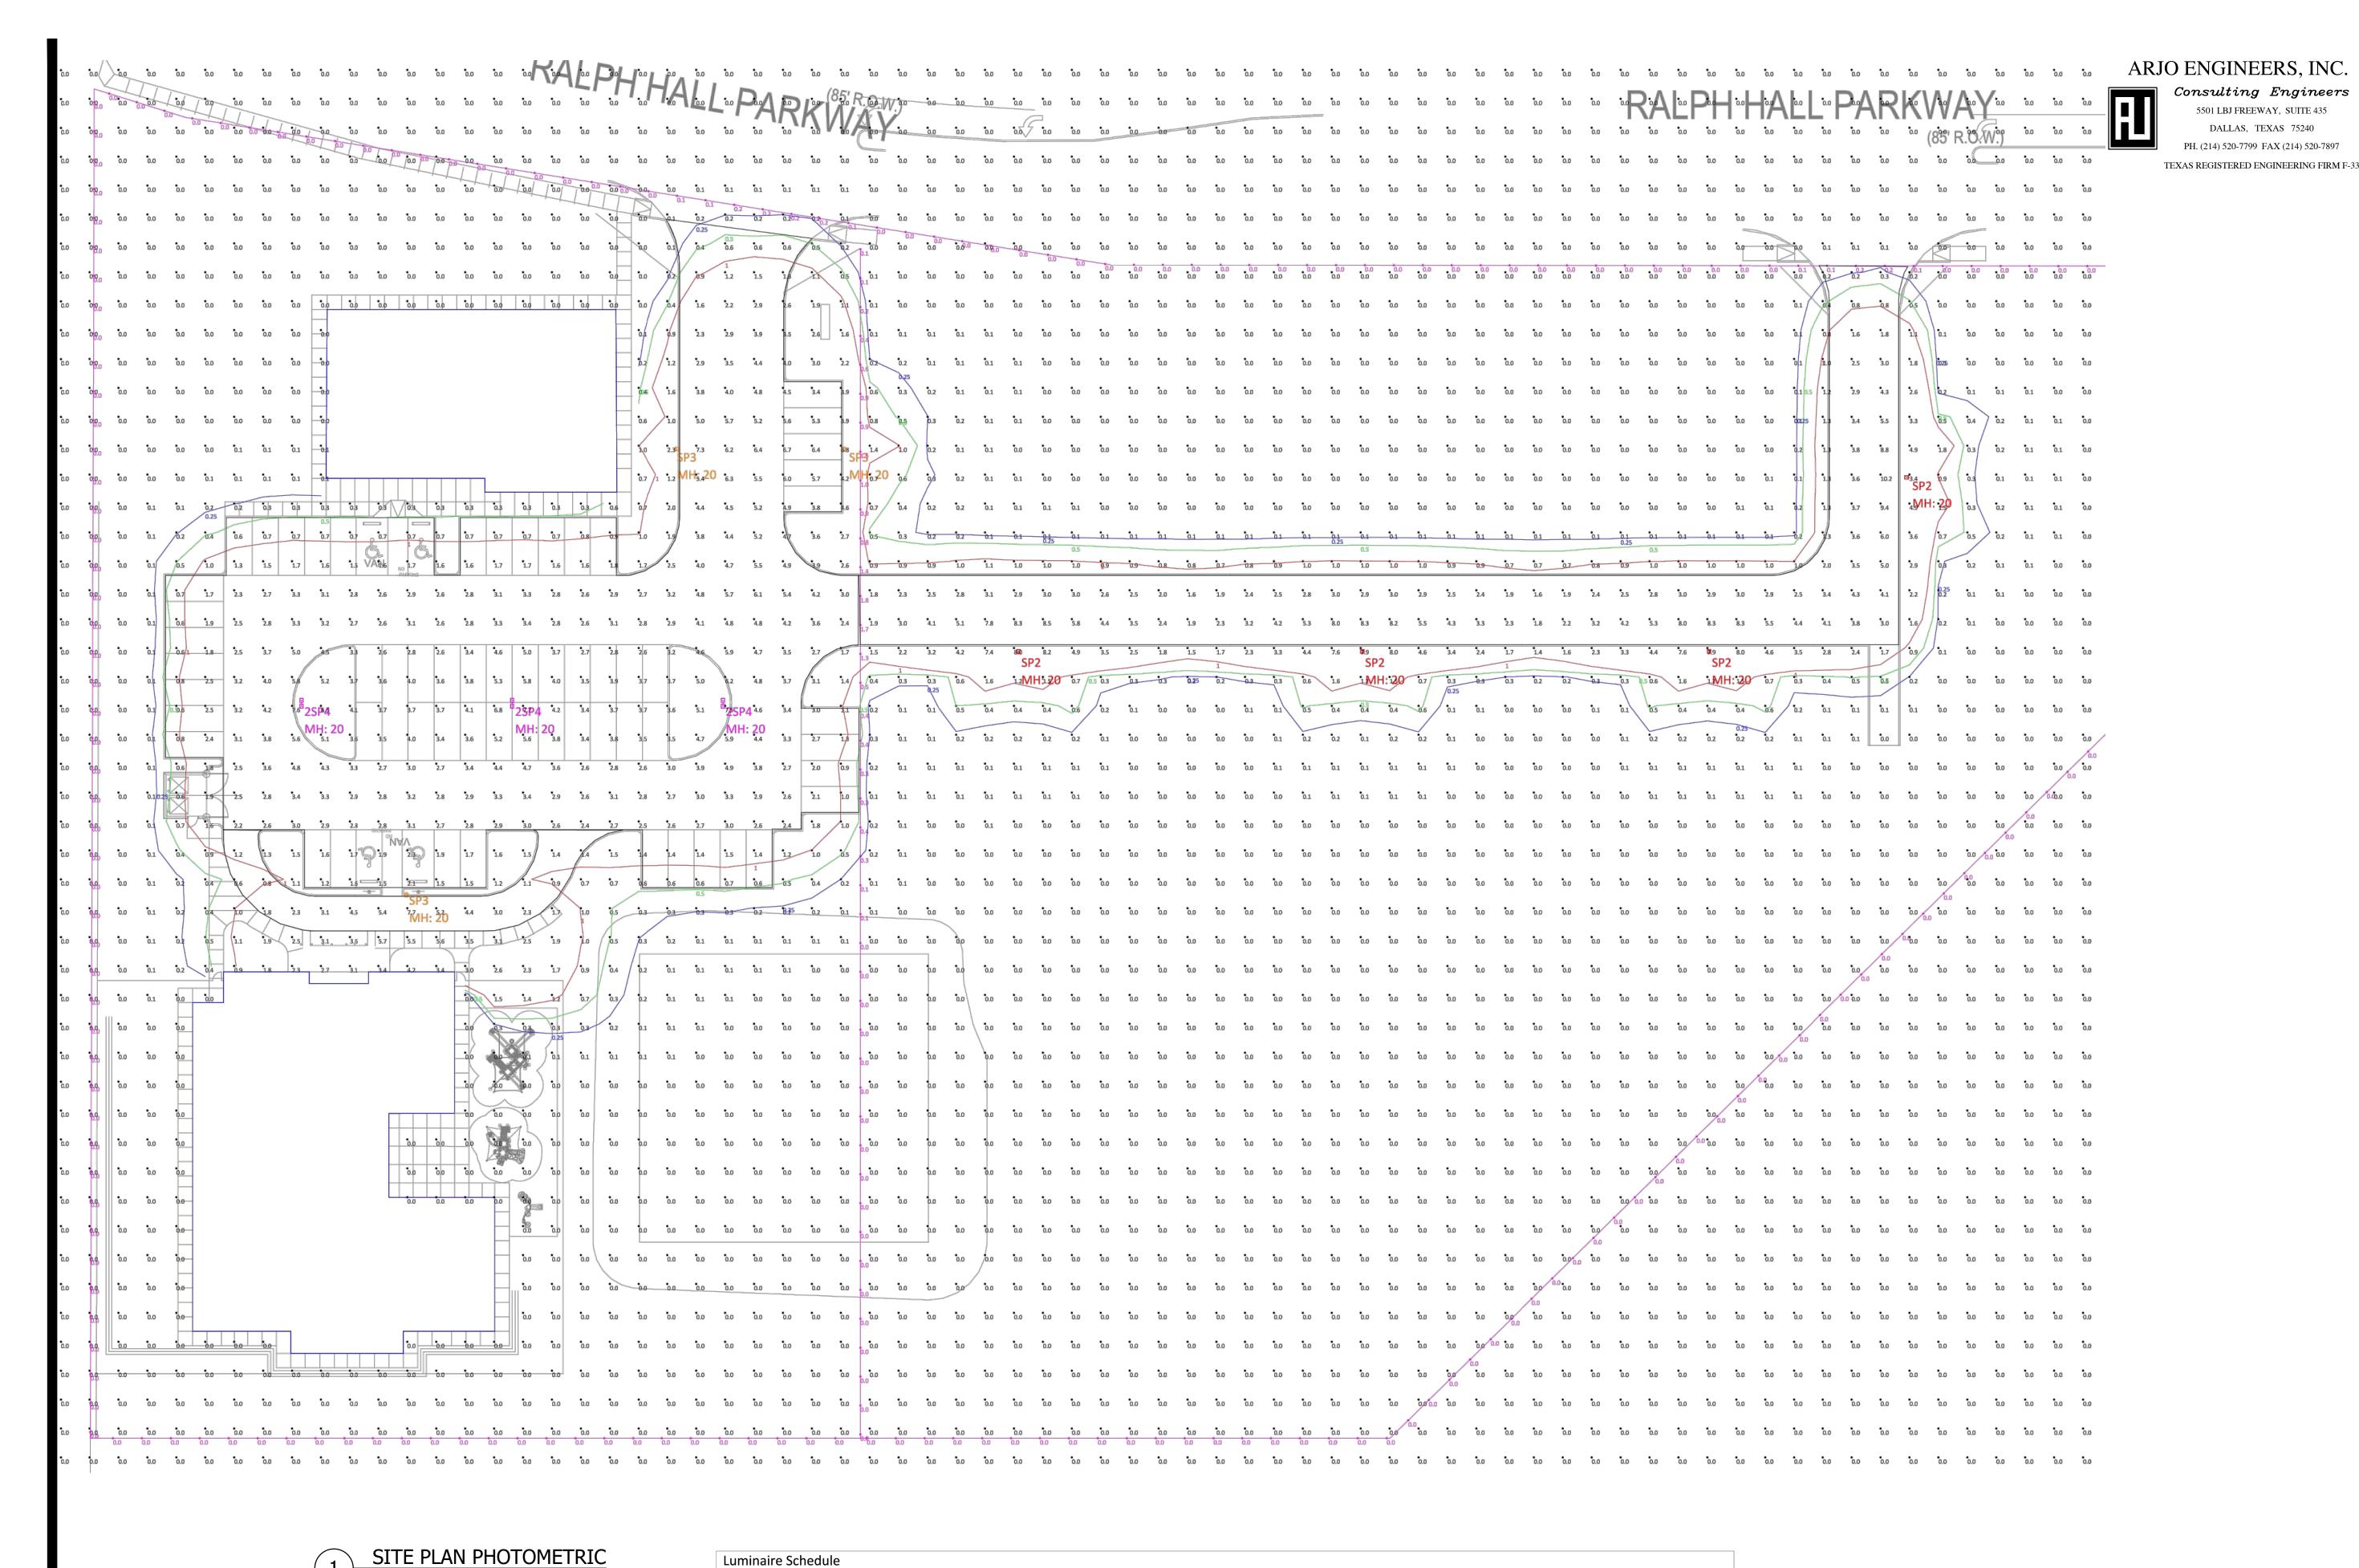

Arrangement | Manufacturer & Part Number

Units PtSpcLr

BACK-BACK BEACON VP-L-64L-135-4K7-4 | 2@180DEGREES

PtSpcTb Avg

2.77

3.67

3.22

10.2

7.7

0.1

BEACON VP-L-64L-135-4K7-2

BEACON VP-L-64L-135-4K7-3

Scale: NOT TO SCALE

Symbol

Label

Grade

Drop Off

East Drive

Property Line

Label

2SP4

SP2

SP3

Calculation Summary

Parking Lot & Drives

3

4

3

SINGLE

SINGLE

Illuminance Fc 10

Illuminance Fc

Illuminance Fc

Illuminance Fc

CalcType

LLF Lum. Lumens

0.900 14935

0.900 17761

0.900 17791

Readings taken at 0'-0" AFG

19.25 Readings taken at 0'-0" AFG

Avg/Min Max/Min Description

N.A.

102.00

4.62

8.05

- 1) Fixture Mounting Heights (MH) are indicated next to each fixture.
- 2) All fixtures labeled with "_alt" indicates an alternative fixture different from
- what was listed in the fixture schedule received was used in this calculation
- 3) All fixtures labeled with "_ph" indicates that another fixture's IES file was used as a placeholder due to unavailable IES files from the specified Manufacturer.
- 4) Interior reflectances 80/50/20; exterior reflectances 20% UON.
- Quantity (QTY) indicated on HLPS Luminaire Schedule is for what is included in this calculation study only - Not final counts.
- 6) Contractor to verify exact fixture quantities and fixture run lengths before ordering.

OMEG

4516 EMERSON AV. #B

DALLAS, TEXAS 75205 214 462 7330

OMEGA DESIGN LLC

DATE COMMENTS



© Copyright 2021, Omega Design LLC

Anyone coming into possession of this copyrighted material other than by agreement with Omega Design LLC is hereby warned that use of such without written consent of Omega

Design LLC is in violation of United States copyright law and user may be liable to Omega Design LLC for damages or

PINNACLE MONTESSORI OF ROCKWALL

Site Address: E. Ralph Hall and Plaza Drive, Rockwall, Texas

> PROJECT # SRC 032 (5916.08)

OWNER

Lakeside Kids, LLC

5909 Beth Drive Plano, Texas 75093

SHEET TITLE:

SITE PLAN -PHOTOMETRIC

SHEET NO.

E1.01

ISSUE DATE: MARCH 20, 2021