




LOCATION MAP

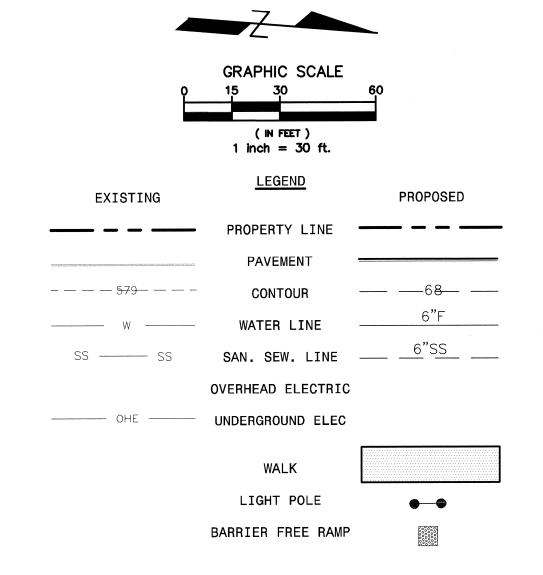

ENGINEER:

VASQUEZ ENGINEERING, L.L.C.

705 W. AVE B, SUITE 216

GARLAND, TEXAS 75040

PHONE: 972-272-4610

CONTACT: JUAN J. VASQUEZ, P.E.

OWNER/DEVELOPER:
CAVENDER INVESTMENT PROPERTIES E, LTD
2025 WSW LOOP 323
TYLER, TEXAS 75701
PHONE: 903-509-9509
CONTACT: JAMES R. THOMPSON, CFO

#### NOTES:

- 1. EXISTING BOUNDARY BASED ON SURVEY PREPARED BY
  - H.D. FETTY LANDS SURVEYOR, LLC.
- REF LANDSCAPE PLAN FOR SITE LANDSCAPING.
   REF LIGHTING PLAN FOR SITE LIGHTING.


SITE SUMMARY TABLE	
County	ROCKWALL
Project Name	CAVENDER'S - BOOT CITY
Zoning District	LI "LIGHT INDUSTRIAL" W/I-30 OVERLAY
Proposed use	RETAIL STORE
Site Area:	3.27 Acres 142,530 S.F.
Building Area	21,341 S.F. (TOTAL)
Building Height:	28' - 1 STORY
Lot Coverage:	21,341/142,530 = 15.0%
Floor Area Ratio:	21,341/142,530 = 1:15.0
Parking Required:	1 SPC / 250 SF = 86 SPACES
Parking Provided:	Regular = 107 SPACES
	Handicap = 5 SPACES
	Total = 112 SPACES
Impervious Area:	75,787 / 142,530 SF = 53.2%
Pervious Area:	66,743 / 142,530 SF = 46.8%


SITE PLAN
CAVENDER'S BOOT CITY
LOT 1, BLOCK 1

CAVENDER'S BOOT CITY ADDITION

3.27 ACRES

ROCKWALL, ROCKWALL COUNTY, TEXAS SEPTEMBER 2, 2014 CASE #SP2014-22

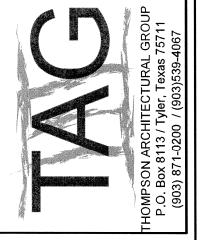

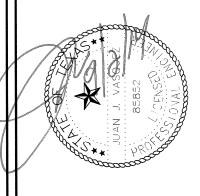

UEZ ENGINEERING L.L.C.
705 WEST AVENUE B
Suite 216
Garland, Texas 75040
Ph: 972-272-4610
TX Registration # F-12266



A New Facility for Cavender's Boot City



SITE PLAN

Revision/Revision Date


Project Number 560-11

Date 09/02/14


Drawn By J.J.V.

Checked By J.J.V

SP1

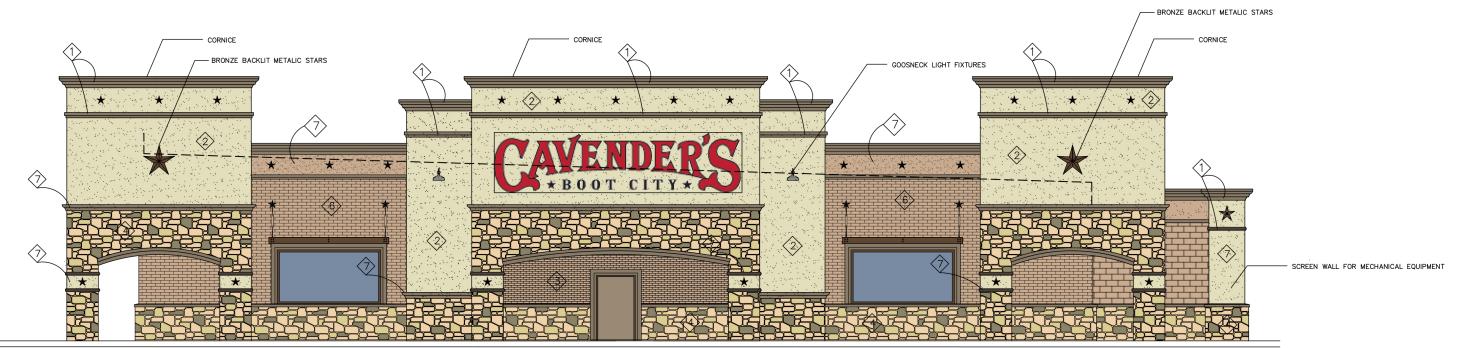

## 1 NORTH ELEVATION - STREET FACADE 3/32" = 1'-0"

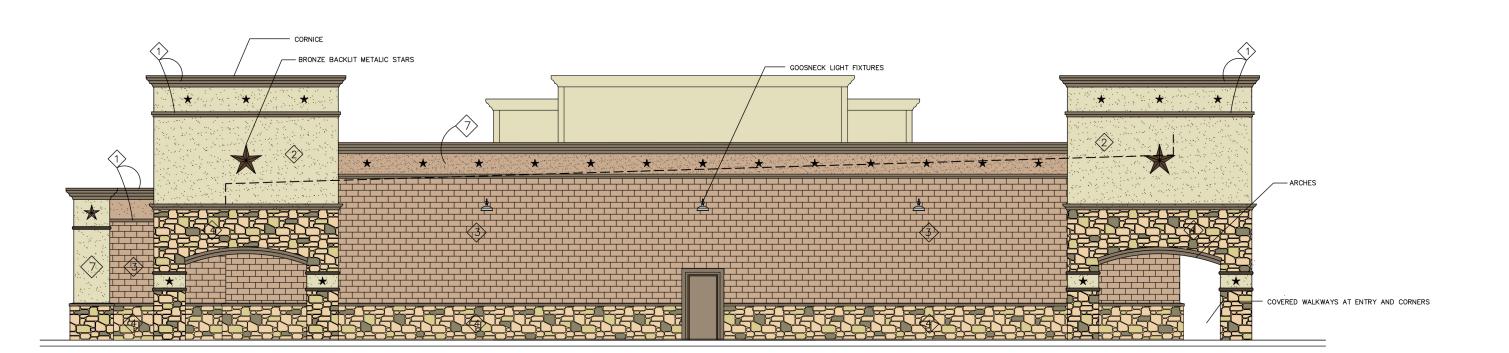

2 SOUTH ELEVATION 3/32" = 1'-0"

#### **GENERAL NOTES:**

- 1. ALL EIFS BANDS TO BE SHERWIN WILLIAMS 'KAFFEE' SW6104.
- 2. FOREGROUND WALLS TO BE TEIFS EQUAL TO STUCCO "TOAST" SAND PEBBLE FINE FINISH.
- 3. PAINT EXTERIOR SPLITFACE BLOCK USING THE FOLLOWING: PREPRITE BLOCK FILLER, B25W25, APPLY PER MANUFACTURER INSTRUCTIONS 2 COATS OF SHERLASTIC ELASTOMERIC/ACRYL, FLAT. FORMULA - BAC COLORANT 02 32 64 128 B1 BLACK
  - N1 RAW UMBER 10 47 1 -R2 MAROON - 26 - 1 Y3 DEEP GOLD 12 58 1 -5 GAL.-A05W00153, DEEP 640515375 APPLY PER MANUFACTURERS INSTRUCTIONS
- 4. REAL STONE AND VENEER STONE TO BE CAVENDER BLEND SAND STONE 4/6/8 FROM KIRBY STONE COMPANY
- 5. BACKGROUND WALLS TO BE STUCCO "BOSTON CREAM"
- SAND PEBBLE FINE FINISH. 6. AVERAGE WALL HEIGHT — 24'-6" WALL HEIGHT AT PARAPET — 21'-10"
- WALL HEIGHT AT ARTICULATION 29'-4"

7. EIFS ONLY ON TRIM, STARS, AND TOP OF MASORY PARAPET


### **KEY NOTES:**

- EIFS STAR AND BAND SHERWIN WILLIAMS 'KAFFEE' SW6104
- STUCCO WALL SHERWIN WILLIAMS 'TOAST' SW6114
- SPLITFACE WALL SEE NOTES
- STONE VENEER SEE NOTES
- 5 STUCCO WALL SHERWIN WILLIAMS 'TOAST' SW6114
- 6 BRICK FACADE
- DEIFS ON MASONRY MATCH BRICK COLOR <10%
- 8 HVAC UNIT BEHIND SCREEN WALL NO ROOF MOUNTED EQUIPMENT


### MATERIAL CALCULATIONS

STONE 23% MASONRY 48% STUCCO 22% EIFS/SECONDARY 7%


5 SECTION - SCREEN WALL
1/2" = 1'-0"

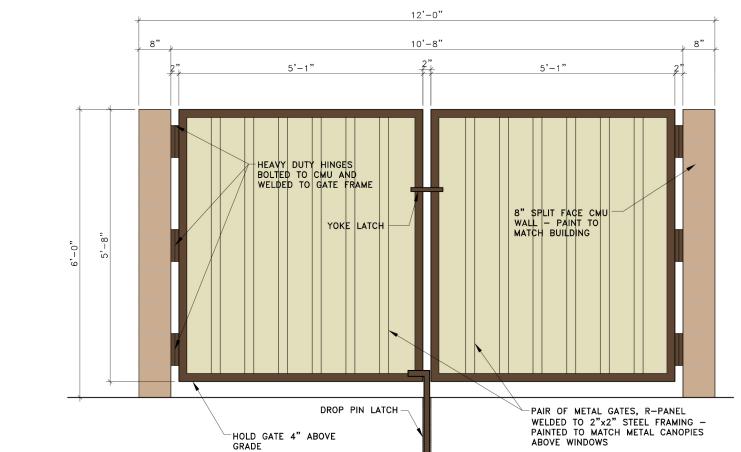


6 ELEVATION - DUMPSTER ENCLOSURE 1/2" = 1'-0"

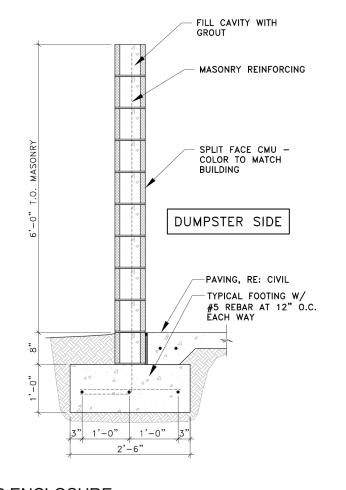

7 SECTION - DUMPSTER ENCLOSURE 1/2" = 1'-0"

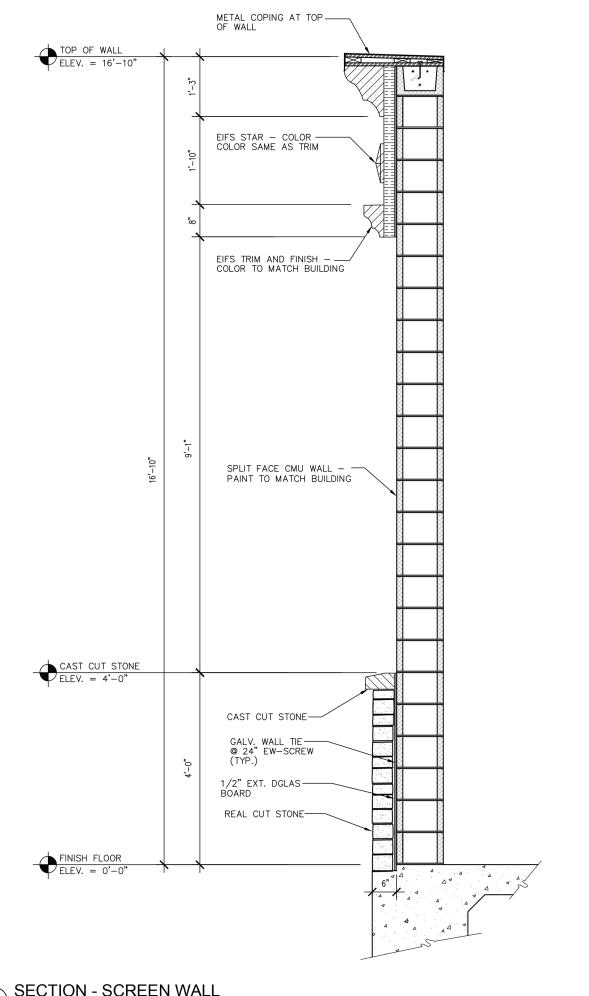

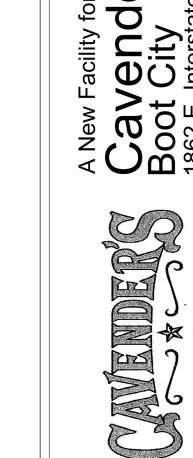

STATEMENT OF OWNERSHIP
THIS ELECTRONIC DRAWING FILE IS RELEASED
UNDER THE AUTHORITY OF TEXAS REGISTERED
ARCHITECT PERRY THOMPSON, III - #14401. THE
SEAL AFFIXED TO THIS DOCUMENT IS PLACED
PURSUANT TO SUB-CHAPTER F - RULE 1.103 OF
THE RULES AND REGULATIONS OF THE TEXAS
BOADD OF ARCHITECTHEAL EXAMINED.

THE RULES AND REGULATIONS OF THE TEXAS BOARD OF ARCHITECTURAL EXAMINERS.
THE USER OF THIS ELECTRONIC FILE AGREES TO ASSUME ALL RESPONSIBILITY FOR ANY MODIFICATION TO OR USE OF THIS DRAWING THAT IS NOT CONSISTENT WITH THE REQUIREMENTS OF THE RULES AND REGULATIONS OF THE TEXAS BOARD OF ARCHITECTURAL EXAMINERS. NO PERSON MAY MODIFY THIS DRAWING WITHOUT THE EXPRESS WRITTEN CONSENT OF THE ARCHITECT.

STATEMENT OF JURISDICTION
THE TEXAS BOARD OF ARCHITECTURAL
EXAMINERS, P.O. BOX 12337 AUSTIN, TEXAS
78711-2337 (512) 305-9000 HAS JURISDICTION
OVER COMPLAINTS REGARDING THE
PROFESSIONAL PRACTICES OF PERSONS
REGISTERED AS ARCHITECTS IN TEXAS.

STATEMENT OF COPYRIGHT ALL REPORTS, PLANS, SPECIFICATIONS,

ALL REPORTS, PLANS, SPECIFICATIONS,
COMPUTER FILES, FIELD DATA, NOTES, AND
OTHER DOCUMENTS PREPARED BY THE
ARCHITECT AS INSTRUMENTS OF SERVICE SHALL
REMAIN THE PROPERTY OF THE ARCHITECT. THE
ARCHITECT SHALL RETAIN ALL COMMON LAW,
STATUTORY AND OTHER RESERVED RIGHTS,
INCLUDING THE COPYRIGHT THERETO. THIS SET
OF CONSTRUCTION DOCUMENTS HAS REFN

OF CONSTRUCTION DOCUMENTS HAS BEEN LICENSED TO THE CLIENT FOR USAGE ONLY ON THIS SITE FOR THIS PROJECT, AND SHALL NOT BE UTILIZED FOR MULTIPLE PROJECTS AND/OR MULTIPLE SITES.

**ROCKWALL CITY** APPROVAL

Revision/Revision Date

13049 Project Number 08/12/14 DLW Drawn By


CASE NUMBER SP2014-022

Checked By

PT3




3/32" = 1'-0"

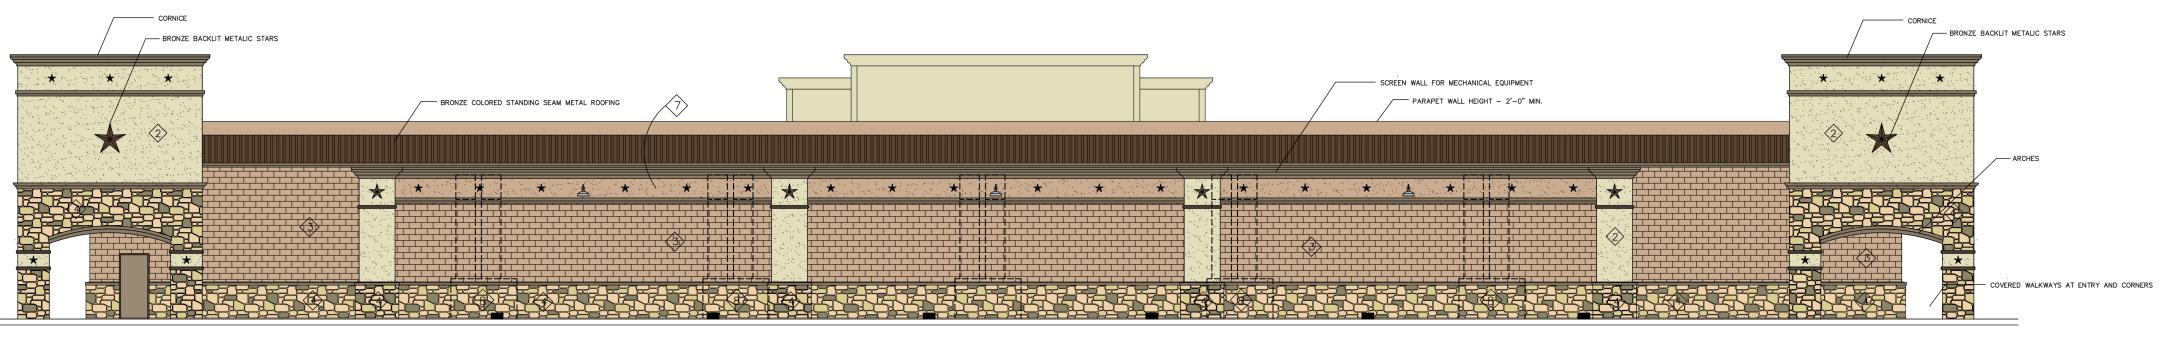

4 WEST ELEVATION 3/32" = 1'-0"

N 4°38'12''W ×325.4(

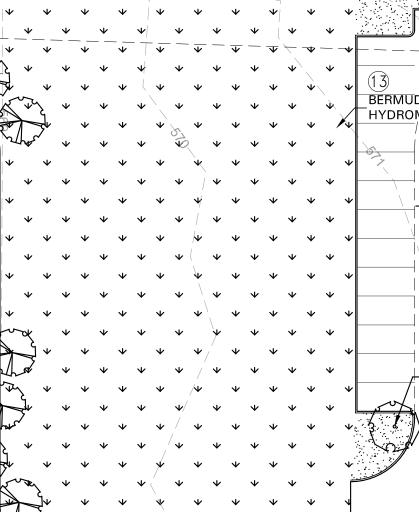

TAT B.O.C., TYP. S 4°38'35"E 698.98"

> H.A. & GWEN COWAN VOL. 209, PG. 367

#### GENERAL LAWN NOTES

F.D. HITT

D.R.R.C.T.

. 42, PG. 569

THE CONTRACTOR IS RESPONSIBLE FOR MAINTAINING TOP SOIL AT THE CORRECT GRADES. CONTRACTOR TO FINE GRADE AREAS TO REACH FINAL CONTOURS AS SPECIFIED PER CIVIL PLANS. ALL CONTOURS SHOULD ACHIEVE POSITIVE DRAINAGE AWAY FROM BUILDINGS AND STRUCTURES. WATER SHOULD NOT BE ABLE TO POOL IN ANY AREAS UNLESS SPECIFIED OTHERWISE. EROSION FABRIC SUCH AS JUTE MATTING OR OPEN WEAVE TO BE USED WHERE NECESSARY TO PREVENT SOIL EROSION.

ANY LOSS OF TOPSOIL OR GRASS DUE TO EROSION IS THE RESPONSIBILITY OF THE CONTRACTOR UNTIL IT IS 100% ESTABLISHED.

CONTRACTOR TO REMOVE ANY ROCKS 3/4" AND LARGER, STICKS AND DEBRIS PRIOR TO INSTALLATION OF TOPSOIL AND SOD.

FOUR (4") OF TOPSOIL SHALL BE APPLIED TO AREAS DISTURBED BY CONSTRUCTION RECEIVING SOD. IF TOPSOIL IS NOT AVAILABLE ON SITE, THE CONTRACTOR SHALL PROVIDE TOPSOIL AS APPROVED BY THE OWNER OR OWNERS REPRESENTATIVE.

TOPSOIL SHALL BE FRIABLE, NATURAL LOAM, FREE OF ROCKS, WEEDS, BRUSH, CLAY

LUMPS, ROOTS, TWIGS, LITTER AND ENVIRONMENTAL CONTAMINANTS. CONTRACTOR SHALL BE RESPONSIBLE FOR SOD UNTIL ACCEPTANCE. THIS SHALL INCLUDE, BUT NOT BE LIMITED TO: MOWING, WATERING, WEEDING, CULTIVATING, CLEANING AND REPLACING DEAD OR BARE AREAS TO KEEP PLANTS IN A VIGOROUS,

HEALTHY CONDITION. SOD SHALL BE REPLACED IF NECESSARY.

WATERED THOROUGHLY DURING INSTALLATION PROCESS.

SOLID SOD:
SOLID SOD SHALL BE PLACED ALONG ALL IMPERVIOUS EDGES, AT A MINIMUM. THIS SHALL INCLUDE CURBS, WALKS, INLETS, MANHOLES AND PLANTING BED AREAS. SOD SHALL COVER OTHER AREAS COMPLETELY AS INDICATED BY PLAN.

SOD SHALL BE STRONGLY ROOTED DROUGHT RESISTANT SOD, NOT LESS THAN 2 YEARS OLD. FREE OF WEEDS AND UNDESIRABLE NATIVE GRASS AND MACHINE CUT TO PAD THICKNESS OF 3/4" (+1/4"), EXCLUDING TOP GROWTH AND THATCH. PROVIDE ONLY SOD CAPABLE OF VIGOROUS GROWTH AND DEVELOPMENT WHEN PLANTED.

DO NOT INSTALL SOD IF IT IS DORMANT OR GROUND IS FROZEN. LAY SOD WITH TIGHTLY FITTING JOINTS, NO OVERLAPS WITH STAGGERED STRIPS TO OFFSET JOINTS.

SOD SHALL BE ROLLED TO CREATE A SMOOTH EVEN SURFACE. SOD SHOULD BE

SHOULD INSTALLATION OCCUR BETWEEN OCTOBER 1ST AND MARCH 1ST, SOD SHALL INCLUDE AN OVER-SEED OF ANNUAL RYE OR WINTER RYEGRASS AT A RATE OF FOUR POUNDS PER ONE THOUSAND SQUARE FEET FOR A GROWN-IN APPEARANCE

CONTRACTOR SHALL ENSURE CONFORMANCE TO §115.D OF TITLE 7, PART XXIX,

#### HORTICULTURE COMMISSION CHAPTER 1. HYDROMULCH:

SCARIFY SURFACE TO A MINIMUM OF 2" DEPTH PRIOR TO THE IMPORT TOPSOIL APPLICATION. TOP SOIL SHALL BE PLACED 2" IN DEPTH IN ALL AREAS TO BE SEEDED. CONTRACTOR TO SUPPLY HIGH QUALITY IMPORTED TOPSOIL HIGH IN HUMAS AND ORGANIC CONTENT FROM A LOCAL SUPPLY, IMPORTED TOPSOIL SHALL BE REASONABLY FREE OF CLAY LUMPS, COARSE SANDS, STONES, ROOTS AND OTHER

IF INADEQUATE MOISTURE IS PRESENT IN SOIL, APPLY WATER AS NECESSARY FOR OPTIMUM MOISTURE FOR SEED APPLICATION.

ALL SEED SHALL BE HIGH QUALITY, TREATED LAWN TYPE SEED AND IS FREE OF NOXIOUS GRASS SEEDS. THE SEED APPLICATION SHALL BE UNIFORMLY DISTRIBUTED ON THE AREAS INDICATED ON PLANS. HYDROMULCH WITH BERMUDA GRASS SEED AT A RATE OF TWO POUNDS PER ONE THOUSAND SQUARE FEET.

IF INSTALLATION OCCURS BETWEEN OCTOBER 1ST AND APRIL 1ST, ALL HYDORMULCH AREAS SHALL BE OVER-SEEDED WITH ANNUAL RYE GRASS AT A RATE OF FOUR POUNDS PER ONE THOUSAND SQUARE FEET. CONTRACTOR TO RE-HYDROMULCH WITH BERMUDA GRASS AT THE END OF THE ANNUAL RYE GROWING SEASON.

AFTER APPLICATION, NO EQUIPMENT SHALL OPERATE OVER APPLIED AREAS. WATER SEEDED AREAS IMMEDIATELY AFTER INSTALLATION TO SATURATION.

ALL LAWN AREAS TO BE HYDROMULCHED SHALL ACHIEVE 100% COVERAGE PRIOR TO

### LANDSCAPE NOTES

REFERENCE SITEWORK AND SPECIFICATIONS FOR INFORMATION NEEDED FOR LANDSCAPE WORK.

CONTRACTOR TO VERIFY AND LOCATE ALL PROPOSED AND EXISTING STRUCTURES. NOTIFY LANDSCAPE ARCHITECT OR DESIGNATED REPRESENTATIVE FOR ANY LAYOUT DISCREPANCIES OR ANY CONDITION THAT WOULD PROHIBIT THE INSTALLATION AS

CONTRACTOR SHALL CALL 811 TO VERIFY AND LOCATE AY AND ALL UTILITIES ON SITE PRIOR TO COMMENCING WORK. LANDSCAPE ARCHITECT SHOULD BE NOTIFIED OF ANY

A MINIMUM OF 2% SLOPE SHALL BE PROVIDED AWAY FROM ALL STRUCTURES.

LANDSCAPE ISLANDS SHALL BE CROWNED, AND UNIFORM THROUGHOUT THE SITE. ALL PLANTING AREAS SHALL BE GRADED SMOOTH TO ACHIEVE FINAL CONTOURS AS INDICATED ON PLAN WITH 3" OF TOPSOIL AND 3" OF COMPOST AND CONSISTENTLY BLENDED TO A DEPTH OF 9". ALL BEDS SHALL BE CROWNED TO ANTICIPATE SETTLEMENT

AND ENSURE PROPER DRAINAGE. PLANTING AREAS AND SOD TO BE SEPARATED BY STEEL EDGING. EDGING TO BE GREEN IN COLOR AND A MINIMUM OF 3/16" THICK. EDGING SHALL BE STAKED FROM THE INSIDE OF BED. EDGING NOT TO BE MORE THAN 1/2" ABOVE FINISHED GRADE.

MULCH SHALL BE INSTALLED AT 1/2" BELOW THE TOPS OF SIDEWALKS AND CURBING.

QUANTITIES ON THESE PLANS ARE FOR REFERENCE ONLY. THE SPACING OF PLANTS SHOULD BE AS INDICATED ON PLANS OR OTHERWISE NOTED. ALL TREES AND SHRUBS SHALL BE PLANTED PER DETAILS.

CONTAINER GROWN PLANT MATERIAL IS PREFERRED HOWEVER BALL AND BURLAP PLANT MATERIAL CAN BE SUBSTITUTED IF NEED BE AND IS APPROPRIATE TO THE SIZE AND QUALITY INDICATED ON THE PLANT MATERIAL LIST.

TREES SHALL BE PLANTED AT A MINIMUM OF 5' FROM ANY UTILITY LINE, SIDEWALK OR CURB. TREES SHALL ALSO BE 10' CLEAR FROM FIRE HYDRANTS.

4" OF SHREDDED HARDWOOD MULCH (2" SETTLED THICKNESS) SHALL BE PLACED OVER 4.1 OZ WOVEN, WEED BARRIER FABRIC OR APPROVED EQUAL. WEED BARRIER FABRIC SHALL BE USED IN PLANT BEDS AND AROUND ALL TREES AND SHALL BE DE WITT 'WEED BARRIER' OR APPROVED EQUAL. MULCH SHALL BE SHREDDED BARK OR RUBBER LANDSCAPE MULCH, PINE STRAW MULCH IS PROHIBITED.

CONTRACTOR TO PROVIDE UNIT PRICING OF LANDSCAPE MATERIALS AND BE RESPONSIBLE FOR OBTAINING ALL LANDSCAPE AND IRRIGATION PERMITS.

### IRRIGATION: IRRIGATION SYSTEM WILL COMPLY WITH ROCKWALL UDC REQUIREMENTS.

ALL PLANTING BEDS SHALL HAVE AN AUTOMATIC IRRIGATION SYSTEM WITH A FREEZE/RAIN SENSOR. SYSTEM SHALL ALSO HAVE AN ET WEATHER BASED CONTROLLER AND BE DESIGNED AND INSTALLED BY A LICENSED IRRIGATOR.

#### VEGETATION SHOULD BE INSPECTED REGULARLY TO ENSURE THAT PLANT MATERIAL IS ESTABLISHING PROPERLY AND REMAINS IN A HEALTHY GROWING CONDITION APPROPRIATE FOR THE SEASON. IF DAMAGED OR REMOVED, PLANTS MUST BE

MOWING, TRIMMING, EDGING AND SUPERVISION OF WATER APPLICATIONS SHALL BE THE RESPONSIBILITY OF THE CONTRACTOR UNTIL THE OWNER OR OWNER'S REPRESENTATIVE ACCEPTS AND ASSUMES REGULAR MAINTENANCE.

ALL LANDSCAPE AREAS SHOULD BE CLEANED AND KEPT FREE OF TRASH, DEBRIS, WEEDS AND OTHER MATERIAL.

REPLACED BY A SIMILAR VARIETY AND SIZE.

STEEL EDGING SHALL BE 3/16" X 4 X 16' DARK GREEN DURAEDGE STEEL LANDSCAPE

# Buffer strips shall be a minimum of 20' wide and include a berm of

frontage along the IH-30 r.o.w. The minimum required height is 30" and shall not exceed a maximum height of 48". 2. Three canopy trees along with four accent trees are required per 100 feet of the IH-30 r.o.w.

Frontage = 205 l.f.

REQUIRED	PROVIDED	
20' wide buffer	20' wide buffer	
berm and/or shrubs	shrubs 36" ht.	
6 canopy trees, 4" cal.	6 canopy trees, 4" cal.	
8 accent trees, 4' ht.	8 accent trees, 4' ht.	
	SITE LANDSCAPE	

1. PER CHECKLIST: One tree shall be provided for every 750 s.f. of detention area PROVIDED 14,253 s.f. of landscape (10%) 66,743 s.f of landscape (46.8%) 6 canopy street trees, 4" cal (per l-30 4 canopy street trees, 4" cal.

21 trees, 3" cal. PARKING LOT LANDSCAPE

1. Surface parking shall be screened from all adjacent public streets and neighboring sites. The screen must extend along all edges and be a min. 3' in height, 80% opaque.

2. There shall be a landscape island every 10 parking spaces. One shade tree shall be provided for every 10 cars.

Parking Spaces: 113

Parking Area: 46,815 s.f.

REQUIRED	PROVIDED
	5,350 s.f. of landscape in parking area
6" screen	36" screen
1 canopy trees, 4" cal.	14 canopy trees, 4" cal.

County	ROCKWALL
Project Name	CAVENDER'S - BOOT CITY
Zoning District	LI "LIGHT INDUSTRIAL" W/I-30 OVERLAY
Proposed use	RETAIL STORE
Site Area:	3.27 Acres 142,530 S.F.
Building Area	21,341 S.F. (TOTAL)
Building Height:	28' - 1 STORY
Lot Coverage:	21,341/142,530 = 15.0%
Floor Area Ratio:	21,341/142,530 = 1:15.0
Parking Required:	1 SPC / 250 SF = 86 SPACES
Parking Provided:	Regular = 108 SPACES
	Handicap = 5 SPACES
	Total = 113 SPACES
Impervious Area:	75,787 / 142,530 SF = 53.2
Pervious Area:	66,743 / 142,530 SF = 46.8


QTY LABEL COMMON NAME **SCIENTIFIC NAME** SIZE NOTES Bald Cypress Taxodium distichum 3" cal. 12' ht., 4' spread, matching 4" cal. 12' ht., 5' spread, matching 13 CE Cedar Elm Cercis reniformis 'Oklahoma' 30 gal. 8' ht., 4' spread, 3 trunk min. Oklahoma Redbud 6 SO 4" cal. 12' ht., 5' spread Shumard Oak Quercus shumardii SHRUBS/GROUNDCOVER Edward Goucher Abelia Abelia x grandiflora 'Edward Goucher'

full, 20" spread, 24" ht, 30" o.c. Berberis thunbergii 'Autopurpurea' full, 20" spread, 24" ht, 24" o.c. Crimson Pygmy Barberry 5 gal. 4 CA Yuletide Camellia Camellia sasangua 'Yuletide' full to base, 30" spread, 36" ht 190 COT Cotoneaster horizontalis full, 12" spread, 12" ht, 18" o.c. Cotoneaster 126 DBH Dwarf Burford Holly full, 20" spread, 36" ht, 36" o.c. Ilex comuta ' Burford Nana' 36" ht. 145 DFG Dwarf Fountain Grass Pennisetum alopecuroides 'Little Bunny' full, 8" spread, 12" ht, 18" o.c. 31 GM Gulf Muhly full, 20" spread, 24" ht, 30" o.c. Muhlenbergia capillaris 14 KO Knock Out Rose Rosa x 'Radsunny' 5 gal. full, 20" spread, 36" o.c. 58 LOR Loropetalum 'Shang-lo' Loropetalum chinense 'Shang-lo' full, 18" spread, 20" ht, 24" o.c. Nellie R Stevens Holly Illex x 'Nellie R. Stevens' full to base, 30" spread, 36" ht, 40" o.c. 21 TS Texas Sage 'Green Cloud' Leucophyllum frutescens 'Green Cloud' 36" ht. full, 24" spread, 36" ht, 36" o.c. 33 TST full, 24" sprd, 30" o.c. Texas Sage 'Thundercloud' Leucophyllum frutescens 'Thundercloud' 5 gal. 18 RY Red Yucca Hesperaloe parvifolia full, 24" spread, 30" ht, 30" o.c.

Plant list is an aid to bidders only. Contractor shall verify all quantities on plan. All heights and spreads are minimums. Trees shall have a strong central leader and be of matching specimens. All plant material shall meet or exceed remarks as indicated.

Cynodon dactylon

Cynodon dactylon

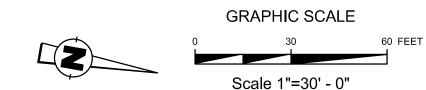

VASQUEZ ENGINEERING, L.L.C. 705 W. AVE B, SUITE 216 GARLAND, TEXAS 75040 PHONE: 972-272-4610 CONTACT: JUAN J. VASQUEZ, P.E.


Bermuda Solid Sod

Bermuda Hydromulch

OWNER/DEVELOPER: CAVENDER'S 2025 WSW LOOP 323 TYLER, TEXAS 75701 PHONE: 903-509-9509 CONTACT: JAMES R. THOMPSON, CFO

LANDSCAPE PLAN CAVENDER'S BOOT CITY LOT 1, BLOCK 1 CAVENDER'S BOOT CITY ADDITION 3.27 ACRES ROCKWALL, ROCKWALL COUNTY, TEXAS AUGUST 15, 2014 CASE # SP2014-022



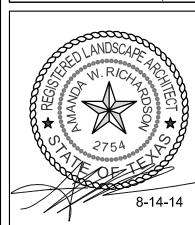








LANDSCAPE PLAN


Revision/Revision Date


Project Number 560-11

08/15/14 Drawn By AWR Checked By AWR

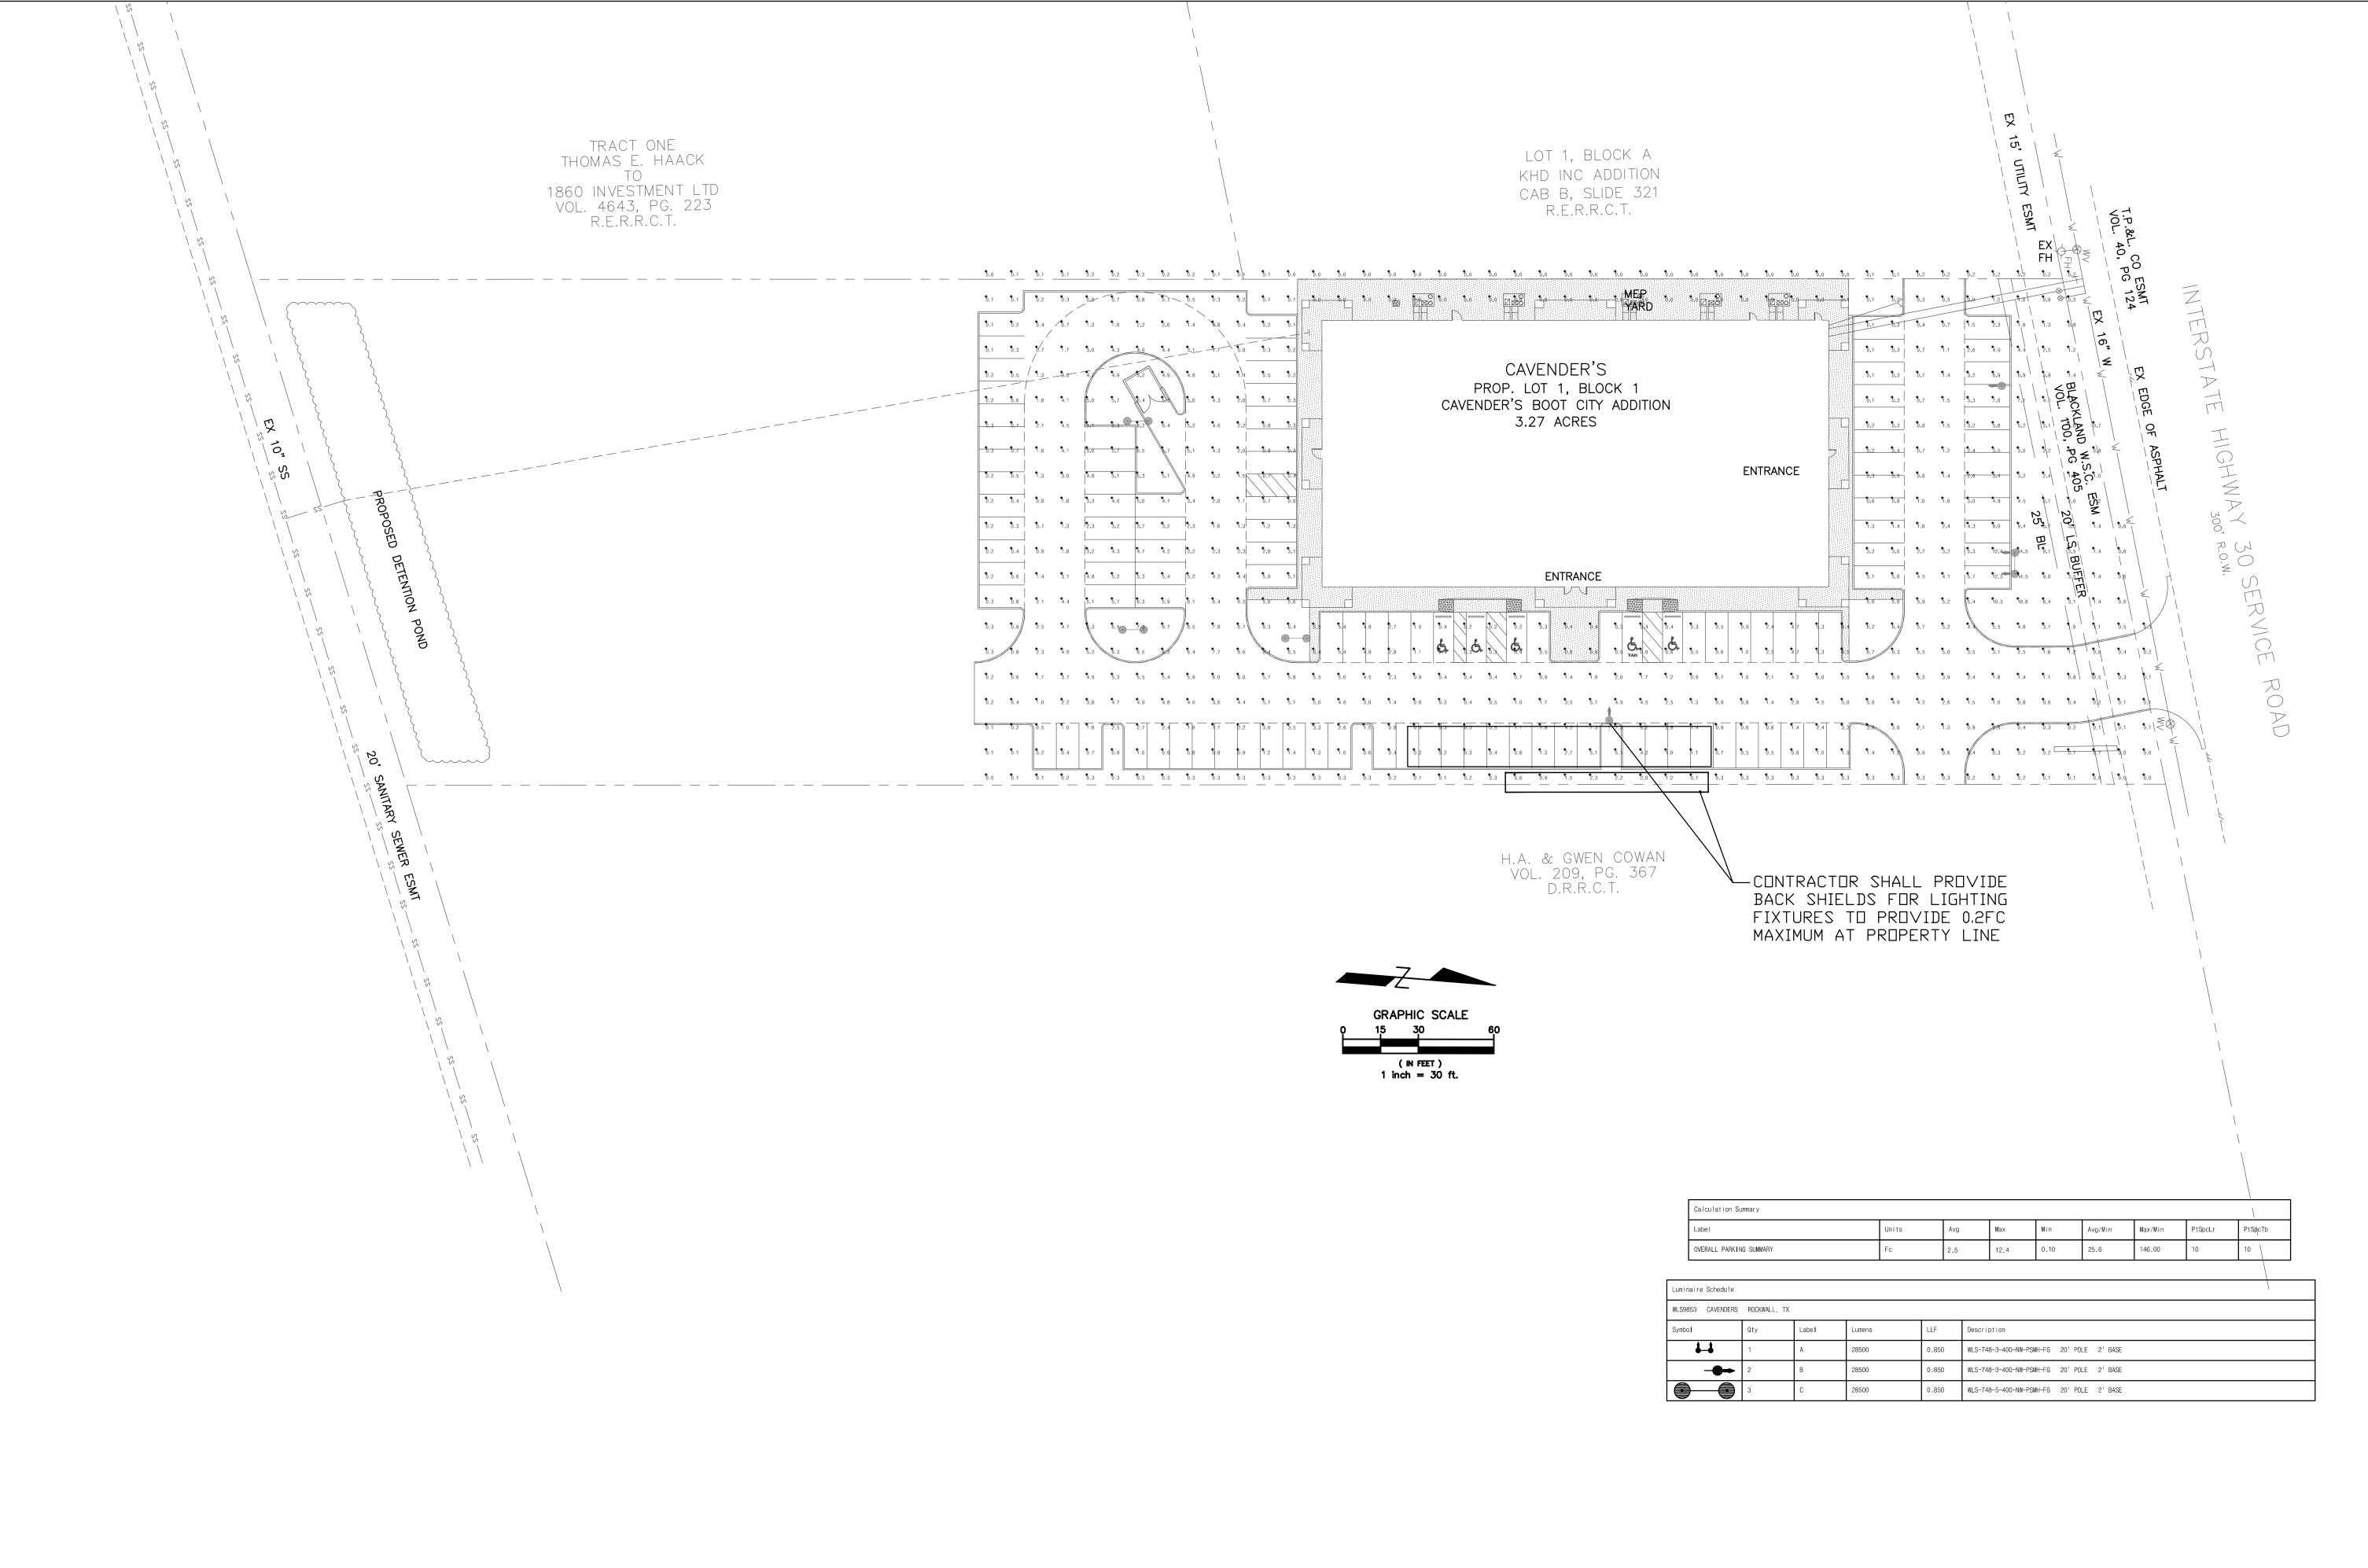



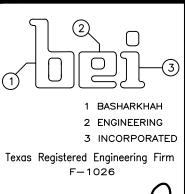

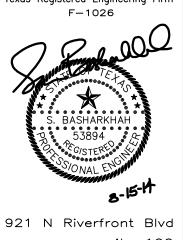

dallas texas 75207 (214) 228—2298

REVIEW
BIDDING

A New Facility for **Cavender's Boot City**1862 E. Interstate Hwy 30
Rockwall, Texas



Revision/Revision Date

 Project Number
 13049

 Date
 08/15/14

 Drawn By
 RS

 Checked By
 SB

MEP1.5