

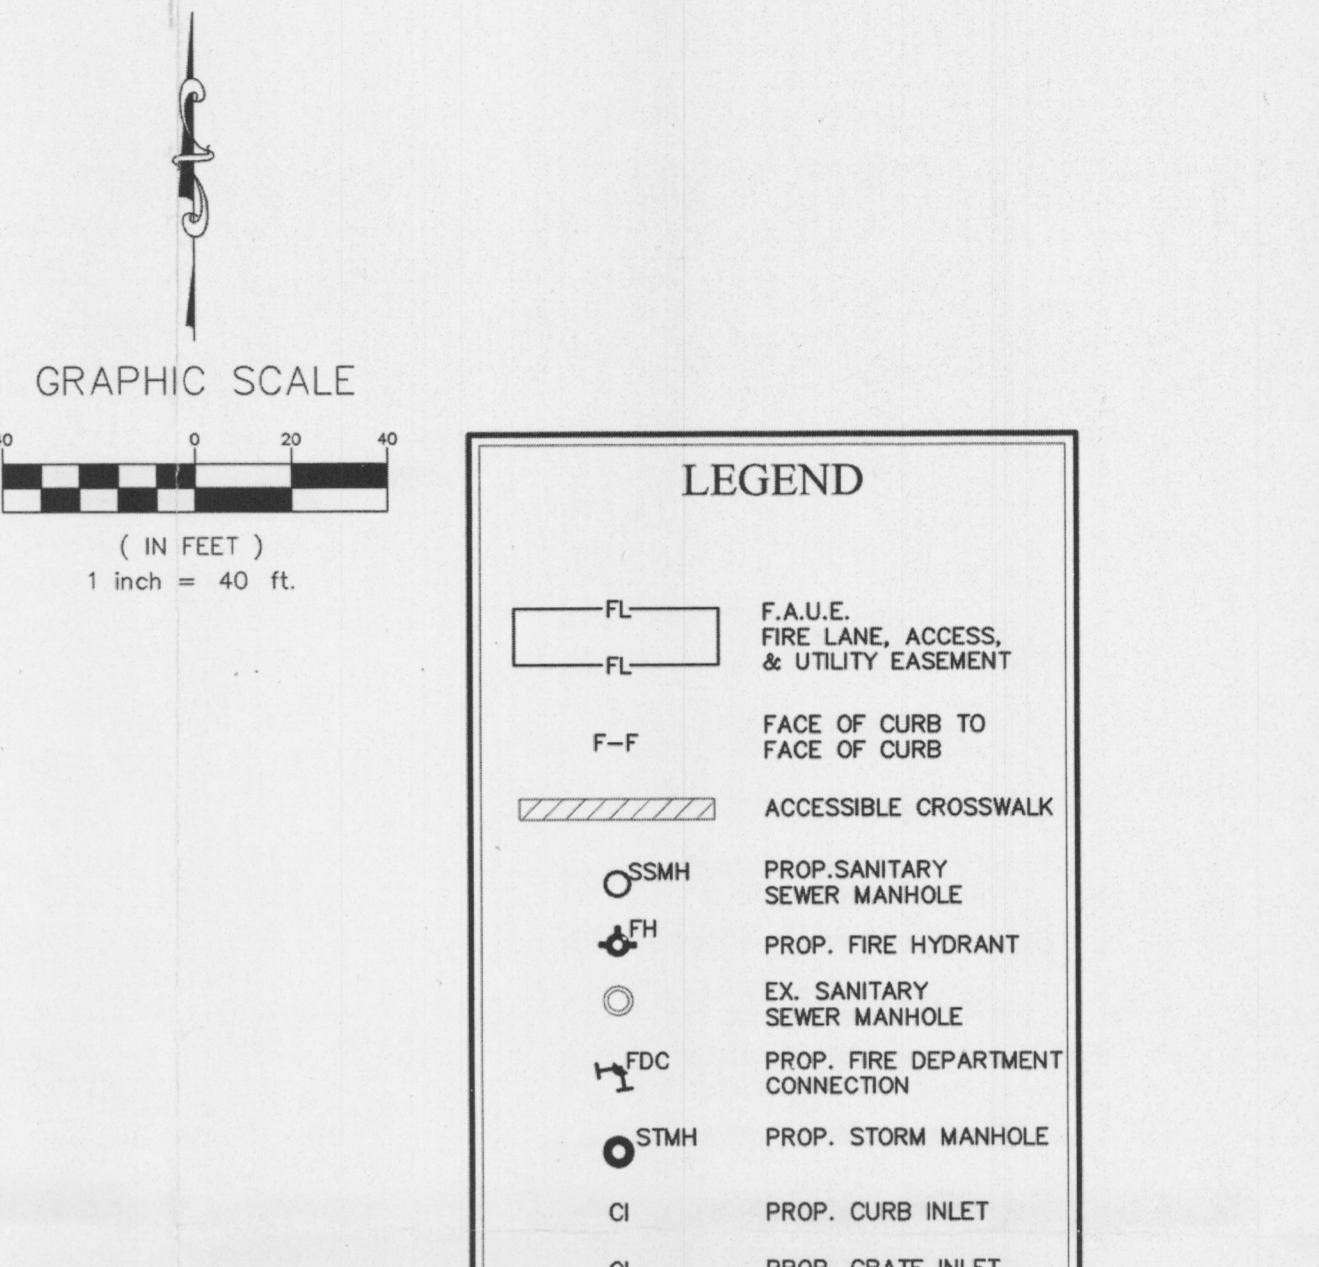
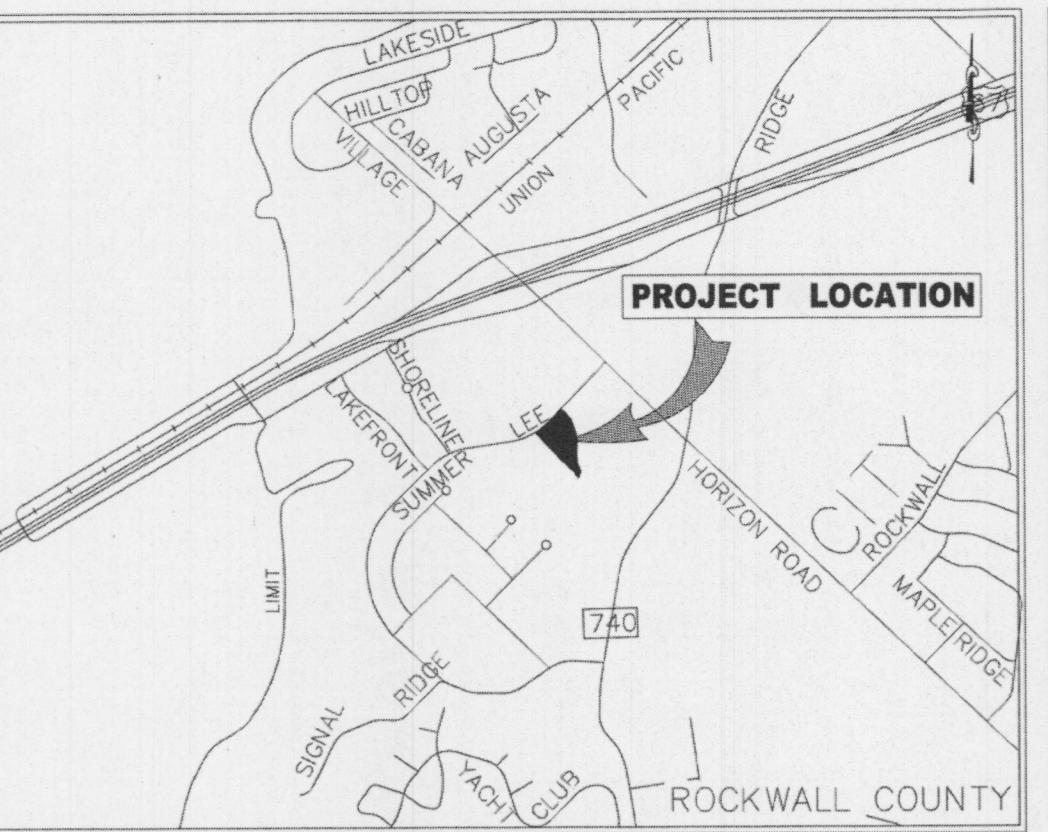


Engineer of Record:	BCA	
Drawn by:	TCS	
Date Plotted:	12/2/2016	
Issue for Pricing / Bidding:		
Issue for Permit Application:		
Issue for Construction:		
REVISIONS		
#	DATE	COMMENTS

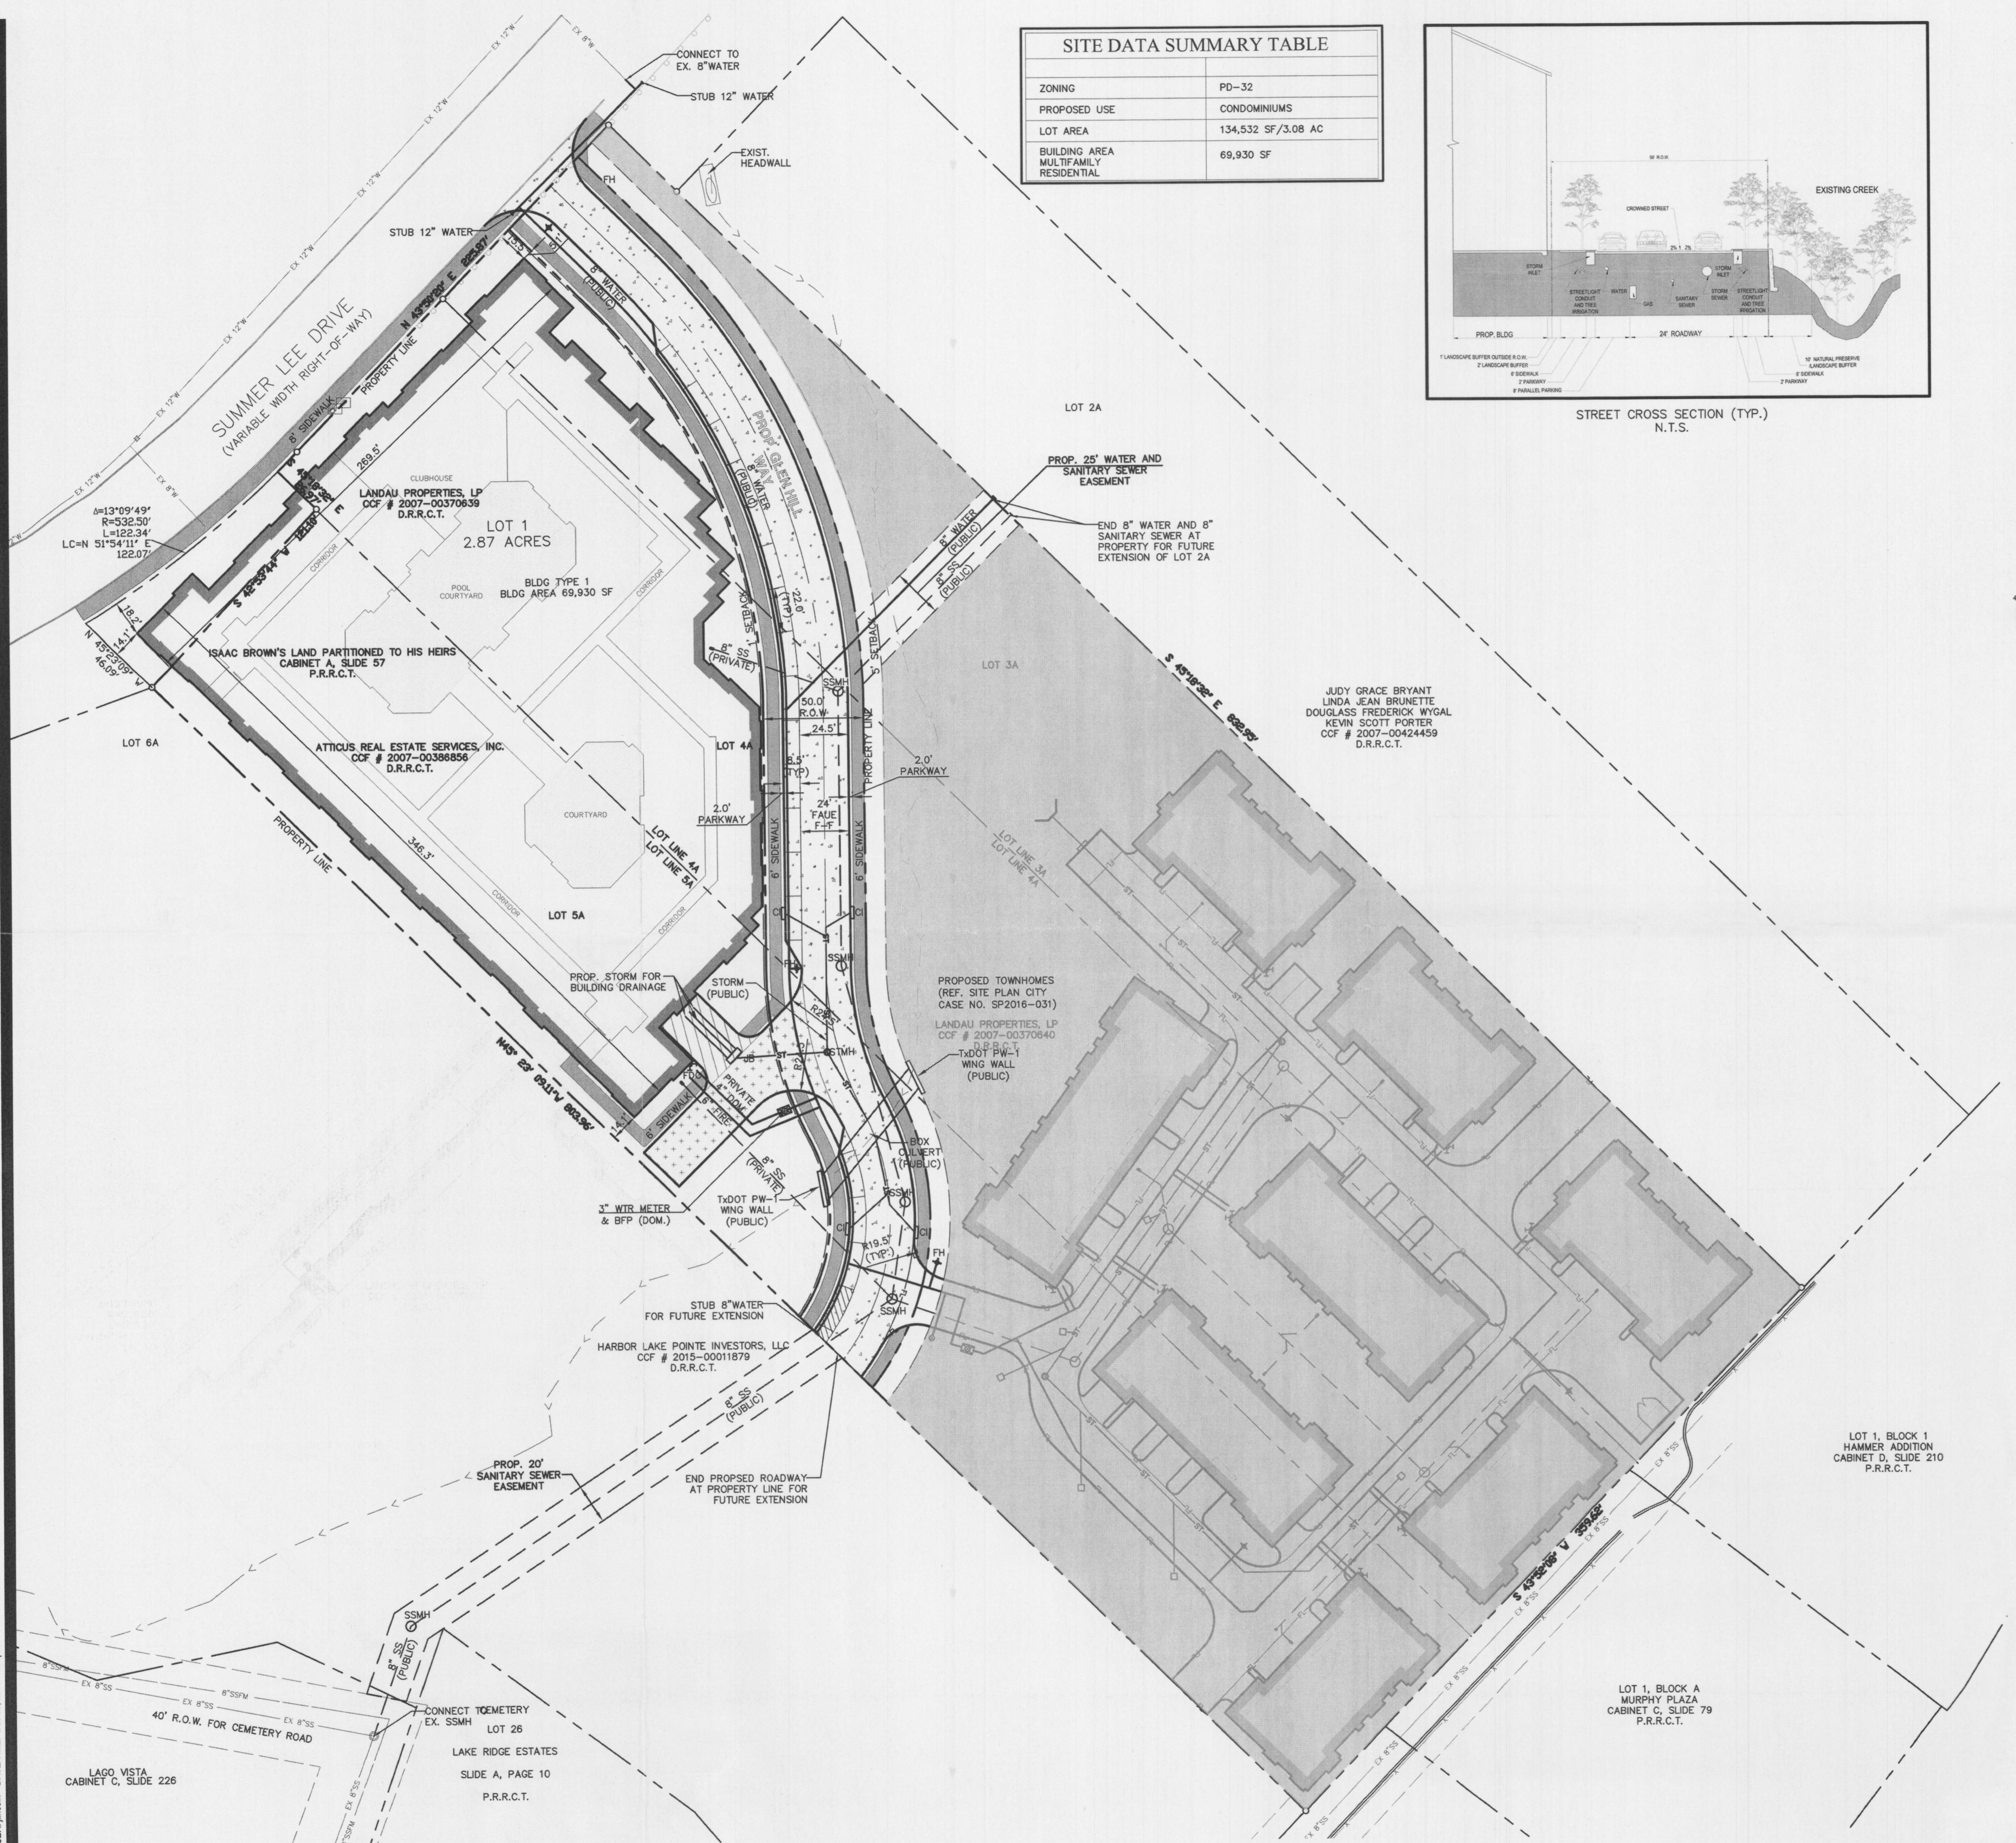

NOTES

- ALL DIMENSIONS ARE TO BACK OF CURB UNLESS OTHERWISE NOTED.
- REFERENCE SHEET SP 2 OF 2 FOR GARAGE PARKING LAYOUT AND CALCULATIONS

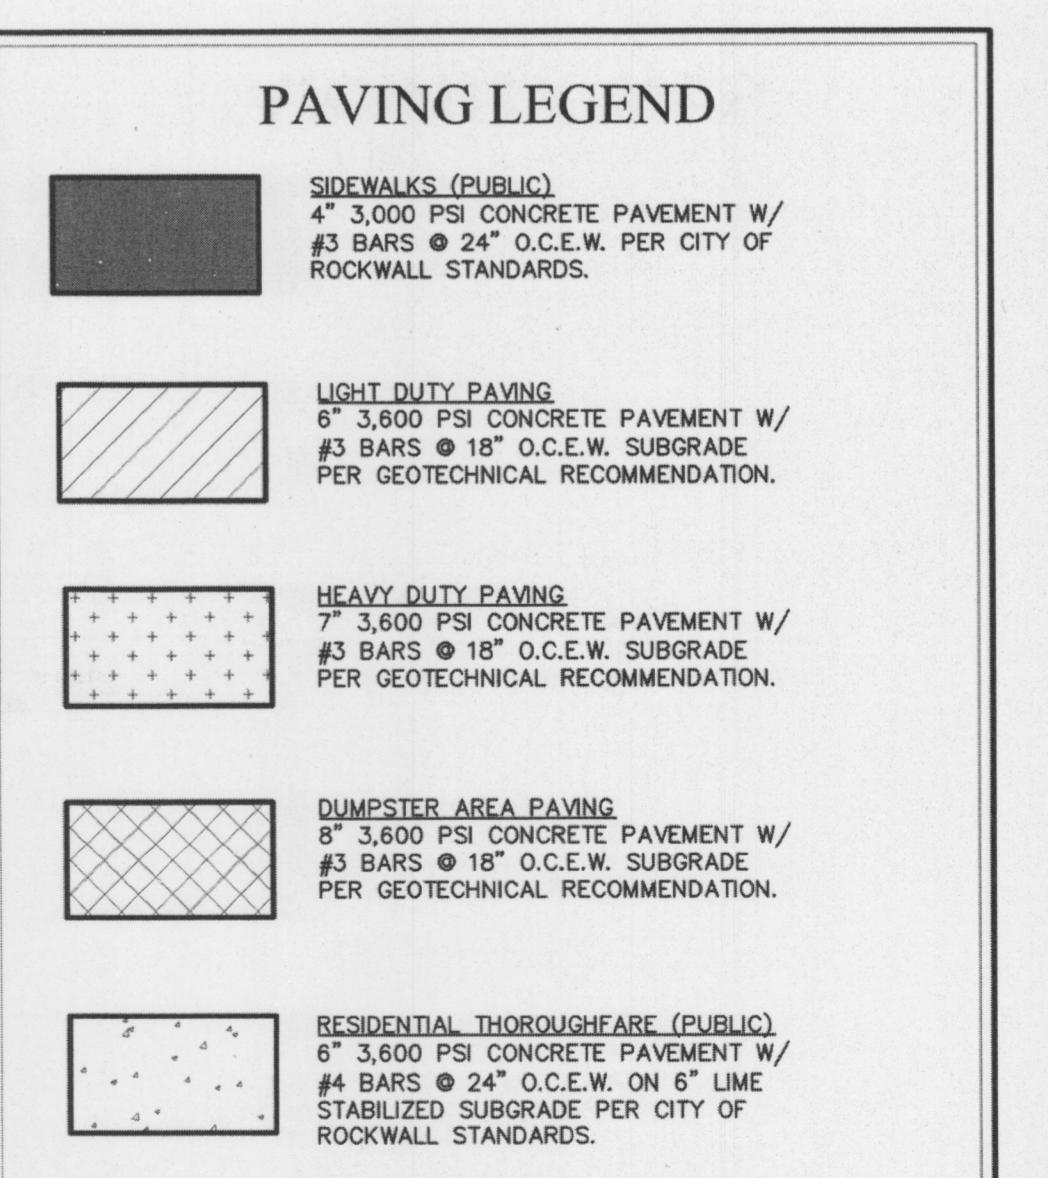



civil engineering, LLC.
5339 ALPHA ROAD, SUITE 75240
972.701.9636 • 972.701.9639 FAX
TX REGISTERED ENGINEERING FIRM F-12600
www.hpcivileng.com

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THESE PLANS WERE PREPARED UNDER THE DIRECT SUPERVISION OF BRIAN C. ABBOTT, P.E., TEXAS REG. #108439 DATE: 12/2/2016



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SITE PLAN
SP 1 OF 2
HPCE #16-434


RECEIVED
DEC 05 2016
CASE NO. SP2016-030

ENGINEER:
HPcivil engineering, LLC
5339 ALPHA ROAD, SUITE 300
DALLAS, TEXAS 75240
PHONE: 972.701.9636
CONTACT: JASON LENTZ

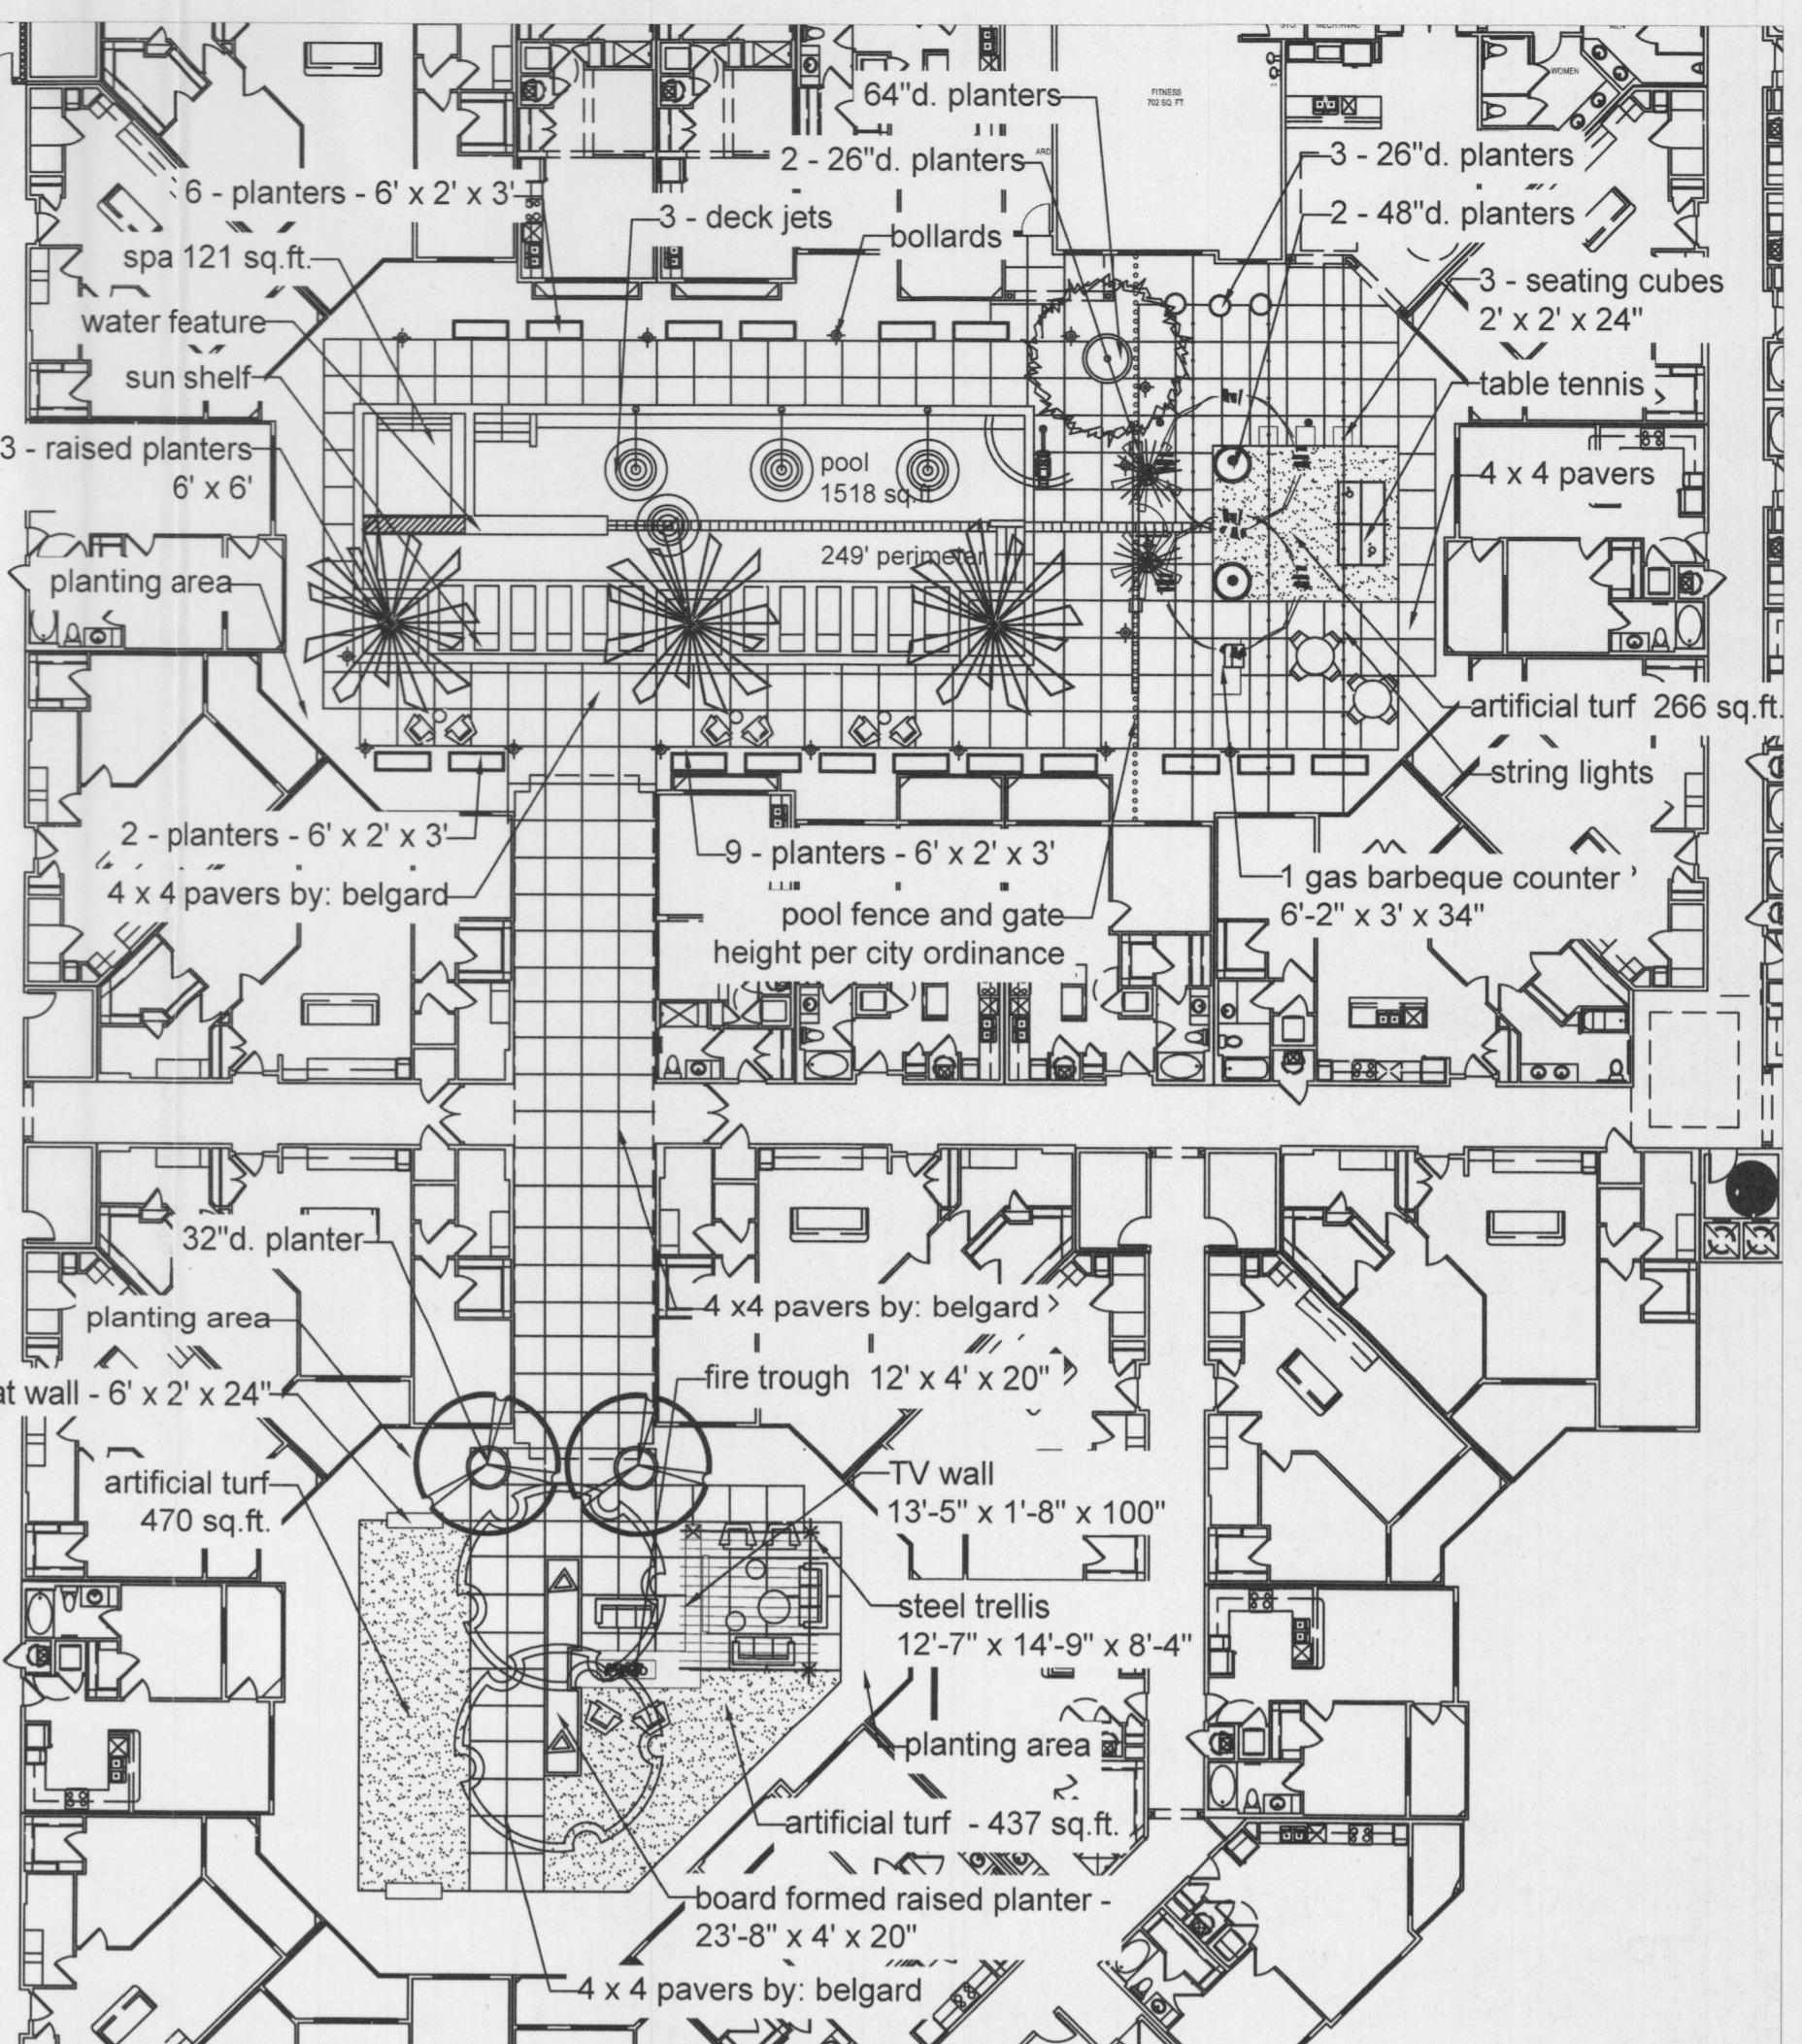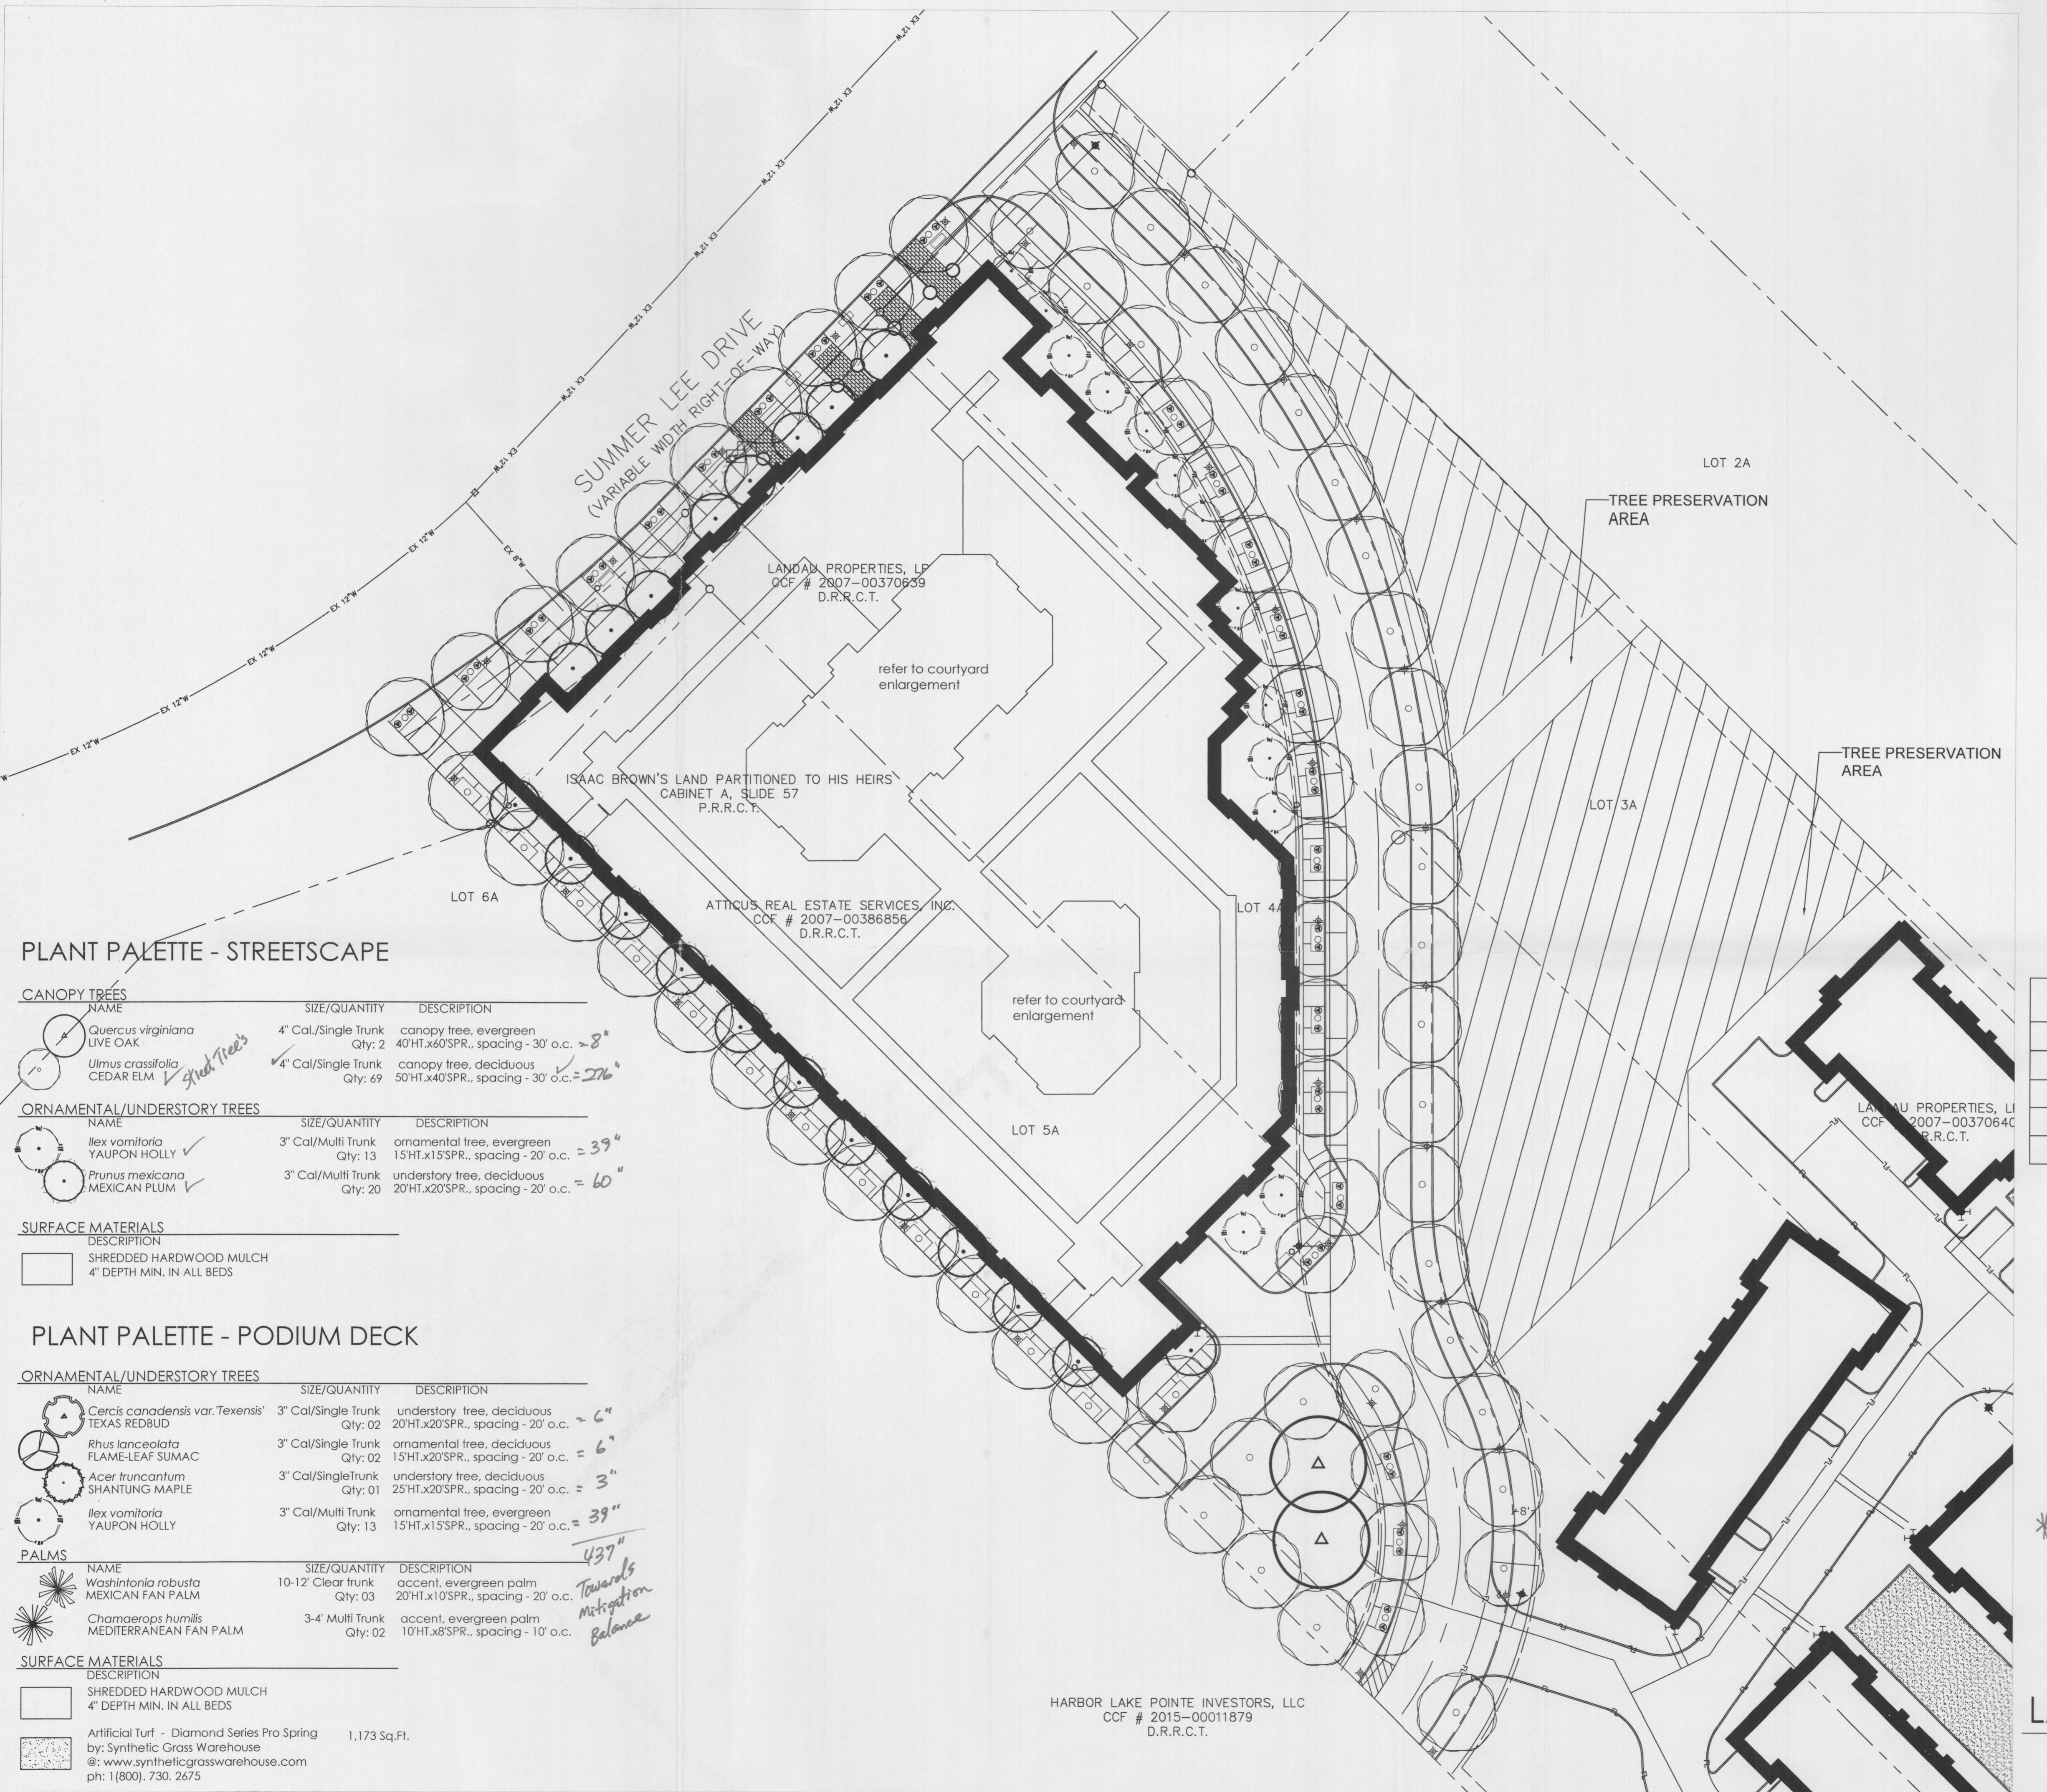


SITE LANDSCAPE CALCULATIONS	
IMPERVIOUS AREA	168,866 SF/3.88 ACRES
LANDSCAPE/OPEN SPACE AREA	119,501 SF/2.74 ACRES
TOTAL SITE AREA	288,367 SF/6.62 ACRES
REQUIRED LANDSCAPE PERCENTAGE PER ZONING	25% OF TOTAL SITE
PROVIDED LANDSCAPE/OPEN SPACE PERCENTAGE	41% OF TOTAL SITE

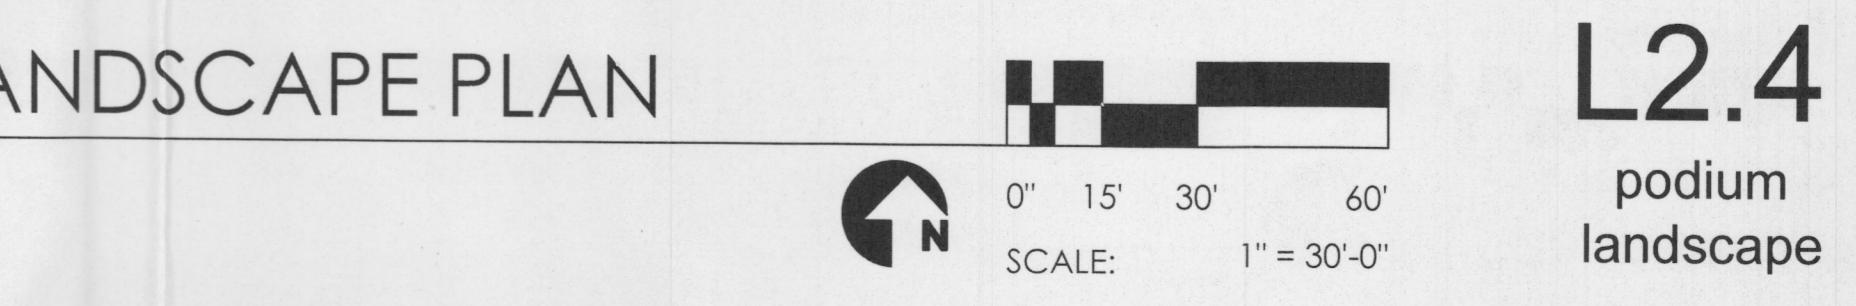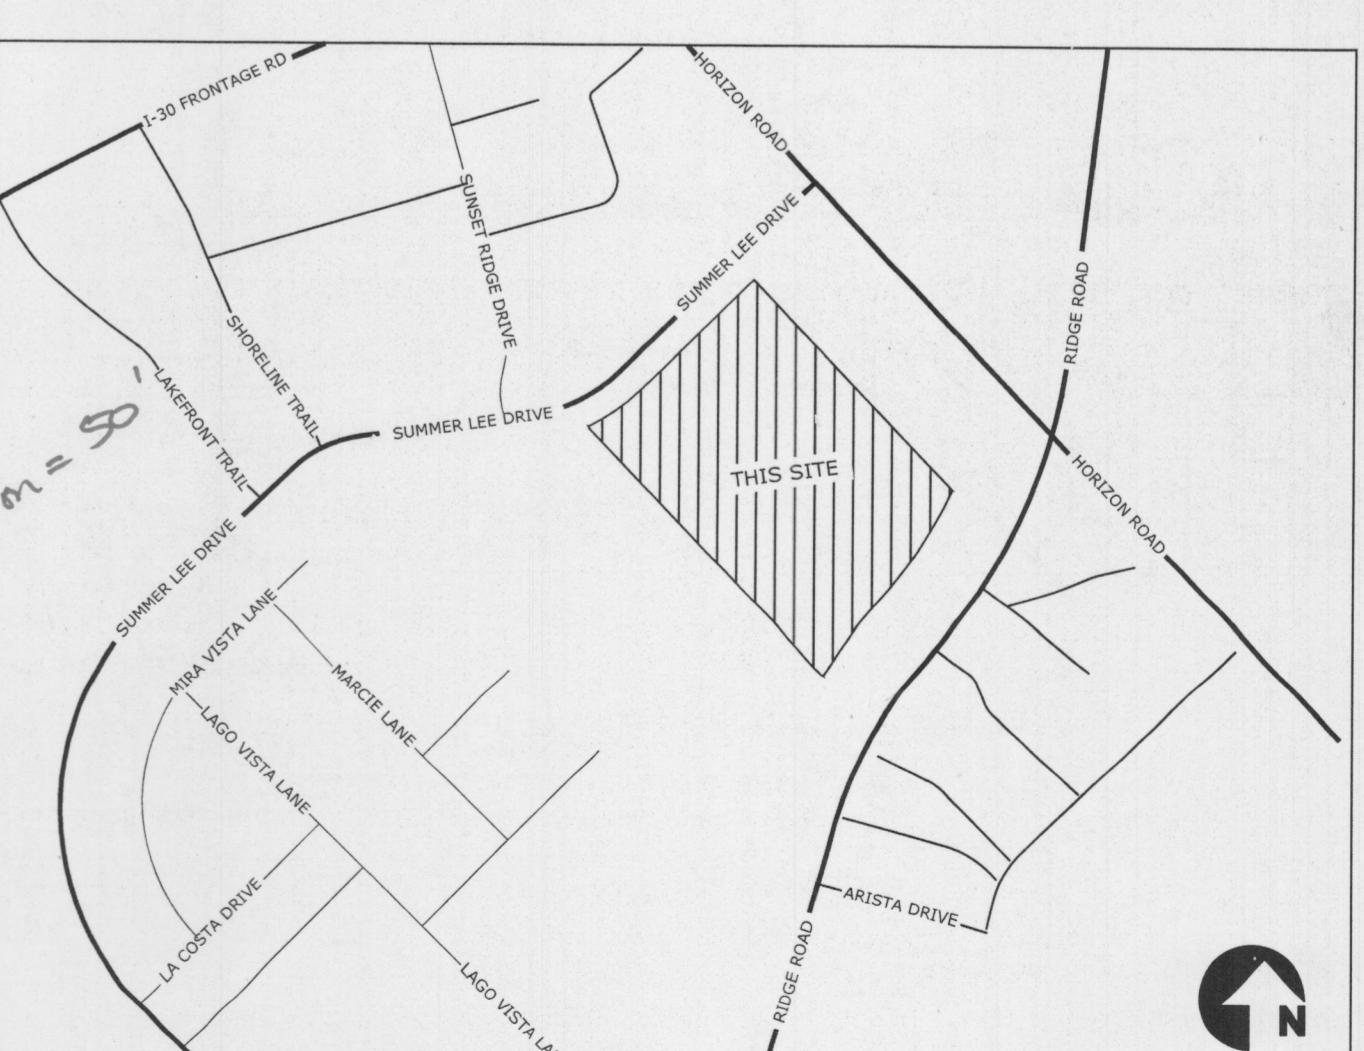


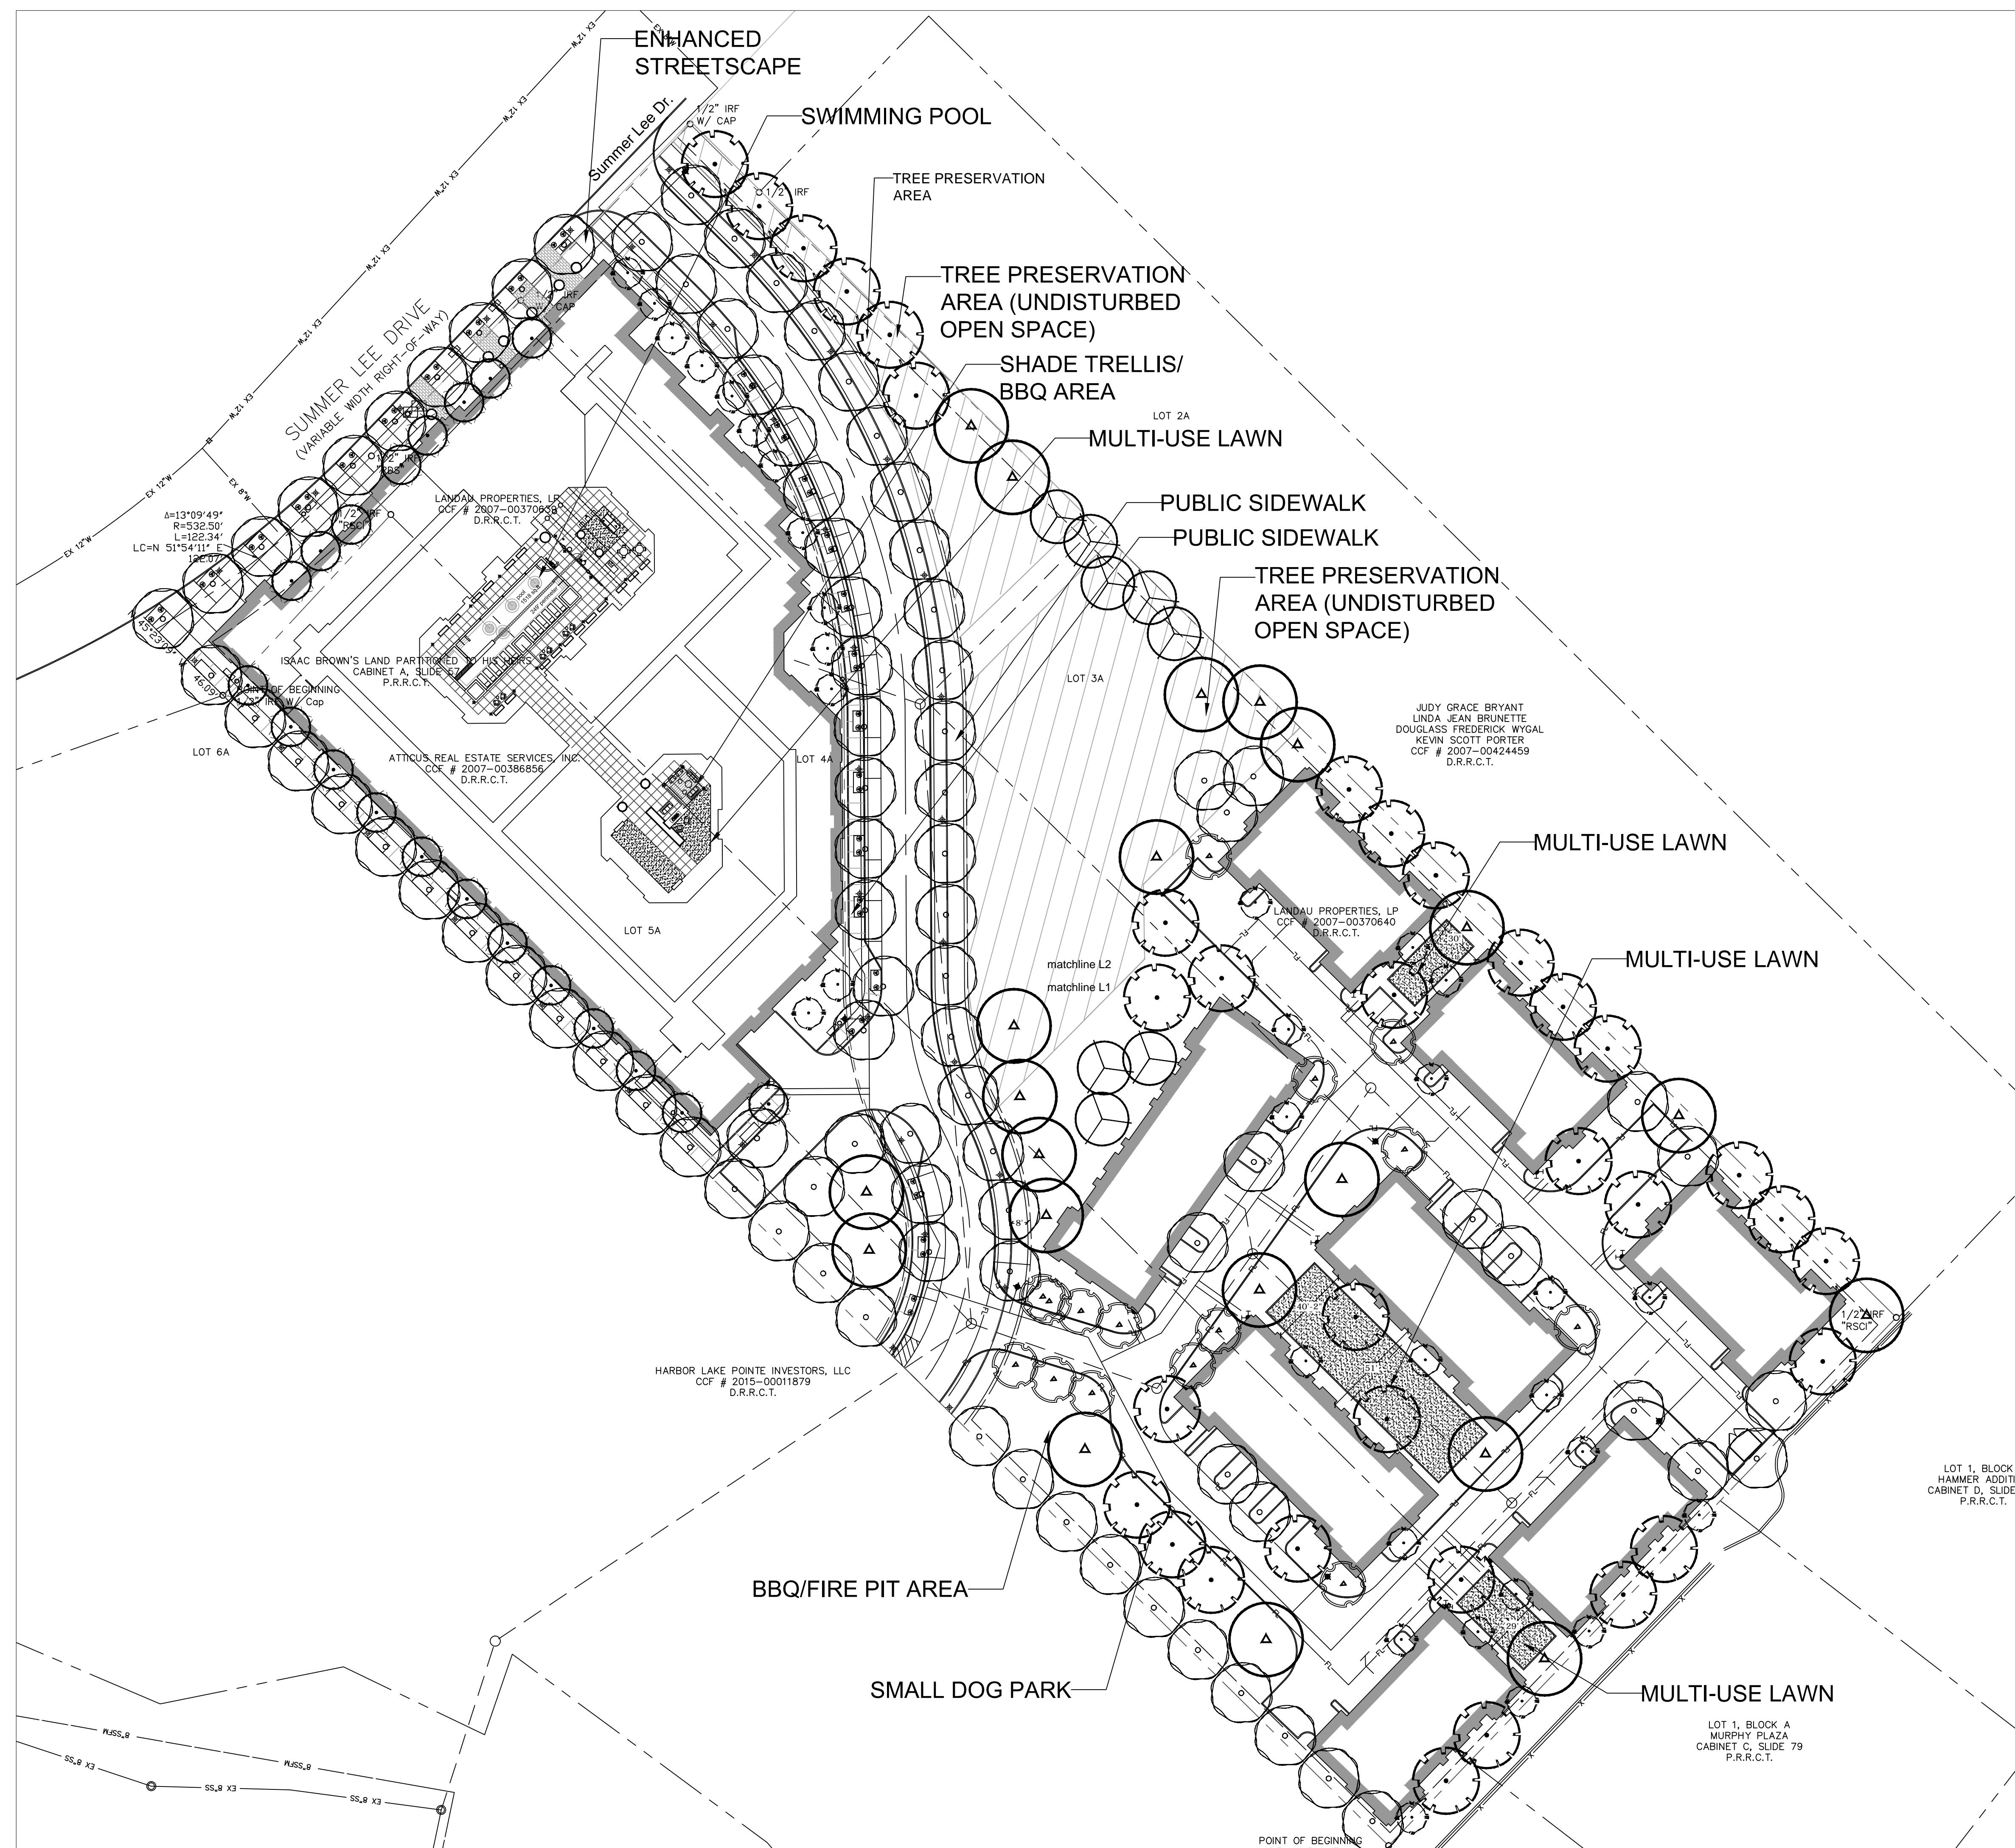

Engineer of Record: BCA
 Drawn by: TCS
 Date Plotted: 12/2/2016
 Issue for Pricing / Bidding:
 Issue for Permit Application:
 Issue for Construction:
 REVISIONS
 # DATE COMMENTS

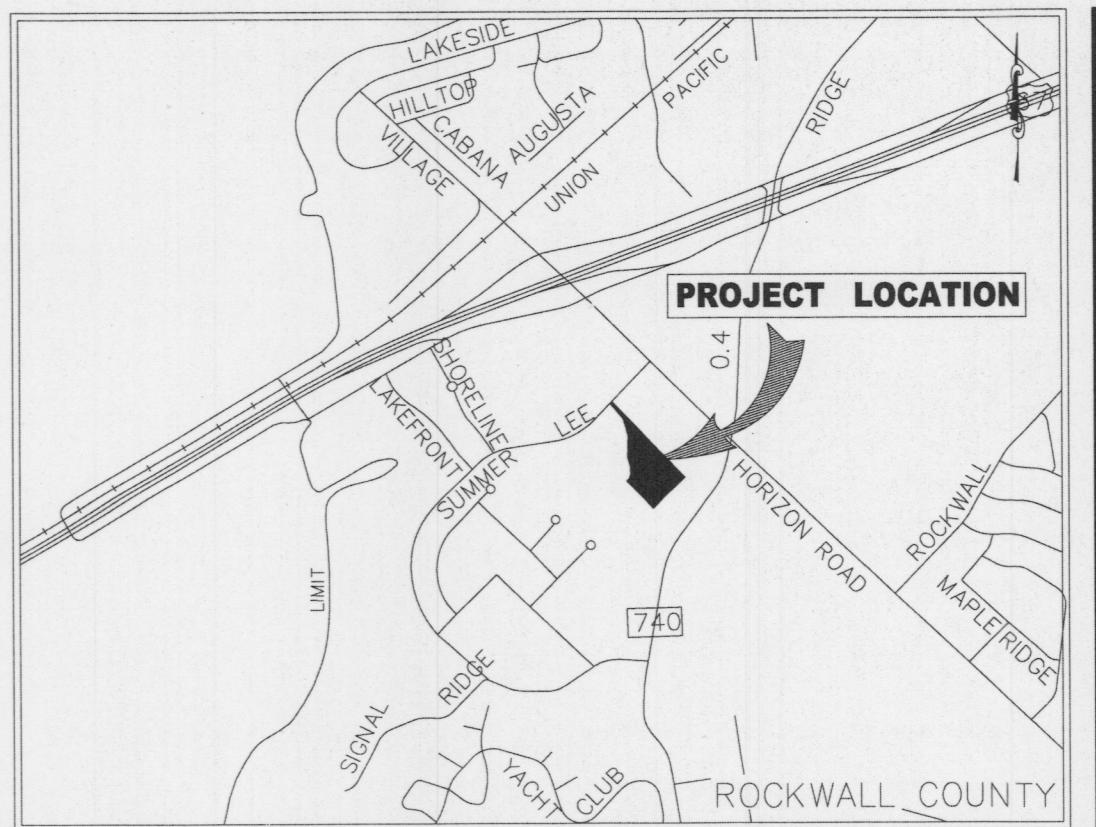

VICINITY MAP
(NOT TO SCALE)

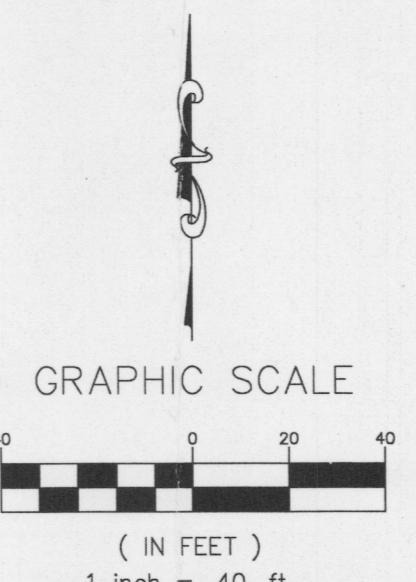

LEGEND	
FL	F.A.U.E. FIRE LANE, ACCESS, & UTILITY EASEMENT
FL	FACE OF CURB TO FACE OF CURB
F-F	ACCESSIBLE CROSSWALK
SSMH	PROP. SANITARY SEWER MANHOLE
FH	PROP. FIRE HYDRANT
SMH	EX. SANITARY SEWER MANHOLE
FDC	PROP. FIRE DEPARTMENT CONNECTION
STMH	PROP. STORM MANHOLE
CI	PROP. CURB INLET
GI	PROP. GRATE INLET
JB	PROP. JUNCTION BOX

NOTES	
1. ALL DIMENSIONS ARE TO BACK OF CURB UNLESS OTHERWISE NOTED.	

PARKING SUMMARY	
1ST LEVEL	4 HANDICAP SPACES (2 VAN, 2 ACCESSIBLE) 148 STANDARD SPACES
TOTAL	152 SPACES
2ND LEVEL	3 HANDICAP SPACES (3 ACCESSIBLE, 0 VAN) 187 STANDARD SPACES
TOTAL	190 SPACES
TOTAL OF BOTH LEVELS	342 SPACES ✓
PARKIN SPACES PROVIDED AT 1.5 SPACES PER UNIT ✓	

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 CONSTRUCTION PURPOSES

THESE PLANS WERE
 PREPARED UNDER THE
 DIRECT SUPERVISION OF
 BRIAN C. ABBOTT, P.E.,
 TEXAS REG. #108439
 DATE: 12/2/2016

DEVELOPER/APPLICANT:
 ATTICUS SUMMER LEE
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 PHONE: 972.701.9636
 CONTACT: JASON LENTZ

ENGINEER:
 HPcivil engineering, LLC
 5339 ALPHA ROAD, SUITE 300
 DALLAS, TEXAS 75240
 PHONE: 972.701.9636
 CONTACT: BRIAN ABBOTT


SHEET TITLE

PARKING LAYOUT


SHEET NO.

SP-2 OF 2

HPCE #16-434

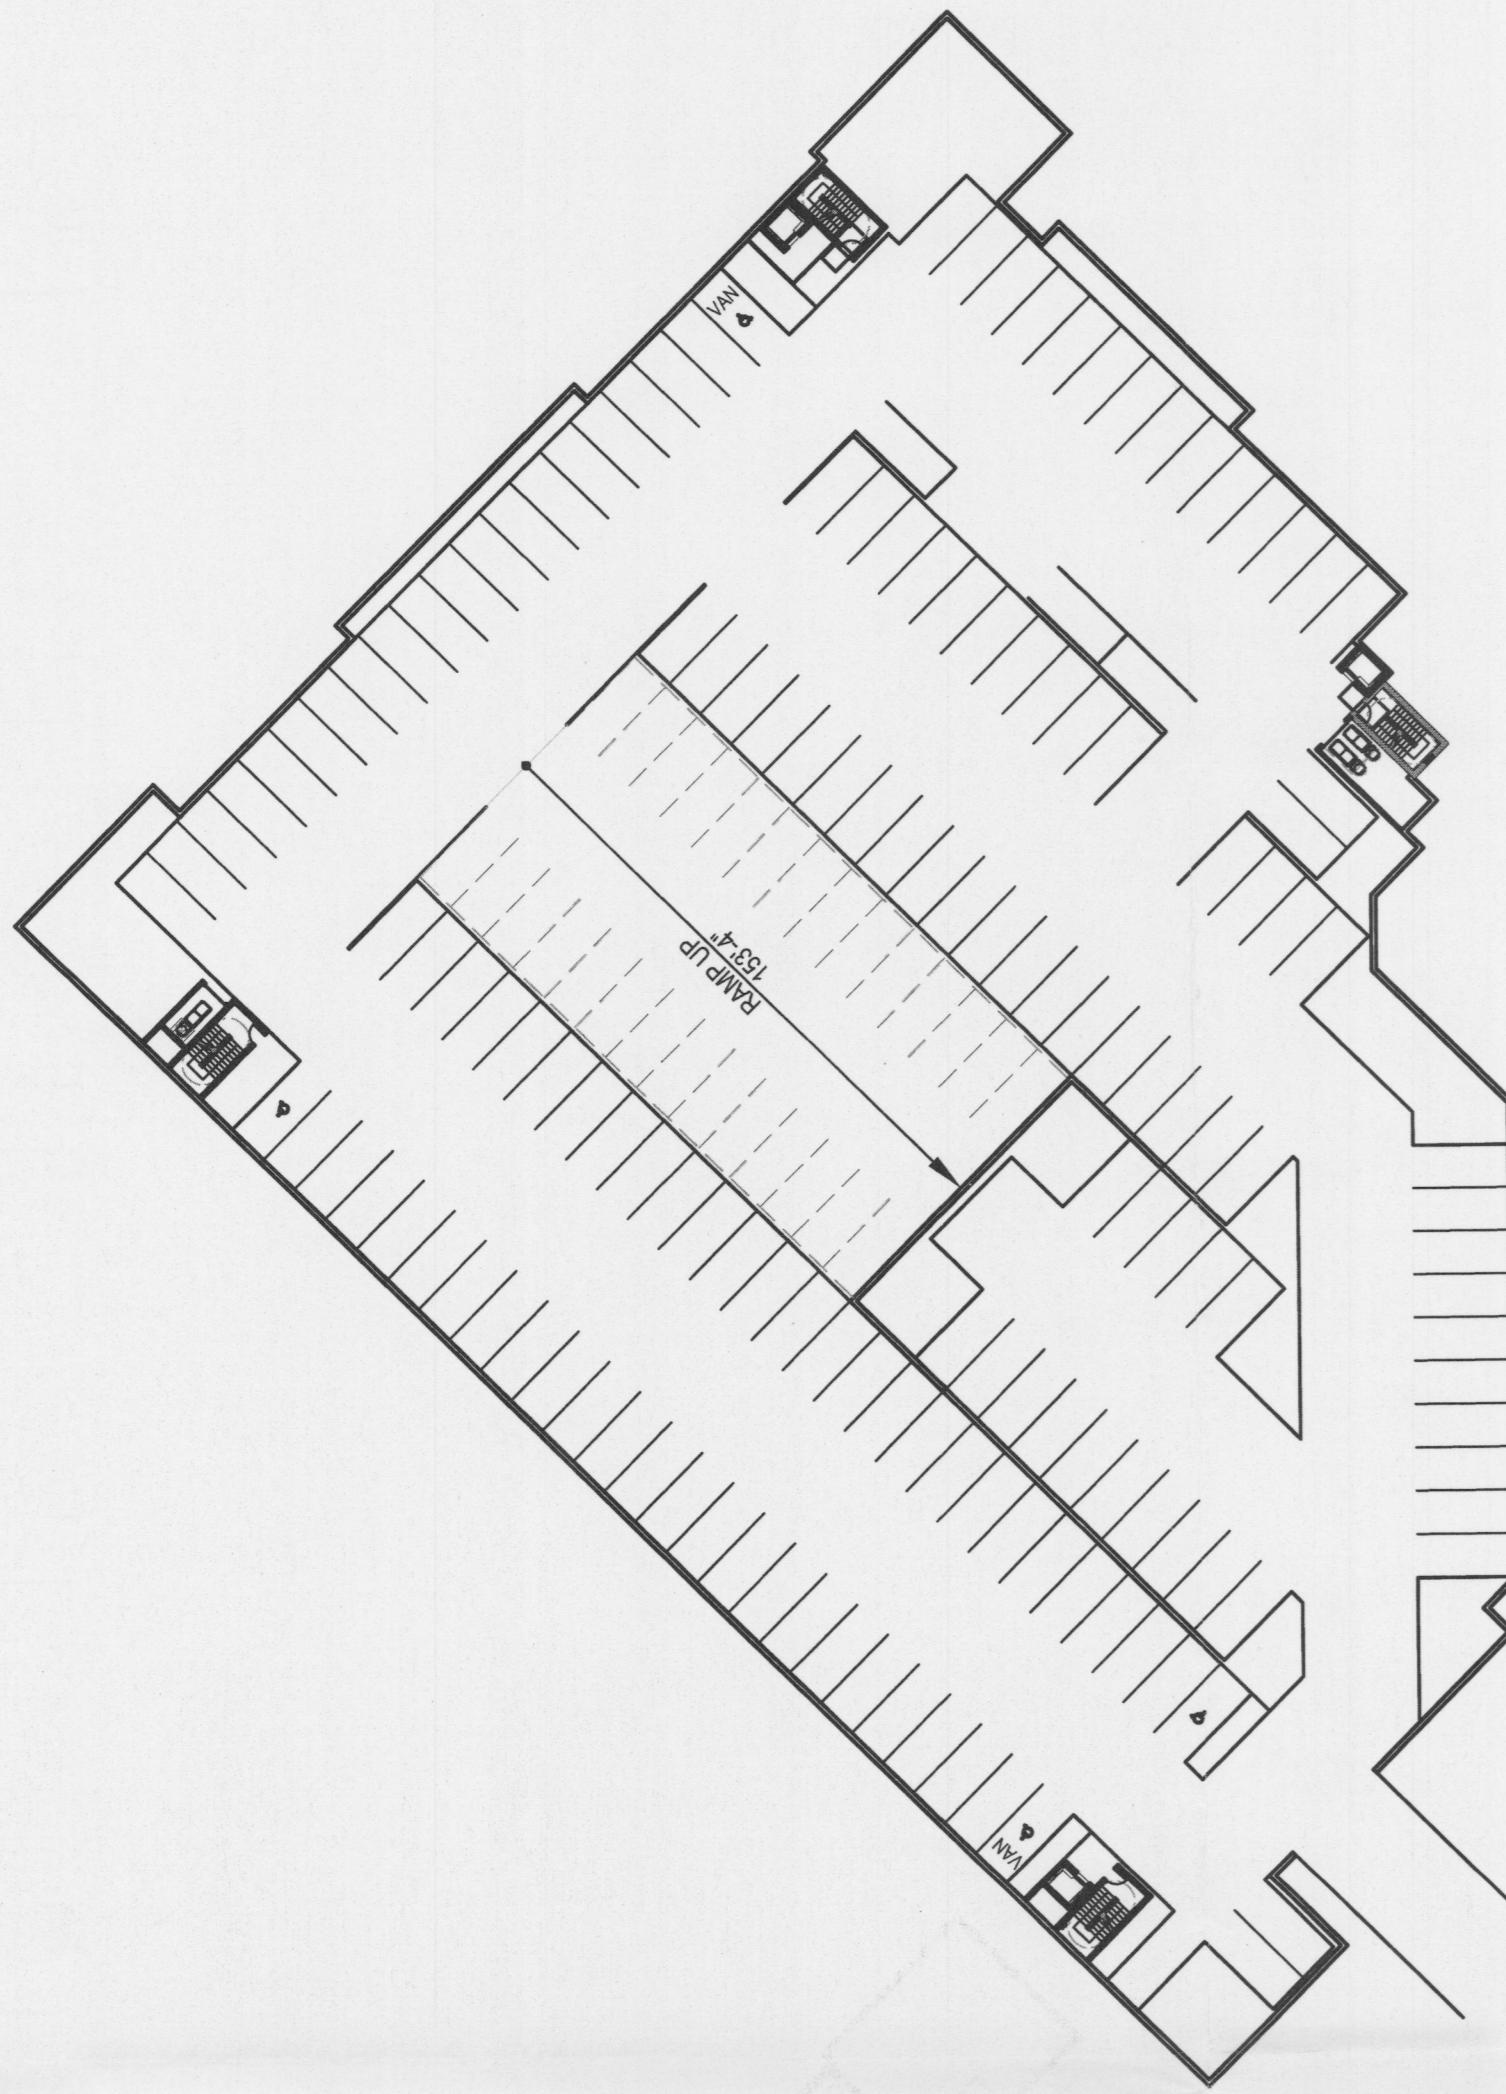

**LEVEL 1 PARKING
STRUCTURE**

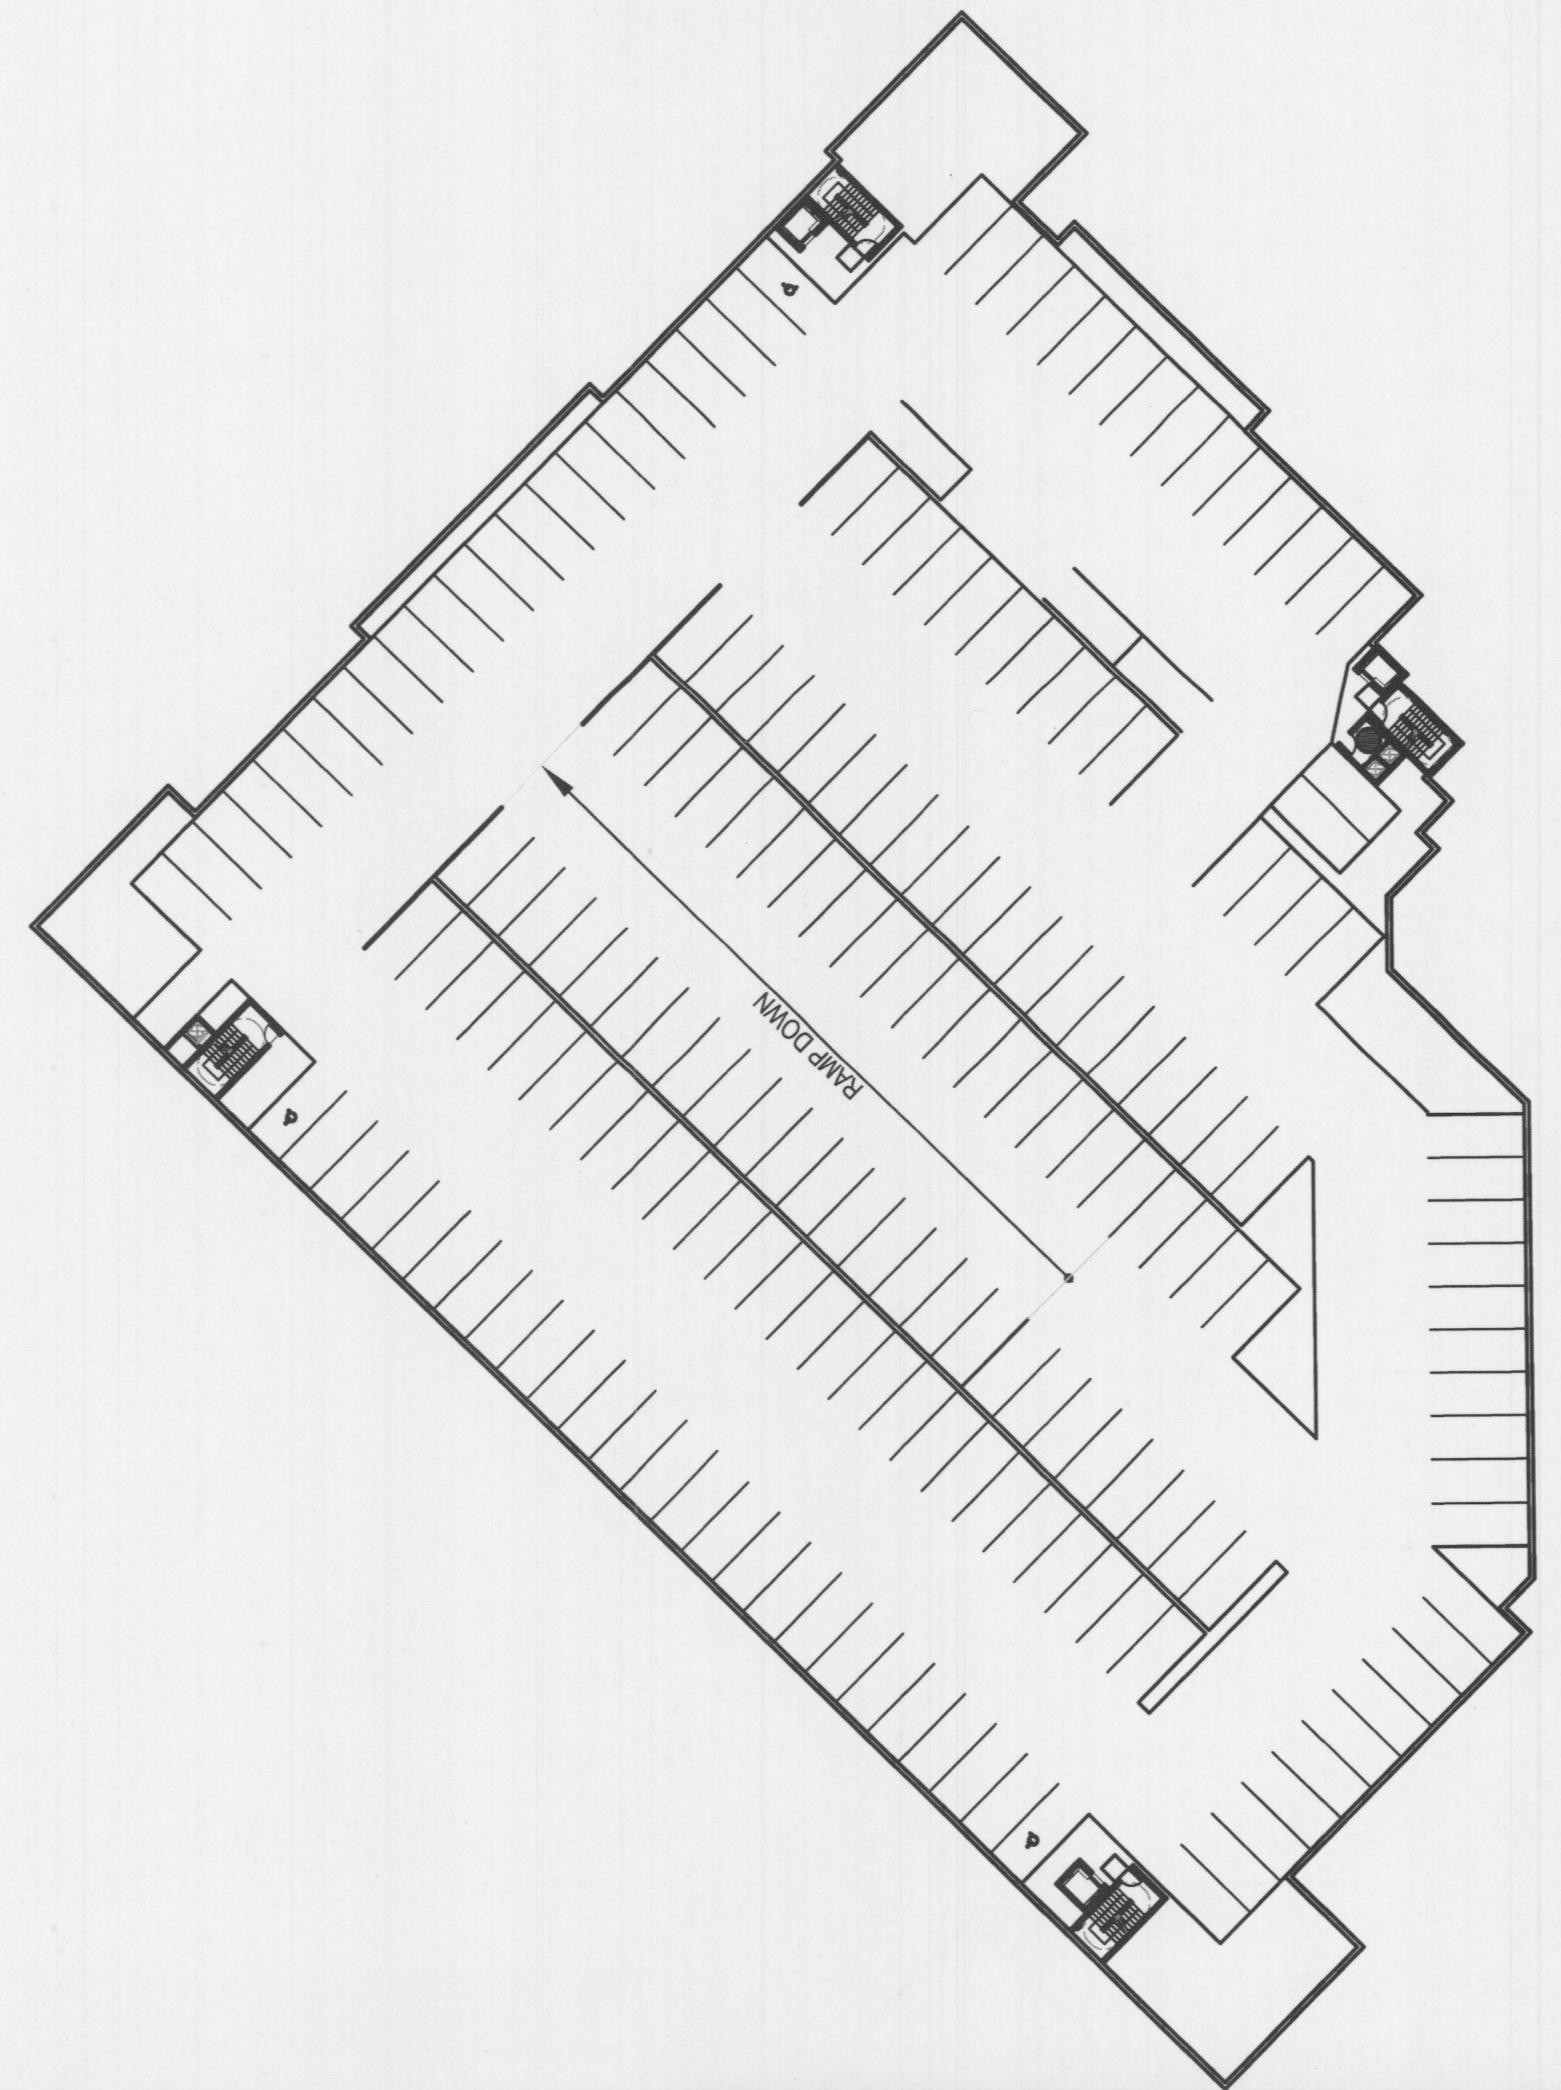

**LEVEL 2 PARKING
STRUCTURE**




17855 N. DALLAS PKWY.,
SUITE 320
DALLAS, TX 75287
V: (469) 385-1616 F: (469) 385-1615

A circular seal for a Professional Engineer license. The outer ring contains the text "STATE OF TEXAS" at the top and "PROFESSIONAL ENGINEER" at the bottom. The inner circle features a five-pointed star at the top, surrounded by four smaller stars. Below the star is the name "MARK N. BIGBIE". In the center of the seal is the number "83876". At the bottom of the seal, the word "LICENSED" is written above the date "11/13/16". A large, handwritten signature "Mark N. Bigbie" is written across the top of the seal.

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SKALA ENGINEERS.

HARBOUR URBAN CENTER PROJECT |

ATTICUS REAL ESTATE DEVELOPMENT

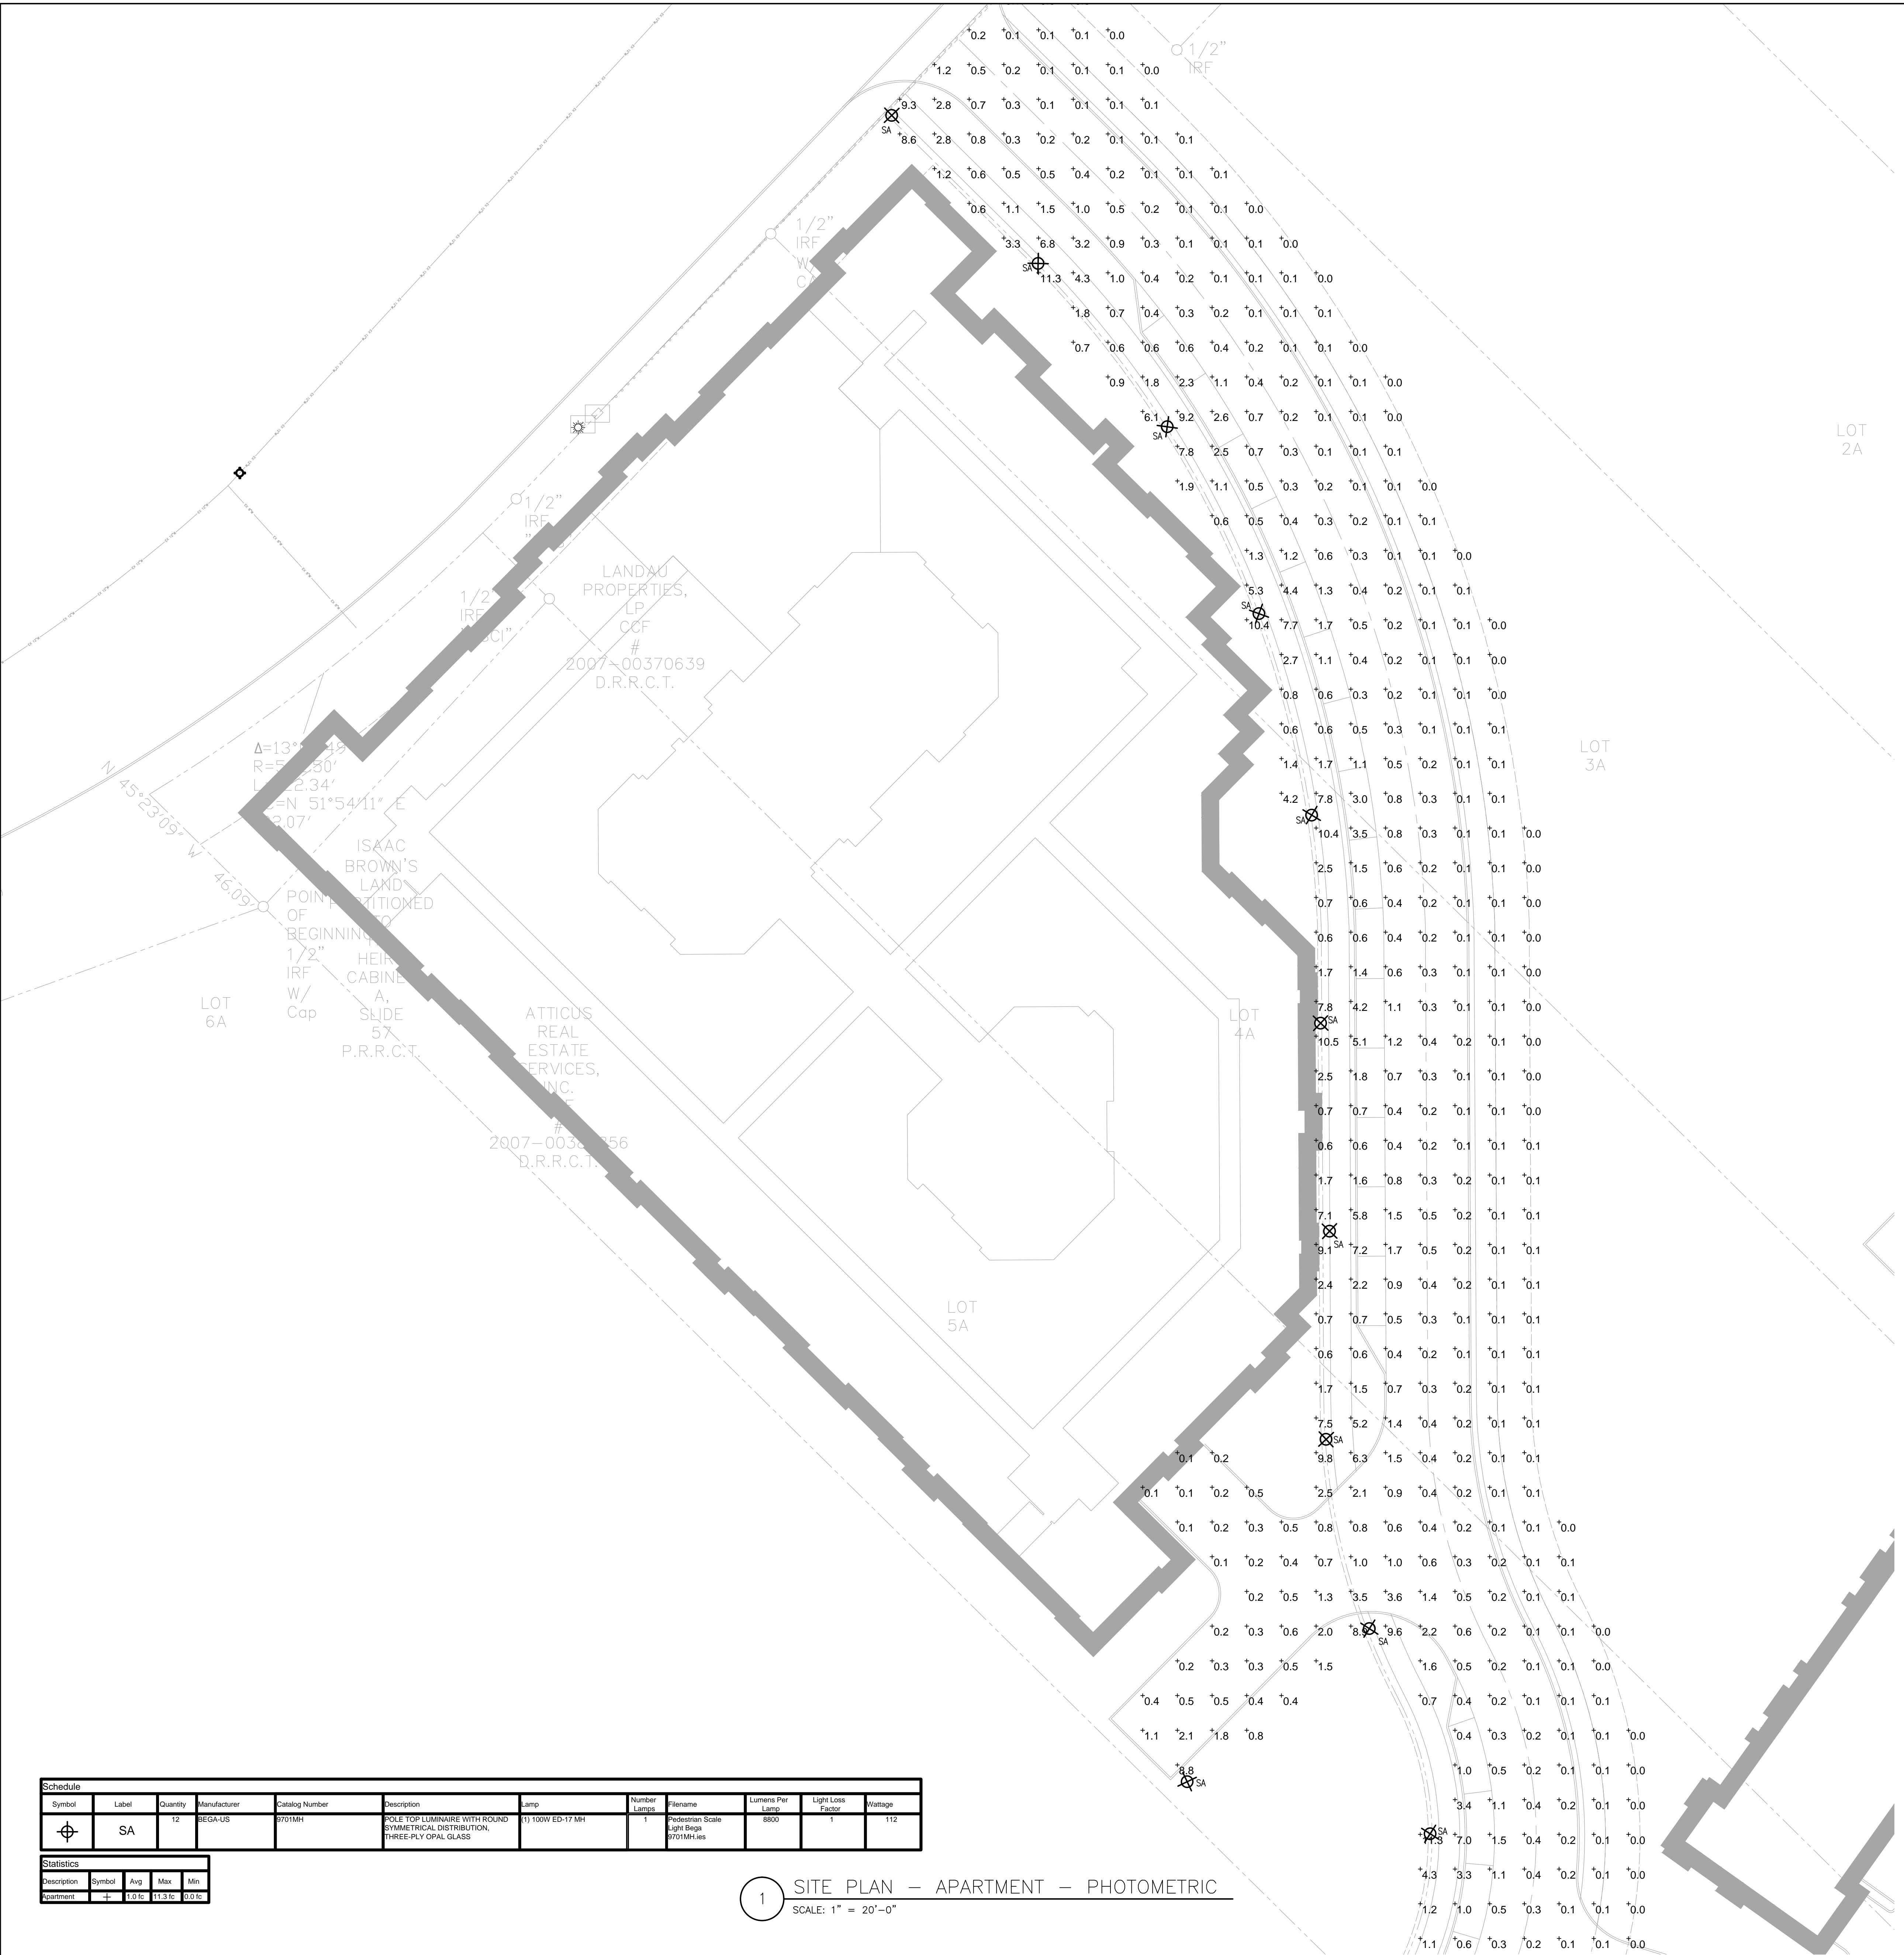

1 SITE PLAN - APARTMENT - PHOTOMETRIC
SCALE: 1" = 20'-0"

Schedule												
Symbol	Label	Quantity	Manufacturer	Catalog Number	Description	Lamp	Number Lamps	Filename	Lumens Per Lamp	Light Loss Factor	Wattage	
	SA	12	BEGA-US	9701MH	POLE TOP LUMINAIRE WITH ROUND SYMMETRICAL DISTRIBUTION, THREE-PLY OPAL GLASS	(1) 100W ED-17 MH	1	Pedestrian Scale Light Bega 9701MH.ies	8800	1	112	

Statistics				
Description	Symbol	Avg	Max	Min
Apartment	+	10.0 fc	11.3 fc	0.0 fc

Pole top luminaires with symmetrical light distribution

Housing: Two interlocking die cast aluminum housings. Heavy gauge .080" spun aluminum shade with rolled edge, finished white inside. Die castings are marine grade, copper free ($\leq 0.3\%$ copper content) A360.0 aluminum alloy.

Arm/fitter: Arm is integrally die cast into lower luminaire housing and bolted into one piece cast aluminum fitter/pole extension with integral slip fitter. Fitter slip fits a 3" O.D. pole top and is secured by six (6) socket head stainless steel set screws threaded into stainless steel inserts.

Enclosure: Hand blown seamless three-ply opal glass with screw neck and minimum 75% transmission, fully gasketed for weather tight operation using a high temperature silicone rubber O-ring gasket.

Electrical: Lampholders are medium base porcelain with nickel plated copper screw shell supplied with 200°C high temperature leads, rated 4KV. Ballasts are magnetic, located in the base of the selected BEGA pole and are available in 120V or 208V or 240V or 277V - specify.

Finish: All BEGA standard finishes are polyester powder coat with minimum 3 mil thickness. These luminaires are available in four standard BEGA colors: Black (BLK); White (WHT); Bronze (BRZ); Silver (SLV). To specify, add appropriate suffix to catalog number. Custom colors supplied on special order.

UL listed for US and Canadian Standards, suitable for wet locations. Protection class: IP 44.

Weight: 18 lbs.

Effective Projection Area (EPA): 2.93 ft²

A technical line drawing of a single pole-top luminaire. It consists of a vertical pole with a horizontal arm extending from the top. The arm holds a cylindrical lamp head. Dimension 'A' is the distance from the center of the lamp head to the vertical pole. Dimension 'B' is the height of the lamp head above the horizontal arm. Dimension 'C' is the width of the lamp head at its widest point.

Single pole-top luminaire

Lamp	Lumen	A	B	C
9701 MH	1 100W ED-17 MH	8800	17 $\frac{3}{4}$	47 $\frac{1}{4}$

**HARBOUR URBAN CENTER
TYPE 'SA' BEGA 9701 MH 100W PSMH
FIXTURE ON BEGA 1108 11'8" TAPERED
ROUND POLE WITH INTEGRAL BANNER
ARMS. POWDER COAT RAL #7003 MOSS
GREY**


Type:
BEGA Product:
Project:
Voltage:
Color:
Options:
Modified:

A photograph of the Harbour Urban Center Type 'SA' BEGA 9701 MH 100W PSMH fixture. The fixture is mounted on a tall, dark, tapered round pole. The fixture itself has a black, integrated banner arm and a large, wide, conical shade. The background is plain white.

BEGA-US 1000 BEGA Way, Carpinteria, CA 93013 (805) 684-0533 FAX (805) 566-9474 www.bega-us.com
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WIND SPEED	≥ 91 MPH TO 100 MPH
	≤ 2 LIGHT FIXTURES ON POLE
POLE HEIGHT ≤ 11'8"	DIAMETER (D) 1'-6" EMBEDMENT (E) 4'-9"



POLE BASE DETAIL

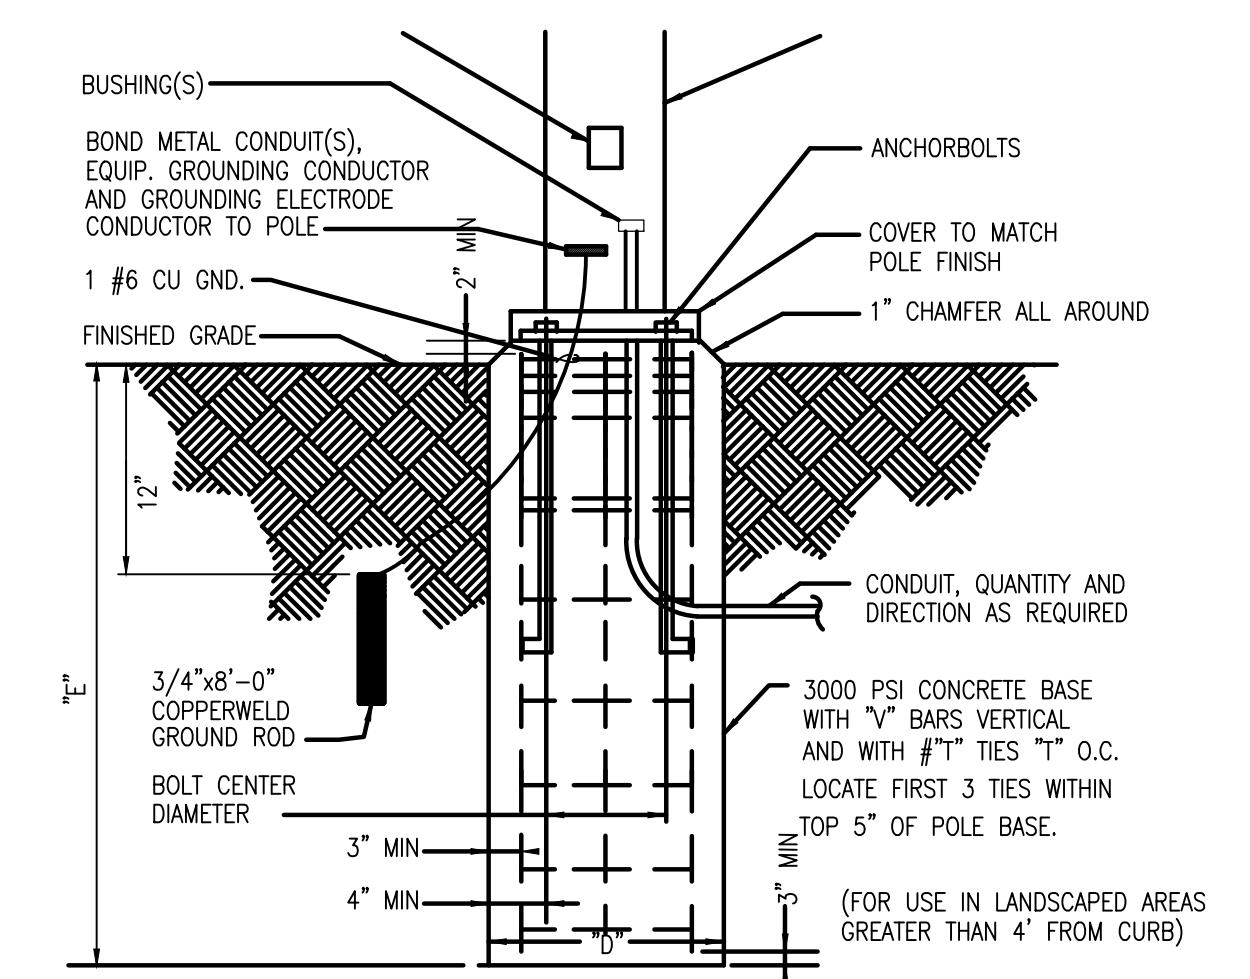PRINT RECORD		
DATE	ISSUED FOR	
11/18/2016	SITE PLAN SUBMISSION	
REVISIONS		
#	DATE	DESCRIPTION
Texas Firm Registration # F-4990		
Project Number: 163-0722		
Drawn By: BDH Checked By: MNB		
SHEET TITLE		
SITE PLAN - APARTMENT - PHOTOMETRIC		
SHEET NUMBER		
E1.00		



FRONT ELEVATION - OPTION 1



FRONT ELEVATION - OPTION 2

A415

HUMPHREYS & PARTNERS ARCHITECTS, L.P.
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5339 Alpha Rd., Suite 300, Dallas, TX 75240 | 972.701.9636 | www.humphreys.com

 ATTICUS

PODIUM BUILDING ELEVATIONS

DEC 06, 2016

HARBOUR URBAN CENTER

Rockwall, TX

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SUMMER LEE STREETSCAPE - FLAT ROOF OPTION

A102

HPA# 16205