


HORIZON VILLAGE ADDITION

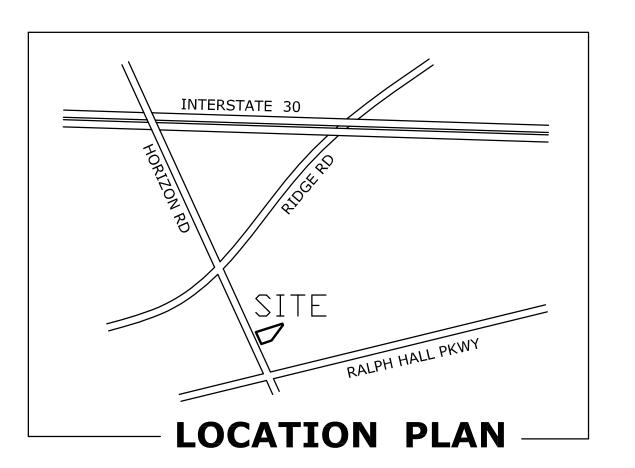

MINIMUM LANDSCAPE AREA 25% REQUIRED	12,096 SF	19,817 SF
MINIMUM LOT AREA	10,000 SF	48,383 SF
MINIMUM LOT WIDTH	60 LF	161 LF
MINIMUM LOT DEPTH	100 LF	371 LF
MINIMUM FRONT SETBACK	15 LF	15 LF
MINIMUM REAR SETBACK	10 LF	10 LF
MINIMUM SIDE SETBACK	10 LF	10 LF
MINIMUM DISTANCE BETWEEN BUILDINGS	15 LF	54′ LF
MAXIMUM BUILDING HEIGHT	60 LF	20' LF
MAXIMUM LOT COVERAGE	60%	9%
MAXIMUM FLOOR AREA RATIO	4:1	.009:1
MAXIMUM IMPERVIOUS AREA	85%	59%

ABSTRACT NO. 9 - WILLIAM BLEVINS SURVEY

1. ZONING: C 2. PROPOSED USE: OIL CHANGE

3. PROPERTY AREA (GROSS): 48,383 SF 1.11 AC 4. BUILDING AREA: PROPOSED 1,440 SF

5. BUILDING HEIGHT: ONE STORY - 20'-6"

6. LOT COVERAGE : 8.8% F.A.R. = 0.009:1 7. PARKING REQUIRED: 2 PER EACH BAY = 18 SPACES REQUIRED

8. HANDICAP REQUIRED 1 ACCESSIBLE IN 0-25 SPACES 1 PROVIDED

9. TOTAL PARKING PROVIDED: 17 EXISTING SPACES/1 NEW SPACE=18

10. TOTAL SQUARE FOOTAGE OF IMPERVIOUS SURFACE: 28,566 SF

HORIZON VILLAGE


BEING A 1.11 AC. TRACT OF LAND SITUATED IN THE HORIZON VILLAGE ADDITION BLOCK 1

LOT 4 IN THE CITY OF ROCKWALL, ROCKWALL COUNTY, TEXAS

OWNER IYM AUTOMOTIVE INC.

2581 HORIZON ROAD ROCKWALL, TEXAS 75032 CASE #SP2019-035

© COPYRIGHT 2019 MERSHAWN ARCHITECTS, INC. NO PRINTING OR COPING IS ALLOWED WITHOUT PERMISSION FROM MERSHAWN.

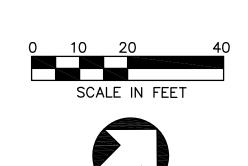

PRICING & CONSTRUCTION GENERAL NOTES:

- THESE DRAWINGS ARE DIAGRAMMATIC IN
 NATURE AND ARE NOT INTENDED TO
 INDICATE EACH AND EVERY FITTING, OFFSET,
 OR OTHER APPURTENANCE NECESSARY TO
 COMPLETE THE SYSTEM.
- 2. IT IS THE SUBCONTRACTOR'S RESPONSIBILITY TO REVIEW THE DOCUMENTS AND INCLUDE ALL NECESSARY ITEMS TO PROVIDE A COMPLETE OPERATIONAL SYSTEM.
- 3. ANY DISCREPANCIES NOTED BY THE SUBCONTRACTOR SHALL BE BROUGHT TO THE ATTENTIONS OF THE ARCHITECT (IN
- WRITING) BEFORE BIDDING THIS PROJECT. AFTER BIDS ARE TURNED IN, THE SUBCONTRACTOR SHALL COMPLETE THE SYSTEMS AT NO ADDITIONAL COST.
- 5. PLUMBING, MECHANICAL, AND ELECTRICAL SUBCONTRACTORS ARE RESPONSIBLE FOR COORDINATING ALL COMPONENTS TO INSURE COMPLETE AND WORKING SYSTEMS EACH SUBCONTRACTOR SHALL REVIEW ALL DRAWNICS FOR COMPLIANCE
- THE ARCHITECT WILL BE RESPONSIBLE TO DETERMINE WHICH TRADE SHALL PROVIDE AND INSTALL ANY COMPONENTS MISSED FOR WORKING SYSTEMS AS NEEDED.

Drawn: GW Checked: WM SHEET

Scale: 1'' = 20' - 0''

Project No.: AAAAAA

Designed: GW


MM/DD/YEAR

KWIK KAR ROCKWALL, TEXAS


NORTH ELEVATION **100% MASONRY 30% STONE 70% BLOCK**

ASPHALT SHINGLES TO MATCH EXISTING SPLIT FACE CMU BLOCK STONE TO MATCH TO MATCH EXISTING EXISTING

> EAST ELEVATION **100% MASONRY 24% STONE 76% BLOCK**

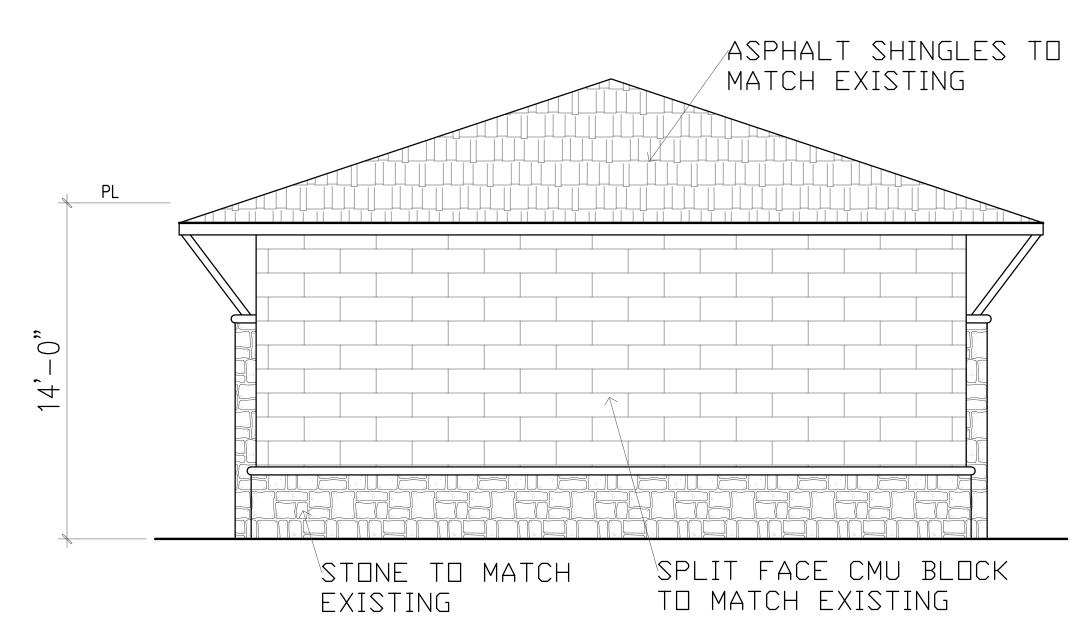

WEST ELEVATION **100% MASONRY 24% STONE 76% BLOCK**

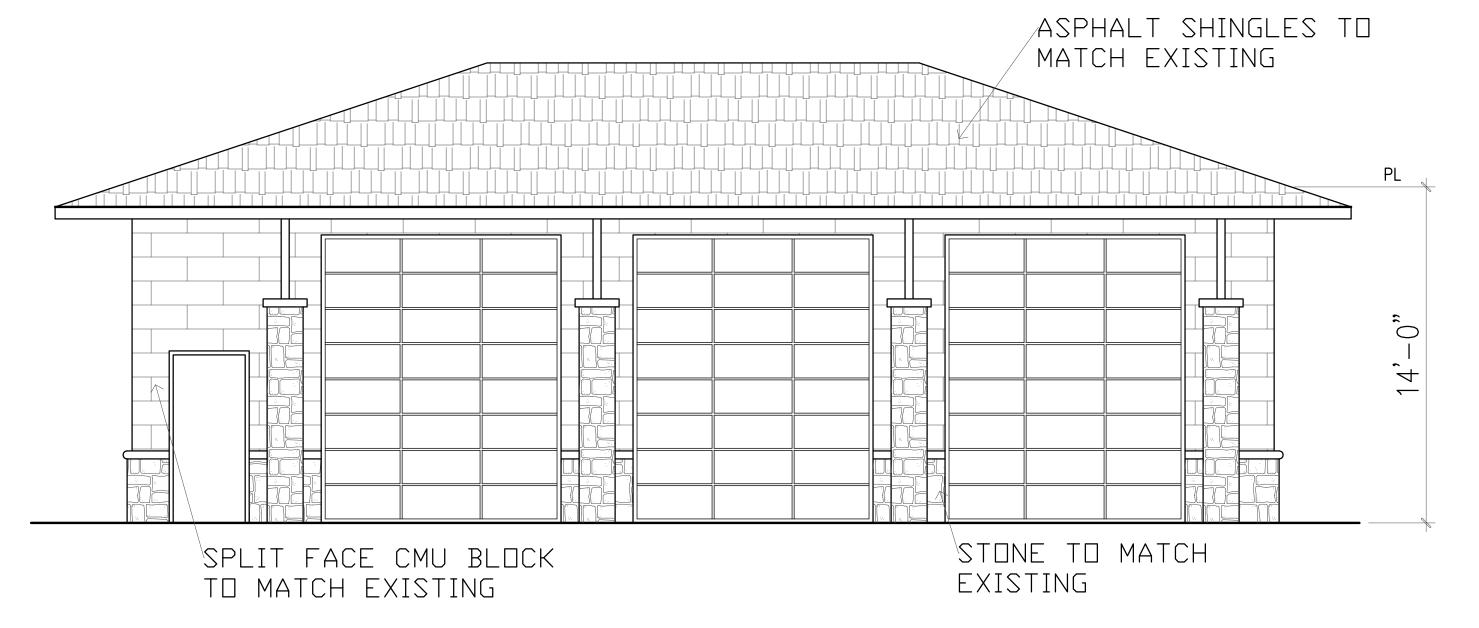

SOUTH ELEVATION **100% MASONRY 38% STONE 62% BLOCK**

PRICING & CONSTRUCTION GENERAL NOTES:

- THESE DRAWINGS ARE DIAGRAMMATIC IN NATURE AND ARE NOT INTENDED TO INDICATE EACH AND EVERY FITTING, OFFSET, OR OTHER APPURTENANCE NECESSARY TO COMPLETE THE SYSTEM.
- 2. IT IS THE SUBCONTRACTOR'S RESPONSIBILITY TO REVIEW THE DOCUMENTS AND INCLUDE ALL NECESSARY ITEMS TO PROVIDE A COMPLETE OPERATIONAL SYSTEM.
- 3. ANY DISCREPANCIES NOTED BY THE SUBCONTRACTOR SHALL BE BROUGHT TO THE ATTENTIONS OF THE ARCHITECT (IN WRITING) BEFORE BIDDING THIS PROJECT.
- 4. AFTER BIDS ARE TURNED IN, THE SUBCONTRACTOR SHALL COMPLETE THE SYSTEMS AT NO ADDITIONAL COST.

DRAWINGS FOR COMPLIANCE.

- 5. PLUMBING, MECHANICAL, AND ELECTRICAL SUBCONTRACTORS ARE RESPONSIBLE FOR COORDINATING ALL COMPONENTS TO INSURE COMPLETE AND WORKING SYSTEMS EACH SUBCONTRACTOR SHALL REVIEW ALL
- 6. THE ARCHITECT WILL BE RESPONSIBLE TO DETERMINE WHICH TRADE SHALL PROVIDE AND INSTALL ANY COMPONENTS MISSED FOR WORKING SYSTEMS AS NEEDED.

OWNER IYM AUTOMOTIVE INC. 2581 HORIZON ROAD ROCKWALL, TEXAS 75032

NO PRINTING OR COPING IS ALLOWED

CASE #SP2019-035

© COPYRIGHT 2019 MERSHAWN ARCHITECTS, INC. WITHOUT PERMISSION FROM MERSHAWN.

'ATION


Scale: 1/4" = 1'-0"

XTE

Project No.: Designed: GW Drawn: GW

Checked: WM SHEET

HORIZON CARWASH HORIZON VILLAGE ADDITION

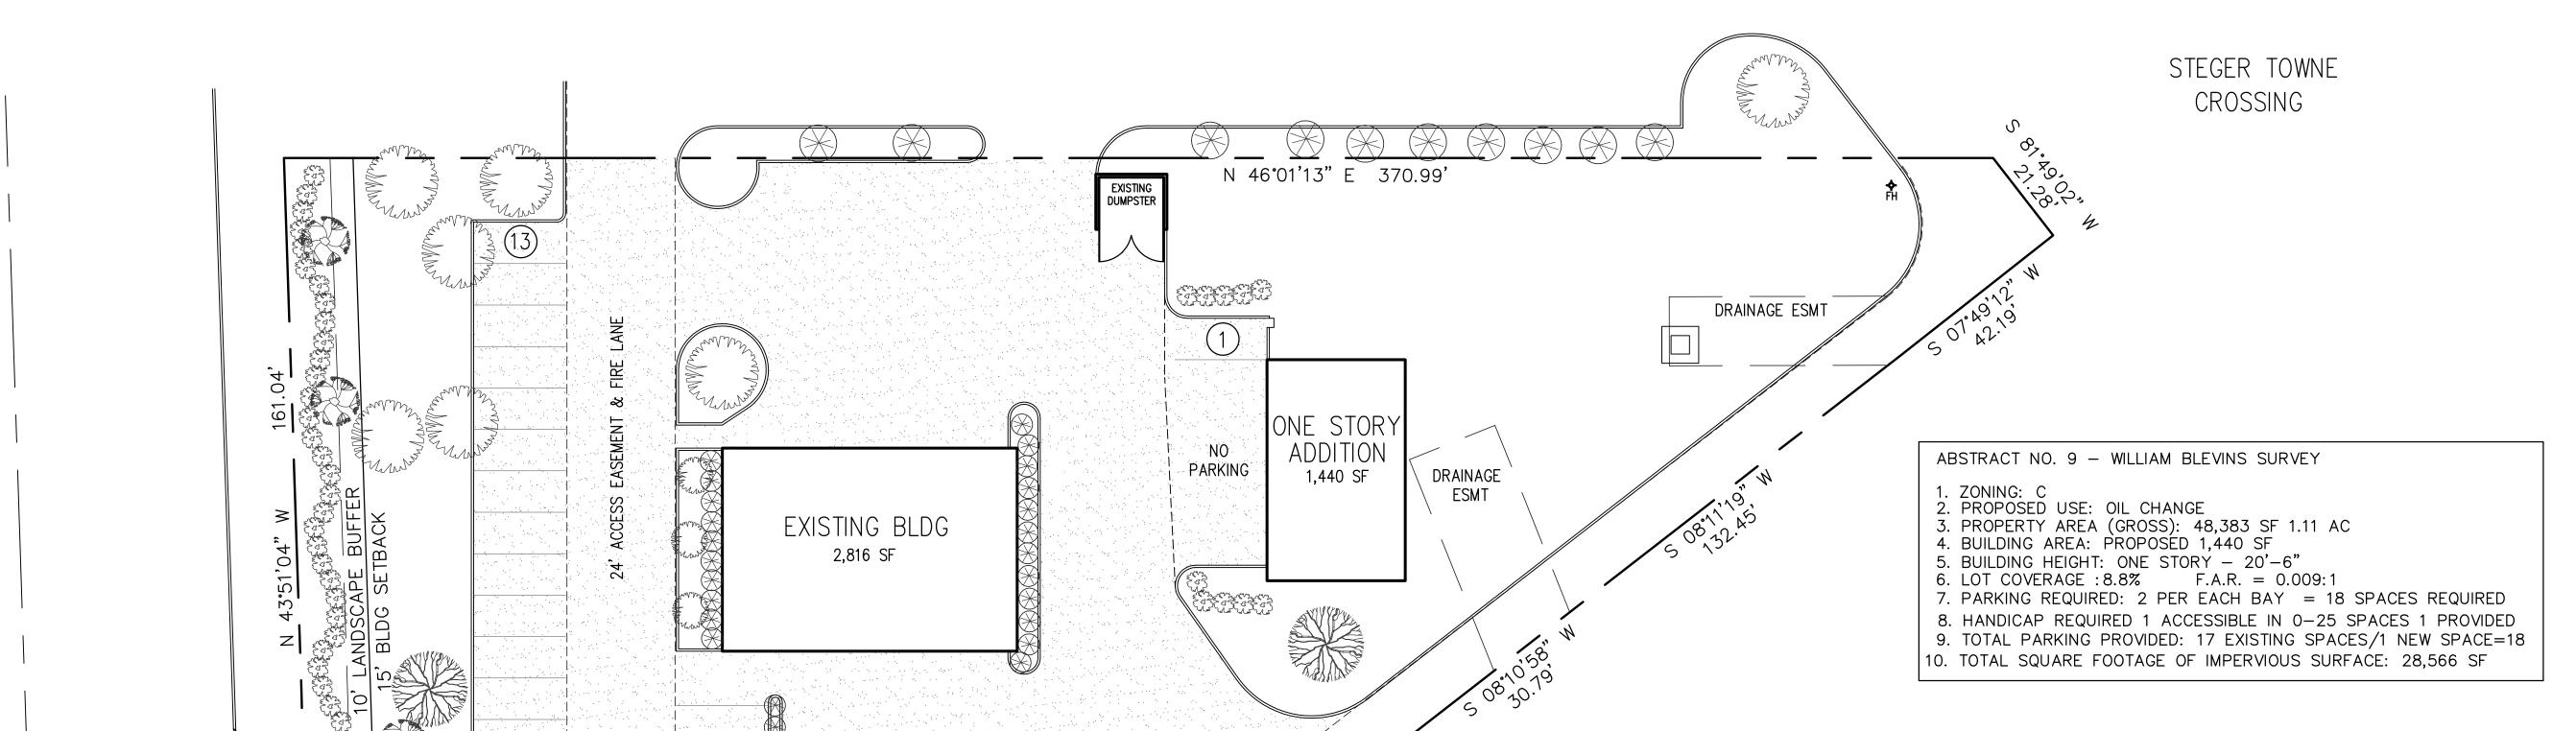


= 57.98

HORIZON VILLAGE ADDITION

24' ACCESS EASEMENT & FIRE LANE

S 46°08'56" W 168.46'

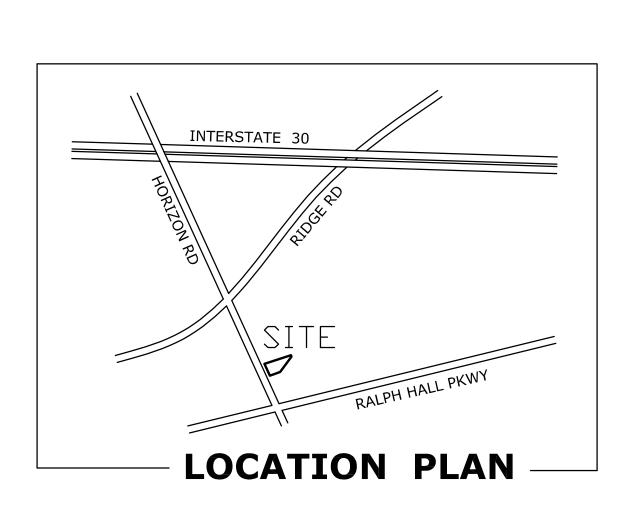

VISIBILITY TRIANGLE

	EXISTING	NEW	REQUIRED	PROVIDED
STREET TREES 1 CANOPY PER 50' LINEAR OF R.O.W.	4	1	3	5
LANDSCAPE BUFFER			25′	35′
MINIMUM LANDSCAPE AREA 25% REQUIRED			12,096 SF	19,817 SF
MINIMUM LOT AREA			10,000 SF	48,383 SF
MINIMUM LOT WIDTH			60 LF	161 LF
MINIMUM LOT DEPTH			100 LF	371 LF
MINIMUM FRONT SETBACK			15 LF	15 LF
MINIMUM REAR SETBACK			10 LF	10 LF
MINIMUM SIDE SETBACK			10 LF	10 LF
MINIMUM DISTANCE BETWEEN BUILDINGS			15 LF	54′ LF
MAXIMUM BUILDING HEIGHT			60 LF	20′ LF
MAXIMUM LOT COVERAGE			60%	9%
MAXIMUM FLOOR AREA RATIO		4:1	.009:1	
MAXIMUM IMPERVIOUS AREA			85%	59%

RED BUD (3) 4' HIGH @ INSTALLATION

LIVE OAKS (2)

CALIPER EXISTING TREE TO REMAIN (7)

INSTALLED WITH A MIN. 4"

EXISTING SHRUB (40)

NEW INDIAN HAWTHORNE (46) PLANTS SHALL BE A MINIMUM OF 3-GALLONS & SHALL CREATE A MINIMUM 2' TALL SCREEN WITHIN TWO YEARS OF PLANTING. SHALL BE PLANTED @ 36" O.C.

ALL REQUIRED LANDSCAPE AND SCREENING SHALL BE MAINTAINED IN A HEALTHY MANOR OR REPLACED AS NEEDED. ALL AREAS NOT SHOWN AS SPECIFIC PLANT MATERIAL SHALL BE SOD, BERMUDA.

IN ORDER TO MEET BUDGET TREES SPECIFIED MAY NOT BE USED OTHER TREES FROM THE APPROVED CITY OF ROCKWALL PLANT LIST MAY BE SUITABLE FOR SUBSTITUTION. REQUIRED LANDSCAPE AREAS SHALL BE IRRIGATED BY AN AUTOMATIC UNDERGROUND IRRIGATION SYSTEM. SYSTEM SHALL HAVE FREEZE GUARD AND RAINSTAT.

CONTRACTOR SHALL SUPPLY SLEEVES AS NEEDED FOR IRRIGATION.

TREES AND PLANTS SHALL BE PLANTED NO CLOSER THAN WITHIN 4' OF CURB AT PARKING SPACES AND NO CLOSER THAN 5' FROM ANY WATER, SEWER, OR STORM SEWER LINES. ALL CONCRETE PAVING SHALL HAVE A 6" CURB


HORIZON VILLAGE

BEING A 1.11 AC. TRACT OF LAND SITUATED IN THE HORIZON VILLAGE ADDITION BLOCK 1 LOT 4

IN THE CITY OF ROCKWALL, ROCKWALL COUNTY, TEXAS

OWNER IYM AUTOMOTIVE INC. 2581 HORIZON ROAD ROCKWALL, TEXAS 75032

CASE #SP2019-035

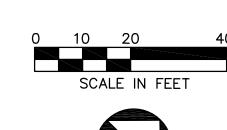



PRICING & CONSTRUCTION GENERAL NOTES:

 THESE DRAWINGS ARE DIAGRAMMATIC IN NATURE AND ARE NOT INTENDED TO INDICATE EACH AND EVERY FITTING, OFFSET, OR OTHER APPURTENANCE NECESSARY TO COMPLETE THE SYSTEM.

2. IT IS THE SUBCONTRACTOR'S RESPONSIBILITY TO REVIEW THE DOCUMENTS AND INCLUDE ALL NECESSARY ITEMS TO PROVIDE A COMPLETE OPERATIONAL SYSTEM.

3. ANY DISCREPANCIES NOTED BY THE SUBCONTRACTOR SHALL BE BROUGHT TO THE ATTENTIONS OF THE ARCHITECT (IN WRITING) BEFORE BIDDING THIS PROJECT.

AFTER BIDS ARE TURNED IN, THE SUBCONTRACTOR SHALL COMPLETE THE SYSTEMS AT NO ADDITIONAL COST.

5. PLUMBING, MECHANICAL, AND ELECTRICAL SUBCONTRACTORS ARE RESPONSIBLE FOR COORDINATING ALL COMPONENTS TO INSURE COMPLETE AND WORKING SYSTEMS EACH SUBCONTRACTOR SHALL REVIEW ALL DRAWNES FOR COMPLANCE.

6. THE ARCHITECT WILL BE RESPONSIBLE TO DETERMINE WHICH TRADE SHALL PROVIDE AND INSTALL ANY COMPONENTS MISSED FOR WORKING SYSTEMS AS NEEDED.

© COPYRIGHT 2019 MERSHAWN ARCHITECTS, INC. NO PRINTING OR COPING IS ALLOWED WITHOUT PERMISSION FROM MERSHAWN.

Scale: 1" = 20'-0"MM/DD/YEAR Project No.: AAAAAA Designed: GW Drawn: GW

Checked: WM SHEET