

Michael Gregory Legg NCARB, AIA, RIBA, SACAP 238 Red Hawk Ridge San Antonio, Texas 78258 ph. 210-416 4935 michael@mlarchitecture.info




DRAWING COORDINATION Architectural, Landscape, Civil, Structural, Mechanical and Electrical drawings are interrelated General Contractor and all Sub Contractors shall review and coordinate the entire set of

SCALE: AS NOTED

PROJECT NO. 02-10-21

A1.0

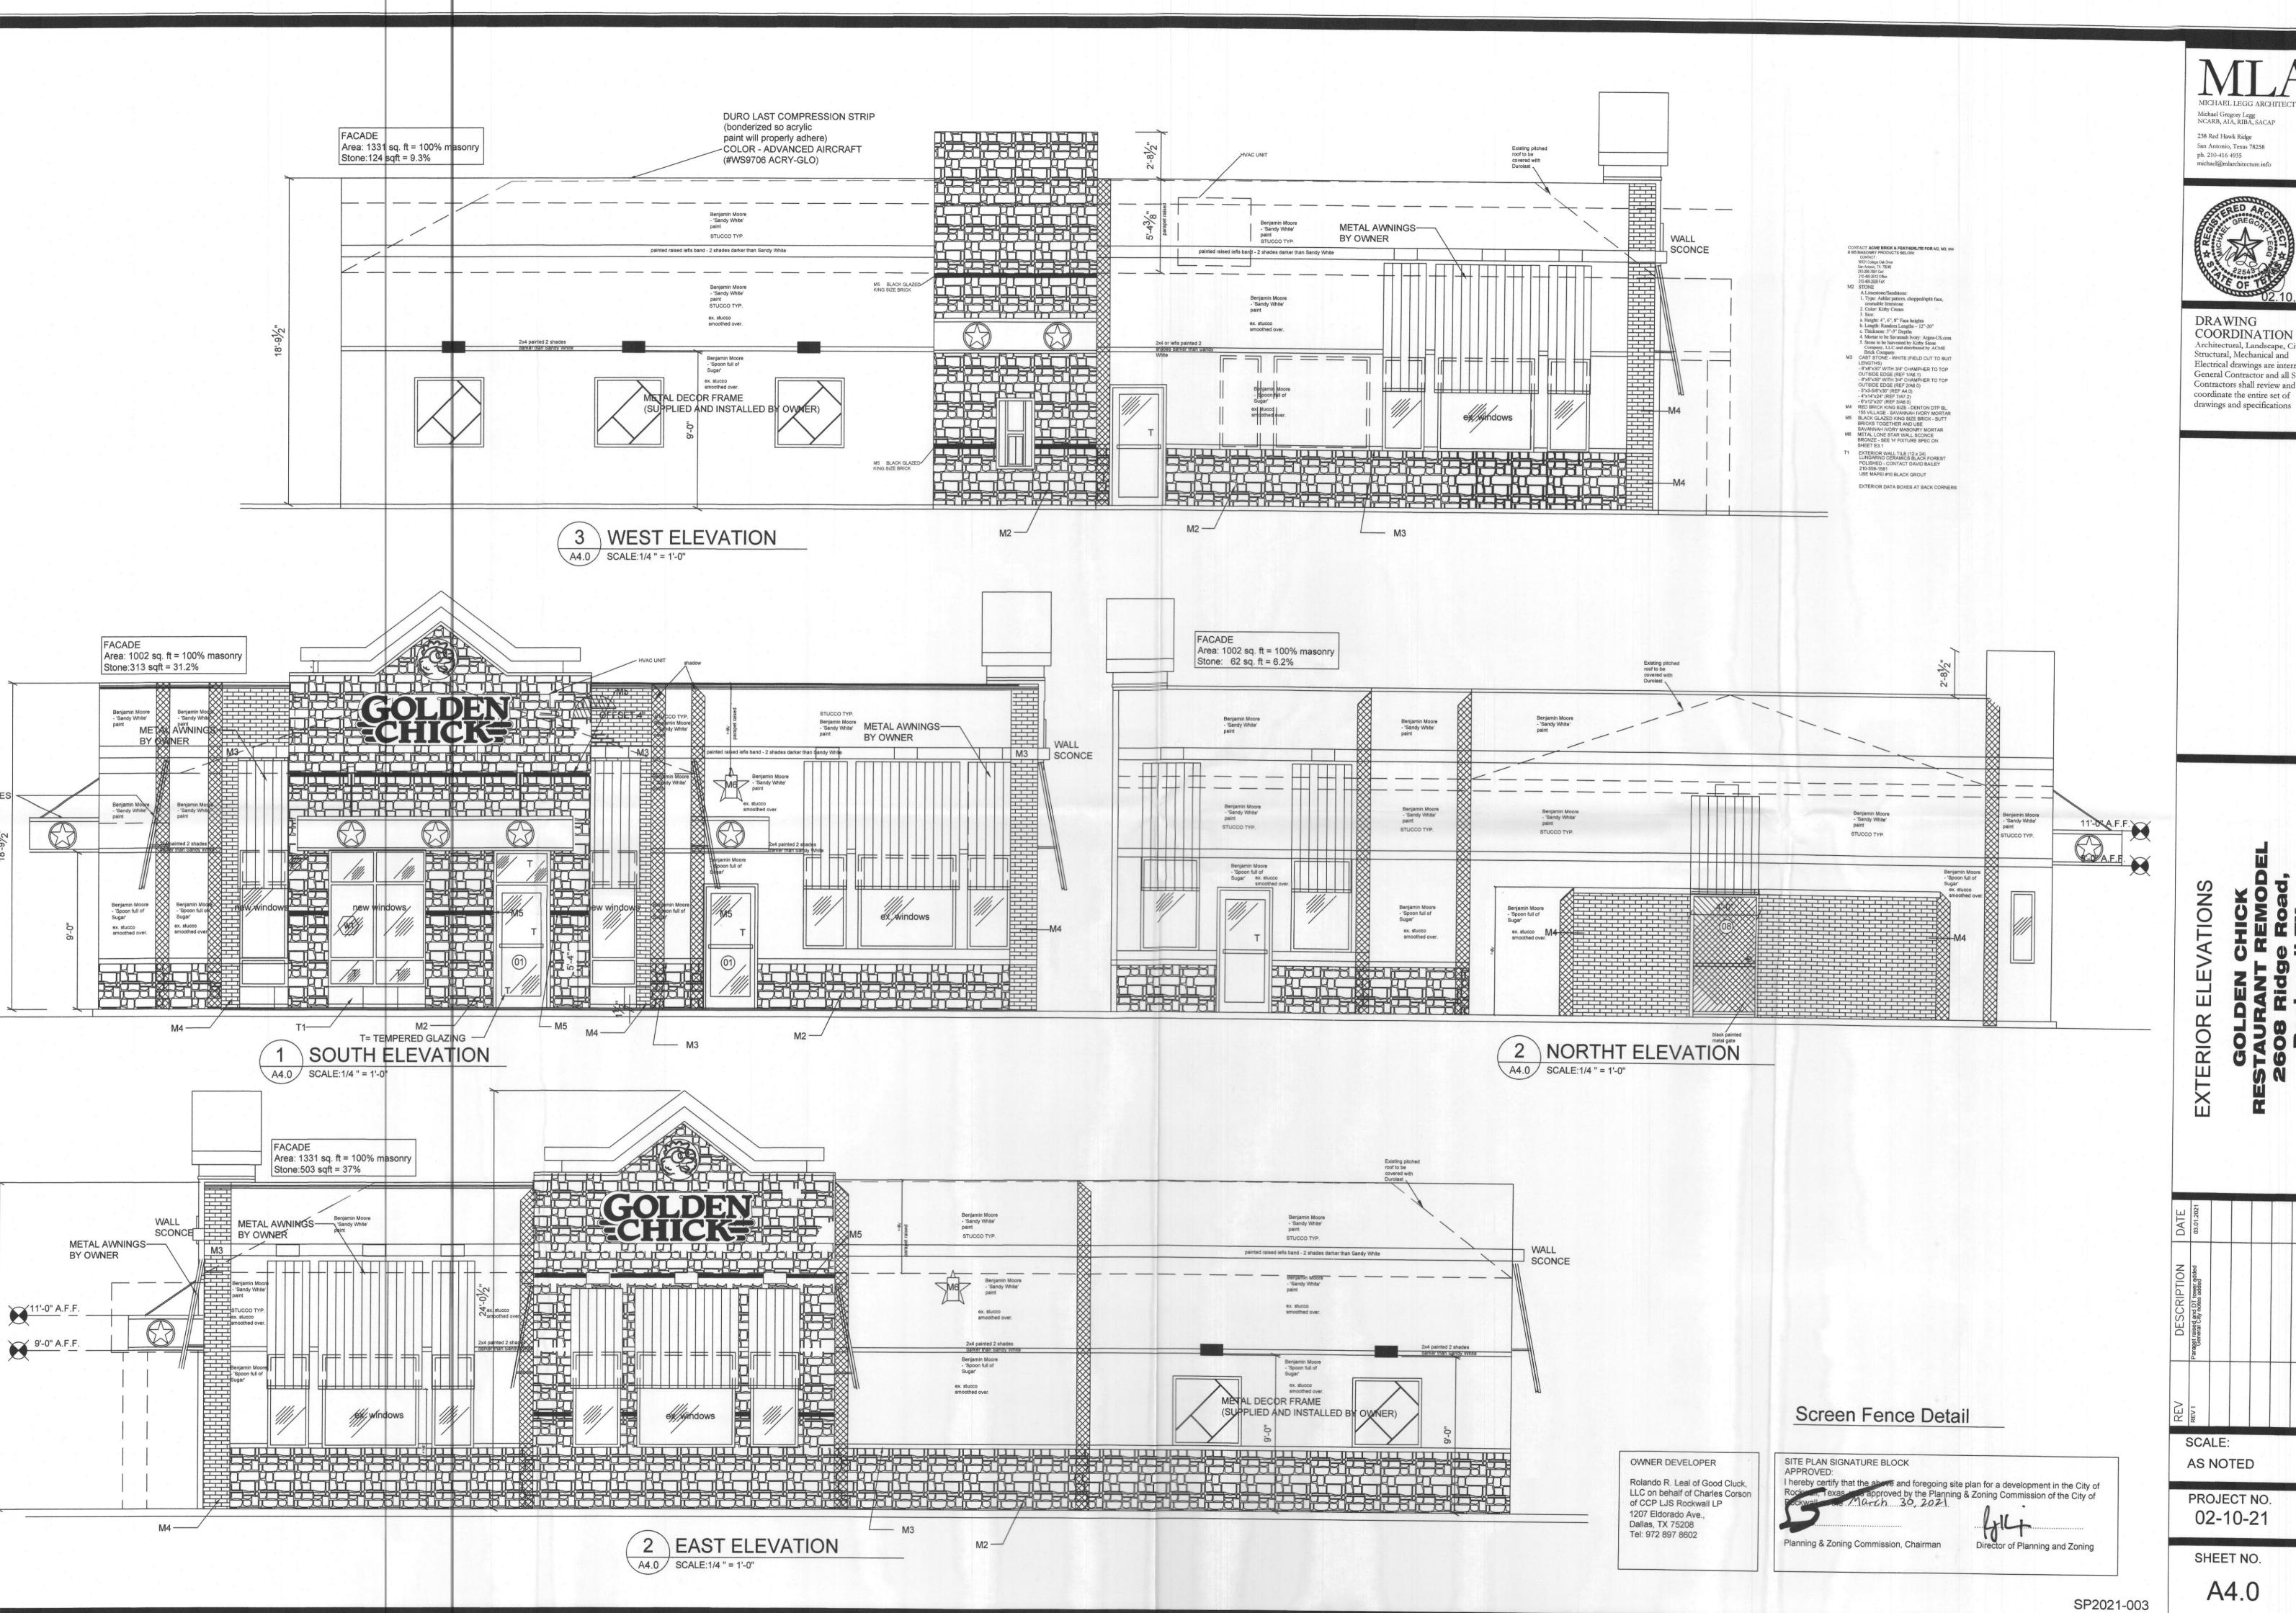



MICHAEL LEGG ARCHITECTURE



COORDINATION Architectural, Landscape, Civil, Structural, Mechanical and Electrical drawings are interrelated General Contractor and all Sub Contractors shall review and

coordinate the entire set of

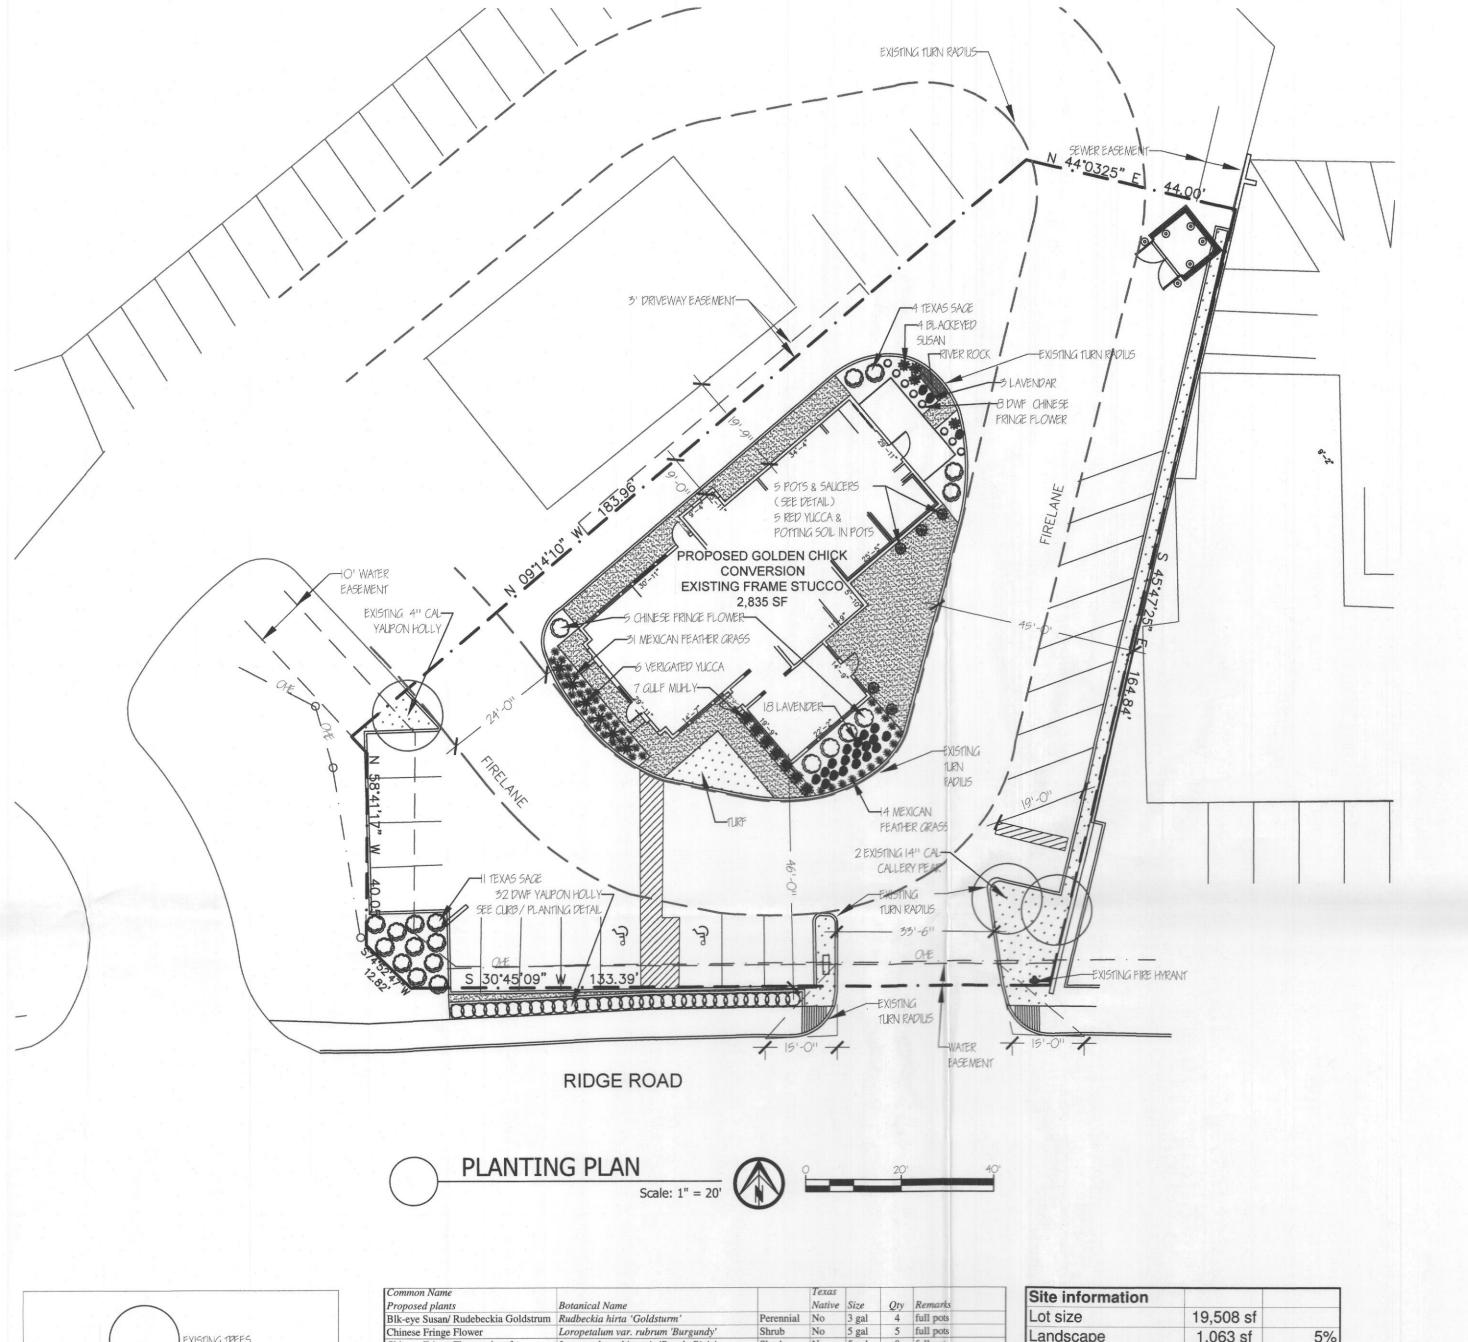

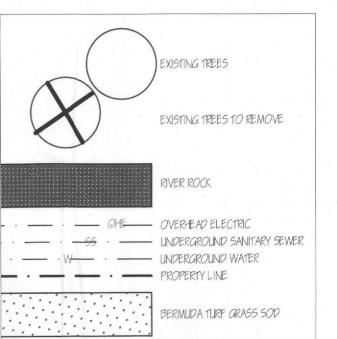

DRAWING KEY

Common Name			Texas	0:	0	p
Proposed plants	Botanical Name			Size	Qty	Remarks
Blk-eye Susan/ Rudebeckia Goldstrum		Perennial	No	3 gal	4	full pots
Chinese Fringe Flower	Loropetalum var. rubrum 'Burgundy'	Shrub	No	5 gal	5	full pots
Chinese Fringe Flower, dwarf	Loropetalum chinensis 'Purple Pixie'	Shrub	No	5 gal	8	full pots
Dwarf Yaupon Holly	Ilex vomitoria 'Nana'	Shrub	Yes	5 gal	32	full pots
Gulf Muhly	Muhlenbergia capillaris	Grass	Yes	3 gal	7	full pots
Lavendar, English 'Munstead'	Lavandula angustifolia 'Munstead'	Herb	No	1 gal	21	full pots
Mexican Feather Grass	Nassella tenuissima	Grass	Yes	1 gal	45	full pots
Red Yucca	Hesperaloe parviflora	Shrub-like	Yes	5 gal	5	full pots
Texas Sage, Compact	Leucophyllum frutescens 'Compactum'	Shrub	Yes	5 gal	15	full pots
Variegated Yucca (Adams Needle)	Yucca Filamentosa	Shrub	No	5 gal	6	full pots
Bermuda grass sod	Tiff 419		sf	140		
River Rock	New Mexico, 4" depth		sf	20		
Metal edging	14 guage, 4" green		lin ft	90		
Ceramic Pot + saucer	Golden Chick Custom Mold - teal (see detail)		ea	5		
Potting soil			cu ft	7.5		
Crushed Rock - drainage rock for pots			cu ft	3		
Existing Plants						
Callery Pear	Pyrus calleryana	Tree	Yes	12" cal	2	
Yaupon Holly	Ilex vomitoria	Small tree	Yes	4" cal	1	
All proposed plants are low-water-use	nlants					

Site information		
Lot size	19,508 sf	
Landscape	1,063 sf	5%
Patio	598 sf	
Building size	2835 sf	
Parking spaces	25	

#### **Jurisdiction of Project**

REGULATORY AUTHORITIES:

CITY OF ROCKWALL PLANNING & ZONING 385 S. GOLIAD ST. ROCKWALL, TEXAS 75087 972.771.7745

TEXAS DEPARTMENT OF LICENSING AND REGULATION ELIMINATION OF ARCHITECTURAL BARRIERS E.O. THOMPSON STATE OFFICE BUILDING 920 COLORADO AUSTIN, TEXAS 78701 (512) 463-3211 (512) 475-2886 (FAX)

#### **Landscaping Requirements**

CITY OF ROCKWALL TREE PRESERVATION LANDSCAPE ORDINANCE ARTICLE VIII LANDSCAPE STANDARDS

NONCONFORMING SITE

STREET LANDSCAPING (133 LIN FT)
BUFFER STRIP ALONG PUBLIC STREET
REQUIRED: 10' WIDE PROVIDED: NONE

TREES - ONE LARGE TREE + 1 ORNAMENTAL TREE PER 50 LIN FT REQUIRED: 2.5 LARGE TREES PROVIDED: NONE - OVER HEAD WIRES & NO SPACE FOR PLANTING TREES A. PLANTING SCREEN FOR PARKING HEADLIGHTS PROVIDED: SHRUB ROW

REQUIRED LANDSCAPING
COMMERCIAL
REQUIRED: 20%
PROVIDED: 7.5%
LANDSCAPE CREDITS


LANDSCAPE CREDITS
RIGHT OF WAY LANDSCAPING + 2.5%
PARKING LOT SCREENING + 2.5%
XERISCAPING +2.5%

LANDSCAPE DOES NOT OBSTRUCT TRAFFIC VISIBILITY.

## **Irrigation Requirements**

UNDERGROUND AUTOMATIC SPRINKLING SYSTEM PROVIDED. EXISTING IRRIGATION SYSTEM. TO BE VERIFIED THAT THE EXISTING SYSTEM IS INSTALLED ACCORDING TO TCEQ LAWS AND REGULATIONS. THE SYSTEM SHALL INCLUDE A FREEZE-RAIN SENSOR.

### **Site Location**

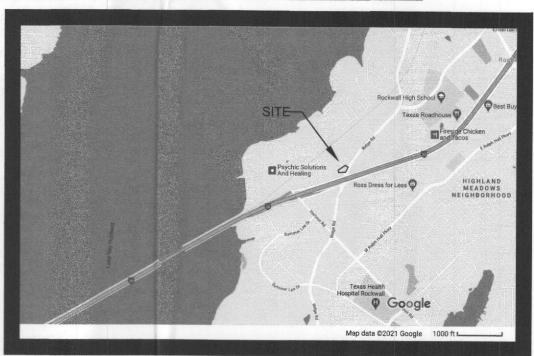

## **Owner & Professionals Information**

OWNER/DEVELOPER
ROLANDO R. LEAL OF GOOD CLUCK, LLC ON BEHALF OF
CHARLES CORSON OF CCP LJS ROCKWALL LP
1207 ELDORADO AVE., DALLAS, TX 75208
TEL: 972 897 8602


ARCHITECT
MLA - MICHAEL LEGG ARCHITECT
26116 HIGH TIMBER PASS
SAN ANTONIO, TEXAS 78260
ATTN: CAROL FELDMAN, 972-523-4944
ATTN: MICHAEL LEGG, 210-416-4935

CAROL@FELDMANDESIGN.COM

SITE	<b>PLAN</b>	SIGNATURE	BLOCK	
ADDE	DOVE !	).		

I hereby certify that the above and foregoing site plan for a development in the City of Rockwall, Texas, was approved by the Planning & Zoning Commission of the City of Rockwall on the ...30,2021

5

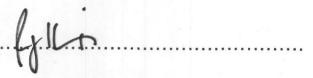

Planning & Zoning Commission, Chairman

Director of Planning and Zoning

SP2021-003 LANDSCAPE PLANTING PLAN

 NO. ITEM DESCRIPTION
 DATE:
 FELDMAN

 1. SUBMITTAL
 2/10/21
 PESIGN STUDIOS

 2. REVISED PER COMMENTS
 3/3/21
 PESIGN STUDIOS

 3.
 4.
 P.O. Box 852546, Richardson, Texas 750€

 5.
 Abbile: 972 525-4944

 6.
 Card@feldmandesian.com


These drawings have been prepared by or under the supervision of Carol Feldman, Registered Landscape Architect #2080, Licensed Irrigator LI #20245

GOLDEN CHICK RESAURANT
2608 RIDGE ROAD
ROCKWALL, TEXAS

GOLDEN ECHICK

SHEET NO.

L1.01

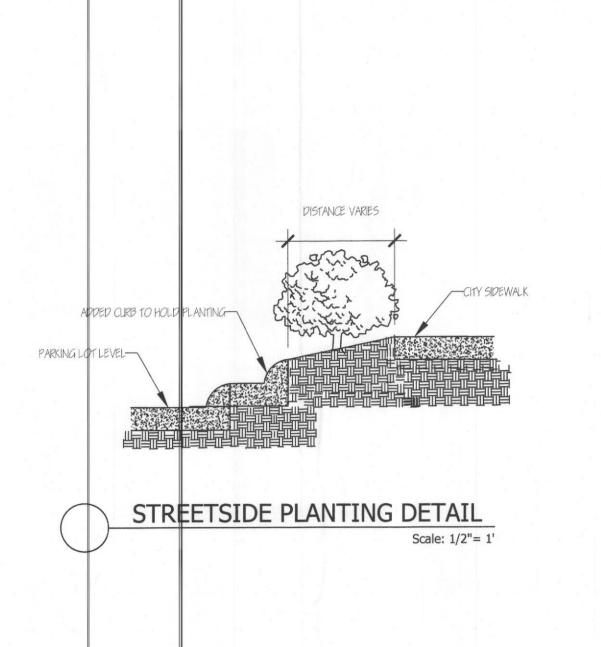

NOTE: PLACE 2 TREE STAKES ON SOUTH SIDE OF ROOT BALL AND ONE TREE STAKE ON NORTH SIDE OF ROOT BALL NOTE: TREE STAKES TO BE REMOVED BY OWNER 18 MONTHS AFTER INSTALLATIO TREE STAKE DETAIL

-PROTECTION (HOSE COVERED


-CLIT ROPES AT TOP OF ROOTBALL

REMOVE TOP 1/3 OF BURLAP AND ALL WIRE AND OTHER

NON-BIODEGRADABLE MATERIA

Scale: Not to scale

WIRE) AROUND TREE TRUNK

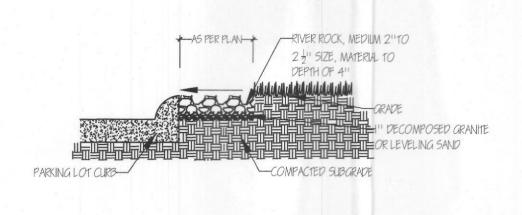

Scale: 1/2"= 1'

RIVER ROCK

PLANT SHRUB WITH TOP OF ROOTBALL LEVEL WITH EXISTING GRADE FORM SALICER WITH 4" EXISTING TOPSOIL

BACKFILL WITH ORIGINAL SOIL, WATER-

THOROUGHLY TO REMOVE AIR POCKETS

NOTE: FOR ROOT-BOUND PLANTS, LOOSEN ROOTS AT OLITER E PLANT SHRUB WITH TOP O ROOTBALL LEVEL WITH EXISTING GRADE -EXISTING GRADE PLANT INTO TILLED AND AMENDED SOIL

SHRUB & ORNAMENTAL GRASS PLANTING DETAIL

PERENNIAL PLANTING DETAIL

Scale: Not to scale

SECTION 02910 - SOIL PREPARATION PART 1 - GENERAL

DESCRIPTION

PROVIDE COMPLETE GRADING AND SOIL PREPARATION, INCLUDING AMENDMENTS, AS SPECIFIED HEREIN.

EXAMINE SITE TO VERIFY REQUIRED ROUGH GRADING HAS BEEN COMPLETED CORRECTLY PRIOR TO BED PREPARATION WORK. 2. EXAMINE SITE TO VERIFY THAT ALL INVASIVE PLANTS AND THEIR ROOTS HAVE BEEN REMOVED PRIOR TO BED REPARATION WORK.

**APPROVALS** 1. ALL 'APPROVED EQUAL' MATERIALS MUST BE APPROVED BY LANDSCAPE ARCHITECT.

PART 2 - PRODUCTS MATERIALS

COMPOST:

1.1. COTTON BUR COMPOST SHALL BE SUPPLIED BY: GREENSENSE COMPOST, GARLAND TX. OR, CLEAR FORK MATERIALS, ALEDO, TX, OR APPROVED EQUAL

. FERTILIZERS AND SUPPLEMENTS 2.1. A 6-2-4 GRANULAR FERTILIZER WITH A WATER SOLUBLE \$LOW RELEASE ORGANIC BASE SUCH AS GREENSENSE, OR SUSTANE. OR APPROVED EQUAL.

3.1. SHALL BE SHREDDED HARDWOOD MULCH, SHREDDED CEDAR MULCH, SHREDDED NATIVE MULCH, OR APPROVED EQUAL.

PART 3 - EXECUTION

BED PREPARATION AND PREPARATION FOR SOD INSTALLATION GENERAL 1.1. INSPECT ALL EXISTING CONDITIONS AND OTHER ITEMS OF WORK

PREVIOUSLY COMPLETED. DO NOT PROCEED UNTIL DEFECTS ARE 1.2. INSPECT THAT ALL INVASIVE PLANTS AND THEIR ROOTS HAVE BEEN

REMOVED COMPLETELY. 1.3. ALL AREAS TO BE PREPARED WITH ORGANIC TECHNIQUES DNLY.

SHRUB BEDS: 2.1. BREAK UP AND TILL EXISTING SOIL TO A DEPTH OF 6 INCHES, ADD A 3 INCH LAYER OF COMPOST TO THE BEDS,

TILL EXISTING SOIL AND COMPOST TOGETHER TO A TOTAL OVERALL DEPTH OF 8 INCHES. 2.4. RAKE OUT ROCKS AND CLODS AND FINE GRADE THE BEDS TO DRAIN IN APPROPRIATE DIRECTIONS.

2.5. TOP-DRESS BED WITH A 3 INCH LAYER OF MULCH AFTER PLANTING. 3. SOD AND SEED AREAS 3.1. LIGHTLY CULTIVATE COMPACTED SOIL AND RAKE THE SOIL SMOOTH. 3.2. ADD 1/2 INCH COMPOST TO ALL AREAS.
3.3. FINE GRADE TO DRAIN IN APPROPRIATE DIRECTIONS. ADD 1/2 INCH COMPOST TO ALL AREAS.

END OF SECTION 02910

GENERAL LANDSCAPE

1. LANDSCAPE CONTRACTOR IS RESPONSIBLE FOR LOCATING AL UNDERGROUND UTILITIES AND STRUCTURES WHETHER OR NOT SHOWN ON THE PLANS, AND SHALL BE RESPONSIBLE FOR DAMAGE TO SAID UTILITIES OR STRUCTURES CAUSED BY HIS/HER CREW AND SUBCONTRACTORS.

2. NO PLANTING TO TAKE PLACE UNTIL OWNER HAS INSPECTED AND APPROVED THE BED PREPARATION.

3. NO PLANTING TO TAKE PLACE UNTIL OWNER HAS INSPECTED AND APPROVED ALL PLANT MATERIAL AND ALL PLANT PLACEMENT. FIELD ADJUSTMENTS OF PLANT LOCATIONS TO BE COORDINATED WITH OWNER.

4. ALL CANOPY AND ORNAMENTAL TREES TO BE STAKED (SEE DETAIL.) 5. ALL LAWN AND LANDSCAPE BED AREAS ARE TO BE SEPARATED BY 14 GAUGE EDGING UNLESS OTHERWISE NOTED ON THE PLANS.

SECTION 02915 - LANDSCAPE PLANTING

PART 1 - GENERAL A. SPECIAL CONDITIONS

1. COMPLY WITH APPLICABLE FEDERAL, STATE, COUNTY AND LOCAL REGULATIONS GOVERNING LANDSCAPE MATERIALS AND WORK.

2.EMPLOY ONLY EXPERIENCE PERSONNEL FAMILIAR WITH REQUIRED WORK. PROVIDE ADEQUATE SUPERVISION BY A QUALIFIED FOREMAN WITH A MINIMUM OF TEN(10) YEARS EXPERIENCE WITH PROJECTS OF SIMILAR COMPLEXITY.

REQUIRED MATERIAL IS NOT OBTAINABLE, SUBMIT PROOF OF NON-AVAILABILITY TO OWNER'S REPRESENTATIVE.

4.PROVIDE QUANTITY, SIZE, GENUS, SPECIES AND VARIETY OF TREES AND SHRUBS INDICATED AND SCHEDULED FOR LANDSCAPE WORK WHICH COMPLY WITH APPLICABLE REQUIREMENTS OF ANSI Z60.1 AMERICAN STANDARD FOR NURSERY STOCK, AND ANY APPLICABLE STATE AND FEDERAL LAWS CONCERNING DISEASE AND INSECT INFESTATION. B.REFERENCE STANDARDS

1. AMERICAN STANDARD FOR NURSERY STOCK, ANSI Z60.1, 2014 BY AMERICAN NATIONAL STANDARDS INSTITUTE, INC. 2. SHINNERS & MAHLER'S, ILLUSTRATED FLORA OF NORTH CENTRAL TEXAS, BOTANICAL RESEARCH INSTITUTE OF TEXAS (BRIT), FORT WORTH, TEXAS,

3. HORTUS THIRD, CORNELL UNIVERSITY, 1967.

C.PREPARATION 4. COORDINATION WITH BUILDING AND ENGINEERING PROJECT ACTIVITIES. 5. COORDINATE THE WORK OF THIS SECTION WITH THAT OF REGULAR AND EMERGENCY WATER UTILITY ACTIVITIES ON THE SITE.

6. COORDINATION WITH IRRIGATION SYSTEM: 6.1. THE UNDERGROUND IRRIGATION SYSTEM MUST BE INSTALLED PRIOR TO COMMENCEMENT OF THE PLANTING OPERATIONS. 6.2. THE IRRIGATION SYSTEM SHALL BE OPERATIONAL AT THE TIME THAT PLANTING OPERATIONS COMMENCE.

6.3. COORDINATE WORK WITH THE IRRIGATION CONTRACTOR TO PREVENT DAMAGE TO THE IRRIGATION SYSTEM.

D.ALL PLANT MATERIALS FOR THIS PROJECT SHALL BE NURSERY-GROWN, INCLUDING TREES. 1. CONTAINER GROWN PLANTS SHALL HAVE BEEN STEPPED-UP AS

NECESSARY TO PREVENT ROOT GIRDLING. 2. CONTAINER GROWN PLANTS SHALL HAVE BEEN IN THE CONTAINER FOR A MINIMUM OF SIX (6) MONTHS PRIOR TO DELIVERY TO THE SITE TO ENSURE ADEQUATE ROOT DEVELOPMENT.

3. THE 'ROOT FLARE' OF ALL TREES AND SHRUBS SHALL NOT BE COVERED WITH SOIL THE FOLLOWING TREE CARE PROCEDURES SHALL BE ADHERED TO: 1. DO NOT MAKE FLUSH CUTS OR LEAVE STUBS WHEN PRUNING. LEAVE

THE BRANCH COLLAR INTACT. 2.DO NOT USE ANY TYPE OF PRUNING PAINT ON WOUNDS. 3.DO NOT USE ANY TYPE OF TREE WRAP, EXCEPT, TRUNKS MAY BE WRAPPED WITH BURLAP DURING PLANTING OPERATIONS ONLY. 4. STAKE AND GUY ANY TREES AS PER DETAIL. THE CONTRACTOR WILL BE RESPONSIBLE FOR THE REMOVAL OF STAKES AND GUYS AFTER TREES

HAVE BEEN IN THE GROUND 6 MONTHS, AND BEFORE THE ONE YEAR ANNIVERSARY OF PLANTING. 5.DO NOT HANDLE ANY TREE BY ITS TRUNK. ANY TREE HANDLED IN SUCH A MANNER SHOULD BE REJECTED.

F. WARRANTEE 1. UNCONDITIONALLY WARRANT ALL PLANTS FOR A PERIOD OF ONE (1) YEAR AFTER THE DATE OF INSTALLATION INITIAL ACCEPTANCE. REPLACE MATERIALS NOT IN VIGOROUS, THRIVING CONDITION AS SOON AS WEATHER PERMITS AFTER NOTIFICATION BY OWNERS THAT THE PLANTS HAVE DIED OR ARE OTHER WISE NOT ACCEPTABLE. GUARANTEE REPLACEMENT PLANTS FOR ONE YEAR, STARTING FROM THE DATE REPLACEMENT IS

2. WARRANTY EXCLUDES REPLACEMENT OF PLANTS BECAUSE OF INJURY BY STORM, NATURAL DROUGHT, DROWNING, HAIL FOR FREEZING, IF REASONABLE CARE WAS TAKEN TO ADEQUATELY PROTECT THE MATERIAL, AND IN THE OPINION OF THE OWNER'S REPRESENTATIVE THAT THE PROBLEM OCCURRED AFTER THE DATE OF INITIAL ACCEPTANCE.

PART 3 - EXECUTION

2X ROOT BALL WIDTH

TREE PLANTING

PLANT TREE WITH ROOT FLARE LEVEL-

FORM SAUCER WITH 414

BACKFILL WITH ORIGINAL SOIL, WATER-THOROUGHLY TO REMOVE AIR POCKETS

EXISTING TOPSOIL TREE STAKE KIT, TYP

WITH FINISHED GRADE

PREPARATION FOR PLANT MATERIAL INSTALLATION EXAMINE THE SUB-GRADE UPON WHICH THE WORK IS TO BE PERFORMED, VERIFY GRADE ELEVATIONS AND VERIFY THAT BEDS HAVE BEEN LEFT LOW BY OTHER TRADES. OBSERVE THE CONDITIONS UNDER WHICH THE WORK IS TO BE PERFORMED AND CONFIRM THAT UNSATISFACTORY CONDITIONS HAVE BEEN CORRECTED PRIOR TO PROCEEDING.

TIME OF PLANTING 1. CARE IS TO BE TAKEN SO THAT NO PLANTS SIT IN POTS IN THE SUMMER HEAT FOR MORE THAN 1 HOUR. IF PLANTING DURING HOT SEASONS (NOT PREFERRED) PLANTING IS TO BE DONE IN SMALL SECTIONS WITH STOCKPILED PLANTS TO BE PROTECTED FROM THE SUMMER HEAT (SHADE AREAS).

TREE PLANTING . STAKE LOCATIONS FOR TREES PRIOR TO DIGGING HOLES. 2. DIG PITS WITH ROUGH SIDES AND WHICH HAVE TAPERED WALLS, A MINIMUM OF TWICE THE WIDTH OF THE TREE BALL. A PEDESTAL SHOULD BE LEFT IN THE CENTER OF THE HOLE AND THE TREE BALL SET UPON

THAT PEDESTAL 3. SET PLANTS IN THE CENTER OF THE HOLE AND ON THE PEDESTAL, PLUM AND VERTICAL, AND AT SUCH A DEPTH THAT THE CROWN OF THE TREE BALL WILL BE LEVEL WITH THE SURROUNDING GRADE.

4. ALL PLANTS SHALL BE SET TO MEET THE SAME RELATIONSHIP TO THE FINISHED GRADE OF THE SURROUNDING SOIL THAT THEY BORE TO PREVIOUS EXISTING GRADE OF SOIL.

5. BACKFILL WITH EXISTING TOPSOIL AND WATER IMMEDIATELY. 6. FORM A SHALLOW BASIN SLIGHTLY LARGER THAN THE PIT TO FACILITATE

WATERING. REMOVE PRIOR TO MULCHING. 7. COVER ALL TREE BALLS WITH A MINIMUM OF 3 OF SPECIFIED MULCH. EXTEND MULCH OUT TO THE EDGE OF THE TREE PIT, BUT KEEP AWAY

8. ALL EXCAVATED MATERIAL UNACCEPTABLE FOR REUSE SHALL BE DISPOSED OF OFF SITE, OR AS DIRECTED BY THE OWNER.

SHRUBS, TALL GRASSES AND PERENNIAL PLANTING. 1. REMOVE CONTAINER AND SET PLANT MATERIAL AT SUCH A LEVEL THAT AFTER SETTLEMENT, THE CROWN OF THE BALL WILL BE AT FINISHED

2. GENTLY CUT OUTER ROOTS OF ANY ROOTBALLS THAT HAVE POT-BOUND PRIOR TO INSTALLATION.

3. COVER PLANTING BEDS WITH A MINIMUM 3 LAYER OF SPECIFIED MULCH. SOD PLANTING . LAY SOD IN AN ORDERLY MANNER TO COVER ALL BARE SOIL AREAS.

. WATER ALL AREAS OF THE SOD UNTIL THOROUGHLY WET. 3. ROLL SOD WITH A SOD ROLLER AFTER 24 HOURS AFTER LAYING AND WATERING SOD TO OBTAIN A UNIFORM, SMOOTH FINISH.

4. FILL JOINTS WITH COMPOST IF NECESSARY TO FORM A UNIFORM GRASS 5. KEEP SOD ADEQUATELY WATERED UNTIL SOD MAKES A FIRM CONNECTION TO THE SOIL.


SEED PLANTING 1. AREAS SHALL BE RAKED TO A DEPTH OF 1/2", SMOOTH AND FREE OF STONES AND DEBRIS.

APPLY SEED EVENLY AT THE RATE RECOMMENDED. 3. RAKE AND WATER TO ESTABLISH A FIRM CONNECTION OF THE SEED TO

THE SOIL. 4. KEEP SEED AREA MOIST (NOT WET) UNTIL SEED GERMINATES AND GRASS IS APPROX. 18" IN HEIGHT.

5. KEEP AREA ADEQUATELY WATERED UNTIL A STAND OF THE GRASS IS 6. RE-SEED TO ESTABLISH A THICK STAND OF GRASS IF NECESSARY.

END OF SECTION 02915

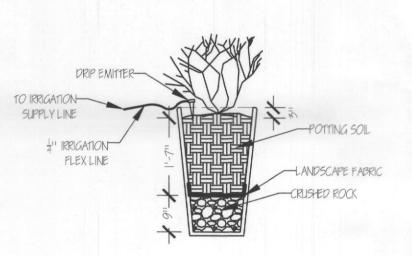


POTTING SOIL - VIGORO POTTING SOIL MIX

OR OTHER EQUAL POTTING SOIL MIX LANDSCAPE FABRIC - LANDSCAPE FABRIC BARRIER THAT ALLOWS WATER PENETRATION BUT BLOCKS SOIL SILT TO LAYER BELOW CRUSHED ROCK - CRUSHED LIMESTONE OR

POT PLANTING DETAIL Scale: 1/2"= 1'

OTHER 3" - 1" CRUSHED ROCK

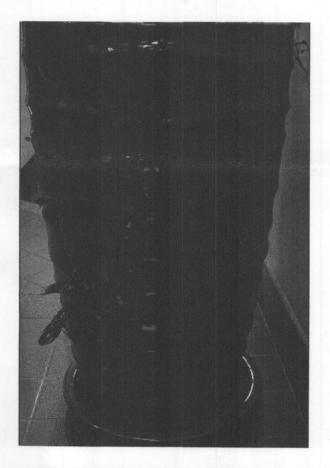

**CERAMIC POTS & SAUCERS** 


GOLDEN CHICK CUSTOM MOLD RIPPLE POT 32" TALL X 20" DIAMETER - TEAL COLOR 15" DIAMETER SAUCER (NOT SHOWN) AVAILABLE BY CONTACTING CORPORATE GOLDEN CHICK, RICHARDSON

# SITE PLAN SIGNATURE BLOCK

APPROVED:

I hereby certify that the above and foregoing site plan for a development in the City of Rockwall, Texas, was approved by the Planning & Zoning Commission of the City of Rockwall on the March 30, 2021



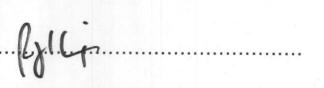

Director of Planning and Zoning

SP2021-003 LANDSCAPE DETAILS

These drawings have

been prepared by or under the supervision of Carol Feldman,

Registered Landscape Architect #2080, Licensed Irrigator LI #20245

2608 ROC

GOLDEN ECHICK

SHEET NO.

L1.02