
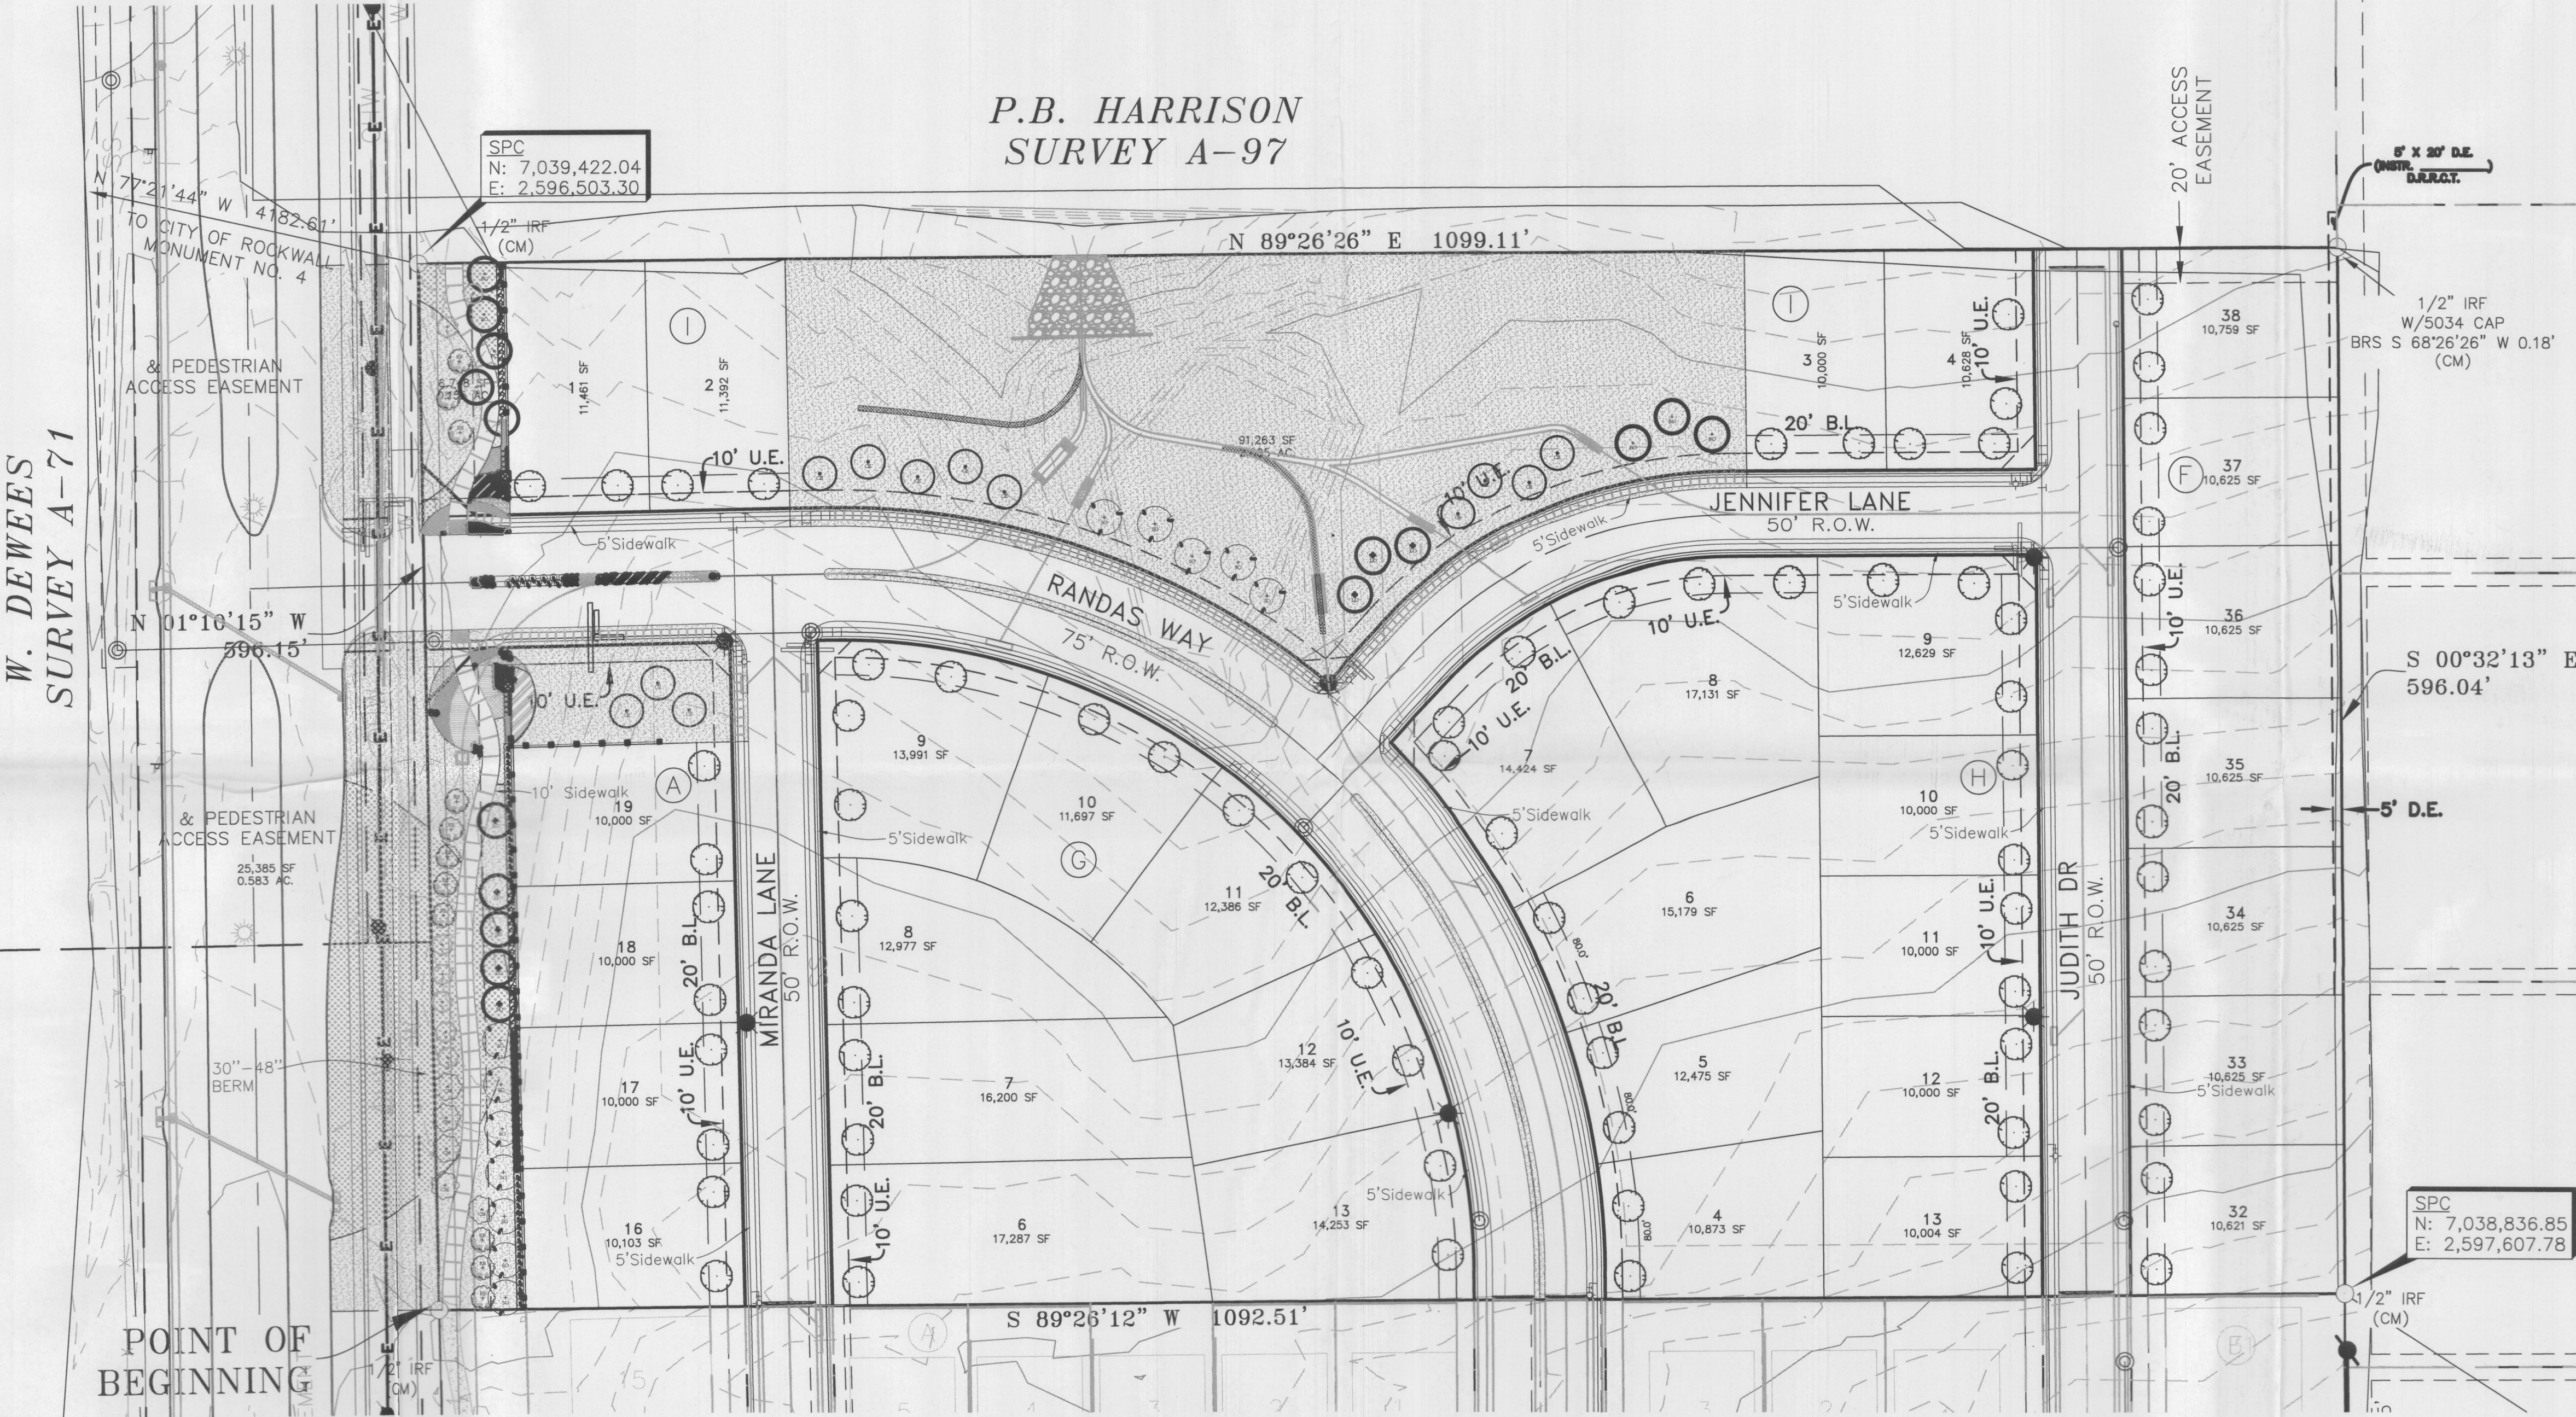


VICINITY MAP  
N.T.S.

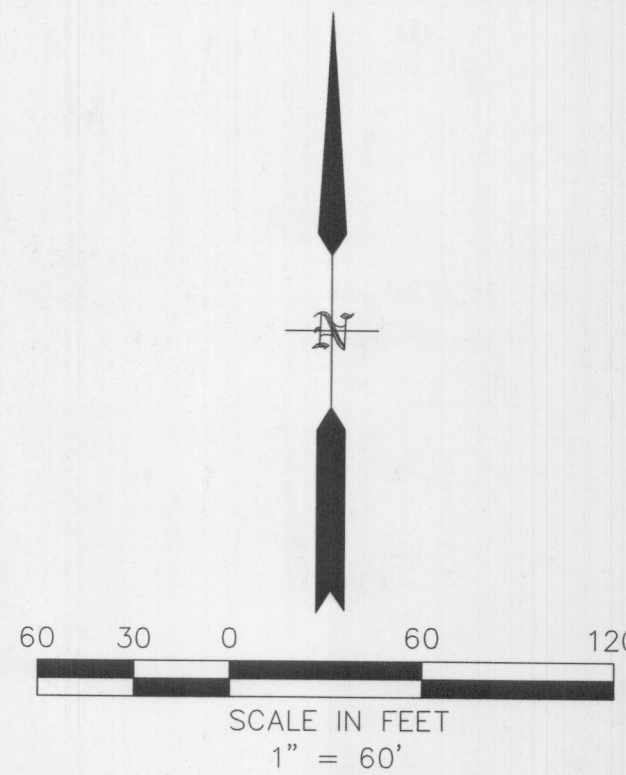

SADDLE STAR SOUTH PHASE 3  
PLANT LEGEND

- 8 - 4" LIVE OAK
- 12 - 4" SHUMARD OAK
- 8 - 4" BUR OAK
- 12 - 4" CEDAR ELM
- 9 - 2" TEXAS REDBUD
- 7 - 2" CHASTE TREE
- 4 - 2" NATCHEZ CRAPE MYRTLE
- 75 - 3" CANOPY TREE (BY BUILDER)

**LEGEND**

EXISTING TREE

PROPOSED 4" CANOPY TREE  
(Bald Cypress, Cedar Elm, Texas Red Oak, Homestead Elm, Lace Bark Elm, Alle Elm, Chinese Platichio, Shumard Oak, Sycamore, and Burr Oak)

PROPOSED 3" CANOPY TREE  
(Bald Cypress, Cedar Elm, Texas Red Oak, Homestead Elm, Lace Bark Elm, Alle Elm, Chinese Platichio, Shumard Oak, Sycamore, and Burr Oak)

PROPOSED 3" EASTERN RED CEDAR

PROPOSED 2" ORNAMENTAL TREE  
(Texas Redbud, Eve's Necklace, Mexican Plum, Downy Hawthorn, Grape Myrtle, Texas Mountain Laurel and Desert Willow)

- BERMUDA GRASS - 36,555 SF
- NATIVE GRAVEL - 730 SF
- BUFFALO GRASS - 108,346 SF
- WEeping LOVE GRASS - 380 G
- TEXAS RIVER ROCK MIX - 542 SF
- LIRIOPAPE GRASS - 111 G
- GULF MUHLY GRASS - 413 G
- OKLAHOMA MOSS BOULDERS - 4T

**LEGEND**

IRF IRON ROD FOUND

B.L. BUILDING SETBACK LINE

CM CONTROL MONUMENT

D.E. DRAINAGE EASEMENT

HOA HOMEOWNERS ASSOCIATION

S.V.E. 20'x20' SIDEWALK AND VISIBILITY EASEMENT

D.U.E. DRAINAGE & UTILITY EASEMENT

U.E. UTILITY EASEMENT

P.R.R.C.T. PLAT RECORDS ROCKWALL COUNTY, TEXAS

D.R.R.C.T. DEED RECORDS ROCKWALL COUNTY, TEXAS

BENCHMARK:  
BM#1 (#102)  
CIRS "ASC SURVEYING COMPANY" BEING IN THE NORTH MEDIAN OF JOHN KING BLVD. AND TO THE WEST OF THE MAIN ENTRANCE OF THE SUBJECT PROPERTY, AND BEING NORTH OF THE MEDIAN POINT 55'. ELEVATION = 531.58  
BM#2 (#104)  
CIRS "ASC SURVEYING COMPANY" BEING IN THE MEDIAN OF JOHN KING BLVD. AT THE TURN IN LANE FOR HAYS ROAD. THE MONUMENT #104 IS LOCATED 22' TO THE SOUTHWEST OF THE BEGINNING OF THE LEFT TURNING LANE ON JOHN KING BLVD. ELEVATION = 538.47  
BM#3 (#106)  
CIRS "ASC SURVEYING COMPANY" BEING IN THE MEDIAN OF JOHN KING BLVD. TO THE SOUTHEAST OF THE SUBJECT PROPERTY, AND BEING LOCATED 72.5' TO THE SOUTHEAST CORNER OF THE HEADWALL WITH AN 8'x8' BOX CULVERT. ELEVATION = 557.33'

SITE PLAN SIGNATURE BLOCK

APPROVED:  
I hereby certify that the above and foregoing site plan for a development in the City of Rockwall, Texas, was approved by the Planning & Zoning Commission of the City of Rockwall on the 16 day of May, 2024.

WITNESS OUR HANDS, this 16 day of May, 2024.

*[Signature]*  
Planning & Zoning Commission, Chairman

*[Signature]*  
Director of Planning and Zoning

SADDLE STAR PHASE 3 SITE PLAN DATA

- a. 14.995 Acres
- b. PD-79 Zoning
- c. 33 Dwelling Units
- d. 2.853 Acres Open Space
- e. All Common Areas/Open Space to be maintained by the H.O.A.
- f. Denotes Street Lights 20' Maximum Height
- g. Denotes Stop Sign & Street Names

ZONING DISTRICT: PD-79  
OPEN SPACE = 2.853 AC.  
33 DWELLING UNITS  
2.20 UNITS PER ACRE

OWNERS  
CDT ROCKWALL/2017, LLC  
6925 FM 2515  
KAUFMAN, TX 75142

LAND SURVEYOR  
R.C. MYERS SURVEYING, LLC  
488 ARROYO COURT  
SUNNYVALE, TX 75182  
(214) 532-0636  
FAX (972) 412-4875  
EMAIL: rcmysurveying@gmail.com  
FIRM NO. 10192300 JOB NO. 355

SITE PLAN

SADDLE STAR ESTATES  
SOUTH, PHASE THREE

33 SINGLE FAMILY LOTS  
3 COMMON AREA TRACT  
14.995 ACRES



SITUATED IN THE  
P.B. HARRISON SURVEY, A-97  
CITY OF ROCKWALL, ROCKWALL COUNTY, TEXAS  
ENGINEERING CONCEPTS & DESIGN, L.P.  
ENGINEERING/PROJECT MANAGEMENT/CONSTRUCTION SERVICES  
TEXAS FIRM REG. NO. 001145  
201 WINDCO CIRCLE, SUITE 200, WYLLIE, TX 75098  
(972) 941-8400 FAX (972) 941-8401

DATE: 01/14/2022

SP2021-034

Z:\PROJECTS\06828 Saddle Star South Ph3\dwg\plans\11-9-2021 6828 Site Plan



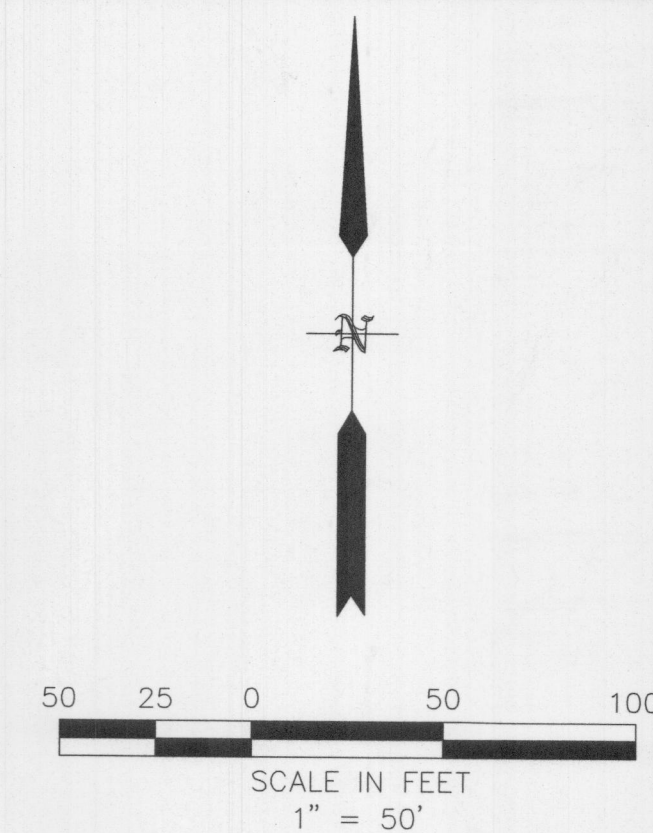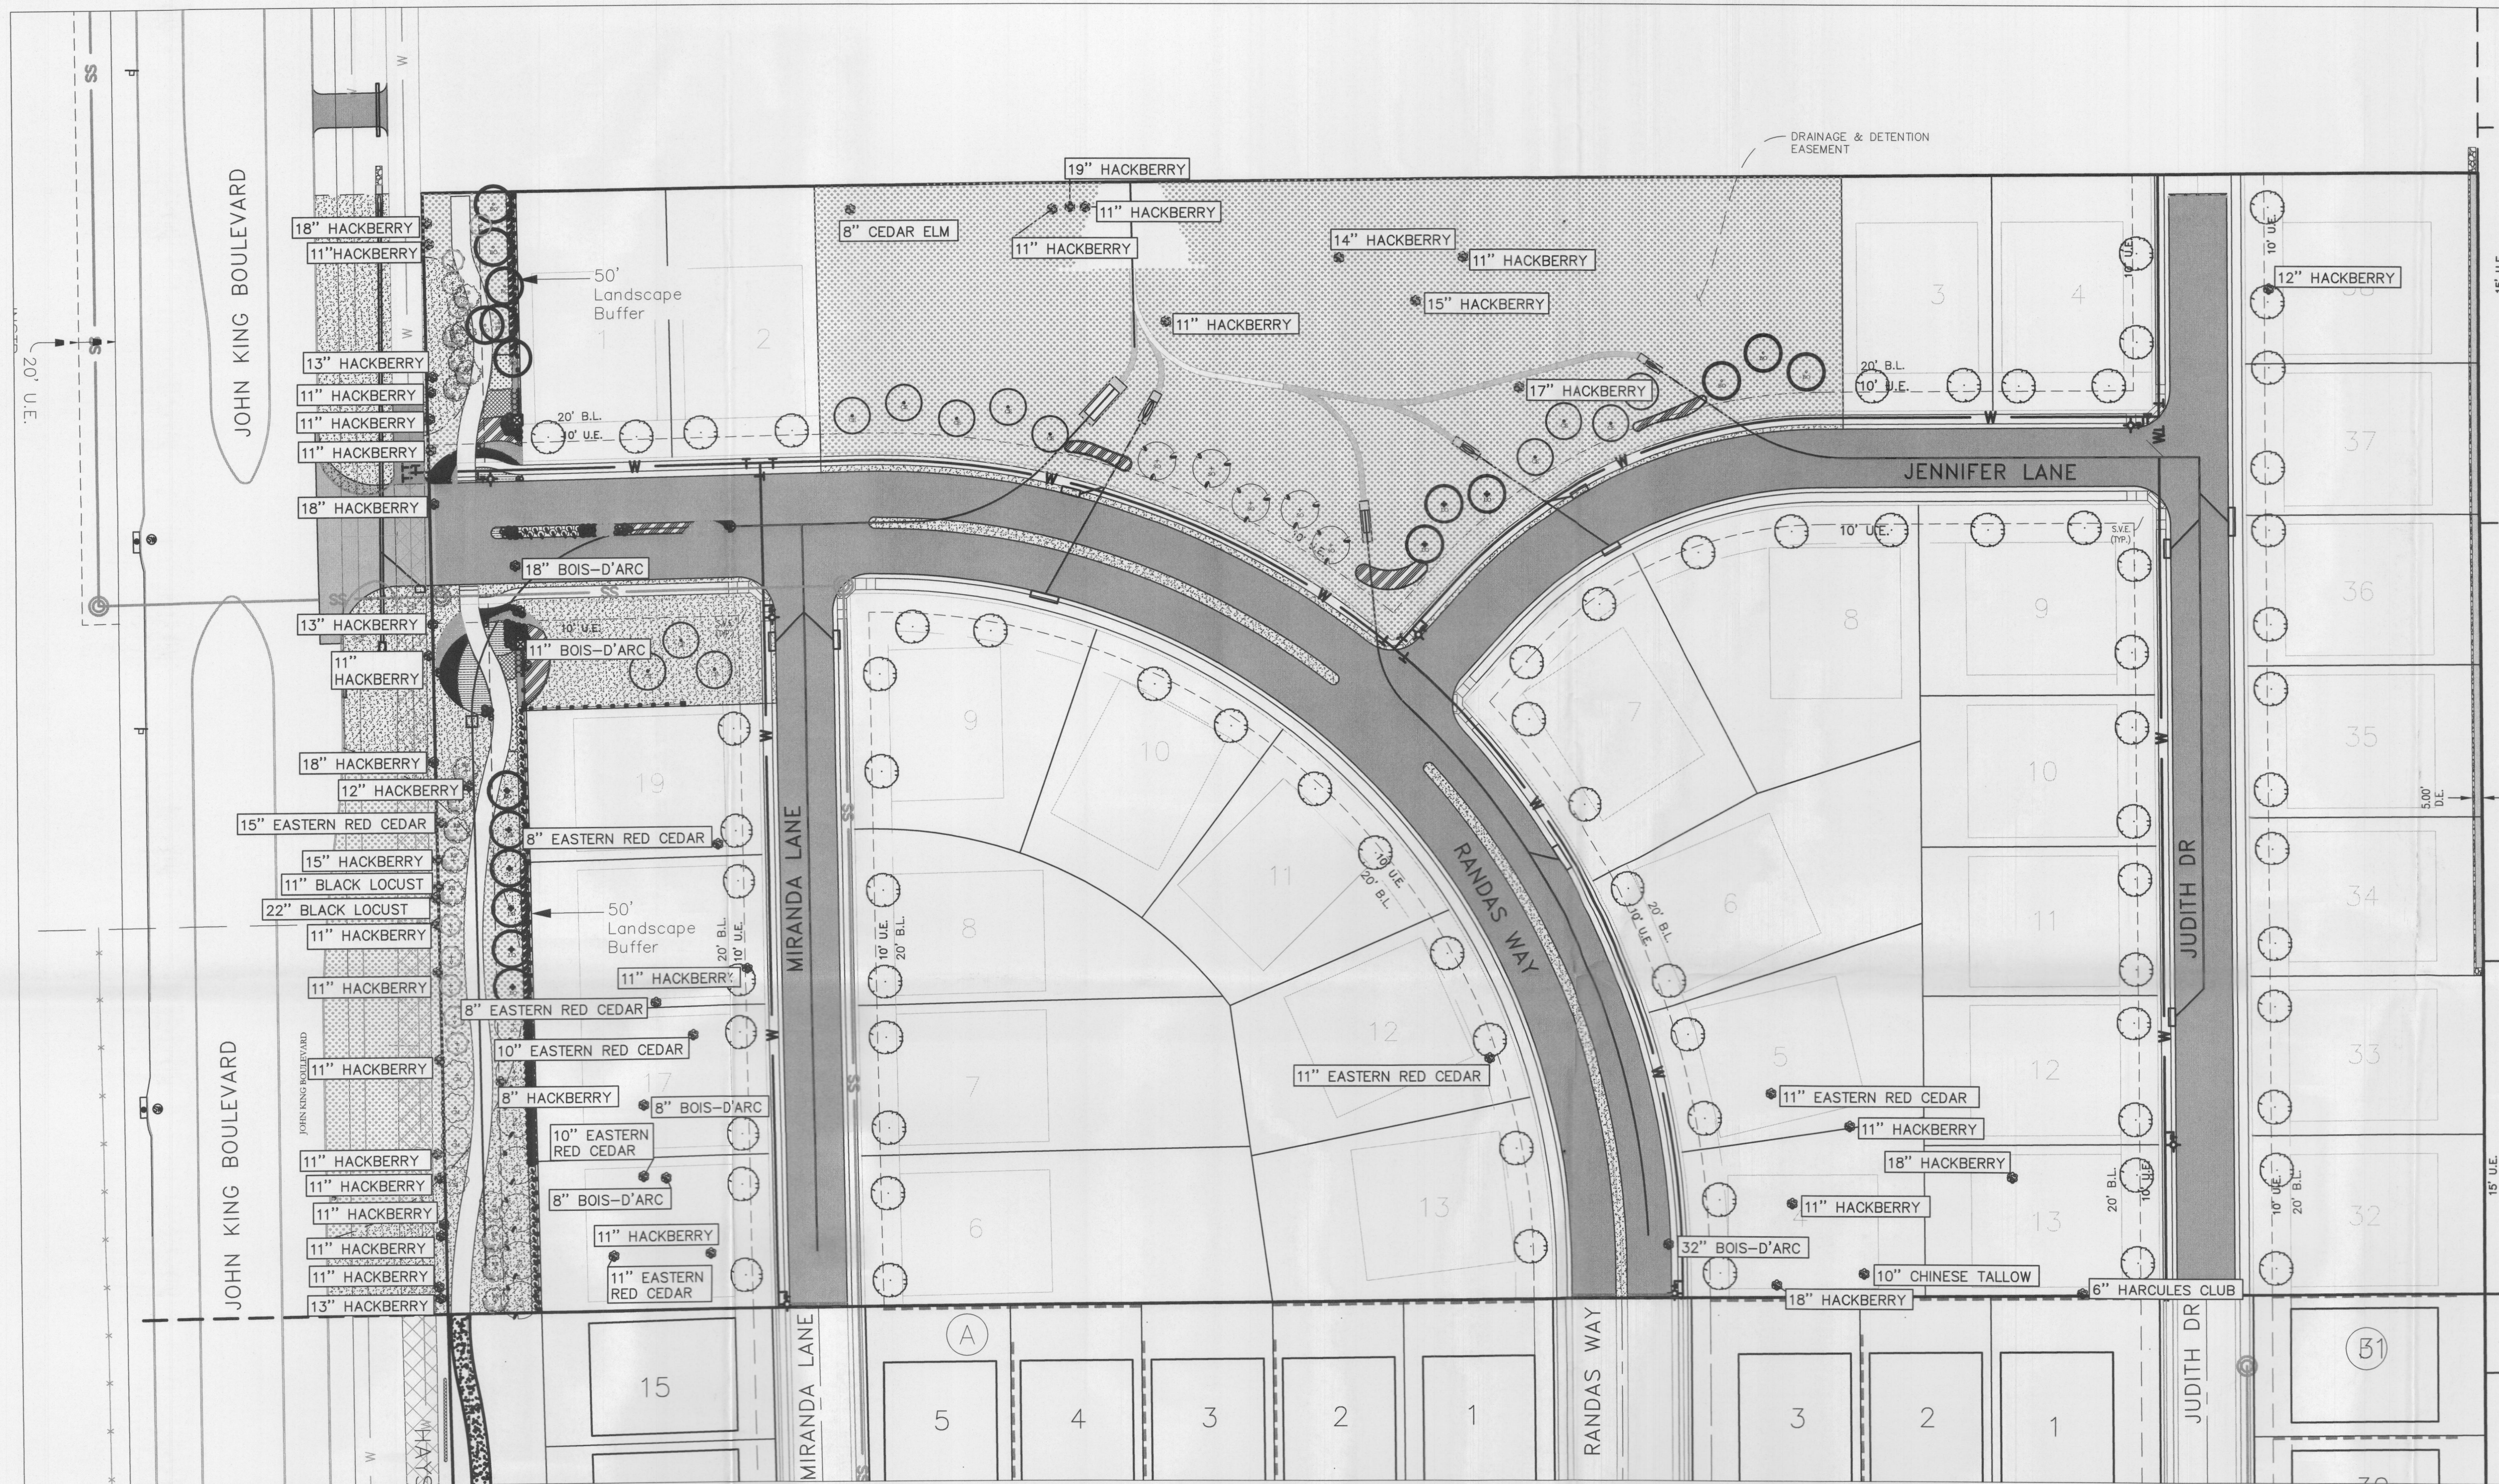

PLANT LEGEND					
SYMBOL	KEY	COMMON NAME	SCIENTIFIC NAME	SIZE	SPACING
	LO	LIVE OAK	QUERCUS VIRGINIANA	4" CALIPER	AS SHOWN
	SO	SHUMARD OAK	QUERCUS SHUMARDII	4" CALIPER	AS SHOWN
	BO	BUR OAK	QUERCUS MACROCARPA	4" CALIPER	AS SHOWN
	CE	CEDAR ELM	ULMUS CRASSIFOLIA	4" CALIPER	AS SHOWN
	RB	TEXAS REDBUD	CERCIS CANADENSIS VAR. TEXENSIS	2" CALIPER 4" MIN. HT.	AS SHOWN
	V	CHASTE TREE	VITEX AGNUS	2" CALIPER 4" MIN. HT.	AS SHOWN
	CM	NATCHEZ CRAPE MYRTLE	LAGERSTROEMIA INDICA X FAURIEI 'NATCHEZ'	2" CALIPER 4" MIN. HT.	AS SHOWN

- PROPOSED 4" CANOPY TREE BY BUILDER
- EXISTING TREE TO BE REMOVED
- SADDLE STAR SOUTH PHASE 3  
TREES to be REPLACED**
- 8 - 4" LIVE OAK  
12 - 4" SHUMARD OAK  
8 - 4" BUR OAK  
12 - 4" CEDAR ELM  
9 - 2" TEXAS REDBUD  
7 - 2" CHASTE TREE  
4 - 2" NATCHEZ CRAPE MYRTLE  
75 - 4" CANOPY TREE (BY BUILDER)  
460 CALIPER INCHES REPLACED

CITY OF ROCKWALL | UNIFIED DEVELOPMENT CODE

- (A) **Primary Protected Trees:** Primary protected trees measuring four inches through 25-inches DBH shall be replaced on an inch-for-inch basis (i.e. the total number of caliper inches of tree being replaced shall equal the total number of caliper inches being removed).
- (B) **Secondary Protected Trees:** Hackberry and cedar trees measuring 11-inches through 25-inches DBH shall be replaced with a half-inch for every inch removed (i.e. the total number of caliper inches of tree required to be replaced shall be half (1/2) of the inches being removed).
- (C) **Featured Trees:** Featured trees (i.e. all trees greater than 25-inches) shall be replaced with twice the number of inches being removed (i.e. the total number of caliper inches of tree being replaced shall be twice the number of caliper inches being removed).
- (D) **Non-Protected Tree:** No mitigation will be required for the removal of any tree that is less than four (4) inches DBH or less than 11-inches DBH for hackberry and cedar trees. In addition, no mitigation shall be required for the removal of Bois d'Arc, willow, cottonwood, locust and Chinaberry trees.

TABLE 1: SUMMARY OF MITIGATION REQUIREMENTS

Type of Tree	Mitigation Value	Mitigation Requirement	Example of Mitigation Requirements
Primary Protected Trees	4" - 25"	1:1	A 20-inch tree would require 20-inches of mitigation.
Secondary Protected Trees	11" - 25"	1:1/2 or 1:0.5	A 20-inch tree would require ten (10) inches of mitigation.
Featured Trees	Greater Than 25"	1:2	A 30-inch tree would require 60-inches of mitigation.

**OWNER/DEVELOPER**

COT ROCKWALL/2017, LLC  
6925 FM 2515  
KAUFMAN, TX 75142

- 1 - 8" CEDAR ELM  
1 - 11" BLACK LOCUST  
1 - 22" BLACK LOCUST  
2 - 8" BOIS-D'ARC  
1 - 11" BOIS-D'ARC  
1 - 18" BOIS-D'ARC  
1 - 32" BOIS-D'ARC

- 1 - 8" HACKBERRY  
21 - 11" HACKBERRY  
2 - 12" HACKBERRY  
3 - 13" HACKBERRY  
1 - 14" HACKBERRY  
2 - 15" HACKBERRY  
1 - 17" HACKBERRY  
5 - 18" HACKBERRY  
1 - 19" HACKBERRY  
1 - 10" CHINESE TALLOW  
1 - 6" HARCULES CLUB  
338 CALIPER INCHES REMOVED

**SITE PLAN SIGNATURE BLOCK**

APPROVED:  
I hereby certify that the above and foregoing site plan for a development in the City of Rockwall, Texas, was approved by the Planning & Zoning Commission of the City of Rockwall on the 14 day of February, 2024.

WITNESS OUR HANDS, this day of February 2024.

Planning & Zoning Commission, Chairman  
  
Director of Planning and Zoning

SP2021-034

\* ALL RESPONSIBILITY FOR ADEQUACY OF DESIGN REMAINS WITH THE DESIGN ENGINEER. THE CITY OF ROCKWALL, IN REVIEWING AND RELEASING PLANS FOR CONSTRUCTION, ASSUMES NO RESPONSIBILITY FOR ADEQUACY OR ACCURACY OF DESIGN.  
\* SEE "NTMWD NOTES" SHEET 1

**CAUTION! EXISTING UTILITIES**  
CONTRACTOR SHOULD CALL 1-800-DIG-TESS PRIOR TO BEGINNING ANY CONSTRUCTION ACTIVITIES FOR EXISTING UTILITY LOCATIONS. EXISTING UTILITIES AND UNDERGROUND FACILITIES INDICATED ON THESE PLANS HAVE BEEN LOCATED FROM REFERENCE INFORMATION. IT IS THE RESPONSIBILITY OF THE CONTRACTOR TO VERIFY BOTH HORIZONTALLY AND VERTICALLY THE LOCATION OF ALL EXISTING UTILITIES AND UNDERGROUND FACILITIES PRIOR TO CONSTRUCTION AND TO TAKE NECESSARY PRECAUTIONS IN ORDER TO PROTECT ALL FACILITIES ENCOUNTERED. THE CONTRACTOR SHALL PRESERVE AND PROTECT ALL EXISTING UTILITIES FROM DAMAGE DURING CONSTRUCTION.

**CAUTION! EXISTING UTILITIES**  
THE CONTRACTOR SHALL CONTACT NTMWD LINE LOCATES AT (469) 826-4569 AT LEAST 72 HOURS PRIOR TO PERFORMING ANY WORK IN THE VICINITY OF THE NTMWD FACILITIES.

**BENCHMARK:**  
BM#1 (#102)  
CIRS "ASC SURVEYING COMPANY" BEING IN THE NORTH MEDIAN OF JOHN KING BLVD. AND TO THE WEST OF THE MAIN ENTRANCE OF THE SUBJECT PROPERTY, AND BEING NORTH OF THE MEDIAN POINT 55'.  
ELEVATION = 531.58

BM#3 (#106)  
CIRS "ASC SURVEYING COMPANY" BEING IN THE MEDIAN OF JOHN KING BLVD. TO THE SOUTHEAST OF THE SUBJECT PROPERTY, AND BEING LOCATED 72.5' TO THE SOUTHEAST OF THE SOUTHEAST CORNER OF THE HEADWALL WITH AN 8'X8' BOX CULVERT.  
ELEVATION = 557.33'

**ENGINEERINGCONCEPTS  
& DESIGN, L.P.**

ENGINEERING / PROJECT MANAGEMENT /  
CONSTRUCTION SERVICES - FIRM REG. #F-001145  
201 WINDCO CIR, STE 200, WYLLIE, TX 75098  
972-941-8400 FAX: 972-941-8401 WWW.ECDLP.COM

REVISIONS:

DRAWN: MJH	DATE:
CHECKED: RCK	DATE: 12/1/2021
PROJECT NO.: 06828	
DWG FILE NAME: 06828 TREESCAPE.DWG	

THIS DOCUMENT IS RELEASED FOR THE PURPOSE OF INTERIM REVIEW UNDER THE AUTHORITY OF RYAN C. KING (123635) ON 12/1/2021. IT IS NOT TO BE USED FOR CONSTRUCTION, BIDDING, OR PERMITTING.

**TREE MITIGATION PLAN**  
**SADDLE STAR SOUTH PHASE 3**  
CITY OF ROCKWALL, ROCKWALL COUNTY, TEXAS

SHEET  
35  
OF  
35



GENERAL CONSTRUCTION NOTES


- ALL CONSTRUCTION, TESTING, AND MATERIALS SHALL BE IN ACCORDANCE WITH THE CITY'S CURRENT STANDARDS, DETAILS, AND SPECIFICATIONS.
- PRIOR TO ANY CONSTRUCTION ACTIVITIES, THE CONTRACTOR SHALL BE FAMILIAR WITH THE PLANS INCLUDING ALL NOTES, STANDARD SPECIFICATIONS, DETAILS, AND CITY STANDARDS.
- TESTING AND INSPECTION OF MATERIALS SHALL BE PERFORMED BY A COMMERCIAL TESTING LABORATORY APPROVED BY THE CLIENT AND CITY. CONTRACTOR SHALL FURNISH MATERIALS OR SPECIMENS FOR TESTING, AND SHALL FURNISH SUITABLE EVIDENCE THAT THE MATERIALS PROPOSED TO BE INCORPORATED INTO THE WORK ARE IN ACCORDANCE WITH THE SPECIFICATIONS.
- CONTRACTOR SHALL NOTIFY THE CITY AT LEAST 48 HOURS PRIOR TO BEGINNING ANY CONSTRUCTION.
- CONTRACTOR IS RESPONSIBLE FOR OBTAINING ALL NECESSARY PERMITS AND APPROVALS PRIOR TO BEGINNING ANY CONSTRUCTION.
- CONTRACTOR MUST KEEP AVAILABLE ON-SITE AT ALL TIMES APPROVED CONSTRUCTION PLANS AND COPIES OF ANY REQUIRED PERMITS ALONG WITH THE CURRENT VERSIONS OF THE FOLLOWING REFERENCES: CITY OF ROCKWALL ENGINEERING STANDARDS, NCTCOG SPECIFICATIONS, TXDOT SPECIFICATIONS, TXDOT STANDARD DRAWINGS.
- ALL SHOP DRAWINGS, WORKING DRAWINGS OR OTHER DOCUMENTS WHICH REQUIRE REVIEW BY THE CITY SHALL BE SUBMITTED BY THE CONTRACTOR SUFFICIENTLY IN ADVANCE OF SCHEDULED CONSTRUCTION TO ALLOW NO LESS THAN 14 CALENDAR DAYS FOR REVIEW AND RESPONSE BY THE CITY.
- THE CONTRACTOR SHALL BE RESPONSIBLE FOR ALL REQUIRED CONSTRUCTION SURVEYING AND STAKING AND SHALL NOTIFY THE CLIENT AND CITY OF ANY DISCREPANCIES PRIOR TO PROCEEDING WITH ANY WORK.
- CONTRACTOR SHALL BE RESPONSIBLE FOR PROTECTING ALL SURVEY MARKERS INCLUDING IRON RODS, PROPERTY CORNERS, OR SURVEY MONUMENTS WITHIN THE LIMITS OF CONSTRUCTION AND OUTSIDE ROW DURING CONSTRUCTION. ANY SURVEY MARKERS DISTURBED DURING CONSTRUCTION SHALL BE REPLACED BY THE CONTRACTOR AT NO COST TO THE CLIENT.
- CONTRACTOR IS RESPONSIBLE FOR KEEPING STREETS AND DRIVEWAYS ADJACENT TO THE PROJECT FREE OF MUD AND DEBRIS AT ALL TIMES. CONTRACTOR SHALL CLEAN UP AND REMOVE ALL LOOSE MATERIAL RESULTING FROM CONSTRUCTION OPERATIONS. THE CONTRACTOR SHALL TAKE ALL AVAILABLE PRECAUTIONS TO CONTROL DUST.
- THE EXISTENCE AND LOCATIONS OF THE PUBLIC AND FRANCHISE UTILITIES SHOWN ON THE DRAWINGS WERE OBTAINED FROM AVAILABLE RECORDS AND ARE APPROXIMATE. THE CONTRACTOR SHALL DETERMINE THE DEPTH AND LOCATION OF EXISTING UNDERGROUND UTILITIES PRIOR TO EXCAVATING, TRENCHING, OR DRILLING AND SHALL BE REQUIRED TO TAKE ANY PRECAUTIONARY MEASURES TO PROTECT ALL LINES SHOWN AND / OR ANY OTHER UNDERGROUND UTILITIES NOT OF RECORD OR NOT SHOWN ON THE PLANS. THE CONTRACTOR SHALL BE RESPONSIBLE FOR CONTACTING ALL PUBLIC AGENCIES AND FRANCHISE UTILITIES 48 HOURS PRIOR TO CONSTRUCTION. (DIG-TESS 1-800-344-8377) THE CONTRACTOR MAY BE REQUIRED EXPOSE THESE FACILITIES AT NO COST TO THE CITY. THE CONTRACTOR WILL BE RESPONSIBLE FOR DAMAGES TO UTILITIES IF THE DAMAGE IS CAUSED BY NEGLIGENCE OR FAILURE TO HAVE LOCATES PERFORMED.
- THE CONTRACTOR SHALL BE RESPONSIBLE FOR ANY DAMAGE TO EXISTING FACILITIES OR ADJACENT PROPERTIES DURING CONSTRUCTION. ANY REMOVAL OR DAMAGE TO EXISTING FACILITIES SHALL BE REPLACED OR REPAIRED TO EQUAL OR BETTER CONDITION BY THE CONTRACTOR.
- CONTRACTOR SHALL BE RESPONSIBLE FOR FURNISHING AND INSTALLING ALL TEMPORARY AND PERMANENT TRAFFIC CONTROL IN ACCORDANCE WITH THE MINIMUM REQUIREMENTS OF THE LATEST REVISION OF THE TEXAS MANUAL ON UNIFORM TRAFFIC CONTROL DEVICES (TMUTCD) AND TXDOT BARRICADE AND CONSTRUCTION STANDARDS.
- CONTRACTOR SHALL NOT IMPEDE TRAFFIC ON EXISTING STREETS, DRIVEWAYS, ALLEYS, OR FIRE LANES OPEN TO THE PUBLIC. IN THE EVENT THE CONSTRUCTION WORK REQUIRES THE CLOSURE OF AN EXISTING STREET, ALLEY, OR FIRE LANE, THE CONTRACTOR SHALL REQUEST THE ROAD CLOSURE THROUGH THE CITY TRAFFIC DIVISION.
- CONTRACTOR SHALL NOT STORE MATERIALS, EQUIPMENT OR OTHER CONSTRUCTION ITEMS ON ADJACENT PROPERTIES OR RIGHT-OF-WAY WITHOUT THE PRIOR WRITTEN CONSENT OF THE PROPERTY OWNER AND THE CITY.
- TEMPORARY FENCING SHALL BE INSTALLED PRIOR TO THE REMOVAL OF EXISTING FENCING. TEMPORARY FENCING SHALL BE REMOVED AFTER PROPOSED FENCING IS APPROVED BY THE CITY. ALL TEMPORARY AND PROPOSED FENCING LOCATIONS SHALL BE SUBJECT TO FIELD REVISIONS AS DIRECTED BY THE CITY.
- UNUSABLE EXCAVATED MATERIAL, OR CONSTRUCTION DEBRIS SHALL BE REMOVED AND DISPOSED OF OFFSITE AT AN APPROVED DISPOSAL FACILITY BY THE CONTRACTOR AT HIS EXPENSE.
- CONTRACTOR SHALL AVOID DAMAGE TO EXISTING TREES. WHEN NECESSARY, TREES AND SHRUB TRIMMING FOR CONSTRUCTION SHALL BE PERFORMED BY CERTIFIED TREE WORKER OR UNDER THE DIRECTION OF A REGISTERED LANDSCAPE ARCHITECT OR CERTIFIED ARBORIST.
- EROSION CONTROL DEVICES SHALL BE INSTALLED ON ALL PROJECTS PRIOR TO BEGINNING CONSTRUCTION AND SHALL BE MAINTAINED THROUGHOUT THE PROJECT IN A CONDITION ACCEPTABLE TO THE CITY.
- CONTRACTOR SHALL LOCATE AND PROTECT ALL EXISTING LANDSCAPE IRRIGATION SYSTEMS. DAMAGE TO EXISTING IRRIGATION SYSTEMS AND LANDSCAPE MATERIALS SHALL BE RESTORED TO EQUAL OR BETTER CONDITION AT NO COST TO CITY OR CLIENT.
- IT IS THE CONTRACTOR'S RESPONSIBILITY TO MAINTAIN A NEAT AND ACCURATE RECORD OF CONSTRUCTION FOR THE CLIENT'S AND CITY'S RECORDS.

CONSTRUCTION PLANS  
FOR  
SCREENING AND BUFFERING

~SADDLE STAR SOUTH - PH3~

CITY OF ROCKWALL  
ROCKWALL COUNTY, TEXAS

SUBMITTAL DATE: January 27, 2022

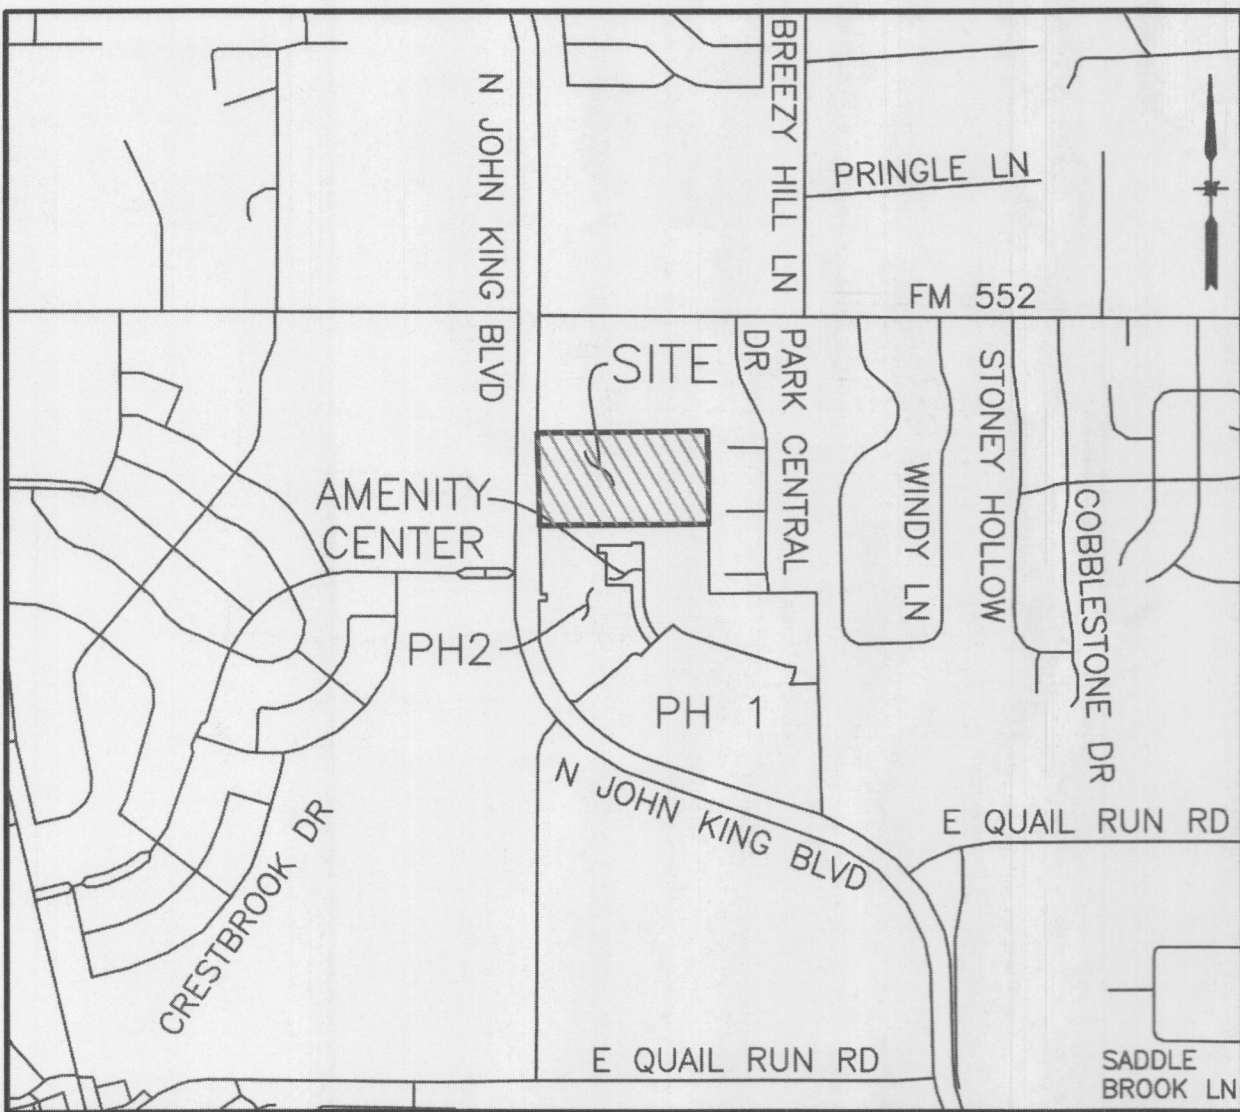

LOCATION MAP  
NOT TO SCALE

SHEET INDEX	
HS1	OVERALL LAYOUT PLAN
HS2-HS4	HARDSCAPE PLANS
HS5-HS6	HARDSCAPE DETAILS
L1-L4	LANDSCAPE PLANS
L5-L6	LANDSCAPE DETAILS
IR1-IR4	IRRIGATION PLANS
IR5-IR6	IRRIGATION DETAILS

GENERAL LANDSCAPE NOTES:

- INSPECTIONS:
- NO EXCAVATION SHALL OCCUR IN CITY R.O.W. WITHOUT A R.O.W. PERMIT--CONTACT THE PUBLIC WORKS DEPARTMENT.
  - THE CONTRACTOR SHALL MARK ALL WATER LINES, SEWER LINES, AND TREE LOCATIONS PRIOR TO CALLING FOR ROW INSPECTION AND PERMIT.
  - THE LANDSCAPE INSTALLATION SHALL COMPLY WITH APPROVED LANDSCAPE DRAWINGS PRIOR TO FINAL ACCEPTANCE BY THE CITY AND ISSUANCE OF A CERTIFICATE OF OCCUPANCY.
  - WATER METERS, CLEANOUTS AND OTHER APPURTENANCES, SHALL BE ACCESSIBLE, ADJUSTED TO GRADE, CLEARLY MARKED WITH FLAGGING AND COMPLIANT WITH PUBLIC WORKS DEPARTMENT STANDARDS PRIOR TO CALLING FOR FINAL LANDSCAPE AND ROW INSPECTIONS.

- LANDSCAPE STANDARDS:
- PLANTINGS AND LANDSCAPE ELEMENTS SHALL COMPLY WITH THE CITY'S ENGINEERING DESIGN STANDARDS, PUBLIC R.O.W. VISIBILITY REQUIREMENTS.
  - UNLESS OTHERWISE SPECIFIED, TREES SHALL BE PLANTED NO LESS THAN 4' FROM CURBS, SIDEWALKS, UTILITY LINES, SCREENING WALLS AND OTHER STRUCTURES. THE CITY HAS FINAL APPROVAL FOR ALL TREE PLACEMENTS.
  - A MINIMUM THREE FEET (3') RADIUS AROUND A FIRE HYDRANT MUST REMAIN CLEAR OF LANDSCAPE PURSUANT TO THE FIRE CODE.
  - STREET TREES, WHERE REQUIRED, SHALL BE (10') MINIMUM FROM THE EDGE OF A STORM SEWER CURB INLET BOX AND THE EDGE OF THE ROOT BALL SHALL BE (4') MINIMUM FROM THE WATER METER.
  - THE AMERICAN STANDARD FOR NURSERY STOCK (ANSI Z60.1-2014) SPECIFICATIONS SHALL GOVERN PLANT QUALIFICATIONS, GRADES, AND STANDARDS.
  - TREE PLANTING SHALL COMPLY WITH DETAILS HEREIN AND THE INTERNATIONAL SOCIETY OF ARBORICULTURE (ISA) STANDARDS.
  - A 2-3" LAYER OF MULCH SHALL BE PROVIDED AROUND THE BASE OF THE PLANTED TREE. THE MULCH SHALL BE PULLED BACK 4" FROM THE TRUNK OF THE TREE.
  - TREE PITS SHALL BE TESTED FOR WATER PERCOLATION. IF WATER DOES NOT DRAIN OUT OF TREE PIT WITHIN 24-HOURS, THE TREE SHALL BE MOVED OR DRAINAGE SHALL BE PROVIDED.
  - ALL BEDS TO HAVE 3" OF COMPOSTED SOIL, LIVING EARTH TECHNOLOGY, OR APPROVED EQUAL TILLED AND TURNED TO A DEPTH OF 8" MINIMUM.
  - ALL PLANT BEDS SHALL BE TOP-DRESSED WITH A MINIMUM OF 3 INCHES OF HARDWOOD MULCH.
  - NATIVE SITE TOPSOIL IS TO BE PROTECTED FROM EROSION OR STOCKPILED. NATIVE SITE TOPSOIL SHALL BE LABORATORY TESTED BY AND ACCREDITED LABORATORY AND AMENDED PER SAID LABORATORY'S RECOMMENDATIONS.


- IRRIGATION STANDARDS:
- ANY CHANGES TO THESE APPROVED IRRIGATION DRAWINGS SHALL BE AUTHORIZED BY THE CITY.
  - CONTACT DEVELOPMENT SERVICES FOR AN IRRIGATION PERMIT PRIOR TO INSTALLING THE IRRIGATION SYSTEM.
  - IRRIGATION OVER-SPRAY ON STREETS AND WALKS IS PROHIBITED.
  - MAINLINES, VALVES, OR CONTROL WIRES SHALL NOT BE LOCATED IN THE CITY'S ROW.
  - ET IRRIGATION CONTROLLERS SHALL BE PROGRAMMED AND ADJUSTED TO NOT EXCEED THE LANDSCAPE WATER ALLOWANCE (LWA) PRIOR TO APPROVAL OF LANDSCAPE INSTALLATION.
  - VALVES SHALL BE LOCATED A MINIMUM OF (3') AWAY FROM STORM SEWERS, AND SANITARY SEWER LINES AND 5 FEET FROM CITY FIRE HYDRANTS AND WATER VALVES.
  - THE BORE DEPTH UNDER STREETS, DRIVE AISLES, AND FIRE LANES SHALL PROVIDE (2') OF CLEARANCE (MINIMUM).
  - IRRIGATION HEADS THAT RUN PARALLEL AND NEAR PUBLIC WATER AND SANITARY SEWER LINES, SHALL BE FED FROM STUBBED LATERALS OR BULL-BEADS. A MINIMUM FIVE FOOT (5') SEPARATION IS REQUIRED BETWEEN IRRIGATION MAIN LINES AND LATERALS THAT RUN PARALLEL TO PUBLIC WATER AND SANITARY SEWER LINES.
  - NO VALVES, BACKFLOW PREVENTION ASSEMBLIES, QUICK COUPLERS ETC. SHALL BE LOCATED CLOSER THAN 10' FROM THE CURB AT STREET OR DRIVE INTERSECTION.


- MAINTENANCE STANDARDS:
- THE OWNER SHALL BE RESPONSIBLE FOR THE ESTABLISHMENT, MAINTENANCE, AND VIGOR OF PLANT MATERIAL IN ACCORDANCE WITH THE DESIGN INTENT AND AS APPROPRIATE FOR THE SEASON OF THE YEAR.
  - LANDSCAPE AND OPEN AREAS SHALL BE FREE OF TRASH, LITTER AND WEEDS.
  - NO PLANT MATERIAL SHALL BE ALLOWED TO ENCROACH ON R.O.W., SIDEWALKS OR EASEMENTS TO THE EXTENT THAT VISION OR ROUTE OF TRAVEL FOR VEHICULAR, PEDESTRIAN, OR BICYCLE TRAFFIC IS IMPEDED.
  - TREE MAINTENANCE SHALL BE IN ACCORDANCE WITH THE STANDARDS OF THE INTERNATIONAL SOCIETY OF ARBORICULTURE.
  - TREE STAKING MATERIALS, IF USED, SHALL BE REMOVED AFTER (1) GROWING SEASON, NO MORE THAN (1) YEAR AFTER INSTALLATION (STEEL TREE STAKES, WIRES, AND HOSES ARE PROHIBITED).

- TREE PROTECTION NOTES:
- CONTACT DEVELOPMENT SERVICES FOR A TREE REMOVAL PERMIT PRIOR TO REMOVAL OR TRANSPLANTING OF ANY TREES.
  - ALL TREES WHICH ARE TO REMAIN ON SITE SHALL BE PROTECTED WITH A (4') TALL BRIGHTLY COLORED PLASTIC FENCE, OR SILT FENCE, PLACED AT THE DRIP LINE OF THE TREES.
  - PRIOR TO THE PRE-CONSTRUCTION MEETING OR OBTAINING A GRADING PERMIT, ALL TREE MARKINGS AND PROTECTIVE FENCING SHALL BE INSTALLED BY THE OWNER AND BE INSPECTED BY DEVELOPMENT SERVICES.
  - NO EQUIPMENT SHALL BE CLEANED, OR HARMFUL LIQUIDS DEPOSITED WITHIN THE LIMITS OF THE ROOT ZONE OF TREES WHICH REMAIN ON SITE.
  - NO SIGNS, WIRES, OR OTHER ATTACHMENTS SHALL BE ATTACHED TO ANY TREE TO REMAIN ON SITE.
  - VEHICULAR AND CONSTRUCTION EQUIPMENT SHALL NOT PARK OR DRIVE WITHIN THE LIMITS OF THE DRIP LINE.
  - GRADE CHANGES IN EXCESS OF 3 INCHES (CUT OR FILL) SHALL NOT BE ALLOWED WITHIN A ROOT ZONE, UNLESS ADEQUATE TREE PRESERVATION METHODS ARE APPROVED BY THE CITY.
  - NO TRENCHING SHALL BE ALLOWED WITHIN THE DRIP-LINE OF A TREE, UNLESS APPROVED BY THE CITY.
  - ALL REMOVED TREES SHALL BE CHIPPED AND USED FOR MULCH ON SITE OR HAULED OFF-SITE.
  - ALL TREE MAINTENANCE TECHNIQUES SHALL BE IN CONFORMANCE WITH INDUSTRY IDENTIFIED STANDARDS. IMPROPER OR MALICIOUS PRUNING TECHNIQUES ARE STRICTLY PROHIBITED.

APPROVED:  
I hereby certify that the above and foregoing site plan for a development in the City of Rockwall, Texas, was approved by the Planning & Zoning Commission of the City of Rockwall on the 16 day of February, 2022.

WITNESS OUR HANDS, this 16 day of February, 2022.

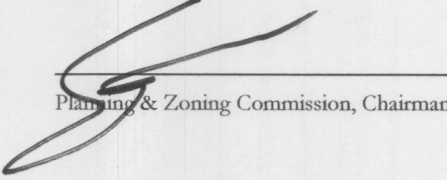  
Planning & Zoning Commission, Chairman

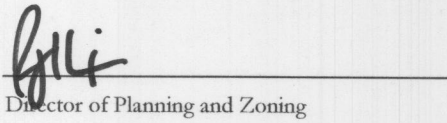  
Director of Planning and Zoning

OWNER / DEVELOPER:  
SADDLE STAR SOUTH HOLDINGS, LLC  
2200 ROSS AVENUE  
SUITE 4200W  
DALLAS, TEXAS 75201  
PH. (972) 716-2900  
CONTACT: PAT ATKINS

CIVIL ENGINEER:  
ENGINEERING CONCEPTS & DESIGN, LP  
201 WINDCO CIRCLE  
SUITE 200  
WYLIE, TEXAS 75098  
PH. (972) 941-8400  
CONTACT: RYAN KING

LANDSCAPE ARCHITECT:  
CODY JOHNSON STUDIO, LLC  
9720 COIT ROAD SUITE 220-333  
PLANO, TEXAS 75025  
PH. (903) 570-0162  
CONTACT: CODY JOHNSON, RLA, ASLA, LI





CITY OF ROCKWALL  
STONE CREEK PHASE VI  
CAB. I, PG. 161  
P.R.R.C.T.

JOHN KING BOULEVARD

MIRANDA LANE

RANADS WAY

JENNIFER LANE

JUDITH DR.

CALLED 12.00 AC.  
MICHAEL & STACY MILLER  
INST. NO. 20170000011122  
D.R.R.C.T.

HS3  
L2  
IR2

HS4  
L3  
IR3

HS2  
L1  
IR1

L4  
IR4

SADDLE STAR  
PHASE 2.

APPROVED:  
I hereby certify that the above and foregoing site plan for a development in the  
City of Rockwall, Texas, was approved by the Planning & Zoning  
Commission of the City of Rockwall on the 16 day of February, 2022.



WITNESS OUR HANDS, this 16 day of February, 2022.

*[Signature]*  
Planning & Zoning Commission, Chairman

*[Signature]*  
Director of Planning and Zoning

JOHNSON VOLK  
CONSULTING

830 CENTRAL PARKWAY EAST, SUITE 300 PLANO, TEXAS 75074  
PH. 972.201.3100  
EMAIL: CODY.JOHNSON@JOHNSONVOLK.COM

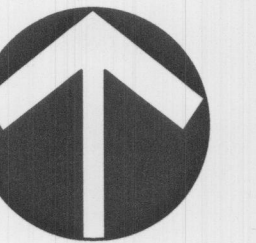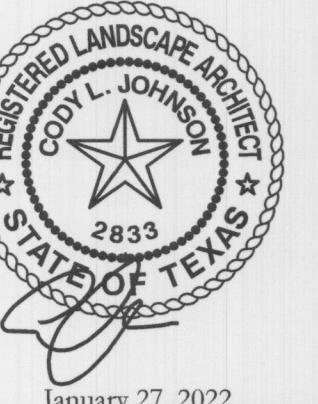

50 25 0 50  
Scale: 1" = 50'-0"

Bar is one inch on  
original drawing. If not  
one inch on this sheet,  
adjust scale as necessary.  
One Inch

SCREENING AND BUFFERING

Overall Layout Plan

Saddle Star South - Phase 3

City of Rockwall, Rockwall County, Texas

CJS PROJECT NO.


PAD001B

SHEET NO.

HS1 of 6



MATCHLINE  
REF: SHEET HS3, L2, LR2  
REF: SHEET HS2, L1, LR1



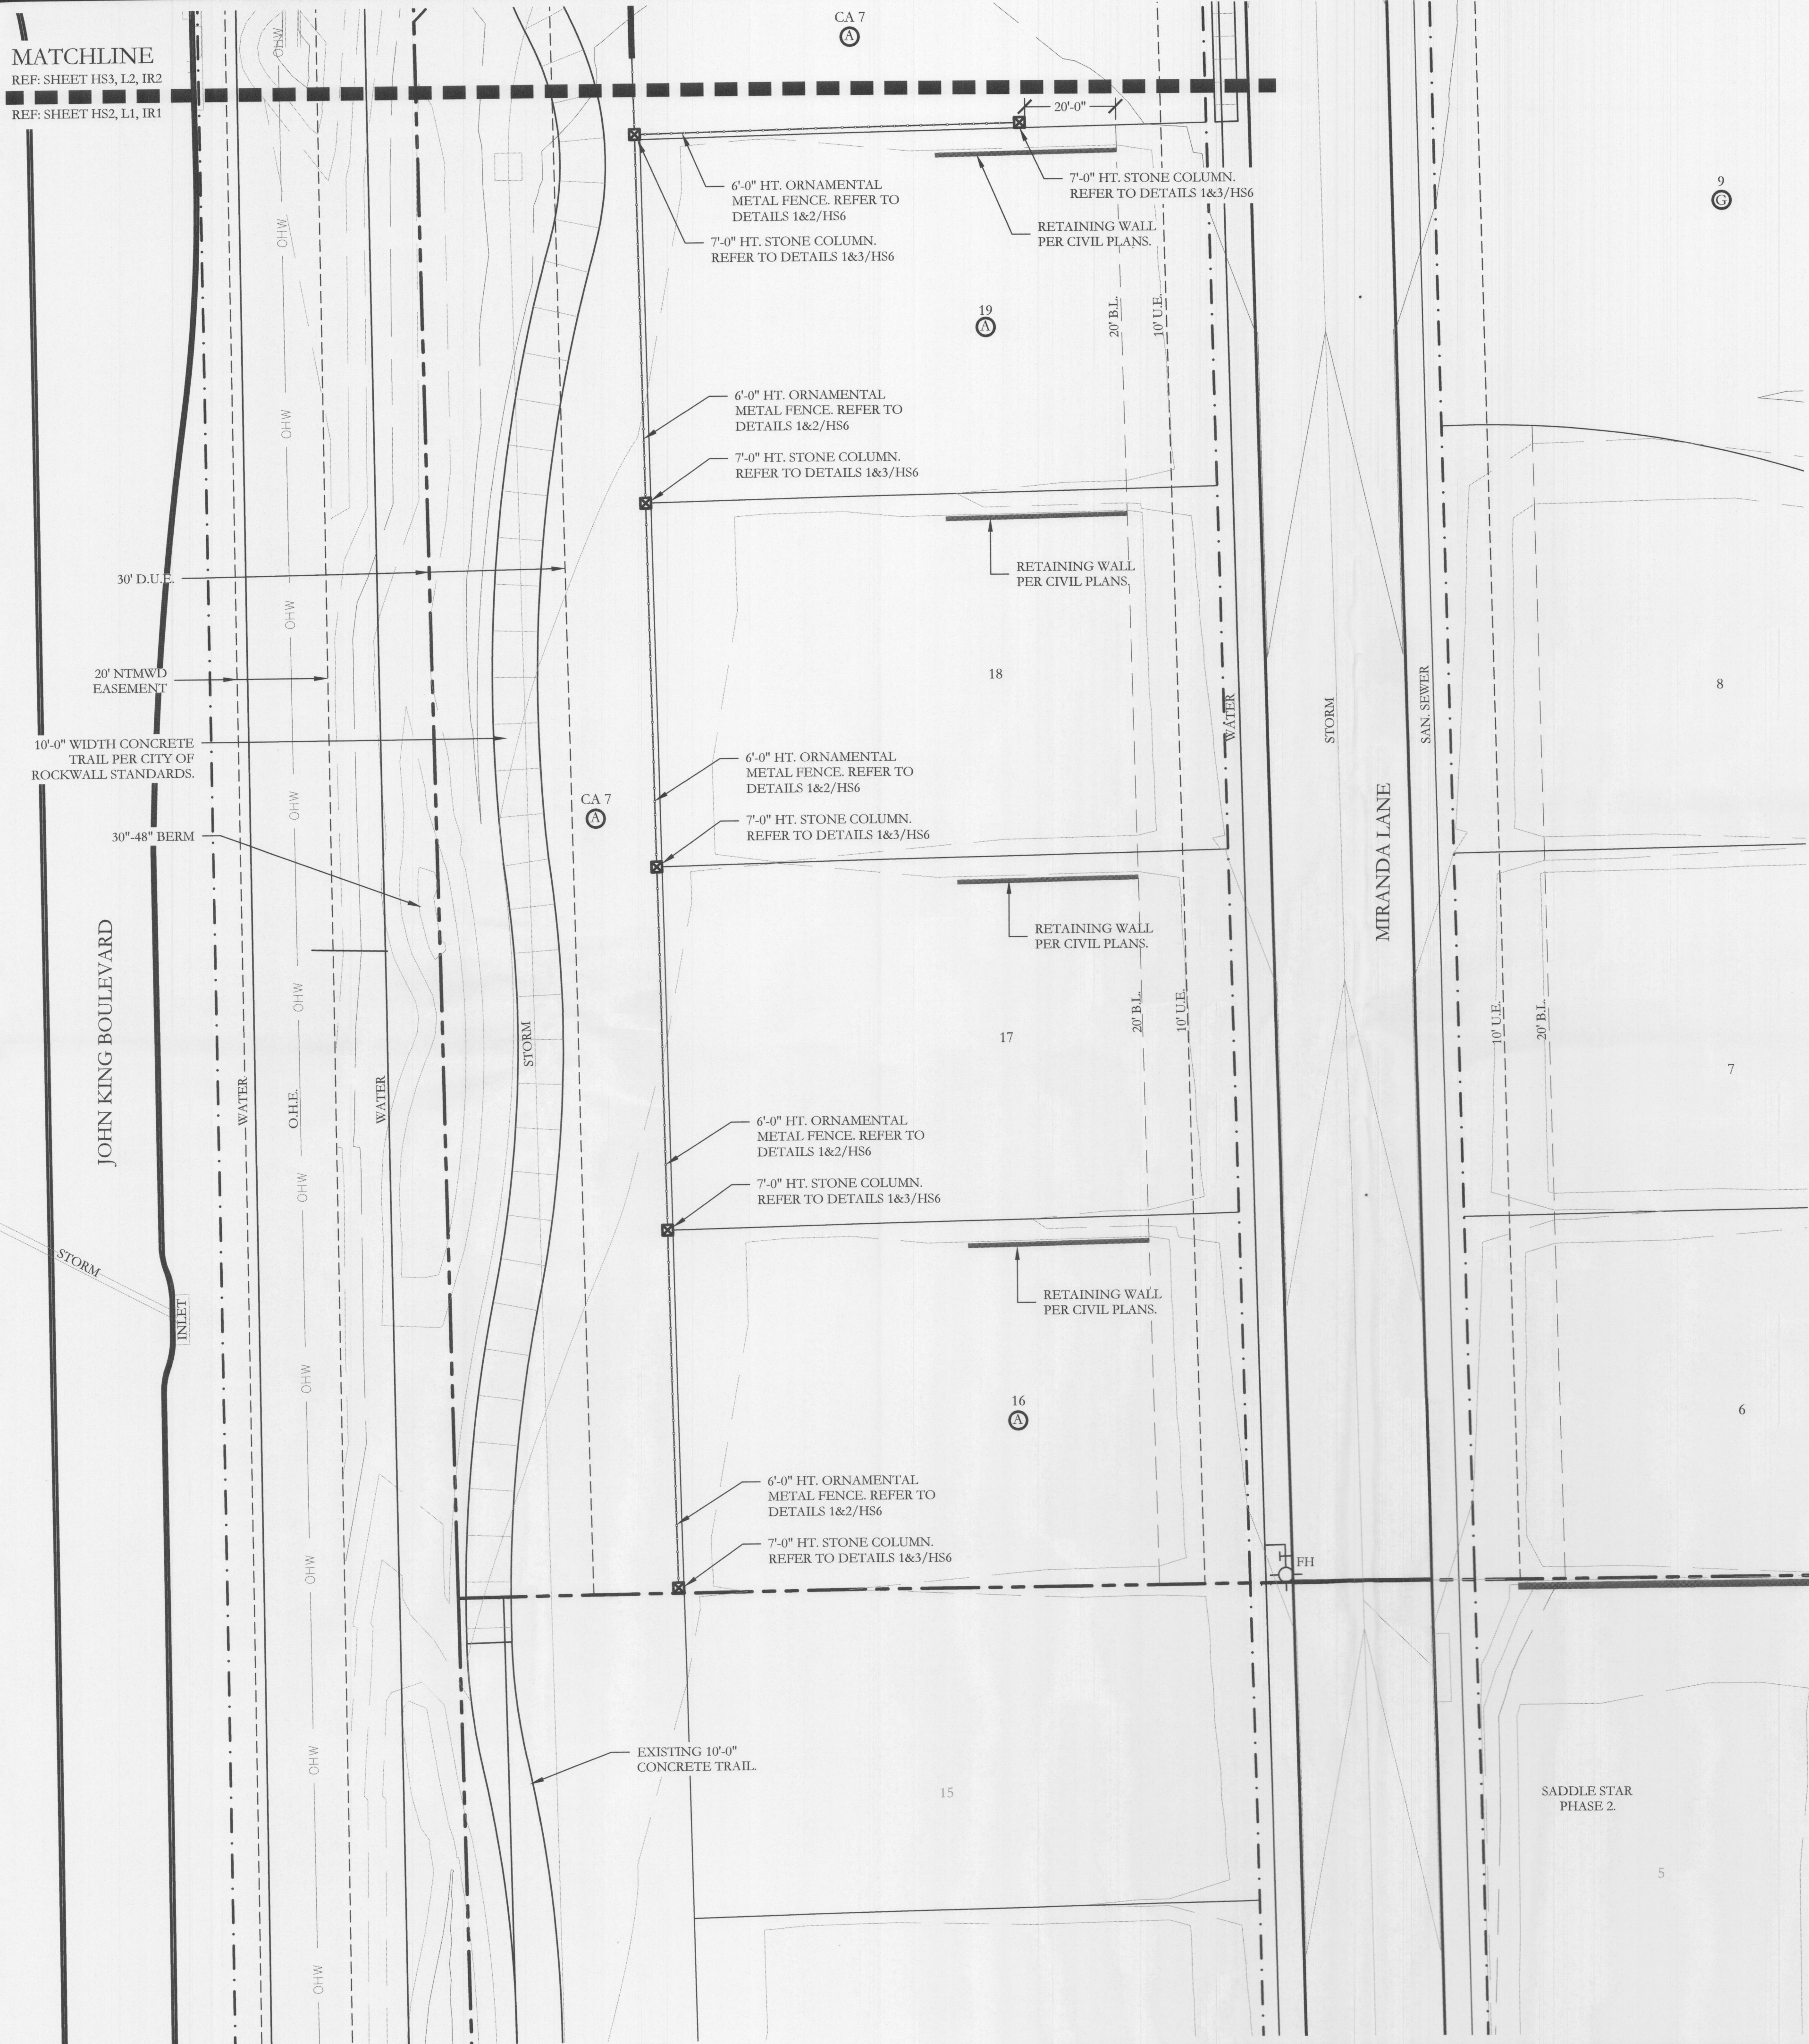


HARDSCAPE LEGEND

- 6'-0" HT. ENTRY SIGN WALL.  
REFER TO DETAILS 1,2&3/HS5.
- 14'-0" HT. STONE ENTRY TOWER.  
REFER TO DETAILS 1&4/HS5.
- 7'-0" HT. STONE COLUMN.  
REFER TO DETAILS 1&3/HS6.
- 6'-0" HT. ORNAMENTAL METAL FENCE.  
REFER TO DETAILS 1&2/HS6.



830 CENTRAL PARKWAY EAST, SUITE 300 PLANO, TEXAS 75074  
PH: (972) 203-3100  
EMAIL: CODY@JOHNSONVOLK.COM

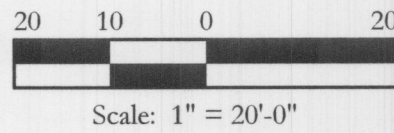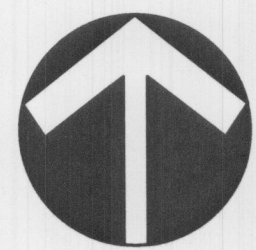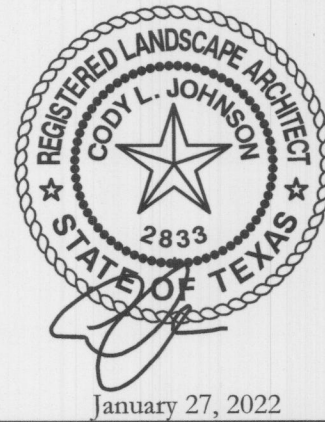

Scale: 1" = 20'-0"

Bar is one inch on original drawing. If not one inch on this sheet, adjust scale as necessary.  
One Inch

SCREENING AND BUFFERING

Hardscape Plans

Saddle Star South - Phase 3


City of Rockwall, Rockwall County, Texas

APPROVED:  
I hereby certify that the above and foregoing site plan for a development in the City of Rockwall, Texas, was approved by the Planning & Zoning Commission of the City of Rockwall on the 16 day of February, 2022.

WITNESS OUR HANDS, this 16 day of February, 2022.  
  
Planning & Zoning Commission, Chairman  
  
Director of Planning and Zoning

CJS PROJECT NO.  
PAD001B  
SHEET NO.  
HS2 of 6



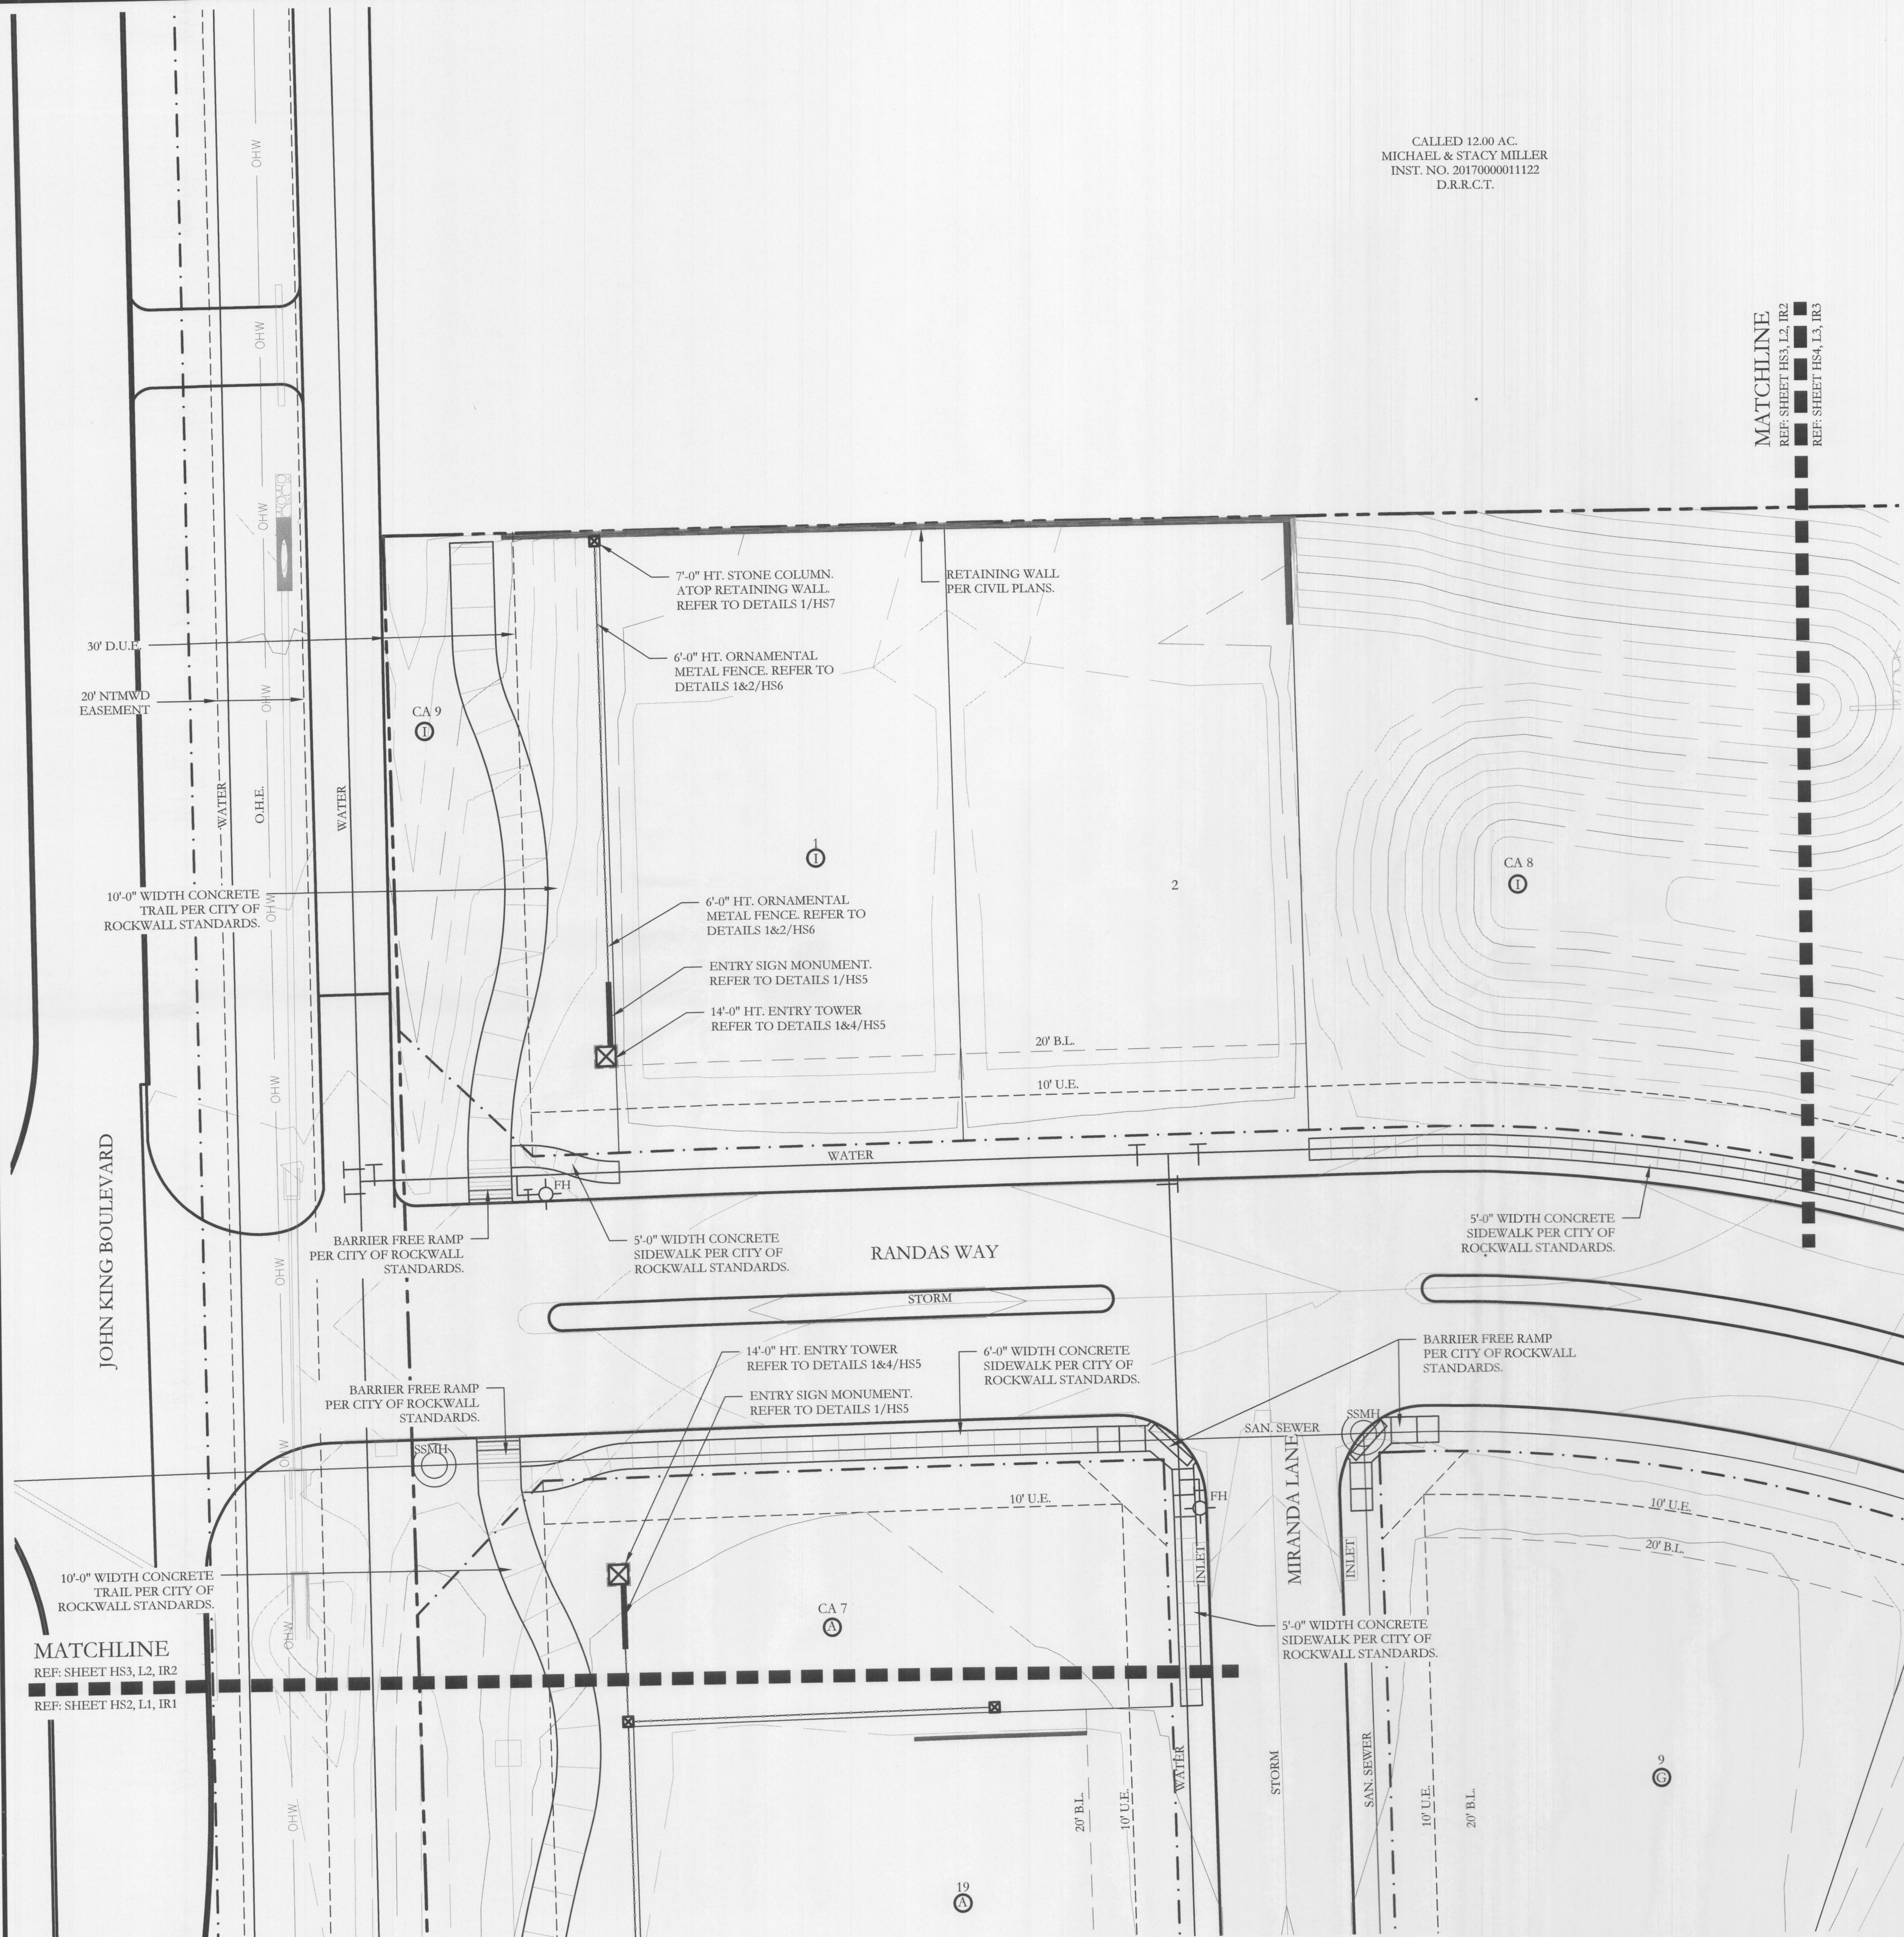



CALLED 12.00 A.C.  
MICHAEL & STACY MILLER  
INST. NO. 2017000011122  
D.R.R.C.T.

MATCHLINE  
REF: SHEET HS3, L2, IR2  
REF: SHEET HS4, L3, IR3

### HARDSCAPE LEGEND

- 6'-0" HT. ENTRY SIGN WALL  
REFER TO DETAILS 1,2&3/HS5.
- 14'-0" HT. STONE ENTRY TOWER  
REFER TO DETAILS 1&4/HS5.
- 7'-0" HT. STONE COLUMN.  
REFER TO DETAILS 1&3/HS6.
- 6'-0" HT. ORNAMENTAL METAL FENCE  
REFER TO DETAILS 1&2/HS6.

**JOHNSON VOLK  
CONSULTING**

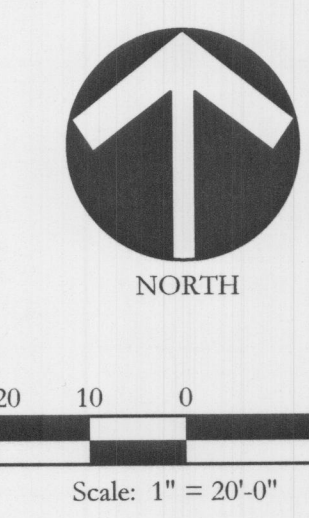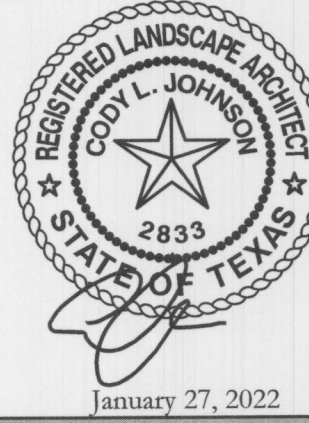

Bar is one inch on original drawing. If not one inch on this sheet, adjust scale as necessary.

**SCREENING AND BUFFERING**  
Hardscape Plans  
**Saddle Star South - Phase 3**  
City of Rockwall, Rockwall County, Texas

**APPROVED:**  
I hereby certify that the above and foregoing site plan for a development in the City of Rockwall, Texas, was approved by the Planning & Zoning Commission of the City of Rockwall on the 16 day of February, 2022.

WITNESS OUR HANDS, this 16 day of February, 2022.

*[Signature]*  
Planning & Zoning Commission, Chairman

*[Signature]*  
Director of Planning and Zoning

CJS PROJECT NO.  
**PAD001B**  
SHEET NO.  
**HS3 of 6**



MATCHLINE  
REF: SHEET HS3, L2, IR2  
REF: SHEET HS4, L3, IR3



CALLED 12.00 A.C.  
MICHAEL & STACY MILLER  
INST. NO. 20170000011122  
D.R.R.C.T.

### HARDSCAPE LEGEND

- 6'-0" HT. ENTRY SIGN WALL.  
REFER TO DETAILS 1,2&3/HS5.
- 14'-0" HT. STONE ENTRY TOWER.  
REFER TO DETAILS 1&4/HS5.
- 7'-0" HT. STONE COLUMN.  
REFER TO DETAILS 1&3/HS6.
- 6'-0" HT. ORNAMENTAL METAL FENCE.  
REFER TO DETAILS 1&2/HS6.



830 CENTRAL PARKWAY EAST, SUITE 300 PLANO, TEXAS 75074  
PH. (972) 201-3100  
EMAIL: CODY@JOHNSONVOLK.COM

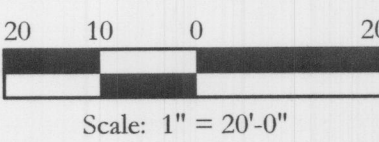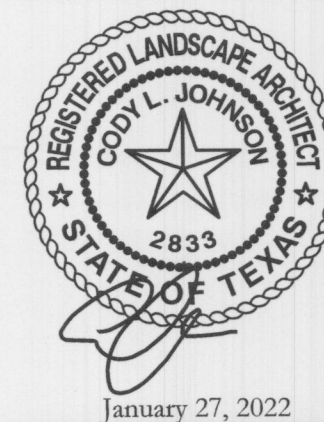

Bar is one inch on original drawing. If not one inch on this sheet, adjust scale as necessary.

### SCREENING AND BUFFERING

#### Hardscape Plans

#### Saddle Star South - Phase 3

City of Rockwall, Rockwall County, Texas

**APPROVED:**  
I hereby certify that the above and foregoing site plan for a development in the City of Rockwall, Texas, was approved by the Planning & Zoning Commission of the City of Rockwall on the 16 day of February, 2022.

WITNESS OUR HANDS, this 16 day of February, 2022.


*[Signature]*  
Planning & Zoning Commission, Chairman

*[Signature]*  
Director of Planning and Zoning

MATCHLINE  
REF: SHEET HS4, L3, IR3  
REF: SHEET L4, IR4


10  
©



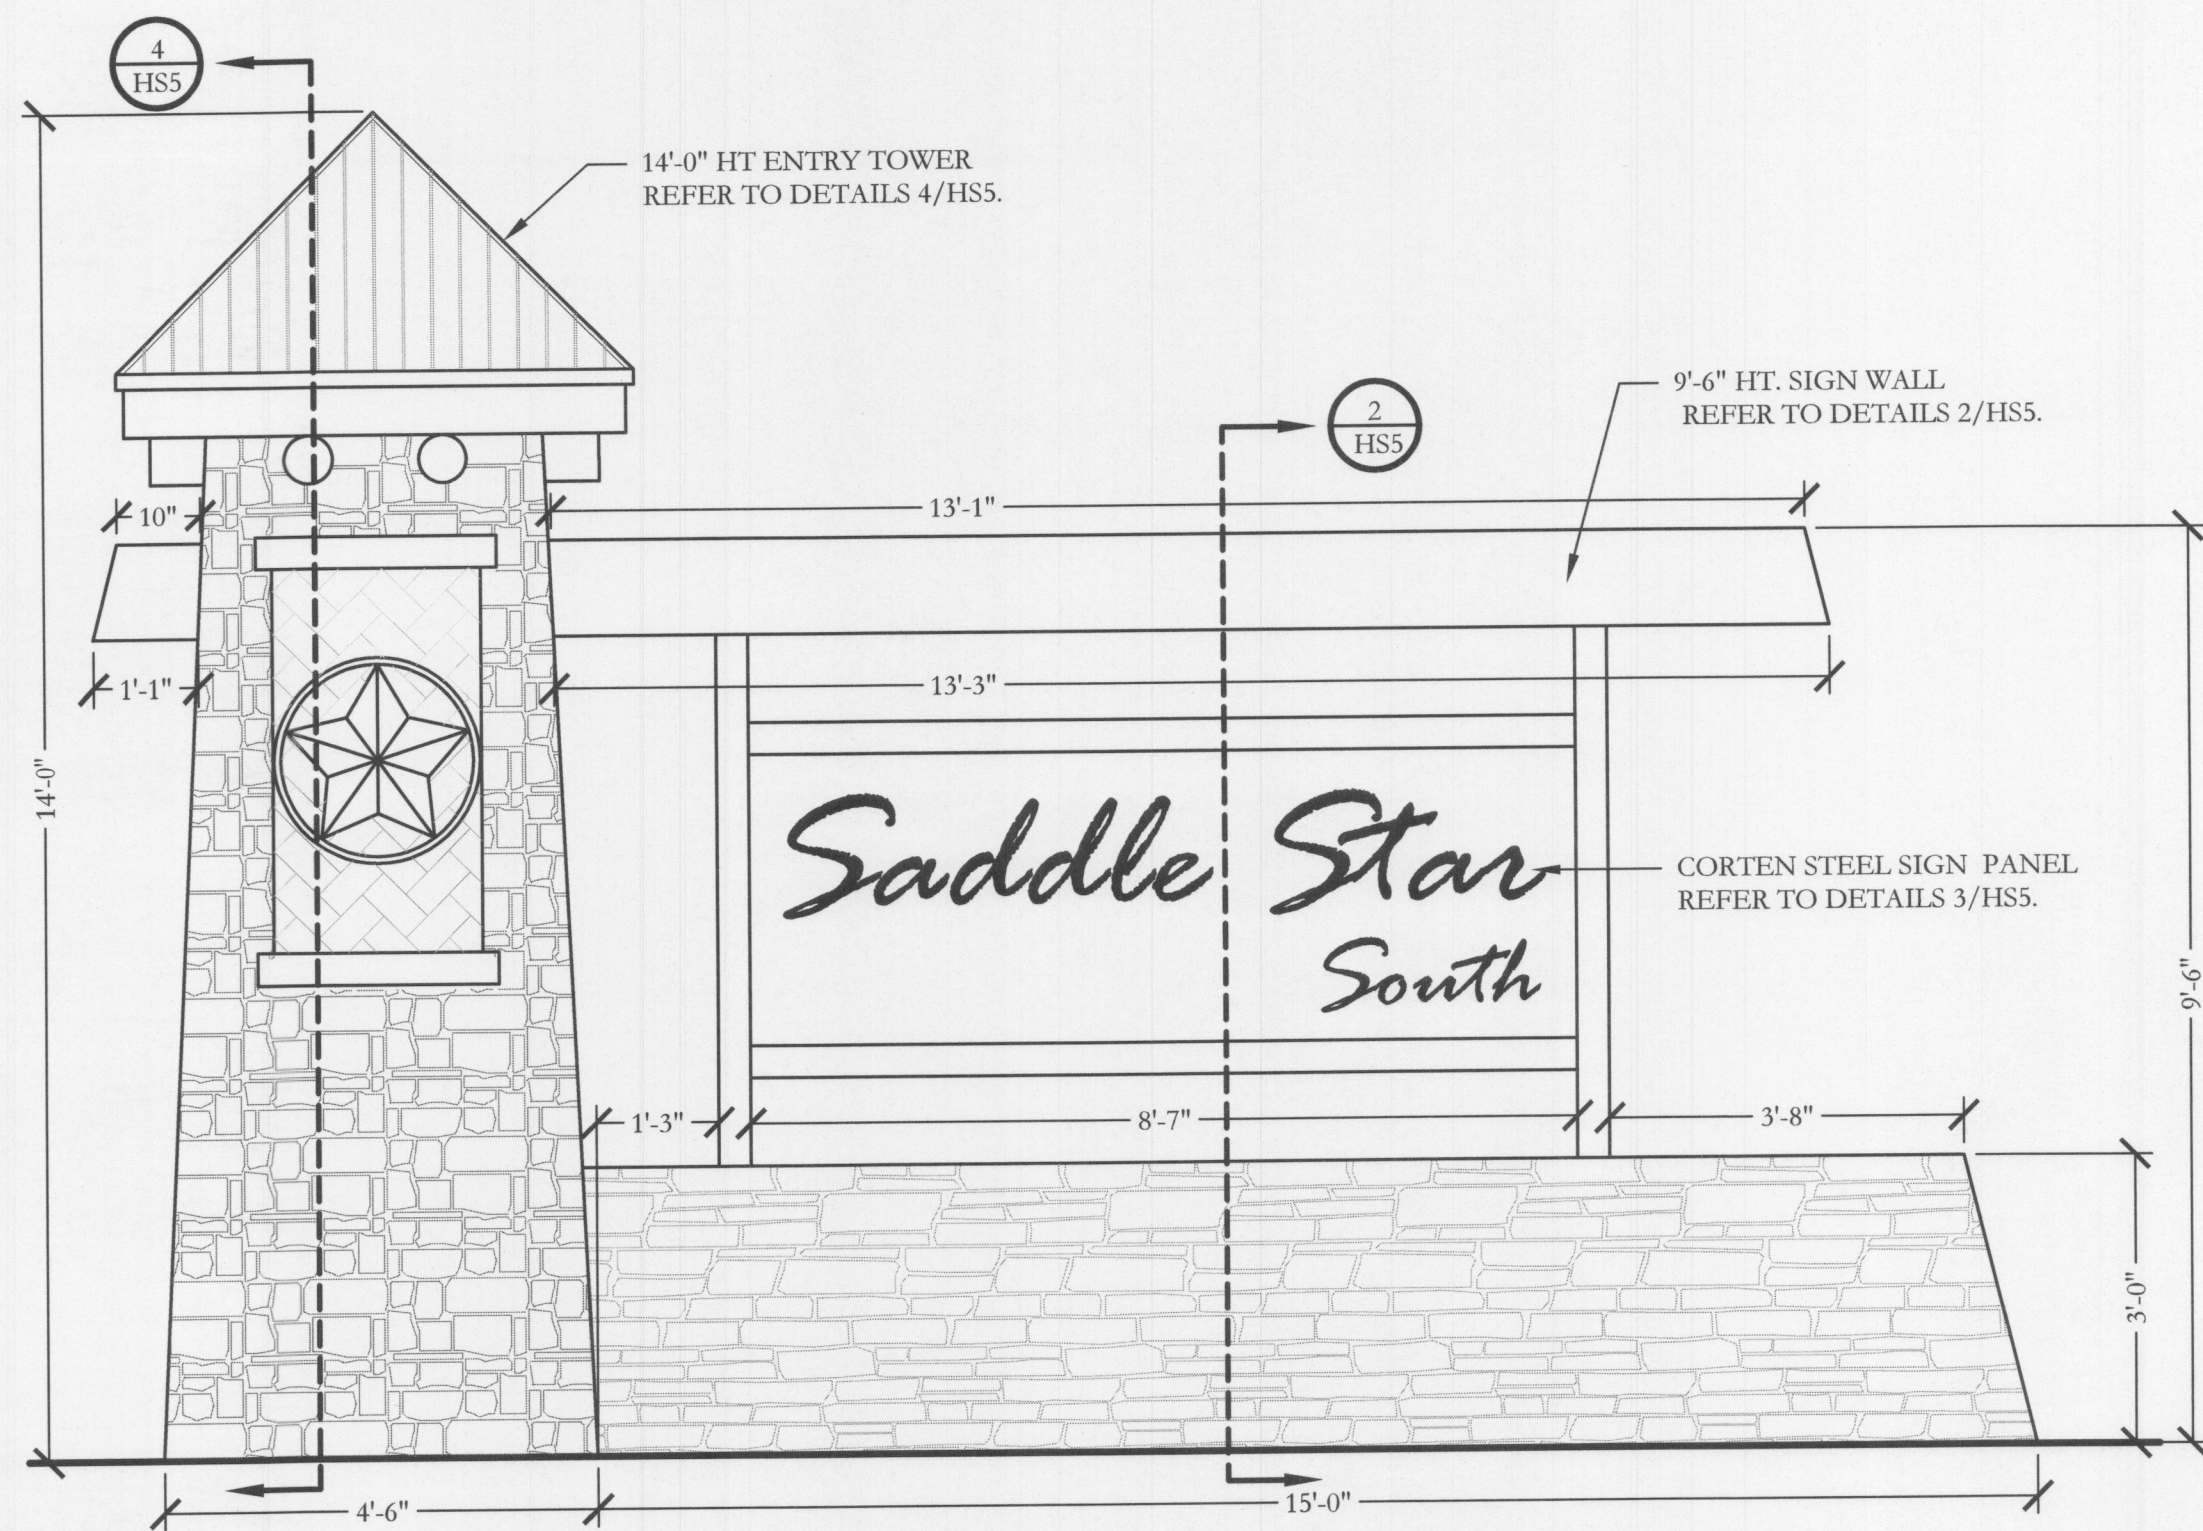


1 ENTRY SIGN MONUMENT  
ELEVATION

SCALE: 1/2" = 1'-0"

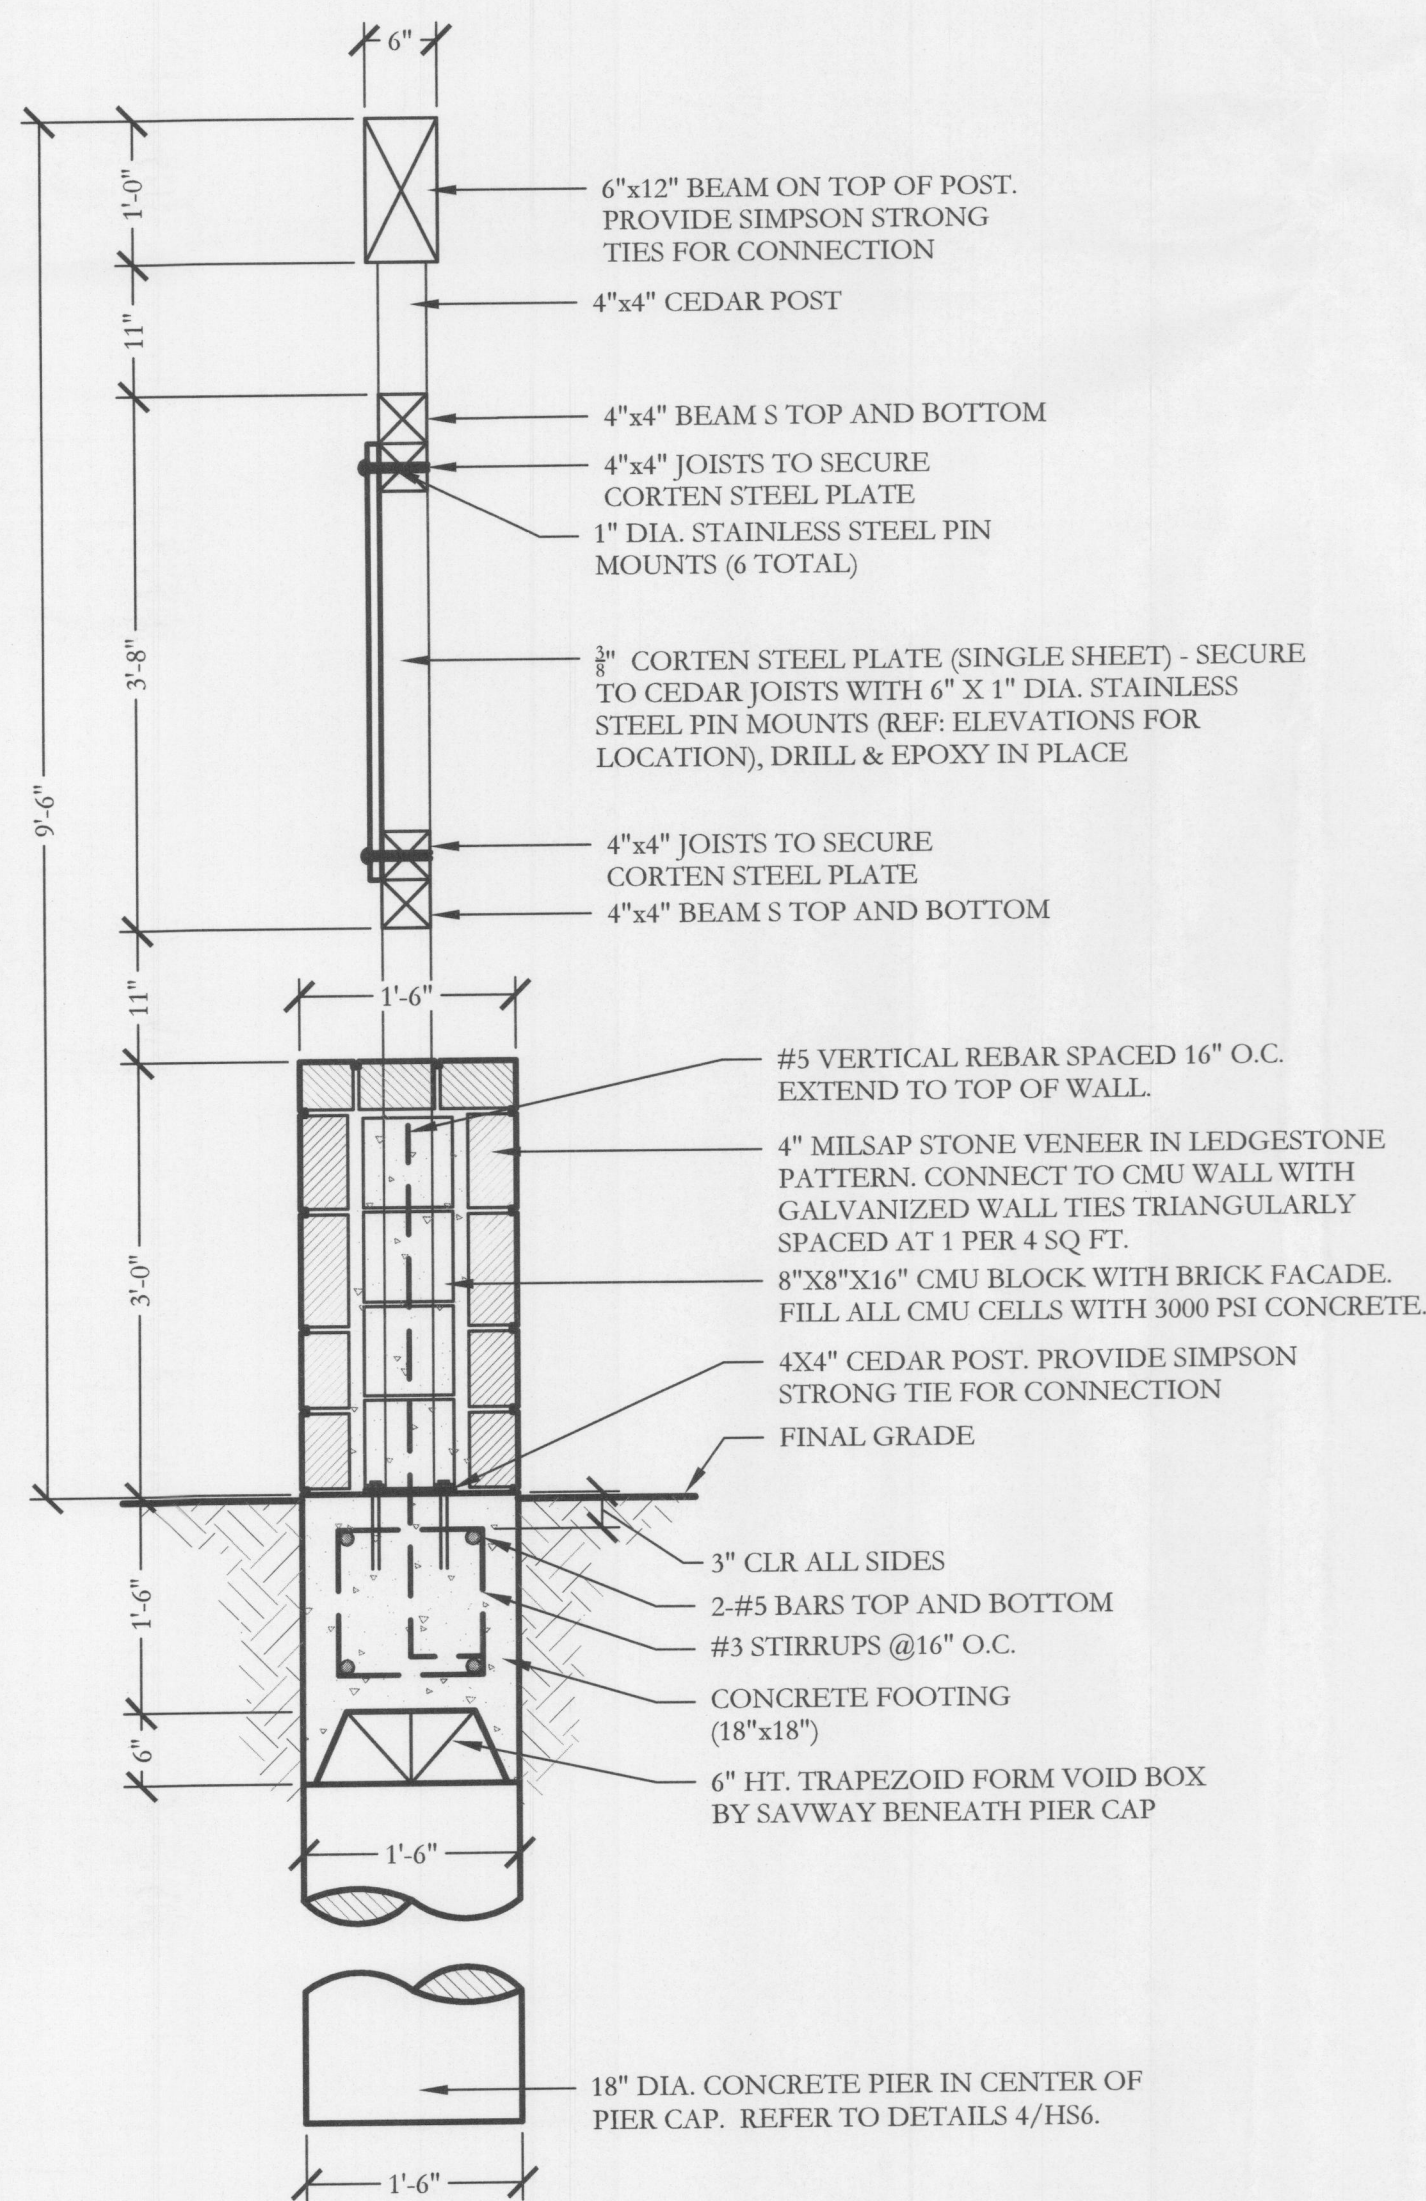


2 9'-6" HT. SIGN WALL  
ELEVATION

SCALE: 3/4" = 1'-0"

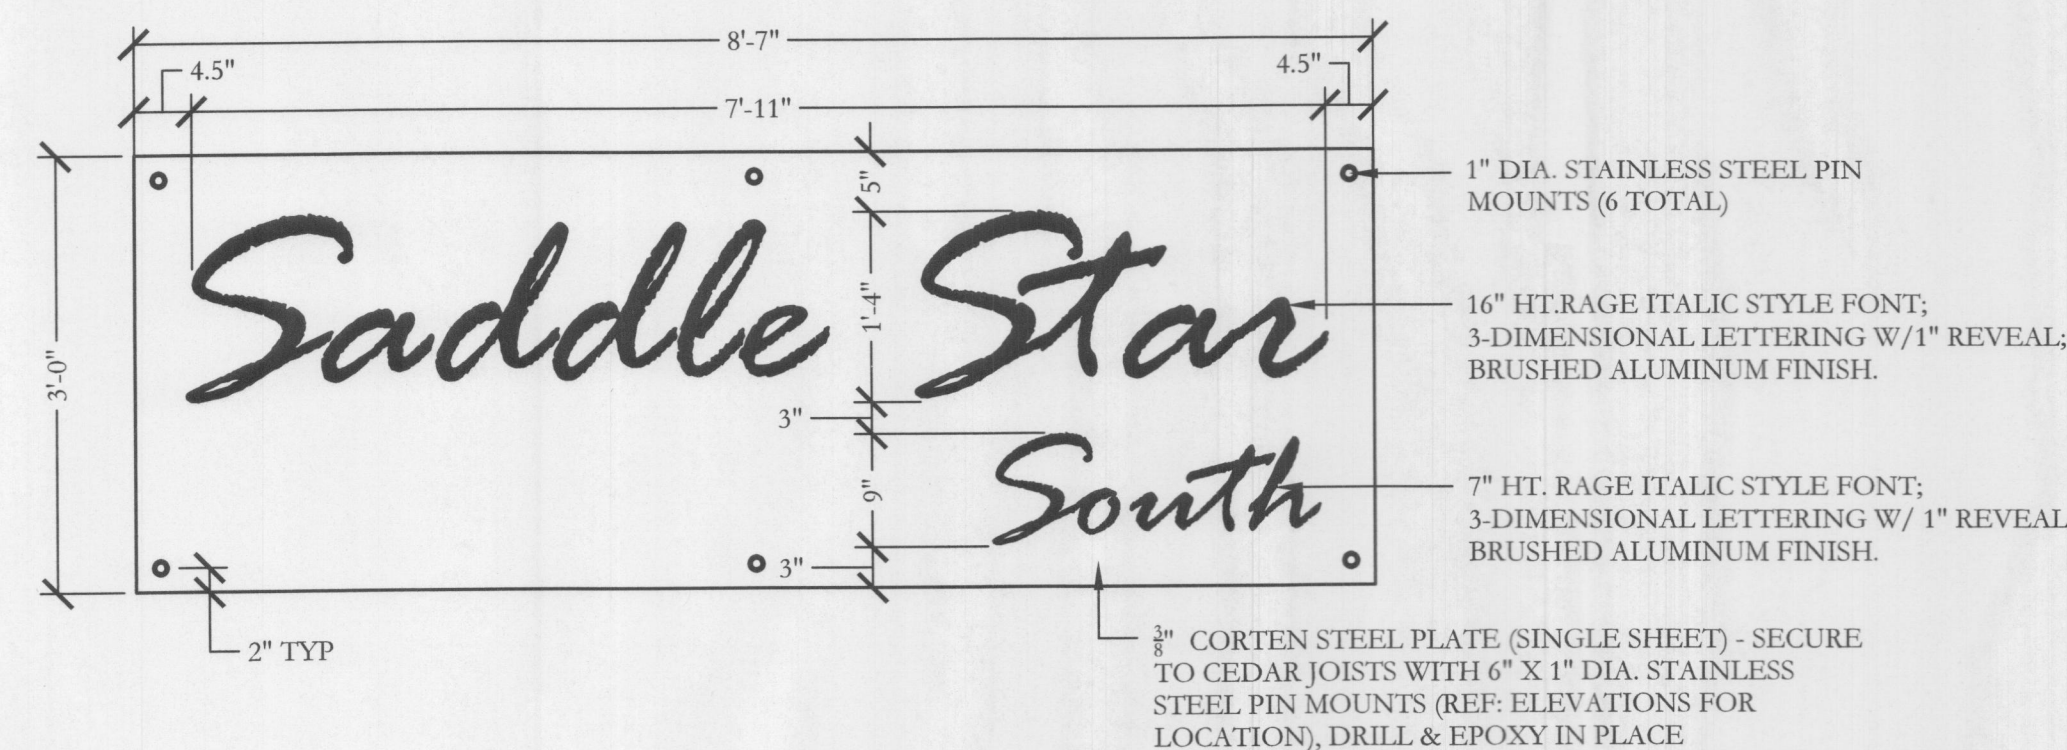

3 CORTEN STEEL SIGN PANEL  
ELEVATION

SCALE: 3/4" = 1'-0"

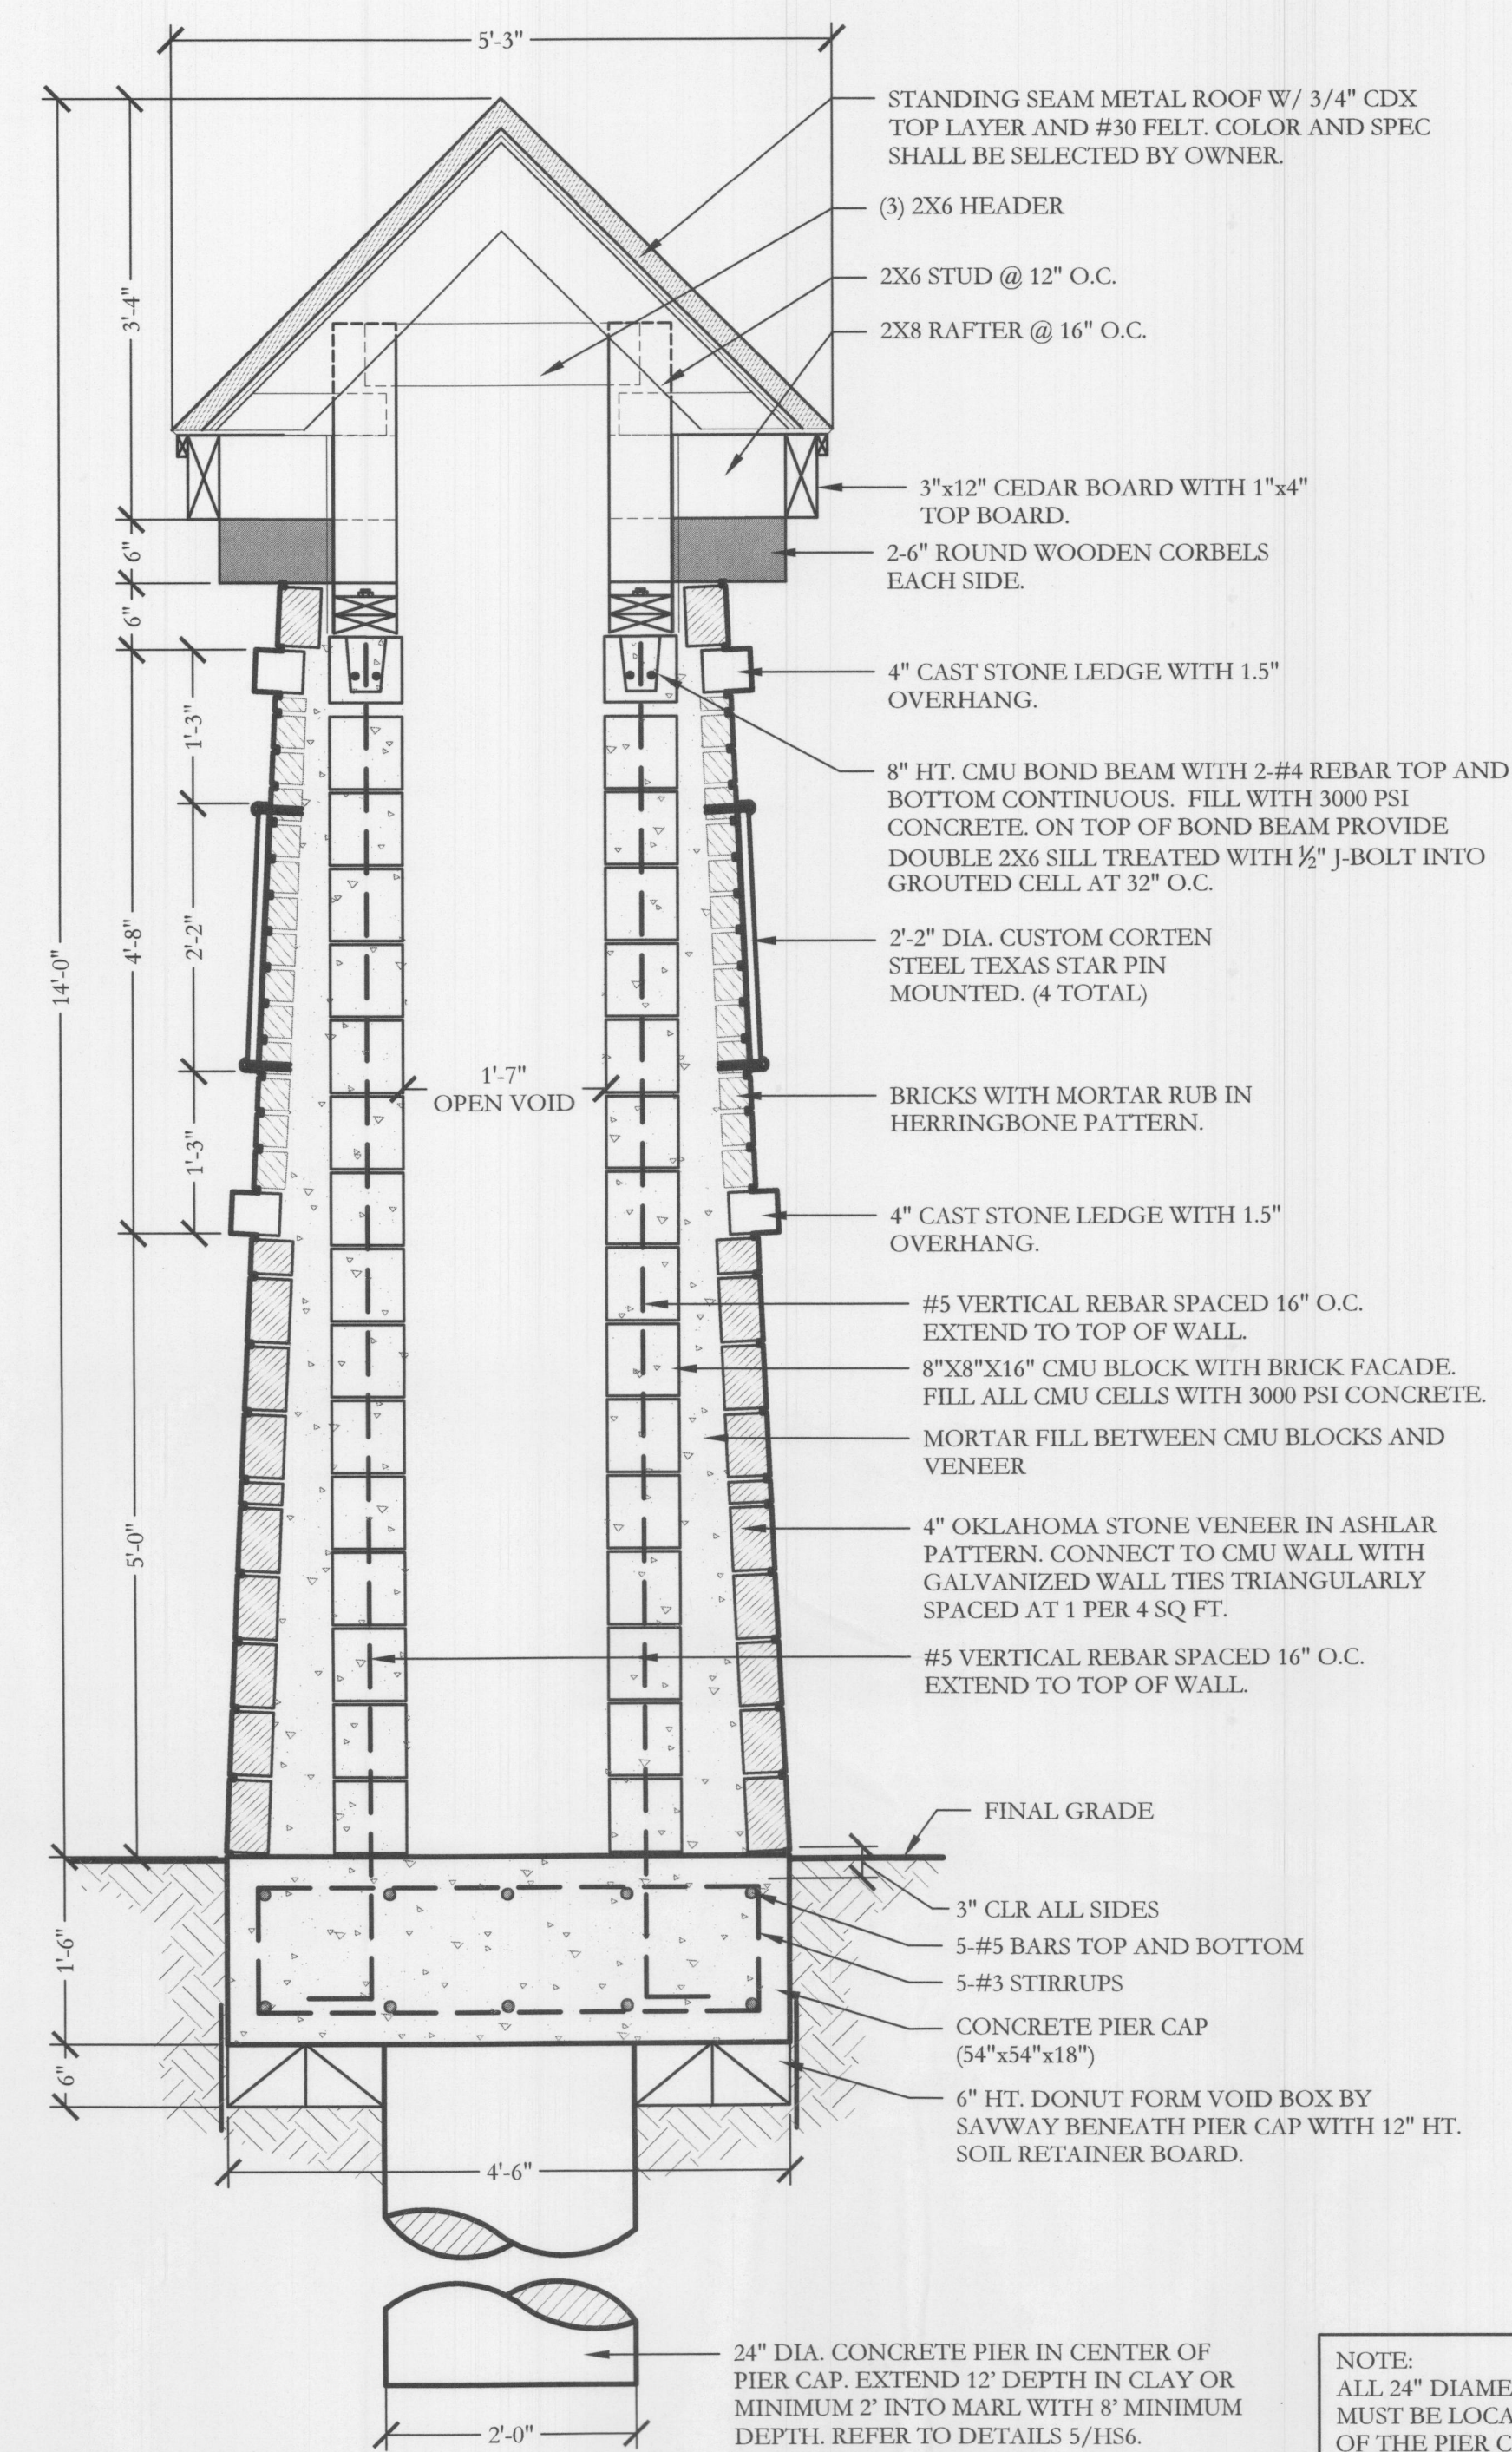






4 14'-0" HT. STONE ENTRY TOWER  
SECTION

SCALE: 3/4" = 1'-0"

**APPROVED:**  
I hereby certify that the above and foregoing site plan for a development in the City of Rockwall, Texas, was approved by the Planning & Zoning Commission of the City of Rockwall on the 16 day of February, 2022.

WITNESS OUR HANDS, this 16 day of February, 2022.  
\_\_\_\_\_  
Planning & Zoning Commission, Chairman  
\_\_\_\_\_  
Director of Planning and Zoning



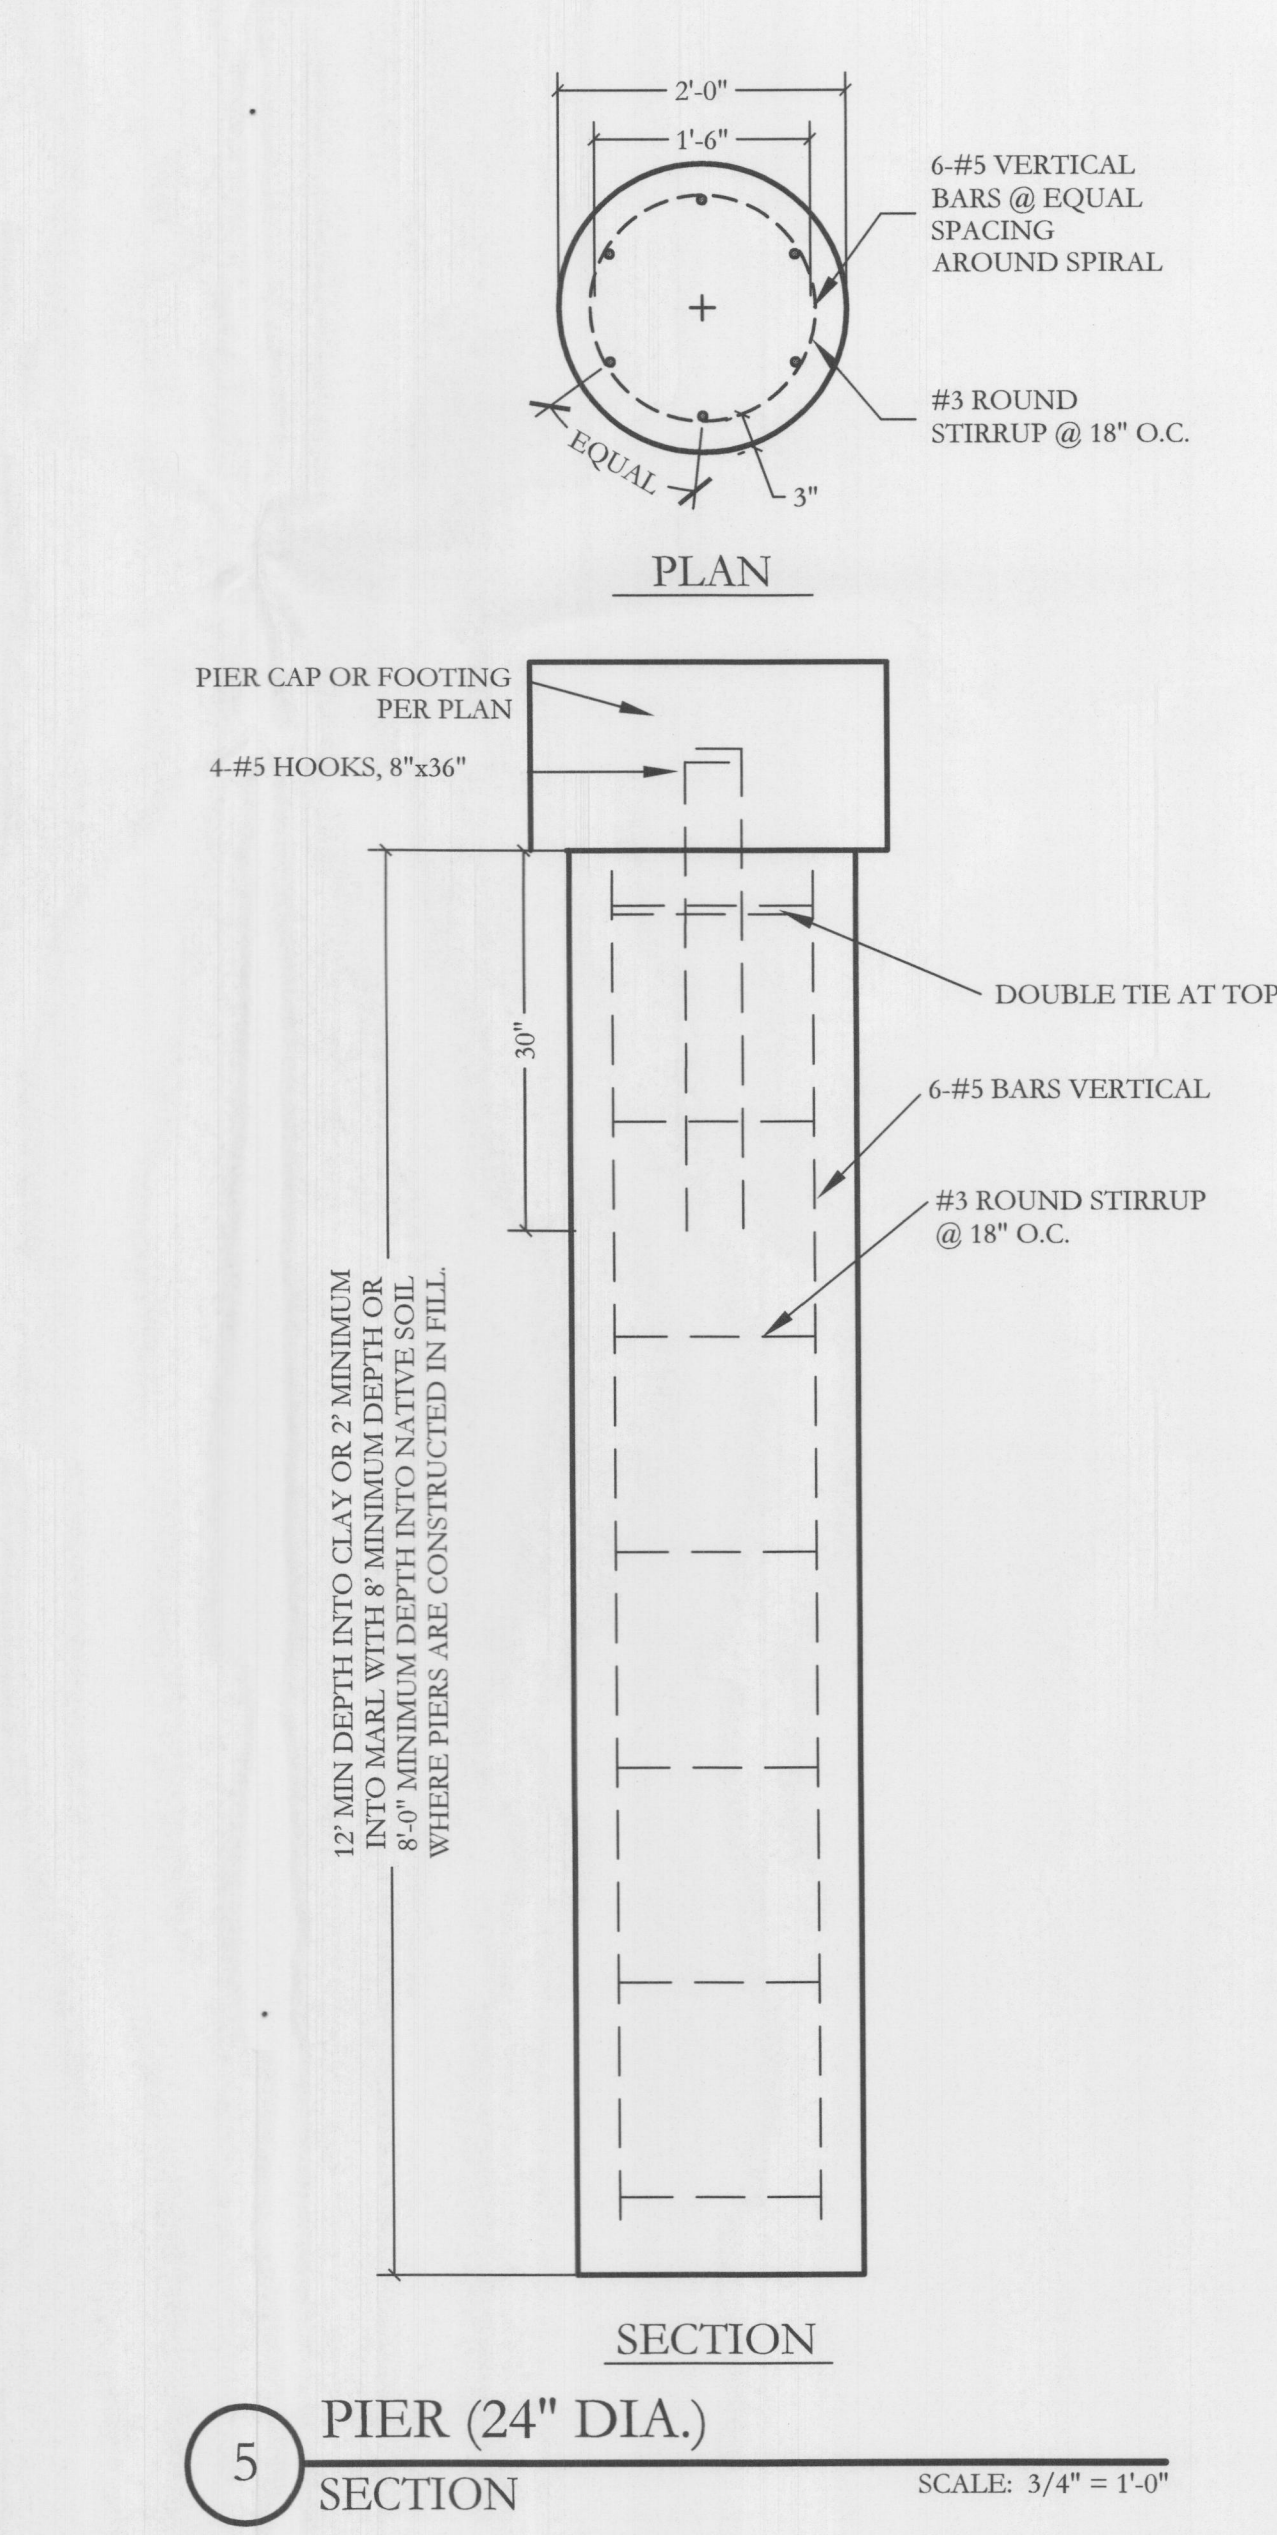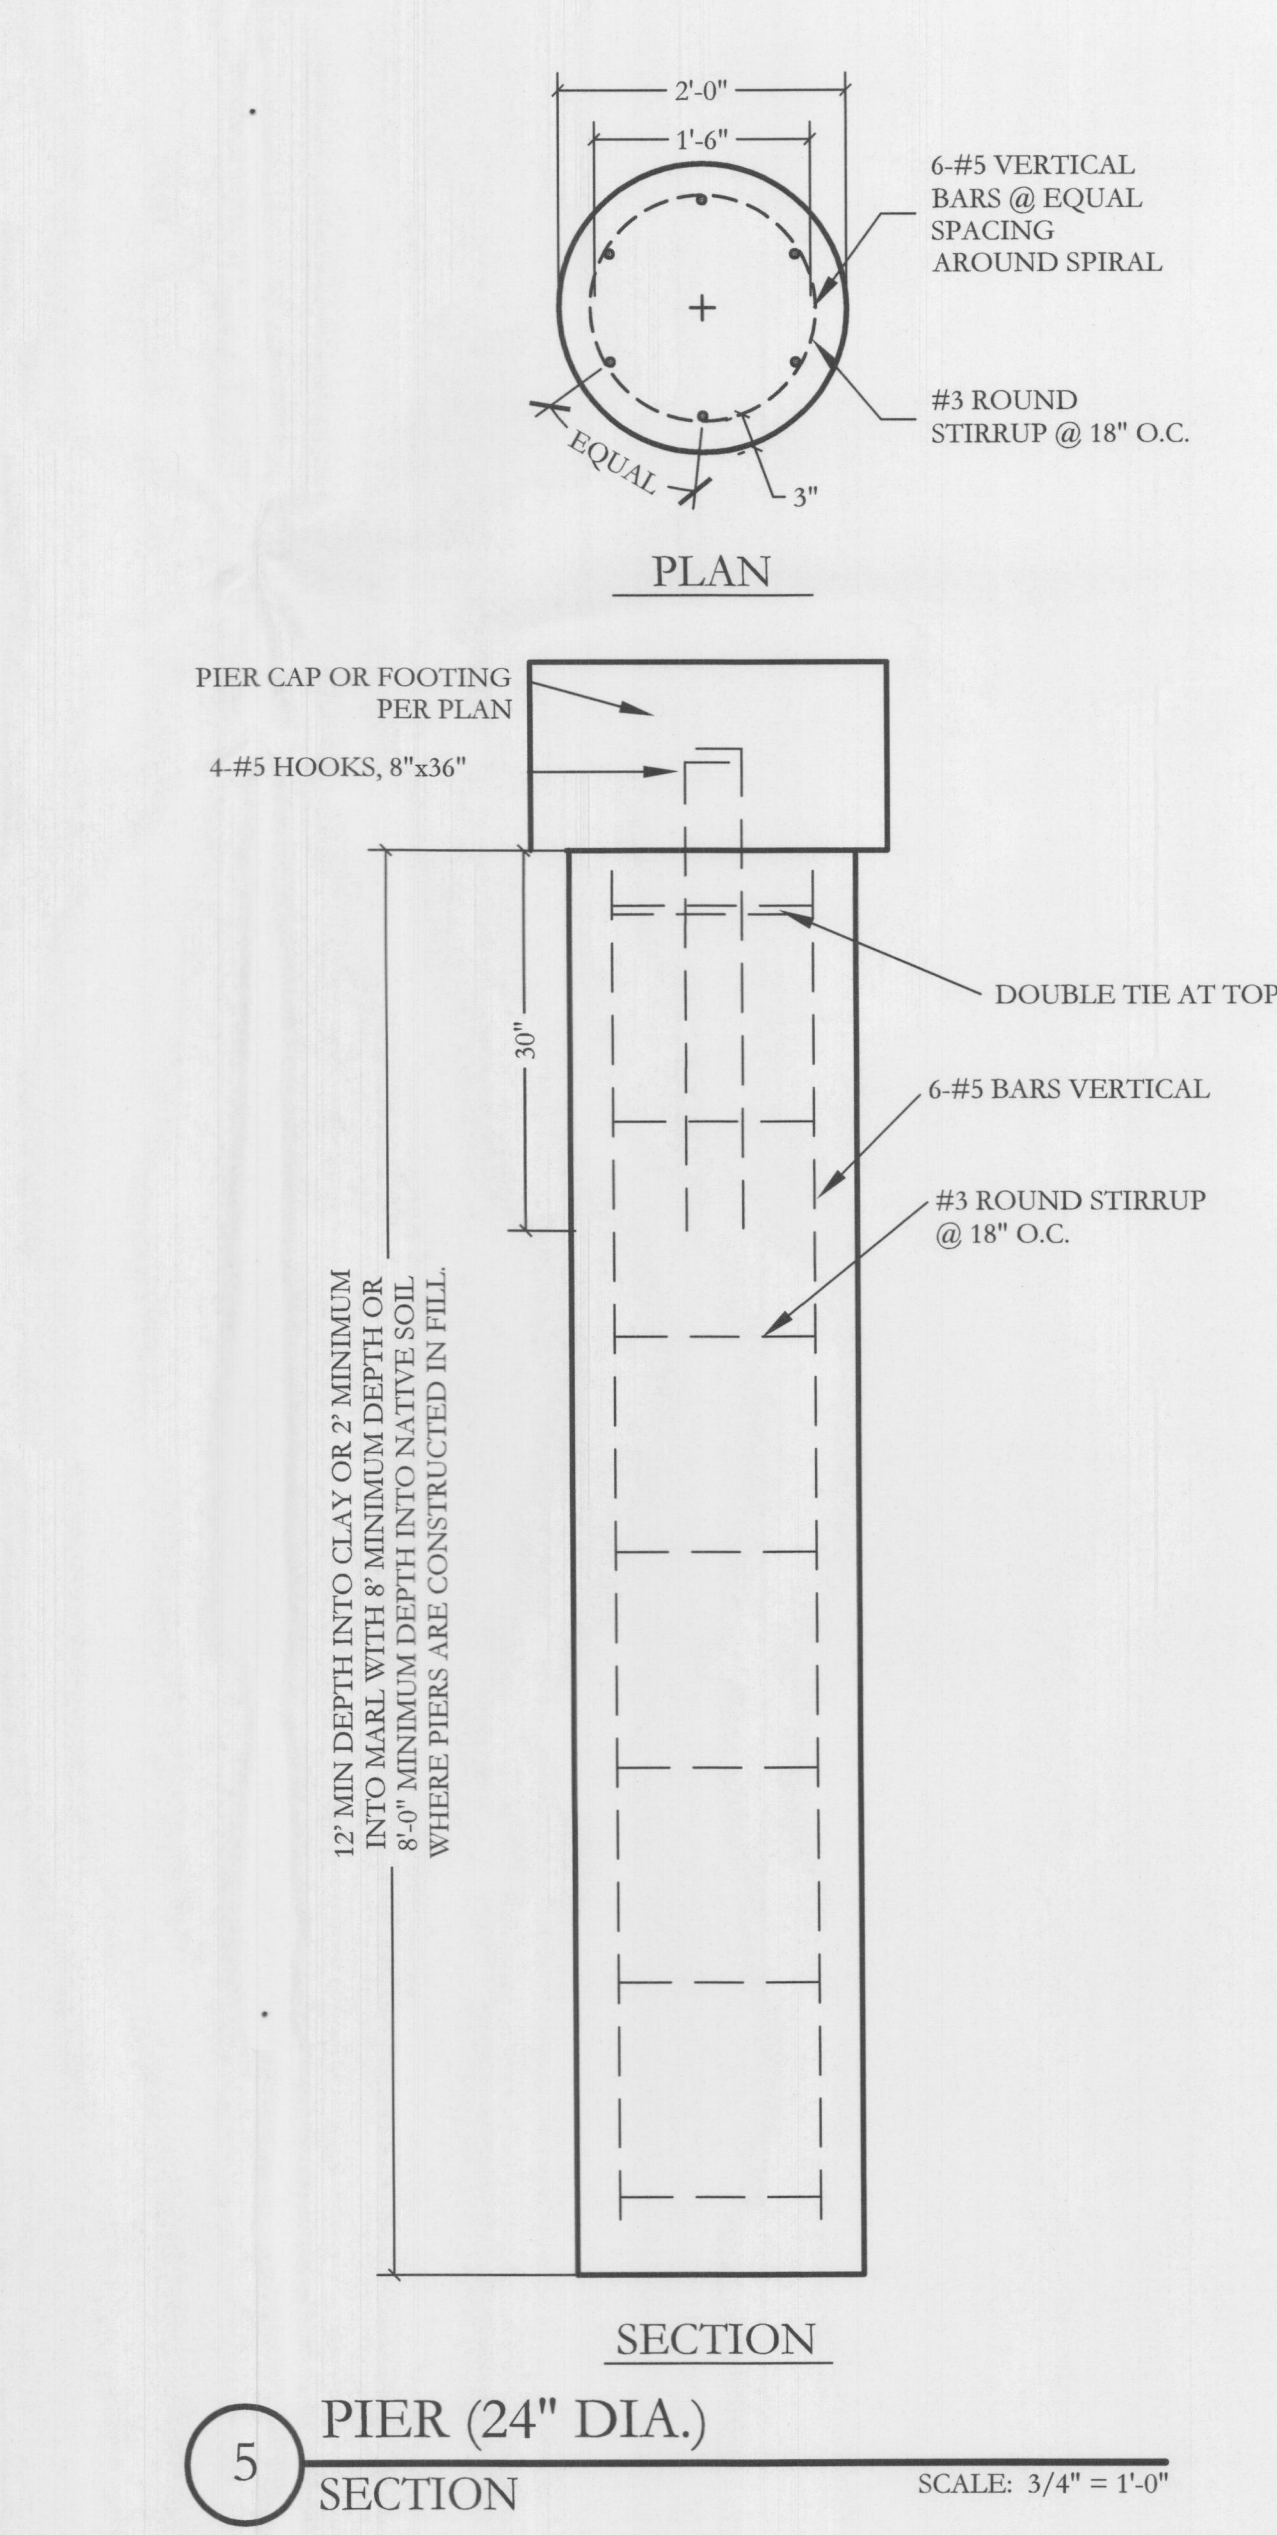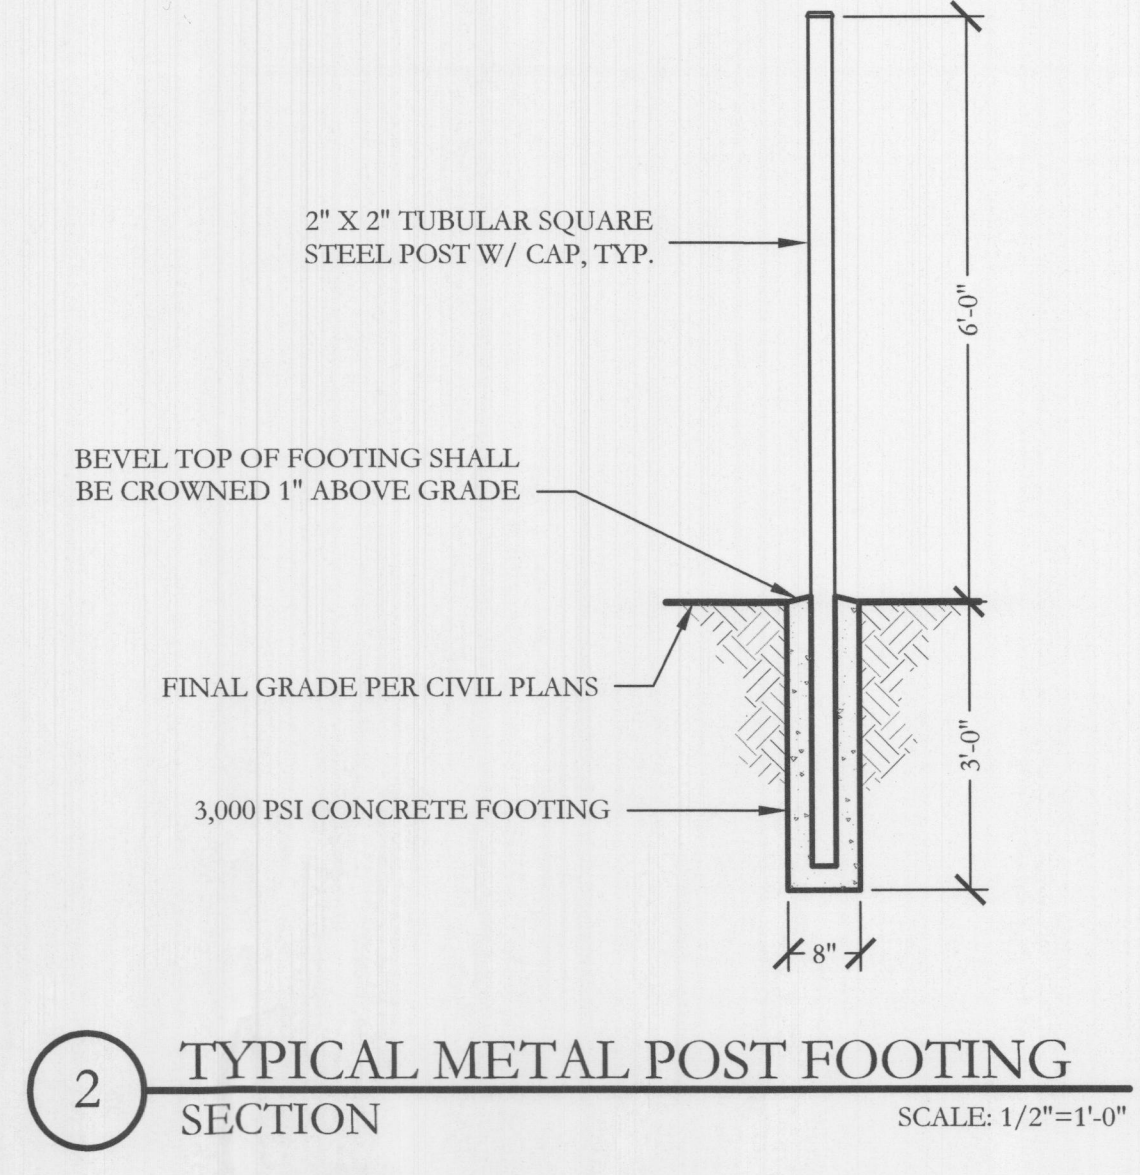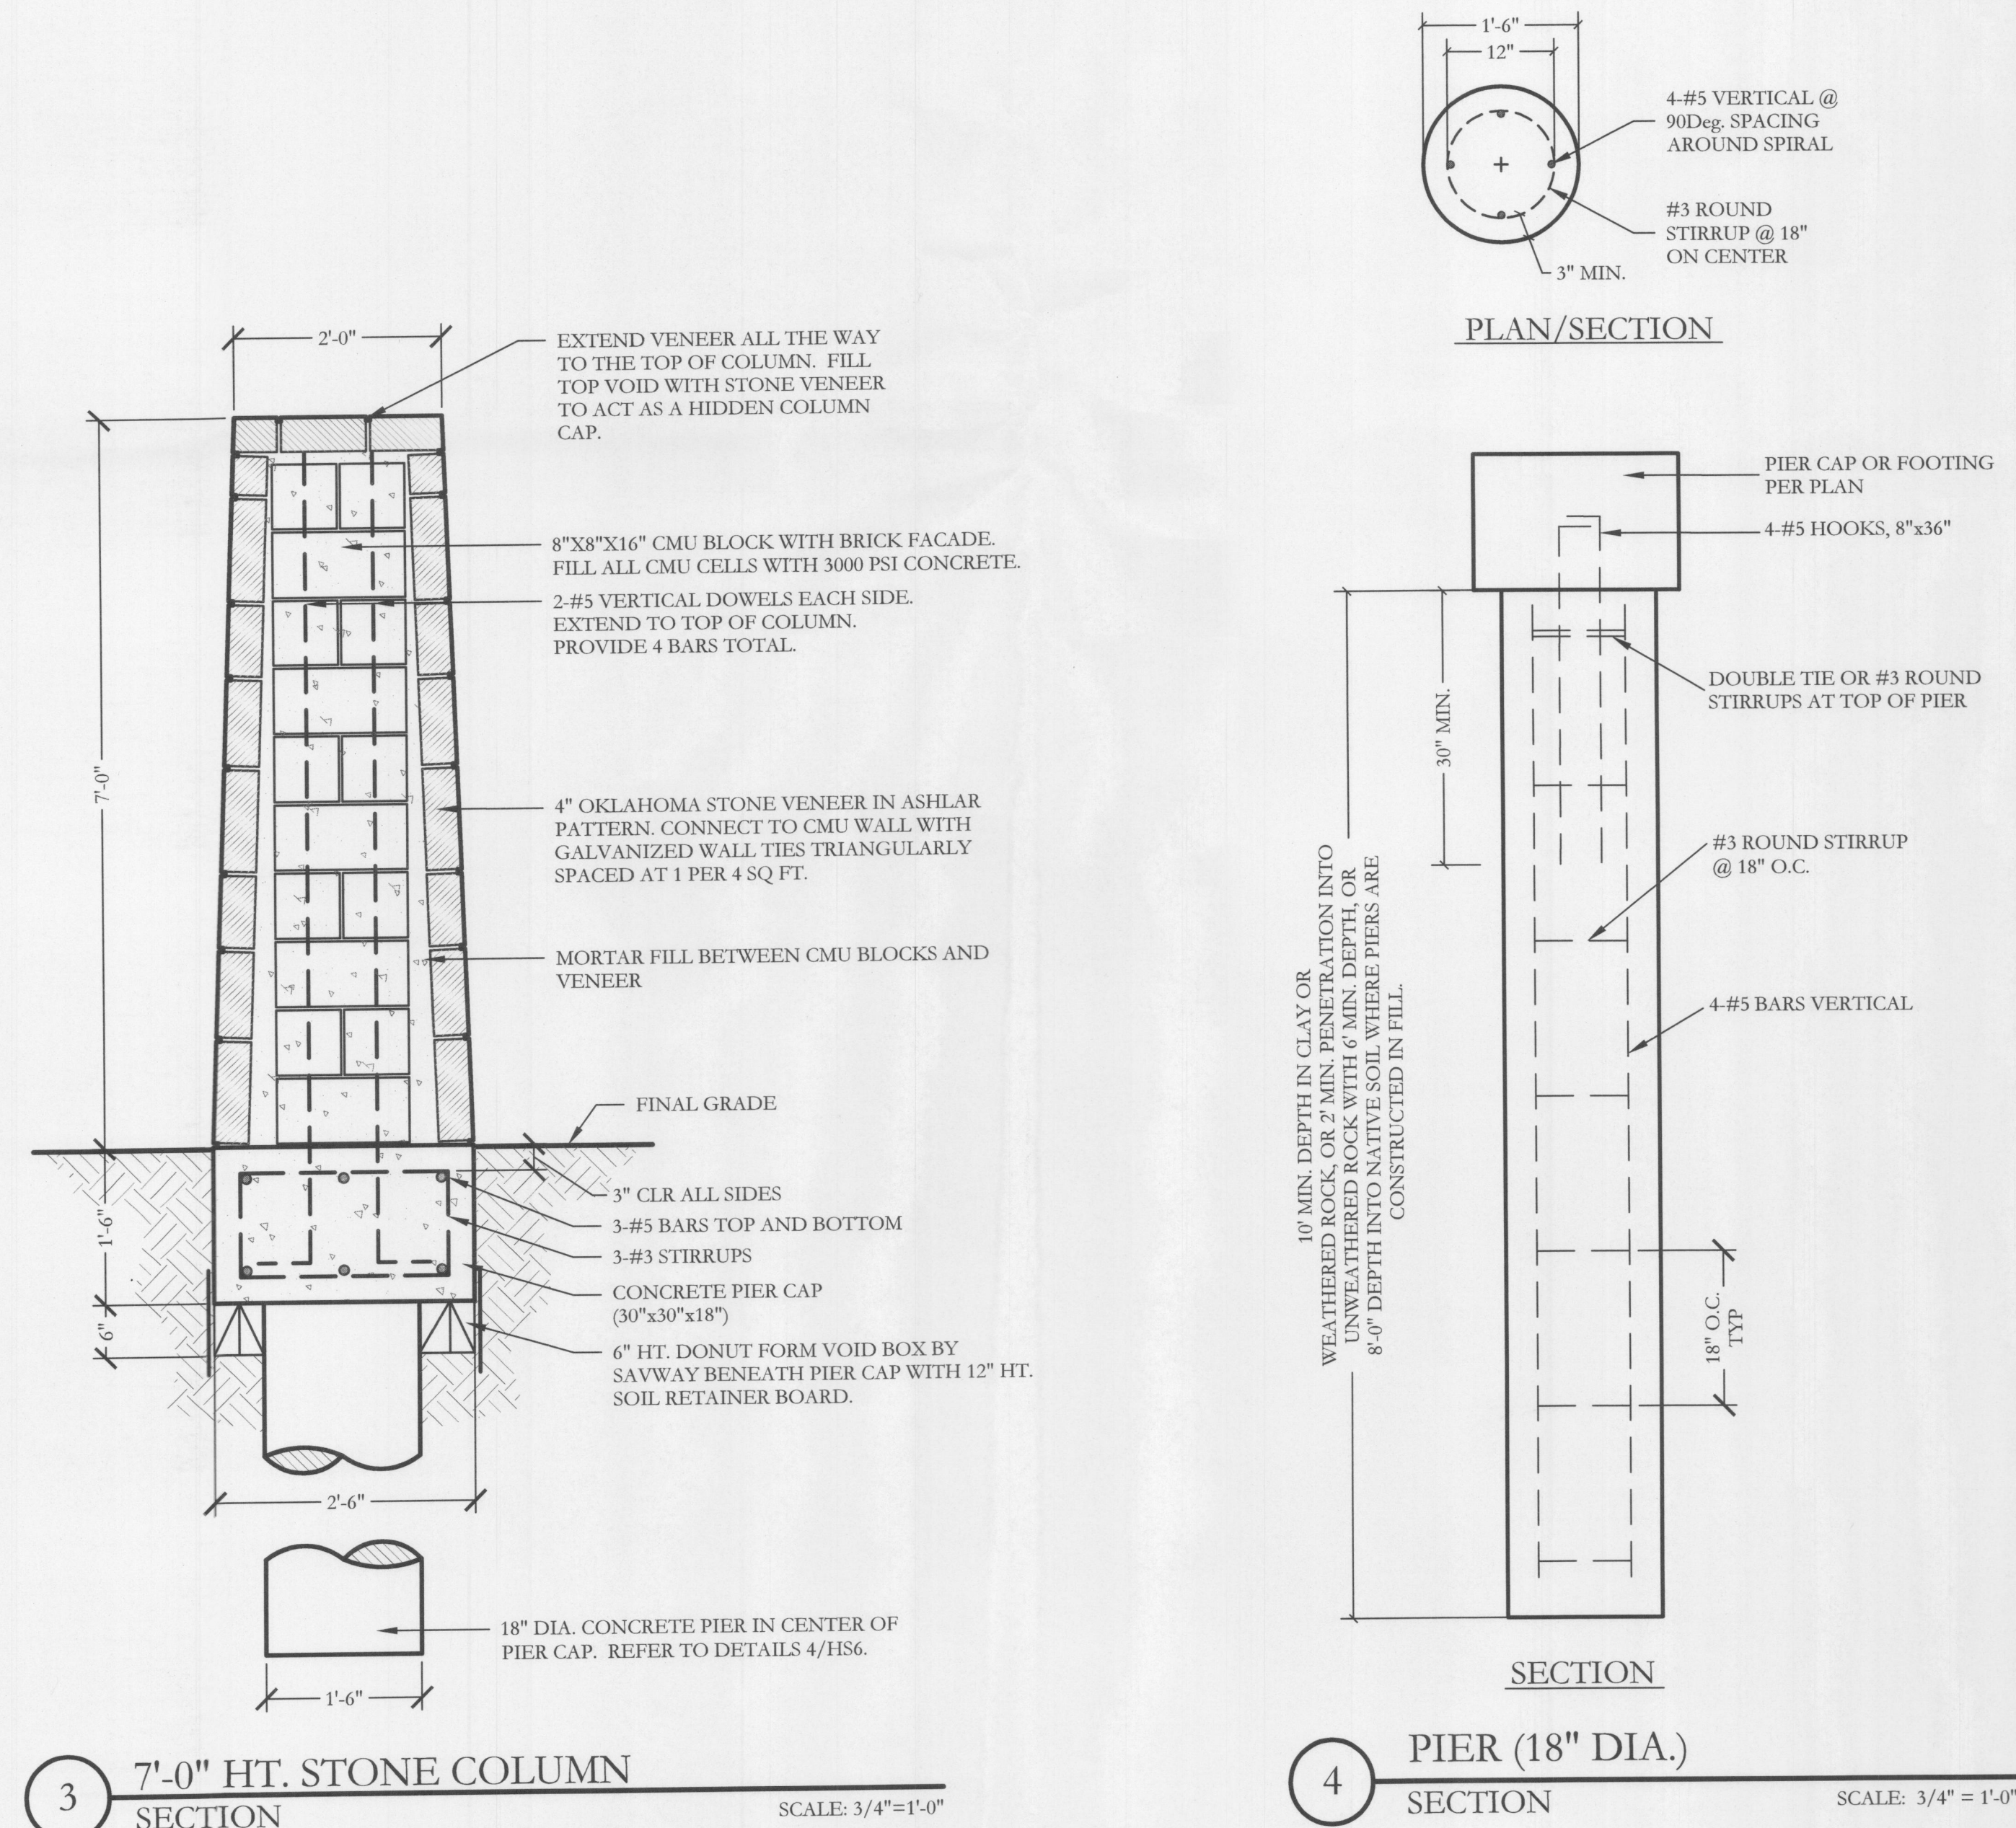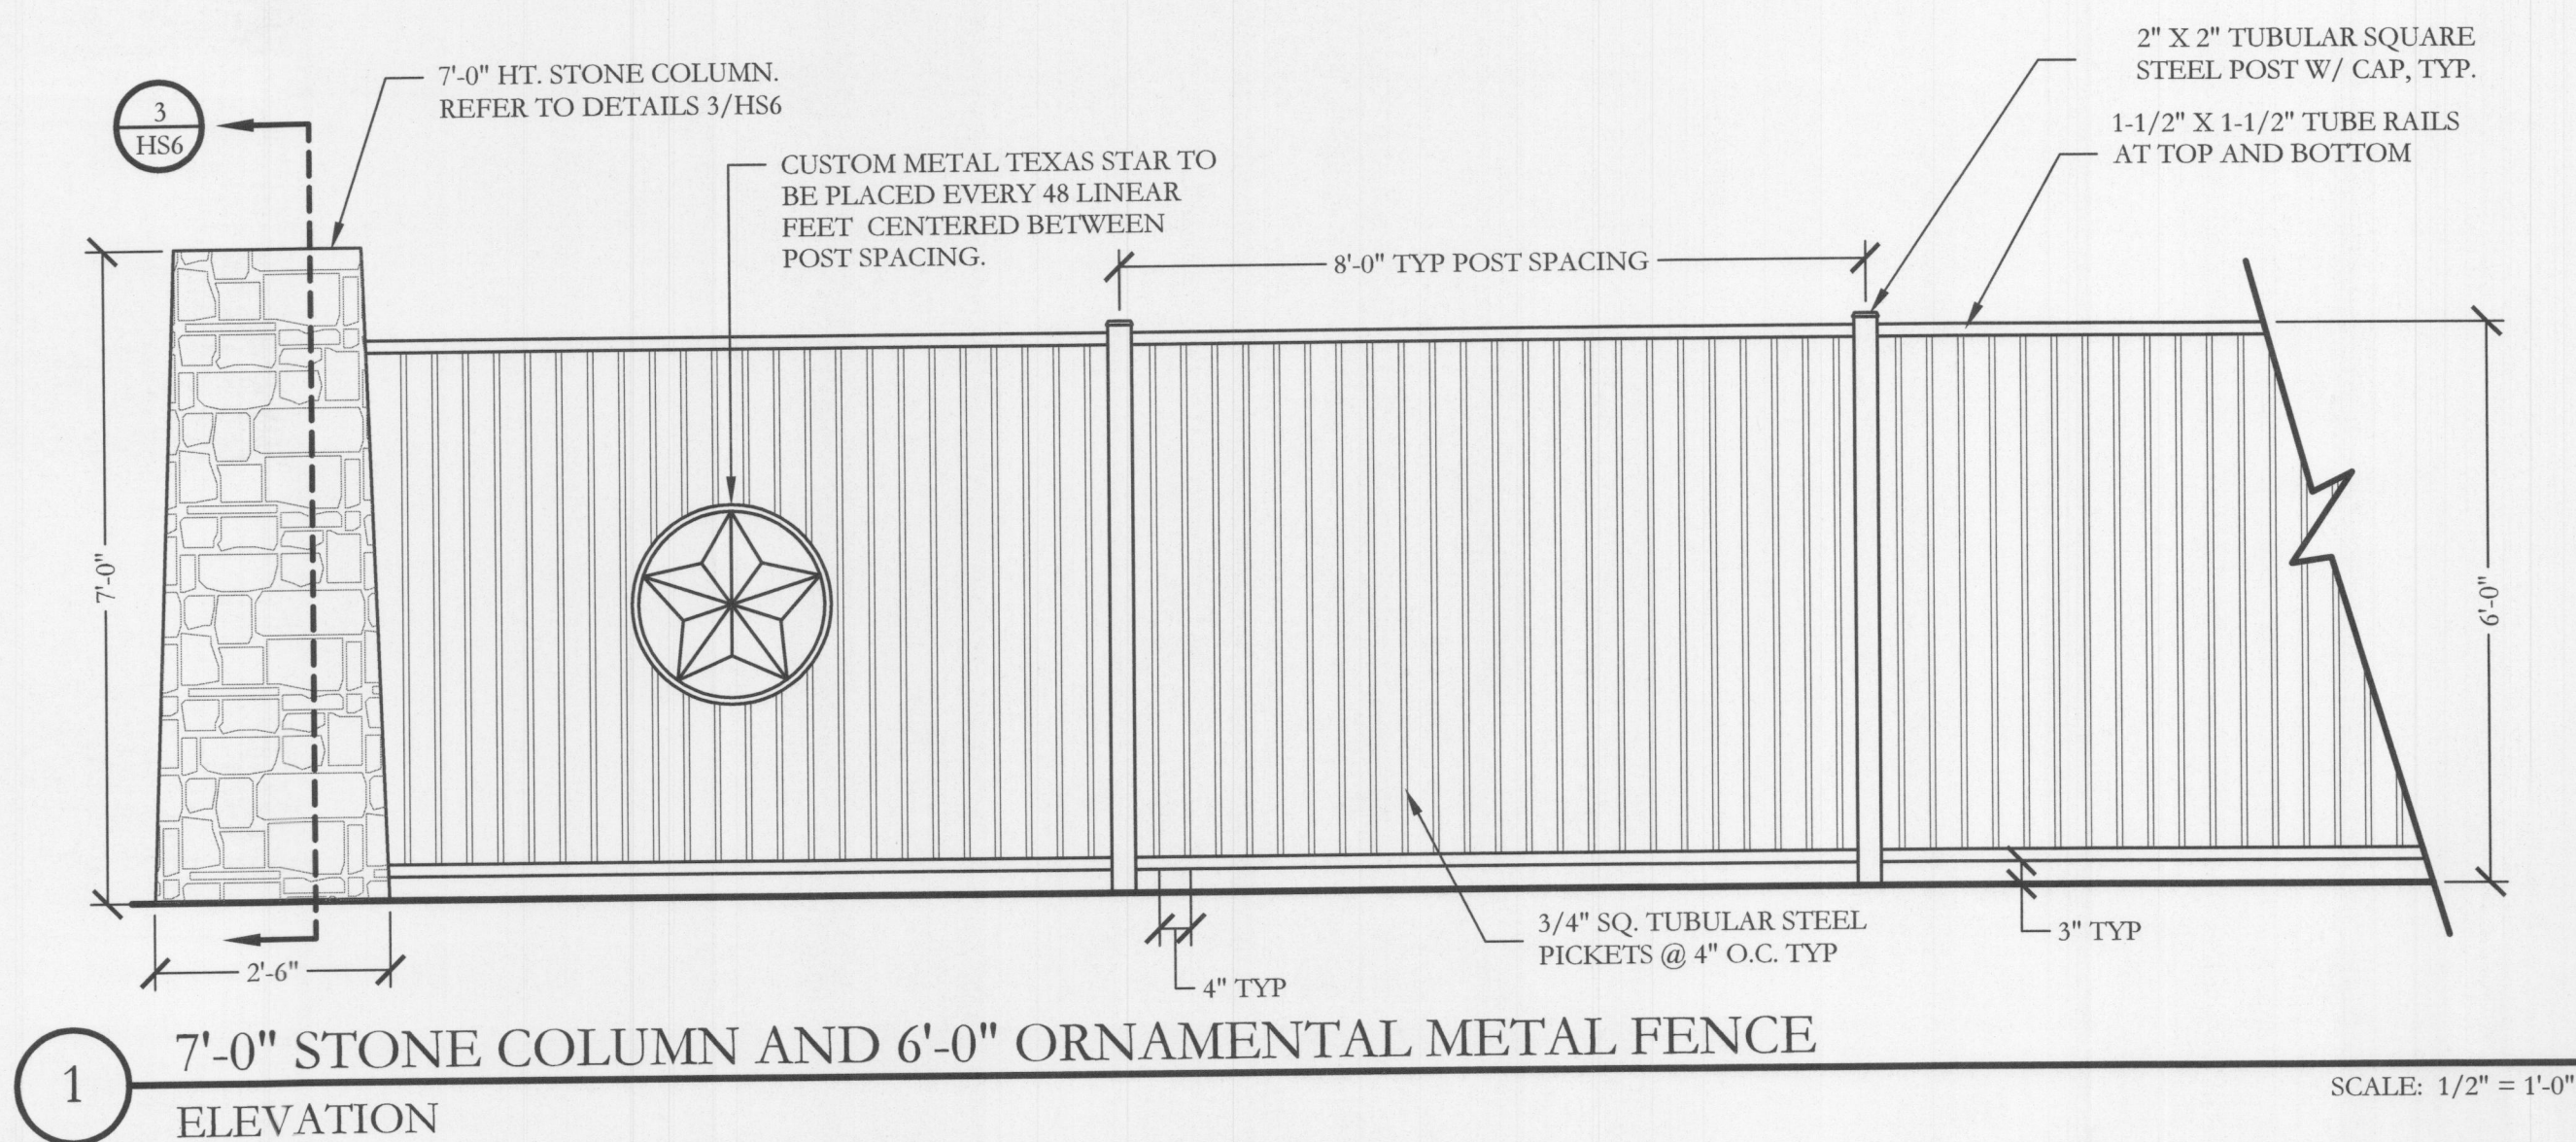

## GENERAL NOTES - HARDSCAPE CONSTRUCTION

- CAST-IN-PLACE CONCRETE**
- ALL CONCRETE SHALL BE 3000 PSI, NORMAL WEIGHT, 28 DAY STRENGTH WITH A 4 TO 6 INCH SLUMP. THE CEMENT SHALL BE TYPE I AND SHALL CONFORM TO ASTM C150. AGGREGATES SHALL CONFORM TO ASTM C33.
  - ALL MIXING, TRANSPORTING, PLACING, AND CURING OF CONCRETE SHALL COMPLY WITH ACT 318.
  - CONCRETE SHALL NOT BE PLACED IN RAINING OR FREEZING WEATHER.
  - CHLORIDES SHALL NOT BE USED.
  - MAXIMUM AGGREGATE SIZE = 1".
- CONCRETE REINFORCING STEEL**
- ALL REINFORCEMENT SHALL CONFORM TO ASTM A615 60 GRADE AND DEFORMED PER ASTM A305. PROVIDE 38 BAR DIAMETER LAP SPLICES FOR ALL CONTINUOUS BARS UNLESS NOTED OTHERWISE.
  - PROVIDE THE FOLLOWING MINIMUM COVER FOR CONCRETE CAST IN PLACE REINFORCEMENT:
    - CONCRETE CAST AGAINST EARTH AND PERMANENTLY EXPOSED TO EARTH: 3 INCHES
    - CONCRETE EXPOSED TO EARTH OR WEATHER:
      - (A) BARS LARGER THAN NO. 5: 2 INCHES
      - (B) BARS NO. 5 AND SMALLER: 1-1/2 INCHES.
    - CONCRETE NOT EXPOSED TO EARTH OR WEATHER:
      - (A) BARS LARGER THAN NO. 11: 1-1/2 INCHES
      - (B) BARS NO. 11 AND SMALLER: 3/4 INCHES.
    - BEAMS AND COLUMNS: 1-1/2 INCHES
    - SHELLS AND FOLDED PLATES
      - (A) BAR LARGER THAN NO. 5: 3/4 INCHES
      - (B) BARS NO. 5 AND SMALLER: 1/2 INCHES.
  - ALL REINFORCING STEEL SHALL BE CLEAN AND FREE OF GREASE.

- DRILLED PIERS**
- PIERS NOT SPECIFICALLY LOCATED ON THE PLAN SHALL BE CENTERED ON WALL OR BEAM.
  - PIER REINFORCING AND CONCRETE SHALL BE PLACED IMMEDIATELY OR TO WITHIN A MAXIMUM OF 8 HOURS AFTER DRILLING IS COMPLETE.
  - STEEL CASING IS REQUIRED WHEN MORE THAN 2 INCHES OF STANDING WATER IS PRESENT AT THE BOTTOM OF THE SHAFTS PRIOR TO PLACEMENT OF STEEL AND CONCRETE.
  - PROVIDE 64 BAR DIAMETER LAP SPLICES IN ALL VERTICAL PIER REINFORCING AS REQUIRED
  - PROVIDE PIER TO GRADE BEAM DOWELS TO MATCH SIZE, QUANTITY, AND LOCATION OF LONGITUDINAL PIER REINFORCING. MIN DOWEL PROJECTION INTO PIER = 30 BAR DIA. MIN DOWEL PROJECTION INTO BEAM = TOP LONGITUDINAL GRADE BEAM REINFORCING. PROVIDE STANDARD HOOK AT TERMINAL END OF DOWEL IN GRADE BEAM.

- STRUCTURAL CONCRETE MASONRY UNIT**
- CONCRETE MASONRY UNITS SHALL BE HOLLOW LOAD-BEARING TYPE N-1 CONFORMING TO ASTM C90 AND HAVE A MINIMUM COMPRESSIVE STRENGTH OF 1900 PSI.
  - CONCRETE MASONRY UNITS SHALL HAVE A MINIMUM PRISM STRENGTH OF 1500 PSI AT 28 DAYS.
  - MORTAR SHALL BE ASTM C270, TYPE S, WITH A MINIMUM COMPRESSIVE STRENGTH OF 1800 PSI IN ACCORDANCE WITH ASTM C780. MASONRY CEMENT IS PROHIBITED.
  - COARSE GROUT SHALL HAVE A MINIMUM COMPRESSIVE STRENGTH OF 2500 PSI AND A MAXIMUM AGGREGATE SIZE OF 1/2" IN ACCORDANCE WITH ASTM C476. REFER TO DETAILS FOR WALL REINFORCING BAR SIZE AND SPACING.
  - REINFORCE HORIZONTAL JOINTS WITH GALVANIZED LADDER TYPE STEEL IN ACCORDANCE WITH ANSI/ASTM A82. SIDE AND CROSS RODS SHALL BE 9 GA MINIMUM.
  - HORIZONTAL REINFORCEMENT SHALL BE SPACED AT 16" MAXIMUM. PROVIDE A 16" LAP AT SPLICES.
  - JOINT REINFORCING SHALL BE DISCONTINUOUS AT CONTROL AND EXPANSION JOINTS.
  - LAP VERTICAL REINFORCING BARS AT 72 BAR DIAMETERS.
  - LAP HORIZONTAL REINFORCING BARS AT 48 BAR DIAMETERS.
  - PLACE GROUT USING LOW-LIFT METHOD, 6'-8" MAXIMUM LIFTS.

## WALL NOTES

- THESE DETAILS AND SPECIFICATIONS ARE APPLICABLE ONLY FOR THE SITE CONDITIONS AND HEIGHTS SHOWN HEREIN. IF CONDITIONS CHANGE FROM THOSE DESCRIBED HEREIN, THE ENGINEER SHOULD BE NOTIFIED IMMEDIATELY TO DETERMINE THE EFFECT, IF ANY, ON THE STRUCTURAL DESIGN AND LAYOUT.
- THE CONTRACTOR IS RESPONSIBLE FOR MAKING HIMSELF FAMILIAR WITH ALL UNDERGROUND UTILITIES, PIPES, AND STRUCTURES EITHER SHOWN OR NOT SHOWN ON THE PLANS. THE CONTRACTOR WILL BE RESPONSIBLE FOR ANY COST INCURRED DUE TO DAMAGE OR REPLACEMENT OF SAID UTILITIES AND STRUCTURES CAUSED BY HIS FORCES.
- ALL EARTHWORK SHALL BE PERFORMED AS INDICATED IN THE GEOTECHNICAL INVESTIGATION. PROPER EXECUTION OF EARTHWORK SHALL BE VERIFIED BY AN INDEPENDENT TESTING LAB.
- PRE-POUR OBSERVATION OF FOOTINGS, BEAMS, AND PIERS IS RECOMMENDED BY OR UNDER THE DIRECTION OF A LICENSED PROFESSIONAL ENGINEER.
- ALL CONCRETE USED IN FOOTINGS AND PIERS SHALL HAVE A MINIMUM COMPRESSIVE STRENGTH OF 3000 PSI @ 28 DAYS. CONCRETE USED IN COLUMNS SHALL HAVE A MINIMUM COMPRESSIVE STRENGTH OF 3000 PSI @ 28 DAYS.
- ALL REINFORCING SHALL BE NEW BILLET STEEL, ASTM A615, GRADE 60 EXCEPT STIRRUPS SHALL BE GRADE 40 AND SPIRALS SHALL BE ASTM A82, GRADE 60.
- CONCRETE FOR DRILLED PIERS SHALL BE POURED WITHIN 8 HOURS OF DRILLING PIER HOLES.
- REFER TO DETAILS FOR TYPE AND SIZE OF STONE WALL REINFORCING.
- ALL MORTAR TO BE TYPE S; MORTAR COLOR TO BE SELECTED BY OWNER. MASONRY CEMENT WILL NOT BE ALLOWED.
- ALL MORTAR JOINTS ARE TO BE 3/8" CONCAVE TOOLED JOINTS.
- STONE AND BRICK VENEER MATERIAL SHALL BE SELECTED BY OWNER.
- THE CONTRACTOR IS RESPONSIBLE FOR ALL REQUIRED PERMITS, APPLICABLE FEES, AND CITY INSPECTIONS.
- LAYOUT OF THE PROPOSED SCREENING WALL SHALL BE PERFORMED IN THE FIELD BY THE OWNER'S REPRESENTATIVE AND THE CONTRACTOR PRIOR TO BEGINNING CONSTRUCTION.
- THE WALL STONE MATERIAL & PATTERN SHALL BE SELECTED BY OWNER AS NOTED ON LAY STONE COURSES LEVEL AND PLUMB. DO NOT EXCEED 1/4" VARIATION FROM LEVEL IN 20 FEET MAXIMUM.
- CLEAN STONEMASONRY PROMPTLY AFTER COMPLETION WITH FIBER BRUSHES, CLEAN WATER OR APPROVED CLEANING AGENT. DO NOT USE WIRE BRUSHES OR ACID TYPE CLEANING AGENTS.
- THE CONTRACTOR SHALL PROVIDE A 4' X 4' MOCKUP OF THE STONE AND BRICK SCREEN WALL FOR THE OWNERS REVIEW PRIOR TO BEGINNING THE STONE WORK. THE APPROVED "MOCKUP" SHALL SERVE AS THE STANDARD FOR THE STONE WORK ON THE PROJECT.
- THE CONTRACTOR SHALL OBTAIN A PERMIT FOR ALL WALL CONSTRUCTION AND SECURE ALL NECESSARY INSPECTIONS AND CERTIFICATIONS REQUIRED.

## ORNAMENTAL METAL FENCE NOTES

- THE CONTRACTOR IS RESPONSIBLE FOR MAKING HIMSELF FAMILIAR WITH ALL UNDERGROUND UTILITIES, PIPES, AND STRUCTURES EITHER SHOWN OR NOT SHOWN ON THE PLANS. THE CONTRACTOR WILL BE RESPONSIBLE FOR ANY COST INCURRED DUE TO DAMAGE OR REPLACEMENT OF SAID UTILITIES AND STRUCTURES CAUSED BY HIS FORCES.
- ALL CONCRETE USED IN FOOTING AND PIERS SHALL HAVE A MINIMUM COMPRESSIVE STRENGTH OF 3000 PSI @ 28 DAYS.
- THE CONTRACTOR IS RESPONSIBLE FOR ALL REQUIRED PERMITS AND TOWN INSPECTIONS.
- ALL ORNAMENTAL METAL TUBES, POSTS, RAILS AND PICKETS SHALL BE FLUSH AND FREE OF ALL DENTS, SPURS, AND SHARP EDGES AND SHALL BE INSTALLED LEVEL, PLUMB, AND SQUARE.
- PROVIDE CONTINUOUS WELDS ALONG ALL EDGES OF FENCE MEMBERS.
- ALL METAL SURFACES SHALL BE PRIMED AND PAINTED WITH TWO COATS OF RUSTPROOF PAINT, COLOR TO BE FLAT BLACK. CONTRACTOR TO SUBMIT SAMPLES AS REQUIRED.
- CONTRACTOR IS RESPONSIBLE FOR VERIFYING ALL DIMENSIONS BEFORE MANUFACTURING GATES AND FENCE. GATE LOCKING MECHANISM SHALL BE SELECTED BY OWNER.
- ALL ORNAMENTAL METAL FENCE MEMBERS ARE TO BE TUBULAR MEMBERS IN ACCORDANCE WITH ASTM 513 HOT ROLLED STRUCTURAL STEEL 50,000 PSI TENSILE STRENGTH, 60,000 PSI YIELD STRENGTH.
- FENCE MEMBER SIZES TO BE AS FOLLOWS:
  - PICKETS, 3/4" SQUARE 16 GA.
  - RAILS, 1-1/2" X 1/2" SQUARE 16 GA.
  - POSTS, 2" SQUARE 11 GA.
- CONTRACTOR TO PROVIDE SHOP DRAWINGS FOR ALL FENCE GATES AND OPENERS. SHOP DRAWINGS SHALL INCLUDE ALL PRODUCT CUT SHEETS AS WELL AS INSTALLATION AND MANUFACTURING DETAILS. CONTRACTOR TO BE RESPONSIBLE FOR STRUCTURAL DESIGN OF GATES.
- CONCRETE FOOTING FOR POSTS SHALL BE 3X POST WIDTH FOR 2" SQUARE POSTS AND 2X POST WIDTH FOR 4" SQUARE POSTS.
- POSTS SHALL BE PLACED AT A MINIMUM DISTANCE OF 6'-0" O.C. AND A MAXIMUM DISTANCE OF 8'-0" O.C.
- FENCE SHALL MEET LOCAL CODES AND REQUIREMENTS. CONTRACTOR SHALL BE RESPONSIBLE FOR ENSURING COMPLIANCE INCLUDING NECESSARY UP-SIZING OF POSTS, PICKETS AND HORIZONTAL BARS AND INCREASING THE HEIGHT OF THE FENCE AS IT APPEARS IN THIS DETAIL AT NO ADDITIONAL COST TO THE OWNER FOR MATERIALS AND/OR LABOR.

**APPROVED:**  
I hereby certify that the above and foregoing site plan for a development in the City of Rockwall, Texas, was approved by the Planning & Zoning Commission of the City of Rockwall on the 16 day of February, 2022.

WITNESS OUR HANDS, this 16 day of February, 2022

*[Signature]* Planning & Zoning Commission, Chairman

*[Signature]* Director of Planning and Zoning



10' MIN. PIER DEPTH BELOW BASE OF RETAINING WALL IN CLAY OR WEATHERED ROCK, OR 3' MIN. PENETRATION INTO UNWEATHERED ROCK WITH 6' MIN. DEPTH.


CONTRACTOR TO USE SONOTUBES FOR PIER SECTION TO BE POURED ABOVE BASE OF RETAINING WALL.

CONTRACTOR TO USE 6-#5 BARS (DO NOT BUNDLE) FOR PIERS  
INSTALLED WITHIN RETAINING WALLS ABOVE 4' IN HEIGHT.


RETAINING WALL DESIGN TO BE SUBMITTED BY CONTRACTOR AND  
CONSTRUCTED PRIOR TO SCREEN WALL COLUMNS & PANELS.

SCREEN WALL DESIGNED TO BE SUPPORTED BY PIERS & COLUMNS.  
RETAINING WALLS ARE INDEPENDENT OF LOADING. ENGINEER TO BE  
CONSULTED PRIOR TO CONSTRUCTION TO REVIEW RETAINING WALL  
DESIGN.

SONOTUBES SHALL BE INSTALLED PRIOR TO RETAINING WALL CONSTRUCTION TAKING PLACE.

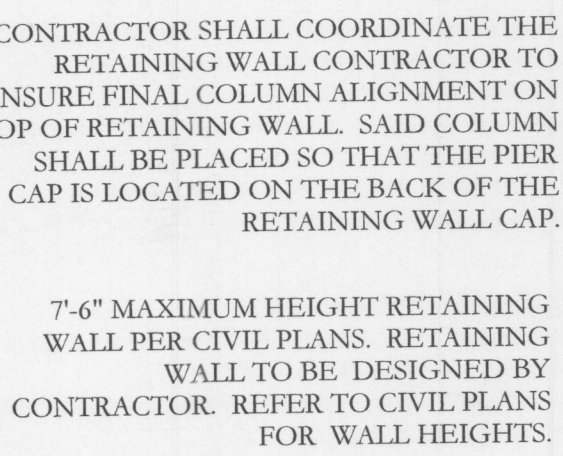


SCALE: 3/4"=1'-0"

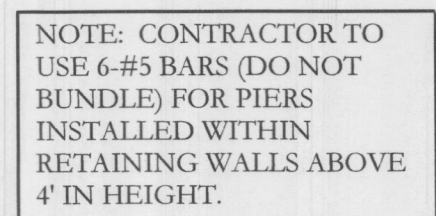

SCALE:  $3/4" = 1'-0"$

I hereby certify that the above and foregoing site plan for a development in the City of Rockwall, Texas, was approved by the Planning & Zoning Commission of the City of Rockwall on the 16 day of February, 2022.


  
Planning & Zoning Commission, Chairman

*[Signature]*  
Director of Planning and Zoning

car is one inch on original drawing. If not one inch on this sheet, just scale as necessary.

One Inch



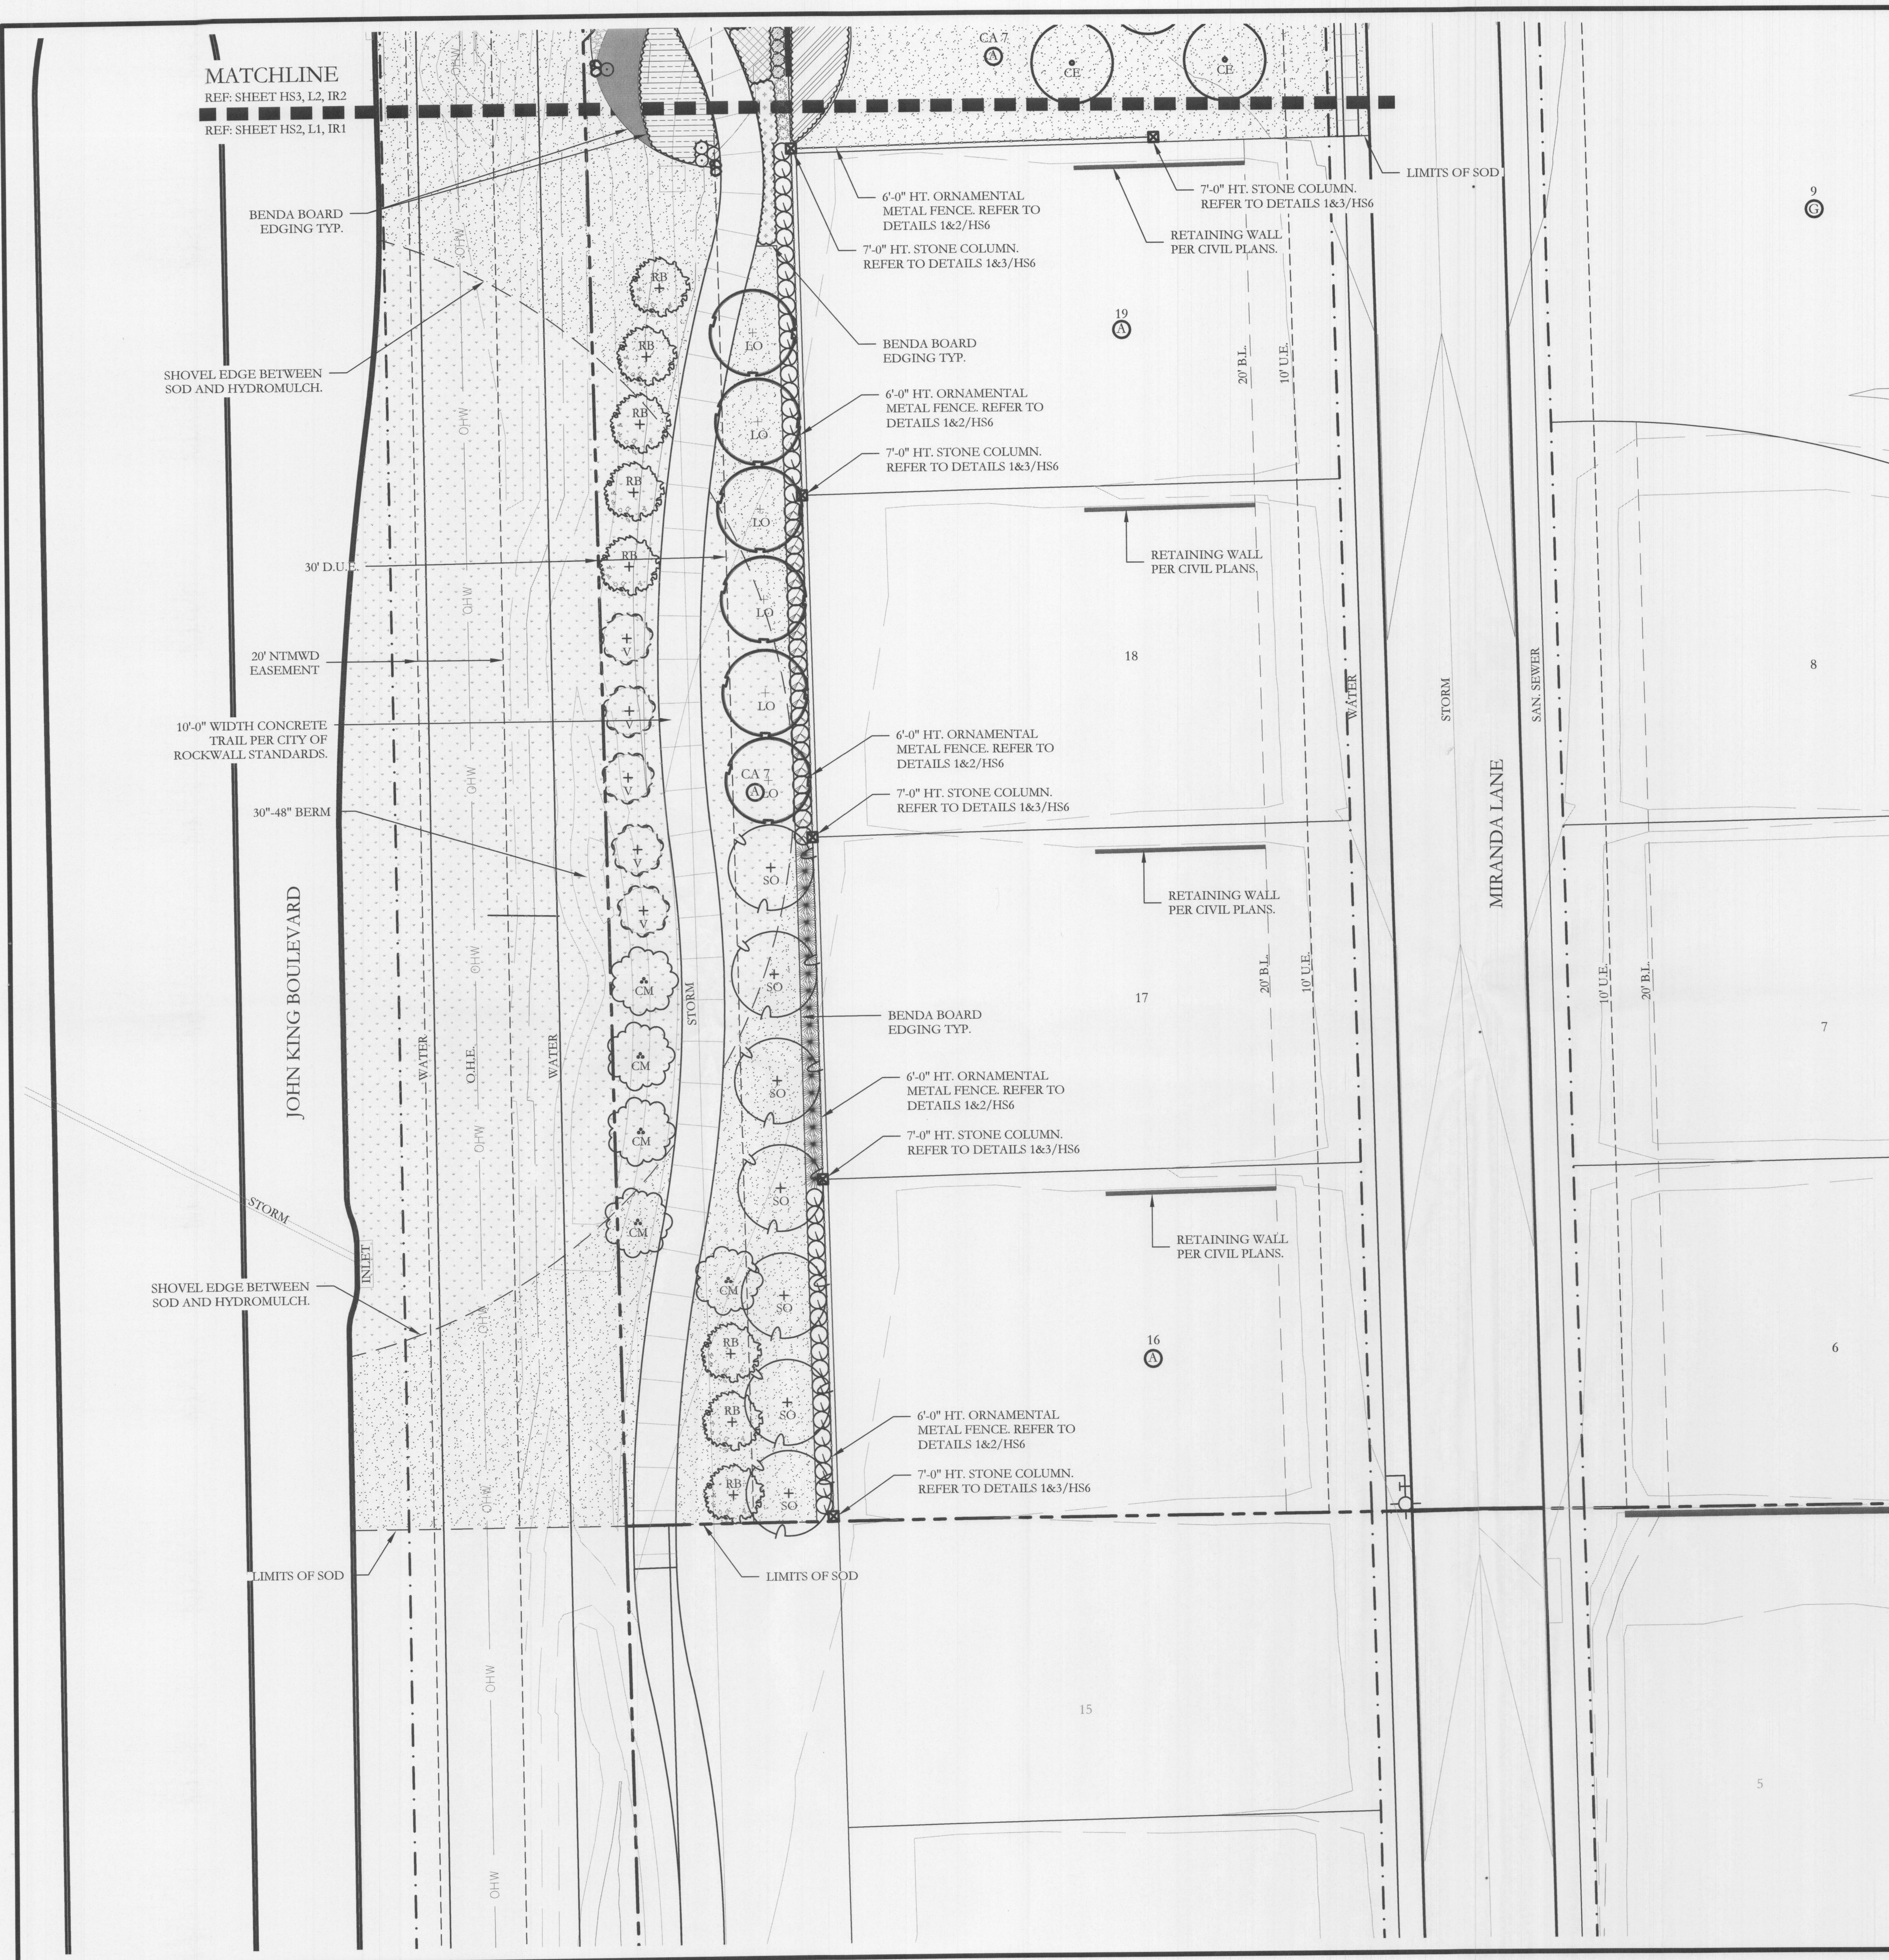

PLANT LEGEND					
SYMBOL	KEY	COMMON NAME	SCIENTIFIC NAME	SIZE	SPACING
	LO	LIVE OAK	QUERCUS VIRGINIANA	4" CALIPER	AS SHOWN
	SO	SHUMARD OAK	QUERCUS SHUMARDII	4" CALIPER	AS SHOWN
	BO	BUR OAK	QUERCUS MACROCARPA	4" CALIPER	AS SHOWN
	CE	CEDAR ELM	ULMUS CRASSIFOLIA	4" CALIPER	AS SHOWN
	RB	TEXAS REDBUD	CERCIS CANADENSIS VAR. TEXENSIS	2" CALIPER 4" MIN. HT.	AS SHOWN
	V	CHASTE TREE	VITEX AGNUS	2" CALIPER 4" MIN. HT.	AS SHOWN
	CM	NATCHEZ GRAPE MYRTLE	LAGERSTROEMIA INDICA X FAURIEI 'NATCHEZ'	2" CALIPER 4" MIN. HT.	AS SHOWN
		TEXAS SAGE	LEUCOPHYLLUM FRUTESCENS	7 GALLON	48" O.C.
		EDWARD GOUCHER ABELIA	ABELIA GRANDIFLORA 'EDWARD GOUCHER'	7 GALLON	48" O.C.
		STANDARD BURFORD HOLLY	ILEX CORNUTA 'BURFORDII'	7 GALLON	48" O.C.
		INDIAN HAWTHORN 'SNOW'	RHAPHIOLEPIS INDICA 'SNOW'	5 GALLON	36" O.C.
		AUTUMN SAGE	SALVIA GREGGII	5 GALLON	36" O.C.
		RED YUCCA	HESPERALOE PARVIFLORA	5 GALLON	36" O.C.
		UPRIGHT ROSEMARY	ROSMARINUS OFFICINALIS 'UPRIGHT'	5 GALLON	36" O.C.
		ARTEMISIA	ARTEMISIA SCHMIDTIANA 'SILVER MOUND'	5 GALLON	36" O.C.
		GULF MUHLY GRASS	MUHLENBERGIA CAPILLARIS 'REGAL MIST'	5 GALLON	36" O.C.
		LIRIOPE GRASS	LIRIOPE MUSCARI	1 GALLON	18" O.C.
		WEEPING LOVE GRASS	ERAGROSTIS CURVULA	1 GALLON	18" O.C.
		COMMON BERMUDA GRASS	CYNODON DACTYLON	SQUARE FEET	SOLID SOD
		BEE HAPPY MIX	BY NATIVE AMERICAN SEED CO	SQUARE FEET	HYDROMULCH
		BLACK STAR CRUSHED GRANITE	3" DEPTH MINIMUM WITH DEWITT 4.1 OZ FILTER FABRIC BENEATH ROCK	SQUARE FEET	3/4" 1" DIAMETER
		TEXAS RIVER ROCK; MIX OF TANS, BROWNS, GRAYS, AND PINKS	3" DEPTH MINIMUM WITH DEWITT 4.1 OZ FILTER FABRIC BENEATH ROCK	SQUARE FEET	EQUAL COMBINATION OF 1-2" AND 2-4"
		OKLAHOMA MOSS ROCK BOULDERS	BURY BOTTOM THIRD OF BOULDER IN LANDSCAPE BED.	50 LB - 250 LB	FIELD LOCATE ALL BOULDER MASSES

APPROVED:  
I hereby certify that the above and foregoing site plan for a development in the City of Rockwall, Texas, was approved by the Planning & Zoning Commission of the City of Rockwall on the 16 day of February, 2022.

WITNESS OUR HANDS, this 16 day of February, 2022.

Planning & Zoning Commission, Chairman

Director of Planning and Zoning

JOHNSON VOLK CONSULTING

830 CENTRAL PARKWAY EAST, SUITE 300 PLANO, TEXAS 75074  
PH: (972) 201-3100  
EMAIL: CODY.JOHNSON@JOHNSONVOLK.COM

REGISTERED LANDSCAPE ARCHITECT  
CODY L. JOHNSON  
2833  
STATE OF TEXAS  
January 27, 2022

NORTH

Scale: 1" = 20'-0"  
Bar is one inch on original drawing. If not one inch on this sheet, adjust scale as necessary.  
One Inch

SCREENING AND BUFFERING

Landscape Plan


Saddle Star South - Phase 3

City of Rockwall, Rockwall County, Texas

CJS PROJECT NO.  
PAD001B

SHEET NO.  
L1 of 6



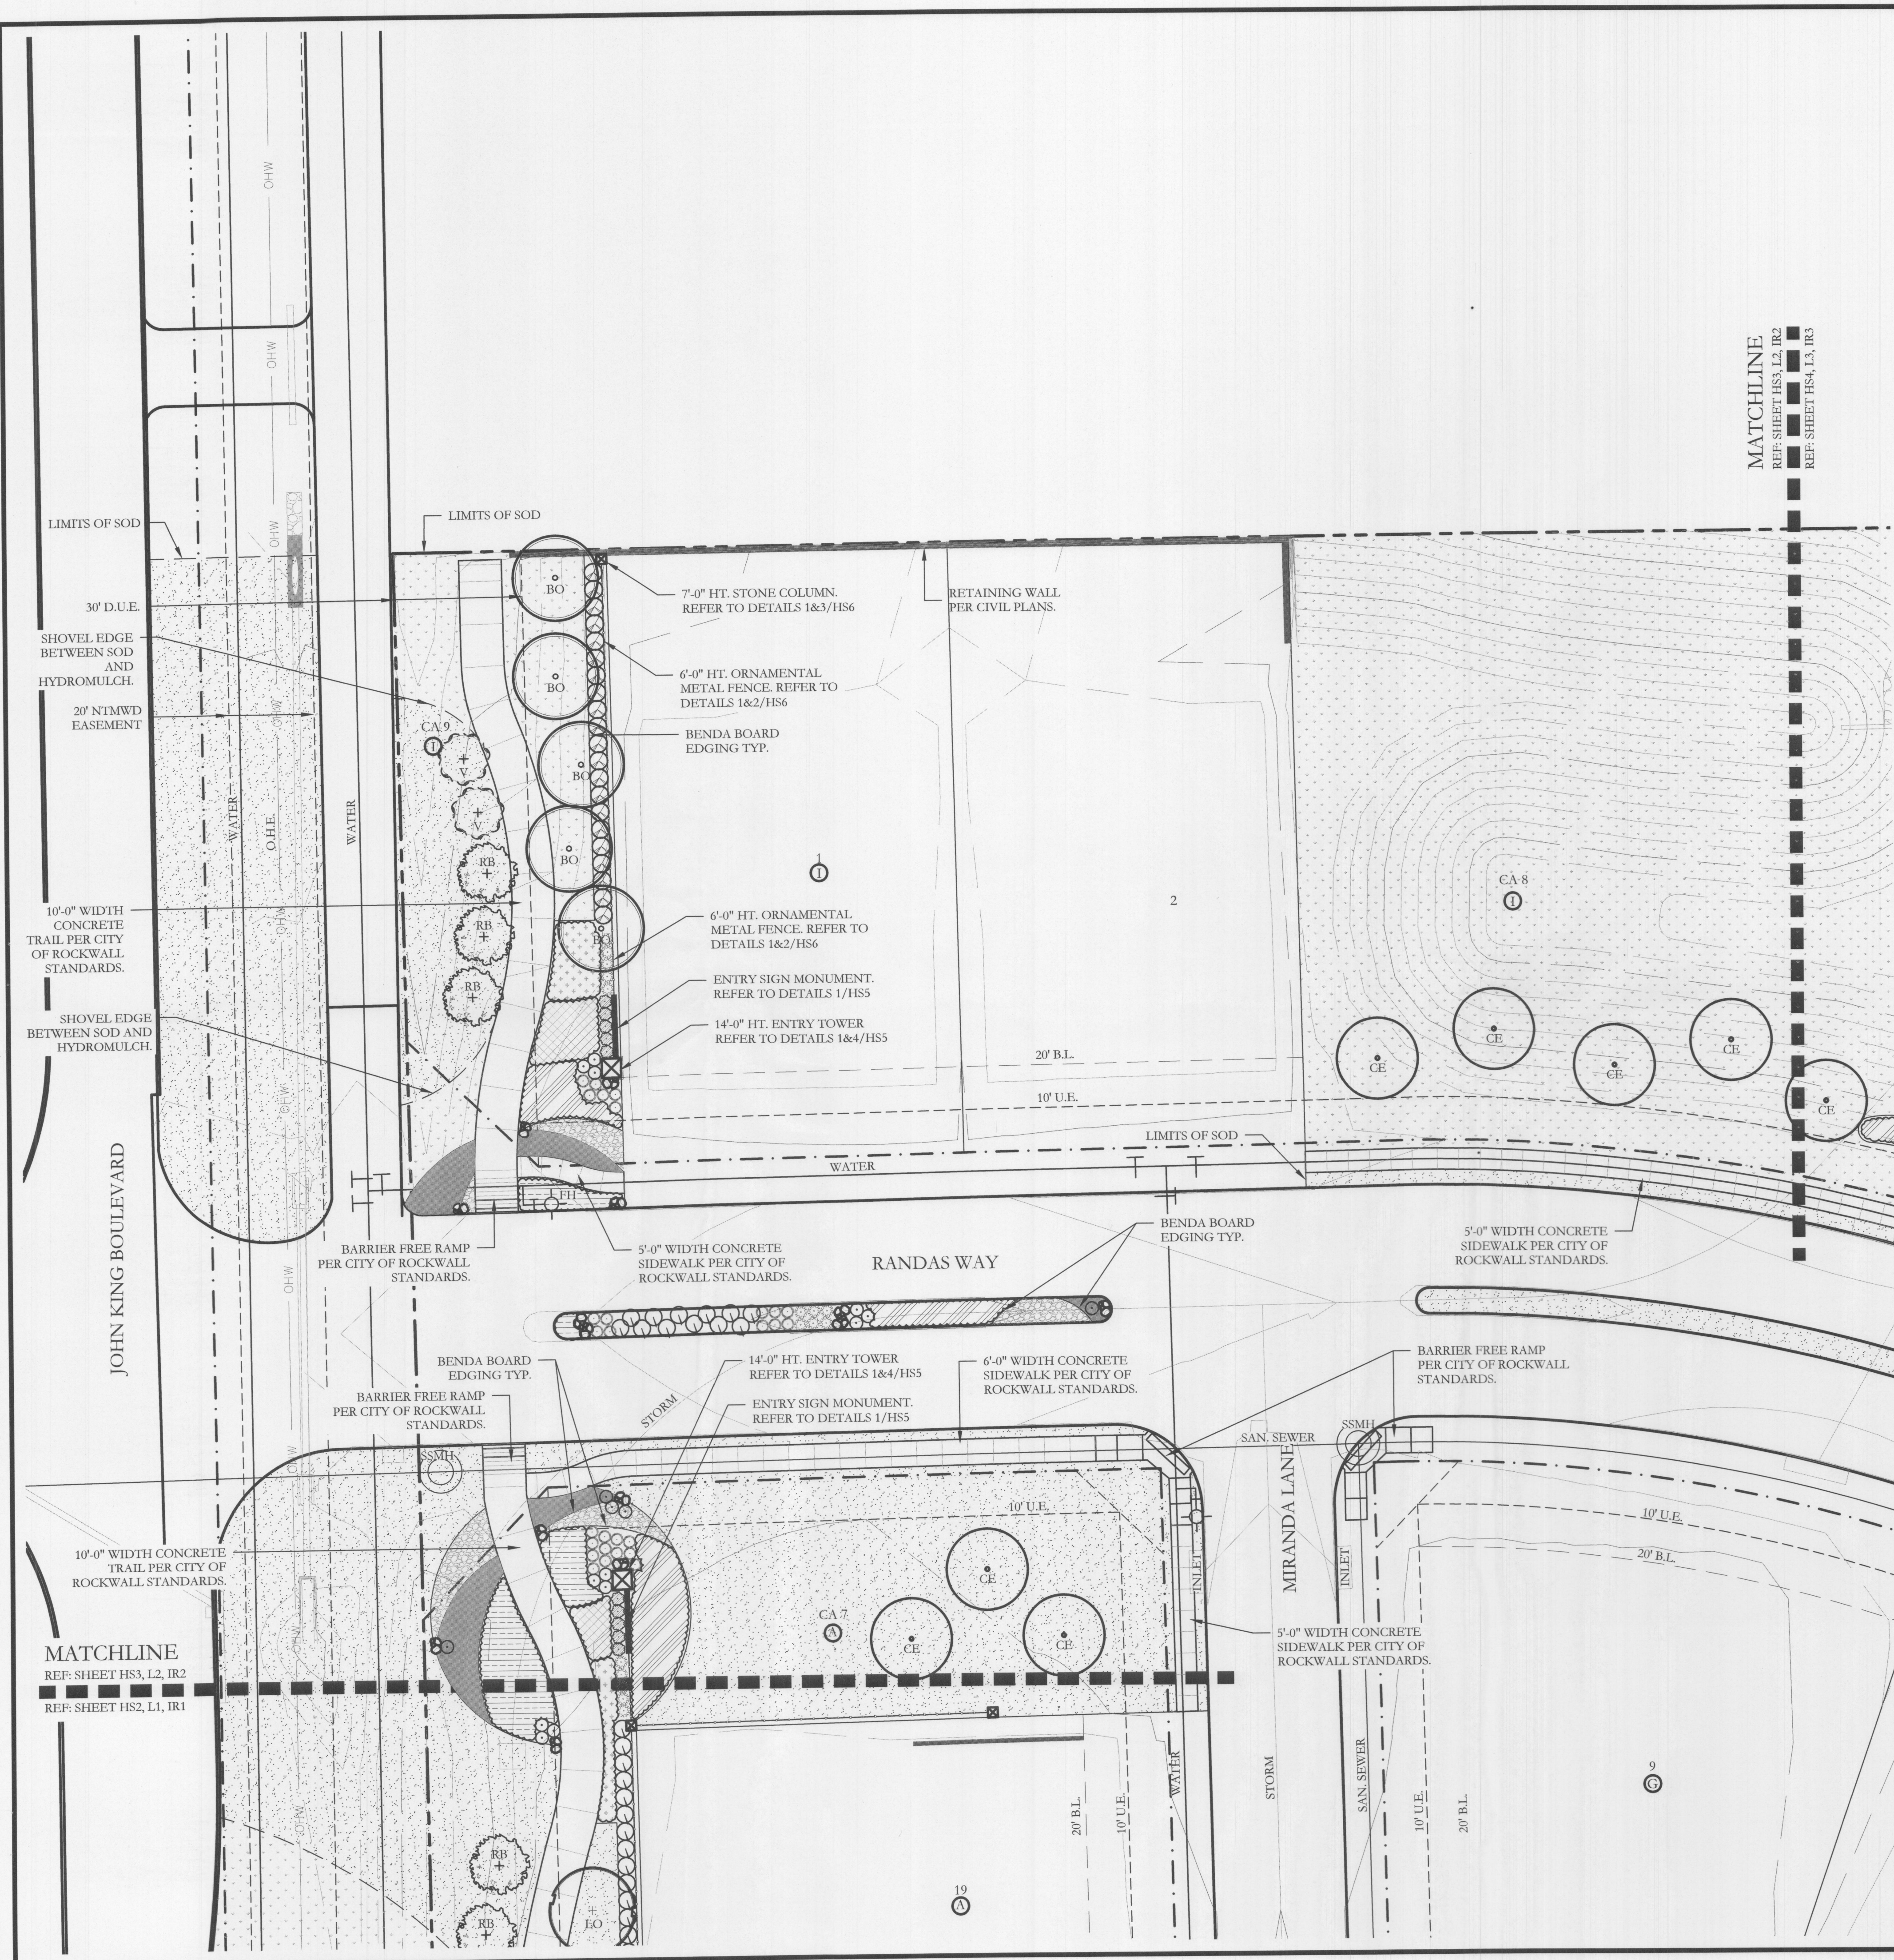

PLANT LEGEND					
SYMBOL	KEY	COMMON NAME	SCIENTIFIC NAME	SIZE	SPACING
	LO	LIVE OAK	QUERCUS VIRGINIANA	4" CALIPER	AS SHOWN
	SO	SHUMARD OAK	QUERCUS SHUMARDII	4" CALIPER	AS SHOWN
	BO	BUR OAK	QUERCUS MACROCARPA	4" CALIPER	AS SHOWN
	CE	CEDAR ELM	ULMUS CRASSIFOLIA	4" CALIPER	AS SHOWN
	RB	TEXAS REDBUD	CERCIS CANADENSIS VAR. TEXENSIS	2" CALIPER 4' MIN. HT.	AS SHOWN
	V	CHASTE TREE	VTTEX AGNUS	2" CALIPER 4' MIN. HT.	AS SHOWN
	CM	NATCHEZ CRAPE MYRTLE	LAGERSTROEMIA INDICA X FAURIEI 'NATCHEZ'	2" CALIPER 4' MIN. HT.	AS SHOWN
		TEXAS SAGE	LEUCOPHYLLUM FRUTESCENS	7 GALLON	48" O.C.
		EDWARD GOUCHER ABELIA	ABELIA GRANDIFLORA 'EDWARD GOUCHER'	7 GALLON	48" O.C.
		STANDARD BURFORD HOLLY	ILEX CORNUTA 'BURFORDII'	7 GALLON	48" O.C.
		INDIAN HAWTHORN 'SNOW'	RHAPHIOLEPIS INDICA 'SNOW'	5 GALLON	36" O.C.
		AUTUMN SAGE	SALVIA GREGGII	5 GALLON	36" O.C.
		RED YUCCA	HESPERALOE PARVIFLORA	5 GALLON	36" O.C.
		UPRIGHT ROSEMARY	ROSMARINUS OFFICINALIS 'UPRIGHT'	5 GALLON	36" O.C.
		ARTEMISIA	ARTEMISIA SCHMIDTIANA 'SILVER MOUND'	5 GALLON	36" O.C.
		GULF MUHLY GRASS	MUHLENBERGIA CAPILLARIS 'REGAL MIST'	5 GALLON	36" O.C.
		LIRIOPE GRASS	LIRIOPE MUSCARI	1 GALLON	18" O.C.
		WEEPING LOVE GRASS	ERAGROSTIS CURVULA	1 GALLON	18" O.C.
		COMMON BERMUDA GRASS	CYNODON DACTYLON	SQUARE FEET	SOLID SOD
		BEE HAPPY MIX	BY NATIVE AMERICAN SEED CO	SQUARE FEET	HYDROMULCH
		BLACK STAR CRUSHED GRANITE	3" DEPTH MINIMUM WITH DEWITT 4.1 OZ FILTER FABRIC BENEATH ROCK	SQUARE FEET	1/4" DIAMETER
		TEXAS RIVER ROCK, MIX OF TANS, BROWNS, GRAYS, AND PINKS	3" DEPTH MINIMUM WITH DEWITT 4.1 OZ FILTER FABRIC BENEATH ROCK	SQUARE FEET	EQUAL COMBINATION OF 1-2" AND 2-4"
		OKLAHOMA MOSS ROCK BOULDERS	BURY BOTTOM THIRD OF BOULDER IN LANDSCAPE BED.	50 LB - 250 LB	FIELD LOCATE ALL BOULDER MASSES

**APPROVED:**  
I hereby certify that the above and foregoing site plan for a development in the City of Rockwall, Texas, was approved by the Planning & Zoning Commission of the City of Rockwall on the 16 day of February, 2022.

WITNESS OUR HANDS, this 16 day of February, 2022.  
  
Director of Planning and Zoning

JOHNSON VOLK CONSULTING

830 CENTRAL PARKWAY EAST, SUITE 300 PLANO, TEXAS 75074  
PH: (972) 201-3100  
EMAIL: CODY.JOHNSON@JOHNSONVOLK.COM

NORTH

Scale: 1" = 20'-0"

Bar is one inch on original drawing. If not one inch on this sheet, adjust scale as necessary.

One Inch

SCREENING AND BUFFERING

Landscape Plan

Saddle Star South - Phase 3

City of Rockwall, RockwallCounty, Texas

CJS PROJECT NO.


PAD001B

SHEET NO.

L2 of 6



MATCHLINE  
REF: SHEET HS4, L2, IR2  
REF: SHEET HS4, L3, IR3

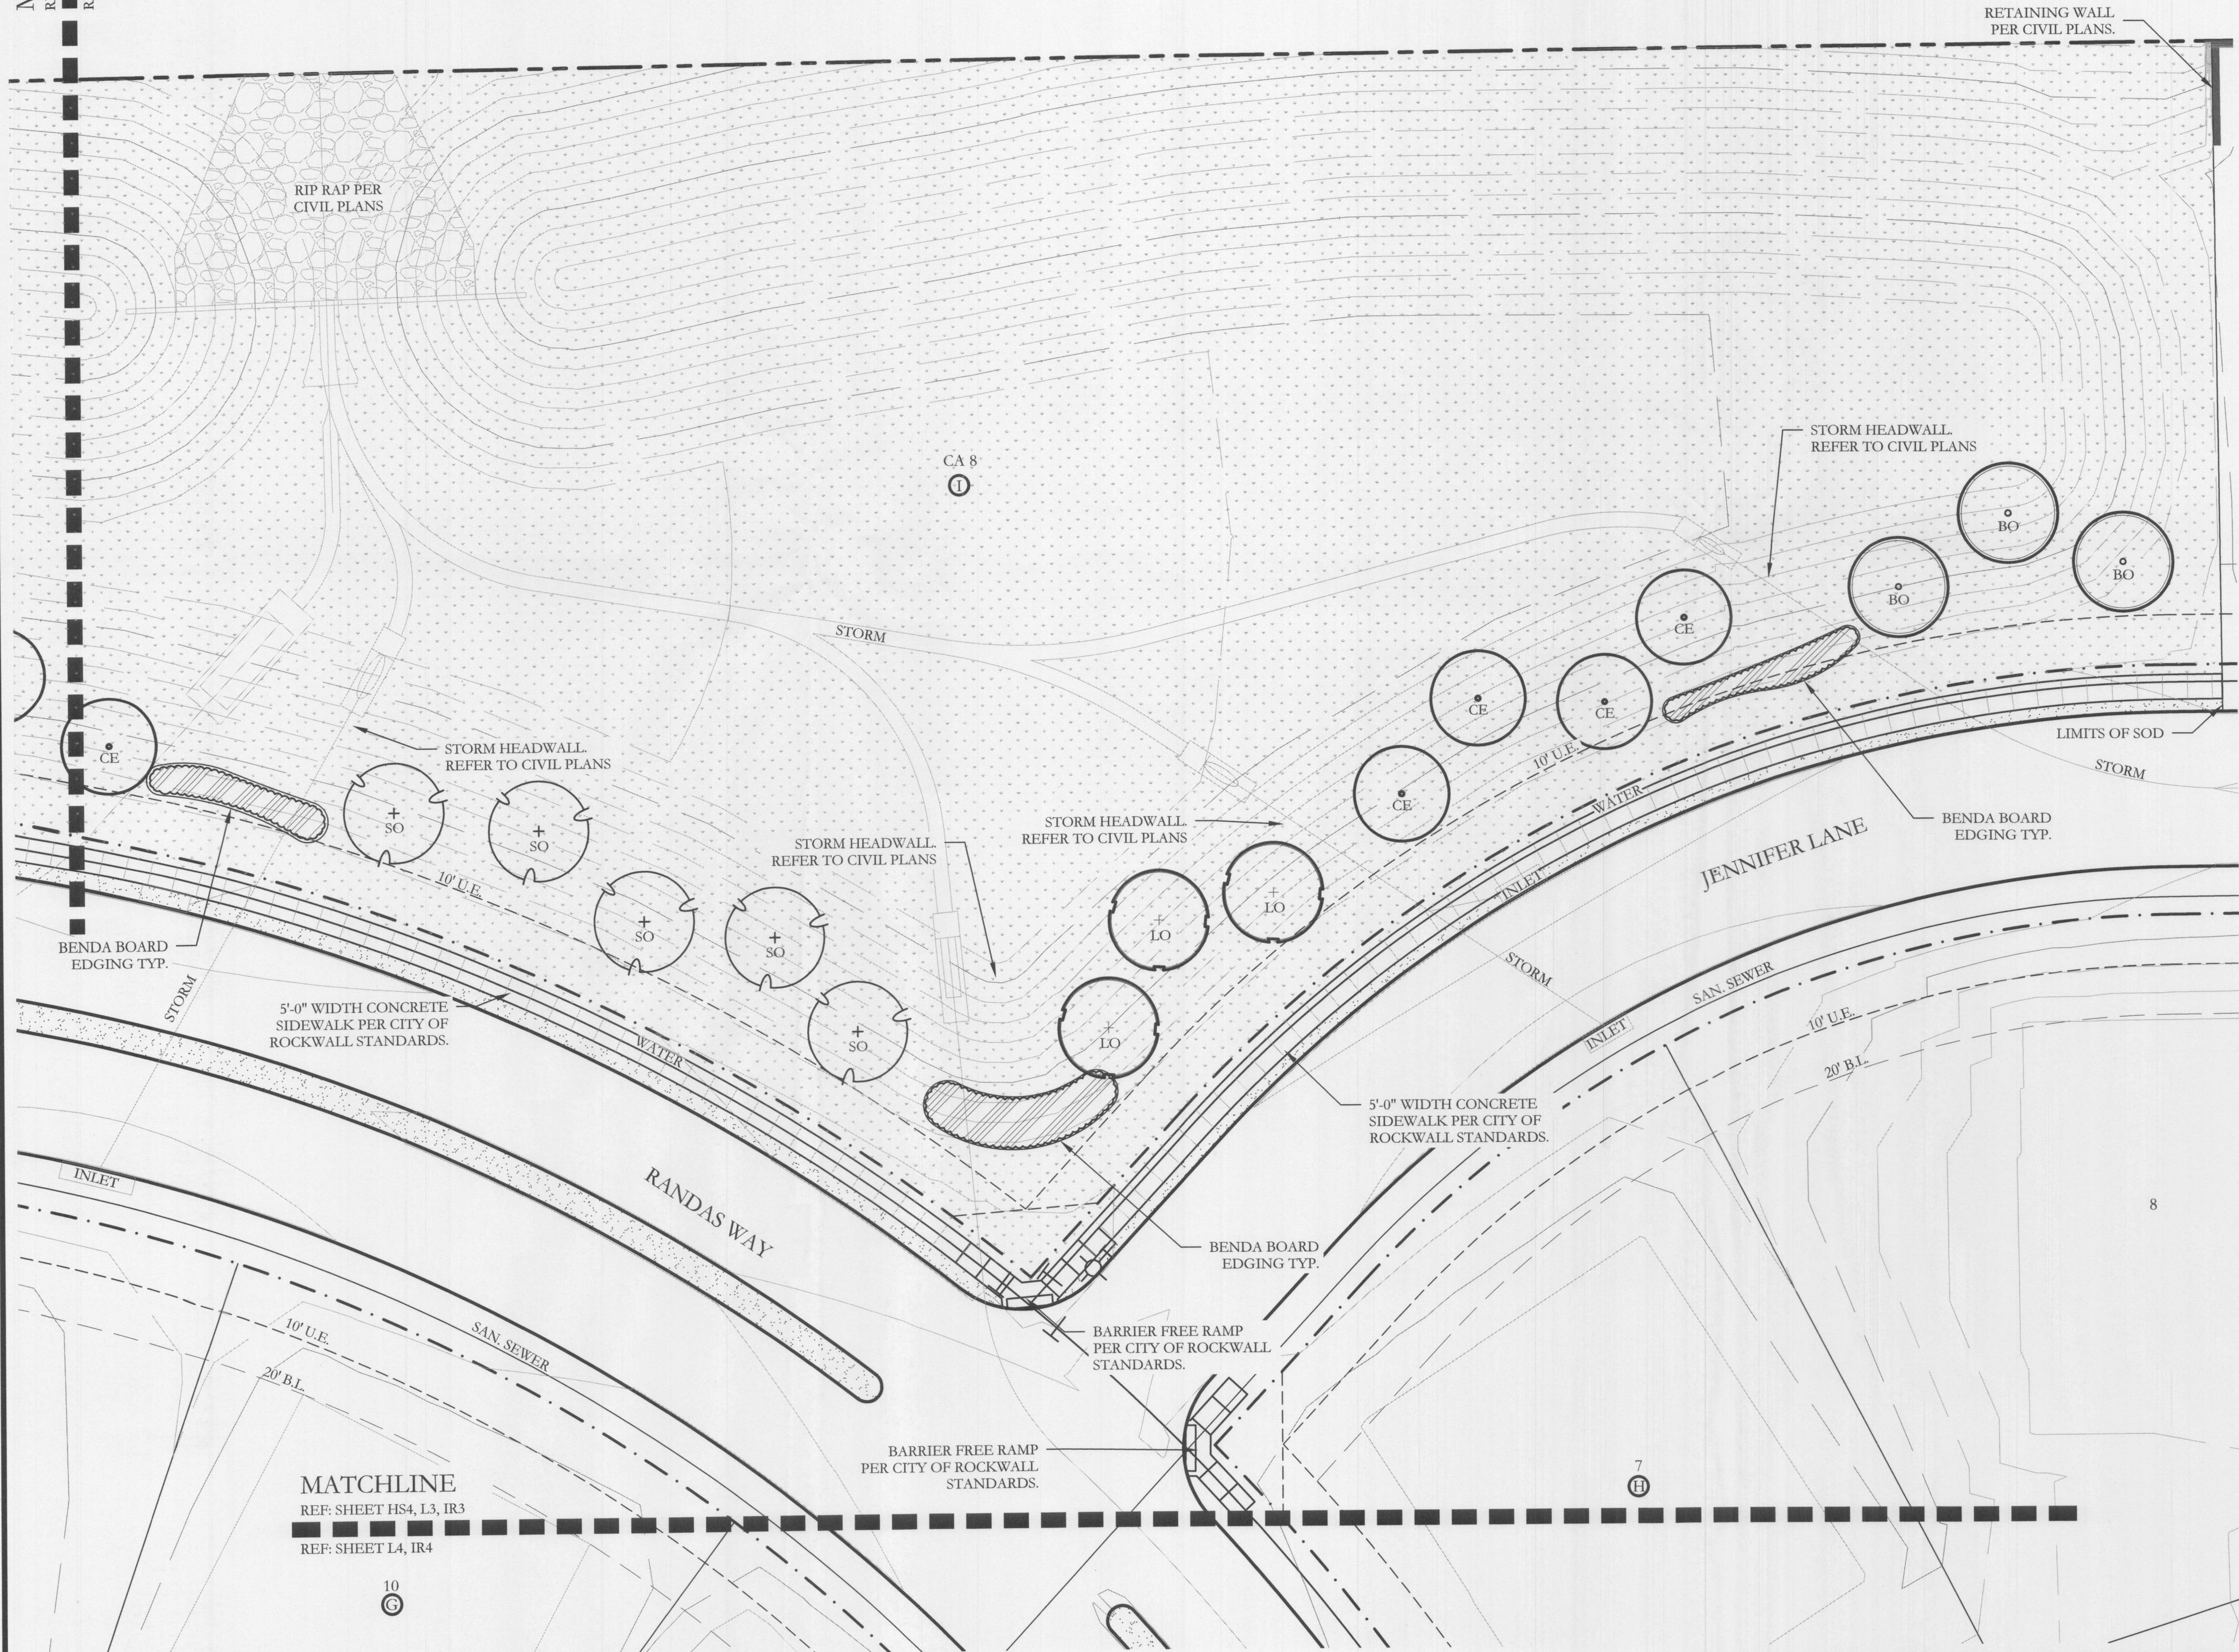

MATCHLINE  
REF: SHEET HS4, L3, IR3  
REF: SHEET L4, IR4

PLANT LEGEND					
SYMBOL	KEY	COMMON NAME	SCIENTIFIC NAME	SIZE	SPACING
	LO	LIVE OAK	QUERCUS VIRGINIANA	4" CALIPER	AS SHOWN
	SO	SHUMARD OAK	QUERCUS SHUMARDII	4" CALIPER	AS SHOWN
	BO	BUR OAK	QUERCUS MACROCARPA	4" CALIPER	AS SHOWN
	CE	CEDAR ELM	ULMUS CRASSIFOLIA	4" CALIPER	AS SHOWN
	RB	TEXAS REDBUD	CERCIS CANADENSIS VAR. TEXENSIS	2" CALIPER 4' MIN. HT.	AS SHOWN
	V	CHASTE TREE	VITEX AGNUS	2" CALIPER 4' MIN. HT.	AS SHOWN
	CM	NATCHEZ CRAPE MYRTLE	LAGERSTROEMIA INDICA X FAURIEI 'NATCHEZ'	2" CALIPER 4' MIN. HT.	AS SHOWN
		TEXAS SAGE	LEUCOPHYLLUM FRUTESCENS	7 GALLON	48" O.C.
		EDWARD GOUCHER ABELIA	ABELIA GRANDIFLORA 'EDWARD GOUCHER'	7 GALLON	48" O.C.
		STANDARD BURFORD HOLLY	ILEX CORNUTA 'BURFORDII'	7 GALLON	48" O.C.
		INDIAN HAWTHORN 'SNOW'	RHAPHIOLEPIS INDICA 'SNOW'	5 GALLON	36" O.C.
		AUTUMN SAGE	SALVIA GREGGII	5 GALLON	36" O.C.
		RED YUCCA	HESPERALOE PARVIFLORA	5 GALLON	36" O.C.
		UPRIGHT ROSEMARY	ROSMARINUS OFFICINALIS 'UPRIGHT'	5 GALLON	36" O.C.
		ARTEMISIA	ARTEMISIA SCHMIDTIANA 'SILVER MOUND'	5 GALLON	36" O.C.
		GULF MUHLY GRASS	MUHLENBERGIA CAPILLARIS 'REGAL MIST'	5 GALLON	36" O.C.
		LIRIOPE GRASS	LIRIOPE MUSCARI	1 GALLON	18" O.C.
		WEeping LOVE GRASS	ERAGROSTIS CURVULA	1 GALLON	18" O.C.
		COMMON BERMUDA GRASS	CYNODON DACTYLON	SQUARE FEET	SOLID SOD
		BEE HAPPY MIX	BY NATIVE AMERICAN SEED CO	SQUARE FEET	HYDROMULCH
		BLACK STAR CRUSHED GRANITE	3" DEPTH MINIMUM WITH DEWITT 4.1 OZ FILTER FABRIC BENEATH ROCK	SQUARE FEET	3/4" DIAMETER
		TEXAS RIVER ROCK, MIX OF TANS, BROWNS, GRAYS, AND PINKS	3" DEPTH MINIMUM WITH DEWITT 4.1 OZ FILTER FABRIC BENEATH ROCK	SQUARE FEET	EQUAL COMBINATION OF 1-2" AND 2-4"
		OKLAHOMA MOSS ROCK BOULDERS	BURY BOTTOM THIRD OF BOULDER IN LANDSCAPE BED.	50 LB - 250 LB	FIELD LOCATE ALL BOULDER MASSES


APPROVED:  
I hereby certify that the above and foregoing site plan for a development in the City of Rockwall, Texas, was approved by the Planning & Zoning Commission of the City of Rockwall on the 16 day of February, 2022.

WITNESS OUR HANDS, this 16 day of February, 2022.

Planning & Zoning Commission, Chairman

Director of Planning and Zoning

JOHNSON VOLK  
CONSULTING  
830 CENTRAL PARKWAY EAST, SUITE 300 PLANO, TEXAS 75074  
PH: (972) 391-3100  
EMAIL: CODY@JOHNSONVOLK.COM

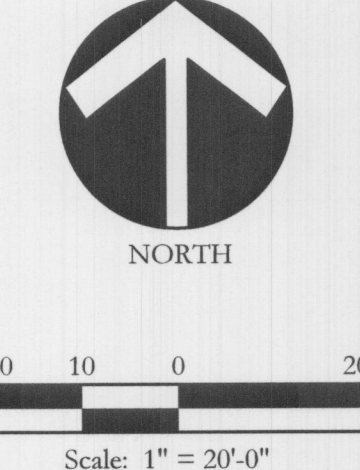


Bar is one inch on original drawing. If not one inch on this sheet, adjust scale as necessary.

SCREENING AND BUFFERING  
Landscape Plan  
Saddle Star South - Phase 3  
City of Rockwall, Rockwall County, Texas

CJS PROJECT NO.  
PAD001B  
SHEET NO.  
L3 of 6




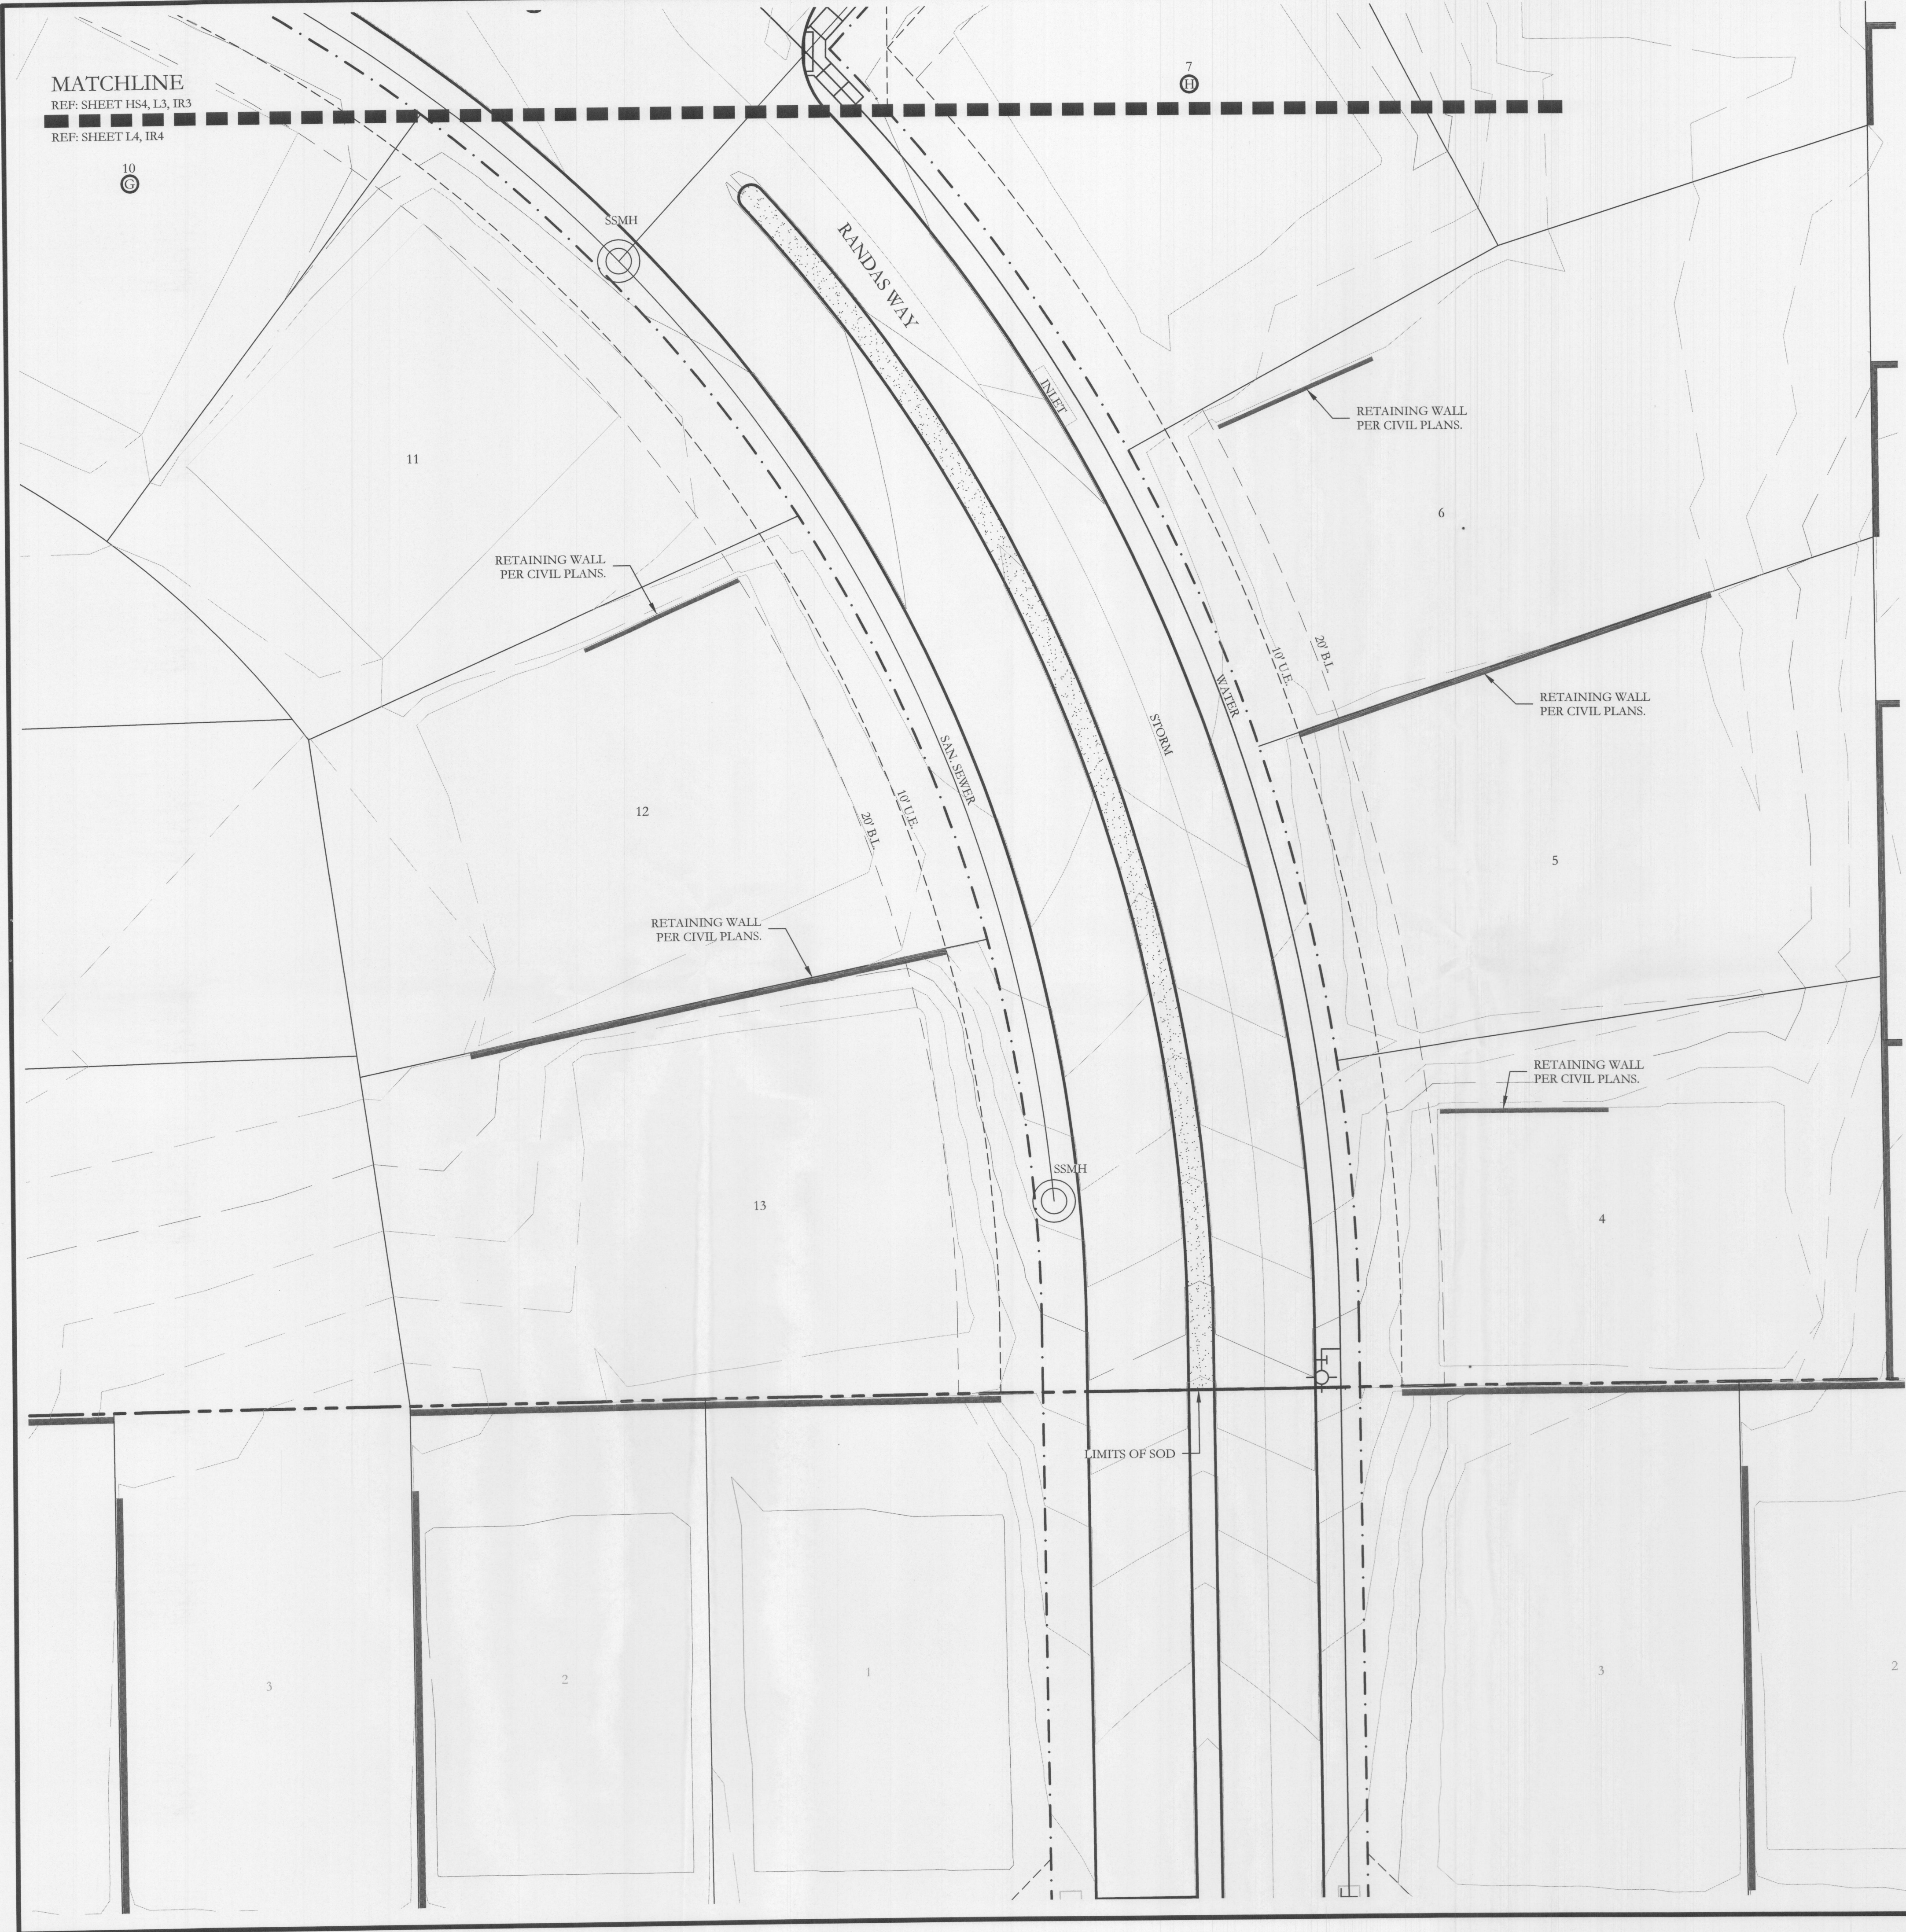


PLANT LEGEND					
SYMBOL	KEY	COMMON NAME	SCIENTIFIC NAME	SIZE	SPACING
	LO	LIVE OAK	QUERCUS VIRGINIANA	4" CALIPER	AS SHOWN
	SO	SHUMARD OAK	QUERCUS SHUMARDII	4" CALIPER	AS SHOWN
	BO	BUR OAK	QUERCUS MACROCARPA	4" CALIPER	AS SHOWN
	CE	CEDAR ELM	ULMUS CRASSIFOLIA	4" CALIPER	AS SHOWN
	RB	TEXAS REDBUD	CERCIS CANADENSIS VAR. TEXENSIS	2" CALIPER 4' MIN. HT.	AS SHOWN
	V	CHASTE TREE	VITEX AGNUS	2" CALIPER 4' MIN. HT.	AS SHOWN
	CM	NATCHEZ CRAPE MYRTLE	LAGERSTROEMIA INDICA X FAURIEI 'NATCHEZ'	2" CALIPER 4' MIN. HT.	AS SHOWN
		TEXAS SAGE	LEUCOPHYLLUM FRUTESCENS	7 GALLON	48" O.C.
		EDWARD GOUCHER ABELIA	ABELIA GRANDIFLORA 'EDWARD GOUCHER'	7 GALLON	48" O.C.
		STANDARD BURFORD HOLLY	ILEX CORNUTA 'BURFORDII'	7 GALLON	48" O.C.
		INDIAN HAWTHORN 'SNOW'	RHAPHIOLEPIS INDICA 'SNOW'	5 GALLON	36" O.C.
		AUTUMN SAGE	SALVIA GREGGII	5 GALLON	36" O.C.
		RED YUCCA	HESPERALOE PARVIFLORA	5 GALLON	36" O.C.
		UPRIGHT ROSEMARY	ROSMARINUS OFFICINALIS 'UPRIGHT'	5 GALLON	36" O.C.
		ARTEMISIA	ARTEMISIA SCHMIDTIANA 'SILVER MOUND'	5 GALLON	36" O.C.
		GULF MUHLY GRASS	MUHLENBERGIA CAPILLARIS 'REGAL MIST'	5 GALLON	36" O.C.
		LIRIOPE GRASS	LIRIOPE MUSCARI	1 GALLON	18" O.C.
		WEeping LOVE GRASS	ERAGROSTIS CURVULA	1 GALLON	18" O.C.
		COMMON BERMUDA GRASS	CYNODON DACTYLON	SQUARE FEET	SOLID SOD
		BEE HAPPY MIX	BY NATIVE AMERICAN SEED CO	SQUARE FEET	HYDROMULCH
		BLACK STAR CRUSHED GRANITE	3" DEPTH MINIMUM WITH DEWITT 4.1 OZ. FILTER FABRIC BENEATH ROCK	SQUARE FEET	1/2" DIAMETER
		TEXAS RIVER ROCK, MIX OF TANS, BROWNS, GRAYS, AND PINKS	3" DEPTH MINIMUM WITH DEWITT 4.1 OZ. FILTER FABRIC BENEATH ROCK	SQUARE FEET	EQUAL COMBINATION OF 1-2" AND 2-4"
		OKLAHOMA MOSS ROCK BOULDERS	BURY BOTTOM THIRD OF BOULDER IN LANDSCAPE BED.	50 LB - 250 LB	FIELD LOCATED ALL BOULDER MASSES

**APPROVED:**  
I hereby certify that the above and foregoing site plan for a development in the City of Rockwall, Texas, was approved by the Planning & Zoning Commission of the City of Rockwall on the 16 day of February, 2022.

WITNESS OUR HANDS, this 16 day of February, 2022.

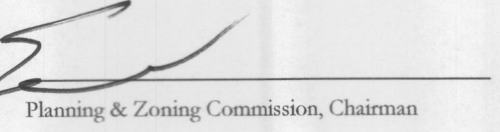 Planning & Zoning Commission, Chairman

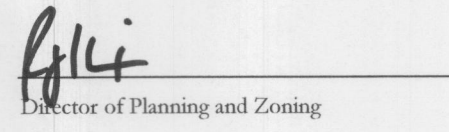 Director of Planning and Zoning



## LANDSCAPE PROVIDED

## JOHN KING BOULEVARD

- A. MINIMUM TWENTY (50) FOOT LANDSCAPE EDGE PROVIDED
- B. 10' SIDEWALK WITHIN LANDSCAPE BUFFER PROVIDED.
- C. 3 - 4" CAL. CANOPY TREE & 4 ACCENT TREES / 100 LF OF LINEAR FRONTAGE  
596 LF OF FRONTAGE / 100 LF = 18 - 4" CAL. TREES & 22 ACCENT TREES REQUIRED  
PROVIDED: 18 - 4" CALIPER CANOPY TREES & 23 ACCENT TREES PROVIDED
- D. MIN 30" HT. SHRUBBERY PROVIDED ALONG LENGTH OF STREET FRONTAGE.

## DETENTION AREA LOT CA8 BLOCK I

- A. 1 SHRUB OR ORNAMENTAL GRASS PER 750 SF OF DRY DETENTION AREA.  
91,263 SF OF DETENTION AREA / 750 SF = 122 - SHRUBS OR ORNAMENTAL GRASSES  
PROVIDED: 188 ORNAMENTAL GRASSES.

## PLANT LIST

KEY	ESTIMATED QUANTITY	COMMON NAME	SCIENTIFIC NAME	SIZE	SPACING	REMARKS
LO	9	LIVE OAK	QUERCUS VIRGINIANA	4" CALIPER	AS SHOWN	NURSERY GROWN; FULL HEAD; MINIMUM BRANCHING HEIGHT AT 6'-0"; MINIMUM 10'-0" OVERALL HEIGHT.
SO	12	SHUMARD OAK	QUERCUS SHUMARDII	4" CALIPER	AS SHOWN	NURSERY GROWN; FULL HEAD; MINIMUM BRANCHING HEIGHT AT 6'-0"; MINIMUM 10'-0" OVERALL HEIGHT.
BO	8	BUR OAK	QUERCUS MACROCARPA	4" CALIPER	AS SHOWN	NURSERY GROWN; FULL HEAD; MINIMUM BRANCHING HEIGHT AT 6'-0"; MINIMUM 10'-0" OVERALL HEIGHT.
CE	12	CEDAR ELM	ULMUS CRASSIFOLIA	4" CALIPER	AS SHOWN	NURSERY GROWN; FULL HEAD; MINIMUM BRANCHING HEIGHT AT 6'-0"; MINIMUM 10'-0" OVERALL HEIGHT.
RB	11	TEXAS REDBUD	CERCIS CANADENSIS VAR. TEXENSIS	2" CALIPER	AS SHOWN	NURSERY GROWN; FULL HEAD; MINIMUM 8'-0" OVERALL HEIGHT.
V	7	CHASTE TREE	VITEX ANGUS-CASTUS	2" CALIPER	AS SHOWN	NURSERY GROWN; FULL HEAD; MINIMUM 8'-0" OVERALL HEIGHT.
CM	5	NATCHEZ CRAPE MYRTLE	LAGERSTROEMIA INDICA X FAURIEI 'NATCHEZ'	2" CALIPER	AS SHOWN	NURSERY GROWN; FULL HEAD; MINIMUM 8'-0" OVERALL HEIGHT.
	52	TEXAS SAGE	LEUCOPHYLLUM FRUTESCENS	7 GALLON	48" O.C.	CONTAINER GROWN; FULL PLANT.
	41	EDWARD GOUCHER ABELIA	ABELIA GRANDIFLORA 'EDWARD GOUCHER'	7 GALLON	48" O.C.	CONTAINER GROWN; FULL PLANT.
	20	STANDARD BURFORD HOLLY	ILEX CORNUTA 'BURFORDII'	7 GALLON	48" O.C.	CONTAINER GROWN; FULL PLANT.
	10	INDIAN HAWTHORN SNOW	RHAPHIOLEPIS INDICA 'SNOW'	5 GALLON	36" O.C.	CONTAINER GROWN; FULL PLANT.
	28	AUTUMN SAGE	SALVIA GREGGII	5 GALLON	36" O.C.	CONTAINER GROWN; FULL PLANT.
	17	RED YUCCA	HESPERALOE PARVIFLORA	5 GALLON	36" O.C.	CONTAINER GROWN; FULL PLANT.
	16	UPRIGHT ROSEMARY	ROSMARINUS OFFICINALIS 'UPRIGHT'	5 GALLON	36" O.C.	CONTAINER GROWN; FULL PLANT.
	35	ARTEMISIA	ARTEMISIA SCHMIDTIANA 'SILVER MOUND'	5 GALLON	36" O.C.	CONTAINER GROWN; FULL PLANT.
	190	GULF MUHLY GRASS	MUHLENBERGIA CAPILLARIS 'REGAL MIST'	5 GALLON	36" O.C.	CONTAINER GROWN; FULL PLANT.
	137	LIRIOPE GRASS	LIRIOPE MUSCARI	1 GALLON	18" O.C.	CONTAINER GROWN; FULL PLANT.
	380	WEeping LOVE GRASS	ERAGROSTIS CURVULA	1 GALLON	18" O.C.	CONTAINER GROWN; FULL PLANT.
	35,827	COMMON BERMUDA GRASS	CYNODON DACTYLON	SQUARE FEET	SOLID SOD	MINIMUM 100% COVERAGE ALL AREAS SHOWN
	107,749	BEE HAPPY MIX	BY NATIVE AMERICAN SEED CO.	SQUARE FEET	HYDROMULCH	MINIMUM 100% COVERAGE ALL AREAS SHOWN
	730	BLACK STAR CRUSHED GRANITE	3" DEPTH MINIMUM WITH DEWITT 4.1 OZ FILTER FABRIC BENEATH ROCK	SQUARE FEET	1/2" DIAMETER	MINIMUM 100% COVERAGE ALL AREAS SHOWN
	542	TEXAS RIVER ROCK, MIX OF TANS, BROWNS, GRAYS, AND PINKS	3" DEPTH MINIMUM WITH DEWITT 4.1 OZ FILTER FABRIC BENEATH ROCK	SQUARE FEET	EQUAL COMBINATION OF 1-2" AND 2-4"	MINIMUM 100% COVERAGE ALL AREAS SHOWN
	4	OKLAHOMA MOSS ROCK BOULDERS	BURY BOTTOM THIRD OF BOULDER IN LANDSCAPE BED.	TONS	FIELD LOCATE	50 LB - 250 LB PER BOULDER

## GENERAL LANDSCAPE NOTES

## INSPECTIONS:

- NO EXCAVATION SHALL OCCUR IN CITY R.O.W. WITHOUT A R.O.W. PERMIT--CONTACT THE PUBLIC WORKS DEPARTMENT.
- THE CONTRACTOR SHALL MARK ALL WATER LINES, SEWER LINES, AND TREE LOCATIONS PRIOR TO CALLING FOR ROW INSPECTION AND PERMIT.
- THE LANDSCAPE INSTALLATION SHALL COMPLY WITH APPROVED LANDSCAPE DRAWINGS PRIOR TO FINAL ACCEPTANCE BY THE CITY AND ISSUANCE OF A CERTIFICATE OF OCCUPANCY.
- WATER METERS, CLEANOUTS AND OTHER APPURTENANCES, SHALL BE ACCESSIBLE, ADJUSTED TO GRADE, CLEARLY MARKED WITH FLAGGING AND COMPLIANT WITH PUBLIC WORKS DEPARTMENT STANDARDS PRIOR TO CALLING FOR FINAL LANDSCAPE AND ROW INSPECTIONS.

## LANDSCAPE STANDARDS:

- PLANTINGS AND LANDSCAPE ELEMENTS SHALL COMPLY WITH THE CITY'S ENGINEERING DESIGN STANDARDS, PUBLIC R.O.W. VISIBILITY REQUIREMENTS.
- UNLESS OTHERWISE SPECIFIED, TREES SHALL BE PLANTED NO LESS THAN 4' FROM CURBS, SIDEWALKS, UTILITY LINES, SCREENING WALLS AND OTHER STRUCTURES. THE CITY HAS FINAL APPROVAL FOR ALL TREE PLACEMENTS.
- A MINIMUM THREE FEET (3') RADIUS AROUND A FIRE HYDRANT MUST REMAIN CLEAR OF LANDSCAPE PURSUANT TO THE FIRE CODE.
- STREET TREES, WHERE REQUIRED, SHALL BE (10') MINIMUM FROM THE EDGE OF A STORM SEWER CURB INLET BOX AND THE EDGE OF THE ROOT BALL SHALL BE (4') MINIMUM FROM THE WATER METER.
- THE AMERICAN STANDARD FOR NURSERY STOCK (ANSI Z60.1-2004) SPECIFICATIONS SHALL GOVERN PLANT QUALIFICATIONS, GRADES, AND STANDARDS.
- TREE PLANTING SHALL COMPLY WITH DETAILS HEREIN AND THE INTERNATIONAL SOCIETY OF ARBORICULTURE (ISA) STANDARDS.
- A 2-3" LAYER OF MULCH SHALL BE PROVIDED AROUND THE BASE OF THE PLANTED TREE. THE MULCH SHALL BE PULLED BACK 4" FROM THE TRUNK OF THE TREE.
- TREE PITS SHALL BE TESTED FOR WATER PERCOLATION. IF WATER DOES NOT DRAIN OUT OF TREE PIT WITHIN 24-HOURS, THE TREE SHALL BE MOVED OR DRAINAGE SHALL BE PROVIDED.
- ALL BEDS TO HAVE 3" OF COMPOSTED SOIL, LIVING EARTH TECHNOLOGY, OR APPROVED EQUAL TILLED AND TURNED TO A DEPTH OF 8" MINIMUM.
- ALL PLANT BEDS SHALL BE TOP-DRESSED WITH A MINIMUM OF 3 INCHES OF HARDWOOD MULCH.
- NATIVE SITE TOPSOIL IS TO BE PROTECTED FROM EROSION OR STOCKPILED. NATIVE SITE TOPSOIL SHALL BE LABORATORY TESTED BY AND ACCREDITED LABORATORY AND AMENDED PER SAID LABORATORY'S RECOMMENDATIONS.

## IRRIGATION STANDARDS:

- ANY CHANGES TO THESE APPROVED IRRIGATION DRAWINGS SHALL BE AUTHORIZED BY THE CITY. CONTACT DEVELOPMENT SERVICES FOR AN IRRIGATION PERMIT PRIOR TO INSTALLING THE IRRIGATION SYSTEM.
- IRRIGATION OVER-SPRAY ON STREETS AND WALKS IS PROHIBITED.
- MAINLINES, VALVES, OR CONTROL WIRES SHALL NOT BE LOCATED IN THE CITY'S ROW.
- ET IRRIGATION CONTROLLERS SHALL BE PROGRAMMED AND ADJUSTED TO NOT EXCEED THE LANDSCAPE WATER ALLOWANCE (LWA) PRIOR TO APPROVAL OF LANDSCAPE INSTALLATION.
- VALVES SHALL BE LOCATED A MINIMUM OF (3') AWAY FROM STORM SEWERS, AND SANITARY SEWER LINES AND 5 FEET FROM CITY FIRE HYDRANTS AND WATER VALVES.
- THE BORE DEPTH UNDER STREETS, DRIVE AISLES, AND FIRE LANES SHALL PROVIDE (2') OF CLEARANCE (MINIMUM).
- IRRIGATION HEADS THAT RUN PARALLEL AND NEAR PUBLIC WATER AND SANITARY SEWER LINES; SHALL BE FED FROM STUBBED LATERALS OR BULL-HEADS. A MINIMUM FIVE FOOT (5') SEPARATION IS REQUIRED BETWEEN IRRIGATION MAIN LINES AND LATERALS THAT RUN PARALLEL TO PUBLIC WATER AND SANITARY SEWER LINES.
- NO VALVES, BACKFLOW PREVENTION ASSEMBLIES, QUICK COUPLERS ETC. SHALL BE LOCATED CLOSER THAN 10' FROM THE CURB AT STREET OR DRIVE INTERSECTION.

## MAINTENANCE STANDARDS:

- THE OWNER SHALL BE RESPONSIBLE FOR THE ESTABLISHMENT, MAINTENANCE, AND VIGOR OF PLANT MATERIAL IN ACCORDANCE WITH THE DESIGN INTENT AND AS APPROPRIATE FOR THE SEASON OF THE YEAR.
- LANDSCAPE AND OPEN AREAS SHALL BE FREE OF TRASH, LITTER AND WEEDS.
- NO PLANT MATERIAL SHALL BE ALLOWED TO ENCROACH ON R.O.W., SIDEWALKS OR EASEMENTS TO THE EXTENT THAT VISION OR ROUTE OF TRAVEL FOR VEHICULAR, PEDESTRIAN, OR BICYCLE TRAFFIC IS IMPEDED.
- TREE MAINTENANCE SHALL BE IN ACCORDANCE WITH THE STANDARDS OF THE INTERNATIONAL SOCIETY OF ARBORICULTURE.
- TREE STAKING MATERIALS, IF USED, SHALL BE REMOVED AFTER (1) GROWING SEASON, NO MORE THAN (1) YEAR AFTER INSTALLATION (STEEL TREE STAKES, WIRES, AND HOSES ARE PROHIBITED).

## TREE PROTECTION NOTES:

- CONTACT DEVELOPMENT SERVICES FOR A TREE REMOVAL PERMIT PRIOR TO REMOVAL OR TRANSPLANTING OF ANY TREES.
- ALL TREES WHICH ARE TO REMAIN ON SITE SHALL BE PROTECTED WITH A (4') TALL BRIGHTLY COLORED PLASTIC FENCE, OR SILT FENCE, PLACED AT THE DRIP LINE OF THE TREES.
- PRIOR TO THE PRE-CONSTRUCTION MEETING OR OBTAINING A GRADING PERMIT, ALL TREE MARKINGS AND PROTECTIVE FENCING SHALL BE INSTALLED BY THE OWNER AND BE INSPECTED BY DEVELOPMENT SERVICES.
- NO EQUIPMENT SHALL BE CLEANED, OR HARMFUL LIQUIDS DEPOSITED WITHIN THE LIMITS OF THE ROOT ZONE OF TREES WHICH REMAIN ON SITE.
- NO SIGNS, WIRES, OR OTHER ATTACHMENTS SHALL BE ATTACHED TO ANY TREE TO REMAIN ON SITE.
- VEHICULAR AND CONSTRUCTION EQUIPMENT SHALL NOT PARK OR DRIVE WITHIN THE LIMITS OF THE DRIP LINE.
- GRADE CHANGES IN EXCESS OF 3 INCHES (CUT OR FILL) SHALL NOT BE ALLOWED WITHIN A ROOT ZONE, UNLESS ADEQUATE TREE PRESERVATION METHODS ARE APPROVED BY THE CITY.
- NO TRENCHING SHALL BE ALLOWED WITHIN THE DRIP-LINE OF A TREE, UNLESS APPROVED BY THE CITY.
- ALL REMOVED TREES SHALL BE CHIPPED AND USED FOR MULCH ON SITE OR HAULED OFF-SITE.
- ALL TREE MAINTENANCE TECHNIQUES SHALL BE IN CONFORMANCE WITH INDUSTRY IDENTIFIED STANDARDS. IMPROPER OR MALICIOUS PRUNING TECHNIQUES ARE STRICTLY PROHIBITED.

## APPROVED:

I hereby certify that the above and foregoing site plan for a development in the City of Rockwall, Texas, was approved by the Planning & Zoning Commission of the City of Rockwall on the 16 day of February, 2022.

WITNESS OUR HANDS, this 16 day of February, 2022.

NOT TO SCALE

Planning & Zoning Commission, Chairman

Director of Planning and Zoning


## LANDSCAPE PROVIDED

## JOHN KING BOULEVARD


- A. MINIMUM TWENTY (50) FOOT LANDSCAPE EDGE PROVIDED
- B. 10' SIDEWALK WITHIN LANDSCAPE BUFFER PROVIDED.
- C. 3 - 4" CAL. CANOPY TREE & 4 ACCENT TREES / 100 LF OF LINEAR FRONTAGE  
596 LF OF FRONTAGE / 100 LF = 18 - 4" CAL. TREES & 22 ACCENT TREES REQUIRED  
PROVIDED: 18 - 4" CALIPER CANOPY TREES & 23 ACCENT TREES PROVIDED
- D. MIN 30" HT. SHRUBBERY PROVIDED ALONG LENGTH OF STREET FRONTAGE.

## DETENTION AREA LOT CA8 BLOCK I

- A. 1 SHRUB OR ORNAMENTAL GRASS PER 750 SF OF DRY DETENTION AREA.  
91,263 SF OF DETENTION AREA / 750 SF = 122 - SHRUBS OR ORNAMENTAL GRASSES  
PROVIDED: 188 ORNAMENTAL GRASSES.

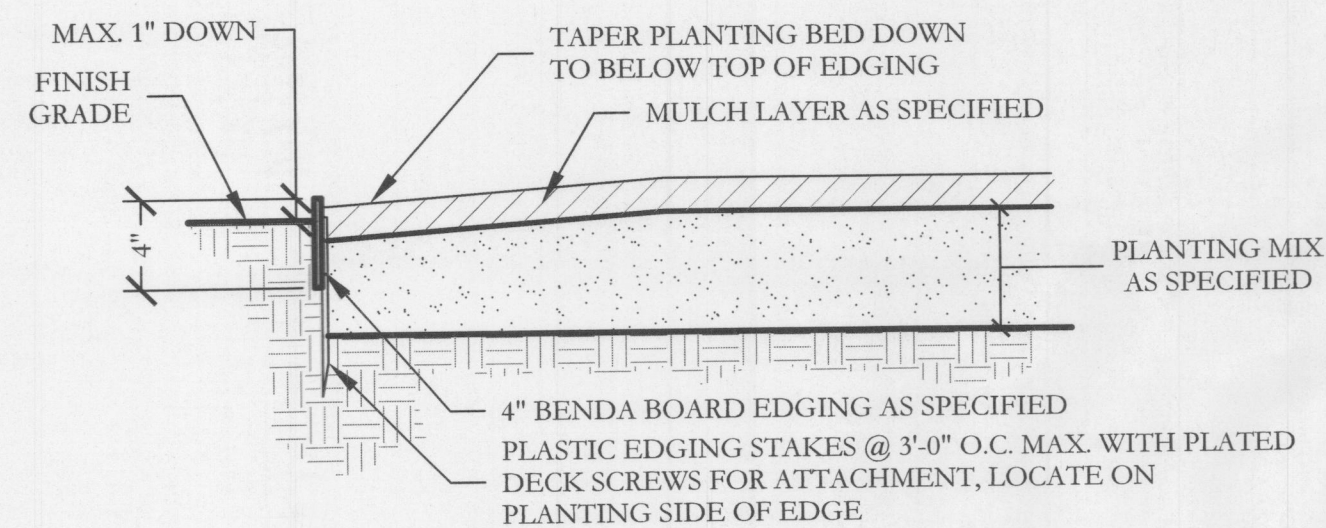


1 TYPICAL BED EDGING DETAIL SECTION NOT TO SCALE

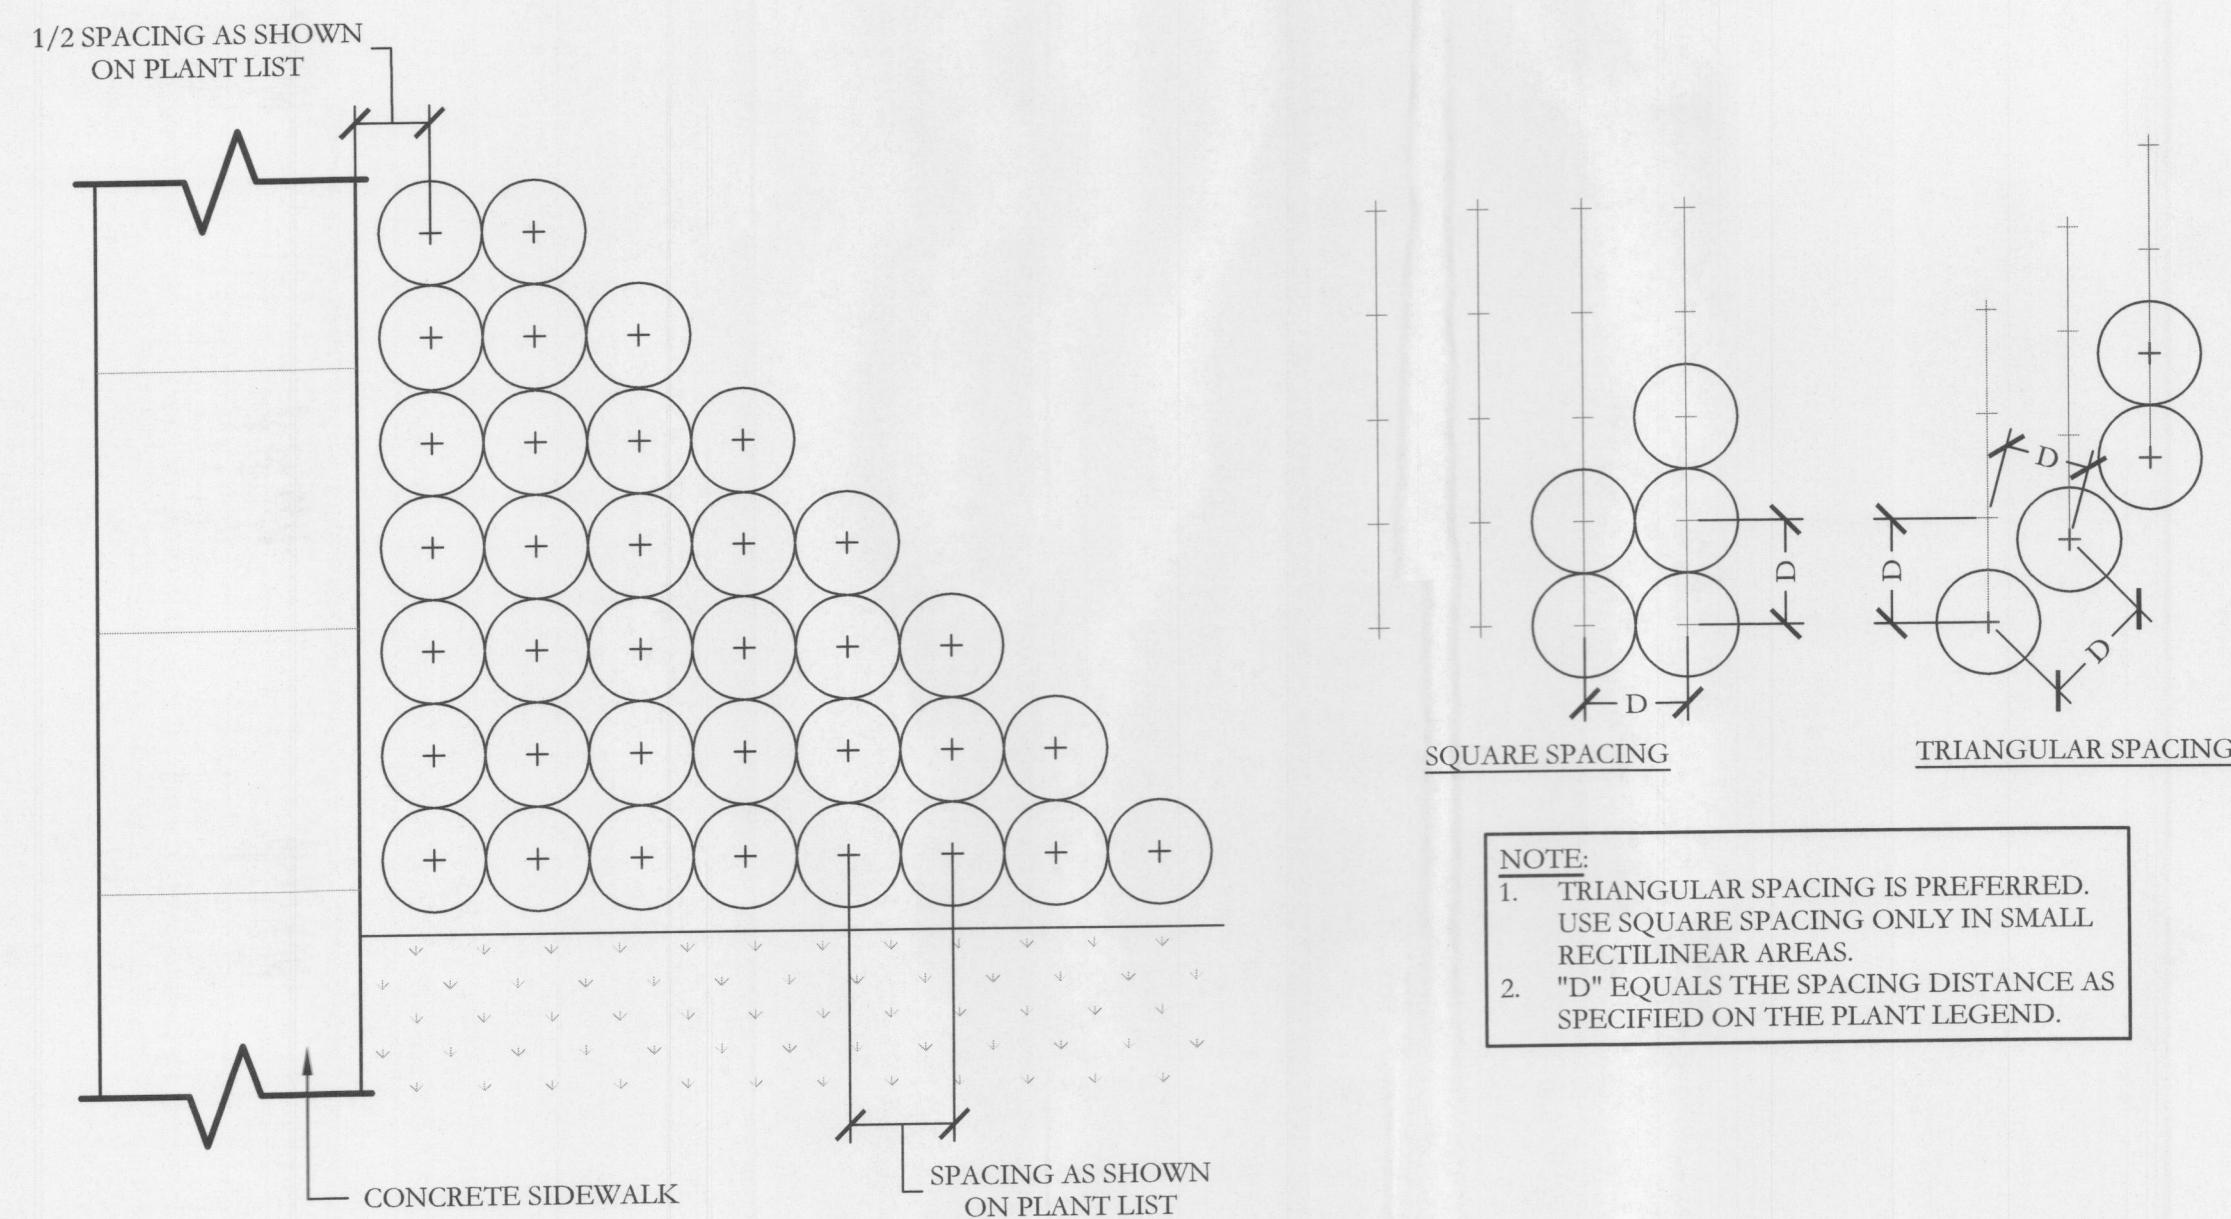


2 TYPICAL SHRUB AND GROUNDCOVER PLANTING PLAN/SECTION




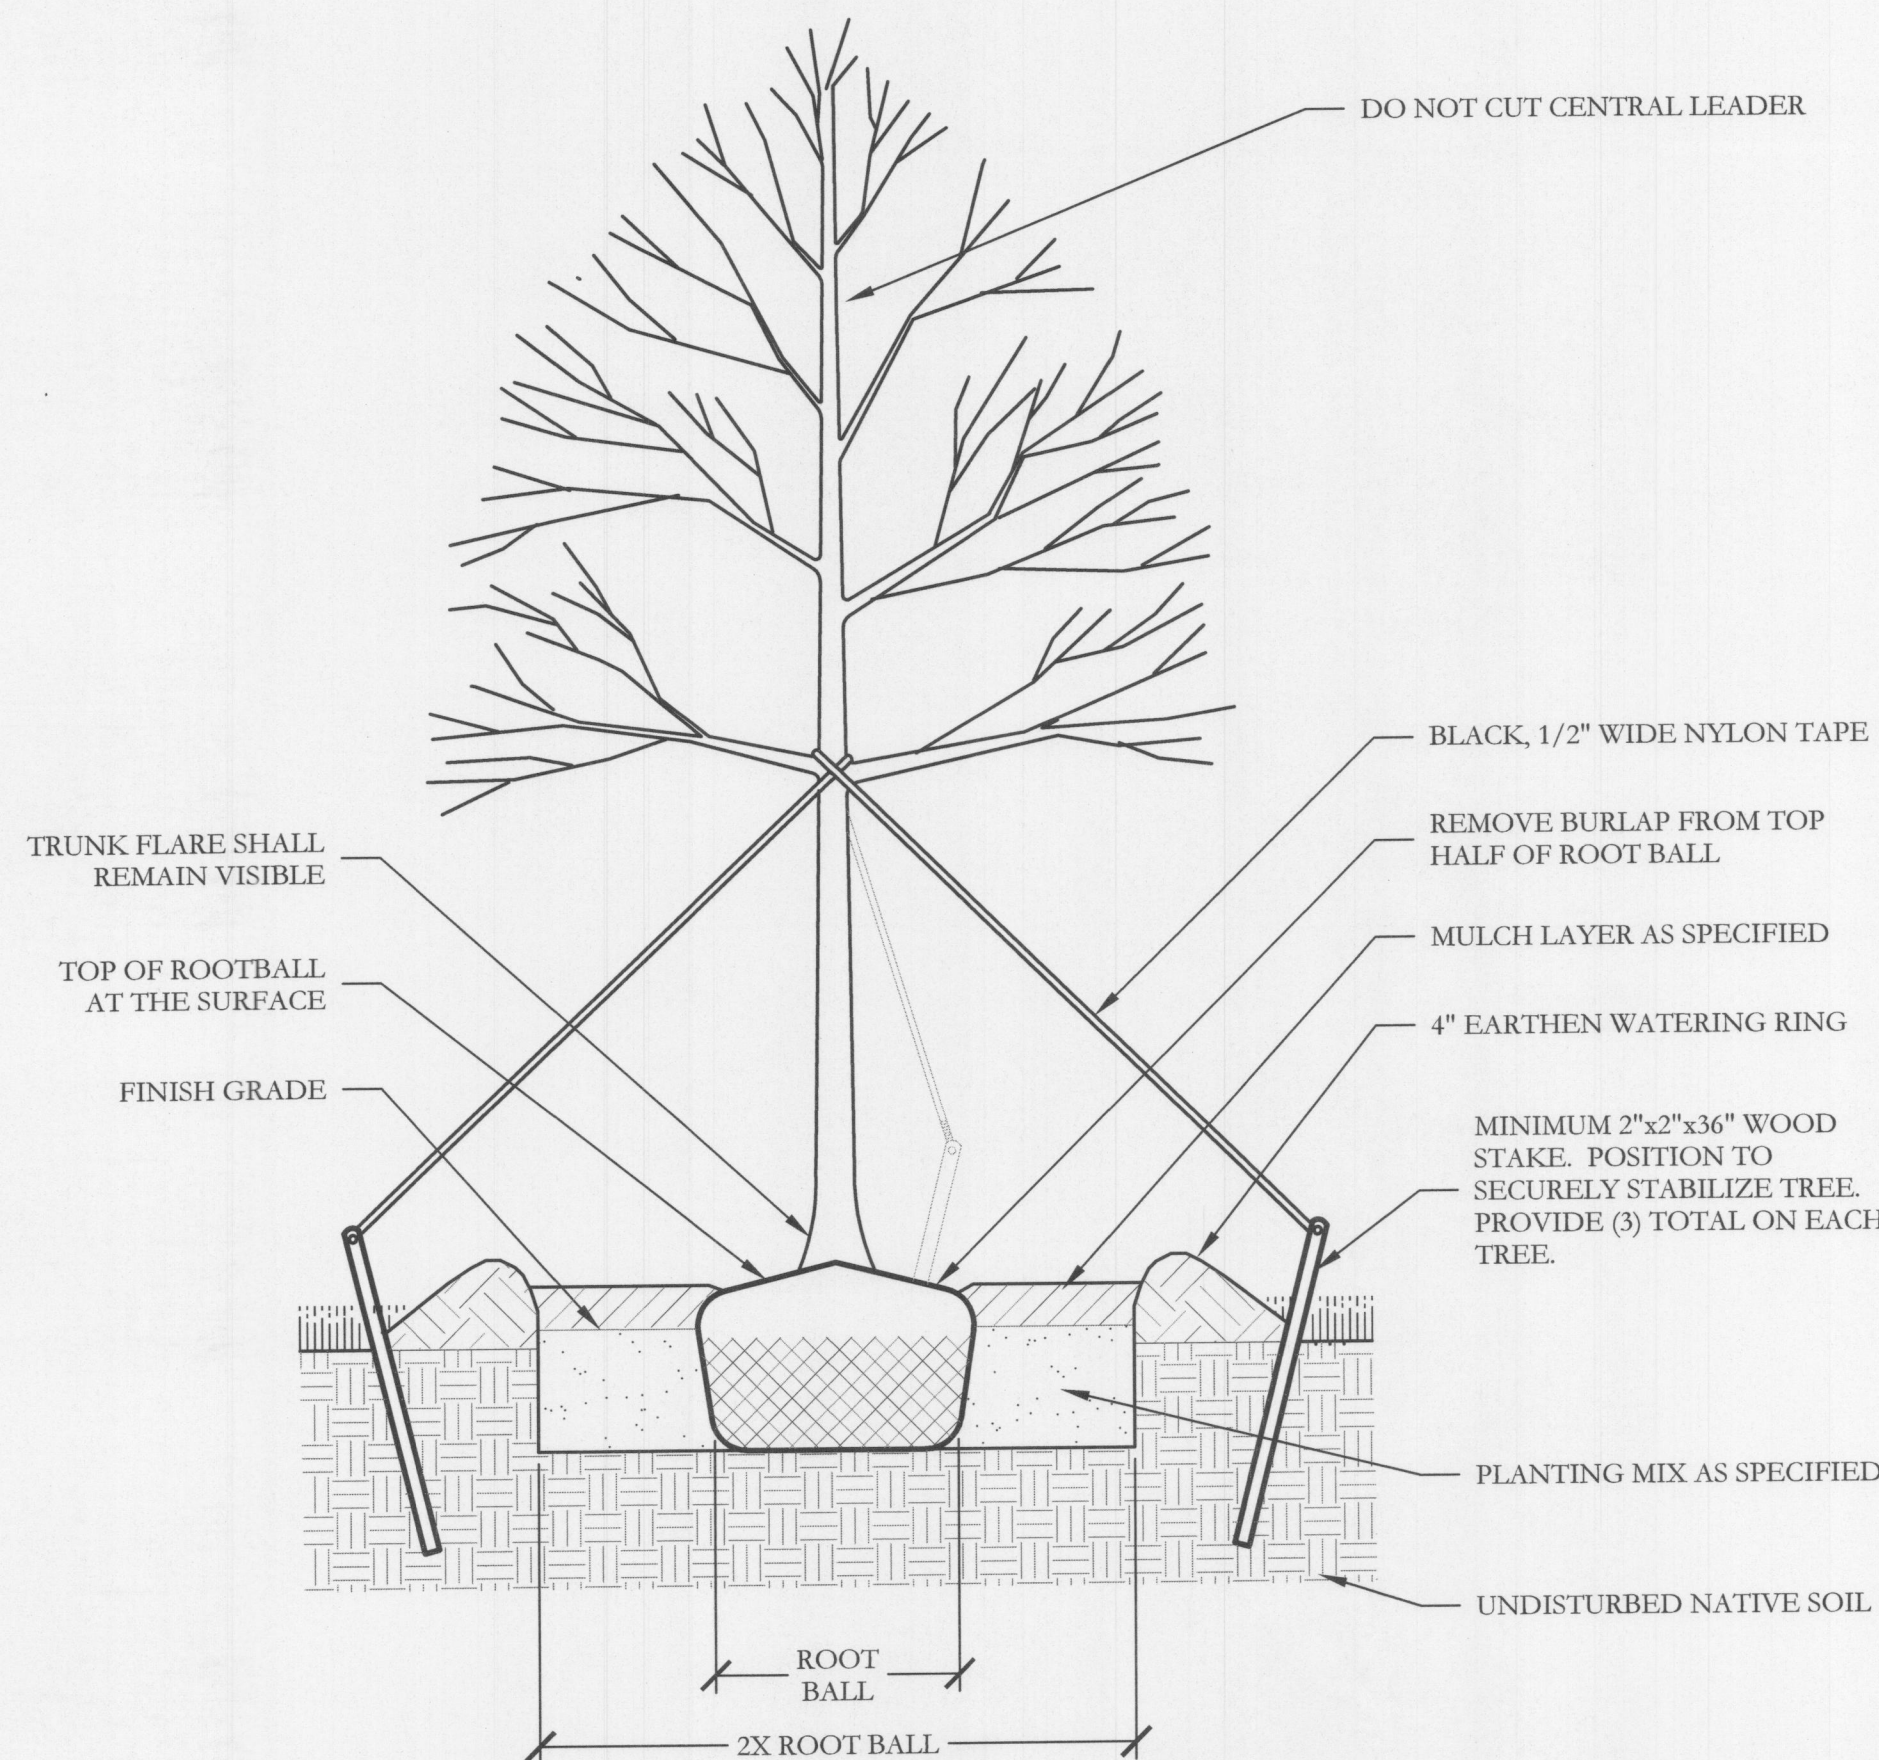


1 TYPICAL TREE PLANTING SECTION NOT TO SCALE

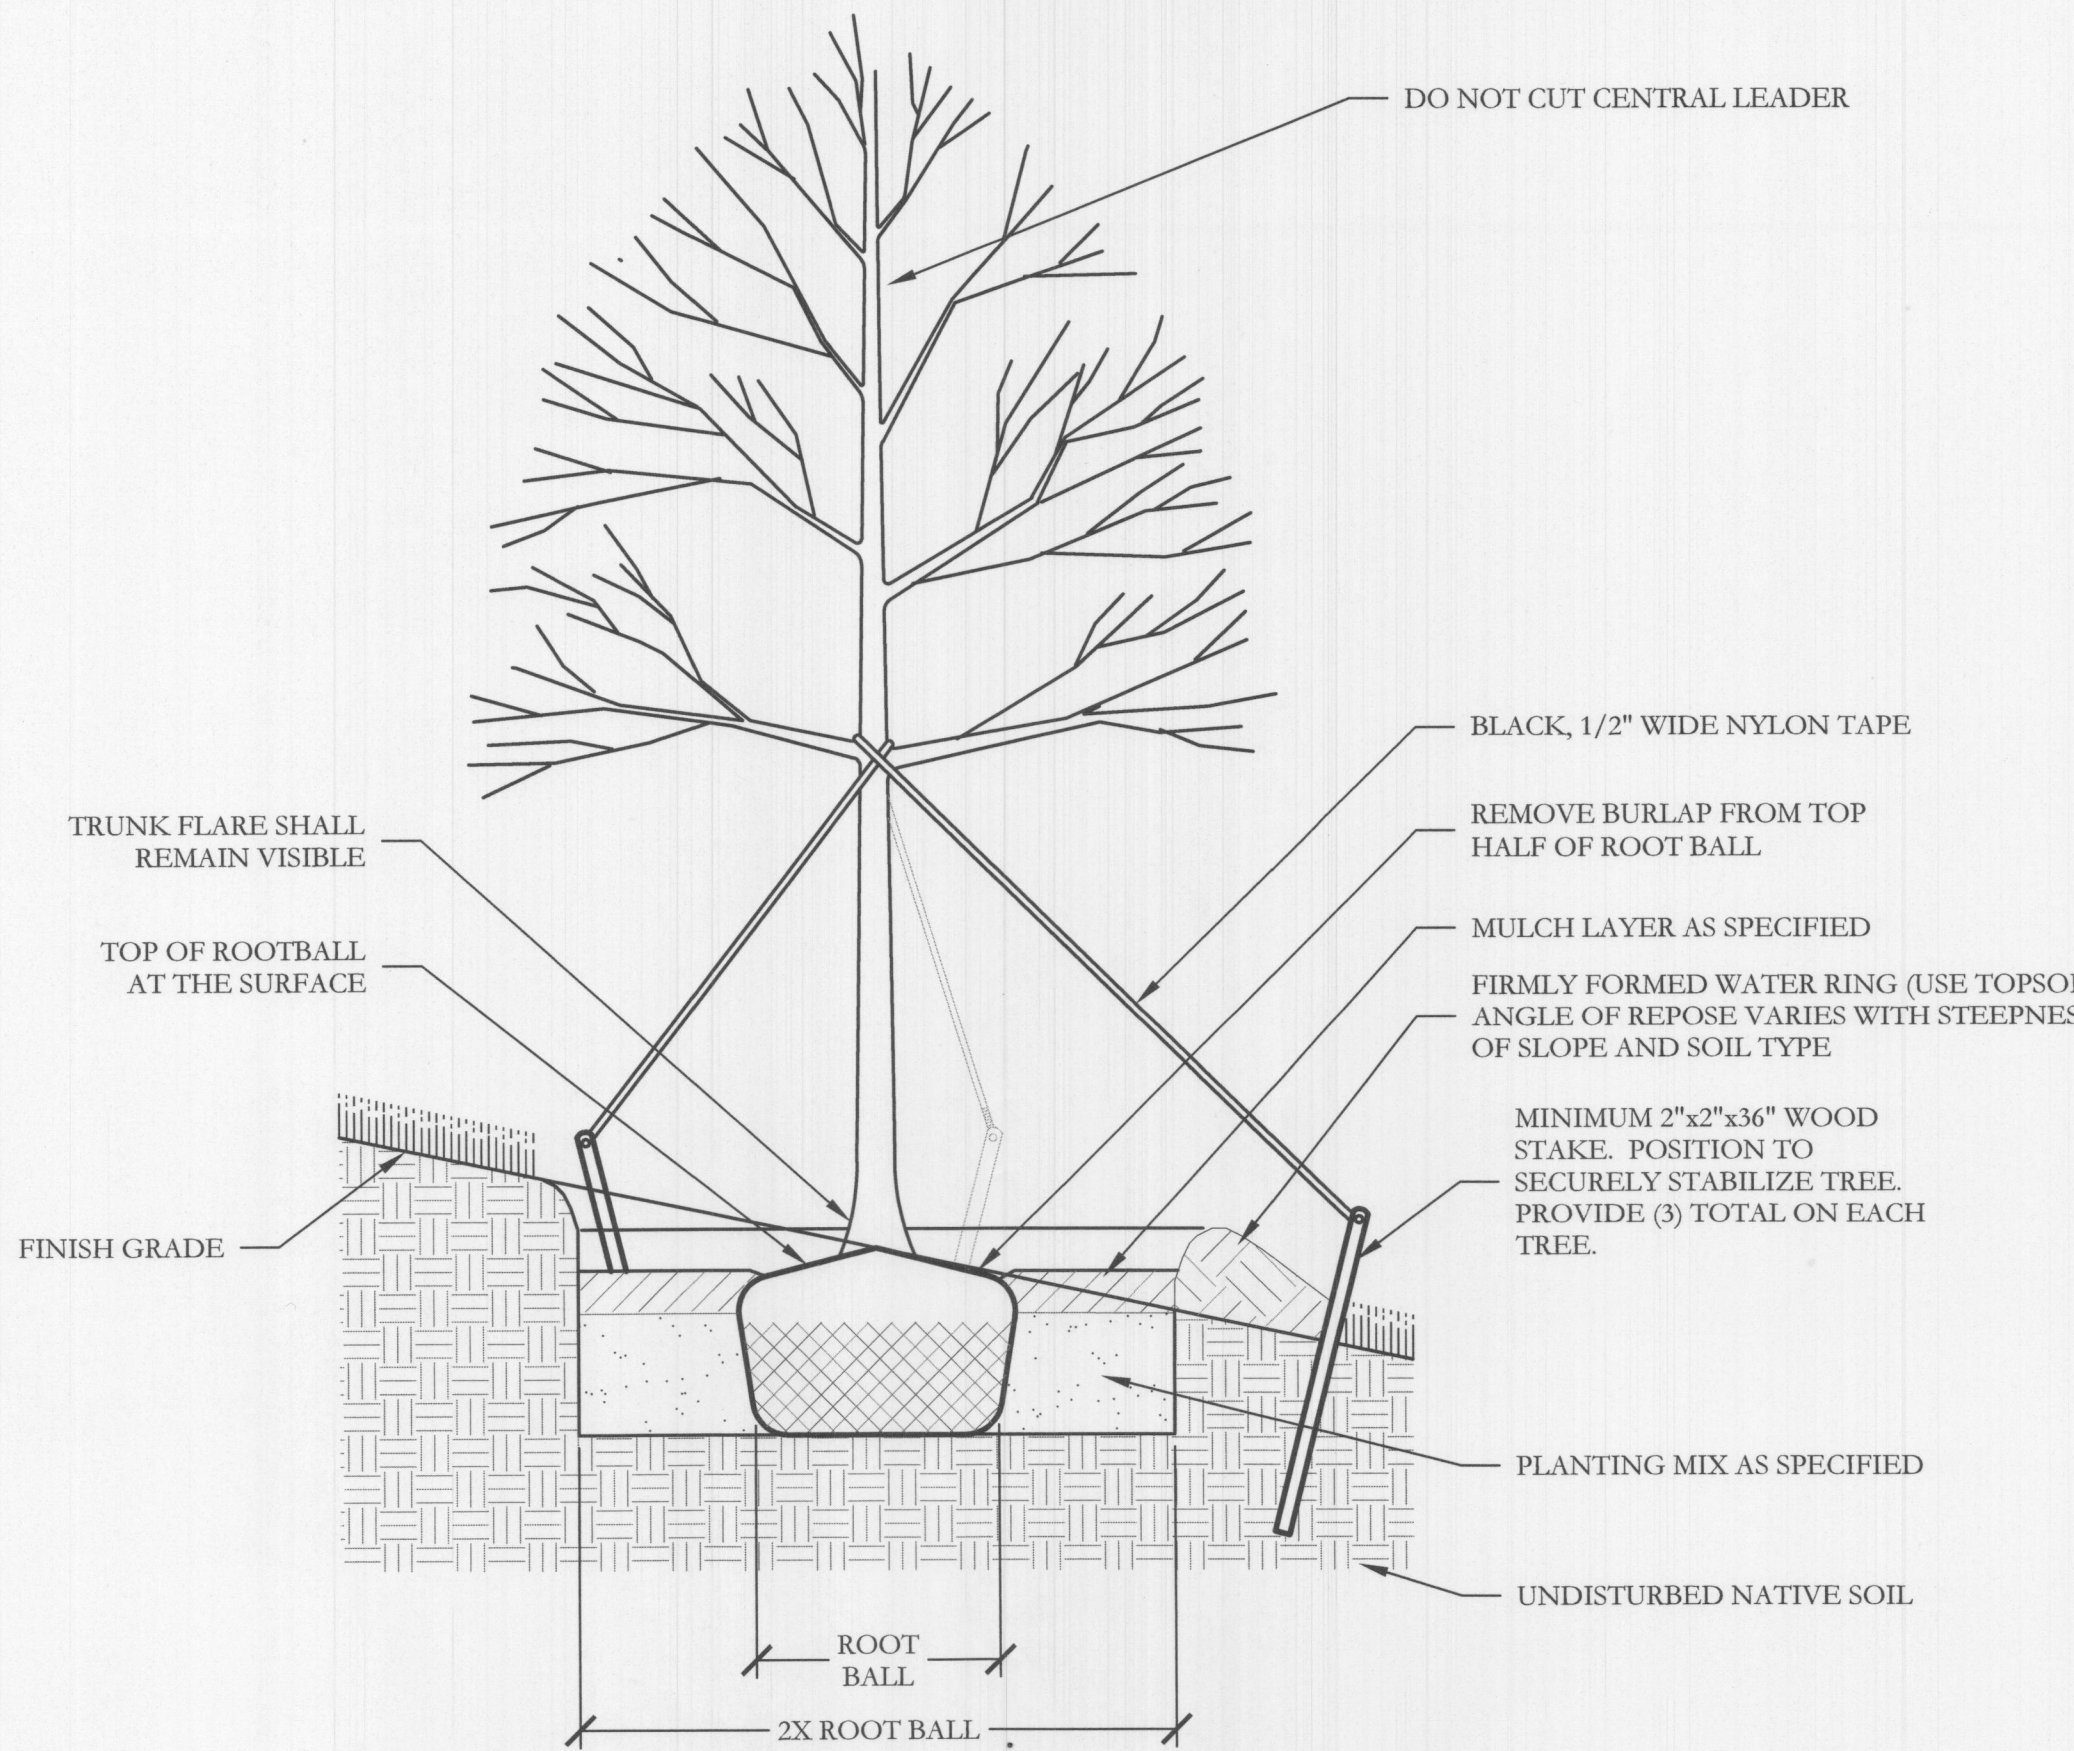


3 TYPICAL TREE PLANTING ON SLOPE SECTION NOT TO SCALE

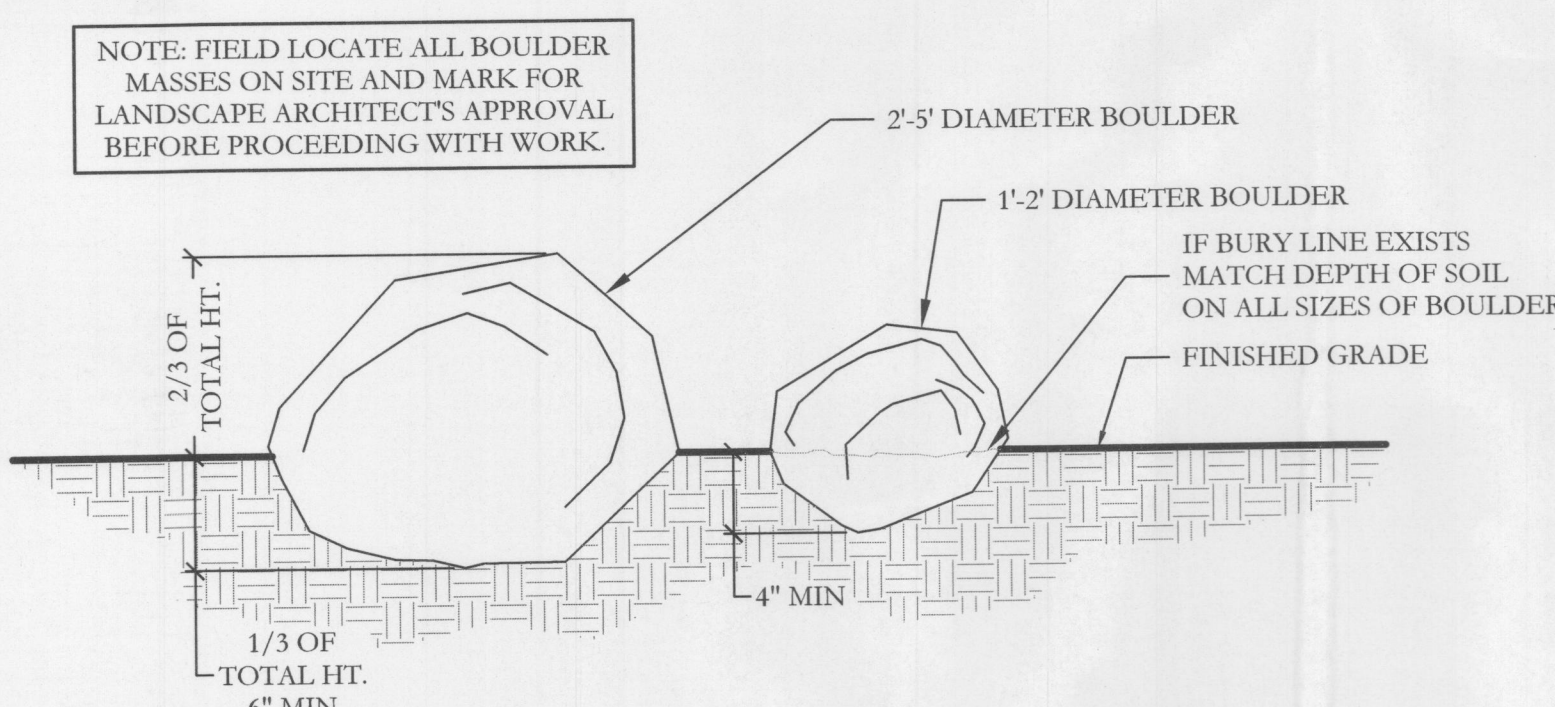

2 LANDSCAPE BOULDER DETAIL SECTION NOT TO SCALE

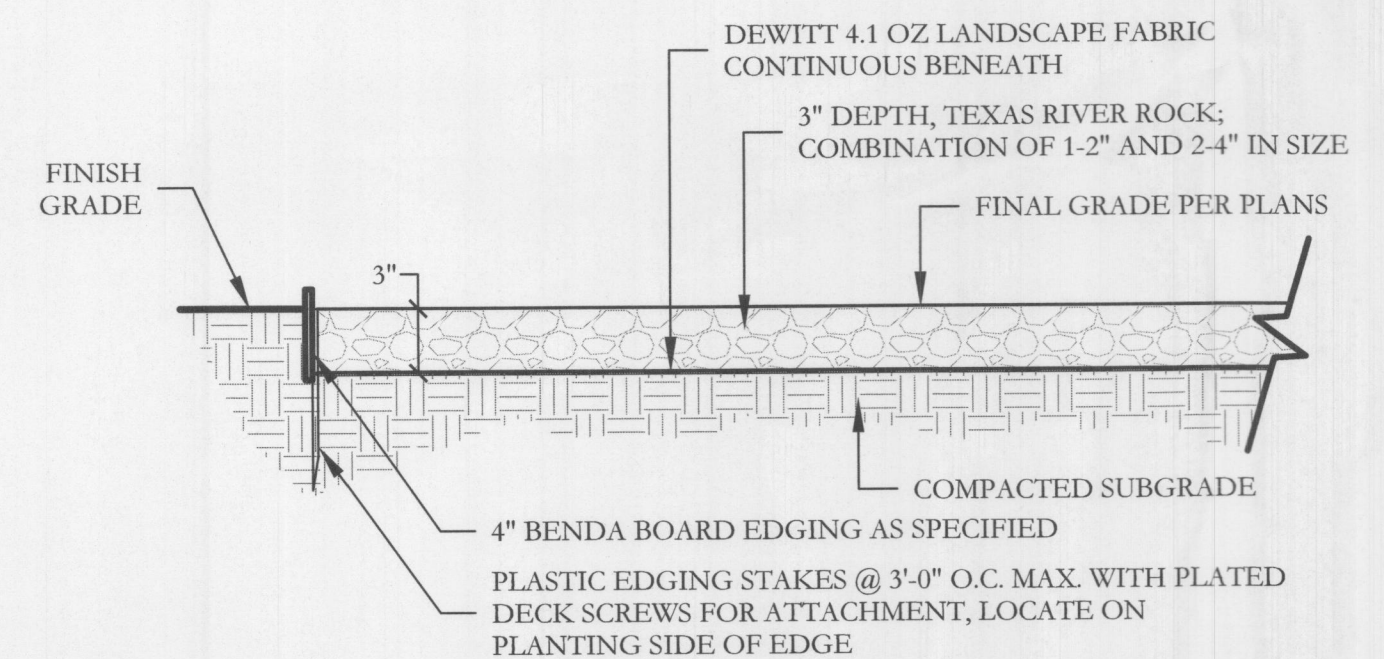

4 TEXAS RIVER ROCK BED SECTION SCALE: 1" = 1'-0"

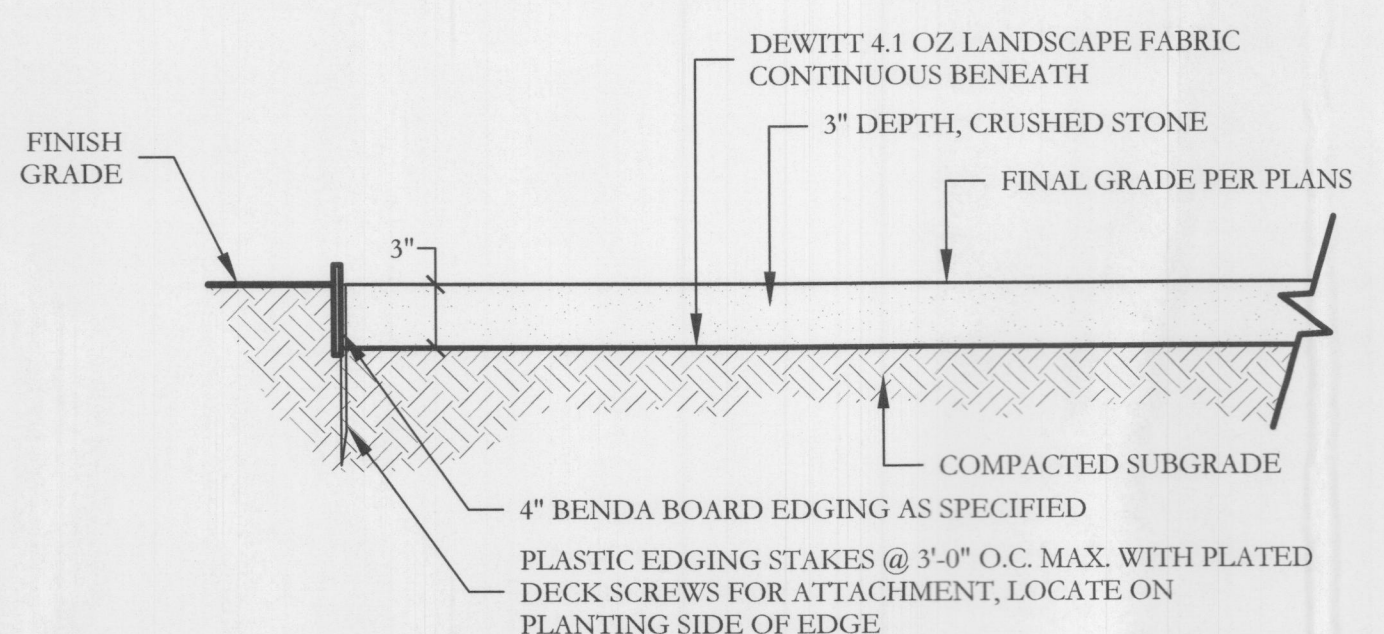

5 CRUSHED STONE DETAILS SECTION SCALE: 1" = 1'-0"


**APPROVED:**  
I hereby certify that the above and foregoing site plan for a development in the City of Rockwall, Texas, was approved by the Planning & Zoning Commission of the City of Rockwall on the 16 day of February, 2022.

WITNESS OUR HANDS, this 16 day of February, 2022.

*[Signature]* Planning & Zoning Commission, Chairman  
*[Signature]* Director of Planning and Zoning



MATCHLINE  
REF: SHEET HS3, L2, IR2  
REF: SHEET HS2, L1, IR1

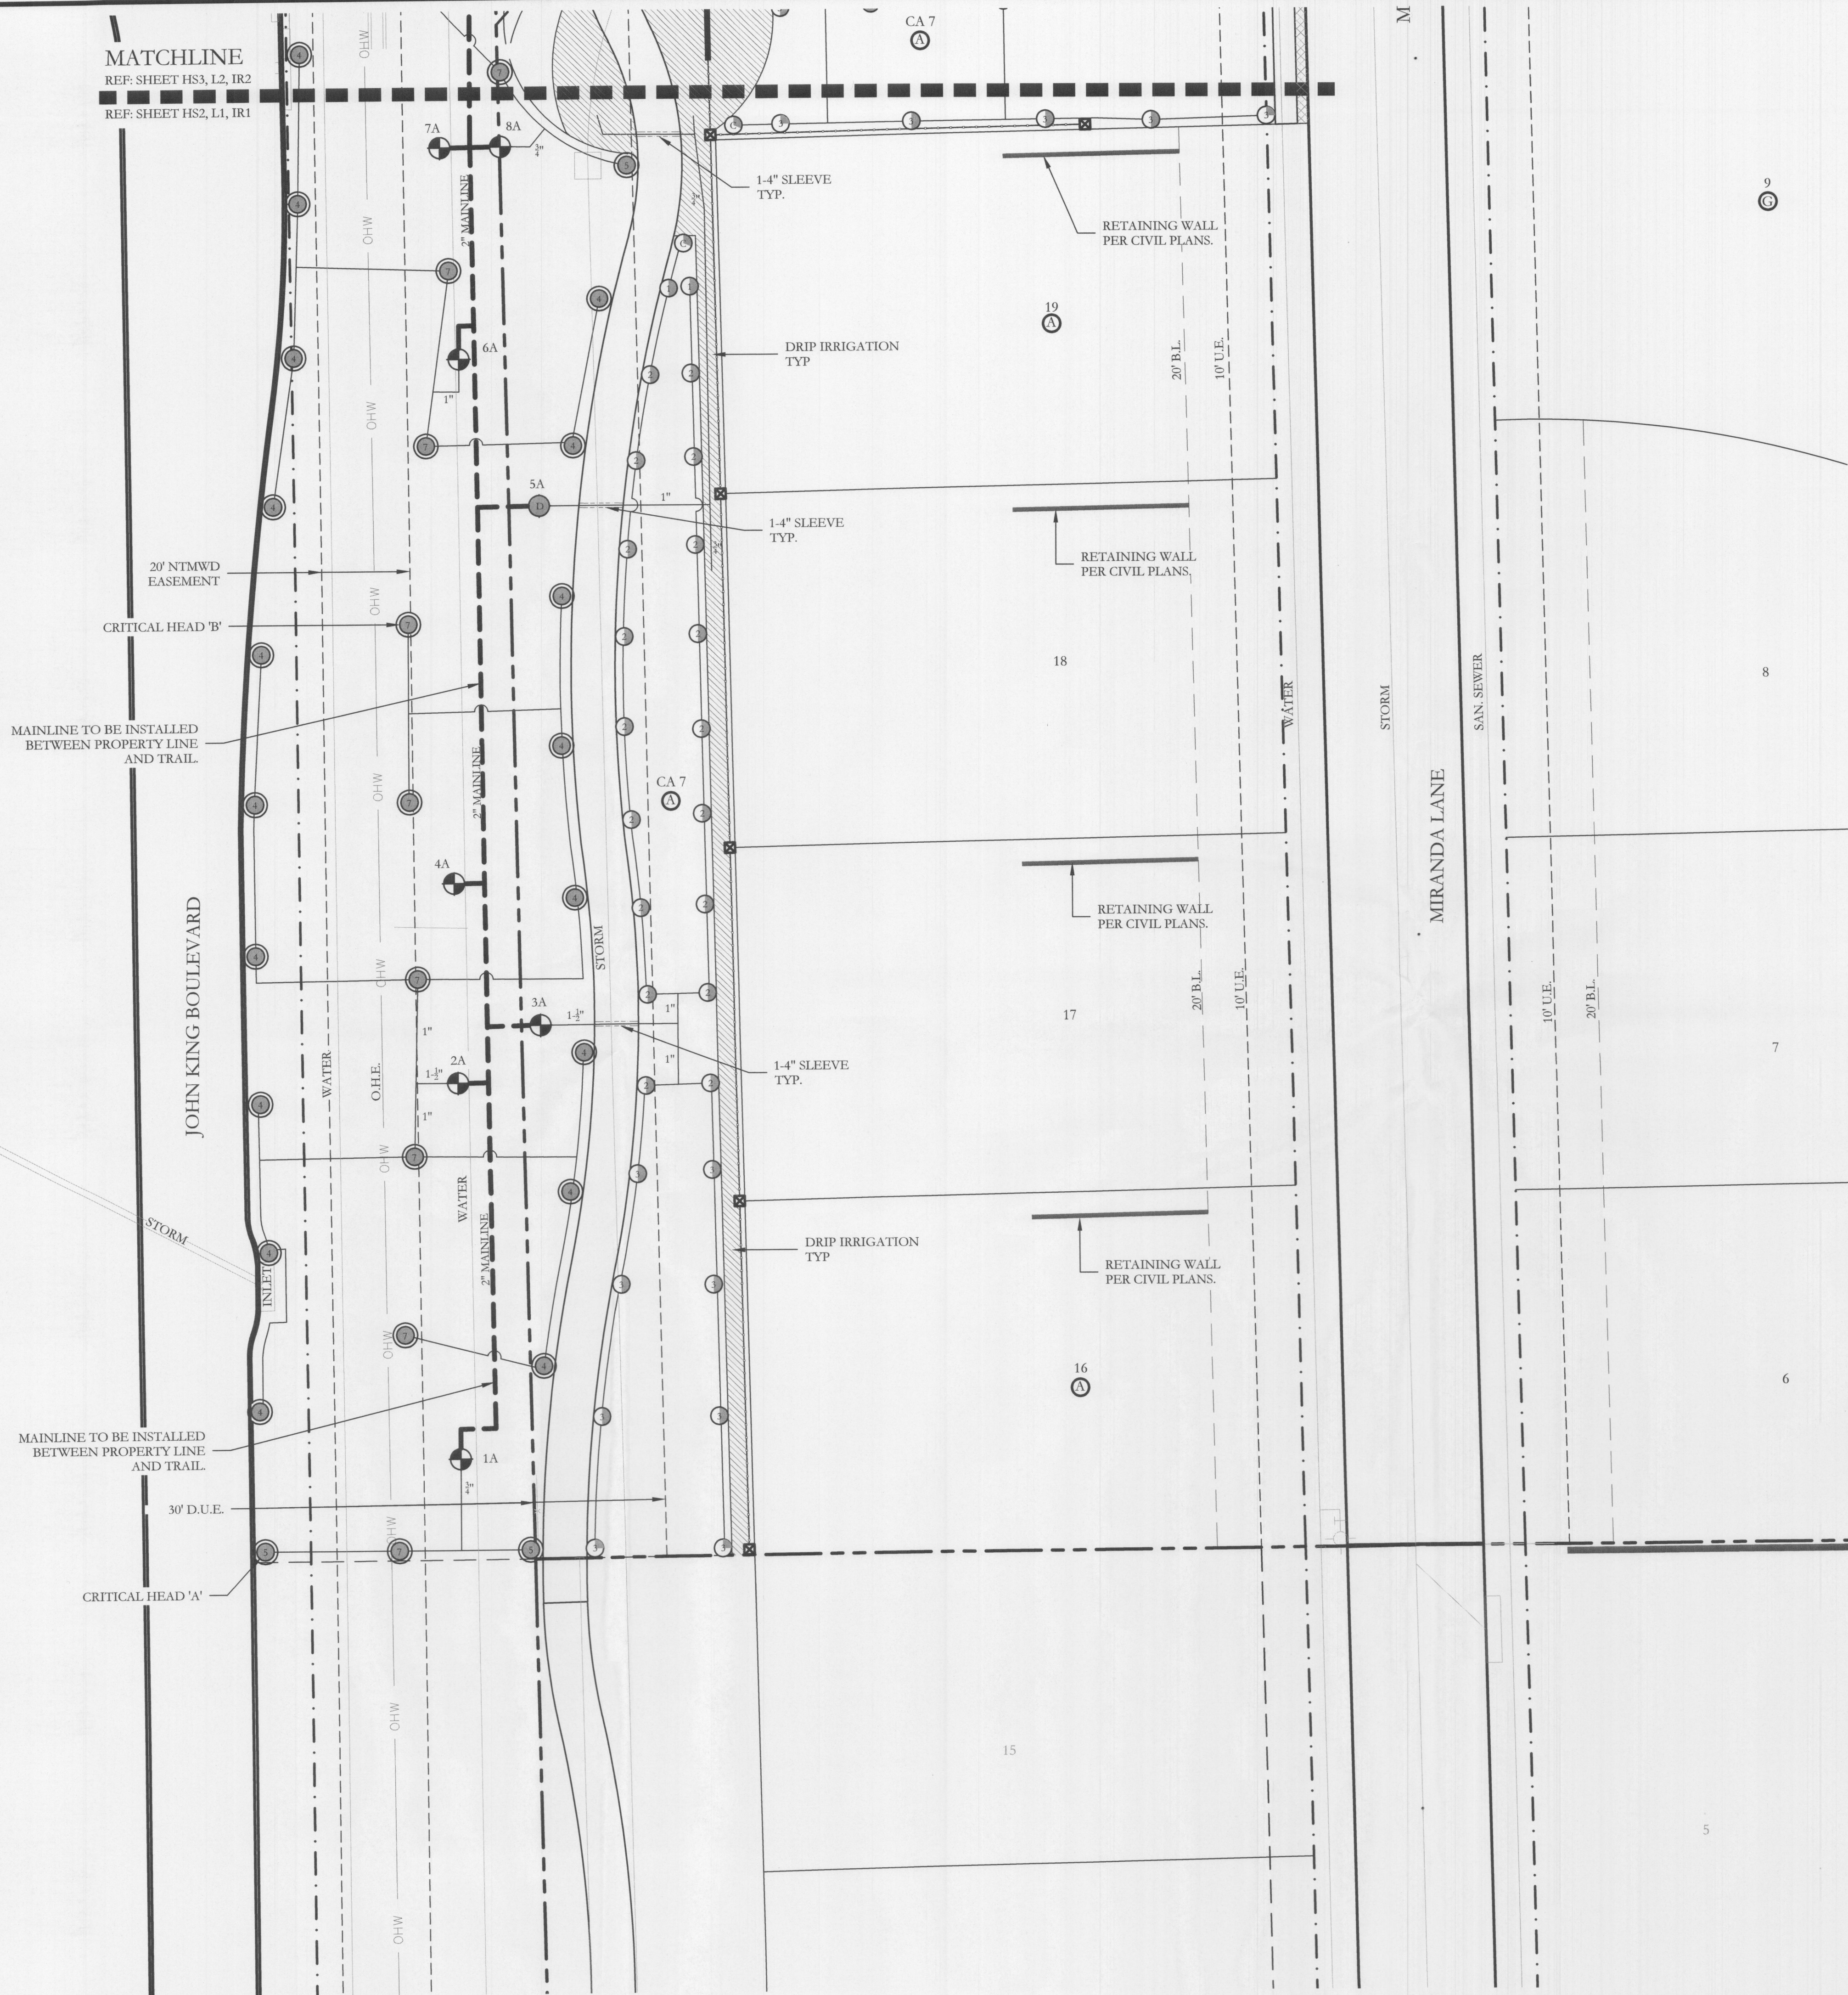

IRRIGATION LEGEND AND SCHEDULE

SYM	DESCRIPTION	MANUFACTURER	MODEL	SIZE / NOZZLE
	AUTOMATIC CONTROLLER	HUNTER	REFER TO PLANS	N/A
	DRIP IRRIGATION CONTROL VALVE	HUNTER	ICZ-101	1"
	DRIP IRRIGATION (LANDSCAPE BEDS)	HUNTER	PLD-06-18	N/A
	DRIP IRRIGATION (TURF BEDS)	HUNTER	PLD-06-12	N/A
	DRIP IRRIGATION	HUNTER	AFB-ADJ BUBBLER (0.5 GPM EACH BUBBLER)	1/2"
	REMOTE CONTROL VALVE	HUNTER	ICV-101G ICV-151G	REFER TO PLAN FOR SIZE
	LAWN MP ROTATOR	HUNTER	MP ROTATOR	MP1000, MP2000, MP3000, MP3500
	4" POP UP MP ROTATOR CORNER STRIP	HUNTER	STRIP SERIES	MP1000S IVORY MP1000S COPPER MP1000S BROWN
	4" POP UP MP ROTATOR CORNER	HUNTER	CORNER SERIES	MP CORNER SERIES ADJUSTABLE ARC 8-15"
	ROTOR HEAD	HUNTER	PGP SERIES	#4 QUARTER/HALF #5 QUARTER #7 HALF/FULL #9 HALF
	WATER METER	---	PER CITY	REFER TO PLAN FOR SIZE
	DOUBLE CHECK VALVE	FEBCO	850-BV Series	REFER TO PLAN FOR SIZE
	ISOLATION VALVE	NIBCO	*T-113	LINE SIZE
	WYE STRAINER	FEBCO	*850	REFER TO PLAN FOR SIZE
	MASTER VALVE	HUNTER	ICV-101G ICV-151G	REFER TO PLAN FOR SIZE
	IRRIGATION SLEEVE	---	SCH. 40 w/ 12 GA. PULL WIRE IN SLEEVE	REFER TO PLAN FOR SIZE
	IRRIGATION MAIN LINE	---	SCH. 40	REFER TO PLAN FOR SIZE
	IRRIGATION LATERAL LINE	---	CLASS 200	REFER TO PLAN FOR SIZE

	PROGRAM AND STATION NUMBER FOR AUTOMATIC CONTROLLER
	VALVE SIZE IN INCHES
	GALLONS PER MINUTE, PER VALVE

REFER TO SHEET IR5 FOR FULL IRRIGATION LEGEND AND SCHEDULE

NOTE:  
ALL LATERAL LINES SHALL BE 3/4" CLASS 200 PVC UNLESS OTHERWISE NOTED ON PLANS.

VALVE LEGEND 'A'



1A 1" V 7.40	2A 1.5" V 36.20	3A 1.5" V 27.11	4A OPEN <20.00	5A DRIP 13.80
6A 1" V 16.40	7A OPEN <20.00	8A 1" V 7.40	9A 1.5" V 32.93	10A DRIP 5.85
11A DRIP 9.41	12A 1.5" V 25.20	13A OPEN <20.00	14A 1.5" V 24.18	

ZONE VALVES LABELED AS 'OPEN' ARE INTENDED FOR THE USE OF SUPPLYING HUNTER AFB-ADJ TREE BUBBLERS ON EACH PROPOSED TREE. IRRIGATION CONTRACTOR SHALL FIELD VERIFY THAT THESE ZONES DO NOT EXCEED 20 GALLONS PER MINUTE. THE IRRIGATION CONTRACTOR SHALL STAKE EACH TREE BUBBLER HEAD LOCATION AND RECEIVE APPROVAL FROM THE OWNER AND/OR THE OWNER'S REPRESENTATIVE PRIOR TO INSTALLATION.

APPROVED:  
I hereby certify that the above and foregoing site plan for a development in the City of Rockwall, Texas, was approved by the Planning & Zoning Commission of the City of Rockwall on the 16 day of February, 2022.

WITNESS OUR HANDS, this 16 day of February, 2022.  
  
Planning & Zoning Commission, Chairman  
  
Director of Planning and Zoning

JOHNSON VOLK  
CONSULTING

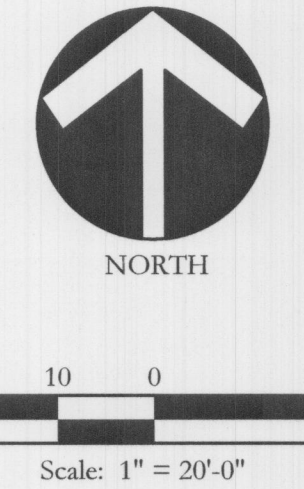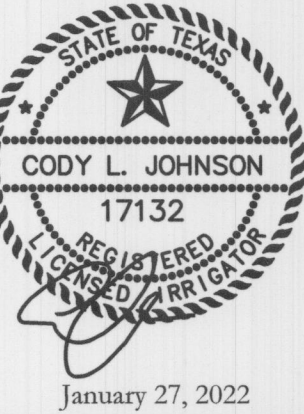

Bar is one inch on original drawing. If not one inch on this sheet, adjust scale as necessary.  
One Inch

SCREENING AND BUFFERING


Irrigation Plan

Saddle Star South - Phase 3

City of Rockwall, RockwallCounty, Texas

CJS PROJECT NO.  
PAD001B  
SHEET NO.  
IR1 of 6



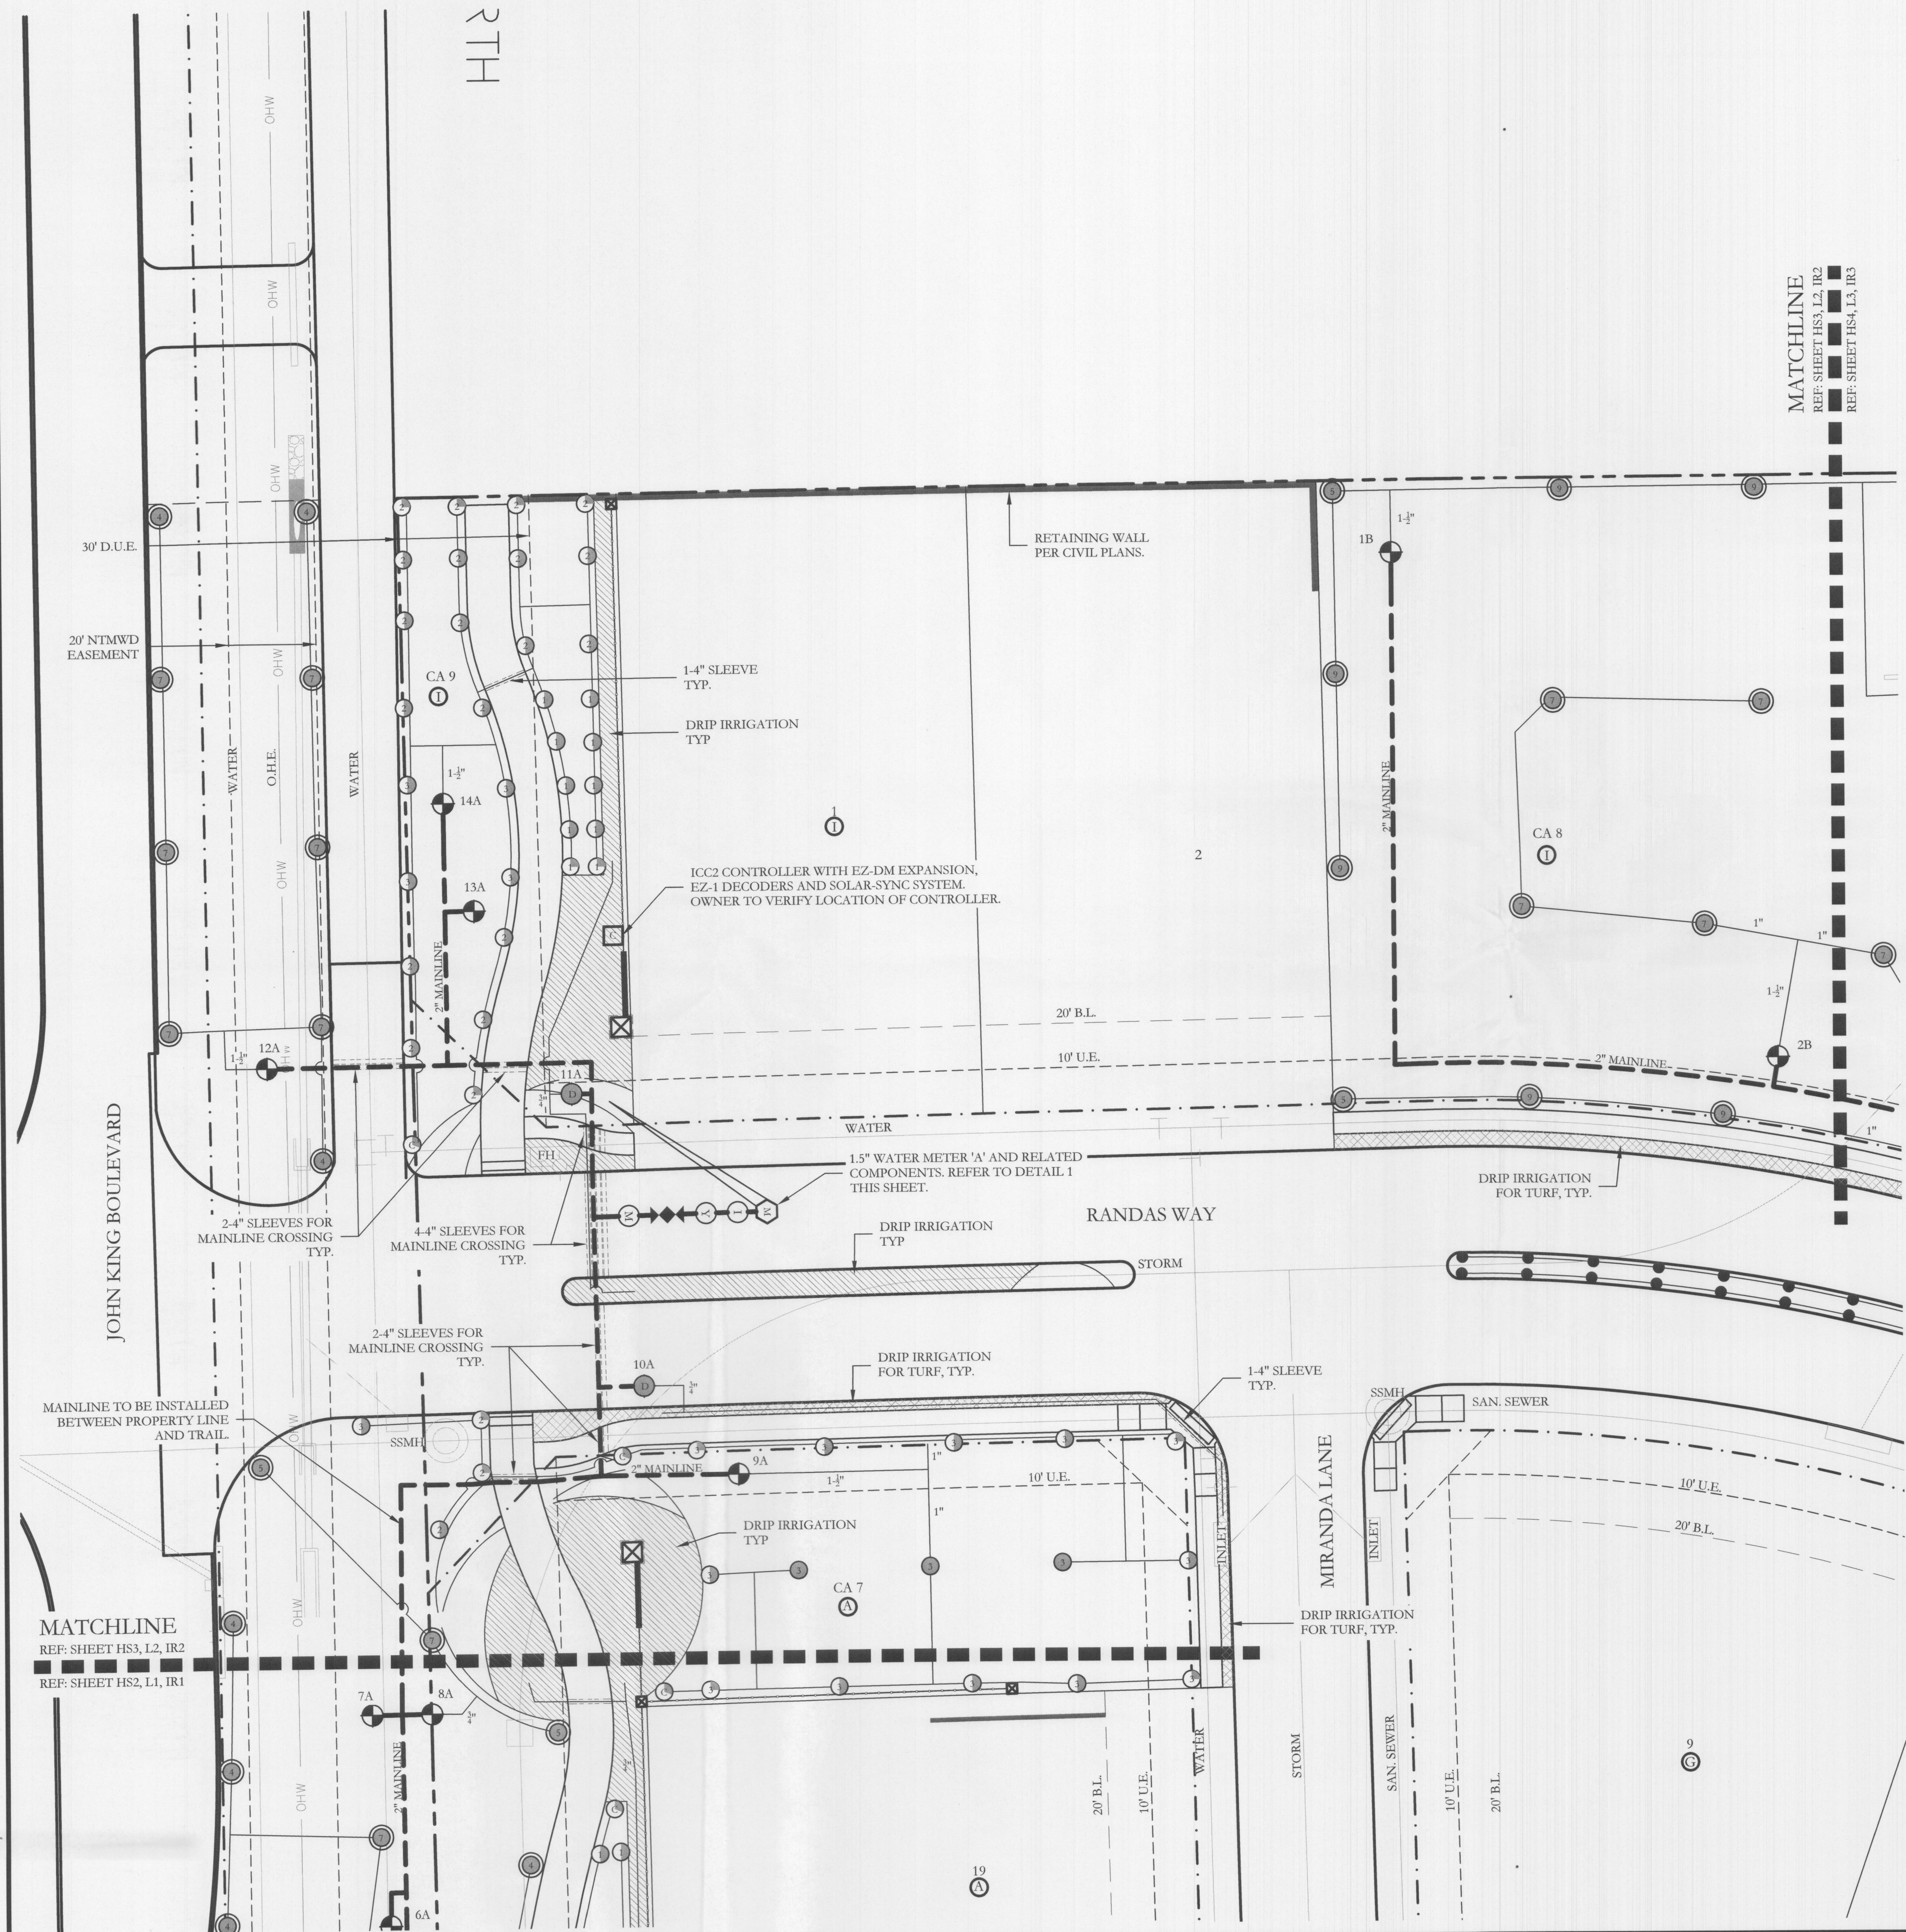

IRRIGATION LEGEND AND SCHEDULE

SYM	DESCRIPTION	MANUFACTURER	MODEL	SIZE / NOZZLE
C	AUTOMATIC CONTROLLER	HUNTER	REFER TO PLANS	N/A
D	DRIP IRRIGATION CONTROL VALVE	HUNTER	ICZ-101	1"
	DRIP IRRIGATION (LANDSCAPE BEDS)	HUNTER	PLD-06-18	N/A
	DRIP IRRIGATION (TURF BEDS)	HUNTER	PLD-06-12	N/A
	DRIP IRRIGATION	HUNTER	AFB-ADJ BUBBLER (0.5 GPM EACH BUBBLER)	1/2"
	REMOTE CONTROL VALVE	HUNTER	ICV-101G ICV-151G	REFER TO PLAN FOR SIZE
	LAWN MP ROTATOR	HUNTER	MP ROTATOR	MP1000, MP2000, MP3000, MP3500
	4" POP UP MP ROTATOR CORNER STRIP	HUNTER	STRIP SERIES	MPLC515 IVORY MPRC515 COPPER MPSS530 BROWN
	4" POP UP MP ROTATOR CORNER	HUNTER	CORNER SERIES	MP CORNER SERIES ADJUSTABLE ARC 8-15°
	ROTOR HEAD	HUNTER	PGP SERIES	#4 QUARTER/HALF #5 QUARTER #7 HALF/FULL #9 HALF
M	WATER METER	---	PER CITY	REFER TO PLAN FOR SIZE
	DOUBLE CHECK VALVE	FEBCO	850-BV Series	REFER TO PLAN FOR SIZE
I	ISOLATION VALVE	NIBCO	*T-113	LINE SIZE
Y	WYE STRAINER	FEBCO	*850	REFER TO PLAN FOR SIZE
M	MASTER VALVE	HUNTER	ICV-101G ICV-151G	REFER TO PLAN FOR SIZE
	IRRIGATION SLEEVE	---	SCH. 40 w/ 12 GA. PULL WIRE IN SLEEVE	REFER TO PLAN FOR SIZE
	IRRIGATION MAIN LINE	---	SCH. 40	REFER TO PLAN FOR SIZE
	IRRIGATION LATERAL LINE	---	CLASS 200	REFER TO PLAN FOR SIZE

- PROGRAM AND STATION NUMBER FOR AUTOMATIC CONTROLLER
- VALVE SIZE IN INCHES
- GALLONS PER MINUTE, PER VALVE

REFER TO SHEET IR5 FOR FULL IRRIGATION LEGEND AND SCHEDULE

NOTE:  
ALL LATERAL LINES SHALL BE 3/4" CLASS 200 PVC UNLESS OTHERWISE NOTED ON PLANS.

VALVE LEGEND 'A'

1A	2A	3A	4A	5A
1" V	1.5" V	1.5" V	OPEN	DRIP
7.40	36.20	27.11	<20.00	13.80
6A	7A	8A	9A	10A
1" V	OPEN	1" V	1.5" V	DRIP
16.40	<20.00	7.40	32.93	5.85
11A	12A	13A	14A	
DRIP	1.5" V	OPEN	1.5" V	
9.41	25.20	<20.00	24.18	



- 1.5" WATER METER BY OTHER TRADES
- 1.5" ISOLATION VALVE
- 1.5" WYE STRAINER
- 1.5" DOUBLE CHECK ASSEMBLY
- 1.5" MASTER VALVE
- 2" MAINLINE

ZONE VALVES LABELED AS "OPEN" ARE INTENDED FOR THE USE OF SUPPLYING HUNTER AFB-ADJ TREE BUBBLERS ON EACH PROPOSED TREE. IRRIGATION CONTRACTOR SHALL FIELD VERIFY THAT THESE ZONES DO NOT EXCEED 20 GALLONS PER MINUTE. THE IRRIGATION CONTRACTOR SHALL STAKE EACH TREE BUBBLER HEAD LOCATION AND RECEIVE APPROVAL FROM THE OWNER AND/OR THE OWNER'S REPRESENTATIVE PRIOR TO INSTALLATION.

1 BACKFLOW AND RELATED COMPONENTS  
NOT TO SCALE

APPROVED:  
I hereby certify that the above and foregoing site plan for a development in the City of Rockwall, Texas, was approved by the Planning & Zoning Commission of the City of Rockwall on the 16 day of February, 2022.


WITNESS OUR HANDS, this 16 day of February, 2022.  
[Signature] Planning and Zoning Commission, Chairman  
[Signature] Director of Planning and Zoning

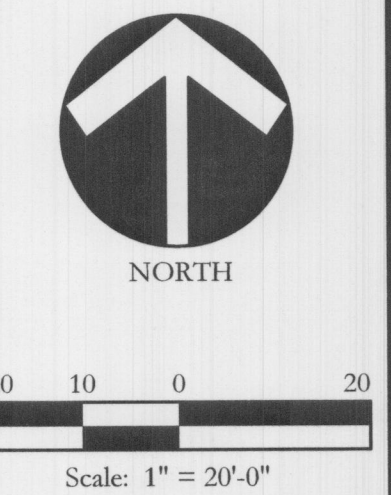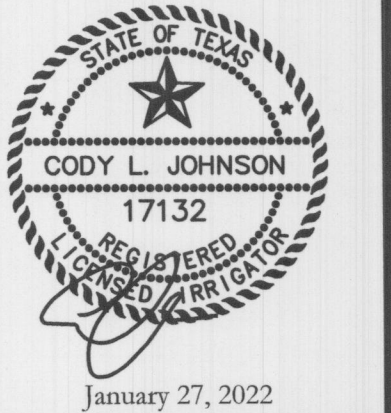

Bar is one inch on original drawing. If not one inch on this sheet, adjust scale as necessary.  
One Inch



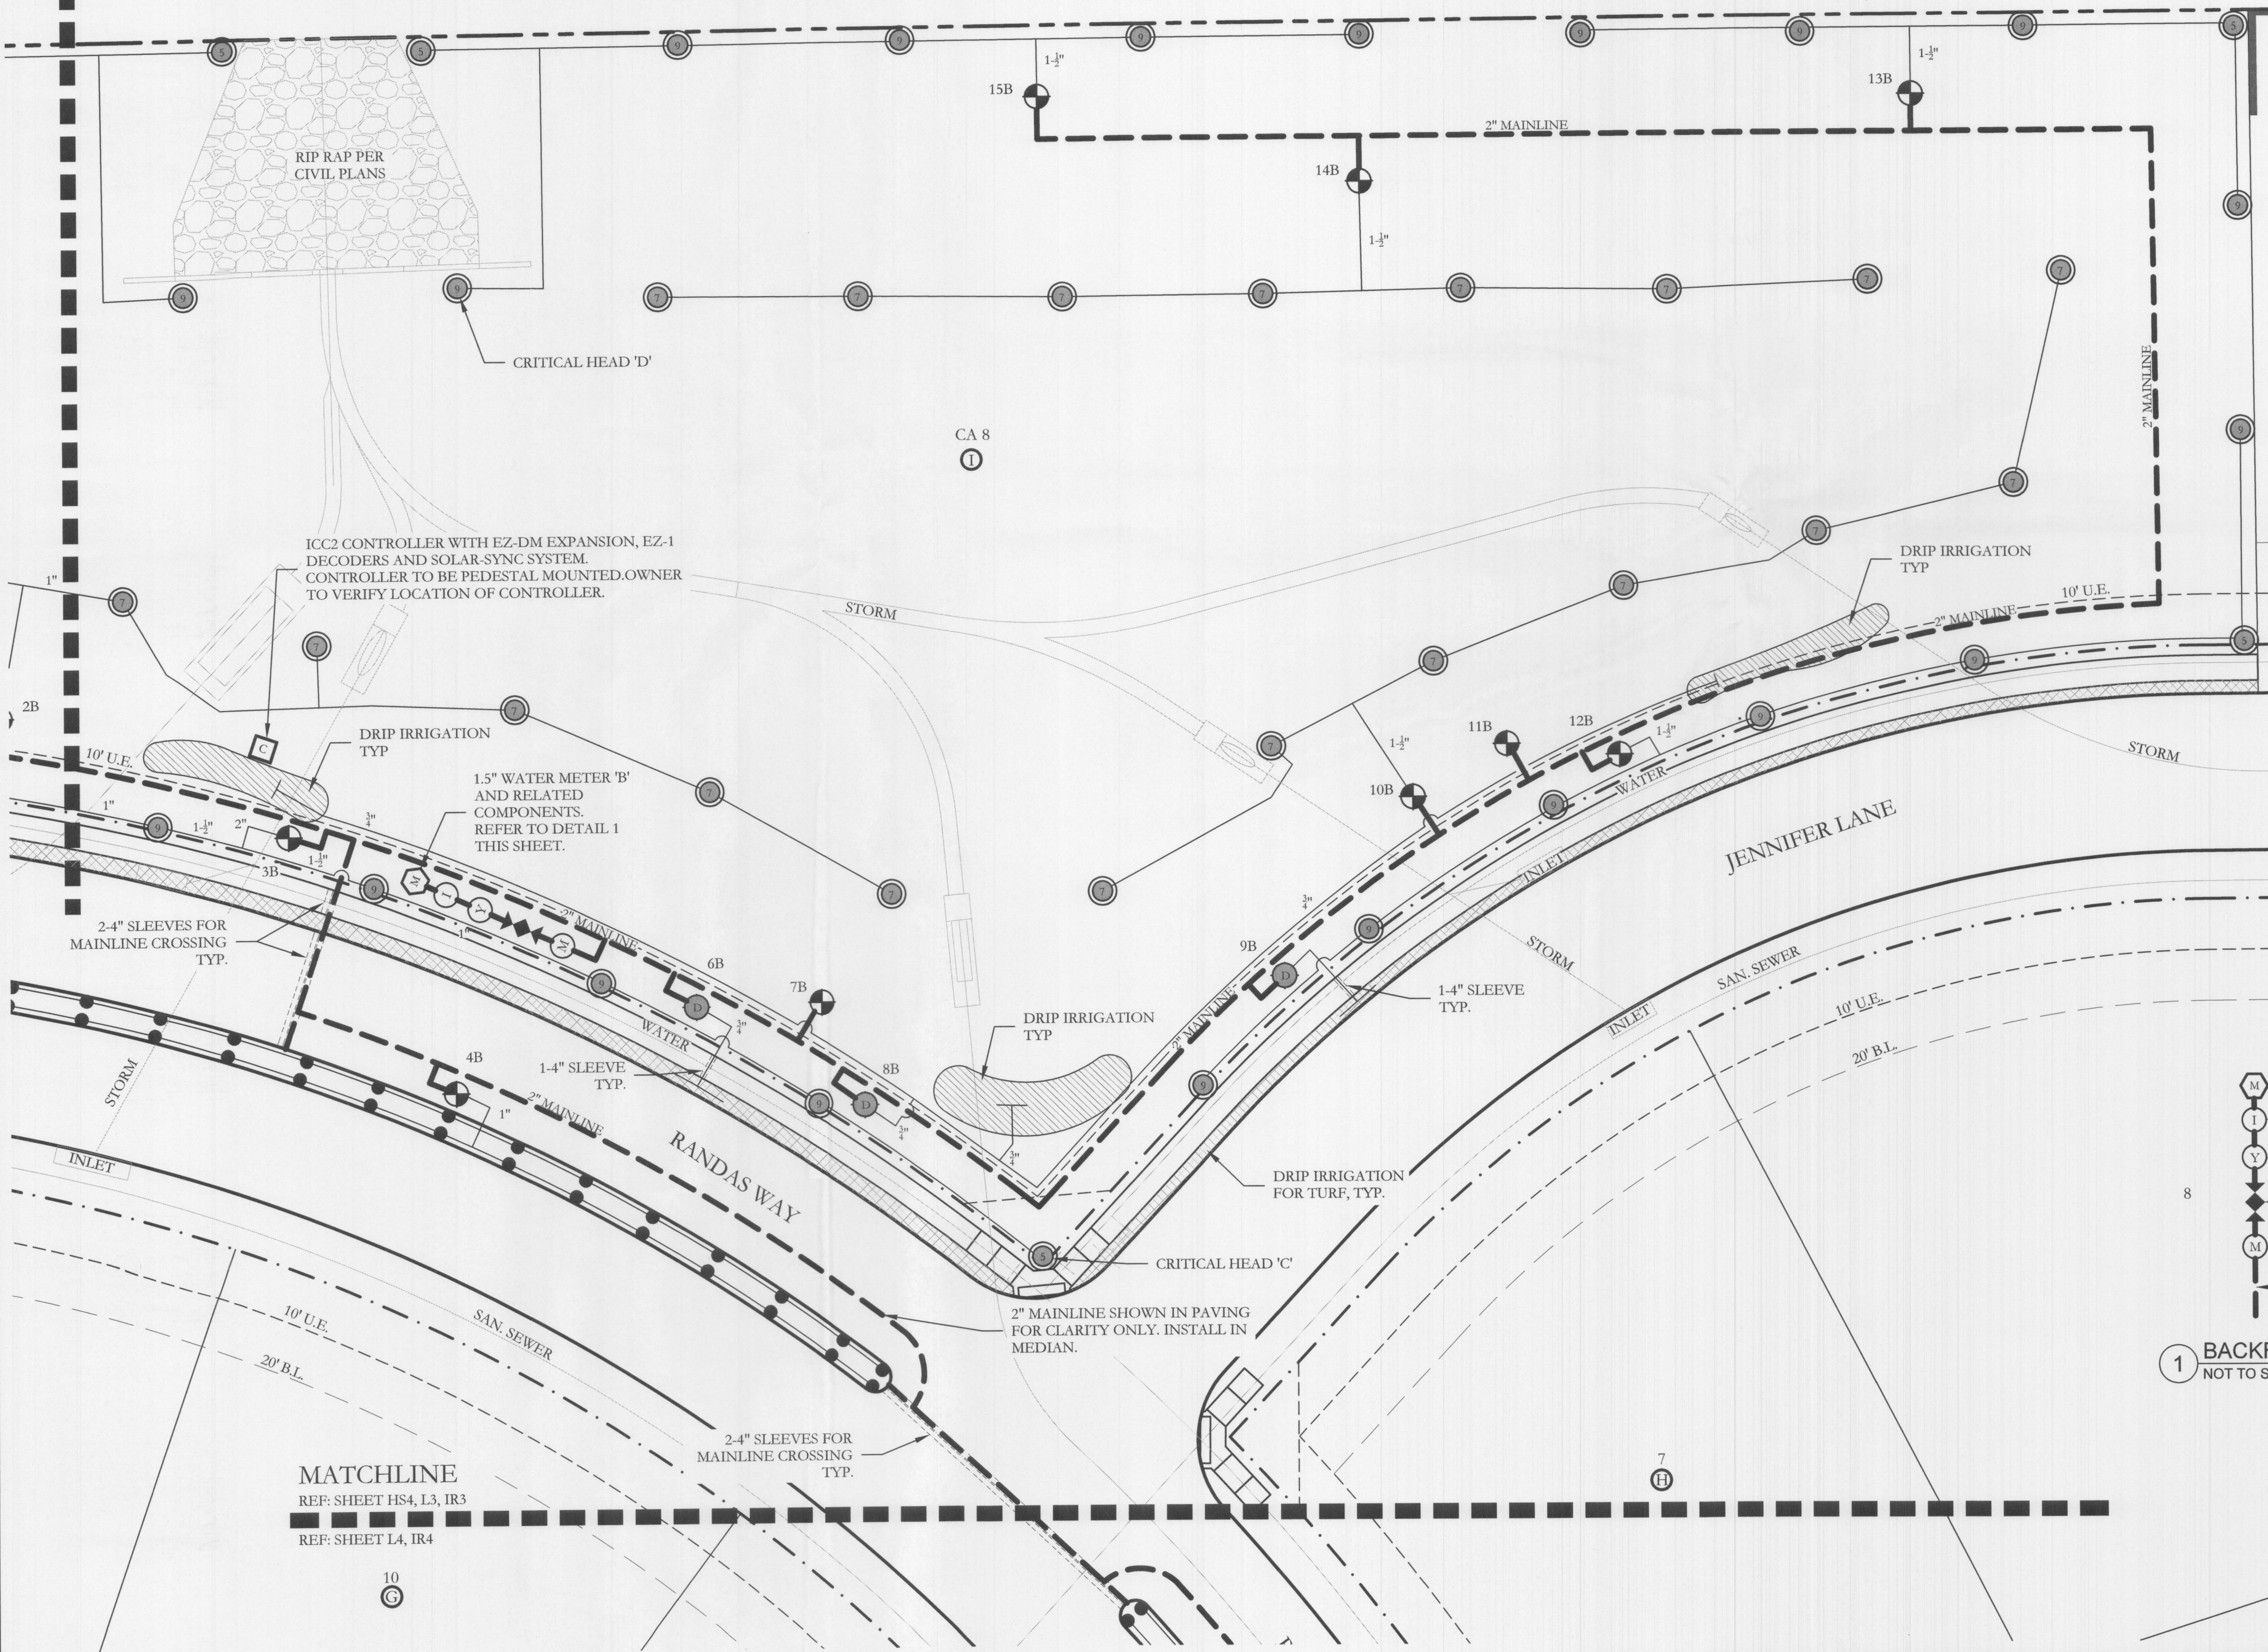


MATCHLINE  
REF: SHEET HS4, L2, IR2  
REF: SHEET HS4, L3, IR3



MATCHLINE  
REF: SHEET HS4, L3, IR3  
REF: SHEET L4, IR4

IRRIGATION LEGEND AND SCHEDULE

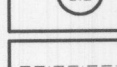SYM	DESCRIPTION	MANUFACTURER	MODEL	SIZE / NOZZLE
	AUTOMATIC CONTROLLER	HUNTER	REFER TO PLANS	N/A
	DRIP IRRIGATION CONTROL VALVE	HUNTER	ICZ-101	1"
	DRIP IRRIGATION (LANDSCAPE BEDS)	HUNTER	PLD-06-18	N/A
	DRIP IRRIGATION (TURF BEDS)	HUNTER	PLD-06-12	N/A
	DRIP IRRIGATION	HUNTER	AFB-ADJ BUBBLER (0.5 GPM EACH BUBBLER)	1/2"
	REMOTE CONTROL VALVE	HUNTER	ICV-101G ICV-151G	REFER TO PLAN FOR SIZE
	LAWN MP ROTATOR	HUNTER	MP ROTATOR	MP1000, MP2000, MP3000, MP3500
	ROTOR HEAD	HUNTER	PGP SERIES	#4 QUARTER/1/2 #5 QUARTER #7 HALF/FULL #9 HALF
	WATER METER	----	PER CITY	REFER TO PLAN FOR SIZE
	DOUBLE CHECK VALVE	FEBCO	850-BV Series	REFER TO PLAN FOR SIZE
	ISOLATION VALVE	NIBCO	*T-113	LINE SIZE
	WYE STRAINER	FEBCO	*850	REFER TO PLAN FOR SIZE
	MASTER VALVE	HUNTER	ICV-101G ICV-151G	REFER TO PLAN FOR SIZE
	IRRIGATION SLEEVE	----	SCH. 40 w/ 12 GA. PULL WIRE IN SLEEVE	REFER TO PLAN FOR SIZE
	IRRIGATION MAIN LINE	----	SCH. 40	REFER TO PLAN FOR SIZE
	IRRIGATION LATERAL LINE	----	CLASS 200	REFER TO PLAN FOR SIZE

- PROGRAM AND STATION NUMBER FOR AUTOMATIC CONTROLLER
- VALVE SIZE IN INCHES
- GALLONS PER MINUTE, PER VALVE

REFER TO SHEET IR5 FOR FULL IRRIGATION LEGEND AND SCHEDULE

NOTE:  
ALL LATERAL LINES SHALL BE 3/4" CLASS 200 PVC UNLESS OTHERWISE NOTED ON PLANS.

VALVE LEGEND 'B'

1B 1.5" V 30.00	2B 1.5" V 30.60	3B 1.5" V 40.40	4B 1" V 15.84	5B 1" V 18.48
6B DRIP 12.35	7B OPEN <20.00	8B DRIP 4.07	9B DRIP 7.65	10B 1.5" V 23.80
11B OPEN <20.00	12B 1.5" V 33.20	13B 1.5" V 22.80	14B 1.5" V 23.80	15B 1.5" V 28.00

ZONE VALVES LABELED AS 'OPEN' ARE INTENDED FOR THE USE OF SUPPLYING HUNTER AFB-ADJ TREE BUBBLERS ON EACH PROPOSED TREE. IRRIGATION CONTRACTOR SHALL FIELD VERIFY THAT THESE ZONES DO NOT EXCEED 20 GALLONS PER MINUTE. THE IRRIGATION CONTRACTOR SHALL STAKE EACH TREE BUBBLER HEAD LOCATION AND RECEIVE APPROVAL FROM THE OWNER AND/OR THE OWNER'S REPRESENTATIVE PRIOR TO INSTALLATION.



1 BACKFLOW AND RELATED COMPONENTS  
NOT TO SCALE

APPROVED:  
I hereby certify that the above and foregoing site plan for a development in the City of Rockwall, Texas, was approved by the Planning & Zoning Commission of the City of Rockwall on the 16 day of February, 2022.

WITNESS OUR HANDS, this 16 day of February, 2022.  
  
Planning & Zoning Commission, Chairman  
  
Director of Planning and Zoning

JOHNSON VOLK  
CONSULTING

830 CENTRAL PARKWAY EAST, SUITE 300 PLANO, TEXAS 75074  
PH. (972) 201-3100  
EMAIL: CODY.JOHNSON@JOHNSONVOLK.COM

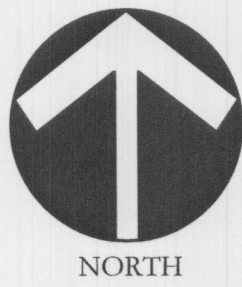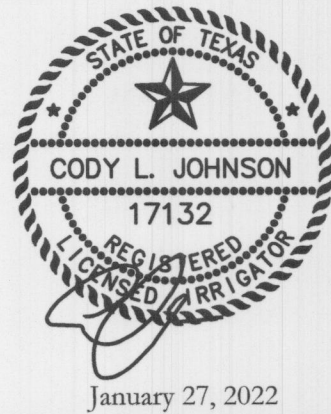

20 10 0 20  
Scale: 1" = 20'-0"

Bar is one inch on original drawing. If not one inch on this sheet, adjust scale as necessary.  
One Inch

SCREENING AND BUFFERING

Irrigation Plan

Saddle Star South - Phase 3

City of Rockwall, Rockwall County, Texas

CJS PROJECT NO.  
PAD001B  
SHEET NO.  
IR3 of 6



MATCHLINE  
REF: SHEET HS4, L3, IR3  
REF: SHEET L4, IR4

10  
C

2.4" SLEEVES FOR  
MAINLINE CROSSING  
TYP.

SSMH

RANDAS WAY  
CAMPUS

INLET

RETAINING WALL  
PER CIVIL PLANS.

2" MAINLINE SHOWN IN PAVING  
FOR CLARITY ONLY. INSTALL IN  
MEDIAN.

RETAINING WALL  
PER CIVIL PLANS.

12

RETAINING WALL  
PER CIVIL PLANS.

13

SSMH

RETAINING WALL  
PER CIVIL PLANS.

4

## IRRIGATION LEGEND AND SCHEDULE

SYM	DESCRIPTION	MANUFACTURER	MODEL	SIZE / NOZZLE
C	AUTOMATIC CONTROLLER	HUNTER	REFER TO PLANS	N/A
D	DRIP IRRIGATION CONTROL VALVE	HUNTER	ICZ-101	1"
	DRIP IRRIGATION (LANDSCAPE BEDS)	HUNTER	PLD-06-18	N/A
	DRIP IRRIGATION (TURF BEDS)	HUNTER	PLD-06-12	N/A
	DRIP IRRIGATION	HUNTER	AFB-ADJ BUBBLER (0.5 GPM EACH BUBBLER)	1/2"
	REMOTE CONTROL VALVE	HUNTER	ICV-101G ICV-151G	REFER TO PLAN FOR SIZE
P I L R	LAWN MP ROTATOR	HUNTER	MP ROTATOR	MP1000, MP2000, MP3000, MP3500
	4" POP UP MP ROTATOR CORNER STRIP	HUNTER	STRIP SERIES	MP/CS15 IVORY MP/CS15 COPPER MP/SS50 BROWN
	4" POP UP MP ROTATOR CORNER	HUNTER	CORNER SERIES	MP CORNER SERIES ADJUSTABLE ARC 8'-15'
	ROTOR HEAD	HUNTER	PGP SERIES	#4 QUARTER/HALF #5 QUARTER #7 HALF/FULL #9 HALF
M	WATER METER	---	PER CITY	REFER TO PLAN FOR SIZE
	DOUBLE CHECK VALVE	FERCO	850-BV Series	REFER TO PLAN FOR SIZE
I	ISOLATION VALVE	NIBCO	*T-113	LINE SIZE
Y	WYE STRAINER	FERCO	*850	REFER TO PLAN FOR SIZE
M	MASTER VALVE	HUNTER	ICV-101G ICV-151G	REFER TO PLAN FOR SIZE
----	IRRIGATION SLEEVE	----	SCH. 40 w/ 12 GA. PULL WIRE IN SLEEVE	REFER TO PLAN FOR SIZE
---	IRRIGATION MAIN LINE	----	SCH. 40	REFER TO PLAN FOR SIZE
---	IRRIGATION LATERAL LINE	----	CLASS 200	REFER TO PLAN FOR SIZE

←	PROGRAM AND STATION NUMBER FOR AUTOMATIC CONTROLLER
←	VALVE SIZE IN INCHES
←	GALLONS PER MINUTE, PER VALVE

## REFER TO SHEET IR5 FOR FULL IRRIGATION LEGEND AND SCHEDULE

NOTE:  
ALL LATERAL LINES SHALL BE 3/4" CLASS 200 PVC UNLESS OTHERWISE NOTED ON PLANS.

## VALVE LEGEND 'B'

1B 1.5" V 30.00	2B 1.5" V 30.00	3B 1.5" V 40.40	4B 1" V 15.84	5B 1" V 18.48
6B DRIP 12.35	7B OPEN <20.00	8B DRIP 4.07	9B DRIP 7.65	10B 1.5" V 23.80
11B OPEN <20.00	12B 1.5" V 33.20	13B 1.5" V 22.80	14B 1.5" V 23.80	15B 1.5" V 28.00

ZONE VALVES LABELED AS 'OPEN' ARE INTENDED FOR THE USE OF SUPPLYING HUNTER AFB-ADJ TREE BUBBLERS ON EACH PROPOSED TREE. IRRIGATION CONTRACTOR SHALL FIELD VERIFY THAT THESE ZONES DO NOT EXCEED 20 GALLONS PER MINUTE. THE IRRIGATION CONTRACTOR SHALL STAKE EACH TREE BUBBLER HEAD LOCATION AND RECEIVE APPROVAL FROM THE OWNER AND/OR THE OWNER'S REPRESENTATIVE PRIOR TO INSTALLATION.

### APPROVED:

I hereby certify that the above and foregoing site plan for a development in the City of Rockwall, Texas, was approved by the Planning & Zoning Commission of the City of Rockwall on the 16 day of February, 2022.

WITNESS OUR HANDS, this 16 day of February, 2022.

*[Signature]*  
Planning & Zoning Commission, Chairman


*[Signature]*  
Director of Planning and Zoning

**JOHNSON VOLK  
CONSULTING**

830 CENTRAL PARKWAY EAST, SUITE 300 PLANO, TEXAS 75074  
PH: (972) 204-3100  
EMAIL: CODY.JOHNSON@JOHNSONVOLK.COM



January 27, 2022

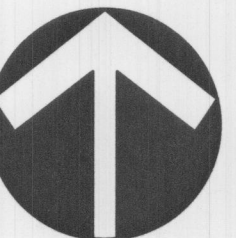

20 10 0 20  
Scale: 1" = 20'-0"

Bar is one inch on original drawing. If not one inch on this sheet, adjust scale as necessary.

One Inch

SCREENING AND BUFFERING

Irrigation Plan

Saddle Star South - Phase 3

City of Rockwall, Rockwall County, Texas



CJS PROJECT NO.









PAD001B




SHEET NO.

IR4 of 6



IRRIGATION LEGEND AND SCHEDULE

SYM	DESCRIPTION	MANUFACTURER	MODEL	SIZE / NOZZLE	NOTES
	AUTOMATIC CONTROLLER	HUNTER	REFER TO PLANS	N/A	INSTALL PER MANUFACTURER'S STANDARDS. IN ADDITION, INSTALL SOLAR-SYNC SYSTEM BY HUNTER.
	DRIP IRRIGATION CONTROL VALVE	HUNTER	ICZ-101	1"	INSTALL PER DETAIL IN 10" ROUND BOX w/ BOLT DOWN LID. ROUT AND PAINT VALVE NUMBER ON LID.
	DRIP IRRIGATION (LANDSCAPE BEDS)	HUNTER	PLD-06-18	N/A	INSTALL PER DETAIL w/ 40 PSI AT OUTFLOW OF DRIP ZONE VALVE.
	DRIP IRRIGATION (TURF BEDS)	HUNTER	PLD-06-12	N/A	INSTALL PER DETAIL w/ 40 PSI AT OUTFLOW OF DRIP ZONE VALVE.
	DRIP IRRIGATION	HUNTER	AFB-ADJ BUBBLER (0.5 GPM EACH BUBBLER)	1/2"	INSTALL PER DETAIL w/ 40 PSI AT BASE OF HEAD. INSTALL 1.0 GPM/LARGE SHADE TREE AND 0.5 GPM/ORN. TREES INSTALL ON ALL PROPOSED TREES, SEE LANDSCAPE PLANS.
	REMOTE CONTROL VALVE	HUNTER	ICV-101G ICV-151G	Refer to Plan for Size	INSTALL PER DETAIL IN 10" ROUND PENTEK VALVE BOX WITH BOLT DOWN LID. ROUT AND PAINT VALVE NUMBER ON LID.
	LAWN MP ROTATOR	HUNTER	MP ROTATOR	MP1000, MP2000, MP3000, MP3500	INSTALL PER DETAIL w/ 40 PSI AT BASE OF HEAD. INSTALL ON IPS FLEX PIPE ALL SPRAY BODIES. INSTALL NOZZLES ON 4" PRS40 SPRAY BODIES.
					

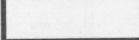- PROGRAM AND STATION NUMBER FOR AUTOMATIC CONTROLLER
- VALVE SIZE IN INCHES
- GALLONS PER MINUTE, PER VALVE

HYDRAULIC CALCULATION METER 'A'  
(LARGEST ZONE)

ITEM	SIZE	PSI	NOTES
SERVICE	1.5"	1.09	TYPE "K" COPPER 20 LN. FT. (36.20 GPM)
WATER METER	1.5"	2.70	(36.20 GPM)
BALL VALVE	1.5"	1.00	(36.20 GPM)
WYE FILTER	1.5"	0.30	(36.20 GPM)
BACKFLOW PREVENTER	1.5"	4.00	(36.20 GPM)
MASTER VALVE	1.5"	1.50	(36.20 GPM)
MAIN LINE	2"	4.35	440 LINEAR FEET (36.20 GPM)
ZONE VALVE (2A)	1.5"	1.50	(36.20 GPM)
LATERAL PIPING	N/A	3.45	
CRITICAL HEAD 'B'	N/A	40.00	
TOTAL LOSS		59.89	
ASSUMED STATIC PRESSURE		70.00	
PRESSURE DIFFERENTIAL		-10.11	

HYDRAULIC CALCULATION METER 'A'  
(FARTHEST ZONE)

ITEM	SIZE	PSI	NOTES
SERVICE	1.5"	0.05	TYPE "K" COPPER 20 LN. FT. (7.40 GPM)
WATER METER	1.5"	0.40	(7.40 GPM)
BALL VALVE	1.5"	1.00	(7.40 GPM)
WYE FILTER	1.5"	0.30	(7.40 GPM)
BACKFLOW PREVENTER	1.5"	4.00	(7.40 GPM)
MASTER VALVE	1.5"	1.50	(7.40 GPM)
MAIN LINE	2"	0.28	477 LINEAR FEET (7.40 GPM)
ZONE VALVE (1A)	1"	3.00	(7.40 GPM)
LATERAL PIPING	N/A	2.15	
CRITICAL HEAD 'A'	N/A	40.00	
TOTAL LOSS		52.68	
ASSUMED STATIC PRESSURE		70.00	
PRESSURE DIFFERENTIAL		-17.32	


TWO-WIRE IRRIGATION NOTES

- PROVIDE A COMPLETE, FUNCTIONING AUTOMATIC IRRIGATION SYSTEM INCLUDING LABOR, MATERIALS, FEES, TAXES, EQUIPMENT, AND OTHER COSTS INCIDENTAL TO ACCOMPLISHING WORK.
- ACQUIRE WRITTEN APPROVAL FROM THE LANDSCAPE ARCHITECT OR LICENSED IRRIGATOR FOR MATERIAL SUBSTITUTES PRIOR TO BEGINNING INSTALLATION.
- FORTY EIGHT (48) HOURS BEFORE IRRIGATION CONSTRUCTION BEGINS, IRRIGATION CONTRACTOR MUST CALL (800) DIG-TESS AND IS RESPONSIBLE FOR LOCATING EXISTING UNDERGROUND UTILITIES AND/OR OBSTACLES PRIOR TO BEGINNING WORK. ANY DAMAGE TO UTILITIES AND/OR FINISHES FROM INFERIOR WORKMANSHIP BY THE IRRIGATION CONTRACTOR SHALL BE REPAIRED AT NO ADDITIONAL COST TO THE OWNER.
- PIPING IS DIAGRAMMATIC AND SHOWN FOR CLARITY ONLY. ADJUST AS REQUIRED FOR EXISTING UTILITIES, OBSTRUCTIONS, TREE ROOT BALLS, ETC. PIPING AND VALVES SHOWN IN PAVING FOR CLARITY ONLY AND SHALL BE INSTALLED IN ADJACENT LANDSCAPE AREA. COORDINATE WITH THE CITY OR ENTITY INSPECTING THE IRRIGATION SYSTEM AND DETERMINE THE LOCAL RULES AND CODES TO ABIDE BY REGARDING MAINLINE AND LATERAL PIPING LOCATIONS.
- COORDINATE SLEEVE AND CONDUIT REQUIREMENTS WITH GENERAL CONTRACTOR. IRRIGATION SLEEVES SHALL BE AS FOLLOWS:
  - SLEEVES INTENDED FOR LATERAL LINES ARE TO BE ONE-FOUR INCH SLEEVE AND ARE TO BE NO MORE THAN A DEPTH OF TWO FEET BELOW TOP OF CURB. SLEEVES SHOULD EXTEND A MINIMUM OF 2'-0" BEYOND BACK OF CURB.
  - SLEEVES INTENDED FOR THE 2" MAINLINE ARE TO BE TWO-FOUR INCH SLEEVES SIDE BY SIDE AND ARE TO BE NO MORE THAN A DEPTH OF TWO FEET BELOW TOP OF CURB. SLEEVES SHOULD EXTEND A MINIMUM OF 2'-0" BEYOND BACK OF CURB.
- LOCATE EACH END OF IRRIGATION SLEEVES DIMENSIONALLY ON THE RECORD "AS BUILT" DRAWINGS.
- THE IRRIGATION CONTRACTOR SHALL COORDINATE THE INSTALLATION OF THE IRRIGATION SYSTEM WITH THE LANDSCAPE CONTRACTOR TO ENSURE ALL PLANT MATERIAL WILL BE WATERED IN ACCORDANCE WITH THE INTENT OF THE PLANS AND SPECIFICATIONS.
- THE IRRIGATION CONTRACTOR SHALL BE RESPONSIBLE FOR DAMAGE TO PLANT MATERIAL DUE TO SYSTEM FAILURE FROM INFERIOR WORKMANSHIP FOR THE DURATION OF THE INSTALLATION OF PLANT MATERIAL AND MAINTENANCE PERIOD FOLLOWING INSTALLATION.
- THE IRRIGATION CONTRACTOR SHALL PROVIDE ALL LABOR AND MATERIAL NECESSARY TO HAND DIG WITHIN ALL EXISTING TREE DRIPLINE ZONES AT NO ADDITIONAL COST TO THE OWNER. THE IRRIGATION CONTRACTOR SHALL BE RESPONSIBLE TO STAKE AND RECEIVE APPROVAL FROM ALL DISCIPLINES PRIOR TO AN TRENCHING AND HAND DIGGING IN AREAS OF EXISTING TREE COVERAGE OR ANY ADDITIONAL AREAS THAT MIGHT BE QUESTIONABLE.
- EXTEND EXTRA WIRE AND MAINLINE PAST THE FARTHEST VALVE, ROUTED PARALLEL AND PLACE IN 12"x17" PENTEK VALVE BOX WERE NOTED ON PLANS FOR FUTURE EXPANSION OF IRRIGATION SYSTEM AT A LATER DATE.
- TWO WIRE PATH SHALL BE DIRECT BURIAL, 14 AWG OR STANDARD DECODER CABLE BY HUNTER WITH YELLOW JACKET (DI1YLW), RATED FOR DIRECT BURIAL APPLICATIONS, UF, UL, APPROVED. HUNTER ICD DECODERS SHALL BE USED ON ALL ZONE VALVE CONNECTIONS TO TWO WIRE PATH. CONTRACTOR TO USE MANUFACTURERS RECOMMENDATIONS OF WIRE SPLICING AND BURIAL TECHNIQUES AS DETAILED AT WWW.HUNTERINDUSTRIES.COM.
- THE OWNER AND/OR LANDSCAPE ARCHITECT SHALL DETERMINE THE FINAL CONTROLLER LOCATION. THE IRRIGATION CONTRACTOR SHALL MAKE FINAL ELECTRICAL CONNECTION OF CONTROLLER PER LOCAL ELECTRICAL CODE. PROVIDE ALL NECESSARY FUSE BOXES, CONDUIT, FITTINGS, CONNECTORS OR OTHER ELECTRICAL DEVICES TO MAKE CONNECTION. OWNER SHALL PROVIDE ELECTRICAL SERVICE WITHIN 10 LINEAR FEET OF CONTROLLER LOCATION UNLESS NOTED OTHERWISE ON DRAWINGS.
- CONNECT REMOTE SENSORS TO CONTROLLER WITH GROUND WIRE IN SERIES PRIOR TO CONNECTING TO REMOTE CONTROL VALVES.
- ALL P.V.C. MAINLINES AND LATERAL LINES SHALL RECEIVE AS FOLLOWS:
  - 18" MINIMUM COVER FOR MAIN LINES
  - 18" MINIMUM COVER FOR PIPING LOCATED UNDER PAVING
  - 12" MINIMUM COVER FOR LATERAL LINES
- THE MINIMUM DISTANCE BETWEEN THE MAINLINE AND LATERAL LINE FITTINGS (EXCEPT FOR REDUCER BUSHINGS) SHALL BE 18".
- THE MINIMUM HORIZONTAL DISTANCE OF 36" SHALL BE MAINTAINED BETWEEN ANY VALVES THAT ARE INSTALLED SIDE BY SIDE.
- WHERE SERVICE TREES ARE INSTALLED ON THE MAINLINE FOR INSTALLATION OF THE ELECTRIC VALVES AND/OR QUICK COUPLING VALVES, THE CONTRACTOR SHALL LIMIT THE NUMBER OF THESE PER SERVICE TEE. DO NOT INSTALL MORE THAN A TOTAL OF EITHER THREE ELECTRIC VALVES OR A COMBINATION OF TWO ELECTRIC VALVES AND ONE QUICK COUPLER VALVE AT EACH TEE. THE MINIMUM DISTANCE BETWEEN FITTINGS SHALL BE 18" AS REFERENCED IN THE ABOVE NOTES.
- ALL PVC PIPE AND FITTINGS ARE TO BE PRIMED WITH PURPLE PVC PRIMER SOLVENT BEFORE APPLYING PVC CEMENT IN ACCORDANCE WITH THE UNIFORM PLUMBING CODE.
- INSTALL QUICK COUPLING VALVES IN 12"x17" PENTEK VALVE BOXES PER DETAIL SHOWN. CONNECT QUICK COUPLING VALVES TO MAINLINE PIPE WITH LASCO UNITTIZED, O-RING SWING JOINTS PER DETAIL SHOWN, #1722-22. SUPPLY OWNER WITH THREE COUPLER KEYS WITH SWIVEL HOSE BIBB EACH, #33DK-10 AND #SH-0 RESPECTIVELY. VALVES TO BE INSTALLED SO THAT THE TOP OF THE QUICK COUPLER IS 2" BELOW BOTTOM OF VALVE BOX LID. PURPLE LID SHALL READ "NON-POTABLE, NOT SAFE FOR DRINKING" IN ENGLISH AND SPANISH.
- ALL LATERAL LINES SHALL BE 3/4" CLASS 200 PVC UNLESS OTHERWISE NOTED ON PLANS.
- ZONE VALVES LABELED AS "OPEN" ARE INTENDED FOR THE USE OF SUPPLYING HUNTER AFB-ADJ TREE BUBBLERS ON EACH PROPOSED TREE. IRRIGATION CONTRACTOR SHALL FIELD VERIFY THAT THESE ZONES DO NOT EXCEED 20 GALLONS PER MINUTE. THE IRRIGATION CONTRACTOR SHALL STAKE EACH TREE BUBBLER HEAD LOCATION AND RECEIVE APPROVAL FROM THE OWNER AND/OR THE OWNER'S REPRESENTATIVE PRIOR TO INSTALLATION.
- ALL STATE OF TEXAS LAWS/RULES AND ALL LOCAL CODES/ORDINANCES AREA MADE PART OF THESE PLANS AND SPECIFICATIONS WHETHER SHOWN OR NOT. THESE LAWS AND ORDINANCES WILL SUPERCEDE THE PLANS, DETAILS, AND/OR SPECIFICATIONS FOR THIS PROJECT. THE IRRIGATION CONTRACTOR IS CAUTIONED THAT HE/SHE IS TO INCLUDE ANY AND ALL COST NECESSARY TO MEET OR EXCEED THE LAWS OF THE STATE OF TEXAS AND LOCAL CODES CONCERNING LANDSCAPE IRRIGATION.
- INCLUDE THE FOLLOWING ALLOWANCES FOR PROVIDING AND INSTALLING AIR RELIEF VALVES AND FLUSH VALVES FOR THE DRIP SYSTEM. EXACT QUANTITY AND LOCATION OF THESE DEVICES WILL BE DETERMINED AT THE TIME OF INSTALLATION. IN GENERAL, ALL AIR RELIEF VALVES WILL BE INSTALLED AT THE HIGH POINTS AND FLUSH VALVES WILL BE INSTALLED AT THE LOW POINTS OF EXHAUST HEADER. ALLOW FOR APPROXIMATELY (1) AIR RELIEF AND APPROXIMATELY ONE (1) FLUSH VALVE FOR EACH DRIP ZONE KIT.
- INCLUDE THE FOLLOWING ALLOWANCE FOR PROVIDING AND INSTALLING DRIP INDICATOR FOR THE DRIP SYSTEM. LOCATION OF DRIP INDICATOR SHOULD BE CENTERED IN DRIP ZONE.

HYDRAULIC CALCULATION METER 'B' (LARGEST ZONE)			
ITEM	SIZE	PSI	NOTES
SERVICE	1.5"	1.32	TYPE "K" COPPER 20 LN. FT. (40.40 GPM)
WATER METER	1.5"	3.30	(40.40 GPM)
BALL VALVE	1.5"	1.00	(40.40 GPM)
WYE FILTER	1.5"	0.30	(40.40 GPM)
BACKFLOW PREVENTER	1.5"	4.00	(40.40 GPM)
MASTER VALVE	1.5"	1.70	(40.40 GPM)
MAIN LINE	2"	0.90	75 LINEAR FEET (40.40 GPM)
ZONE VALVE (3B)	1.5"	1.70	(40.40 GPM)
LATERAL PIPING	N/A	3.20	
CRITICAL HEAD 'C'	N/A	40.00	
TOTAL LOSS		57.42	
ASSUMED STATIC PRESSURE		70.00	
PRESSURE DIFFERENTIAL		-12.58	

HYDRAULIC CALCULATION METER 'B'  
(FARTHEST ZONE)

ITEM	SIZE	PSI	NOTES
SERVICE	1.5"	0.68	TYPE "K" COPPER 20 LN. FT. (28.00 GPM)
WATER METER	1.5"	1.60	(28.00 GPM)
BALL VALVE	1.5"	1.00	(28.00 GPM)
WYE FILTER	1.5"	0.30	(28.00 GPM)
BACKFLOW PREVENTER	1.5"	4.00	(28.00 GPM)
MASTER VALVE	1.5"	1.50	(28.00 GPM)
MAIN LINE	2"	4.20	680 LINEAR FEET (28.00 GPM)
ZONE VALVE (15B)	1.5"	1.50	(28.00 GPM)
LATERAL PIPING	N/A	2.80	
CRITICAL HEAD 'D'	N/A	40.00	
TOTAL LOSS		57.58	
ASSUMED STATIC PRESSURE		70.00	
PRESSURE DIFFERENTIAL		-12.42	

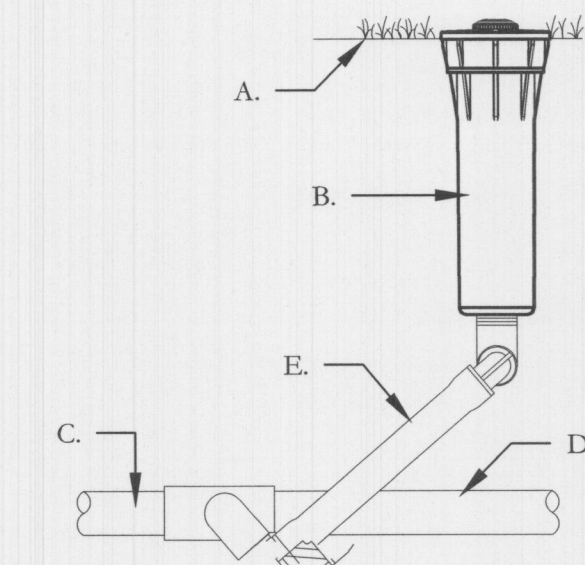

GENERAL NOTES:


- REST PIPE FIRMLY ON TRENCH BOTTOM.
- SNAKE PIPE FROM SIDE TO SIDE.
- DO NOT STACK PIPE IN TRENCH. PROVIDE HORIZONTAL SEPARATION.
- MAINTAIN 2" MINIMUM SEPARATION BETWEEN MAINLINE AND LATERAL LINE PIPING.
- BUNDLE WIRE(S) AT 20 FT. INTERVALS.


CONSTRUCTION NOTES:

- FINISHED GRADE
- ROTOR HEAD PER PLANS
- LATERAL TEE OR ELL
- LATERAL PIPE
- IPS FLEX PIPE


PRS40-CV - MP ROTATOR SPRAY HEAD  
NOT TO SCALE

WITNESS OUR HANDS, this 16 day of February, 2022.

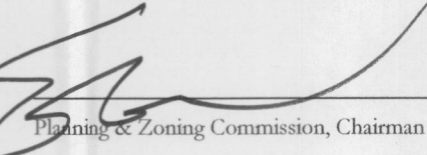  
Planning & Zoning Commission, Chairman

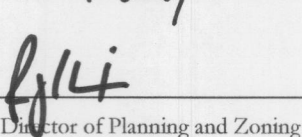  
Director of Planning and Zoning

JOHNSON VOLK  
CONSULTING

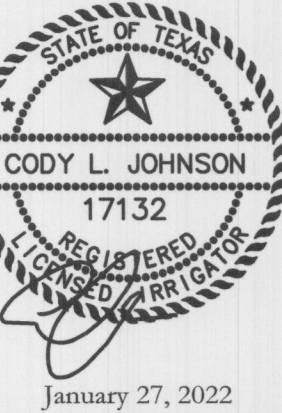

Bar is one inch on original drawing. If not one inch on this sheet, adjust scale as necessary.

One Inch

SCREENING AND BUFFERING

Irrigation Details

Saddle Star South - Phase 3

City of Rockwall, RockwallCountry, Texas


CJS PROJECT NO.

PAD001B

SHEET NO.


IR5 of 6



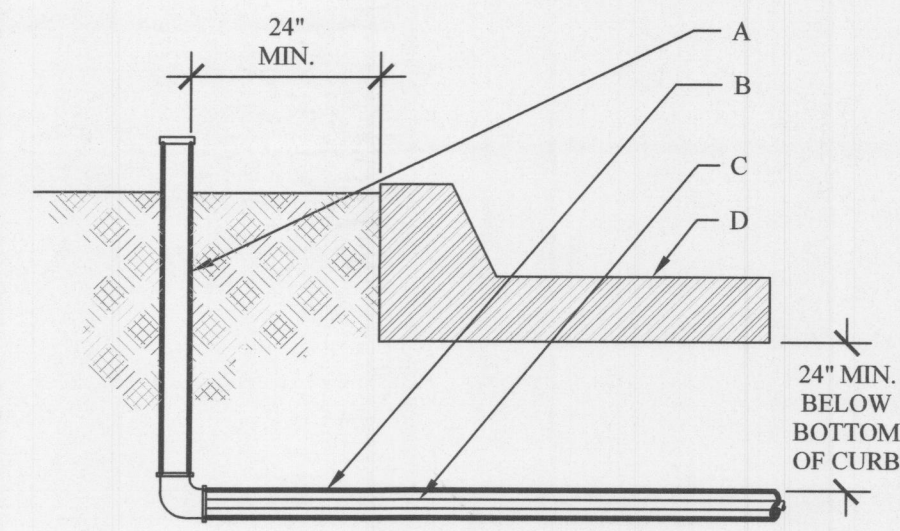


- GENERAL NOTES:**
1. NO DIRECT CONNECTION TO SLEEVE SHALL BE ALLOWED. SLEEVE SIZE SHALL BE TWO (2) SIZES LARGER THAN THE PIPE TO BE SLEEVED.
  2. MARK HARDSCAPE WITH SYMBOL "S" TO INDICATE THAT A SLEEVE IS BELOW.
  3. INSTALL WIRING IN SEPARATE SLEEVE FROM LATERAL AND MAINLINE PIPING.
- CONSTRUCTION NOTES:**
- A. TEMPORARY RISER AND CAP
  - B. SCH 40 PVC IRRIGATION SLEEVE - SEE PLAN.
  - C. PVC MAINLINE, LATERAL OR WIRING - SEE PLAN
  - D. PAVING

IRRIGATION SLEEVES  
NOT TO SCALE

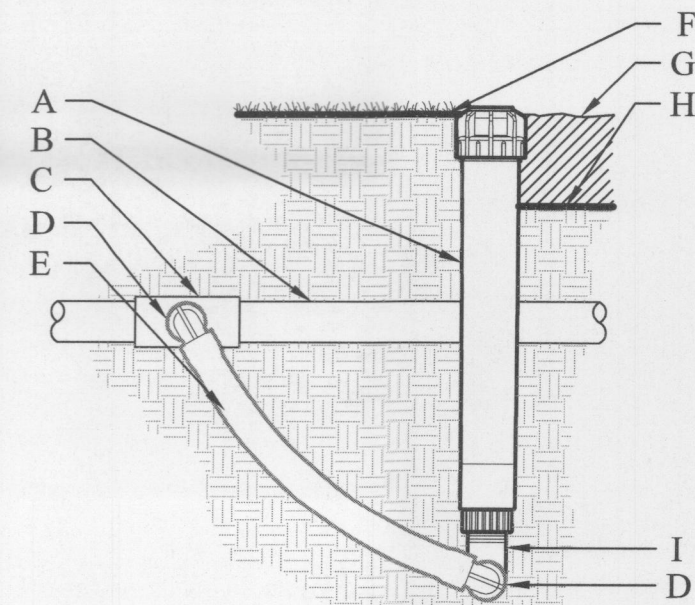

- CONSTRUCTION NOTES:**
- A. ECO INDICATOR - ECOID
  - B. LATERAL PIPE PER PLAN
  - C. FPT CONNECTION FROM LATERAL
  - D. SPIRAL BARB ELBOW - HSBE-XXX
  - E. FLEX<sub>+</sub> TUBING - FLEXSG
  - F. FINISHED GRADE IN TURF
  - G. ADJACENT MULCH
  - H. FINISHED GRADE IN PLANTER BED
  - I. MARLEX STREET ELBOW


ECO INDICATOR WITH FLEX TUBING  
NOT TO SCALE

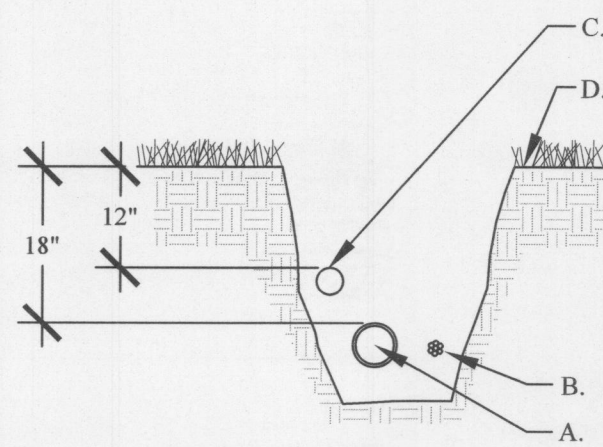

- GENERAL NOTES:**
1. REST PIPE FIRMLY ON TRENCH BOTTOM.
  2. SNAKE PIPE FROM SIDE TO SIDE.
  3. DO NOT STACK PIPE IN TRENCH. PROVIDE HORIZONTAL SEPARATION.
  4. MAINTAIN 2" MINIMUM SEPARATION BETWEEN MAINLINE AND LATERAL LINE PIPING.
  5. BUNDLE WIRE(S) AT 20 FT. INTERVALS.

- CONSTRUCTION NOTES:**
- A. MAINLINE PIPING - 18" MINIMUM COVER
  - B. WIRE BUNDLE - TAPE PER SPECIFICATIONS
  - C. LATERAL LINE PIPING - 12" MINIMUM COVER
  - D. FINISH GRADE


IRRIGATION TRENCH  
NOT TO SCALE

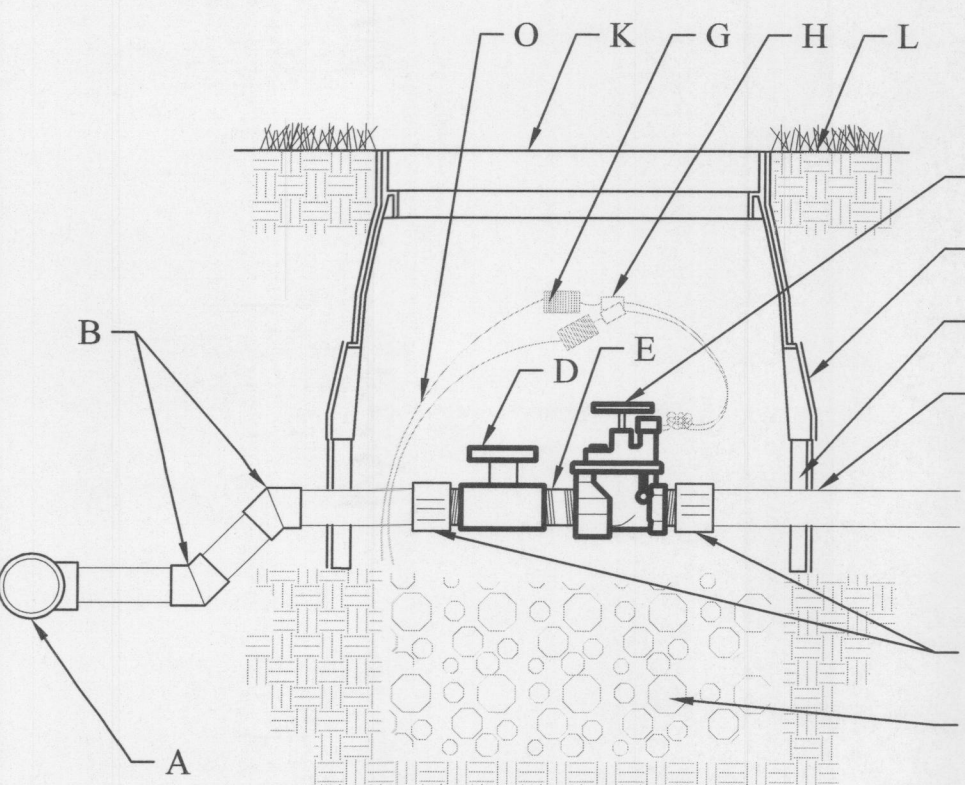


- GENERAL NOTES:**
1. INSTALL PEA GRAVEL FLUSH WITH BOTTOM OF PIPE AND VALVE.
  2. MAINLINE SHALL HAVE A MINIMUM OF 18" COVER AND LATERAL LINE SHALL HAVE A MINIMUM OF 12" COVER.
  3. PROVIDE A 24" WIRE EXPANSION COIL AT EACH DRY SPLICE WIRE CONNECTION.
  4. CENTER VALVE ASSEMBLY IN VALVE BOX.

- CONSTRUCTION NOTES:**
- A. PVC SERVICE TEE
  - B. SCH 40 45° BEND
  - C. SCH 40 MALE ADAPTER
  - D. SCH 40 BALL VALVE
  - E. GRAY SCH 80 SHORT NIPPLE (TBE)
  - F. AUTOMATIC VALVE
  - G. WIRE COIL
  - H. WATERPROOF WIRE CONNECTORS
  - I. LATERAL PIPE
  - J. 10 ML BLACK PLASTIC
  - K. ARMOR 12" STANDARD VALVE BOX WITH COVER AND PENTAGON LOCK. ROUT AND PAINT VALVE NUMBER ON TOP OF LID. SET 1/4" ABOVE FINISH GRADE.
  - L. FINISH GRADE
  - M. WASHED PEA GRAVEL - 6" DEPTH MIN
  - N. 6" VALVE BOX EXTENSIONS AS REQUIRED
  - O. VALVE WIRING

ELECTRIC VALVE  
NOT TO SCALE

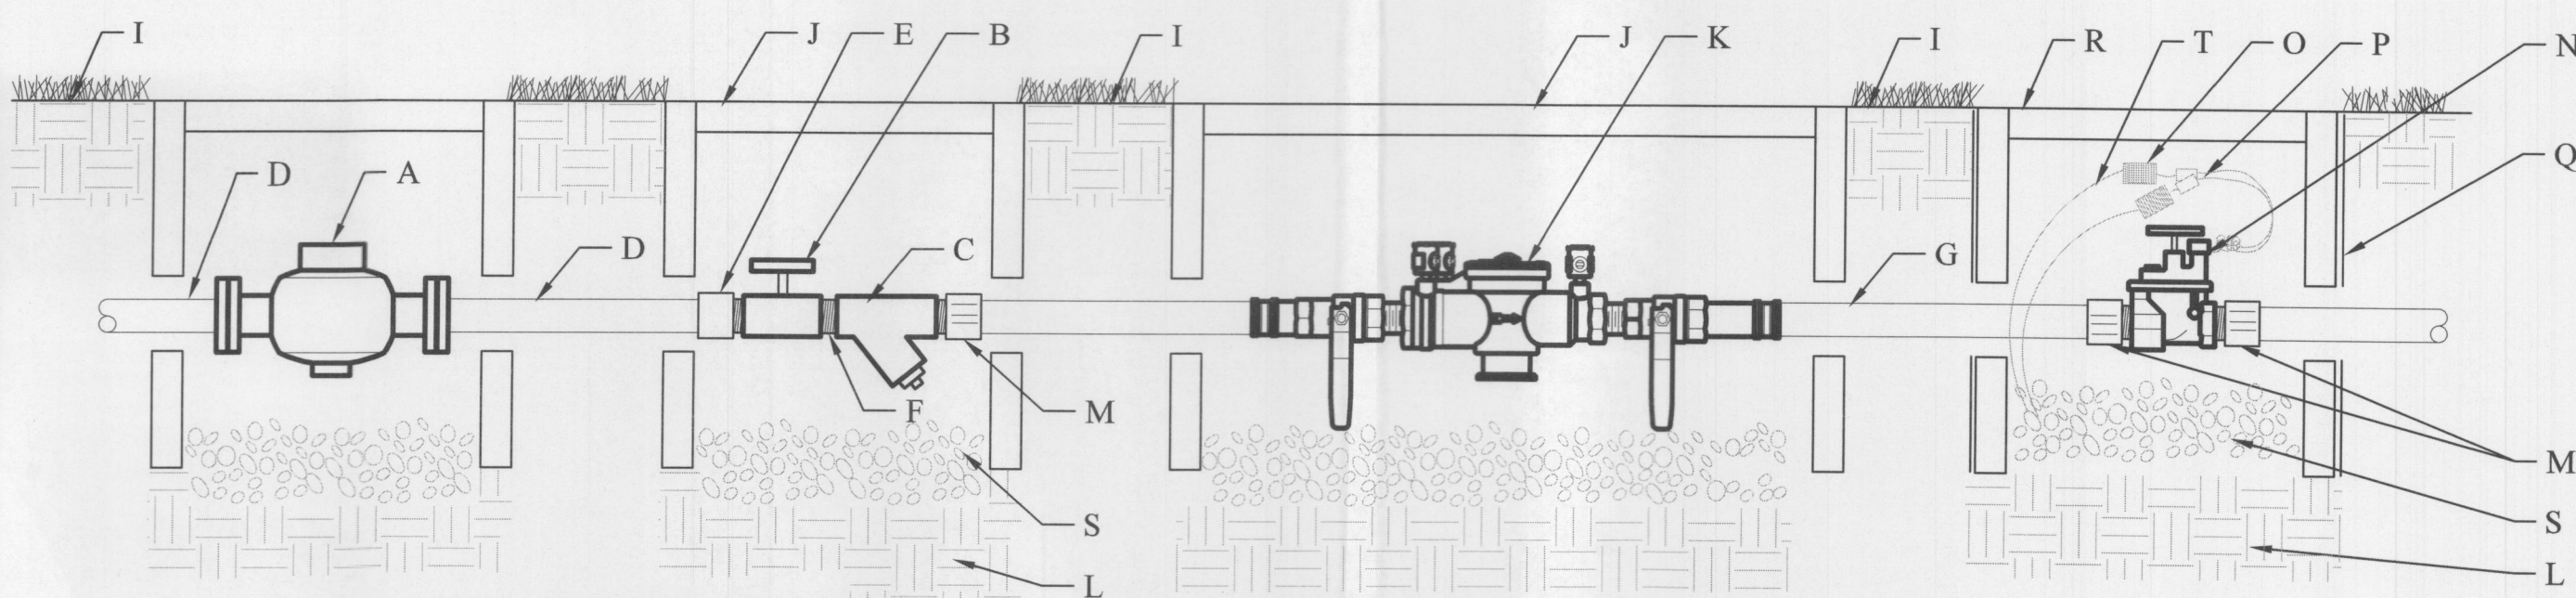


BACKFLOW PREVENTER CONNECTION  
NOT TO SCALE

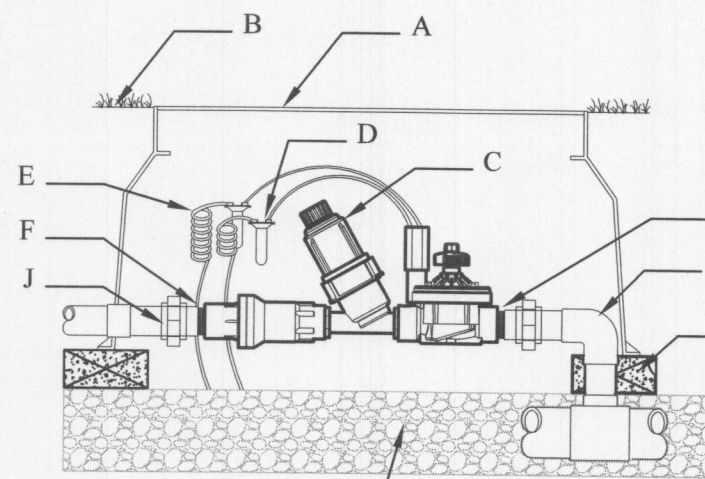

- CONSTRUCTION NOTES:**
- A. JUMBO VALVE BOX
  - B. FINISH GRADE
  - C. DRIP ZONE KIT, MODEL ICZ-101
  - D. WATERPROOF CONNECTORS (2)
  - E. 18-24" COILED WIRE
  - F. SCH. 80 T.O.W. NIPPLE
  - G. MAINLINE PIPING AND FITTINGS
  - H. BRICK SUPPORTS (4)
  - I. 3/4" MINUS WASHED GRAVEL
  - J. PVC SLIP UNIONS (2)


DRIP CONTROL ZONE  
NOT TO SCALE

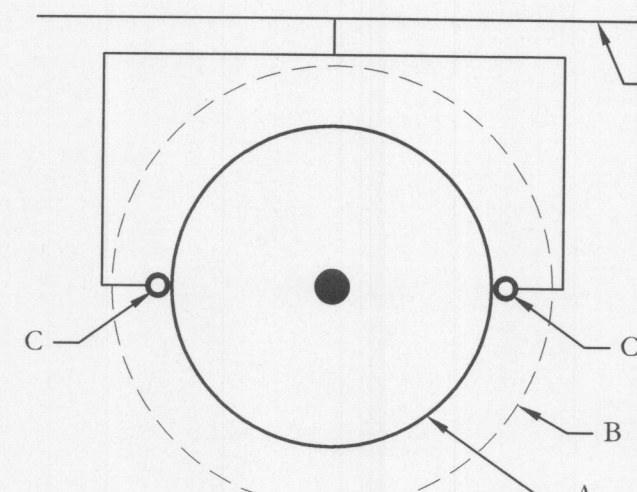

- GENERAL NOTES:**
1. TREE BUBBLERS TO BE ALIGNED PARALLEL WITH MEDIAN CURBS.
  2. NO TRENCHING ALLOWED WITHIN THE TREES ROOTBALL.
  3. TREE BUBBLERS TO BE ON UPHILL SIDE OF THE TREE IN THE RETENTION BASIN OR AS SHOWN.
  4. COORDINATE THE LOCATION OF THE BUBBLERS WITH THE PROPOSED TREE LOCATIONS AS SHOWN ON THE LANDSCAPE PLANTING PLANS.


- CONSTRUCTION NOTES:**
- A. TREE ROOTBALL
  - B. EDGE OF TREE PIT (RETENTION BASIN)
  - C. TREE BUBBLER, NOZZLE: AFB
  - D. LATERAL LINE (SIZED AS SPEC'D.)

TREE BUBBLER PLAN  
NOT TO SCALE

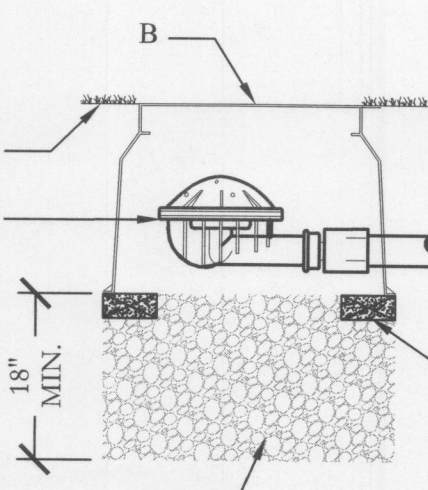


- CONSTRUCTION NOTES:**
- A. FINISH GRADE
  - B. 10" ROUND VALVE BOX
  - C. LINE FLUSHING VALVE
  - D. PLD-450 OR 1/2" FPT ADAPTER
  - E. BRICK SUPPORTS (3)
  - F. 3/4" GRAVEL SUMP

DRIP IRRIGATION - FLUSH VALVE  
NOT TO SCALE

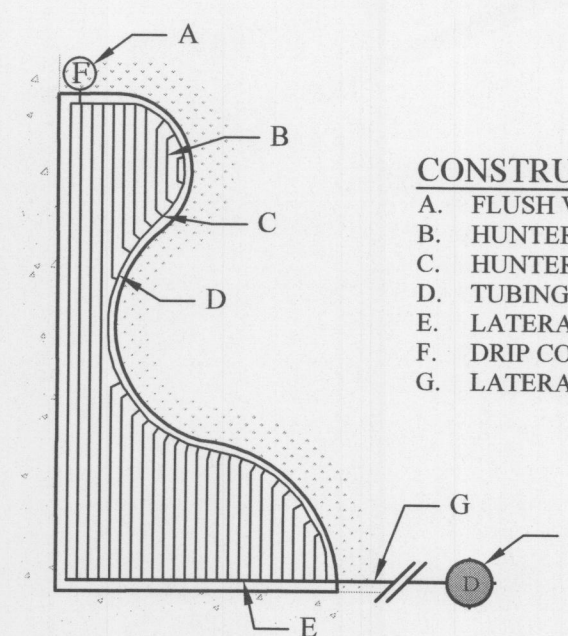


- CONSTRUCTION NOTES:**
- A. FLUSH VALVE
  - B. HUNTER PLD 06-18
  - C. HUNTER PLD TEE
  - D. TUBING STAKE
  - E. LATERAL TO PLD CONNECTION
  - F. DRIP CONTROL VALVE, MODEL ICZ-101
  - G. LATERAL PIPE TO PLANTING BED

DRIP IRRIGATION - BED  
NOT TO SCALE

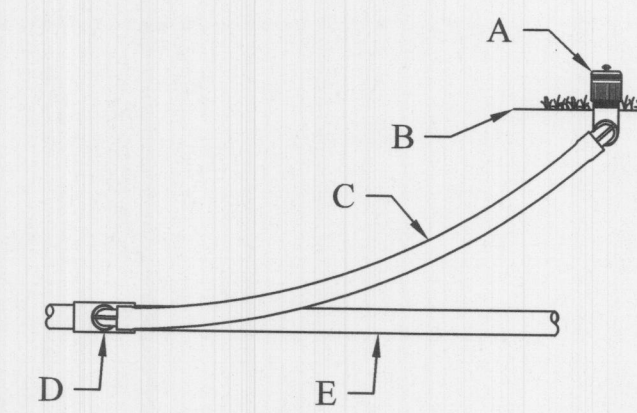


- CONSTRUCTION NOTES:**
- A. MODEL AFB BUBBLER
  - B. FINISH GRADE
  - C. SWING JOINT: HUNTER "PRO-FLEX" TUBING 24"-36", HSBE-050 ELBOWS (2), & MARLEX STREET ELBOW (1)
  - D. LATERAL TEE OR ELL
  - E. LATERAL PIPE

AFB BUBBLER  
NOT TO SCALE

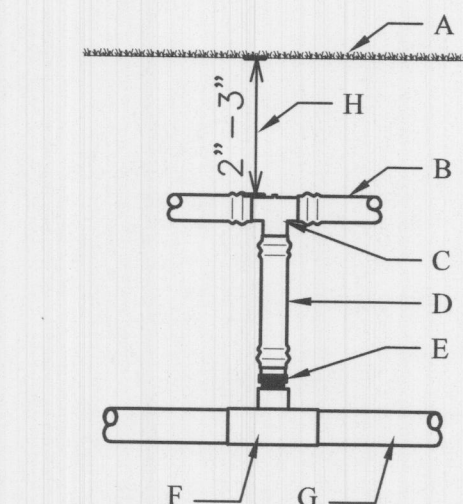

- CONSTRUCTION NOTES:**
- A. FINISH GRADE
  - B. HUNTER PLD 06-18
  - C. PLD-TEE 17MM BARBxBARB
  - D. PLD-BLNK
  - E. PLD-075 3/4" MPTxBARB
  - F. 3/4" MPT TEE
  - G. LATERAL PIPE
  - H. MINIMUM DRIPLINE DEPTH


BELOW GRADE START CONNECTION  
NOT TO SCALE

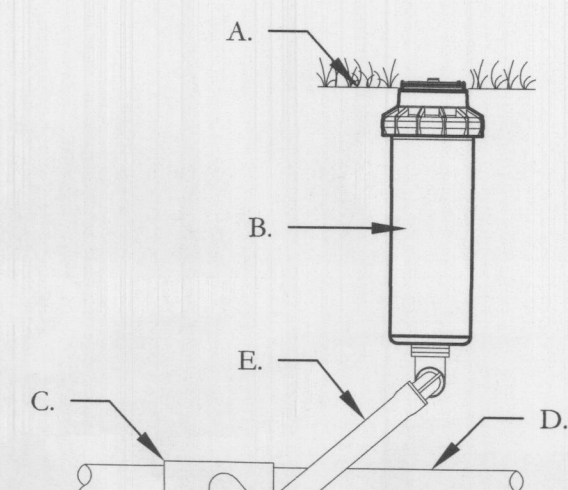

- GENERAL NOTES:**
1. REST PIPE FIRMLY ON TRENCH BOTTOM.
  2. SNAKE PIPE FROM SIDE TO SIDE.
  3. DO NOT STACK PIPE IN TRENCH. PROVIDE HORIZONTAL SEPARATION.
  4. MAINTAIN 2" MINIMUM SEPARATION BETWEEN MAINLINE AND LATERAL LINE PIPING.
  5. BUNDLE WIRE(S) AT 20 FT. INTERVALS.

- CONSTRUCTION NOTES:**
- A. FINISHED GRADE
  - B. ROTOR HEAD
  - C. LATERAL TEE OR ELL
  - D. LATERAL PIPE
  - E. LASCO SWING JOINT


ROTOR HEAD  
NOT TO SCALE

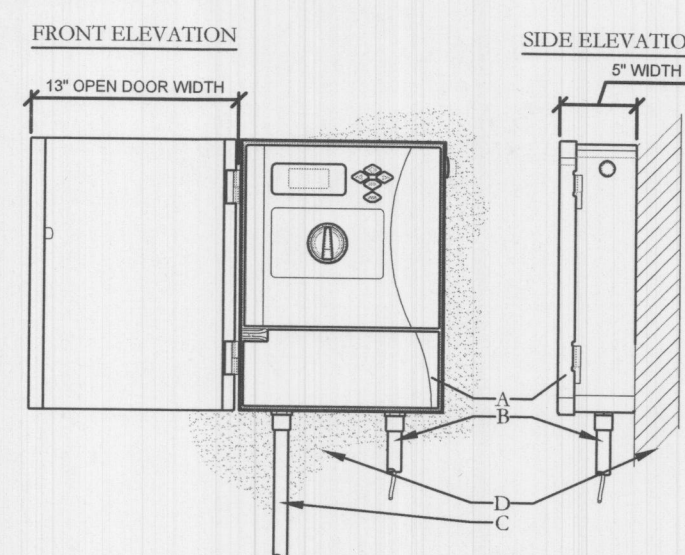

- CONSTRUCTION NOTES:**
- A. IRRIGATION CONTROLLER (12C-800-M) PER PLAN
  - B. IRRIGATION CONTROL WIRE IN CONDUIT SIZE AND TYPE PER LOCAL CODES
  - C. ELECTRICAL SUPPLY CONDUIT, CONNECT TO POWER SOURCE, I-BOX INSIDE CONTROLLER ADJACENT SURFACE TO MOUNT CONTROLLER PER PLAN
  - D. NOTES:


1. INSTALLATION TO BE COMPLETED IN ACCORDANCE WITH MANUFACTURER'S SPECIFICATIONS
2. CONTROLLER ACCEPTS 120 VOLTS AC
3. SEE PLAN LEGEND FOR MODEL NUMBER AND SPECIFICATIONS
4. ALWAYS REFER TO PRODUCT INSTALLATION NOTES PRIOR TO INSTALLATION
5. MOUNT CONTROLLER LCD SCREEN EYE LEVEL. CONTROLLER SHALL BE HARD WIRE TO GROUND 110 VAC POWER SOURCE

ICC2 CONTROLLER - WALL MOUNT  
(NOT TO SCALE)

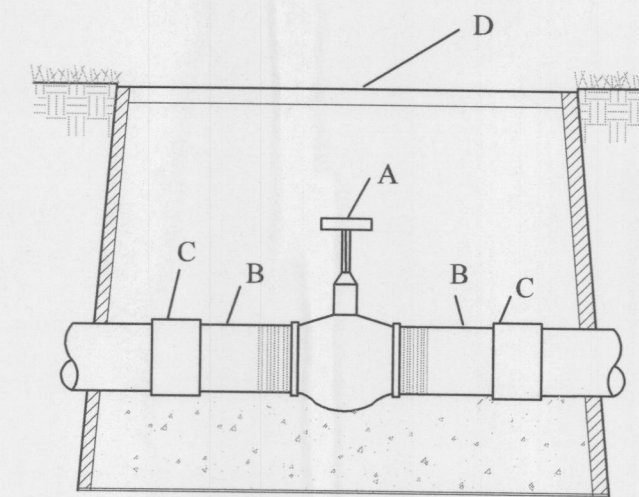


- CONSTRUCTION NOTES:**
- A. GATE VALVE
  - B. SCH 80 TOE NIPPLE
  - C. COUPLING
  - D. 11x17 VALVE BOX

GATE VALVE  
NOT TO SCALE

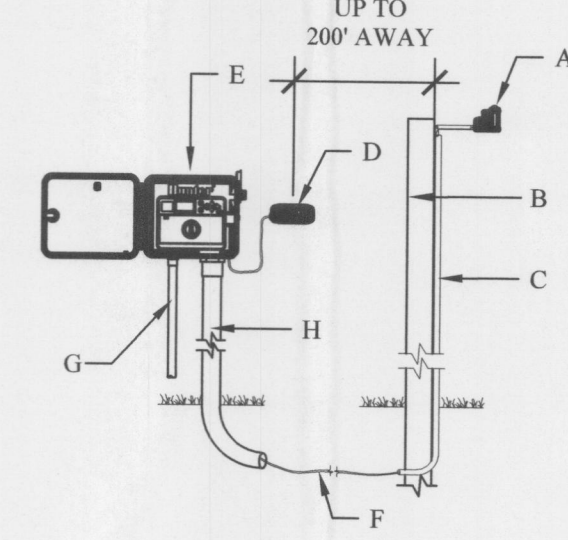


- CONSTRUCTION NOTES:**
- A. MODEL: SOLAR SYNC SENSOR
  - B. SUITABLE POST, POLE, OR GUTTER MOUNT. MOUNT IN LOCATION WHERE SENSOR CAN RECEIVE FULL SUN, IS OPEN TO RAINFALL AND OUT OF SPRINKLER SPRAY PATTERN.
  - C. CONDUIT FROM SOLAR SYNC SENSOR TO CONTROLLER OR TO A POINT 12" BELOW GRADE
  - D. MODEL SOLAR SYNC MODULE. MOUNT LESS THAN 6" AWAY FROM CONTROLLER. MODULE CAN BE MOUNTED INTERNALLY WHEN PAIRED WITH THE PCC CONTROLLER.
  - E. HUNTER ICC2 CONTROLLER
  - F. COMMUNICATION WIRE, 18-2(WIRE TYPE TO MEET INSTALLATION CODE REQUIREMENTS), FROM MODULE TO SENSOR. MAXIMUM TOTAL WIRE DISTANCE, 200 FEET.
  - G. POWER SOURCE
  - H. CONDUIT FOR VALVE CONTROL WIRE AND SOLAR SYNC COMMUNICATION WIRE

SOLAR SYNC SYSTEM (ICC2 CONTROLLER)  
NOT TO SCALE

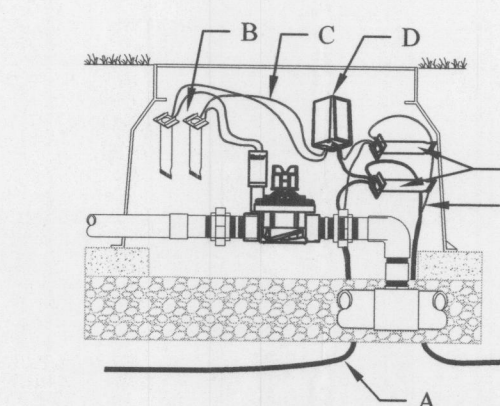

- CONSTRUCTION NOTES:**
- A. JACKETED ID WIRE PATH TWISTED TO NEXT DECODER
  - B. DEY-2
  - C. TWO BLACK WIRES TO VALVE SOLENOID/ UP TO 100 FT/30M
  - D. MODEL DUAL-1 DECODER
  - E. DBRIT-6 (2)
  - F. JACKETED ID: WIRE PATH FROM CONTROLLER ALLOW 5 FT./1.5M SLACK PER DECODER/1/3 ON EITHER SIDE OF DECODER.

DUAL-1 DECODER  
NOT TO SCALE

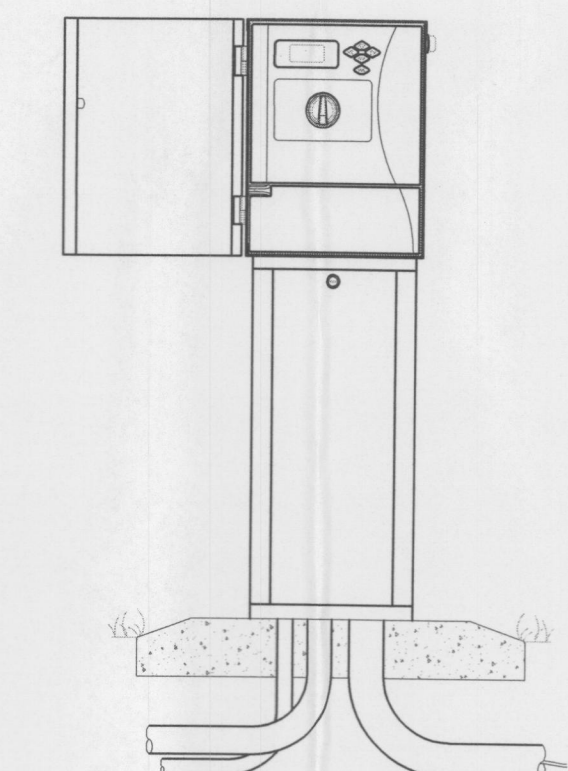

- CONSTRUCTION NOTES:**
- A. IRRIGATION CONTROLLER (ICC-PED) PER PLAN
  - B. ELECTRICAL SUPPLY CONDUIT, CONNECT TO POWER SOURCE, I-BOX INSIDE CONTROLLER
  - C. GROUND WIRE CONDUIT GROUND PER ASIC GUIDELINES
  - D. IRRIGATION CONTROL WIRE IN CONDUIT SIZE AND TYPE PER LOCAL CODES
  - E. PEDESTAL BASE PER PLAN, ENSURE POSITIVE DRAINAGE AWAY FROM PEDESTAL

- NOTES:**
1. INSTALLATION TO BE COMPLETED IN ACCORDANCE WITH MANUFACTURER'S SPECIFICATIONS
  2. SEE PLAN LEGEND FOR MODEL NUMBER AND SPECIFICATIONS
  3. ALWAYS REFER TO PRODUCT INSTALLATION NOTES PRIOR TO INSTALLATION
  4. CONTROLLER SHALL BE HARD WIRE TO GROUND 110 VAC POWER SOURCE

ICC2 CONTROLLER - PEDESTAL MOUNT  
(NOT TO SCALE)

**APPROVED:**


I hereby certify that the above and foregoing site plan for a development in the City of Rockwall, Texas, was approved by the Planning & Zoning Commission of the City of Rockwall on the 16 day of February, 2022.

WITNESS OUR HANDS, this 16 day of February, 2022.

Planning & Zoning Commission, Chairman

**JOHNSON VOLK CONSULTING**

830 CENTRAL PARKWAY EAST, SUITE 300 PLANO, TEXAS 75074  
PH. (972) 201-3100  
EMAIL: CODY@JOHNSONVOLK.COM

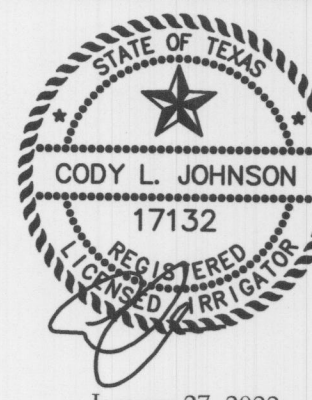

January 27, 2022

Bar is one inch on original drawing. If not one inch on this sheet, adjust scale as necessary.

One Inch

SCREENING AND BUFFERING

Irrigation Details

Saddle Star South - Phase 3

City of Rockwall, Rockwall County, Texas

CJS PROJECT NO.

PAD001B

SHEET NO.

IR6 of 6