GENERAL CONSTRUCTION NOTES

- 1. ALL CONSTRUCTION, TESTING, AND MATERIALS SHALL BE IN ACCORDANCE WITH THE CITY'S CURRENT STANDARDS, DETAILS, AND SPECIFICATIONS.
- PRIOR TO ANY CONSTRUCTION ACTIVITIES, THE CONTRACTOR SHALL BE FAMILIAR WITH THE PLANS INCLUDING ALL NOTES, STANDARD SPECIFICATIONS, DETAILS, AND CITY STANDARDS.
- 3. TESTING AND INSPECTION OF MATERIALS SHALL BE PERFORMED BY A COMMERCIAL TESTING LABORATORY APPROVED BY THE CLIENT AND CITY. CONTRACTOR SHALL FURNISH MATERIALS OR SPECIMENS FOR TESTING, AND SHALL FURNISH SUITABLE EVIDENCE THAT THE MATERIALS PROPOSED TO BE INCORPORATED INTO THE WORK ARE IN ACCORDANCE WITH THE
- 4. CONTRACTOR SHALL NOTIFY THE CITY AT LEAST 48 HOURS PRIOR TO BEGINNING
- CONTRACTOR IS RESPONSIBLE FOR OBTAINING ALL NECESSARY PERMITS AND APPROVALS PRIOR TO BEGINNING ANY CONSTRUCTION.
- CONTRACTOR MUST KEEP AVAILABLE ON-SITE AT ALL TIMES APPROVED CURRENT VERSIONS OF THE FOLLOWING REFERENCES: CITY OF ROCKWALL ENGINEERING STANDARDS, NCTCOG SPECIFICATIONS, TXDOT SPECIFICATIONS, TXDOT STANDARD DRAWINGS.
- ALL SHOP DRAWINGS, WORKING DRAWINGS OR OTHER DOCUMENTS WHICH REQUIRE REVIEW BY THE CITY SHALL BE SUBMITTED BY THE CONTRACTOR SUFFICIENTLY IN ADVANCE OF SCHEDULED CONSTRUCTION TO ALLOW NO LESS THAN 14 CALENDAR DAYS FOR REVIEW AND RESPONSE BY THE CITY.
- THE CONTRACTOR SHALL BE RESPONSIBLE FOR ALL REQUIRED CONSTRUCTION SURVEYING AND STAKING AND SHALL NOTIFY THE CLIENT AND CITY OF ANY DISCREPANCIES PRIOR TO PROCEEDING WITH ANY WORK.
- CONTRACTOR SHALL BE RESPONSIBLE FOR PROTECTING ALL SURVEY MARKERS INCLUDING IRON RODS, PROPERTY CORNERS, OR SURVEY MONUMENTS WITHIN THE LIMITS OF CONSTRUCTION AND OUTSIDE ROW DURING CONSTRUCTION. ANY SURVEY MARKERS DISTURBED DURING CONSTRUCTION SHALL BE REPLACED BY THE CONTRACTOR AT NO COST TO THE CLIENT.
- 10. CONTRACTOR IS RESPONSIBLE FOR KEEPING STREETS AND DRIVEWAYS ADJACENT TO THE PROJECT FREE OF MUD AND DEBRIS AT ALL TIMES. CONTRACTOR SHALL CLEAN UP AND REMOVE ALL LOOSE MATERIAL RESULTING FROM CONSTRUCTION OPERATIONS. THE CONTRACTOR SHALL TAKE ALL AVAILABLE PRECAUTIONS TO
- 11. THE EXISTENCE AND LOCATIONS OF THE PUBLIC AND FRANCHISE UTILITIES ARE APPROXIMATE. THE CONTRACTOR SHALL DETERMINE THE DEPTH AND LOCATION OF EXISTING UNDERGROUND UTILITIES PRIOR TO EXCAVATING, TRENCHING, OR DRILLING AND SHALL BE REQUIRED TO TAKE ANY PRECAUTIONARY MEASURES TO PROTECT ALL LINES SHOWN AND / OR ANY OTHER AND FRANCHISE UTILITIES 48 HOURS PRIOR TO CONSTRUCTION. (DIG-TESS 1-800-344-8377) THE CONTRACTOR MAY BE REQUIRED EXPOSE THESE FACILITIES AT NO COST TO THE CITY. THE CONTRACTOR WILL BE RESPONSIBLE FOR DAMAGES TO UTILITIES IF THE DAMAGE IS CAUSED BY NEGLIGENCE OR FAILURE TO HAVE
- 12. THE CONTRACTOR SHALL BE RESPONSIBLE FOR ANY DAMAGE TO EXISTING FACILITIES OR ADJACENT PROPERTIES DURING CONSTRUCTION, ANY REMOVAL OR
- CONTRACTOR SHALL BE RESPONSIBLE FOR FURNISHING AND INSTALLING ALL TEMPORARY AND PERMANENT TRAFFIC CONTROL IN ACCORDANCE WITH THE MINIMUM REQUIREMENTS OF THE LATEST REVISION OF THE TEXAS MANUAL ON UNIFORM TRAFFIC CONTROL DEVICES (TMUTCD) AND TXDOT BARRICADE AND CONSTRUCTION STANDARDS.
- 14. CONTRACTOR SHALL NOT IMPEDE TRAFFIC ON EXISTING STREETS, DRIVEWAYS, ALLEYS, OR FIRE LANES OPEN TO THE PUBLIC. IN THE EVENT THE CONSTRUCTION WORK REQUIRES THE CLOSURE OF AN EXISTING STREET, ALLEY, OR FIRE LANE, THE CONTRACTOR SHALL REQUEST THE ROAD CLOSURE THROUGH THE CITY
- 15. CONTRACTOR SHALL NOT STORE MATERIALS, EQUIPMENT OR OTHER CONSTRUCTION ITEMS ON ADJACENT PROPERTIES OR RIGHT-OF-WAY WITHOUT THE PRIOR WRITTEN CONSENT OF THE PROPERTY OWNER AND THE CITY.
- TEMPORARY FENCING SHALL BE INSTALLED PRIOR TO THE REMOVAL OF EXISTING FENCING. TEMPORARY FENCING SHALL BE REMOVED AFTER PROPOSED FENCING IS APPROVED BY THE CITY. ALL TEMPORARY AND PROPOSED FENCING LOCATIONS SHALL BE SUBJECT TO FIELD REVISIONS AS DIRECTED BY THE CITY.
- UNUSABLE EXCAVATED MATERIAL, OR CONSTRUCTION DEBRIS SHALL BE REMOVED AND DISPOSED OF OFFSITE AT AN APPROVED DISPOSAL FACILITY BY THE CONTRACTOR AT HIS EXPENSE.
- 18. CONTRACTOR SHALL AVOID DAMAGE TO EXISTING TREES. WHEN NECESSARY, TREES AND SHRUB TRIMMING FOR CONSTRUCTION SHALL BE PERFORMED BY CERTIFIED TREE WORKER OR UNDER THE DIRECTION OF A REGISTERED
- LANDSCAPE ARCHITECT OR CERTIFIED ARBORIST. 19. EROSION CONTROL DEVICES SHALL BE INSTALLED ON ALL PROJECTS PRIOR TO BEGINNING CONSTRUCTION AND SHALL BE MAINTAINED THROUGHOUT THE
- PROJECT IN A CONDITION ACCEPTABLE TO THE CITY. 20. CONTRACTOR SHALL LOCATE AND PROTECT ALL EXISTING LANDSCAPE IRRIGATION SYSTEMS. DAMAGE TO EXISTING IRRIGATION SYSTEMS AND LANDSCAPE MATERIALS SHALL BE RESTORED TO EQUAL OR BETTER CONDITION AT NO COST TO CITY OR CLIENT.
- 21. IT IS THE CONTRACTOR'S RESPONSIBILITY TO MAINTAIN A NEAT AND ACCURATE RECORD OF CONSTRUCTION FOR THE CLIENT'S AND CITY'S RECORDS.

I hereby certify that the above and foregoing site plan for a development in the City of Rockwall, Texas, was approved by the


Planning & Zoning Commission of the City of Rockwall on the 7 day of Hory, 213

CONSTRUCTION PLANS FOR SCREENING AND BUFFERING

~Discovery Lakes Ph. 1~ CITY OF ROCKWALL

ROCKWALL COUNTY, TEXAS

SUBMITTAL DATE: March 01, 2023

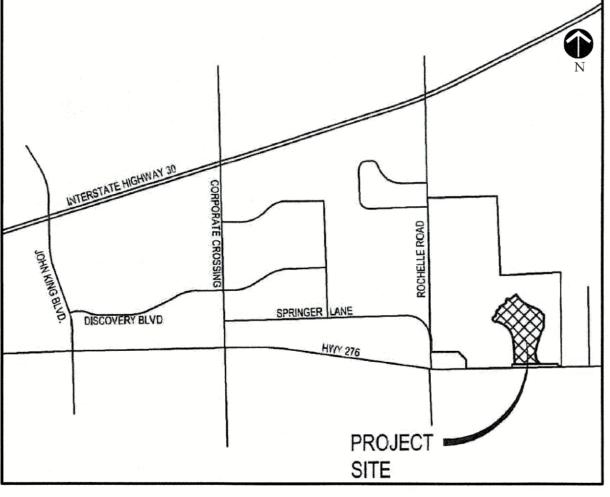

LOCATION MAP NOT TO SCALE

OWNER / DEVELOPER:

DISCOVERY LAKES, LLC. 15400 KNOLL TRAIL DRIVE, **SUITE 230** DALLAS, TEXAS 75248

CIVIL ENGINEER:

TEAGUE NALL AND PERKINS, INC. 825 WATTERS CREEK BOULEVARD SUITE, M300 **ALLEN, TEXAS 75013** PH. (214) 461-9867 CONTACT: CAMERON SLOWN, P.E.

LANDSCAPE ARCHITECT:

SHEET INDEX

OVERALL LAYOUT PLAN

HARDSCAPE PLANS

FENCING EXHIBIT

LANDSCAPE PLANS

IRRIGATION PLANS

IRRIGATION DETAILS

LANDSCAPE DETAILS

HARDSCAPE DETAILS

HS2-HS4

HS5-HS8

L8-L9

IR1-IR7

IR8-IR9

OVERALL LANDSCAPE SITE PLAN

JOHNSON VOLK CONSULTING 704 CENTRAL PARKWAY EAST SUITE 1200 PLANO, TEXAS 75074 PH. (972) 201-3100 CONTACT: CODY JOHNSON, RLA, ASLA, LI

GENERAL LANDSCAPE NOTES:

INSPECTIONS:

- . NO EXCAVATION SHALL OCCUR IN CITY R.O.W. WITHOUT A R.O.W. PERMIT--CONTACT
- LOCATIONS PRIOR TO CALLING FOR ROW INSPECTION AND PERMIT. THE LANDSCAPE INSTALLATION SHALL COMPLY WITH APPROVED LANDSCAPE DRAWINGS PRIOR TO FINAL ACCEPTANCE BY THE CITY AND ISSUANCE OF A CERTIFICATE OF OCCUPANCY.
- WATER METERS, CLEANOUTS AND OTHER APPURTENANCES, SHALL BE ACCESSIBLE ADJUSTED TO GRADE, CLEARLY MARKED WITH FLAGGING AND COMPLIANT WITH PUBLIC WORKS DEPARTMENT STANDARDS PRIOR TO CALLING FOR FINAL LANDSCAPE AND ROW INSPECTIONS.

LANDSCAPE STANDARDS:

- I. PLANTINGS AND LANDSCAPE ELEMENTS SHALL COMPLY WITH THE CITY'S
- ENGINEERING DESIGN STANDARDS, PUBLIC R.O.W. VISIBILITY REQUIREMENTS. CURBS, SIDEWALKS, UTILITY LINES, SCREENING WALLS AND OTHER STRUCTURES.
- 3. A MINIMUM THREE FEET (3') RADIUS AROUND A FIRE HYDRANT MUST REMAIN
- CLEAR OF LANDSCAPE PURSUANT TO THE FIRE CODE. STREET TREES, WHERE REQUIRED, SHALL BE (10') MINIMUM FROM THE EDGE OF A STORM SEWER CURB INLET BOX AND THE EDGE OF THE ROOT BALL SHALL BE (4')
- 5. THE AMERICAN STANDARD FOR NURSERY STOCK (ANSI Z60.1-2014) SPECIFICATIONS
- SHALL GOVERN PLANT QUALIFICATIONS, GRADES, AND STANDARDS. TREE PLANTING SHALL COMPLY WITH DETAILS HEREIN AND THE INTERNATIONAL SOCIETY OF ARBORICULTURE (ISA) STANDARDS
- A 2-3" LAYER OF MULCH SHALL BE PROVIDED AROUND THE BASE OF THE PLANTED TREE. THE MULCH SHALL BE PULLED BACK 4" FROM THE TRUNK OF THE TREE.
- I. TREE PITS SHALL BE TESTED FOR WATER PERCOLATION. IF WATER DOES NOT DRAIN OUT OF TREE PIT WITHIN 24-HOURS, THE TREE SHALL BE MOVED OR DRAINAGE SHALL BE PROVIDED.
- 9. ALL BEDS TO HAVE 3" OF COMPOSTED SOIL, LIVING EARTH TECHNOLOGY, OR APPROVED EQUAL TILLED AND TURNED TO A DEPTH OF 8" MINIMUM.
- ALL PLANT BEDS SHALL BE TOP-DRESSED WITH A MINIMUM OF 3 INCHES OF
- 11. NATIVE SITE TOPSOIL IS TO BE PROTECTED FROM EROSION OR STOCKPILED NATIVE SITE TOPSOIL SHALL BE LABORATORY TESTED BY AND ACCREDITED LABORATORY AND AMENDED PER SAID LABORATORY'S RECOMMENDATIONS

IRRIGATION STANDARDS:

- ANY CHANGES TO THESE APPROVED IRRIGATION DRAWINGS SHALL BE
- AUTHORIZED BY THE CITY. 2. CONTACT DEVELOPMENT SERVICES FOR AN IRRIGATION PERMIT PRIOR TO
- INSTALLING THE IRRIGATION SYSTEM. IRRIGATION OVER-SPRAY ON STREETS AND WALKS IS PROHIBITED.
- 4. MAINLINES, VALVES, OR CONTROL WIRES SHALL NOT BE LOCATED IN THE CITY'S
- 5. ET IRRIGATION CONTROLLERS SHALL BE PROGRAMMED AND ADJUSTED TO NOT EXCEED THE LANDSCAPE WATER ALLOWANCE (LWA) PRIOR TO APPROVAL OF LANDSCAPE INSTALLATION.
- 6. VALVES SHALL BE LOCATED A MINIMUM OF (3') AWAY FROM STORM SEWERS, AND SANITARY SEWER LINES AND 5 FEET FROM CITY FIRE HYDRANTS AND WATER
- 7. THE BORE DEPTH UNDER STREETS, DRIVE AISLES, AND FIRE LANES SHALL PROVIDE
- (2') OF CLEARANCE (MINIMUM). IRRIGATION HEADS THAT RUN PARALLEL AND NEAR PUBLIC WATER AND SANITARY SEWER LINES; SHALL BE FED FROM STUBBED LATERALS OR BULL-BEADS. A MINIMUM
- FIVE FOOT (5') SEPARATION IS REQUIRED BETWEEN IRRIGATION MAIN LINES AND LATERALS THAT RUN PARALLEL TO PUBLIC WATER AND SANITARY SEWER LINES.
- 9. NO VALVES, BACKFLOW PREVENTION ASSEMBLIES, OUICK COUPLERS ETC. SHALL BE
- LOCATED CLOSER THAN 10' FROM THE CURB AT STREET OR DRIVE INTERSECTION.

MAINTENANCE STANDARDS:


- . THE OWNER SHALL BE RESPONSIBLE FOR THE ESTABLISHMENT, MAINTENANCE, AND VIGOR OF PLANT MATERIAL IN ACCORDANCE WITH THE DESIGN INTENT AND AS APPROPRIATE FOR THE SEASON OF THE YEAR.
- 2. LANDSCAPE AND OPEN AREAS SHALL BE FREE OF TRASH, LITTER AND WEEDS. 3. NO PLANT MATERIAL SHALL BE ALLOWED TO ENCROACH ON R.O.W., SIDEWALKS OR EASEMENTS TO THE EXTENT THAT VISION OR ROUTE OF TRAVEL FOR VEHICULAR.
- PEDESTRIAN, OR BICYCLE TRAFFIC IS IMPEDED. 4. TREE MAINTENANCE SHALL BE IN ACCORDANCE WITH THE STANDARDS OF THE INTERNATIONAL SOCIETY OF ARBORICULTURE.
- TREE STAKING MATERIALS, IF USED, SHALL BE REMOVED AFTER (1) GROWING SEASON, NO MORE THAN (1) YEAR AFTER INSTALLATION (STEEL TREE STAKES. WIRES, AND HOSES ARE PROHIBITED).

TREE PROTECTION NOTES:

- CONTACT DEVELOPMENT SERVICES FOR A TREE REMOVAL PERMIT PRIOR TO REMOVAL OR TRANSPLANTING OF ANY TREES.
- . ALL TREES WHICH ARE TO REMAIN ON SITE SHALL BE PROTECTED WITH A (4') TALL BRIGHTLY COLORED PLASTIC FENCE, OR SILT FENCE, PLACED AT THE DRIP LINE OF
- 3. PRIOR TO THE PRE-CONSTRUCTION MEETING OR OBTAINING A GRADING PERMIT, ALL TREE MARKINGS AND PROTECTIVE FENCING SHALL BE INSTALLED BY THE OWNER AND BE INSPECTED BY DEVELOPMENT SERVICES.
- 4. NO EQUIPMENT SHALL BE CLEANED, OR HARMFUL LIQUIDS DEPOSITED WITHIN
- THE LIMITS OF THE ROOT ZONE OF TREES WHICH REMAIN ON SITE . NO SIGNS, WIRES, OR OTHER ATTACHMENTS SHALL BE ATTACHED TO ANY TREE TO
- REMAIN ON SITE. 6. VEHICULAR AND CONSTRUCTION EQUIPMENT SHALL NOT PARK OR DRIVE WITHIN
- THE LIMITS OF THE DRIP LINE.
- GRADE CHANGES IN EXCESS OF 3 INCHES (CUT OR FILL) SHALL NOT BE ALLOWED WITHIN A ROOT ZONE, UNLESS ADEQUATE TREE PRESERVATION METHODS ARE APPROVED BY THE CITY.
- 8. NO TRENCHING SHALL BE ALLOWED WITHIN THE DRIP-LINE OF A TREE, UNLESS APPROVED BY THE CITY.
- 9. ALL REMOVED TREES SHALL BE CHIPPED AND USED FOR MULCH ON SITE OR
- HAULED OFF-SITE. 10. ALL TREE MAINTENANCE TECHNIQUES SHALL BE IN CONFORMANCE WITH INDUSTRY IDENTIFIED STANDARDS. IMPROPER OR MALICIOUS PRUNING TECHNIQUES ARE STRICTLY PROHIBITED.



704 CENTRAL PARKWAY EAST, SUITE 1200 PLANO, TEXAS 75074 PH. (972) 201-3100 EMAIL: CODY.JOHNSON@JOHNSONVOLK.COM

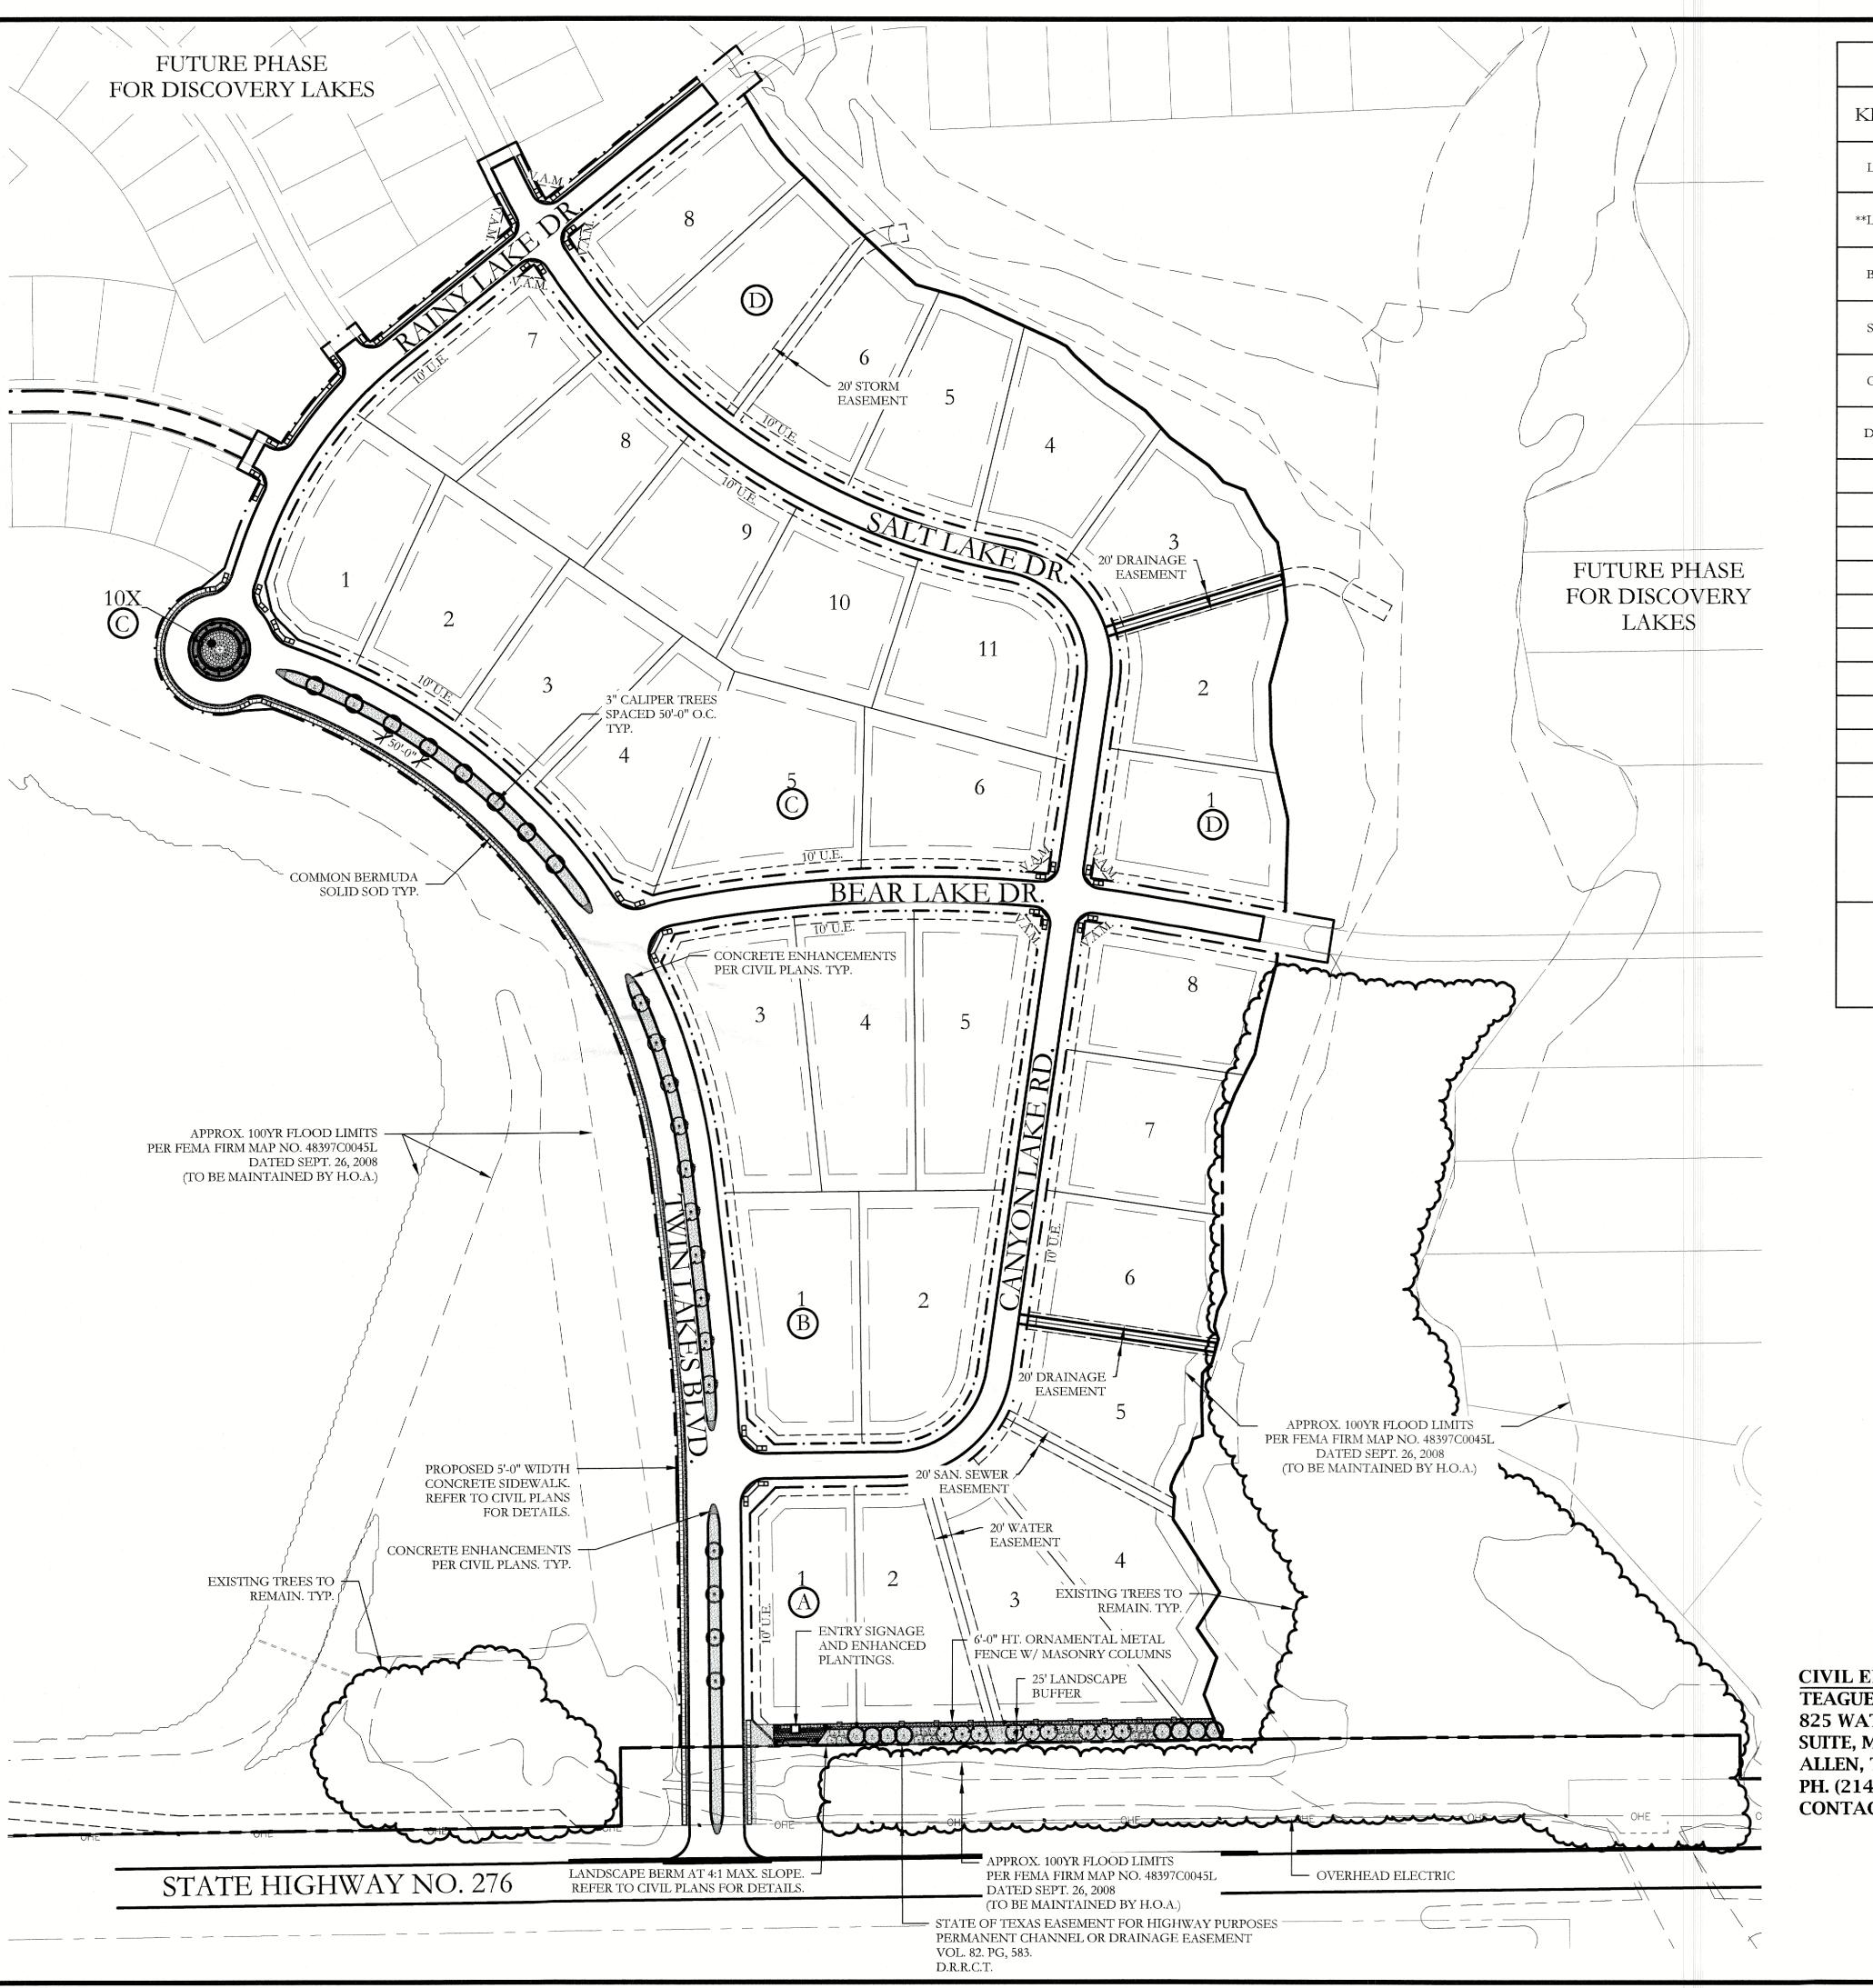

	I	т	T			
KEY ESTIMATED QUANTITY		COMMON NAME	SCIENTIFIC NAME	SIZE	SPACING	
LO			QUERCUS VIRGINIANA	4" CALIPER	AS SHOWN	
TO			QUERCUS VIRGINIANA	8" CALIPER	AS SHOWN	
ВО	8	BUR OAK	QUERCUS MACROCARPA	4" CALIPER	AS SHOWN	
SO	19	SHUMARD OAK	QUERCUS SHUMARDII	4" CALIPER	AS SHOWN	
CE 4 CEDAR ELM		CEDAR ELM	ULMUS CRASSIFOLIA	4" CALIPER	AS SHOWN	
DW	22	DESERT WILLOW	CHILOPSIS LINEARIS	2" CALIPER	AS SHOWN	
	105 STANDARD BURFORD HOLLY		ILEX CORNUTA 'BURFORDII'	7 GALLON	48" O.C.	
	67	PURPLE DIAMOND LOROPETALUM	LOROPETALUM CHINENSIS ' PURPLE DIAMOND'	7 GALLON	48" O.C.	
	25	DESPERADO TEXAS SAGE	LEUCOPHYLLUM FRUTESCENS 'GREADO'	5 GALLON	48" O.C.	
	109	PINKIE INDIAN HAWTHORN	RHAPHIOLEPIS INDICA 'PINKIE'	5 GALLON	36" O.C.	
	36	RED YUCCA	HESPERALOE PARVIFLORA	5 GALLON	36" O.C.	
	50	YELLOW YUCCA	HESPERALOE PARVIFLORA 'YELLOW'	5 GALLON	36" O.C.	
	15	ADAN'S NEEDLE 'COLOR GUARD'	YUCCA FILAMENTOSA 'COLOR GUARD'	5 GALLON	36" O.C.	
	550	MEXICAN FEATHER GRASS	NASSELLA TENUISSIMA	1 GALLON	24" O.C.	
	170	ANNUAL COLOR	TO BE SELECTED BY OWNER	4" POT	8" O.C.	
	35,100	COMMON BERMUDA GRASS	CYNODON DACTYLON	SQUARE FEET	SOLID SOD	
	2	OKLAHOMA MOSS ROCK BOULDERS	N/A	TON	AS SHOWN	
	825	OKLAHOMA RIVER ROCK	N/A	SQUARE FEET	100% COVERAGE	

LANDSCAPE PROVIDED

STATE HIGHWAY - 276

 $5.45 \times 4 = 21.80$

MINIMUM TWENTY (25) FOOT LANDSCAPE BUFFER PROVIDED

6' HT. WROUGHT IRON METAL SCREENING FENCE PROVIDED.

 $\frac{3-4"}{545}$ CAL. CANOPY TREE / 100 LF OF LINEAR FRONTAGE. $\frac{3-4"}{545}$ LF OF FRONTAGE / 100 LF = 5.45

 $5.45 \times 3 = 16.35$

4-ACCENT TREES / 100 LF OF LINEAR FRONTAGE. 545 LF OF FRONTAGE / 100 LF = 5.45

PROVIDED: 17 - 4" CALIPER TREES

22 - ACCENT TREES

SHRUBBERY SHALL HAVE A MINIMUM HEIGHT OF 30 INCHES AND A MAXIMUM HEIGHT OF 48 INCHES.

MINIMUM 2.5' HT. LANDSCAPE BERMS PROVIDED ALONG

FRONTAGE. REFER TO CIVIL PLANS FOR DETAILS

EACH RESIDENTIAL LOT MUST HAVE (2) TWO LOT TREES IN THE FRONT YARD, AND CORNER LOTS MUST HAVE (4) FOUR LOT

CIVIL ENGINEER: TEAGUE NALL AND PERKINS, INC. DISCOVERY LAKES, LLC. 825 WATTERS CREEK BOULEVARD 15400 KNOLL TRAIL DRIVE, 704 CENTRAL PARKWAY EAST SUITE, M300 ALLEN, TEXAS 75013 PH. (214) 461-9867 CONTACT: CAMERON SLOWN, P.E.

OWNER / DEVELOPER: **SUITE 230** DALLAS, TEXAS 75248

LANDSCAPE ARCHITECT:

JOHNSON VOLK CONSULTING **SUITE 1200** PLANO, TEXAS 75074 PH. (972) 201-3100 CONTACT: CODY JOHNSON, RLA, ASLA, LI


APPROVED:	
I hereby certify that the above and foregoing site plan for	a development in the City of Rockwall, Texas, was approved
Planning & Zoning Commission of the City of Rockwall or	the 7 day of February 2023
WITNESS OUR HANDS, this day of Horay	2013 / 11.
	1414
Planning & Zoning Commission, Chairman	Director of Planning and Zoning

CJS PROJECT NO. SHEET NO. SP1 of 1

Bar is one inch on

original drawing. If not one inch on this sheet, adjust scale as necessary

One Inch

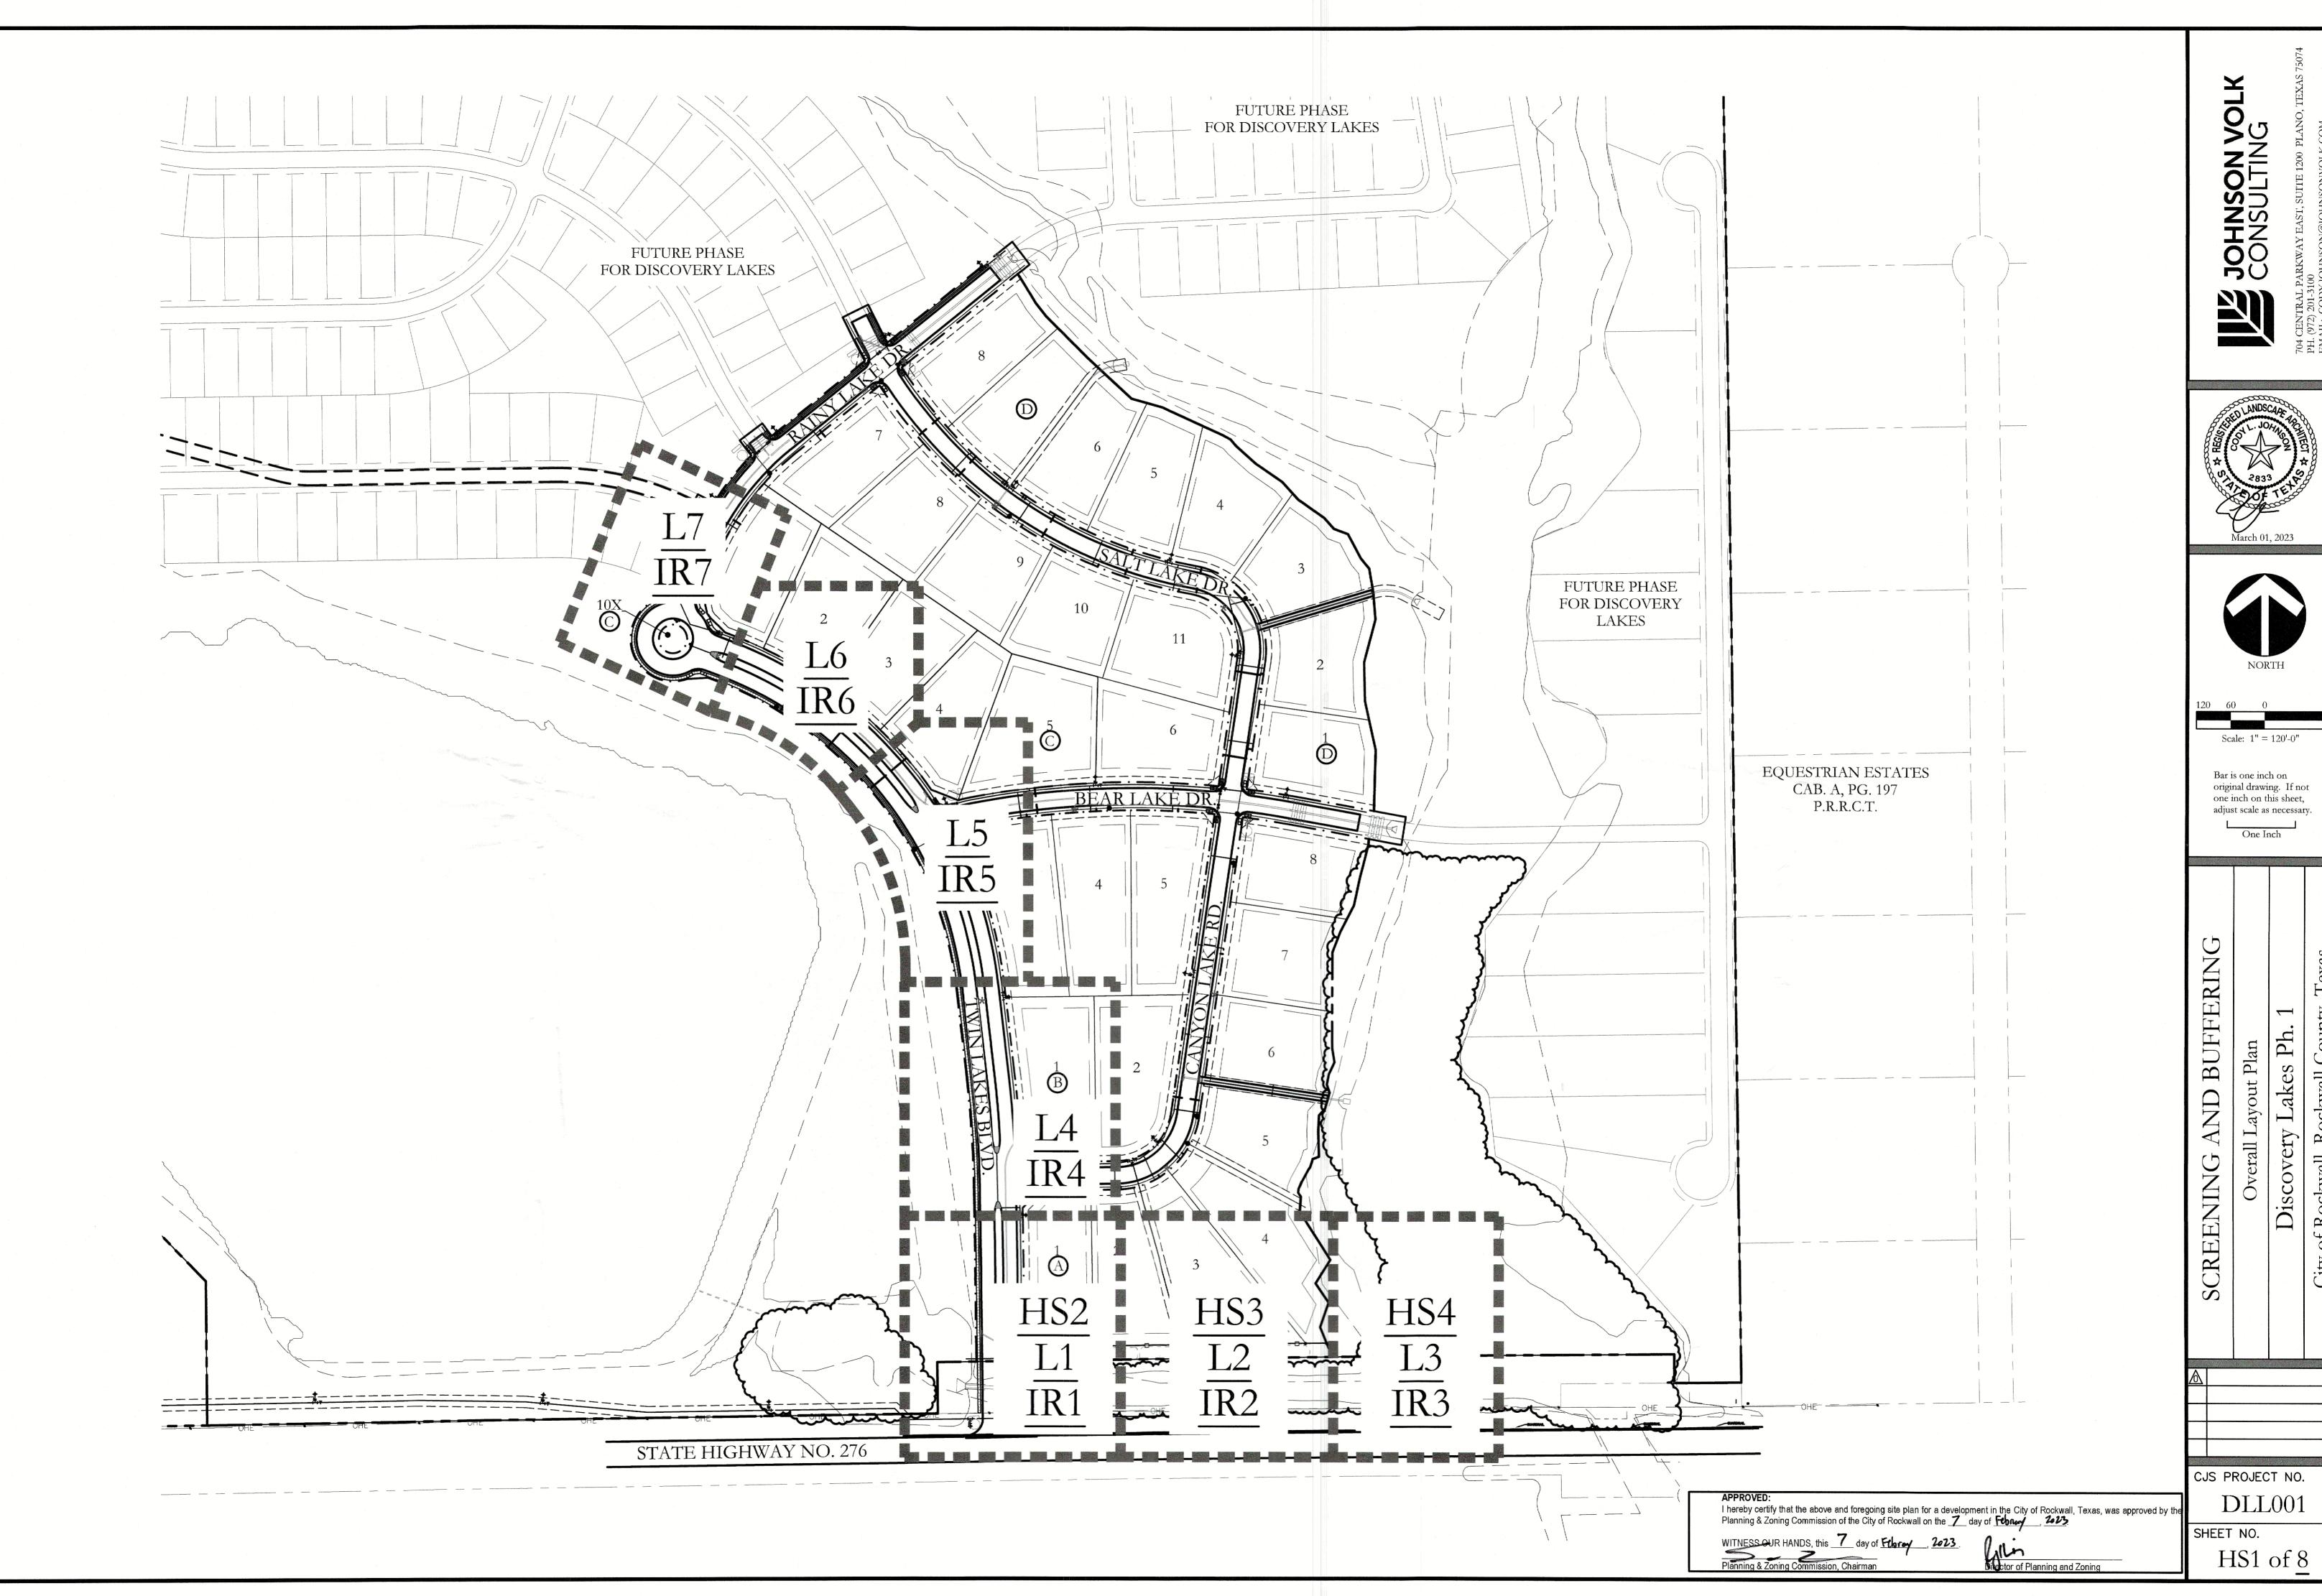




Bar is one inch on original drawing. If not one inch on this sheet,

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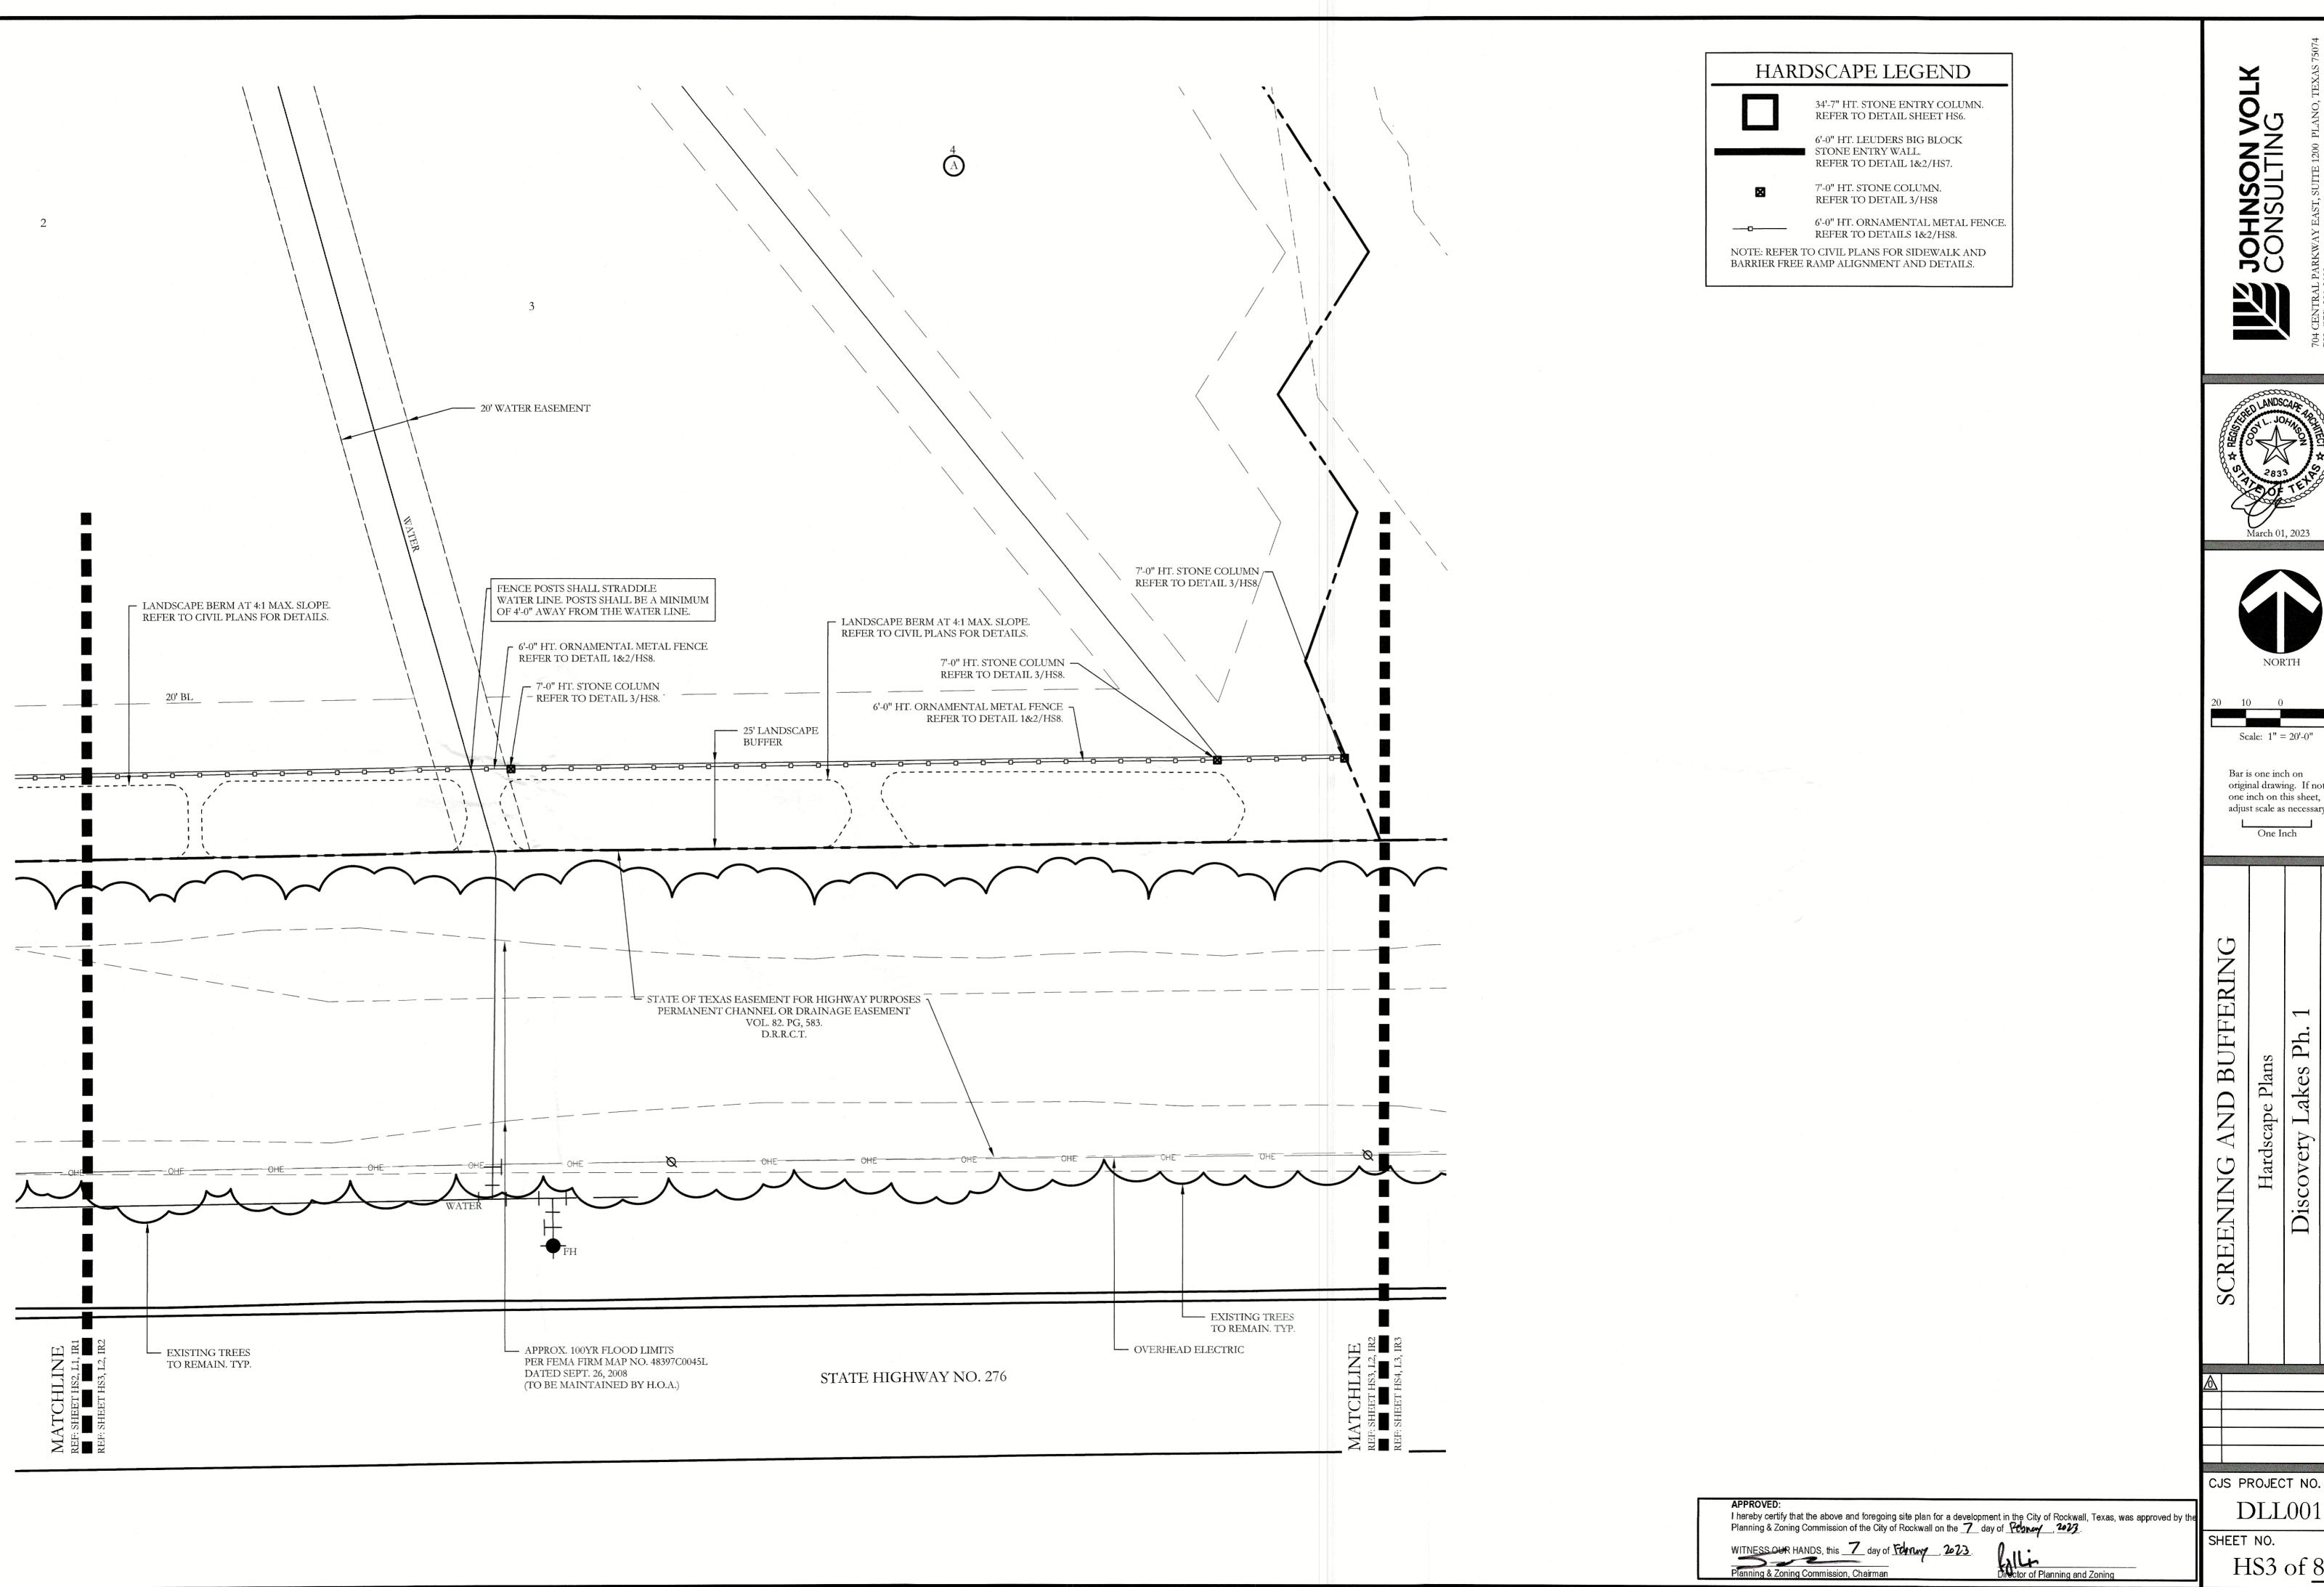
DLL001



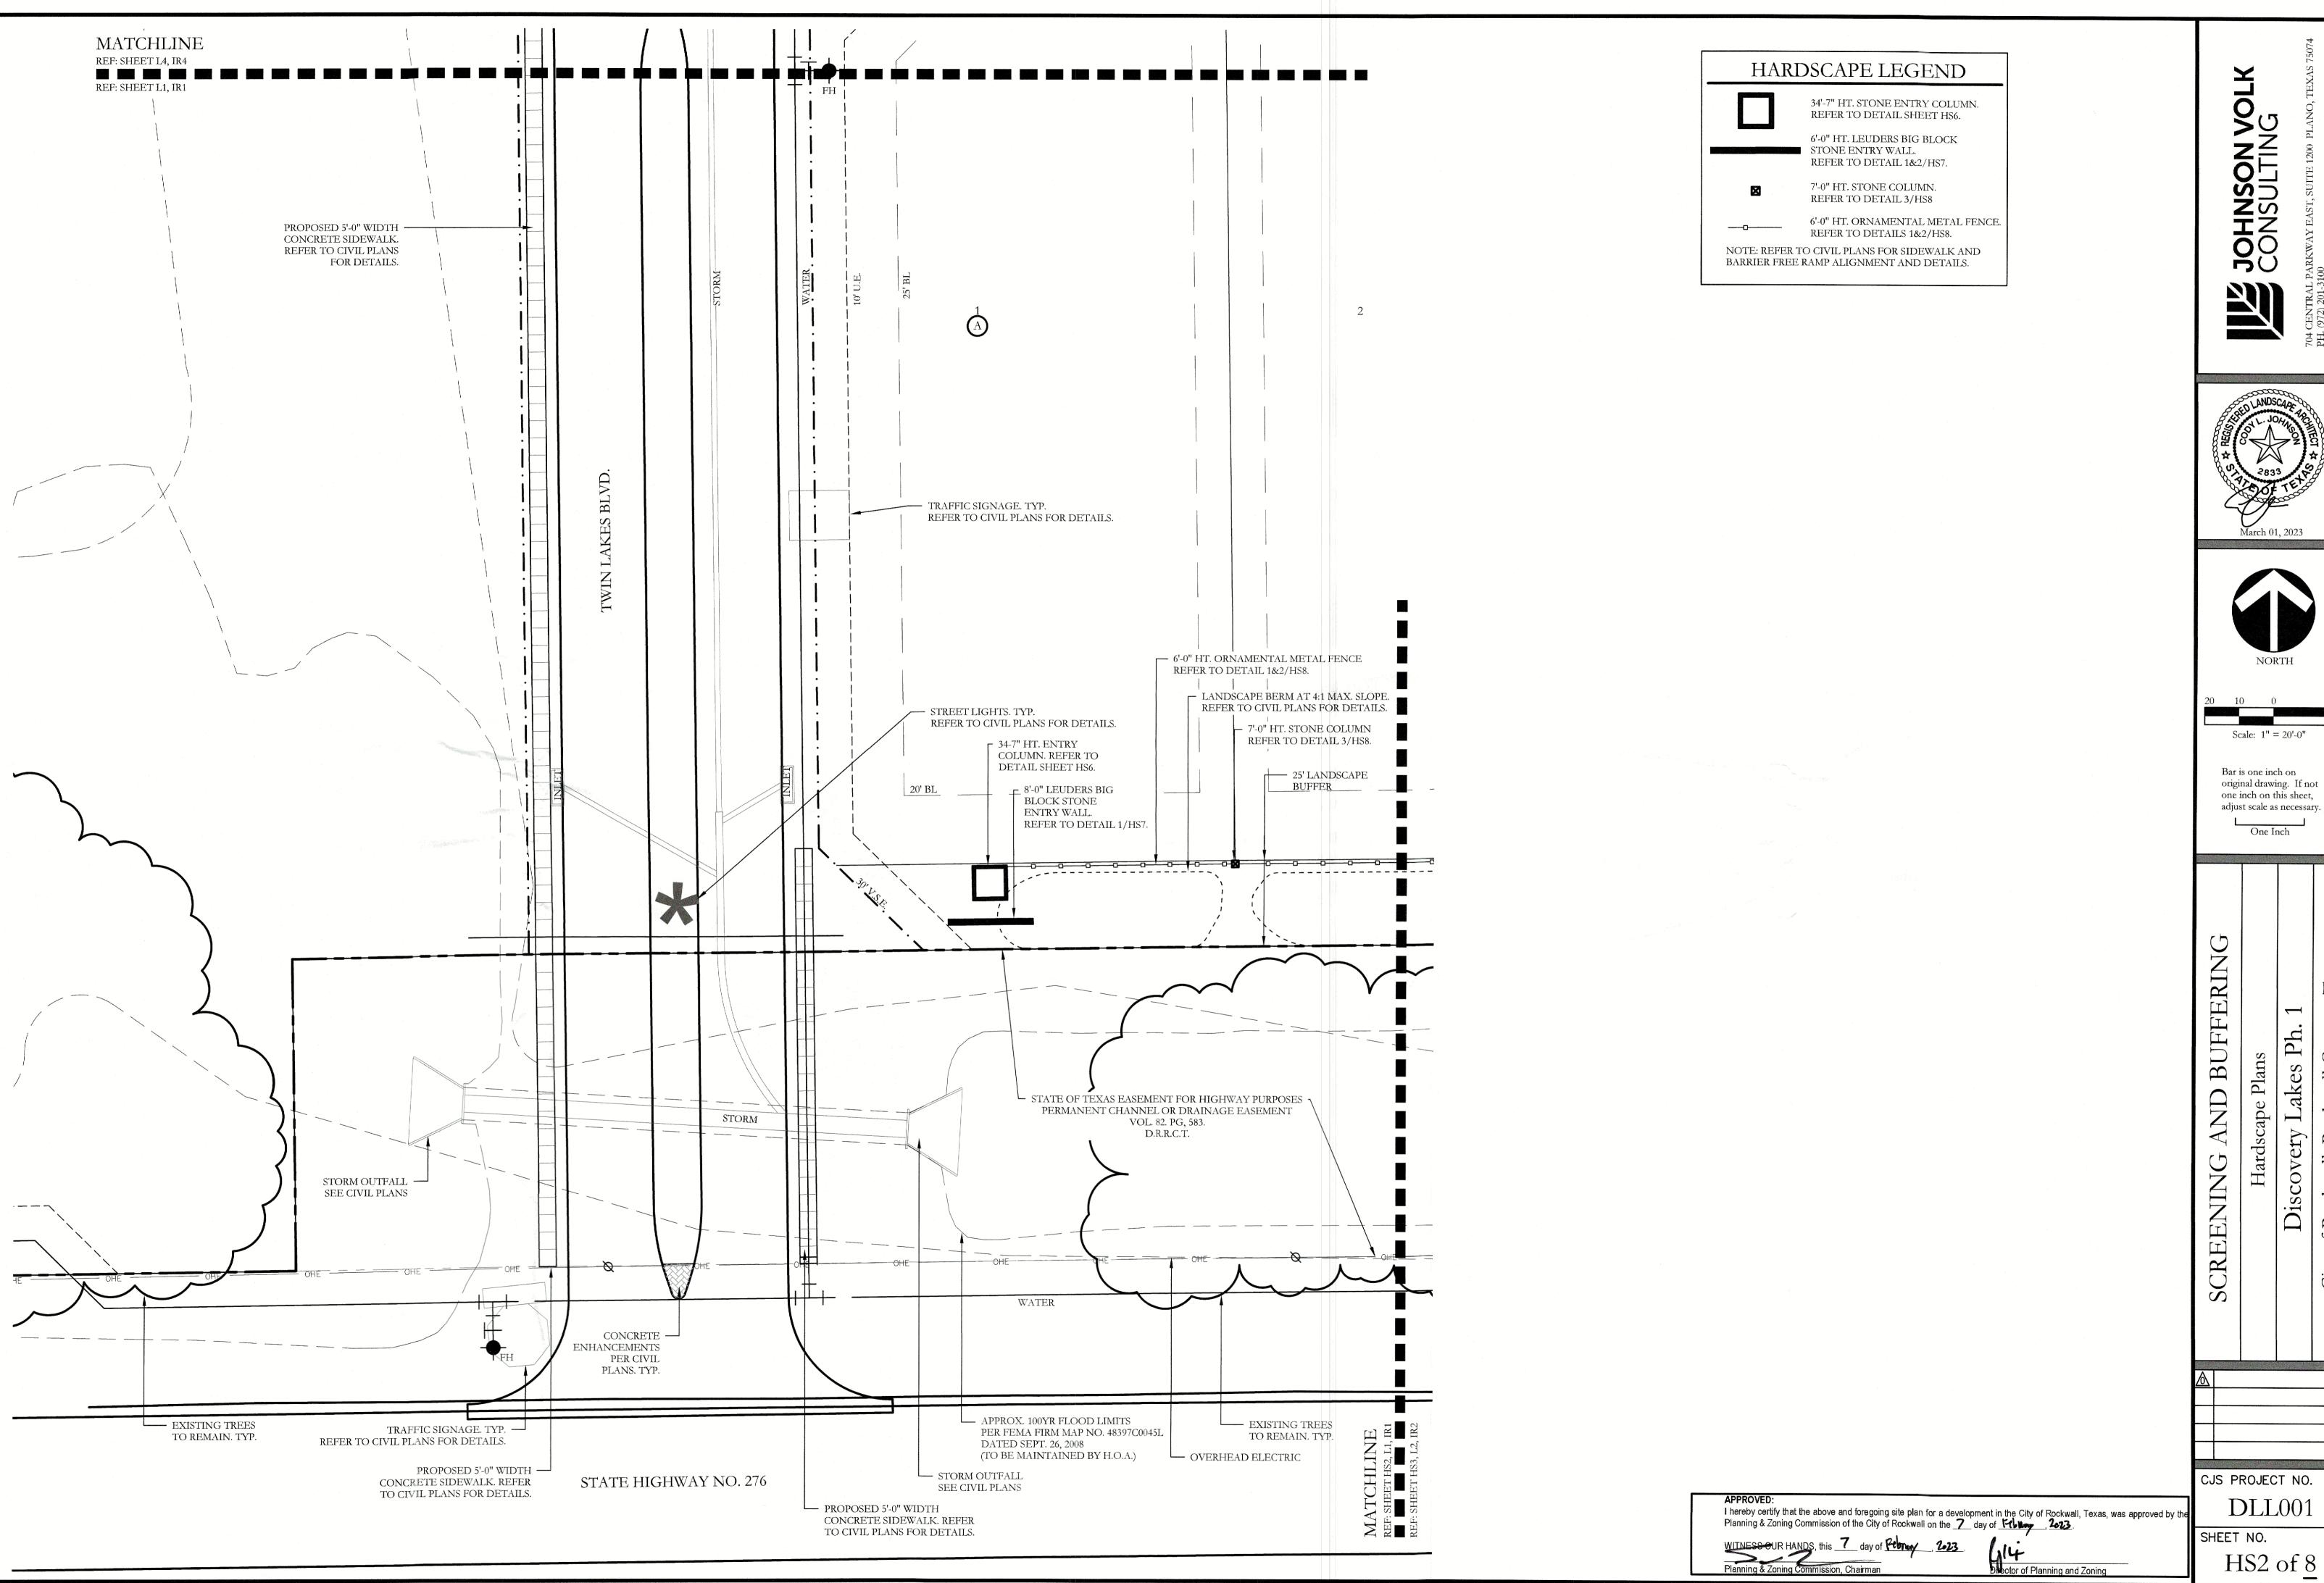

Scale: 1'' = 20'-0''original drawing. If not one inch on this sheet, adjust scale as necessary.

CJS PROJECT NO. DLL001






Scale: 1'' = 20'-0''

Bar is one inch on original drawing. If not one inch on this sheet, adjust scale as necessary.

DLL001

HS3 of 8

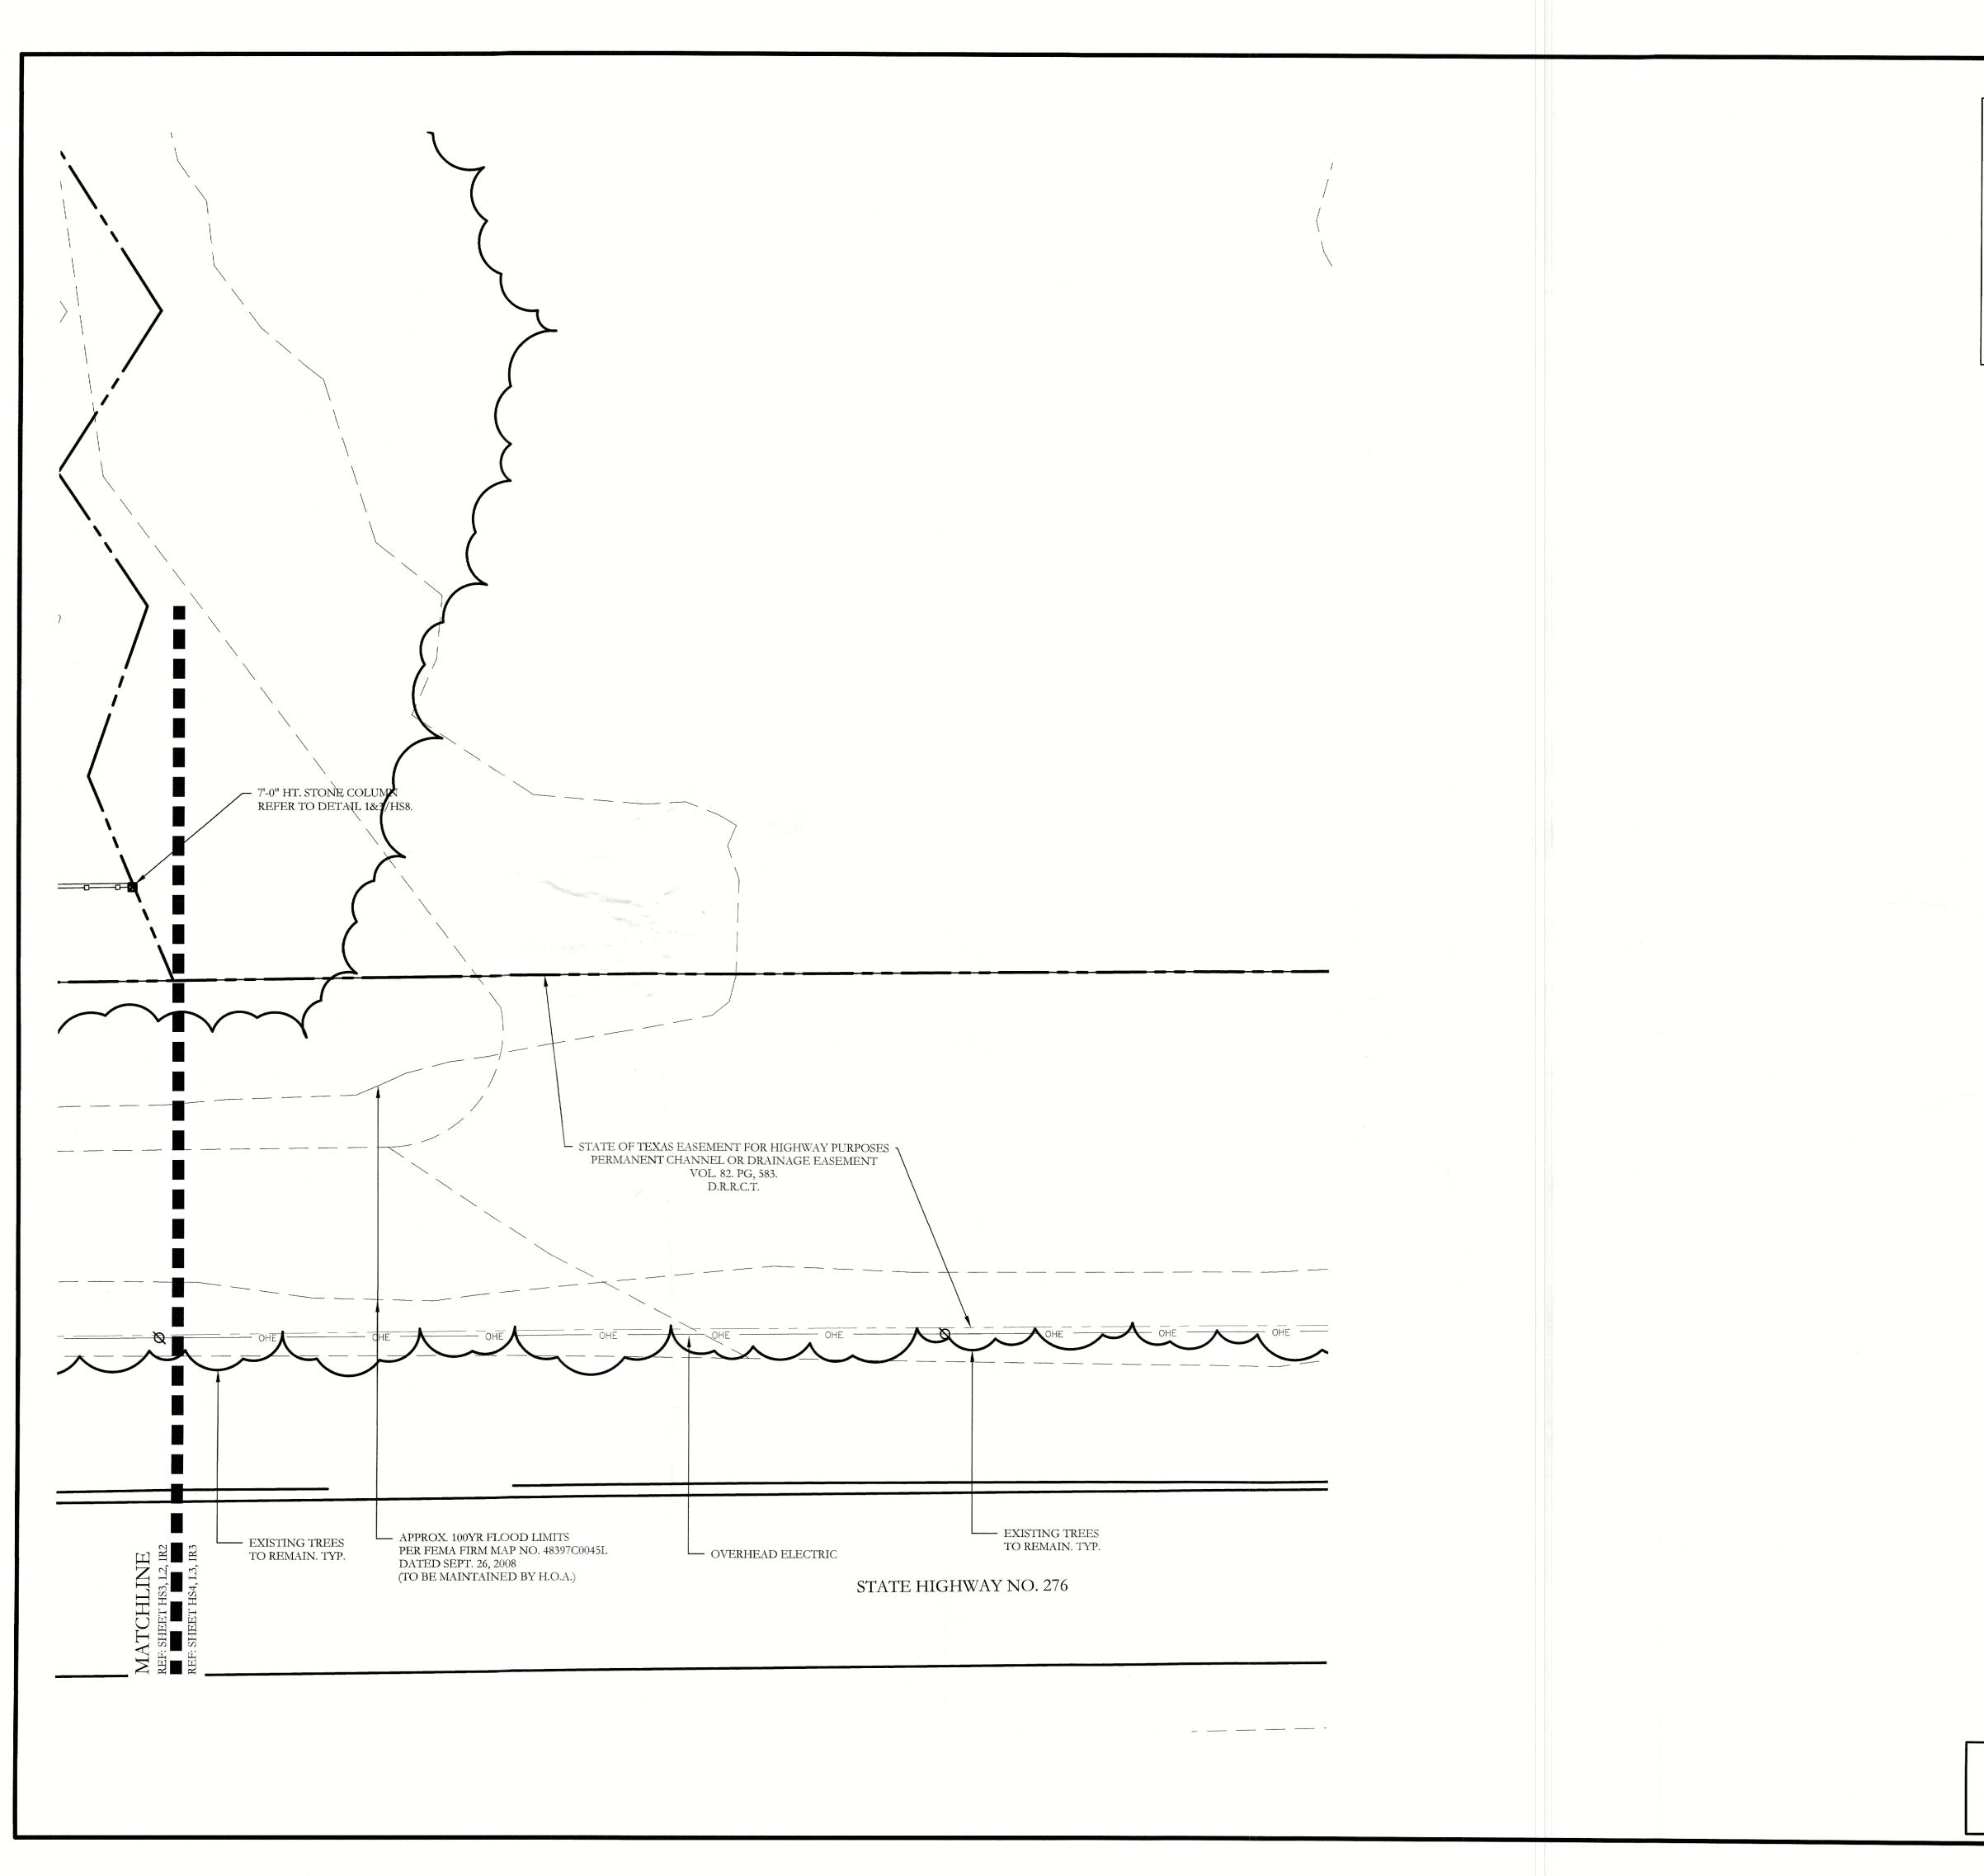

HARDSCAPE LEGEND

34'-7" HT. STONE ENTRY COLUMN. REFER TO DETAIL SHEET HS6.

6'-0" HT. LEUDERS BIG BLOCK STONE ENTRY WALL. REFER TO DETAIL 1&2/HS7.

7'-0" HT. STONE COLUMN. REFER TO DETAIL 3/HS8

6'-0" HT. ORNAMENTAL METAL FENCE. REFER TO DETAILS 1&2/HS8.

NOTE: REFER TO CIVIL PLANS FOR SIDEWALK AND BARRIER FREE RAMP ALIGNMENT AND DETAILS.



Scale: 1'' = 20'-0''

Bar is one inch on original drawing. If not one inch on this sheet, adjust scale as necessary.

One Inch


AND BUFFERINC SCREENING

CJS PROJECT NO. **DLL**001


SHEET NO. HS4 of 8

WITNESS OUR HANDS, this 7 day of Floray 2023.
Planning & Zoning Commission, Chairman

billictor of Planning and Zoning

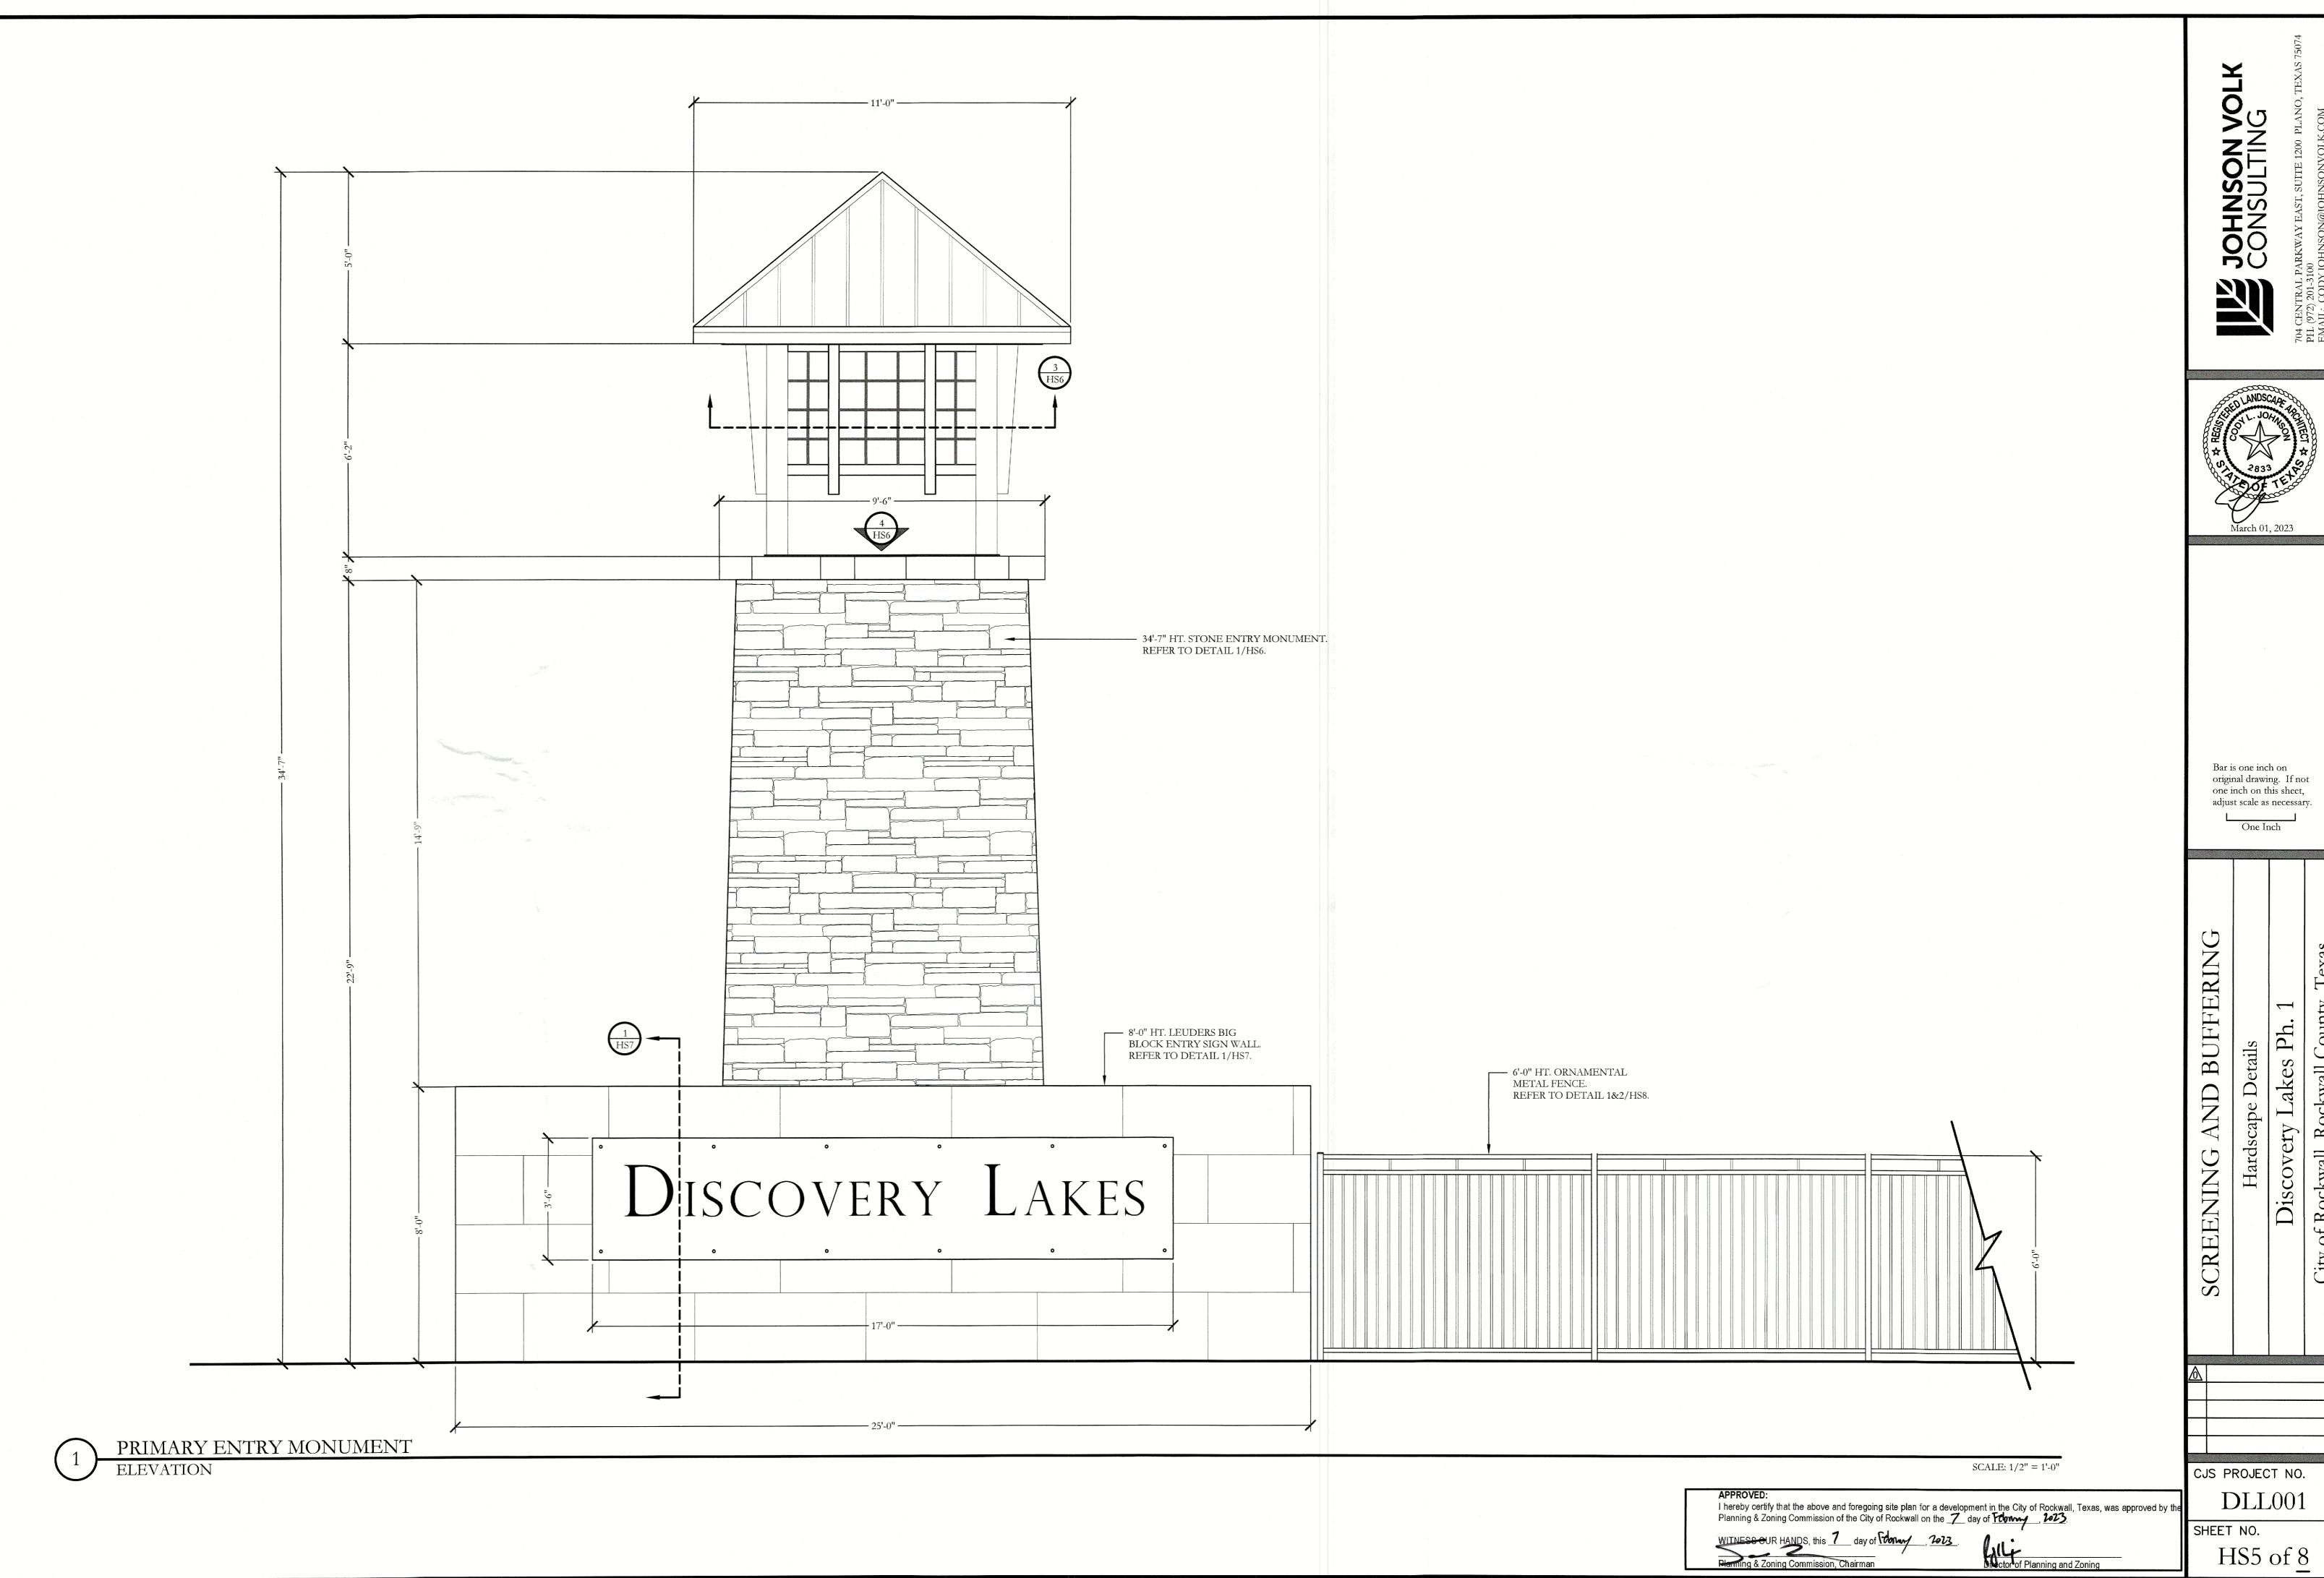

JOHNSON VOLK CONSULTING

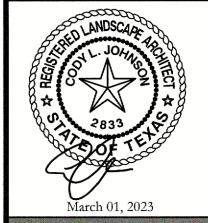



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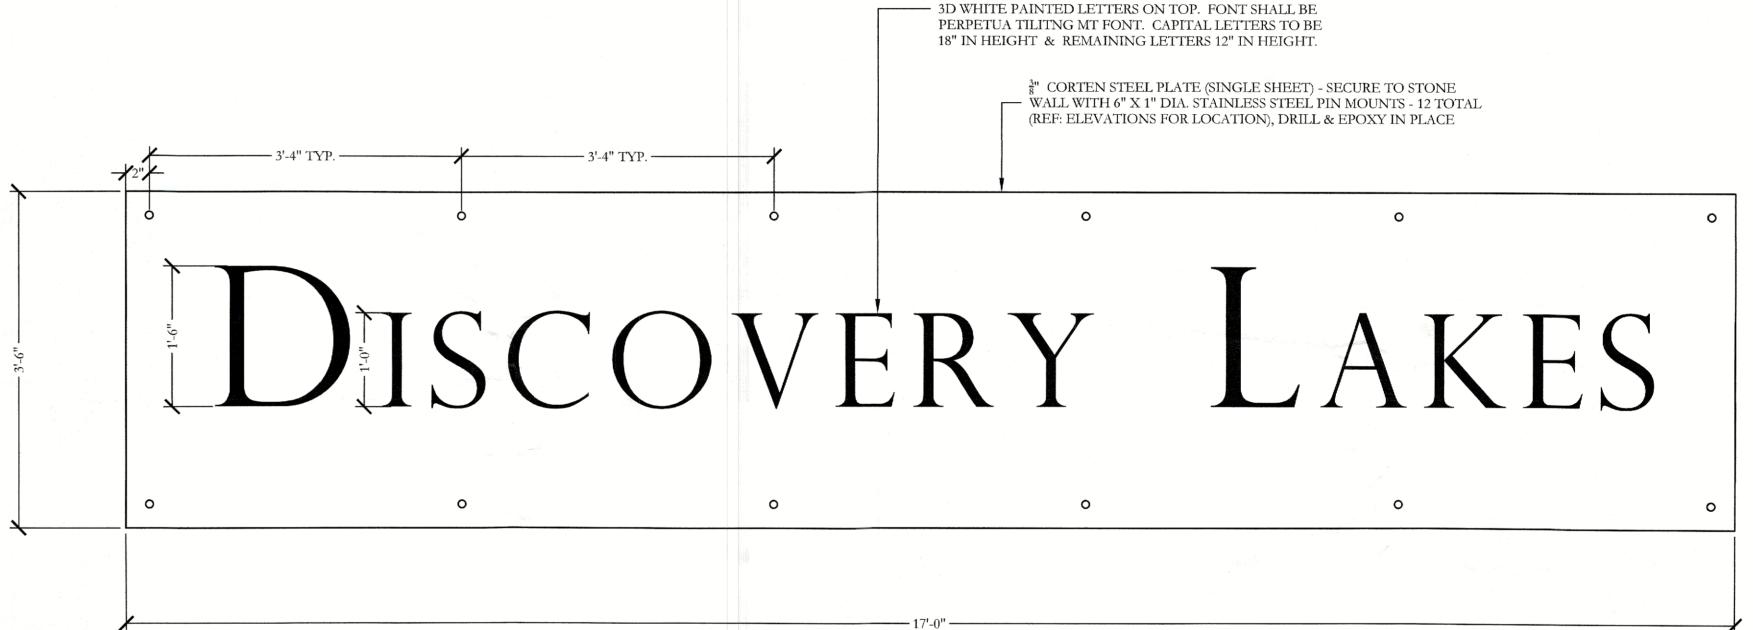
CJS PROJECT NO.

DLL001

SHEET NO.



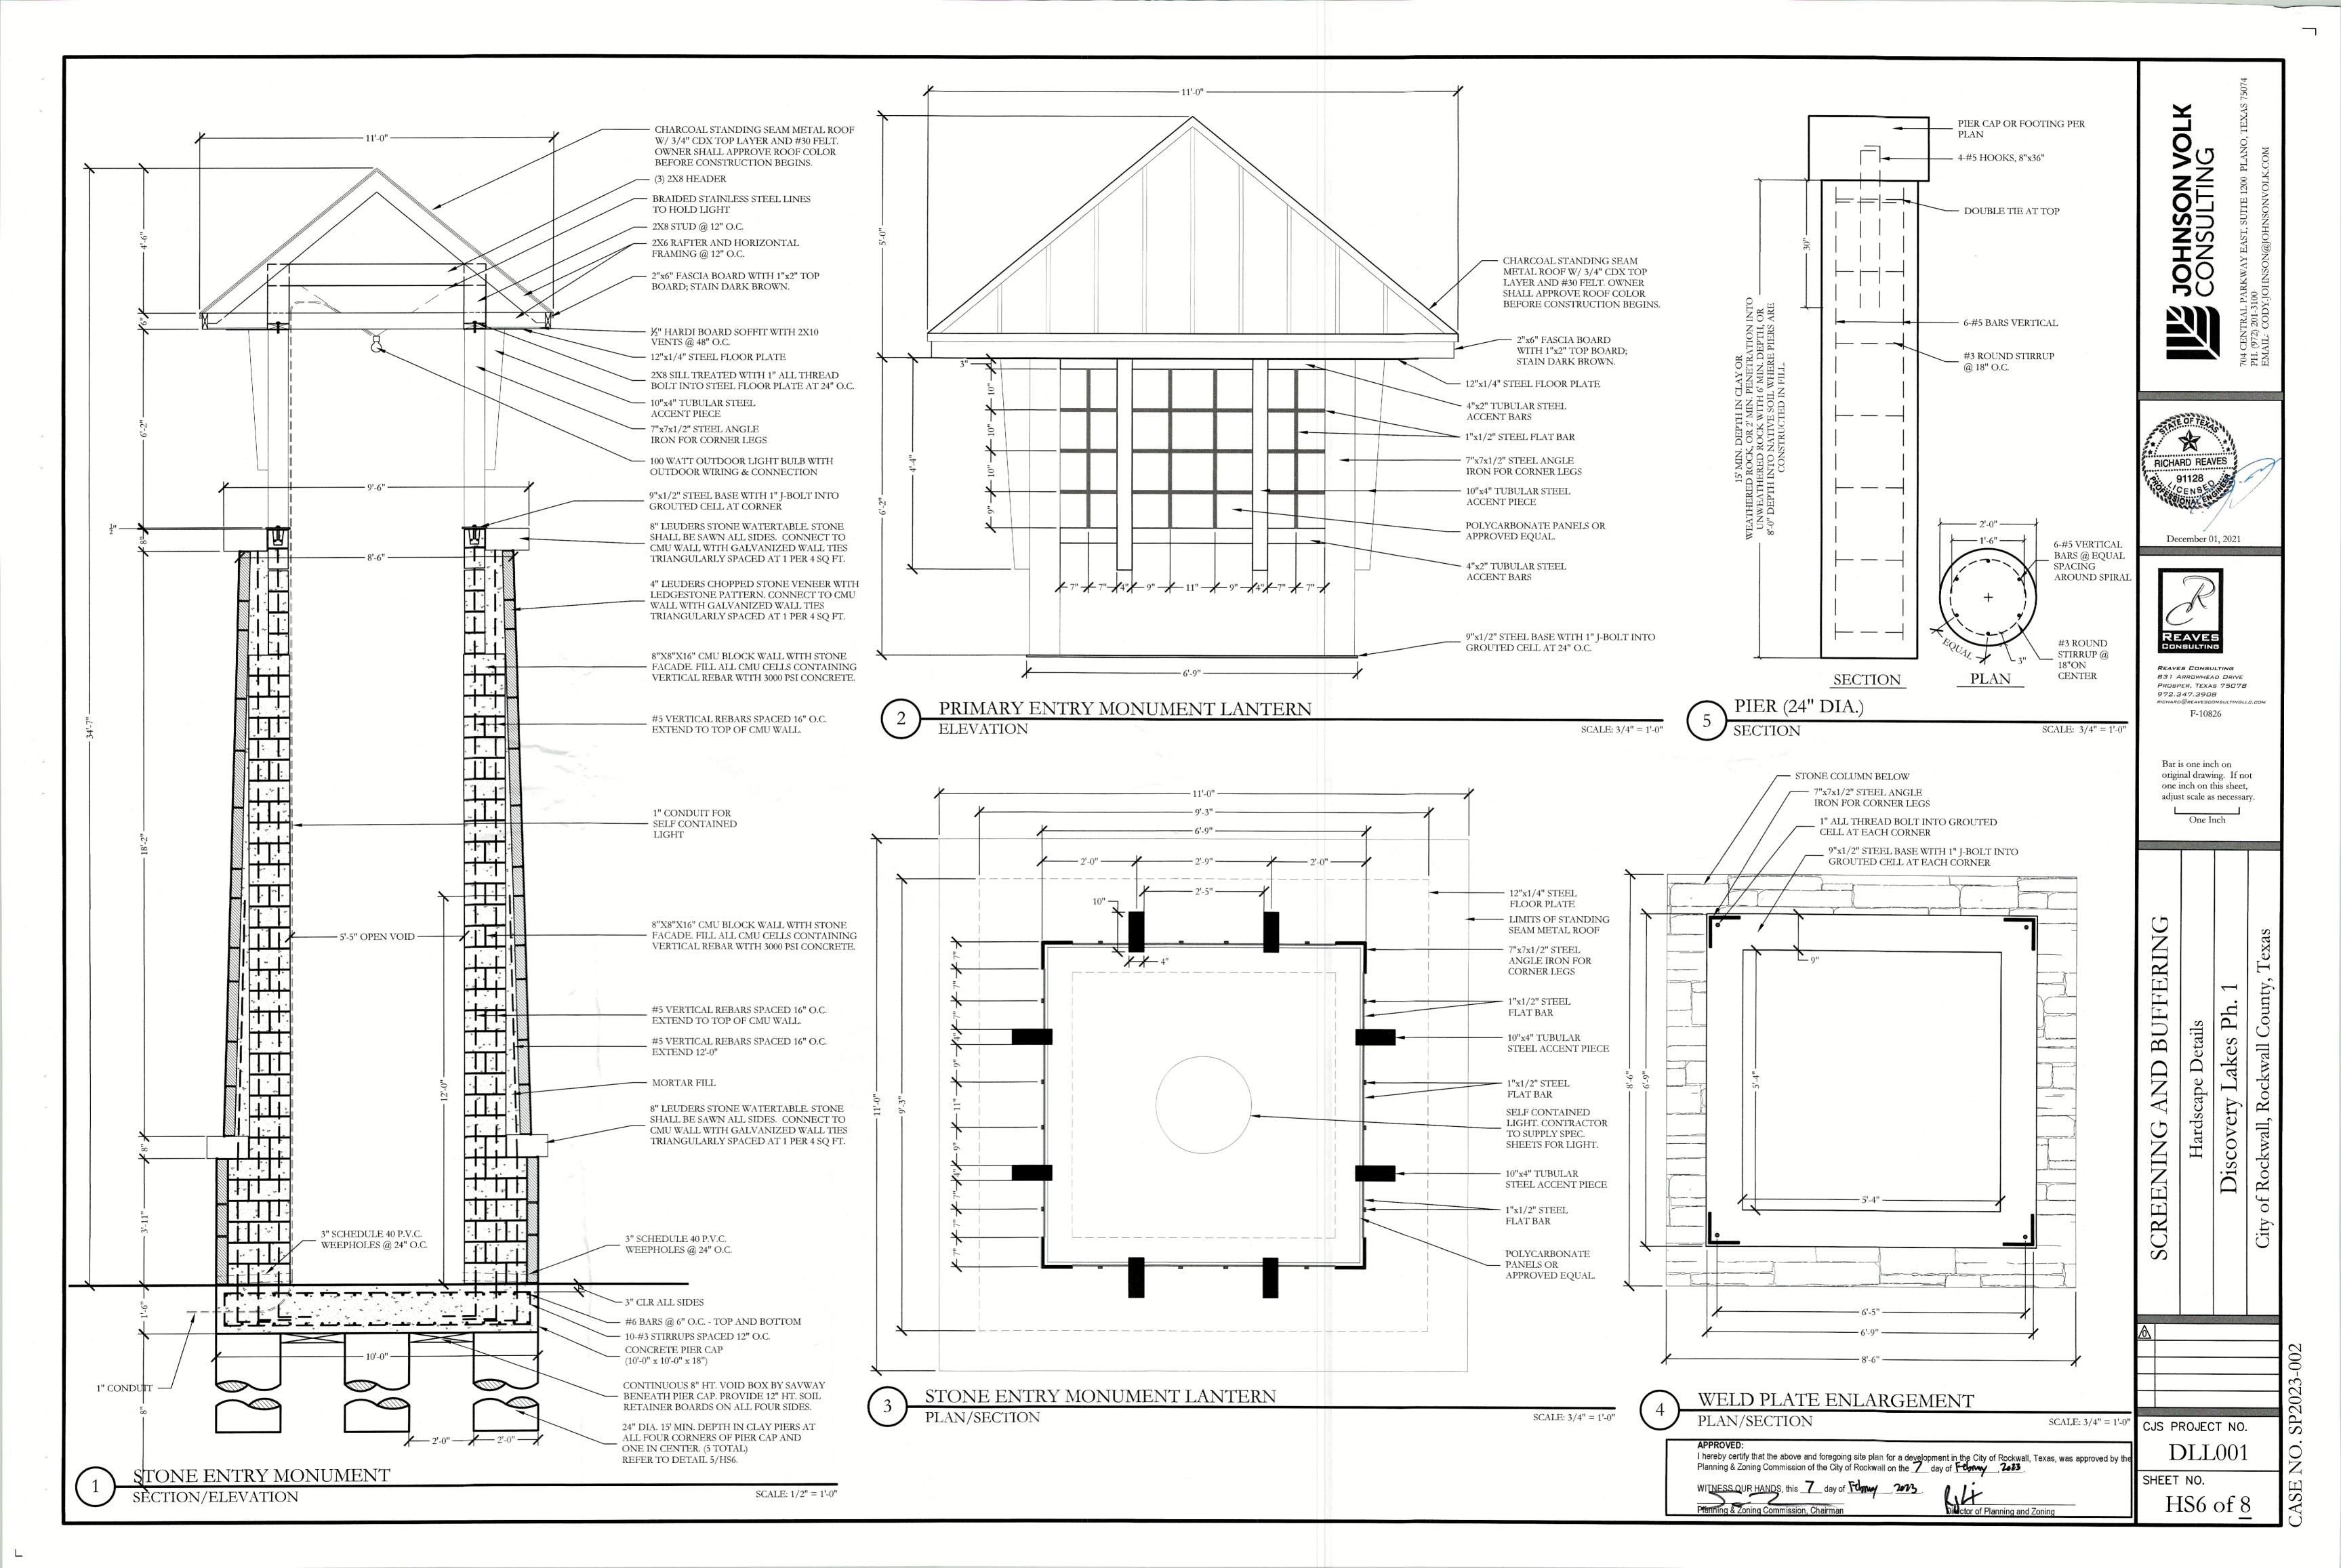

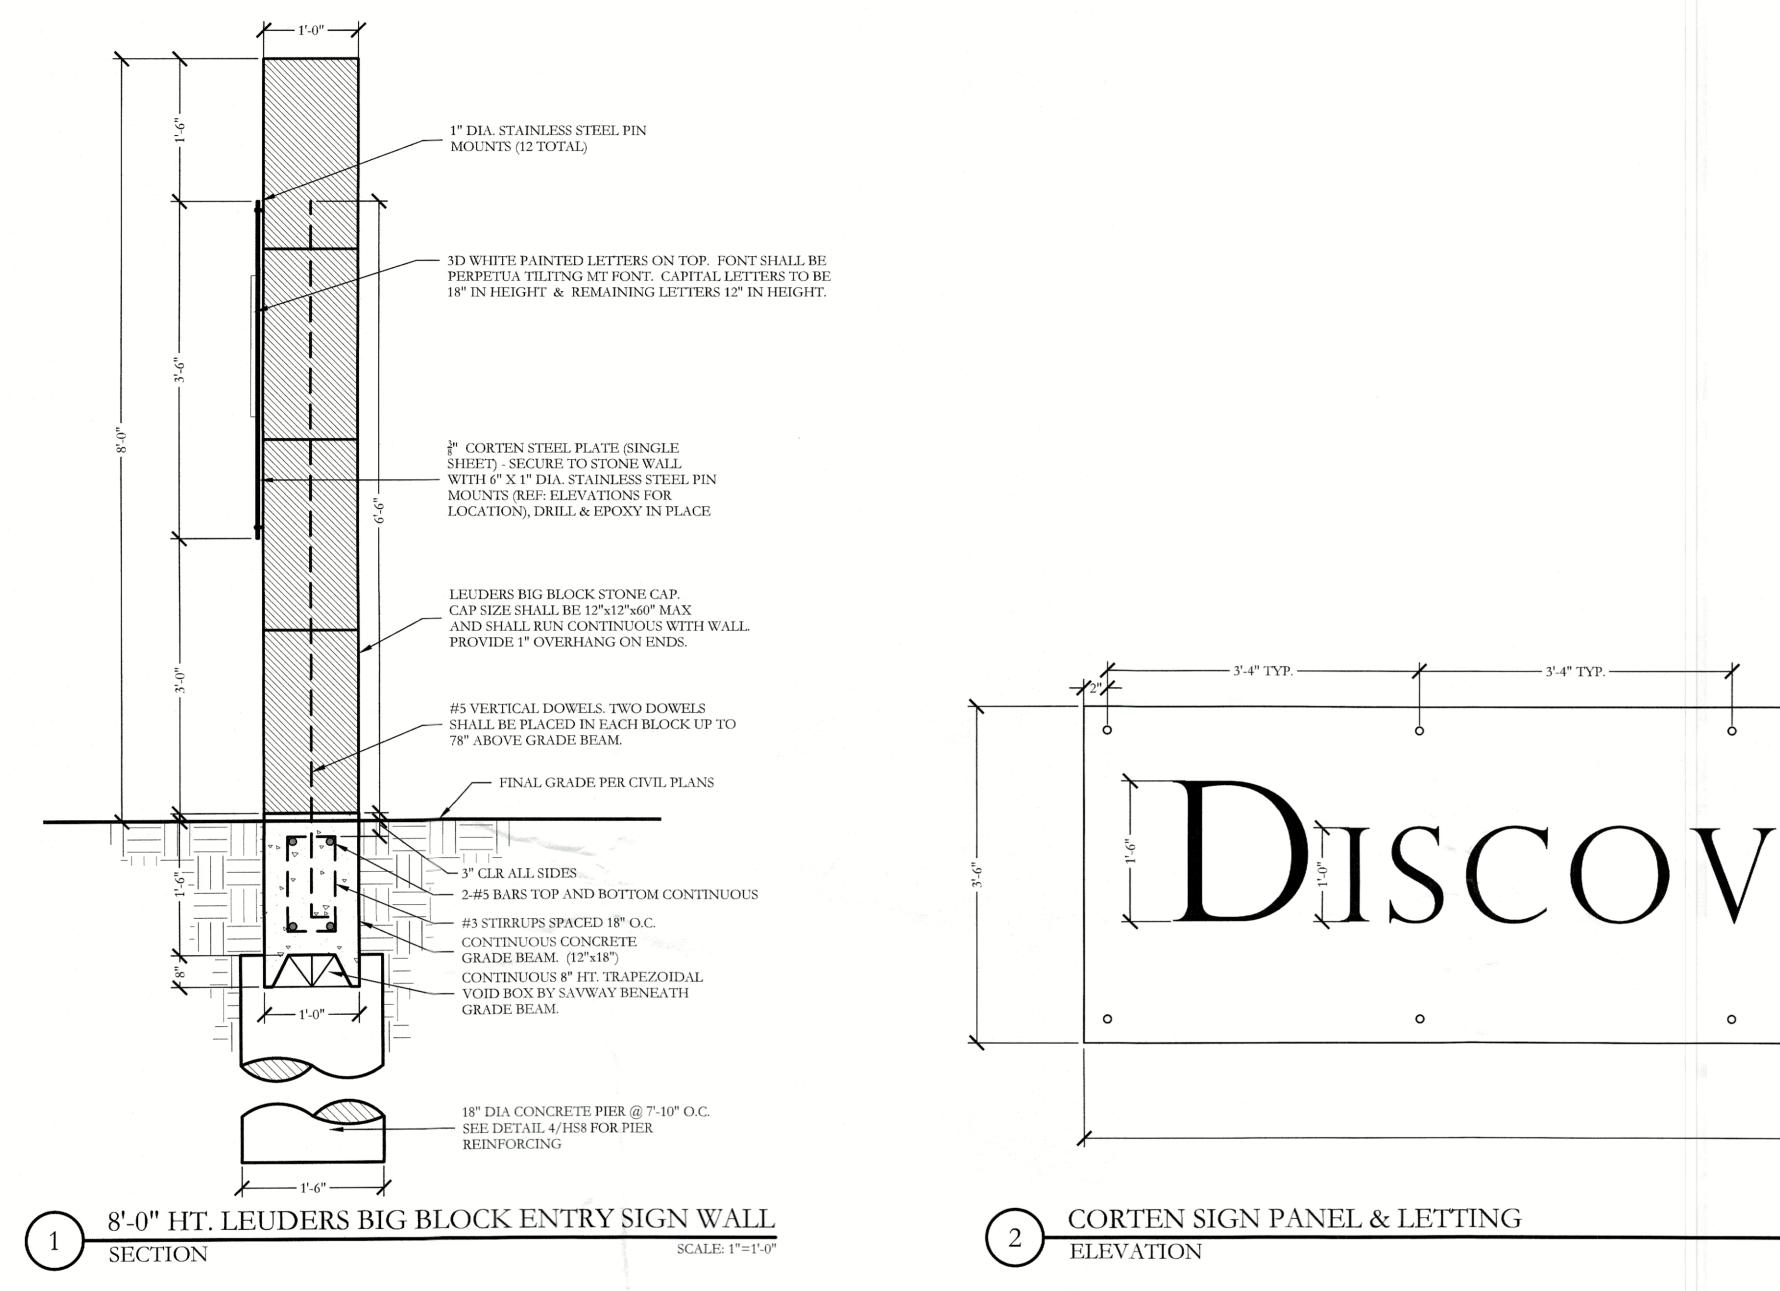

SCALE: 1"=1'-0"

JOHNSON VOLK
CONSULTING
CENTRAL PARKWAY EAST, SUITE 1200 PLANO, TEXAS 75074



December 01, 2021



REAVES CONSULTING

831 ARROWHEAD DRIVE

PROSPER, TEXAS 75078

972.347.3908

RICHARD@REAVESCONSULTINGLLC.COM

Bar is one inch on original drawing. If not one inch on this sheet, adjust scale as necessary.

One Inch

AND BUFFERIN

SCREENING

Jakes Ph. 1

Hardscape Details Discovery Lakes Pl

Hard

CJS PROJECT NO.

DLL001

SHEET NO. HS7 of 8

WITNESS OUR HANDS, this 7 day of Followy, 2013

Director of Planning and Zoning

6'-0" HT. ORNAMENTAL METAL FENCE AND COLUMN

3-2" FLAGSTONE SLABS TO ACT AS

8"X8"X16" CMU BLOCK WITH STONE

FACADE. FILL ALL CMU CELLS WITH

4" STONE VENEER AS SELECTED BY OWNER,

LEDGESTONE PATTERN. CONNECT TO CMU

COLUMN WITH GALVANIZED WALL TIES

TRIANGULARLY SPACED AT 1 PER 4 SQ FT.

2-2" FLAGSTONE SLABS TO ACT AS

2-#5 VERTICAL DOWELS EACH SIDE.

EXTEND TO TOP OF COLUMN.

PROVIDE 4 BARS TOTAL.

FINAL GRADE

CONCRETE PIER CAP

18" DIA. CONCRETE PIER IN CENTER OF PIER CAP. REFER TO DETAIL 4/HS8.

- 2-#5 BARS TOP AND BOTTOM

8" HT. DONUT FORM VOID BOX BY SAVWAY BENEATH PIER CAP WITH 12" HT. SOIL RETAINER BOARD.

· 3" CLR ALL SIDES

— 3-#3 STIRRUPS

(24"x24"x18")

WATERTABLE. PROVIDE 1" OVERHANG

3000 PSI CONCRETE.

COLUMN CAP. PROVIDE 1" OVERHANG

2" X 2" TUBULAR SQUARE STEEL POST W/ CAP, TYP. BEVEL TOP OF FOOTING SHALL BE CROWNED 1" ABOVE GRADE FINAL GRADE PER CIVIL PLANS 3,000 PSI CONCRETE FOOTING

TYPICAL METAL POST FOOTING

4-#5 VERTICAL @ 90Deg. SPACING AROUND SPIRAL #3 ROUND STIRRUP @ 18" ON CENTER

SCALE: 1/2"=1'-0"

PLAN/SECTION

GENERAL NOTES - HARDSCAPE CONSTRUCTION

1. ALL CONCRETE SHALL BE 3000 PSI, NORMAL WEIGHT, 28 DAY STRENGTH WITH A 4 TO 6 INCH SLUMP. THE CEMENT SHALL BE TYPE 1 AND SHALL CONFORM TO ASTM C150.

AGGREGATES SHALL CONFORM TO ASTM C33. 2. ALL MIXING, TRANSPORTING, PLACING, AND CURING OF CONCRETE SHALL COMPLY WITH

3. CONCRETE SHALL NOT BE PLACED IN RAINING OR FREEZING WEATHER.

4. CHLORIDES SHALL NOT BE USED.

5. MAXIMUM AGGREGATE SIZE = 1".

CONCRETE REINFORCING STEEL

 ALL REINFORCEMENT SHALL CONFORM TO ASTM A615 60 GRADE AND DEFORMED PER ASTM A305. PROVIDE 38 BAR DIAMETER LAP SPLICES FOR ALL CONTINUOUS BARS UNLESS NOTED OTHERWISE.

2. PROVIDE THE FOLLOWING MINIMUM COVER FOR CONCRETE CAST IN PLACE

2.1. CONCRETE CAST AGAINST EARTH AND PERMANENTLY EXPOSED TO EARTH: 3 INCHES CONCRETE EXPOSED TO EARTH OF WEATHER:

(A) BARS LARGER THAN NO. 5: 2 INCHES (B) BARS NO. 5 AND SMALLER: 1-1/2 INCHES

2.3. CONCRETE NOT EXPOSED TO EARTH OR WEATHER: SLABS, WALLS AND JOISTS

(A) BARS, LARGER THAN NO. 11: 1-1/2 INCHES (B) BARS NO. 11 AND SMALLER: 3/4 INCHES. BEAMS AND COLUMNS: 1-1/2 INCHES

SHELLS AND FOLDED PLATES

(A) BAR LARGER THAN NO. 5: 3/4 INCHES. (B) BARS NO. 5 AND SMALLER: 1/2 INCHES.

3. ALL REINFORCING STEEL SHALL BE CLEAN AND FREE OF GREASE.

2. PIER REINFORCING AND CONCRETE SHALL BE PLACED IMMEDIATELY OR TO WITHIN A

PIERS NOT SPECIFICALLY LOCATED ON THE PLAN SHALL BE CENTERED ON WALL OR

MAXIMUM OF 8 HOURS AFTER DRILLING IS COMPLETE. 3. STEEL CASING IS REQUIRED WHEN MORE THAN 2 INCHES OF STANDING WATER IS

PRESENT AT THE BOTTOM OF THE SHAFTS PRIOR TO PLACEMENT OF STEEL AND

4. PROVIDE 64 BAR DIAMETER LAP SPLICES IN ALL VERTICAL PIER REINFORCING AS

5. PROVIDE PIER TO GRADE BEAM DOWELS TO MATCH SIZE, QUANTITY, AND LOCATION OF LONGITUDINAL PIER REINFORCING. MIN DOWEL PROJECTION INTO PIER = 30 BAR DIA. MIN DOWEL PROJECTION INTO BEAM = TOP LONGITUDINAL GRADE BEAM REINFORCING. PROVIDE STANDARD HOOK AT TERMINAL END OF DOWEL IN GRADE BEAM.

STRUCTURAL CONCRETE MASONRY UNIT

1. CONCRETE MASONRY UNITS SHALL BE HOLLOW LOAD-BEARING TYPE N-1 CONFORMING TO ASTM C90 AND HAVE A MINIMUM COMPRESSIVE STRENGTH OF 1900 PSI.

2. CONCRETE MASONRY UNITS SHALL HAVE A MINIMUM PRISM STRENGTH OF 1500 PSI AT 28

3. MORTAR SHALL BE ASTM C270, TYPE S, WITH A MINIMUM COMPRESSIVE STRENGTH OF 1800

PSI IN ACCORDANCE WITH ASTM C780. MASONRY CEMENT IS PROHIBITED. 4. COARSE GROUT SHALL HAVE A MINIMUM COMPRESSIVE STRENGTH OF 2500 PSI AND A MAXIMUM AGGREGATE SIZE OF Z" IN ACCORDANCE WITH ASTM C476.REFER TO DETAILS

FOR WALL REINFORCING BAR SIZE AND SPACING. 5. REINFORCE HORIZONTAL JOINTS WITH GALVANIZED LADDER-TYPE STEEL IN

ACCORDANCE WITH ANSI/ASTM A82. SIDE AND CROSS RODS SHALL BE 9 GA MINIMUM. 6. HORIZONTAL REINFORCEMENT SHALL BE SPACED AT 16" MAXIMUM. PROVIDE A 16" LAP

7. JOINT REINFORCING SHALL BE DISCONTINUOUS AT CONTROL AND EXPANSION JOINTS.

8. LAP VERITCAL REINFORCING BARS AT 72 BAR DIAMETERS.

9. LAP HORIZONTAL REINFORCING BARS AT 48 BAR DIAMETERS. 10. PLACE GROUT USING LOW-LIFT METHOD, 6'-8" MAXIMUM LIFTS.

ORNAMENTAL METAL FENCE NOTES

1. THE CONTRACTOR IS RESPONSIBLE FOR MAKING HIMSELF FAMILIAR WITH ALL UNDERGROUND UTILITIES, PIPES, AND STRUCTURES EITHER SHOWN OR NOT SHOWN ON THE PLANS. THE CONTRACTOR WILL BE RESPONSIBLE FOR ANY COST INCURRED DUE TO DAMAGE OR REPLACEMENT OF SAID UTILITIES AND STRUCTURES CAUSED BY

2. ALL CONCRETE USED IN FOOTING AND PIERS SHALL HAVE A MINIMUM COMPRESSIVE STRENGTH OF 3000 PSI @ 28 DAYS.

3. THE CONTRACTOR IS RESPONSIBLE FOR ALL REQUIRED PERMITS AND CITY

4. ALL ORNAMENTAL METAL TUBES, POSTS, RAILS AND PICKETS SHALL BE FLUSH AND FREE OF ALL DENTS, SPURS, AND SHARP EDGES AND SHALL BE INSTALLED LEVEL,

PLUMB, AND SQUARE. PROVIDE CONTINUOUS WELDS ALONG ALL EDGES OF FENCE MEMBERS.

GRIND SMOOTH ALL WELDS.

ALL METAL SURFACES SHALL BE PRIMED AND PAINTED WITH TWO COATS OF RUSTPROOF PAINT, COLOR TO BE FLAT BLACK. CONTRACTOR TO SUBMIT SAMPLES AS

8. CONTRACTOR IS RESPONSIBLE FOR VERIFYING ALL DIMENSIONS BEFORE MANUFACTURING GATES AND FENCE. GATE LOCKING MECHANISM SHALL BE

SELECTED BY OWNER. 9. ALL ORNAMENTAL METAL FENCE MEMBERS ARE TO BE TUBULAR MEMBERS IN

ACCORDANCE WITH ASTM 513 HOT ROLLED STRUCTURAL STEEL 50,000 PSI TENSILE STRENGTH, 60,000 PSI YIELD STRENGTH.

10. FENCE MEMBER SIZES TO BE AS FOLLOWS: 10.1. PICKETS, 3/4" SQUARE 16 GA.


10.2. RAILS, 1-1/2" X 1/2" SQUARE 16 GA 10.3. POSTS, 2" SQUARE 11 GA.

11. CONCRETE FOOTING FOR POSTS SHALL BE A MINIMUM OF 3X POST WIDTH. 12. POSTS SHALL BE PLACED AT A MINIMUM DISTANCE OF 6'-0" O.C AND A MAXIMUM

DISTANCE OF 8'-0" O.C. 13. FENCE SHALL MEET LOCAL CODES AND REQUIREMENTS. CONTRACTOR SHALL BE

RESPONSIBLE FOR ENSURING COMPLIANCE INCLUDING NECESSARY UPSIZING OF POSTS, PICKETS AND HORIZONTAL BARS AND INCREASING THE HEIGHT OF THE FENCE AS IT APPEARS IN THIS DETAIL AT NO ADDITIONAL COST TO THE OWNER FOR MATERIALS AND/OR LABOR.

Orector of Planning and Zoning

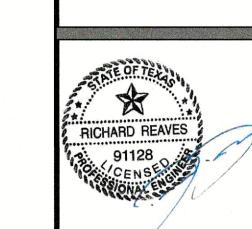

December 01, 2021



REAVES CONSULTING 831 ARROWHEAD DRIVE PROSPER, TEXAS 75078 972.347.3908

F-10826

Bar is one inch on original drawing. If not one inch on this sheet, adjust scale as necessary.

One Inch

CREEN


CJS PROJECT NO.

SHEET NO.

HS8 of 8


7'-0" HT. STONE COLUMN


SCALE: 3/4"=1'-0"

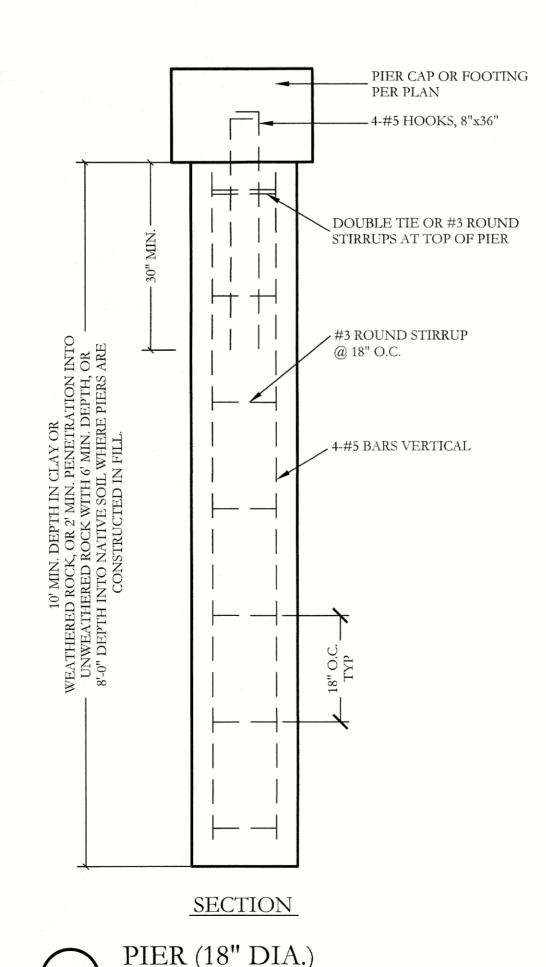



PIER (18" DIA.)

SCALE: 3/4'' = 1'-0''

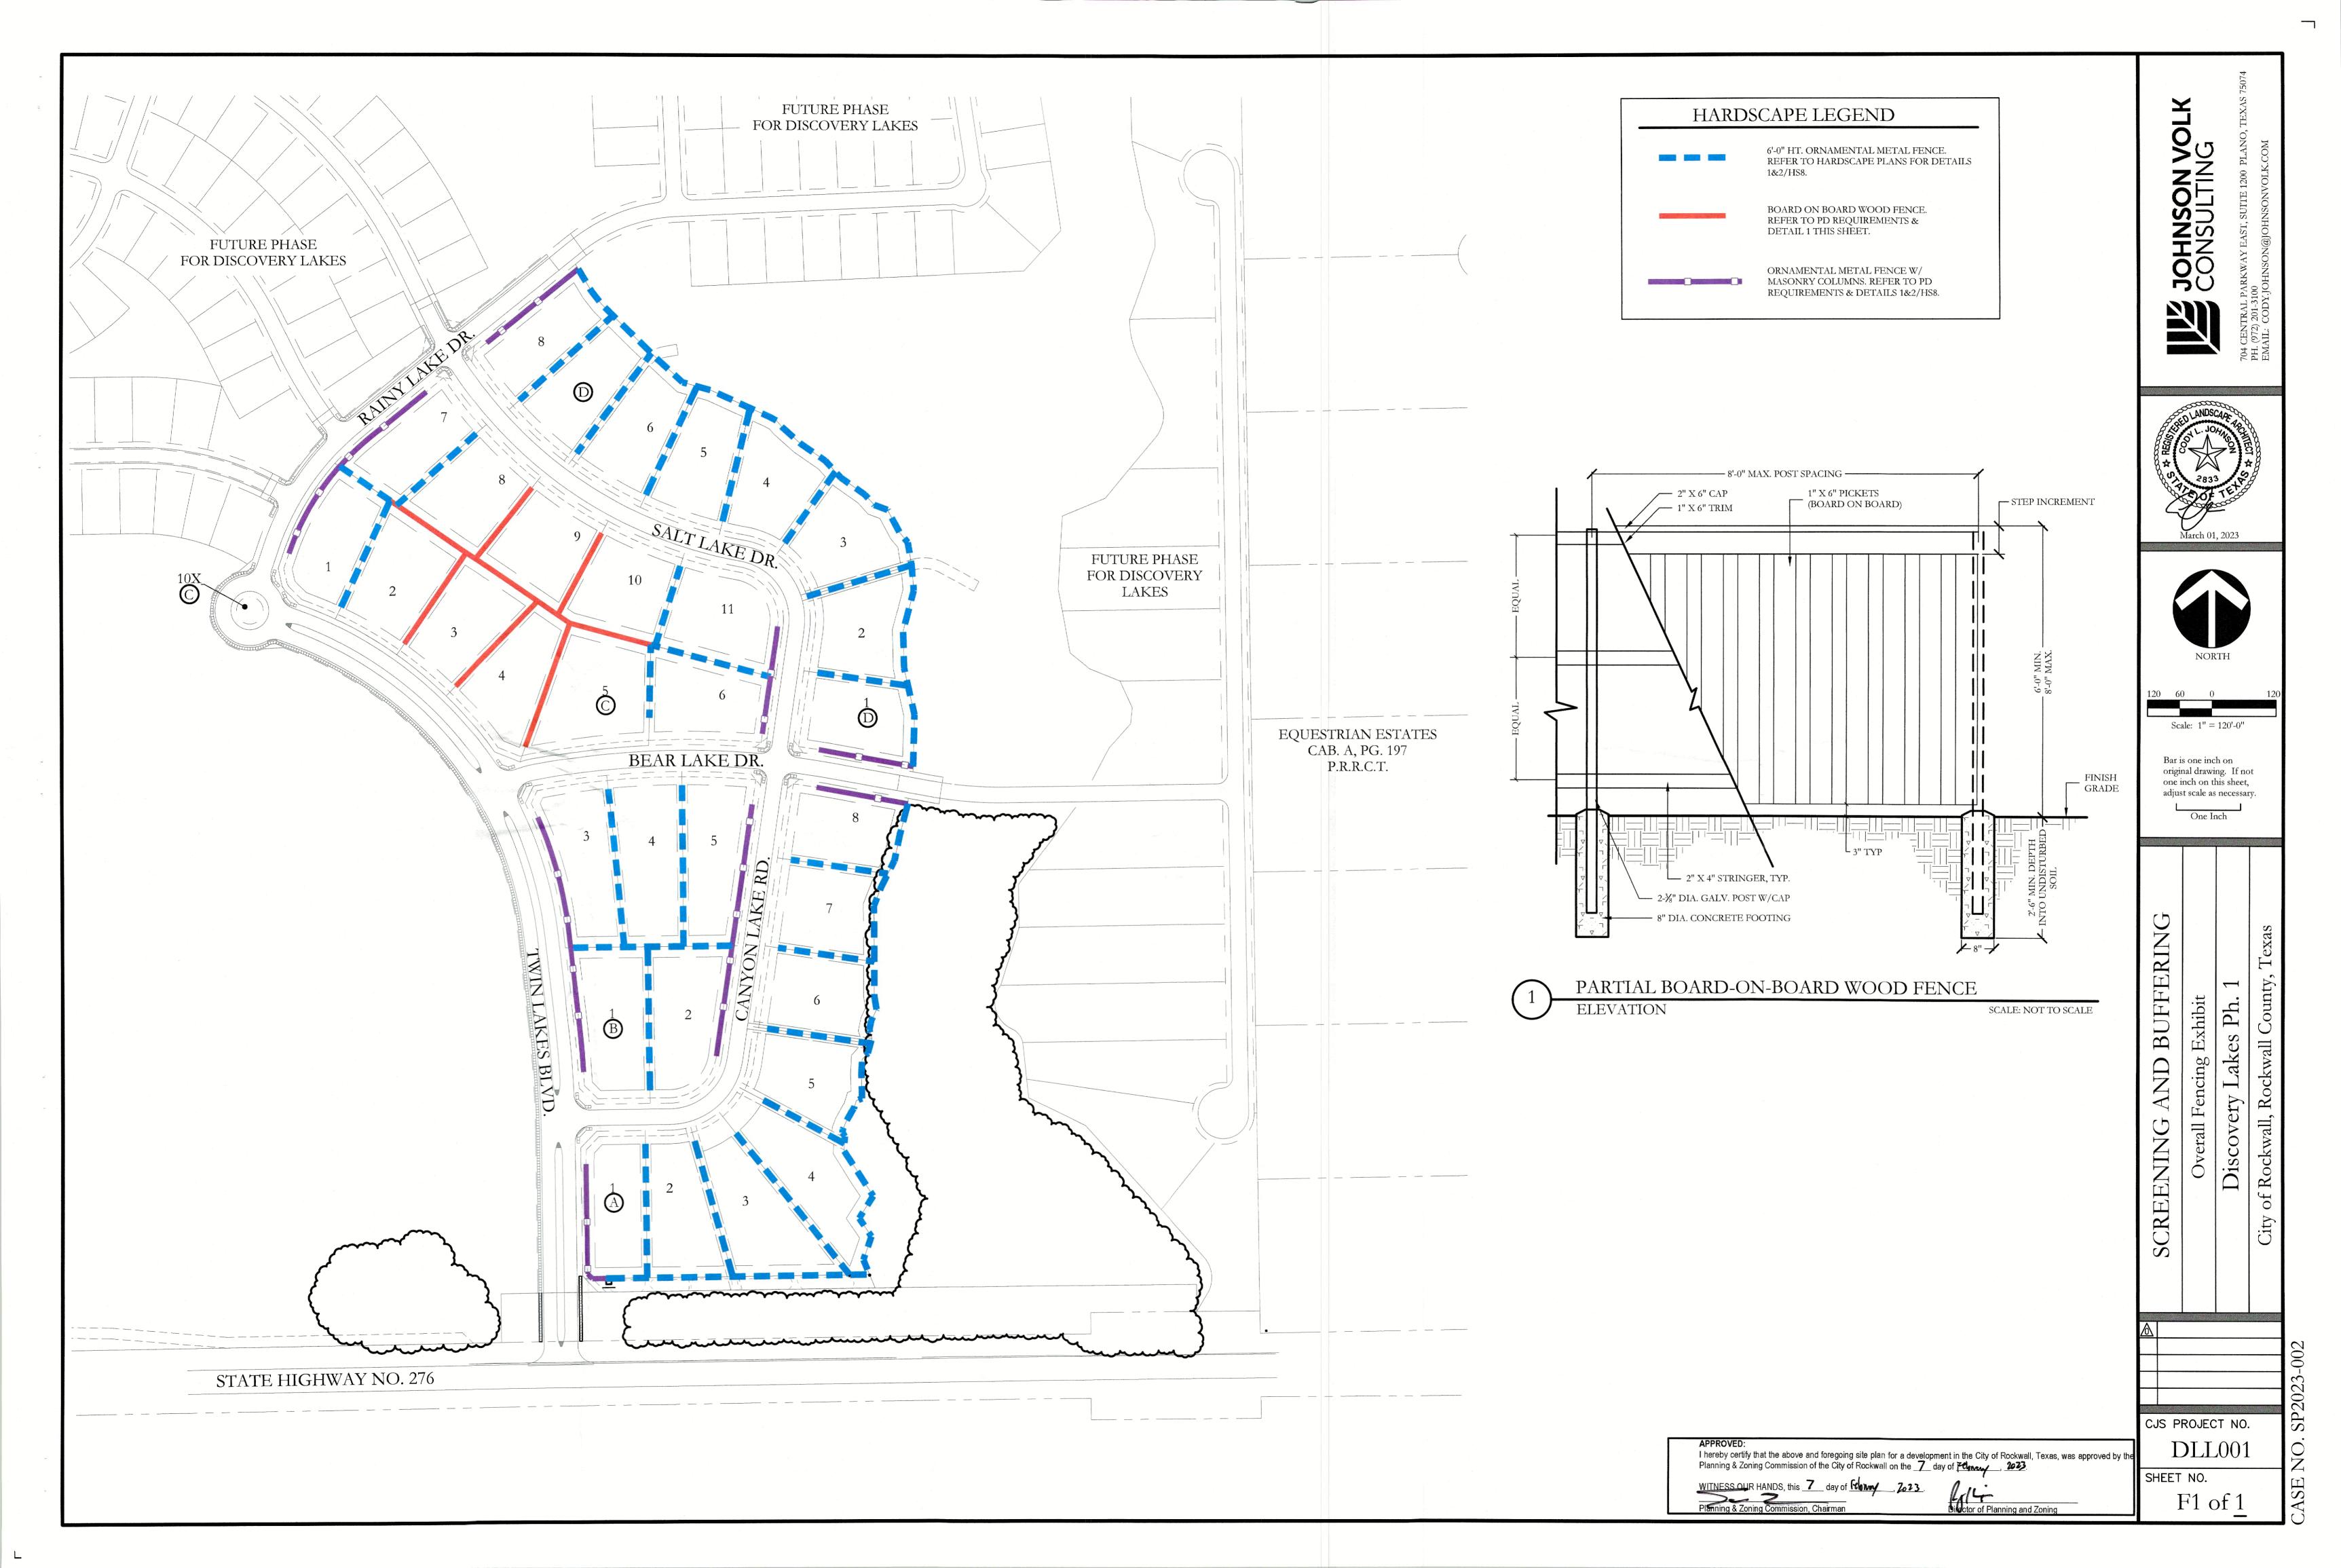

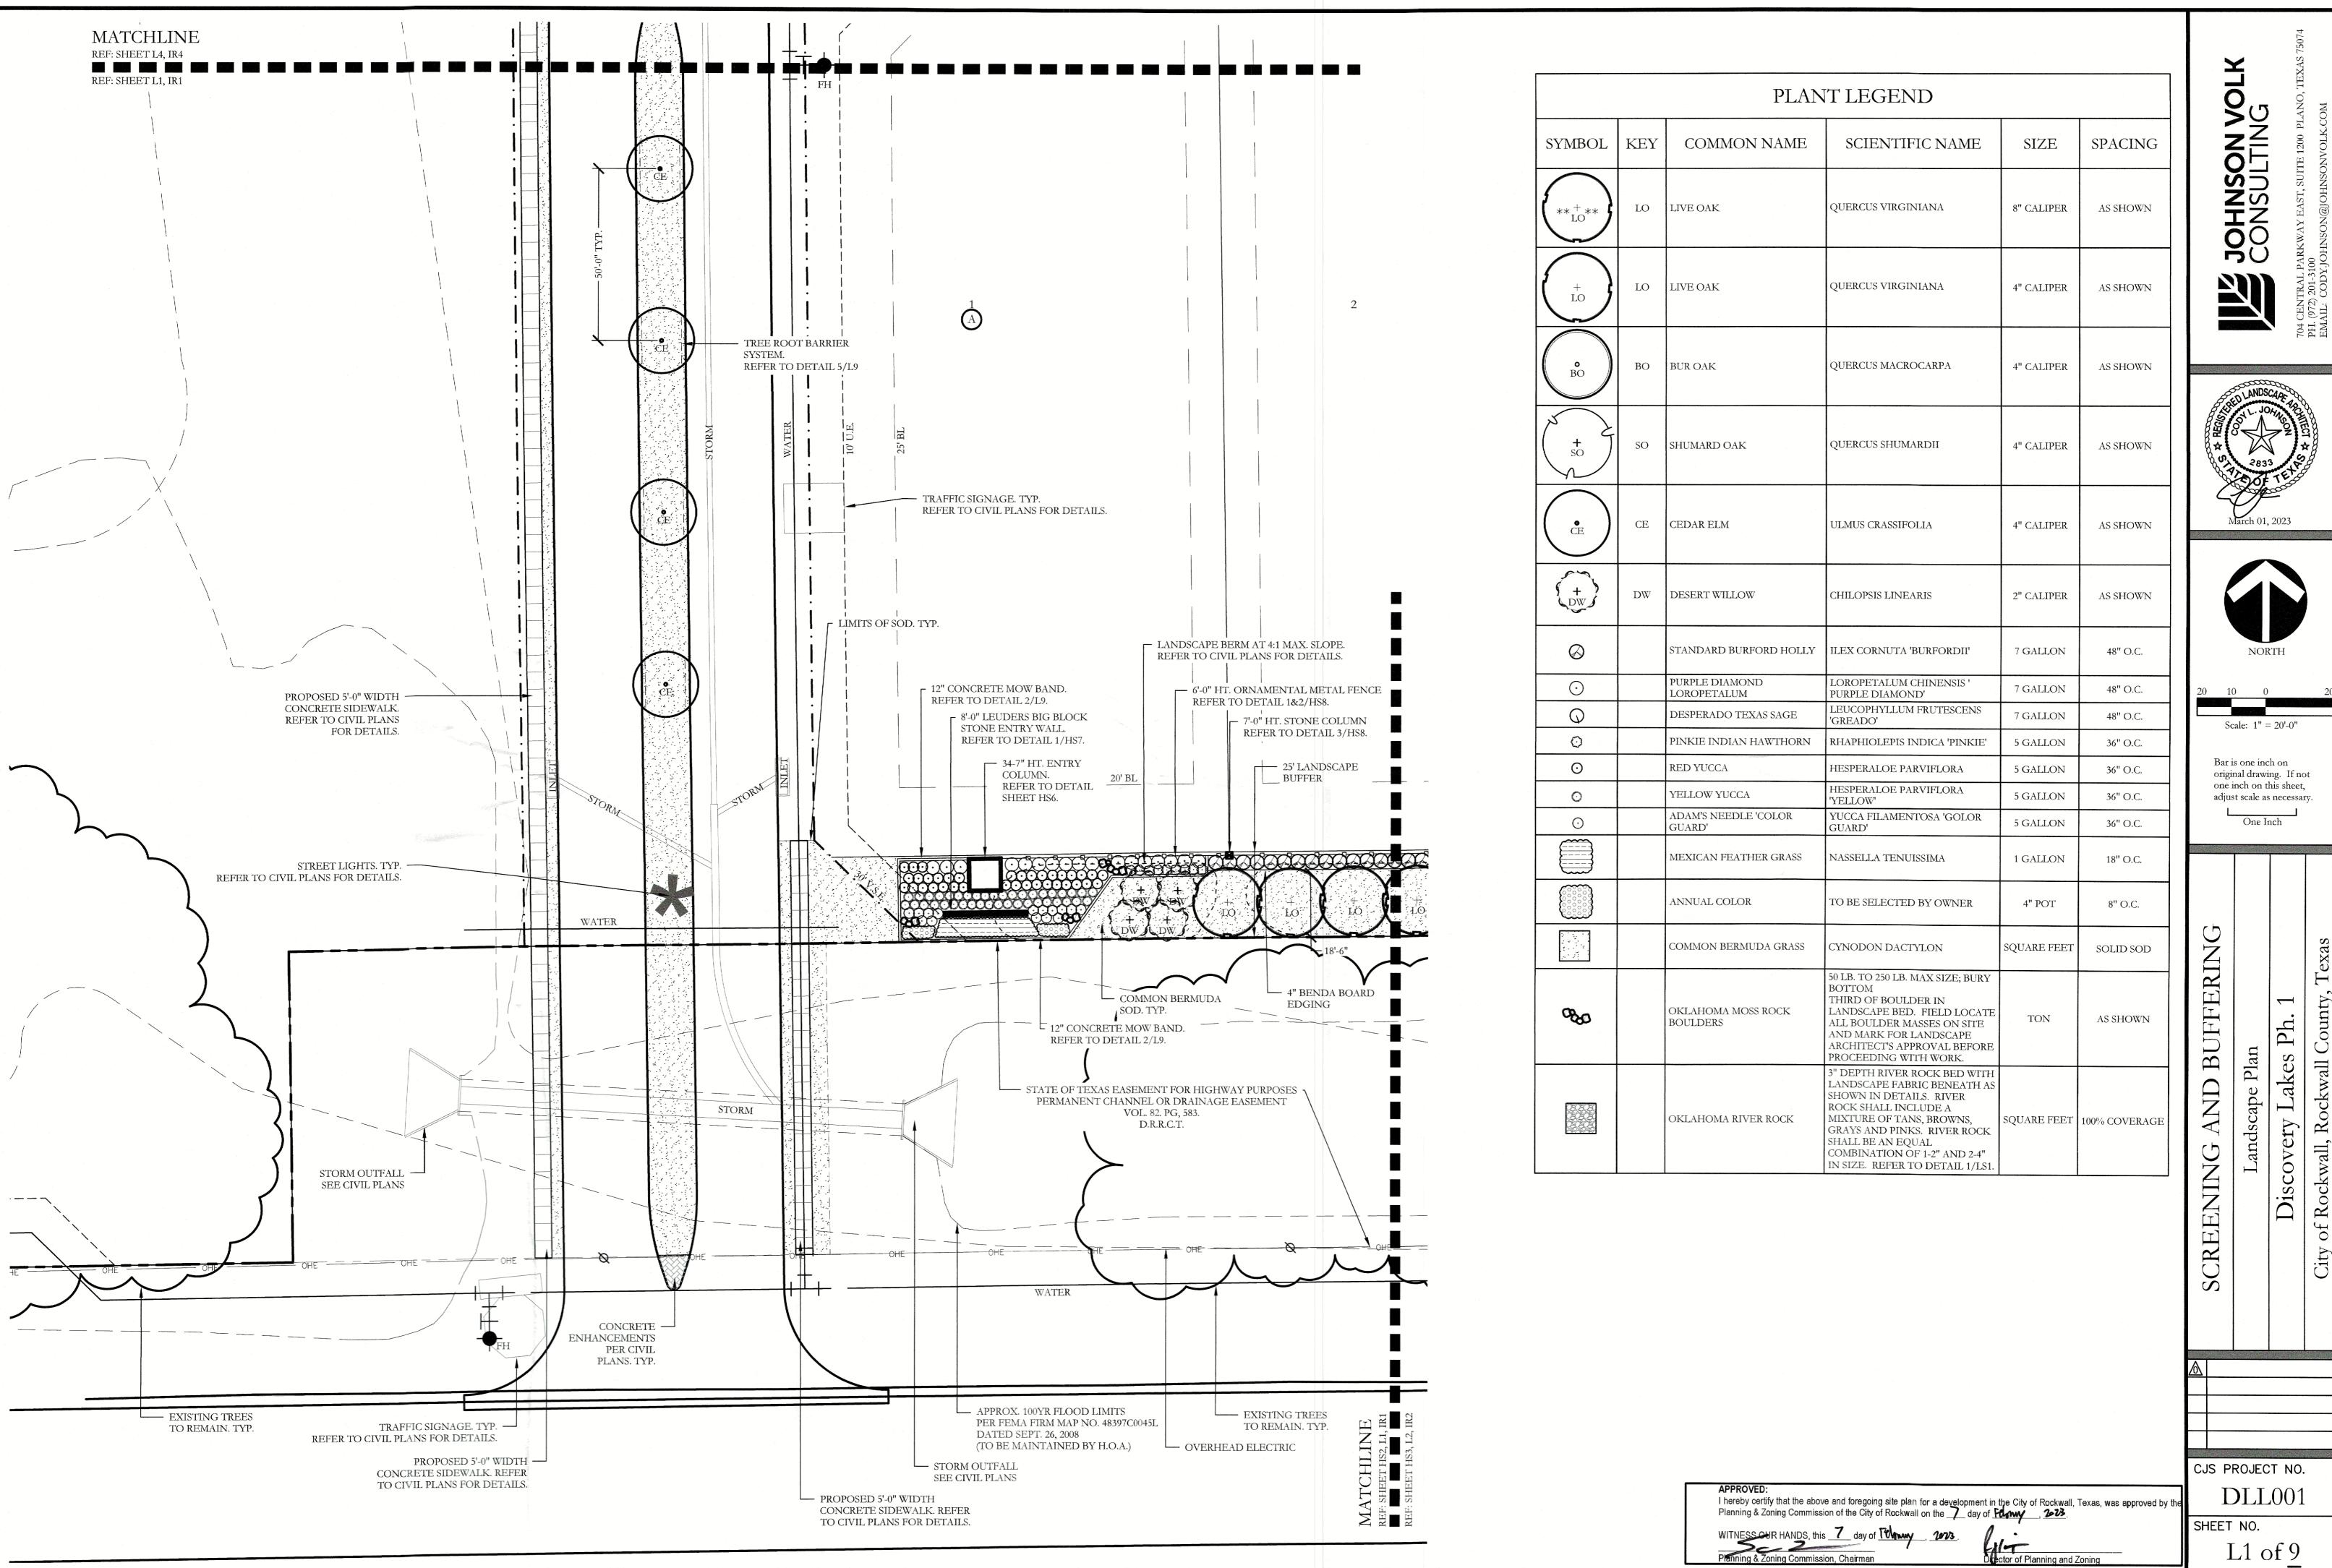

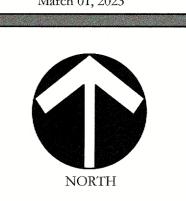

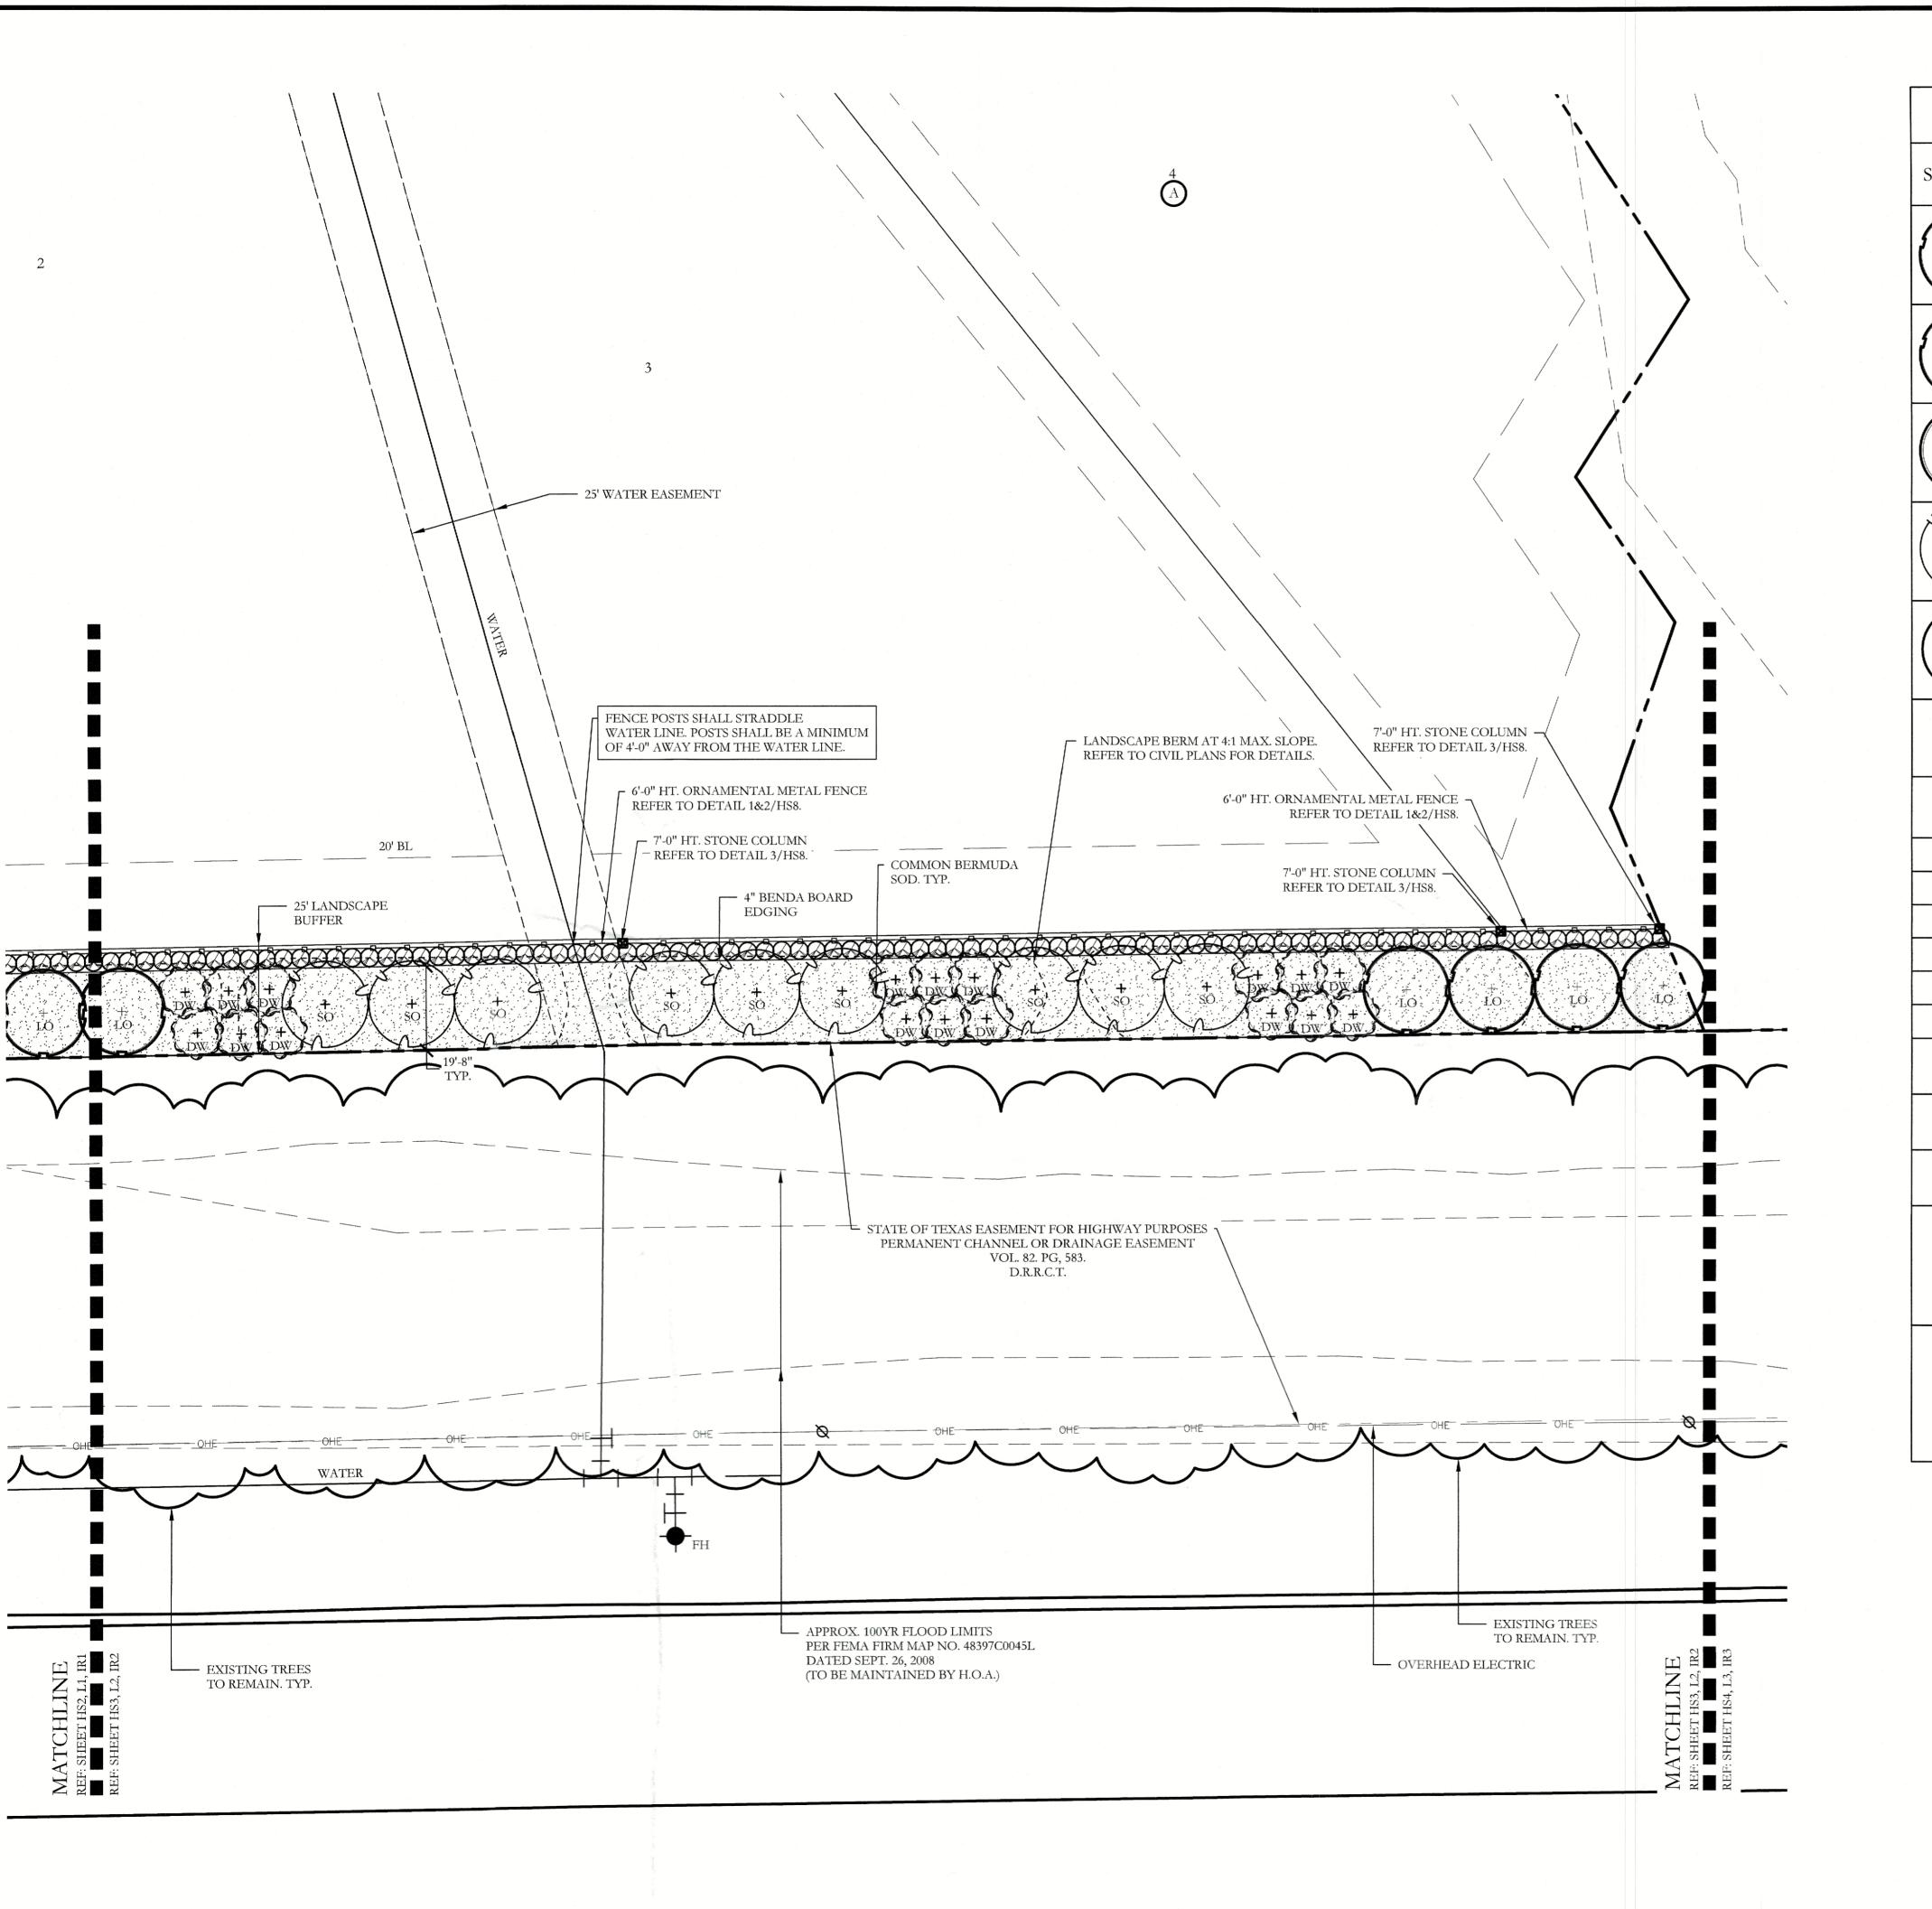

PLANT LEGEND										
SYMBOL	KEY	COMMON NAME	SCIENTIFIC NAME	SIZE	SPACING					
******	LO	LIVE OAK	QUERCUS VIRGINIANA	8" CALIPER	AS SHOWN					
(LO)	LO	LIVE OAK	QUERCUS VIRGINIANA	4" CALIPER	AS SHOWN					
© BO	ВО	BUR OAK	QUERCUS MACROCARPA	4" CALIPER	AS SHOWN					
* SO	SO	SHUMARD OAK	QUERCUS SHUMARDII	4" CALIPER	AS SHOWN					
CE CE	CE	CEDAR ELM	ULMUS CRASSIFOLIA	4" CALIPER	AS SHOWN					
(+)	DW	DESERT WILLOW	CHILOPSIS LINEARIS	2" CALIPER	AS SHOWN					
Ø		STANDARD BURFORD HOLLY	ILEX CORNUTA 'BURFORDII'	7 GALLON	48" O.C.					
\odot		PURPLE DIAMOND LOROPETALUM	LOROPETALUM CHINENSIS ' PURPLE DIAMOND'	7 GALLON	48" O.C.					
Q		DESPERADO TEXAS SAGE	LEUCOPHYLLUM FRUTESCENS 'GREADO'	7 GALLON	48" O.C.					
0		PINKIE INDIAN HAWTHORN	RHAPHIOLEPIS INDICA 'PINKIE'	5 GALLON	36" O.C.					
0		RED YUCCA	HESPERALOE PARVIFLORA	5 GALLON	36" O.C.					
0		YELLOW YUCCA ADAM'S NEEDLE 'COLOR	HESPERALOE PARVIFLORA 'YELLOW' VUCCA FILAMENTOS A 'COLOR	5 GALLON	36" O.C.					
<u></u>		GUARD'	YUCCA FILAMENTOSA 'GOLOR GUARD'	5 GALLON	36" O.C.					
		MEXICAN FEATHER GRASS	NASSELLA TENUISSIMA	1 GALLON	18" O.C.					
(00000) (000000)		ANNUAL COLOR	TO BE SELECTED BY OWNER	4" POT	8" O.C.					
		COMMON BERMUDA GRASS	CYNODON DACTYLON	SQUARE FEET	SOLID SOD					
%		OKLAHOMA MOSS ROCK BOULDERS	50 LB. TO 250 LB. MAX SIZE; BURY BOTTOM THIRD OF BOULDER IN LANDSCAPE BED. FIELD LOCATE ALL BOULDER MASSES ON SITE AND MARK FOR LANDSCAPE ARCHITECT'S APPROVAL BEFORE PROCEEDING WITH WORK.	TON	AS SHOWN					
		OKLAHOMA RIVER ROCK	3" DEPTH RIVER ROCK BED WITH LANDSCAPE FABRIC BENEATH AS SHOWN IN DETAILS. RIVER ROCK SHALL INCLUDE A MIXTURE OF TANS, BROWNS, GRAYS AND PINKS. RIVER ROCK SHALL BE AN EQUAL COMBINATION OF 1-2" AND 2-4" IN SIZE. REFER TO DETAIL 1/LS1.	SQUARE FEET	100% COVERAGE					

SCREENING AND BUFFERING
Landscape Plan
Discovery Lakes Ph. 1
City of Rockwall, Rockwall County, Texas

Scale: 1'' = 20'-0''

Bar is one inch on original drawing. If not one inch on this sheet, adjust scale as necessary.


Director of Planning and Zoning

CJS PROJECT NO.

DLL001

SHEET NO.

L2 of 9

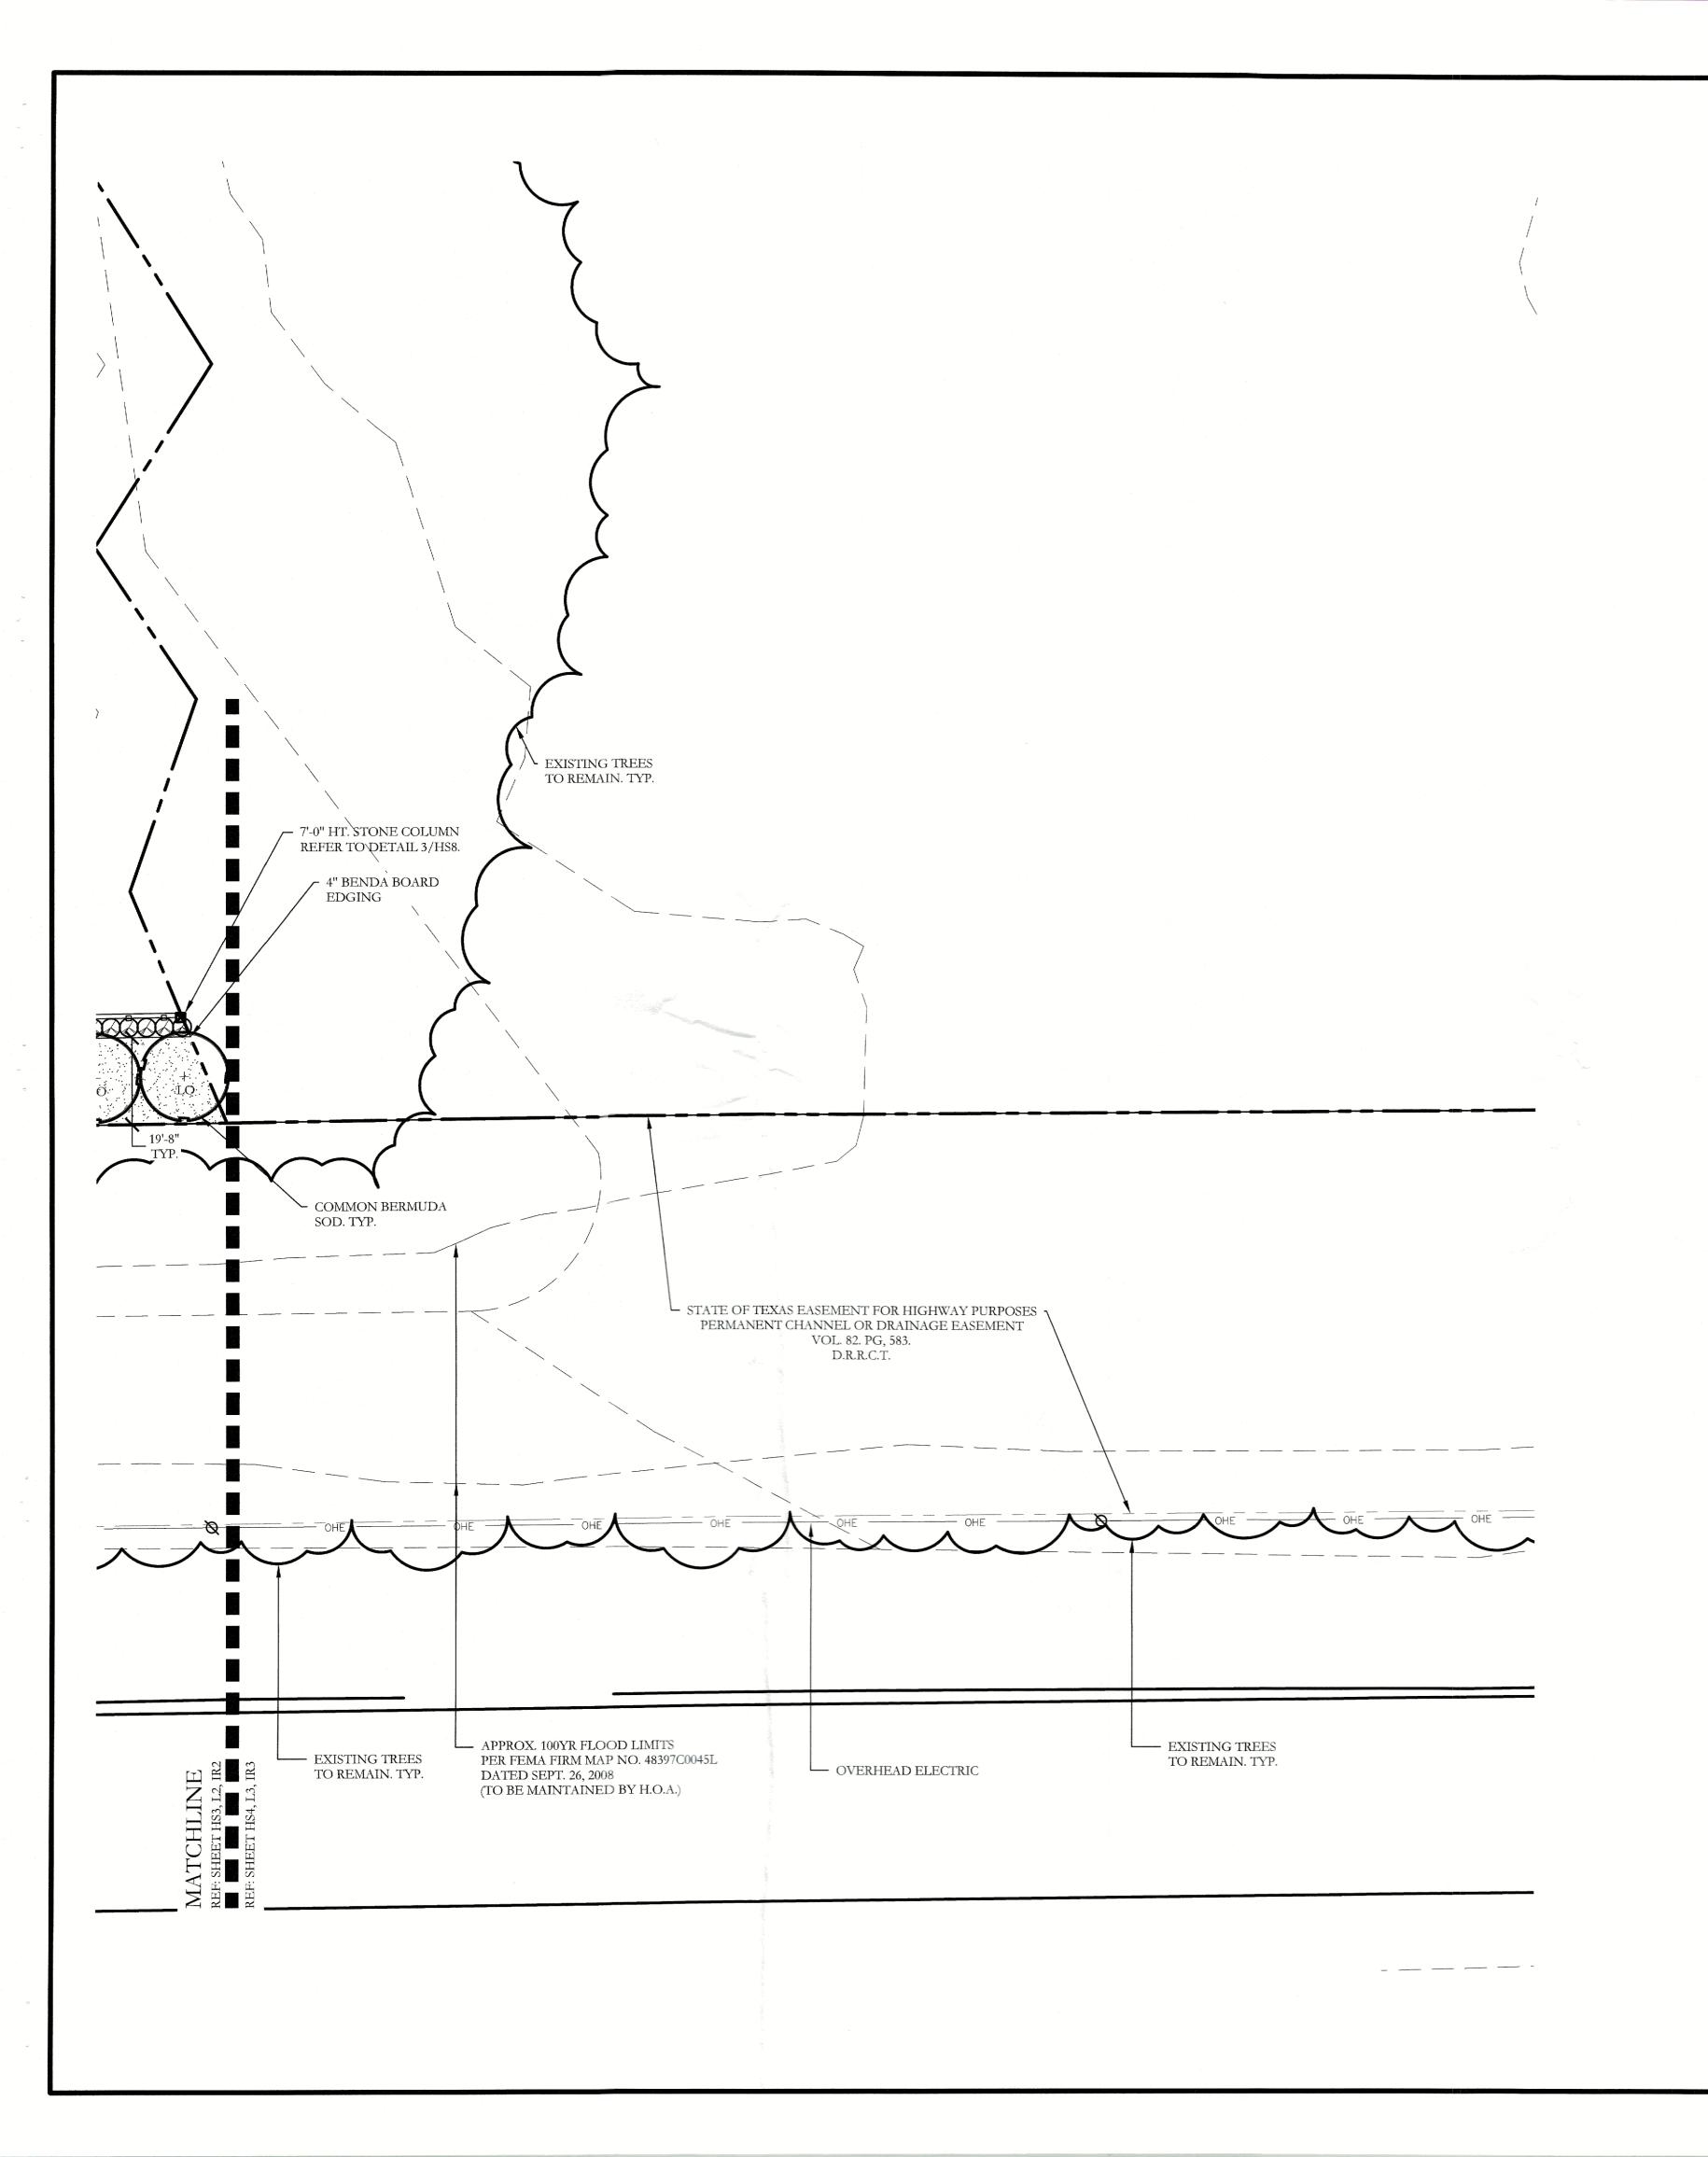


PLANT LEGEND										
SYMBOL	KEY	COMMON NAME	SCIENTIFIC NAME	SIZE	SPACING					
******	LO	LIVE OAK	QUERCUS VIRGINIANA	8" CALIPER	AS SHOWN					
LO LO	LO	LIVE OAK	QUERCUS VIRGINIANA	4" CALIPER	AS SHOWN					
© BO	BO BUR OAK QUE		QUERCUS MACROCARPA	4" CALIPER	AS SHOWN					
X + SO X	so shumard oak Querci		QUERCUS SHUMARDII	4" CALIPER	AS SHOWN					
CE CE	CE CEDAR ELM DW DESERT WILLOW		ULMUS CRASSIFOLIA	4" CALIPER	AS SHOWN					
+ DW			CHILOPSIS LINEARIS	2" CALIPER	AS SHOWN					
Ø		STANDARD BURFORD HOLLY	ILEX CORNUTA 'BURFORDII'	7 GALLON	48" O.C.					
\odot		PURPLE DIAMOND LOROPETALUM	LOROPETALUM CHINENSIS ' PURPLE DIAMOND'	7 GALLON	48" O.C.					
Q		DESPERADO TEXAS SAGE	LEUCOPHYLLUM FRUTESCENS 'GREADO'	7 GALLON	48" O.C.					
O		PINKIE INDIAN HAWTHORN	RHAPHIOLEPIS INDICA 'PINKIE'	5 GALLON	36" O.C.					
0		RED YUCCA	HESPERALOE PARVIFLORA	5 GALLON	36" O.C.					
0		YELLOW YUCCA	HESPERALOE PARVIFLORA 'YELLOW'	5 GALLON	36" O.C.					
⊙		ADAM'S NEEDLE 'COLOR GUARD'	YUCCA FILAMENTOSA 'GOLOR GUARD'	5 GALLON	36" O.C.					
		MEXICAN FEATHER GRASS	NASSELLA TENUISSIMA	1 GALLON	18" O.C.					
600003 600003 600003		ANNUAL COLOR	TO BE SELECTED BY OWNER	4" POT	8" O.C.					
		COMMON BERMUDA GRASS	CYNODON DACTYLON	SQUARE FEET	SOLID SOD					
∞		OKLAHOMA MOSS ROCK BOULDERS	50 LB. TO 250 LB. MAX SIZE; BURY BOTTOM THIRD OF BOULDER IN LANDSCAPE BED. FIELD LOCATE ALL BOULDER MASSES ON SITE AND MARK FOR LANDSCAPE ARCHITECT'S APPROVAL BEFORE PROCEEDING WITH WORK.	TON	AS SHOWN					
	OKLAHOMA RIVER ROCK		3" DEPTH RIVER ROCK BED WITH LANDSCAPE FABRIC BENEATH AS SHOWN IN DETAILS. RIVER ROCK SHALL INCLUDE A MIXTURE OF TANS, BROWNS, GRAYS AND PINKS. RIVER ROCK SHALL BE AN EQUAL COMBINATION OF 1-2" AND 2-4" IN SIZE. REFER TO DETAIL 1/LS1.	SQUARE FEET	100% COVERAGE					

Bar is one inch on original drawing. If not one inch on this sheet, adjust scale as necessary. One Inch AND BUFFERIN SCREENING


Dector of Planning and Zoning


CJS PROJECT NO. DLL001

SHEET NO. L3 of 9

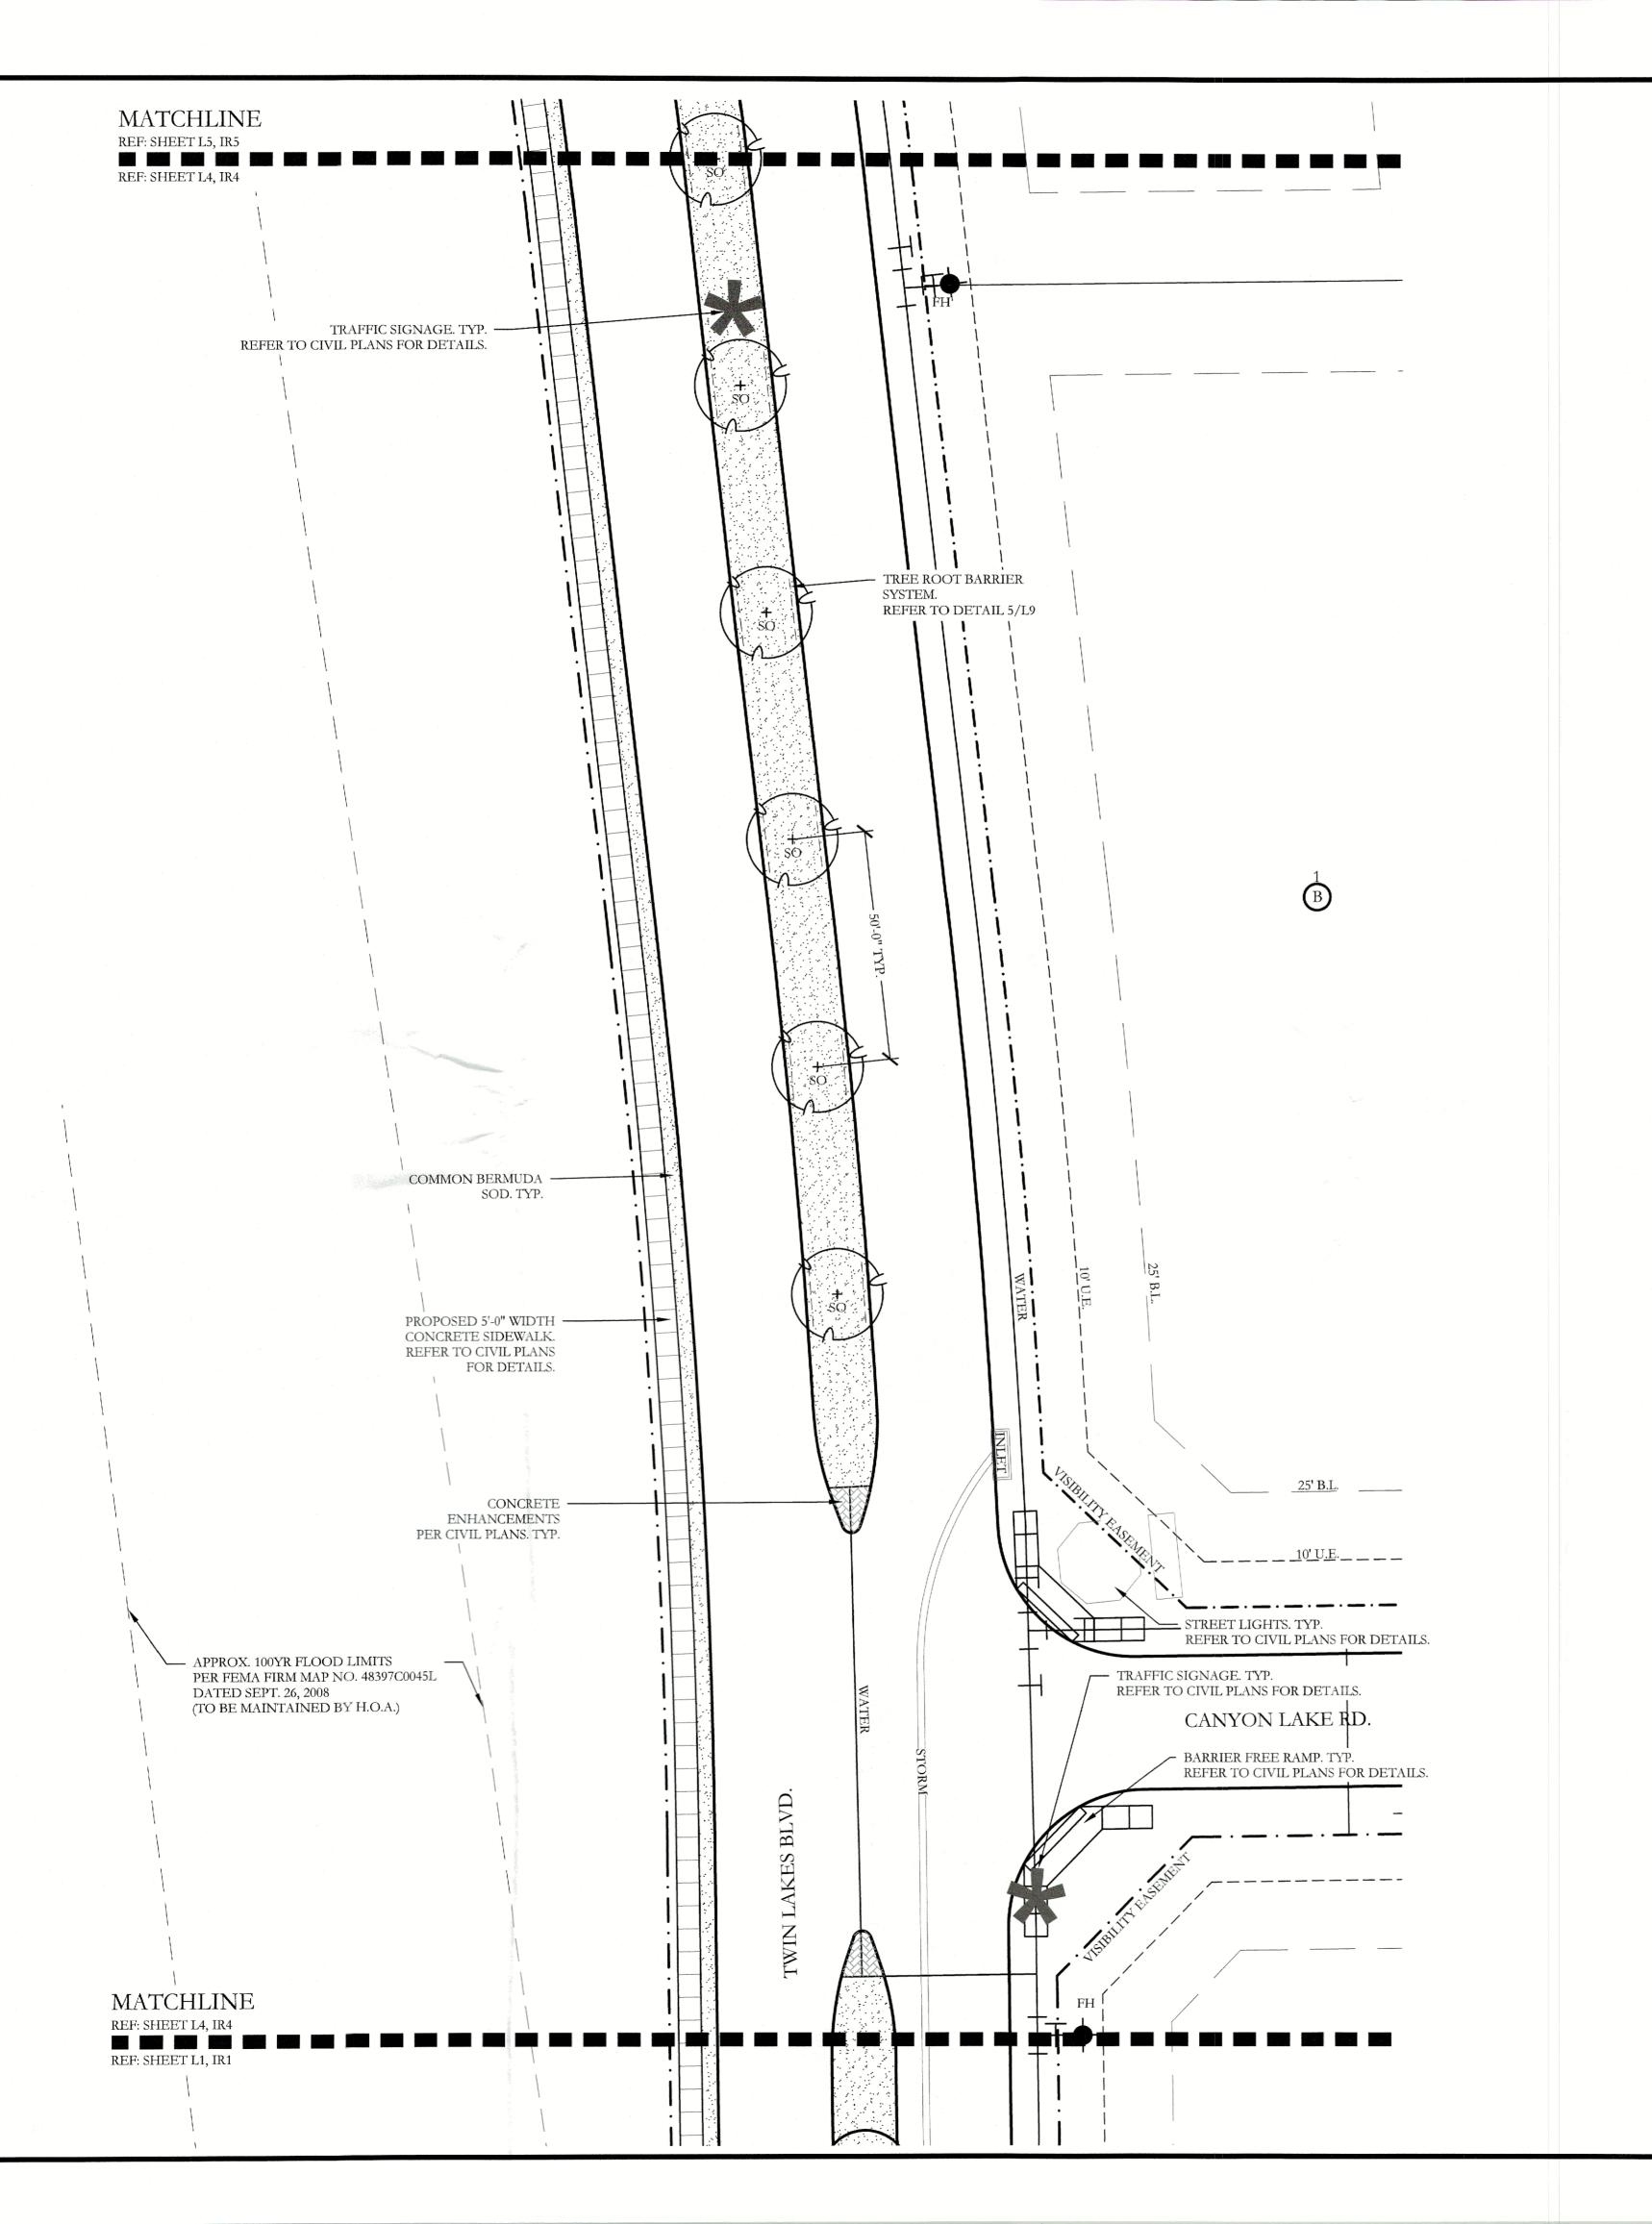

PLANT LEGEND										
SYMBOL	KEY	COMMON NAME	SCIENTIFIC NAME	SIZE	SPACING					
LO LIVE OAK			QUERCUS VIRGINIANA	4" CALIPER	AS SHOWN					
© BO	BO BUR OAK		QUERCUS MACROCARPA	4" CALIPER	AS SHOWN					
* SO	SO	SHUMARD OAK	QUERCUS SHUMARDII	4" CALIPER	AS SHOWN					
N V V V V V V V V V V V V V V V V V V V		COMMON BERMUDA GRASS	CYNODON DACTYLON	SQUARE FEET	SOLID SOD					

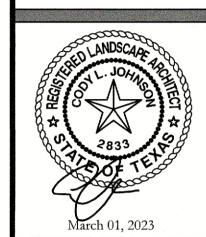

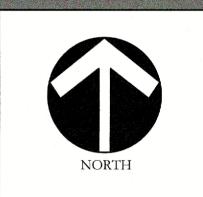

Scale: 1'' = 20'-0''

Bar is one inch on original drawing. If not one inch on this sheet, adjust scale as necessary.

One Inch


SCREENING

AND BUFFERING


CJS PROJECT NO. DLL001

SHEET NO. L4 of <u>9</u>


Director of Planning and Zoning

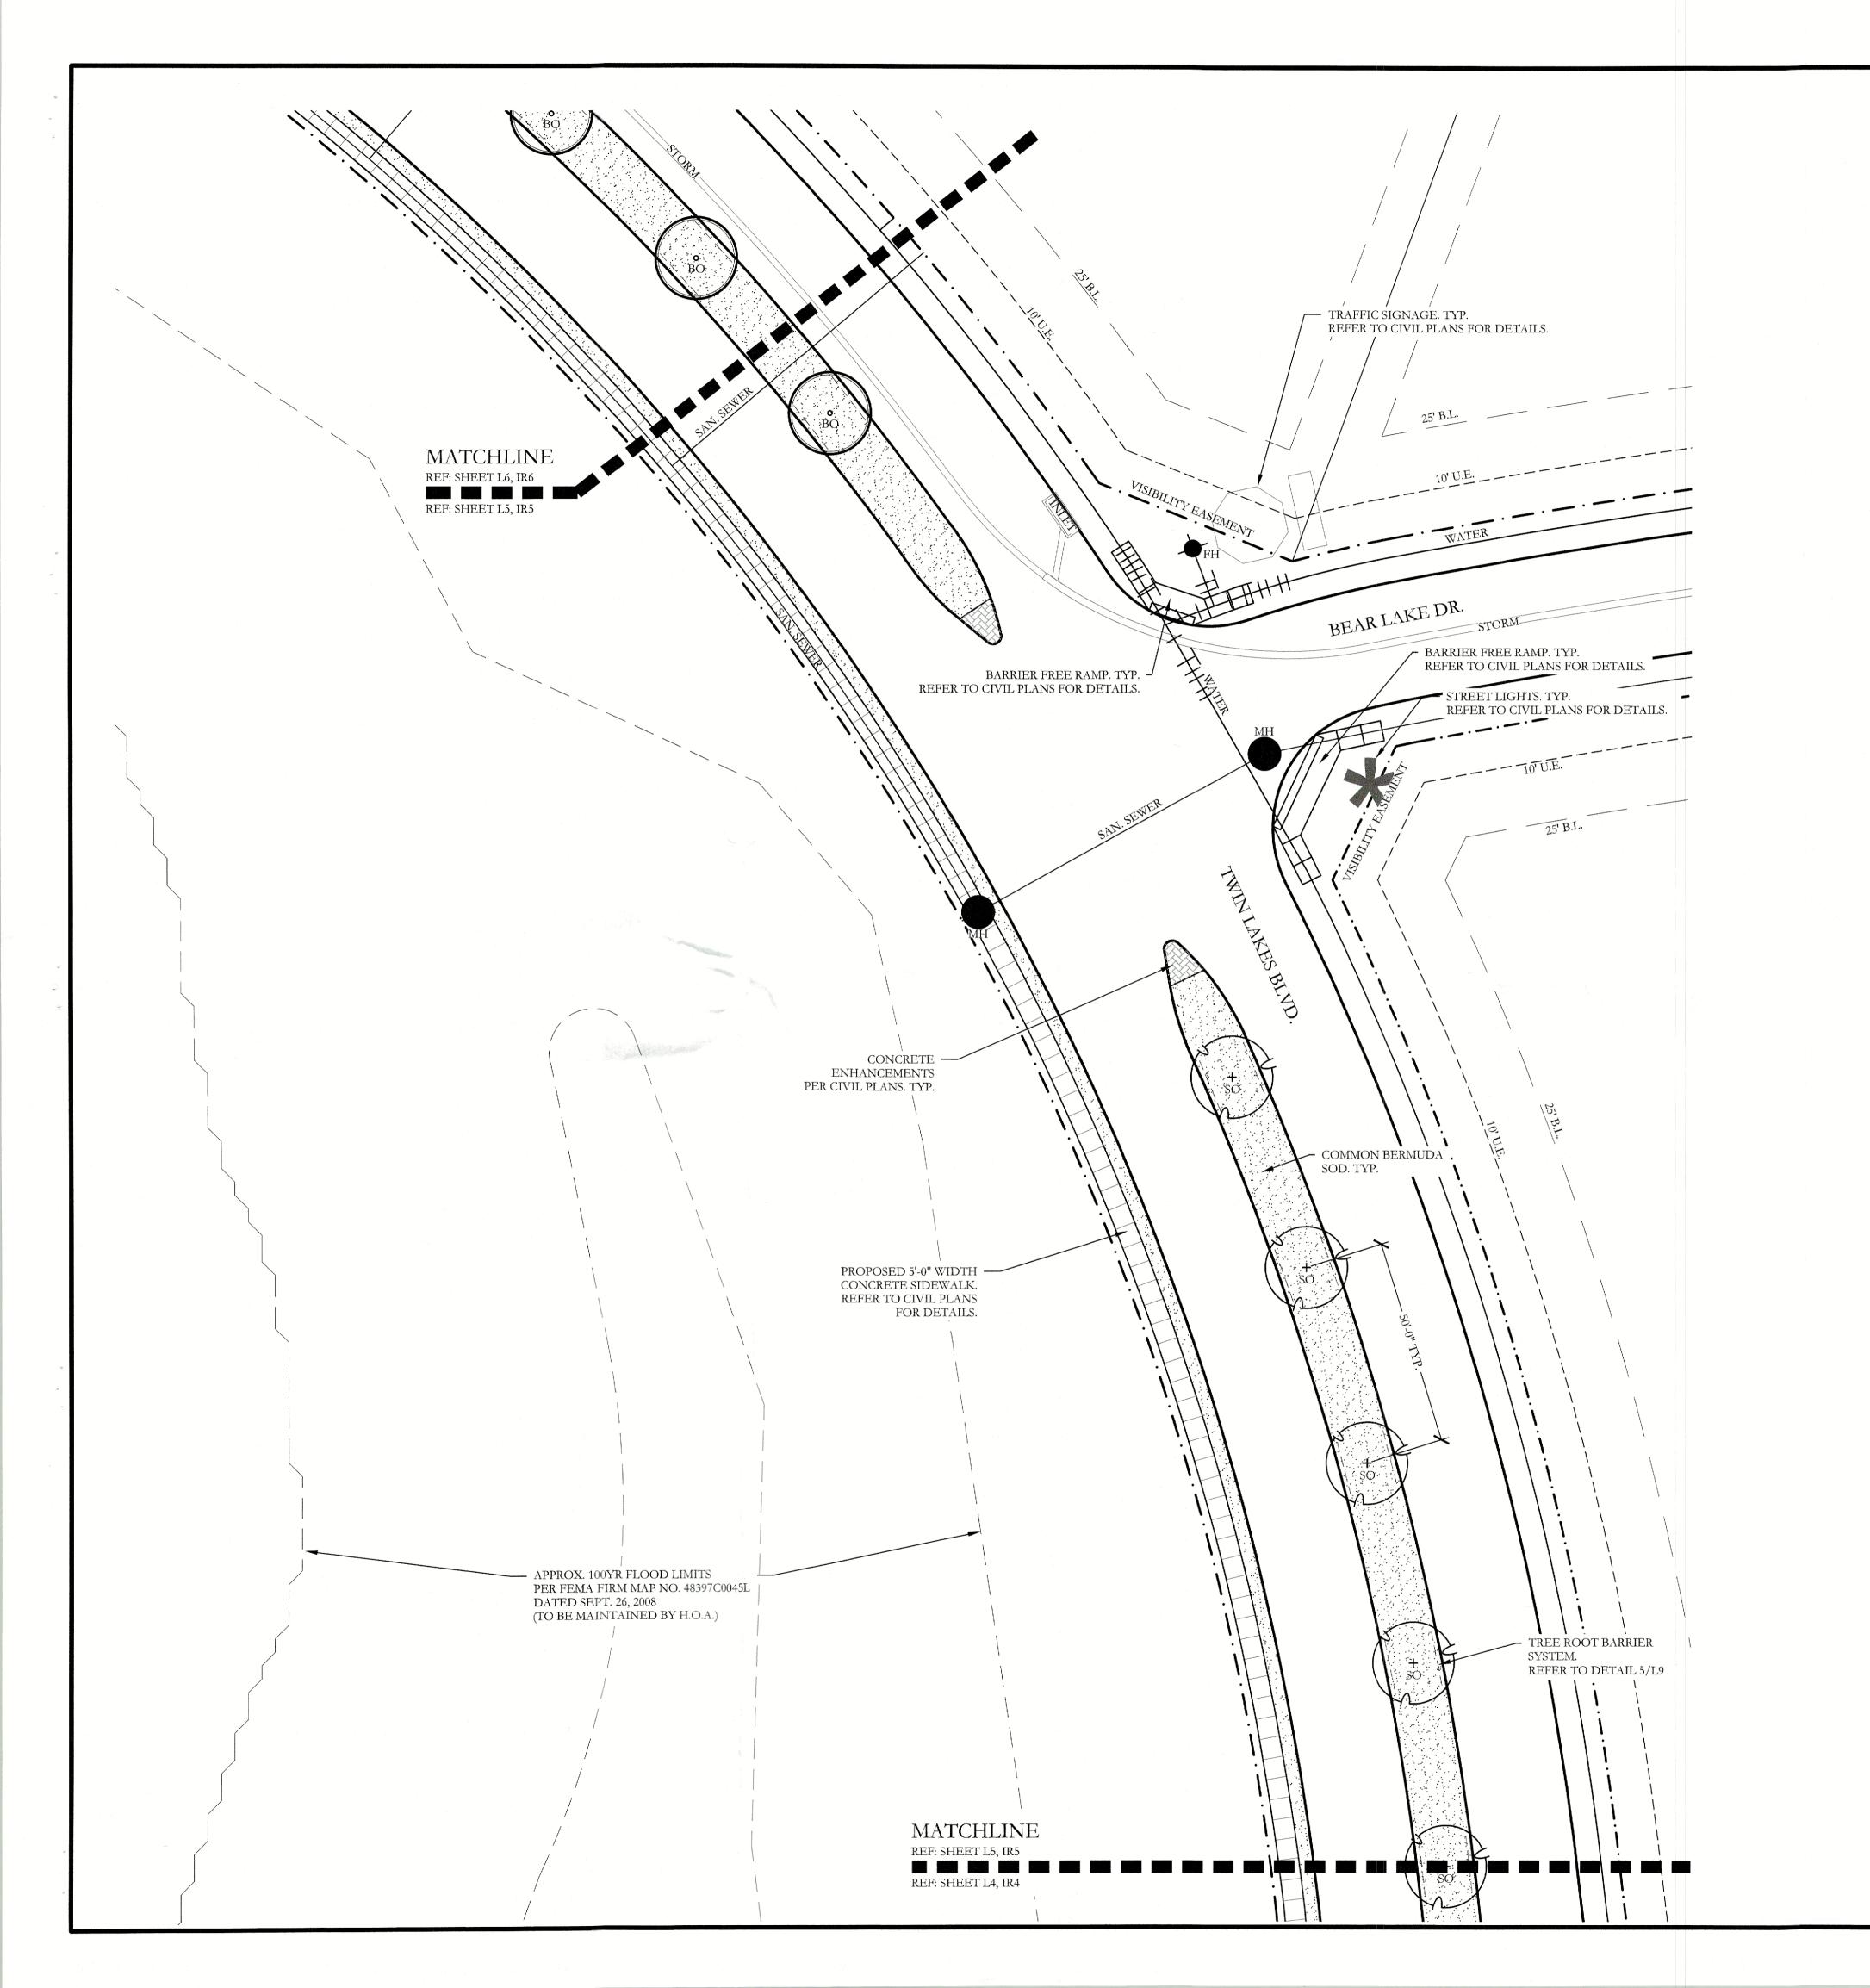


PLANT LEGEND									
SYMBOL KEY COMMON NAME		SCIENTIFIC NAME	SIZE	SPACING					
LO LIVE OAK		QUERCUS VIRGINIANA	4" CALIPER	AS SHOWN					
© BO	BO BUR OAK		QUERCUS MACROCARPA	4" CALIPER	AS SHOWN				
*SO >	SO	SHUMARD OAK	QUERCUS SHUMARDII	4" CALIPER	AS SHOWN				
		COMMON BERMUDA GRASS	CYNODON DACTYLON	SQUARE FEET	SOLID SOD				

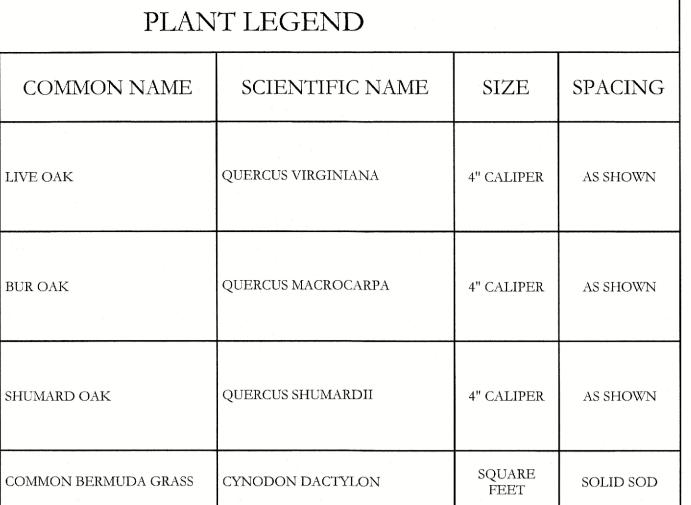

Director of Planning and Zoning

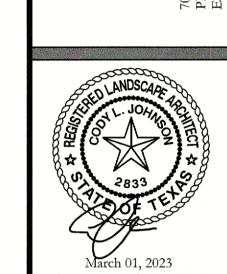

JOHNSON VOLK CONSULTING

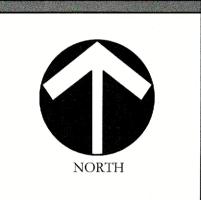


Scale: 1'' = 20' - 0''

Bar is one inch on original drawing. If not one inch on this sheet, adjust scale as necessary.


SCREENING

CJS PROJECT NO. DLL001 SHEET NO.

L5 of <u>9</u>

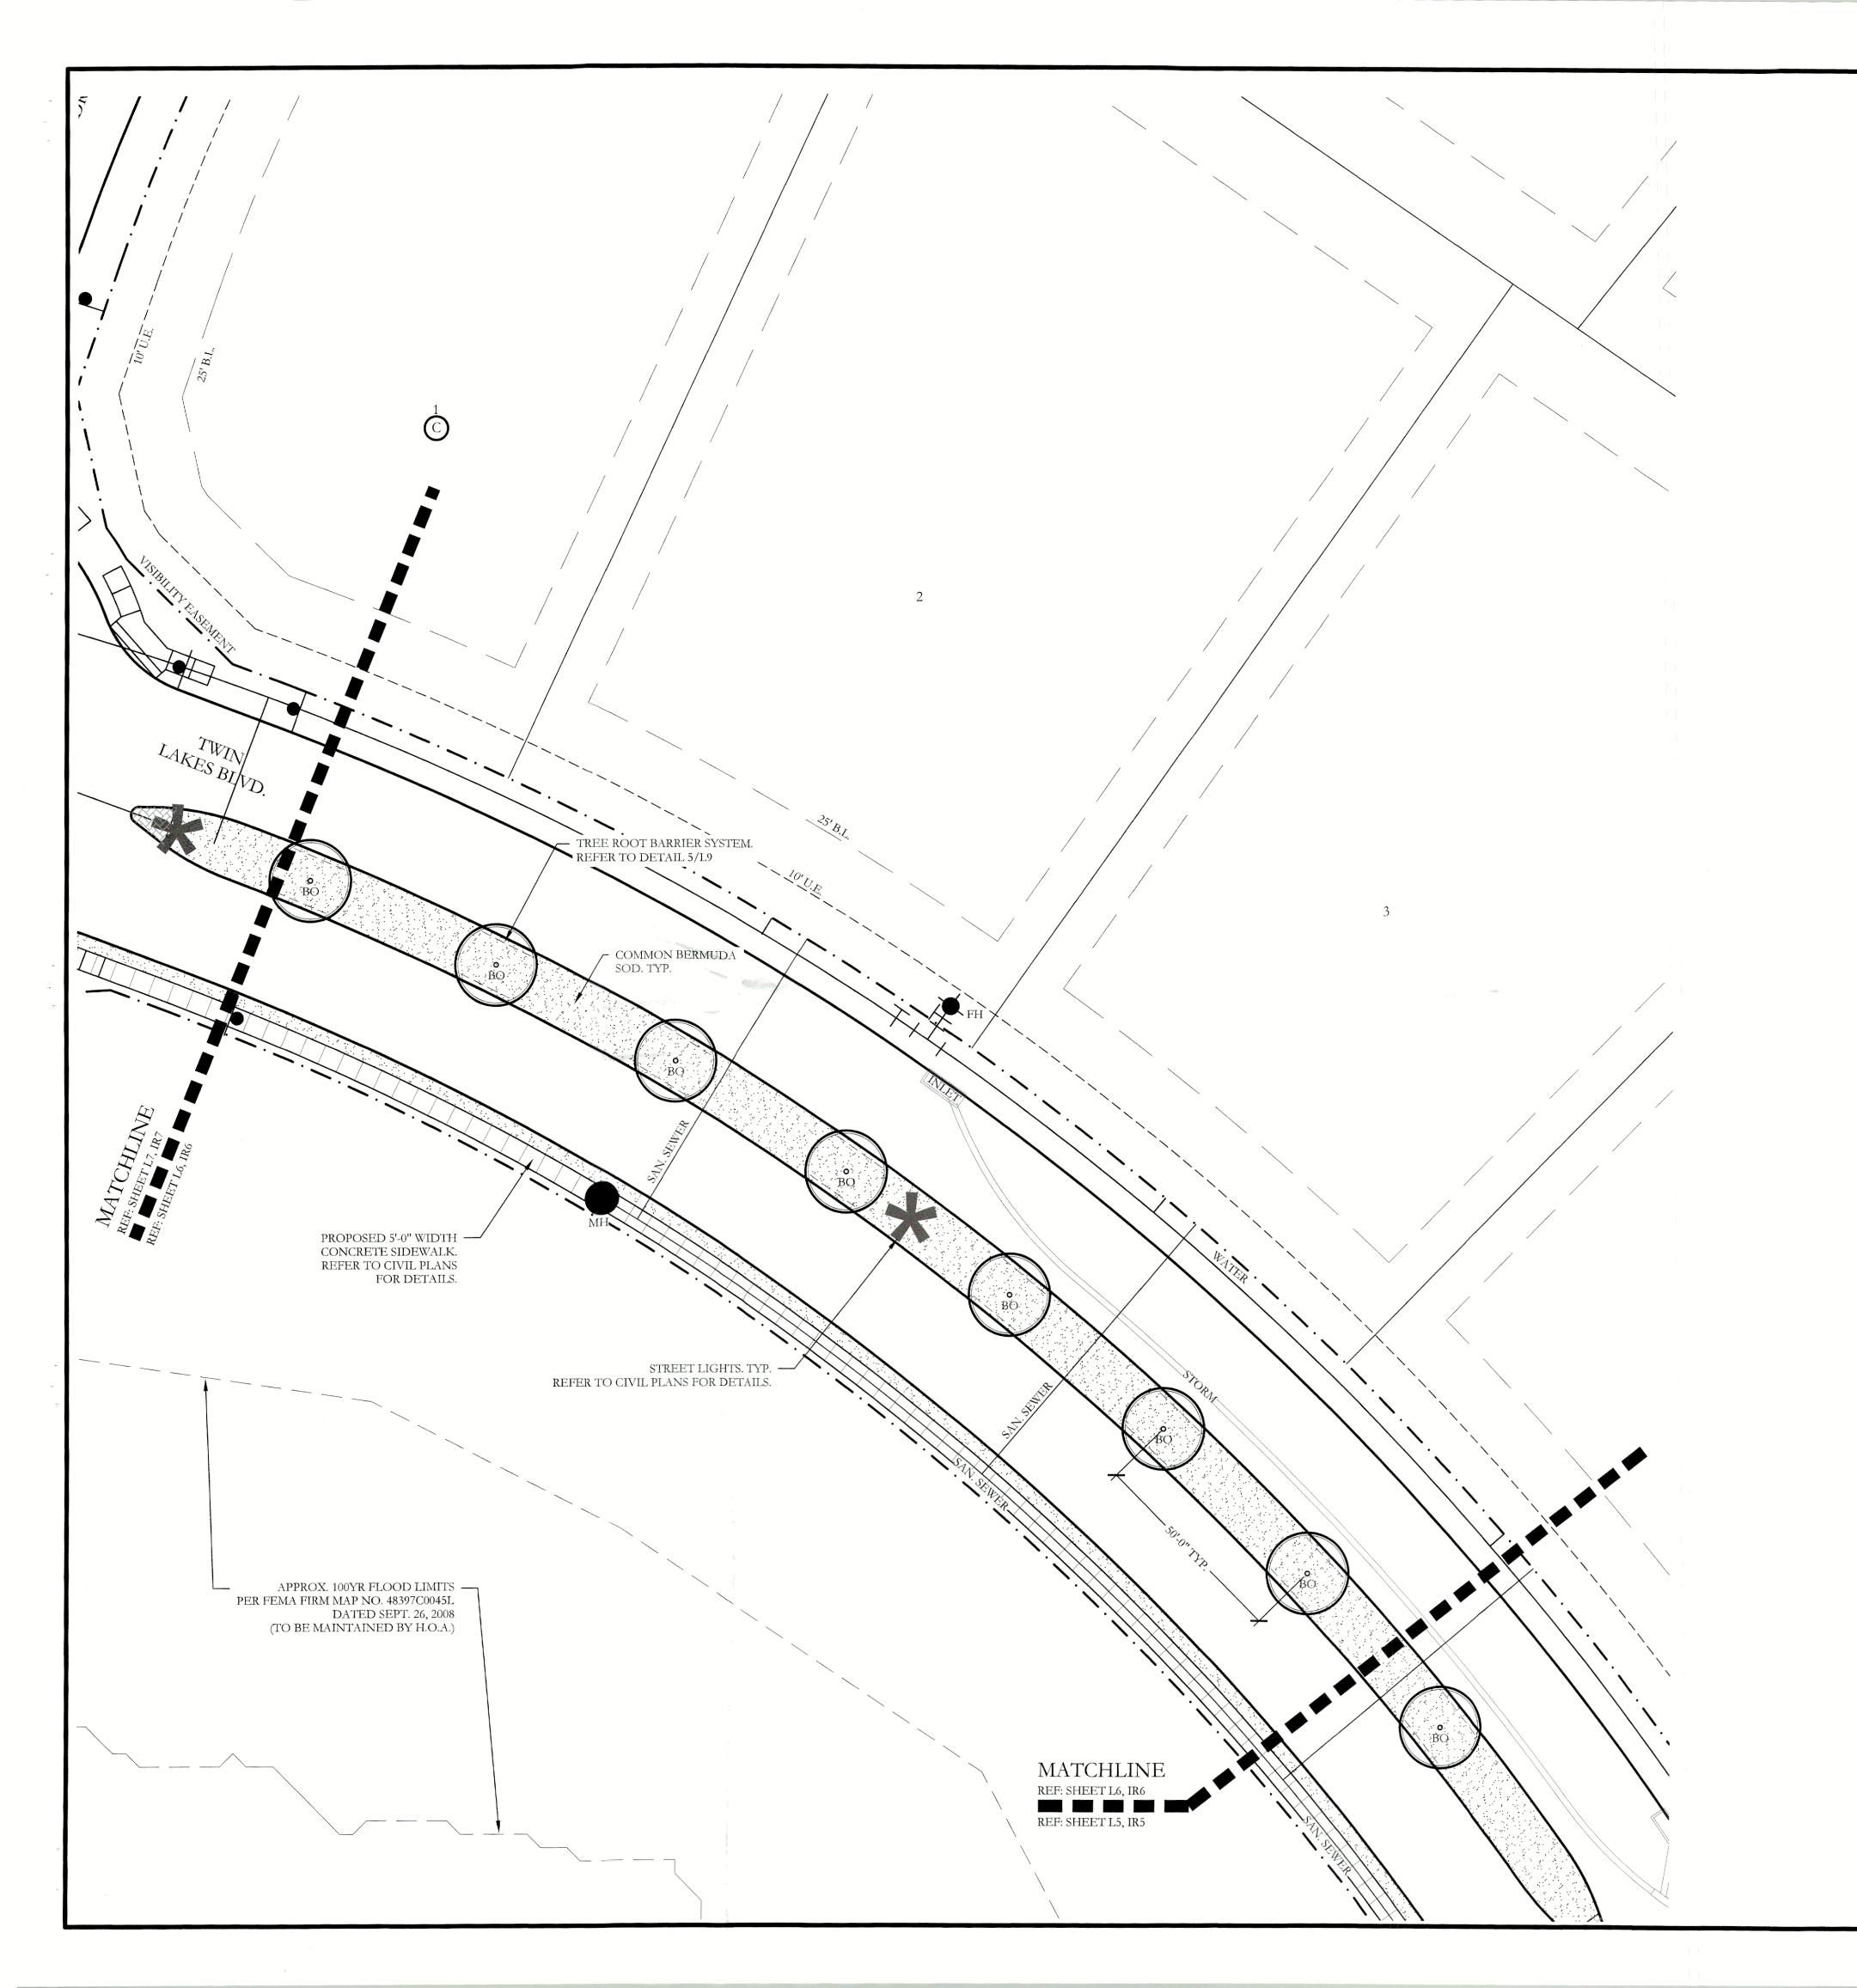

	PLANT LEGEND										
SYMBOL	KEY	COMMON NAME	SCIENTIFIC NAME	SIZE	SPACING						
(LO)	+ LO LIVE OAK		QUERCUS VIRGINIANA	4" CALIPER	AS SHOWN						
© BO	BO BUR OAK		QUERCUS MACROCARPA	4" CALIPER	AS SHOWN						
7 + SO -	so shumard oak		QUERCUS SHUMARDII	4" CALIPER	AS SHOWN						
10 V		COMMON BERMUDA GRASS	CYNODON DACTYLON	SQUARE FEET	SOLID SOD						

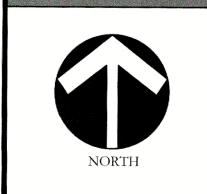

Bar is one inch on original drawing. If not one inch on this sheet, adjust scale as necessary. One Inch

AND BUFFERING


SCREENING

CJS PROJECT NO. DLL001

SHEET NO.

L6 of 9

WITNESS OUR HANDS, this 7 day of Hanning & Zoning Commission, Chairman Director of Planning and Zoning

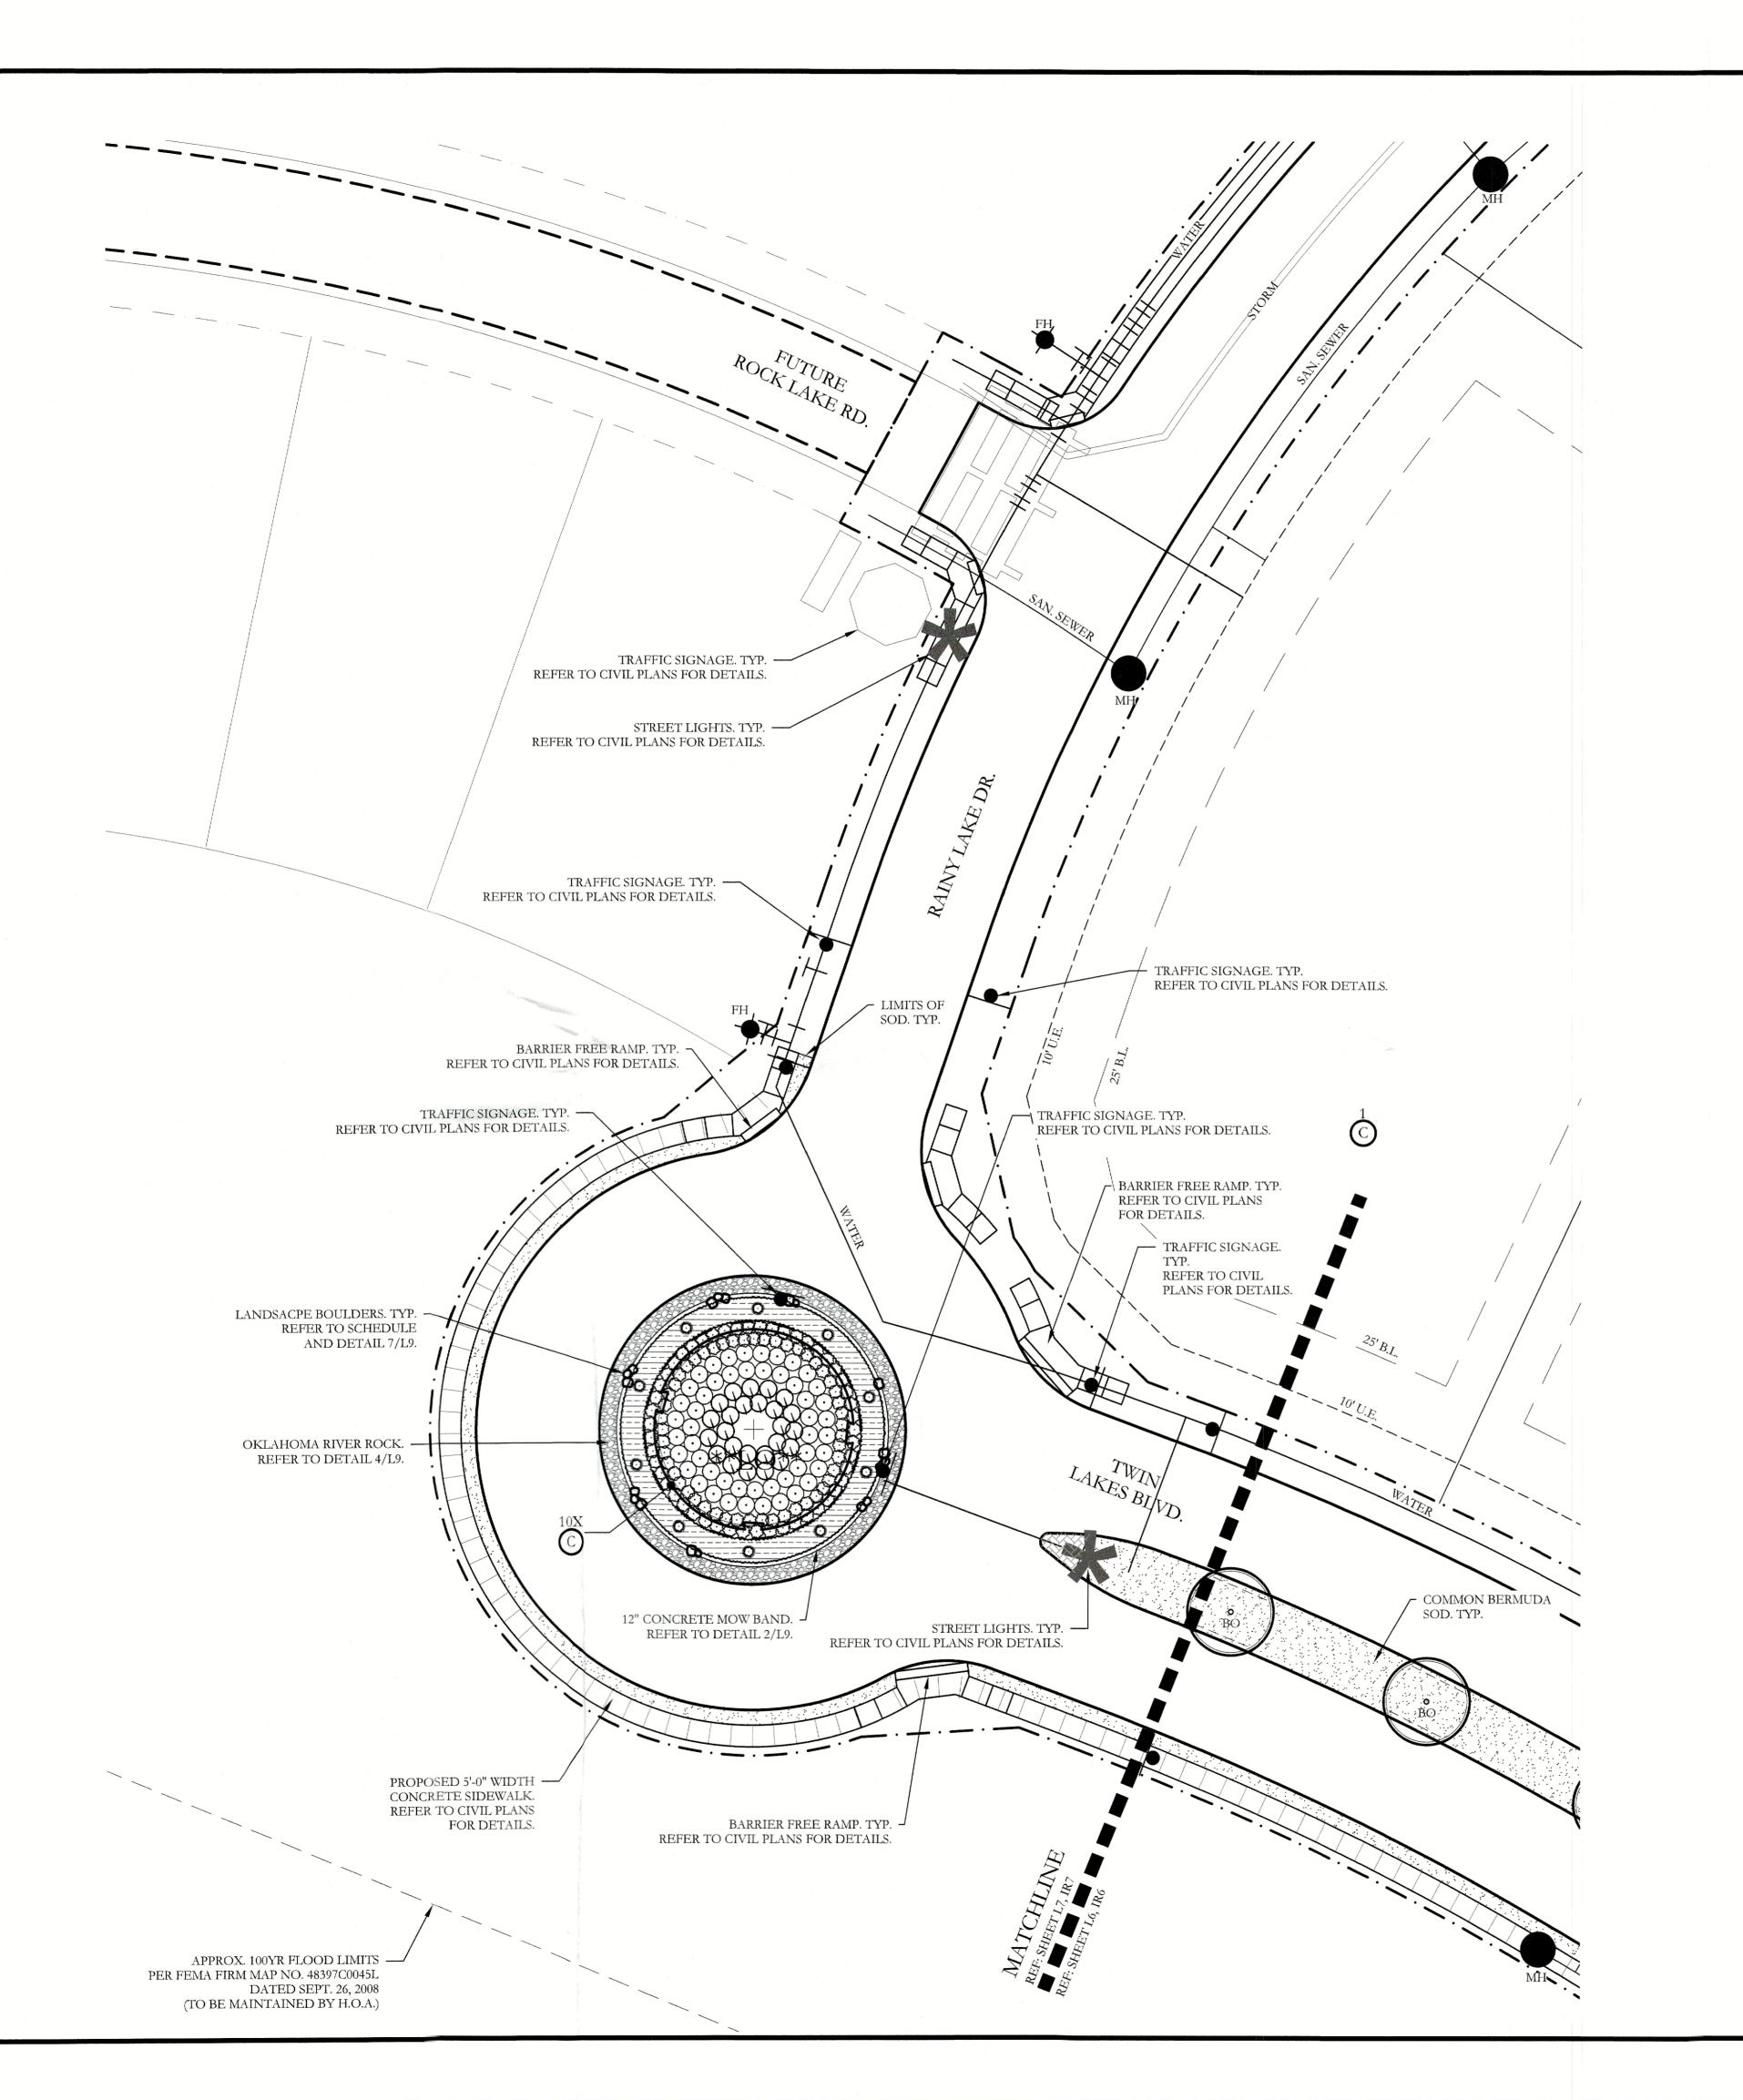

PLANT LEGEND											
SYMBOL	KEY	COMMON NAME	SCIENTIFIC NAME	SIZE	SPACING						
** ⁺ **	** + ** LO LIVE OAK		QUERCUS VIRGINIANA	8" CALIPER	AS SHOWN						
+ LO	+ LO LIVE OAK		QUERCUS VIRGINIANA	4" CALIPER	AS SHOWN						
© BO	BO BUR OAK		QUERCUS MACROCARPA	4" CALIPER	AS SHOWN						
* SO	SO	SHUMARD OAK	QUERCUS SHUMARDII	4" CALIPER	AS SHOWN						
CE CE	CE CEDAR ELM DW DESERT WILLOW		ULMUS CRASSIFOLIA	4" CALIPER	AS SHOWN AS SHOWN						
+ DW			CHILOPSIS LINEARIS	2" CALIPER							
\otimes		STANDARD BURFORD HOLLY	ILEX CORNUTA 'BURFORDII'	7 GALLON	48" O.C.						
\odot		PURPLE DIAMOND LOROPETALUM	LOROPETALUM CHINENSIS ' PURPLE DIAMOND'	7 GALLON	48" O.C.						
0		DESPERADO TEXAS SAGE	LEUCOPHYLLUM FRUTESCENS 'GREADO'	7 GALLON	48" O.C.						
0		PINKIE INDIAN HAWTHORN	RHAPHIOLEPIS INDICA 'PINKIE'	5 GALLON	36" O.C.						
0		RED YUCCA	HESPERALOE PARVIFLORA	5 GALLON	36" O.C.						
0		YELLOW YUCCA	HESPERALOE PARVIFLORA 'YELLOW'	5 GALLON	36" O.C.						
\odot		ADAM'S NEEDLE 'COLOR GUARD'	YUCCA FILAMENTOSA 'GOLOR GUARD'	5 GALLON	36" O.C.						
		MEXICAN FEATHER GRASS	NASSELLA TENUISSIMA	1 GALLON	18" O.C.						
60000000000000000000000000000000000000		ANNUAL COLOR	TO BE SELECTED BY OWNER	4" POT	8" O.C.						
		COMMON BERMUDA GRASS	CYNODON DACTYLON	SQUARE FEET	SOLID SOD						
088 088	OKLAHOMA RIVER ROCK		50 LB. TO 250 LB. MAX SIZE; BURY BOTTOM THIRD OF BOULDER IN LANDSCAPE BED. FIELD LOCATE ALL BOULDER MASSES ON SITE AND MARK FOR LANDSCAPE ARCHITECT'S APPROVAL BEFORE PROCEEDING WITH WORK.	TON	AS SHOWN						
			3" DEPTH RIVER ROCK BED WITH LANDSCAPE FABRIC BENEATH AS SHOWN IN DETAILS. RIVER ROCK SHALL INCLUDE A MIXTURE OF TANS, BROWNS, GRAYS AND PINKS. RIVER ROCK SHALL BE AN EQUAL COMBINATION OF 1-2" AND 2-4" IN SIZE. REFER TO DETAIL 1/LS1.		100% COVERAGE						

JOHNSON VOLK CONSULTING Bar is one inch on original drawing. If not one inch on this sheet, adjust scale as necessary. BUFFERING

SCREENINC

CJS PROJECT NO.

DLL001

SHEET NO. L7 of <u>9</u>

Dilector of Planning and Zoning

LANDSCAPE PROVIDED

STATE HIGHWAY - 276

MINIMUM TWENTY (25) FOOT LANDSCAPE BUFFER PROVIDED

6' HT. WROUGHT IRON METAL SCREENING FENCE PROVIDED.

3-4" CAL. CANOPY TREE / 100 LF OF LINEAR FRONTAGE.

545 LF OF FRONTAGE / 100 LF = 5.45

 $5.45 \times 3 = 16.35$ 4-ACCENT TREES / 100 LF OF LINEAR FRONTAGE. 545 LF OF FRONTAGE / 100 LF = 5.45

 $5.45 \times 4 = 21.80$

PROVIDED: 17 - 4" CALIPER TREES 22 - ACCENT TREES

- SHRUBBERY SHALL HAVE A MINIMUM HEIGHT OF 30 INCHES AND A MAXIMUM HEIGHT OF 48 INCHES.
- MINIMUM 2.5' HT. LANDSCAPE BERMS PROVIDED ALONG FRONTAGE. REFER TO CIVIL PLANS FOR DETAILS
- EACH RESIDENTIAL LOT MUST HAVE (2) TWO LOT TREES IN THE FRONT YARD, AND CORNER LOTS MUST HAVE (4) FOUR LOT

			PLANT LIST			
KEY	ESTIMATED QUANTITY	COMMON NAME	SCIENTIFIC NAME	SIZE	SPACING	REMARKS
LO	8	LIVE OAK	QUERCUS VIRGINIANA	4" CALIPER	AS SHOWN	NURSERY GROWN; FULL HEAD; MINIMUM BRANCHING HEIGHT AT 6'-0"; MINIMUM 10'-0" OVERALL HEIGHT.
LO	1	LIVE OAK - MULTI TRUNK	QUERCUS VIRGINIANA	8" CALIPER	AS SHOWN	NURSERY GROWN; FULL HEAD; MINIMUM BRANCHING HEIGHT AT 10'-0"; MINIMUM 15'-0" OVERALL HEIGHT.
ВО	8	BUR OAK	QUERCUS MACROCARPA	4" CALIPER	AS SHOWN	NURSERY GROWN; FULL HEAD; MINIMUM BRANCHING HEIGHT AT 6'-0"; MINIMUM 10'-0" OVERALL HEIGHT.
SO	19	SHUMARD OAK	QUERCUS SHUMARDII	4" CALIPER	AS SHOWN	NURSERY GROWN; FULL HEAD; MINIMUM BRANCHING HEIGHT AT 6'-0"; MINIMUM 10'-0" OVERALL HEIGHT.
CE	4	CEDAR ELM	ULMUS CRASSIFOLIA	4" CALIPER	AS SHOWN	NURSERY GROWN; FULL HEAD; MINIMUM BRANCHING HEIGHT AT 6'-0"; MINIMUM 10'-0" OVERALL HEIGHT.
DW	22	DESERT WILLOW	CHILOPSIS LINEARIS	2" CALIPER	AS SHOWN	NURSERY GROWN; FULL HEAD; MINIMUM 8'-0" OVERALL HEIGHT.
	105	STANDARD BURFORD HOLLY	ILEX CORNUTA 'BURFORDII'	7 GALLON	48" O.C.	CONTAINER GROWN; FULL PLANT.
	67	PURPLE DIAMOND LOROPETALUM	LOROPETALUM CHINENSIS ' PURPLE DIAMOND'	7 GALLON	48" O.C.	CONTAINER GROWN; FULL PLANT.
	25	DESPERADO TEXAS SAGE	LEUCOPHYLLUM FRUTESCENS 'GREADO'	5 GALLON	48" O.C.	CONTAINER GROWN; FULL PLANT.
	109	PINKIE INDIAN HAWTHORN	RHAPHIOLEPIS INDICA 'PINKIE'	5 GALLON	36" O.C.	CONTAINER GROWN; FULL PLANT.
	36	RED YUCCA	HESPERALOE PARVIFLORA	5 GALLON	36" O.C.	CONTAINER GROWN; FULL PLANT.
	50	YELLOW YUCCA	HESPERALOE PARVIFLORA 'YELLOW'	5 GALLON	36" O.C.	CONTAINER GROWN; FULL PLANT.
	15	ADAN'S NEEDLE 'COLOR GUARD'	YUCCA FILAMENTOSA 'COLOR GUARD'	5 GALLON	36" O.C.	CONTAINER GROWN; FULL PLANT.
	550	MEXICAN FEATHER GRASS	NASSELLA TENUISSIMA	1 GALLON	24" O.C.	CONTAINER GROWN; FULL PLANT.
	170	ANNUAL COLOR	TO BE SELECTED BY OWNER	4" POT	8" O.C.	CONTAINER GROWN; FULL PLANT.
	35,100	COMMON BERMUDA GRASS	CYNODON DACTYLON	SQUARE FEET	SOLID SOD	MINIMUM 100% COVERAGE ALL AREAS SHOWN
	2	OKLAHOMA MOSS ROCK BOULDERS	N/A	TON	AS SHOWN	50 LB. TO 250 LB. MAX SIZE; BURY BOTTOM THIRD OF BOULDER IN LANDSCAPE BED. FIELD LOCATE ALL BOULDER MASSES ON SITE AND MARK FOR LANDSCAPE ARCHITECT'S APPROVAL BEFORE PROCEEDING WITH WORK.
	825	OKLAHOMA RIVER ROCK	N/A	SQUARE FEET	100% COVERAGE	3" DEPTH RIVER ROCK BED WITH LANDSCAPE FABRIC BENEATH AS SHOWN IN DETAILS. RIVER ROCK SHALL INCLUDE A MIXTURE OF TANS, BROWNS, GRAYS, AND PINKS. RIVER ROCK SHALL BE AN EQUAL COMBUNATION OF 1"-2" AND 2"-4" IN SIZE.

GENERAL LANDSCAPE NOTES

INSPECTIONS:

1. NO EXCAVATION SHALL OCCUR IN CITY R.O.W. WITHOUT A R.O.W. PERMIT--CONTACT THE PUBLIC WORKS DEPARTMENT.

- 2. THE CONTRACTOR SHALL MARK ALL WATER LINES, SEWER LINES, AND TREE LOCATIONS PRIOR TO CALLING FOR ROW INSPECTION AND PERMIT.
- 3. THE LANDSCAPE INSTALLATION SHALL COMPLY WITH APPROVED LANDSCAPE DRAWINGS PRIOR TO FINAL ACCEPTANCE BY THE CITY AND ISSUANCE OF A CERTIFICATE OF OCCUPANCY.
- 4. WATER METERS, CLEANOUTS AND OTHER APPURTENANCES, SHALL BE ACCESSIBLE, ADJUSTED TO GRADE, CLEARLY MARKED WITH FLAGGING AND COMPLIANT WITH PUBLIC WORKS DEPARTMENT STANDARDS PRIOR TO CALLING FOR FINAL LANDSCAPE AND ROW INSPECTIONS.

LANDSCAPE STANDARDS:

- 1. PLANTINGS AND LANDSCAPE ELEMENTS SHALL COMPLY WITH THE CITY'S ENGINEERING DESIGN STANDARDS, PUBLIC R.O.W. VISIBILITY REQUIREMENTS.
- 2. UNLESS OTHERWISE SPECIFIED, TREES SHALL BE PLANTED NO LESS THAN 4' FROM CURBS, SIDEWALKS, UTILITY LINES, SCREENING WALLS AND OTHER STRUCTURES. THE CITY HAS FINAL
- APPROVAL FOR ALL TREE PLACEMENTS. 3. A MINIMUM THREE FEET (3') RADIUS AROUND A FIRE HYDRANT MUST REMAIN CLEAR OF LANDSCAPE PURSUANT TO THE FIRE CODE.
- 4. STREET TREES, WHERE REQUIRED, SHALL BE (10') MINIMUM FROM THE EDGE OF A STORM SEWER CURB INLET BOX AND THE EDGE OF THE ROOT BALL SHALL BE (4') MINIMUM FROM THE WATER
- 5. THE AMERICAN STANDARD FOR NURSERY STOCK (ANSI Z60.1-2004) SPECIFICATIONS SHALL GOVERN PLANT QUALIFICATIONS, GRADES, AND STANDARDS.
- 6. TREE PLANTING SHALL COMPLY WITH DETAILS HEREIN AND THE INTERNATIONAL SOCIETY OF ARBORICULTURE (ISA) STANDARDS.
- 7. A 2-3" LAYER OF MULCH SHALL BE PROVIDED AROUND THE BASE OF THE PLANTED TREE. THE
- MULCH SHALL BE PULLED BACK 4" FROM THE TRUNK OF THE TREE. 8. TREE PITS SHALL BE TESTED FOR WATER PERCOLATION. IF WATER DOES NOT DRAIN OUT OF TREE
- PIT WITHIN 24-HOURS, THE TREE SHALL BE MOVED OR DRAINAGE SHALL BE PROVIDED.
- 9. ALL BEDS TO HAVE 3" OF COMPOSTED SOIL, LIVING EARTH TECHNOLOGY, OR APPROVED EQUAL TILLED AND TURNED TO A DEPTH OF 8" MINIMUM.
- 10. ALL PLANT BEDS SHALL BE TOP-DRESSED WITH A MINIMUM OF 3 INCHES OF HARDWOOD MULCH. 11. NATIVE SITE TOPSOIL IS TO BE PROTECTED FROM EROSION OR STOCKPILED. NATIVE SITE TOPSOIL SHALL BE LABORATORY TESTED BY AND ACCREDITED LABORATORY AND AMENDED PER SAID LABORATORY'S RECOMMENDATIONS.

IRRIGATION STANDARDS:

- . ANY CHANGES TO THESE APPROVED IRRIGATION DRAWINGS SHALL BE AUTHORIZED BY THE CITY.
- 2. CONTACT DEVELOPMENT SERVICES FOR AN IRRIGATION PERMIT PRIOR TO INSTALLING THE
- 3. IRRIGATION OVER-SPRAY ON STREETS AND WALKS IS PROHIBITED.
- 4. MAINLINES, VALVES, OR CONTROL WIRES SHALL NOT BE LOCATED IN THE CITY'S ROW.
- 5. ET IRRIGATION CONTROLLERS SHALL BE PROGRAMMED AND ADJUSTED TO NOT EXCEED THE LANDSCAPE WATER ALLOWANCE (LWA) PRIOR TO APPROVAL OF LANDSCAPE INSTALLATION.
- 6. VALVES SHALL BE LOCATED A MINIMUM OF (3') AWAY FROM STORM SEWERS, AND SANITARY SEWER
- LINES AND 5 FEET FROM CITY FIRE HYDRANTS AND WATER VALVES.
- 7. THE BORE DEPTH UNDER STREETS, DRIVE AISLES, AND FIRE LANES SHALL PROVIDE (2') OF CLEARANCE (MINIMUM).
- 8. IRRIGATION HEADS THAT RUN PARALLEL AND NEAR PUBLIC WATER AND SANITARY SEWER LINES; SHALL BE FED FROM STUBBED LATERALS OR BULL-BEADS. A MINIMUM FIVE FOOT (5') SEPARATION IS REQUIRED BETWEEN IRRIGATION MAIN LINES AND LATERALS THAT RUN PARALLEL TO PUBLIC
- 9. NO VALVES, BACKFLOW PREVENTION ASSEMBLIES, QUICK COUPLERS ETC. SHALL BE LOCATED CLOSER THAN 10' FROM THE CURB AT STREET OR DRIVE INTERSECTION.

MAINTENANCE STANDARDS:

WATER AND SANITARY SEWER LINES.

- 1. THE OWNER SHALL BE RESPONSIBLE FOR THE ESTABLISHMENT, MAINTENANCE, AND VIGOR OF PLANT MATERIAL IN ACCORDANCE WITH THE DESIGN INTENT AND AS APPROPRIATE FOR THE SEASON OF THE YEAR.
- 2. LANDSCAPE AND OPEN AREAS SHALL BE FREE OF TRASH, LITTER AND WEEDS.
- 3. NO PLANT MATERIAL SHALL BE ALLOWED TO ENCROACH ON R.O.W., SIDEWALKS OR EASEMENTS TO THE EXTENT THAT VISION OR ROUTE OF TRAVEL FOR VEHICULAR, PEDESTRIAN, OR BICYCLE
- 4. TREE MAINTENANCE SHALL BE IN ACCORDANCE WITH THE STANDARDS OF THE INTERNATIONAL SOCIETY OF ARBORICULTURE.
- 5. TREE STAKING MATERIALS, IF USED, SHALL BE REMOVED AFTER (1) GROWING SEASON, NO MORE THAN (1) YEAR AFTER INSTALLATION (STEEL TREE STAKES, WIRES, AND HOSES ARE PROHIBITED).

TREE PROTECTION NOTES:

- 1. CONTACT DEVELOPMENT SERVICES FOR A TREE REMOVAL PERMIT PRIOR TO REMOVAL OR
- TRANSPLANTING OF ANY TREES. 2. ALL TREES WHICH ARE TO REMAIN ON SITE SHALL BE PROTECTED WITH A (4') TALL BRIGHTLY
- COLORED PLASTIC FENCE, OR SILT FENCE, PLACED AT THE DRIP LINE OF THE TREES.
- 3. PRIOR TO THE PRE-CONSTRUCTION MEETING OR OBTAINING A GRADING PERMIT, ALL TREE MARKINGS AND PROTECTIVE FENCING SHALL BE INSTALLED BY THE OWNER AND BE INSPECTED
- BY DEVELOPMENT SERVICES. 4. NO EQUIPMENT SHALL BE CLEANED, OR HARMFUL LIQUIDS DEPOSITED WITHIN THE LIMITS OF THE
- ROOT ZONE OF TREES WHICH REMAIN ON SITE. 5. NO SIGNS, WIRES, OR OTHER ATTACHMENTS SHALL BE ATTACHED TO ANY TREE TO REMAIN ON
- 6. VEHICULAR AND CONSTRUCTION EQUIPMENT SHALL NOT PARK OR DRIVE WITHIN THE LIMITS OF
- 7. GRADE CHANGES IN EXCESS OF 3 INCHES (CUT OR FILL) SHALL NOT BE ALLOWED WITHIN A ROOT ZONE, UNLESS ADEQUATE TREE PRESERVATION METHODS ARE APPROVED BY THE CITY.
- 8. NO TRENCHING SHALL BE ALLOWED WITHIN THE DRIP-LINE OF A TREE, UNLESS APPROVED BY THE
- 9. ALL REMOVED TREES SHALL BE CHIPPED AND USED FOR MULCH ON SITE OR HAULED OFF-SITE. 10. ALL TREE MAINTENANCE TECHNIQUES SHALL BE IN CONFORMANCE WITH INDUSTRY IDENTIFIED

STANDARDS. IMPROPER OR MALICIOUS PRUNING TECHNIQUES ARE STRICTLY PROHIBITED.

INSON VOIDE

Bar is one inch on original drawing. If not one inch on this sheet, adjust scale as necessary.

One Inch


SCREENING AND BUFFERING	Landscape Details	Discovery Lakes Ph. 1	City of Rockwall, Rockwall County, Texas
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CJS PROJECT NO. DLL001

SHEET NO.

L8 of 9


Director of Planning and Zoning

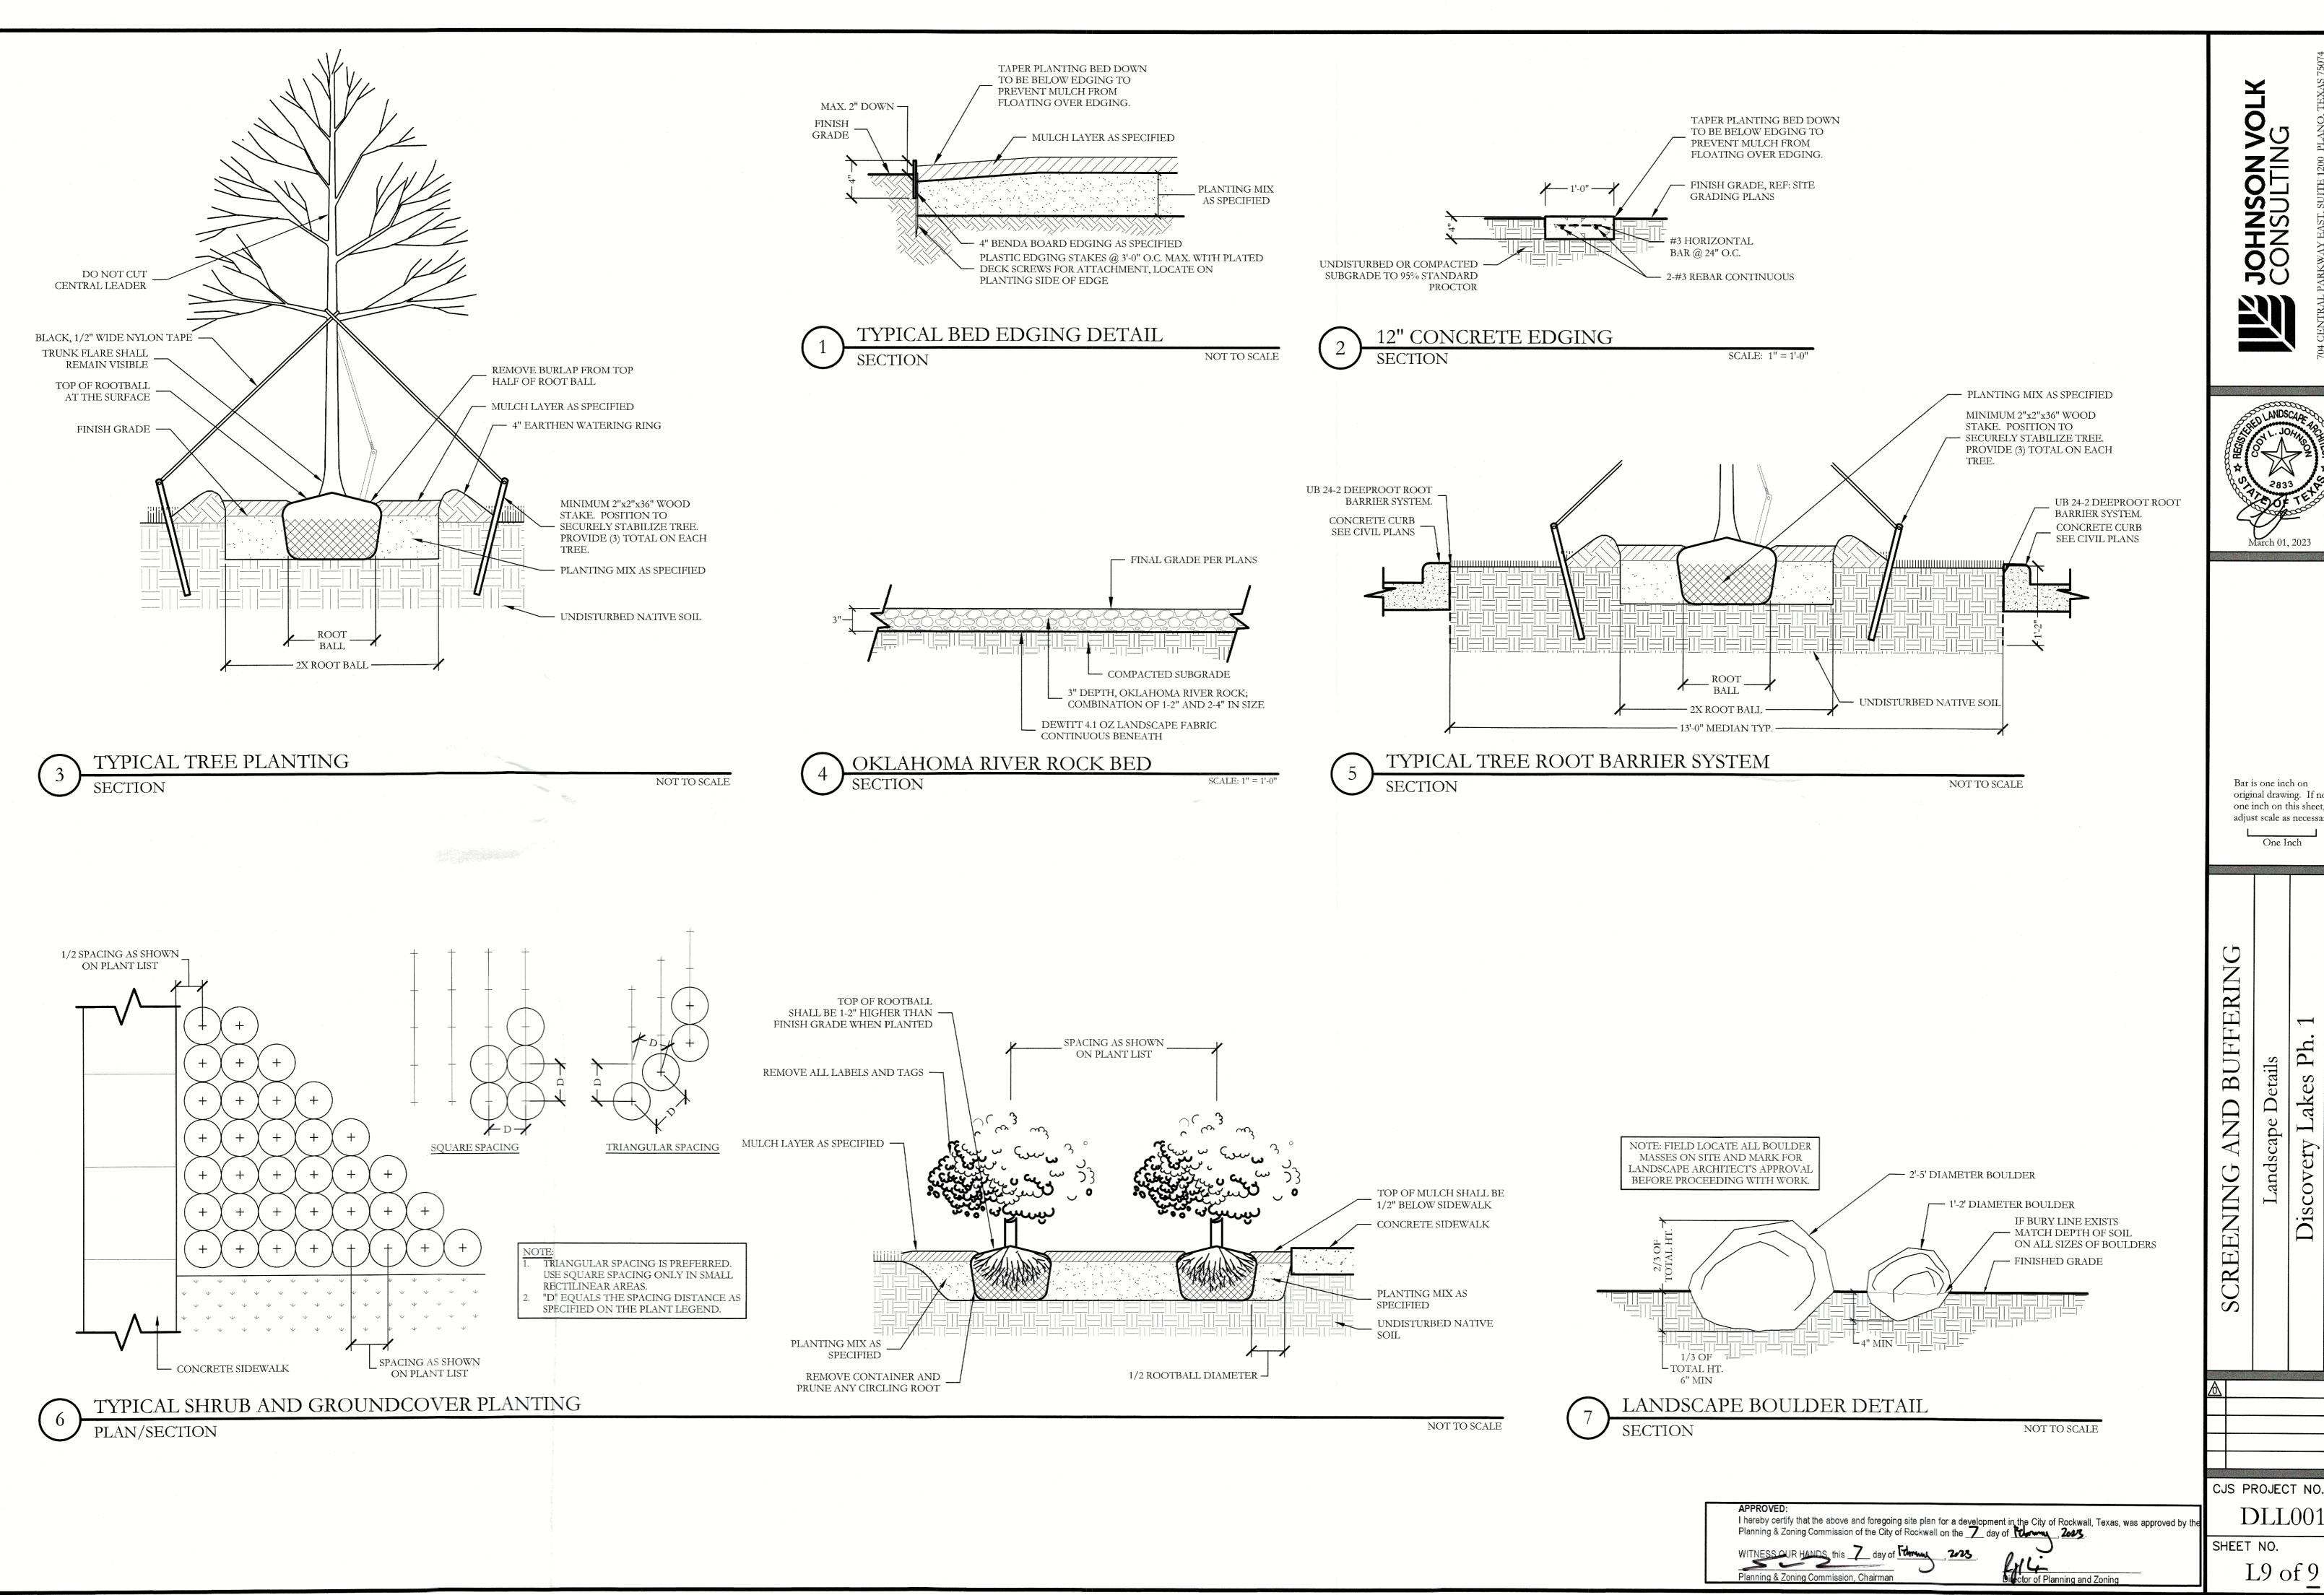

Bar is one inch on original drawing. If not one inch on this sheet, adjust scale as necessary. One Inch

CJS PROJECT NO.


DLL001

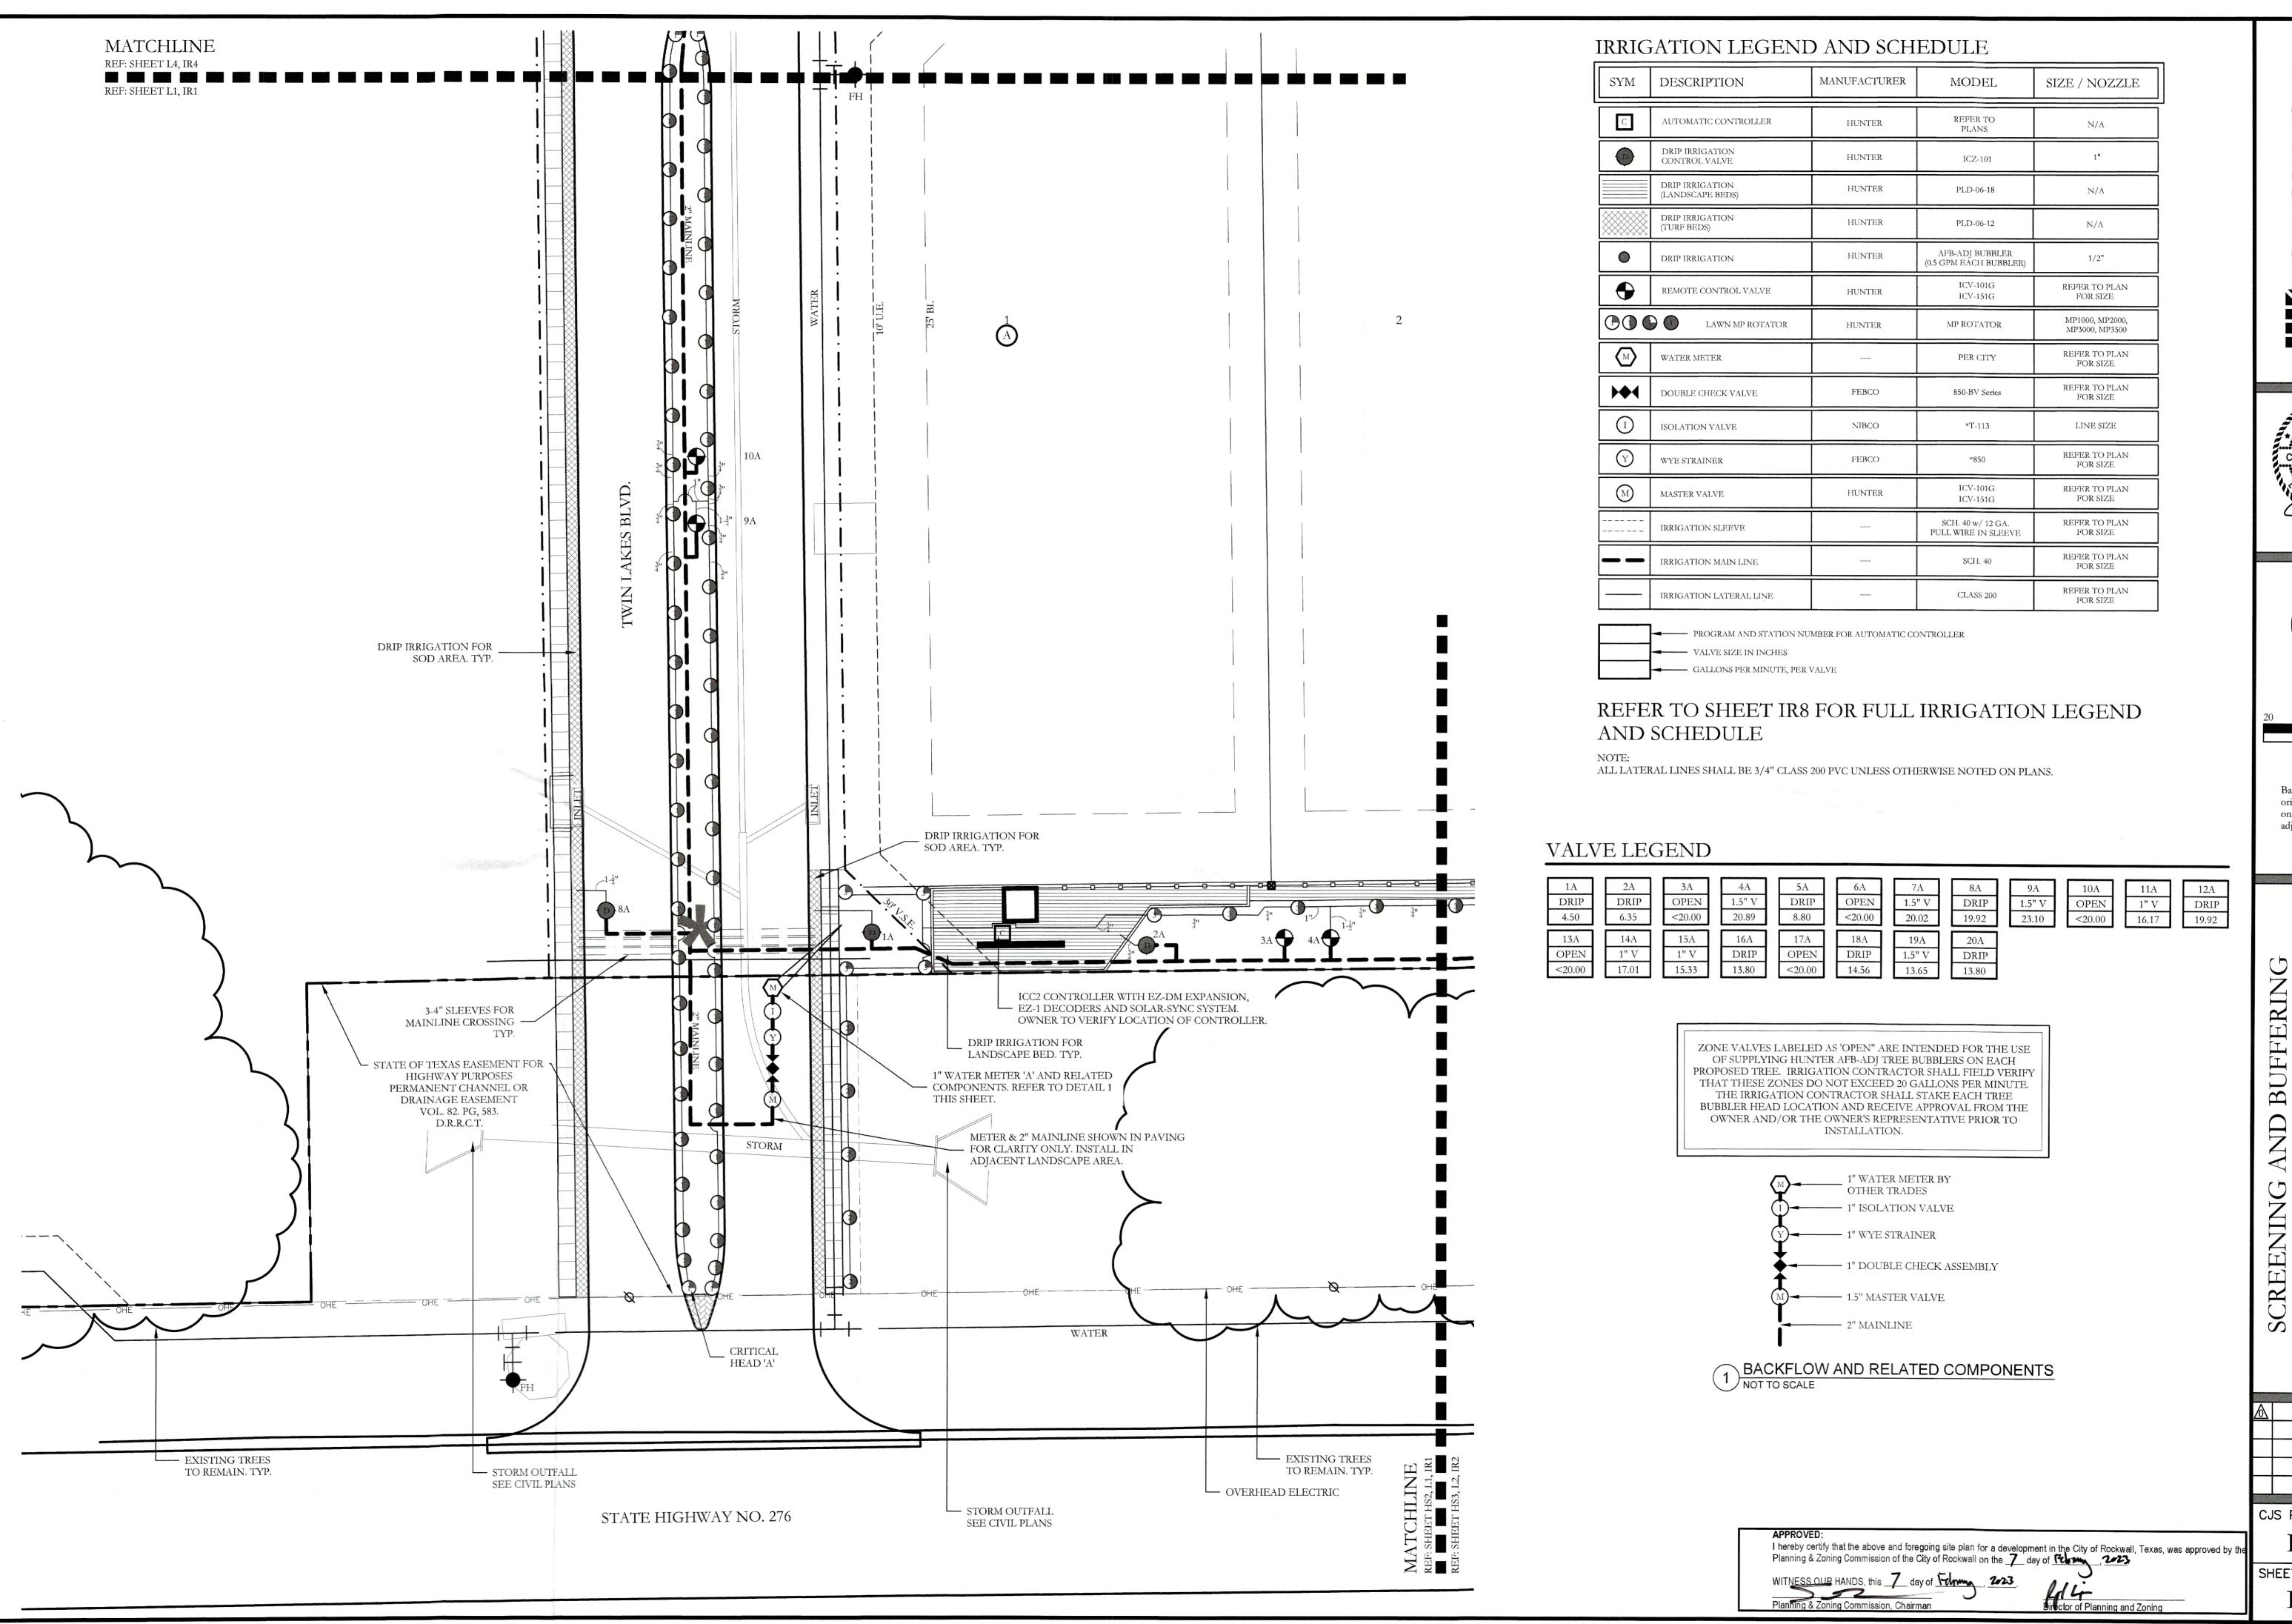

JOHNSON VOLK CONSULTING





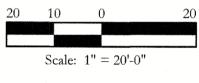

Bar is one inch on original drawing. If not one inch on this sheet, adjust scale as necessary. One Inch


BUFFERING

CJS PROJECT NO.

DLL001

SHEET NO.

IR1 of 9

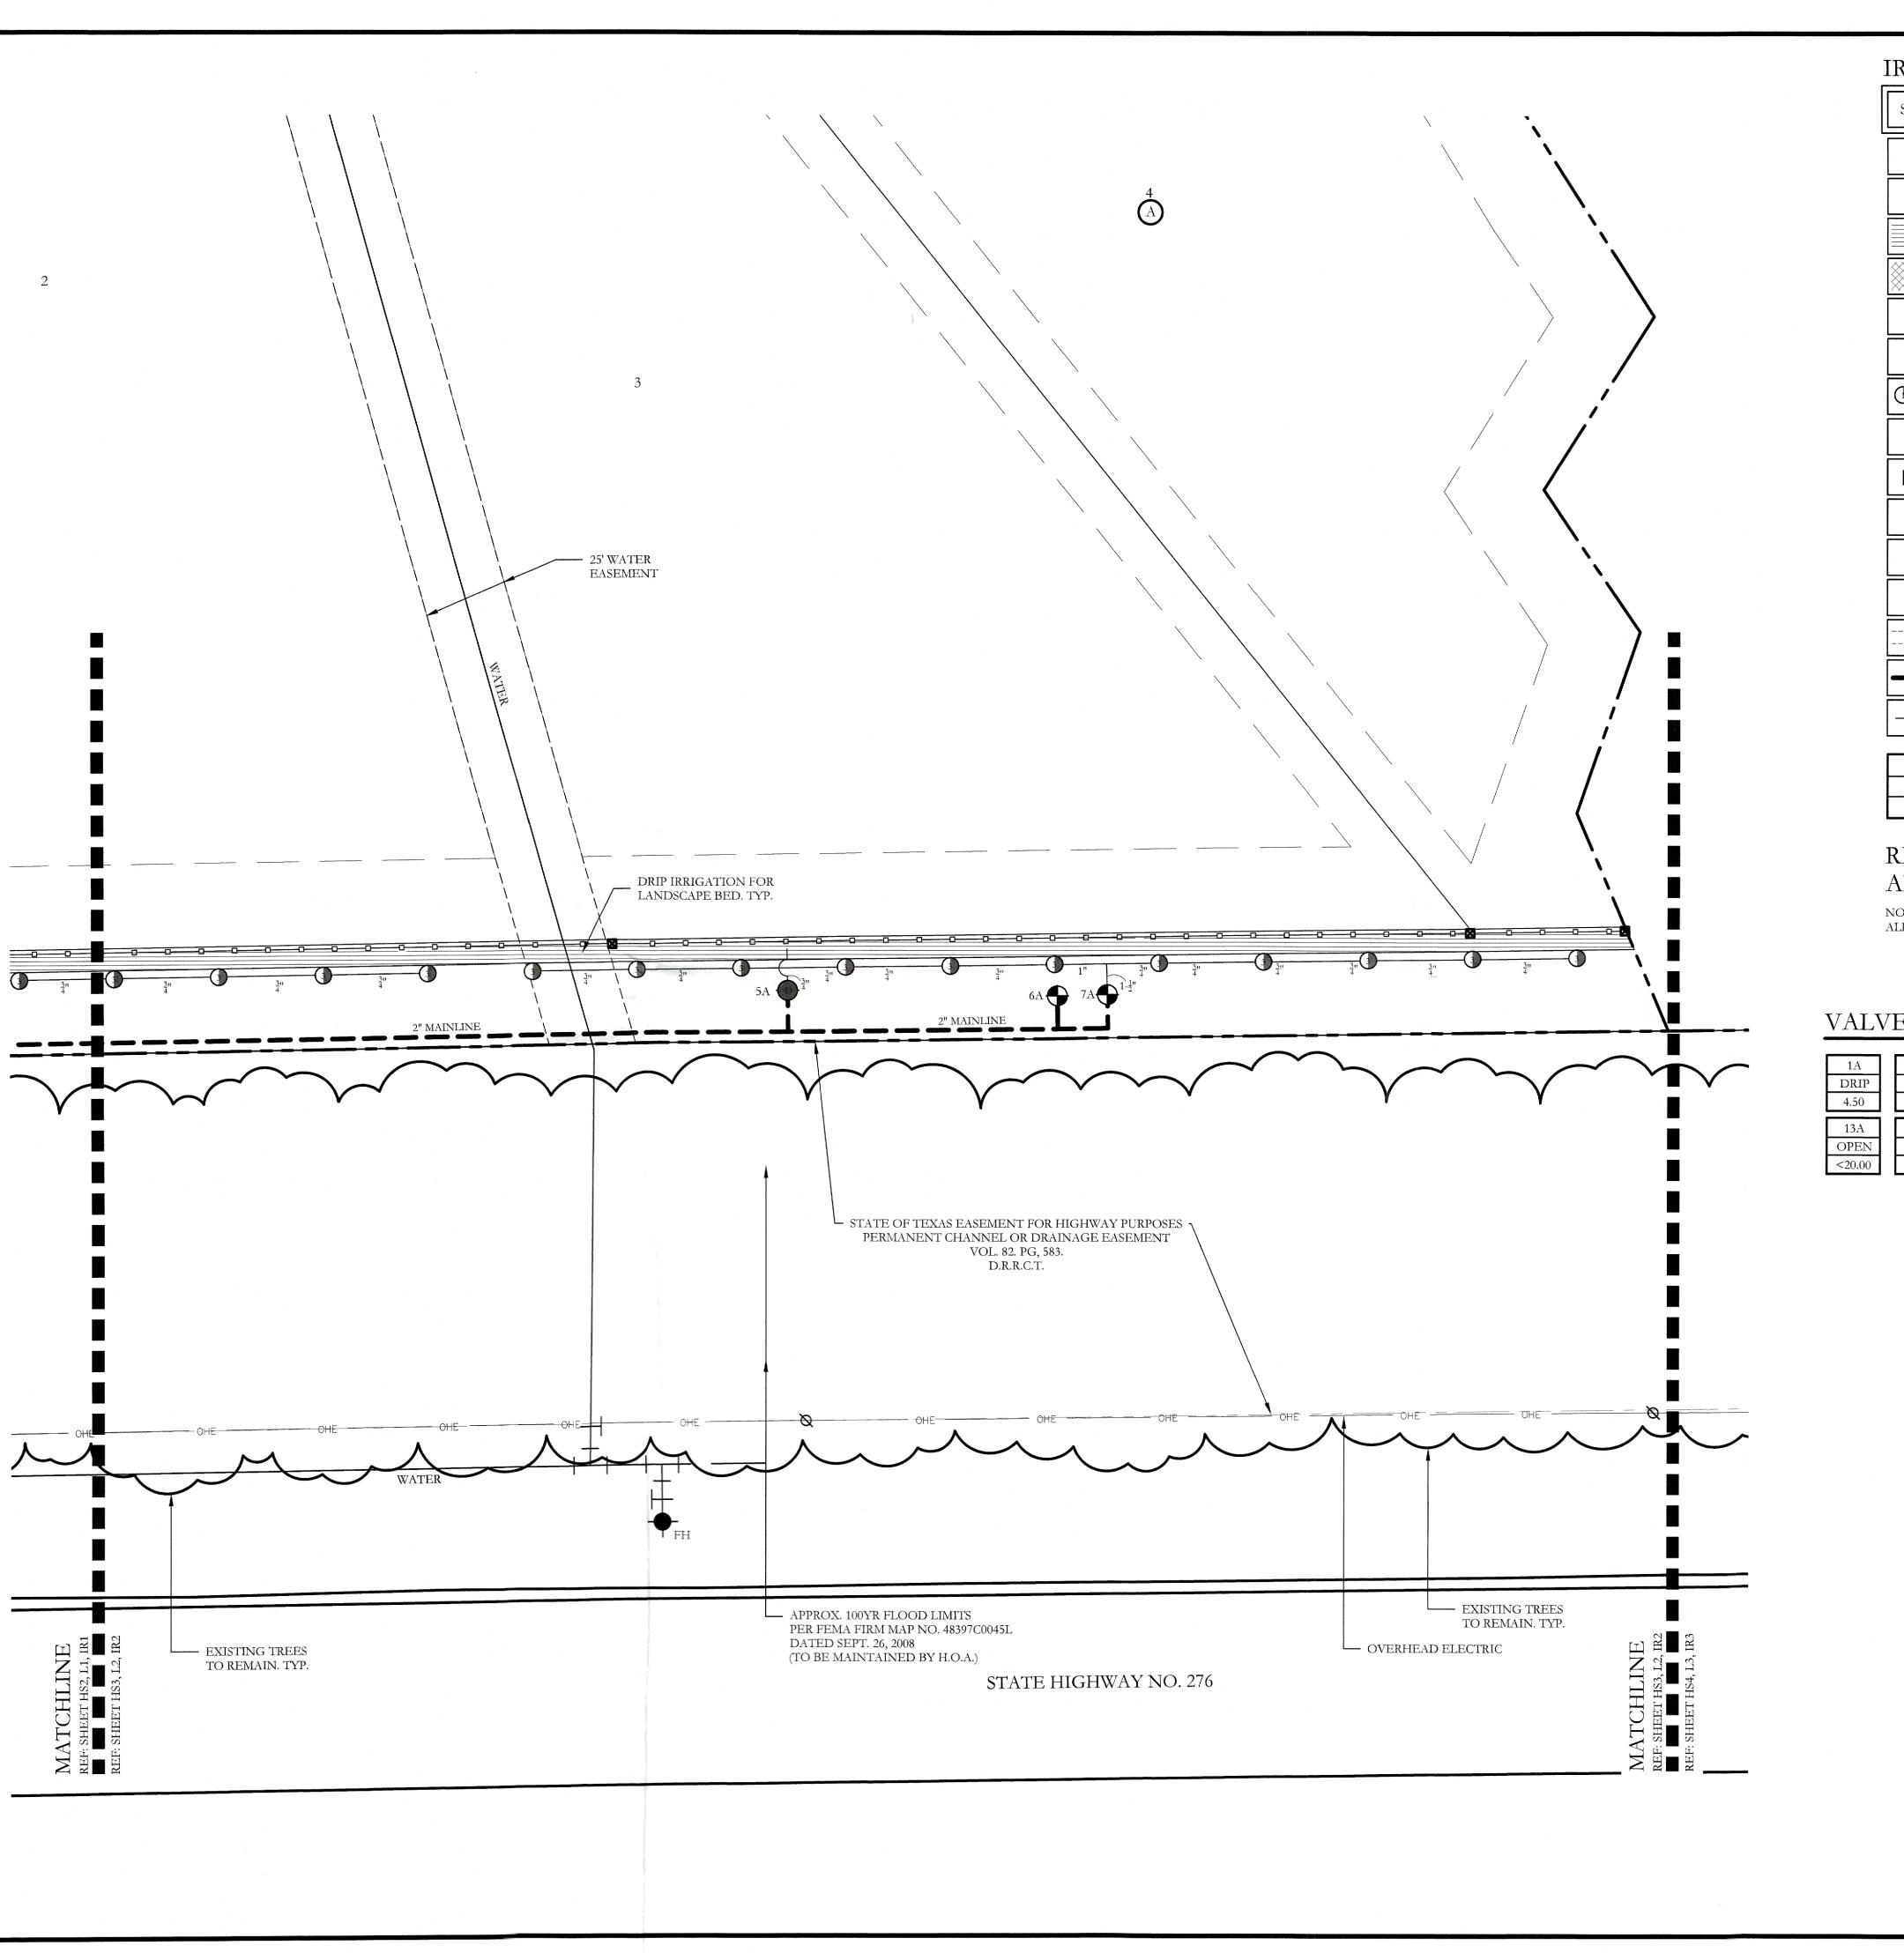

SYM	DESCRIPTION	MANUFACTURER	MODEL	SIZE / NOZZLE	
С	AUTOMATIC CONTROLLER	HUNTER	REFER TO PLANS	N/A	
(b)	DRIP IRRIGATION CONTROL VALVE	HUNTER	ICZ-101	1"	
	DRIP IRRIGATION (LANDSCAPE BEDS)	HUNTER	PLD-06-18	N/A	
	DRIP IRRIGATION (TURF BEDS)	HUNTER	PLD-06-12	N/A	
	DRIP IRRIGATION	HUNTER	AFB-ADJ BUBBLER (0.5 GPM EACH BUBBLER)	1/2"	
•	REMOTE CONTROL VALVE	HUNTER	ICV-101G ICV-151G	REFER TO PLAN FOR SIZE	
(1)	LAWN MP ROTATOR	HUNTER	MP ROTATOR	MP1000, MP2000, MP3000, MP3500	
M	WATER METER		PER CITY	REFER TO PLAN FOR SIZE	
>	DOUBLE CHECK VALVE	FEBCO	850-BV Series	REFER TO PLAN FOR SIZE	
1	ISOLATION VALVE	NIBCO	*T-113	line size	
Y	WYE STRAINER	FEBCO	*850	REFER TO PLAN FOR SIZE	
M	MASTER VALVE	HUNTER	ICV-101G ICV-151G	REFER TO PLAN FOR SIZE	
	IRRIGATION SLEEVE		SCH. 40 w/ 12 GA. PULL WIRE IN SLEEVE	REFER TO PLAN FOR SIZE	
	IRRIGATION MAIN LINE		SCH. 40	REFER TO PLAN FOR SIZE	
	IRRIGATION LATERAL LINE		CLASS 200	REFER TO PLAN FOR SIZE	

PROGRAM AND STATION NUMBER FOR AUTOMATIC CONTROLLER VALVE SIZE IN INCHES GALLONS PER MINUTE, PER VALVE


REFER TO SHEET IR8 FOR FULL IRRIGATION LEGEND AND SCHEDULE


ALL LATERAL LINES SHALL BE 3/4" CLASS 200 PVC UNLESS OTHERWISE NOTED ON PLANS.

VALVE LEGEND

	1A	2A	3A	4A	5A	6A	7A	8A	9A	10A	11A	12A
	DRIP	DRIP	OPEN	1.5" V	DRIP	OPEN	1.5" V	DRIP	1.5" V	OPEN	1" V	DRIP
L	4.50	6.35	<20.00	20.89	8.80	<20.00	20.02	19.92	23.10	<20.00	16.17	19.92
	13A	14A	15A	16A	17A	18A	19A	20A				
	OPEN	1" V	1" V	DRIP	OPEN	DRIP	1.5" V	DRIP				
	<20.00	17.01	15.33	13.80	<20.00	14.56	13.65	13.80				

ZONE VALVES LABELED AS 'OPEN" ARE INTENDED FOR THE USE OF SUPPLYING HUNTER AFB-ADJ TREE BUBBLERS ON EACH PROPOSED TREE. IRRIGATION CONTRACTOR SHALL FIELD VERIFY THAT THESE ZONES DO NOT EXCEED 20 GALLONS PER MINUTE. THE IRRIGATION CONTRACTOR SHALL STAKE EACH TREE BUBBLER HEAD LOCATION AND RECEIVE APPROVAL FROM THE OWNER AND/OR THE OWNER'S REPRESENTATIVE PRIOR TO INSTALLATION.

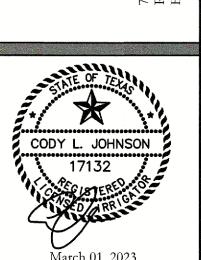

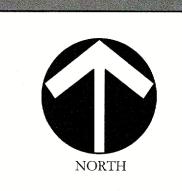

Scale: 1'' = 20'-0''


Bar is one inch on original drawing. If not one inch on this sheet, adjust scale as necessary.

CJS PROJECT NO.

DLL001

SHEET NO.

IR2 of 9

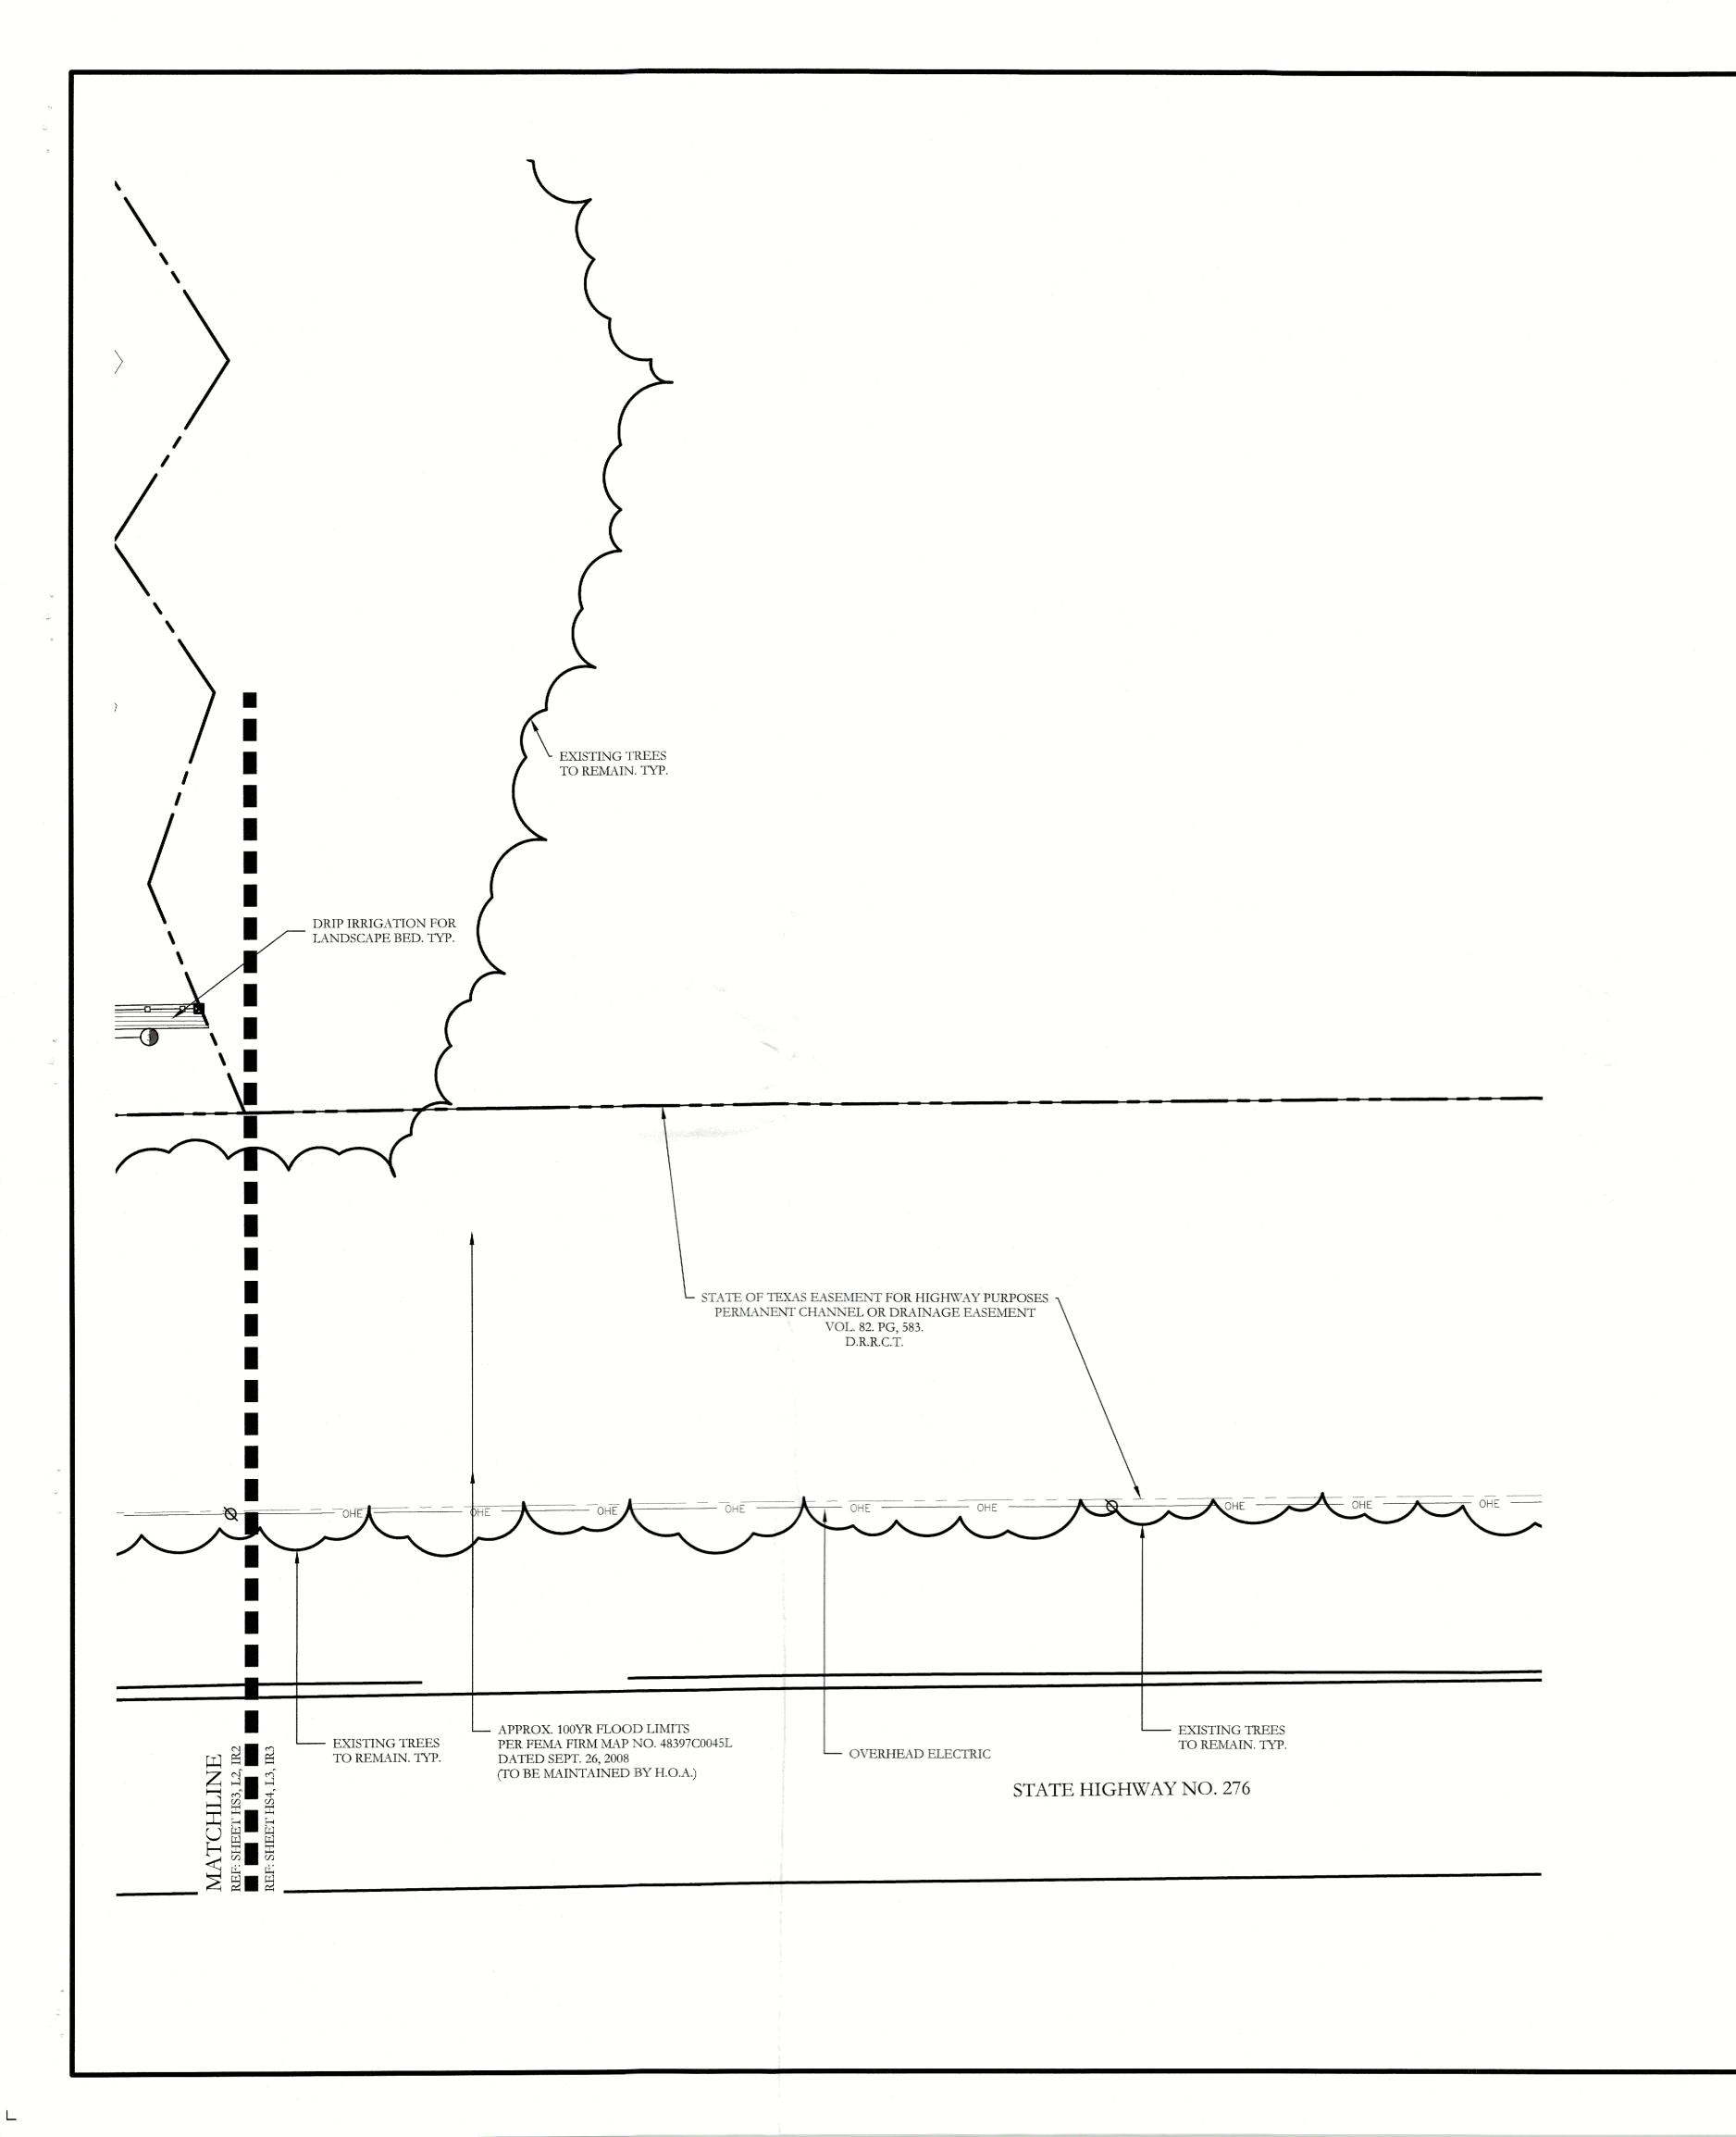

SYM	DESCRIPTION	MANUFACTURER	MODEL	SIZE / NOZZLE
С	AUTOMATIC CONTROLLER	HUNTER	REFER TO PLANS	N/A
(b)	DRIP IRRIGATION CONTROL VALVE	HUNTER	ICZ-101	1"
	DRIP IRRIGATION (LANDSCAPE BEDS)	HUNTER	PLD-06-18	N/A
	DRIP IRRIGATION (TURF BEDS)	HUNTER	PLD-06-12	N/A
	DRIP IRRIGATION	HUNTER	AFB-ADJ BUBBLER (0.5 GPM EACH BUBBLER)	1/2"
•	REMOTE CONTROL VALVE	HUNTER	ICV-101G ICV-151G	REFER TO PLAN FOR SIZE
(1)	LAWN MP ROTATOR	HUNTER	MP ROTATOR	MP1000, MP2000, MP3000, MP3500
M	WATER METER		PER CITY	REFER TO PLAN FOR SIZE
>	DOUBLE CHECK VALVE	FEBCO	850-BV Series	REFER TO PLAN FOR SIZE
1	ISOLATION VALVE	NIBCO	*T-113	LINE SIZE
Ŷ	WYE STRAINER	FEBCO	*850	REFER TO PLAN FOR SIZE
M	MASTER VALVE	HUNTER	ICV-101G ICV-151G	REFER TO PLAN FOR SIZE
	IRRIGATION SLEEVE		SCH. 40 w/ 12 GA. PULL WIRE IN SLEEVE	REFER TO PLAN FOR SIZE
	IRRIGATION MAIN LINE		SCH. 40	REFER TO PLAN FOR SIZE
	IRRIGATION LATERAL LINE		CLASS 200	REFER TO PLAN FOR SIZE

PROGRAM AND STATION NUMBER FOR AUTOMATIC CONTROLLER

VALVE SIZE IN INCHES GALLONS PER MINUTE, PER VALVE

REFER TO SHEET IR8 FOR FULL IRRIGATION LEGEND AND SCHEDULE

ALL LATERAL LINES SHALL BE 3/4" CLASS 200 PVC UNLESS OTHERWISE NOTED ON PLANS.

VALVE LEGEND

			 									-		
1A	2A	3A	4A	5A	6A	7A	8A		9A	Γ	10A	11A	Γ	12A
DRIP	DRIP	OPEN	1.5" V	DRIP	OPEN	1.5" V	DRIP	I	1.5" V		OPEN	1" V	ı	DRIP
4.50	6.35	<20.00	20.89	8.80	<20.00	20.02	19.92		23.10	Ŀ	<20.00	16.17		19.92
13A	14A	15A	16A	17A	18A	19A	20A							
OPEN	1" V	1" V	DRIP	OPEN	DRIP	1.5" V	DRIP							
<20.00	17.01	15.33	13.80	<20.00	14.56	13.65	13.80							

ZONE VALVES LABELED AS 'OPEN" ARE INTENDED FOR THE USE OF SUPPLYING HUNTER AFB-ADJ TREE BUBBLERS ON EACH PROPOSED TREE. IRRIGATION CONTRACTOR SHALL FIELD VERIFY THAT THESE ZONES DO NOT EXCEED 20 GALLONS PER MINUTE. THE IRRIGATION CONTRACTOR SHALL STAKE EACH TREE BUBBLER HEAD LOCATION AND RECEIVE APPROVAL FROM THE OWNER AND/OR THE OWNER'S REPRESENTATIVE PRIOR TO INSTALLATION.

IRRIGATION LEGEND AND SCHEDULE


SYM	DESCRIPTION	MANUFACTURER	MODEL	SIZE / NOZZLE
С	AUTOMATIC CONTROLLER	HUNTER	REFER TO PLANS	N/A
	DRIP IRRIGATION CONTROL VALVE	HUNTER	ICZ-101	1"
	DRIP IRRIGATION (LANDSCAPE BEDS)	HUNTER	PLD-06-18	N/A
	DRIP IRRIGATION (TURF BEDS)	HUNTER	PLD-06-12	N/A
0	DRIP IRRIGATION	HUNTER	AFB-ADJ BUBBLER (0.5 GPM EACH BUBBLER)	1/2"
•	REMOTE CONTROL VALVE	HUNTER	ICV-101G ICV-151G	REFER TO PLAN FOR SIZE
00	LAWN MP ROTATOR	HUNTER	MP ROTATOR	MP1000, MP2000, MP3000, MP3500
M	WATER METER		PER CITY	REFER TO PLAN FOR SIZE
>	DOUBLE CHECK VALVE	FEBCO	850-BV Series	REFER TO PLAN FOR SIZE
1	ISOLATION VALVE	NIBCO	*T-113	line size
Ŷ	WYE STRAINER	FEBCO	*850	REFER TO PLAN FOR SIZE
M	MASTER VALVE	HUNTER	ICV-101G ICV-151G	REFER TO PLAN FOR SIZE
	IRRIGATION SLEEVE		SCH. 40 w/ 12 GA. PULL WIRE IN SLEEVE	REFER TO PLAN FOR SIZE
	IRRIGATION MAIN LINE		SCH. 40	REFER TO PLAN FOR SIZE
	IRRIGATION LATERAL LINE		CLASS 200	REFER TO PLAN FOR SIZE

Scale: 1'' = 20'-0''

Bar is one inch on original drawing. If not one inch on this sheet, adjust scale as necessary.

CJS PROJECT NO. DLL001

SHEET NO. IR3 of 9

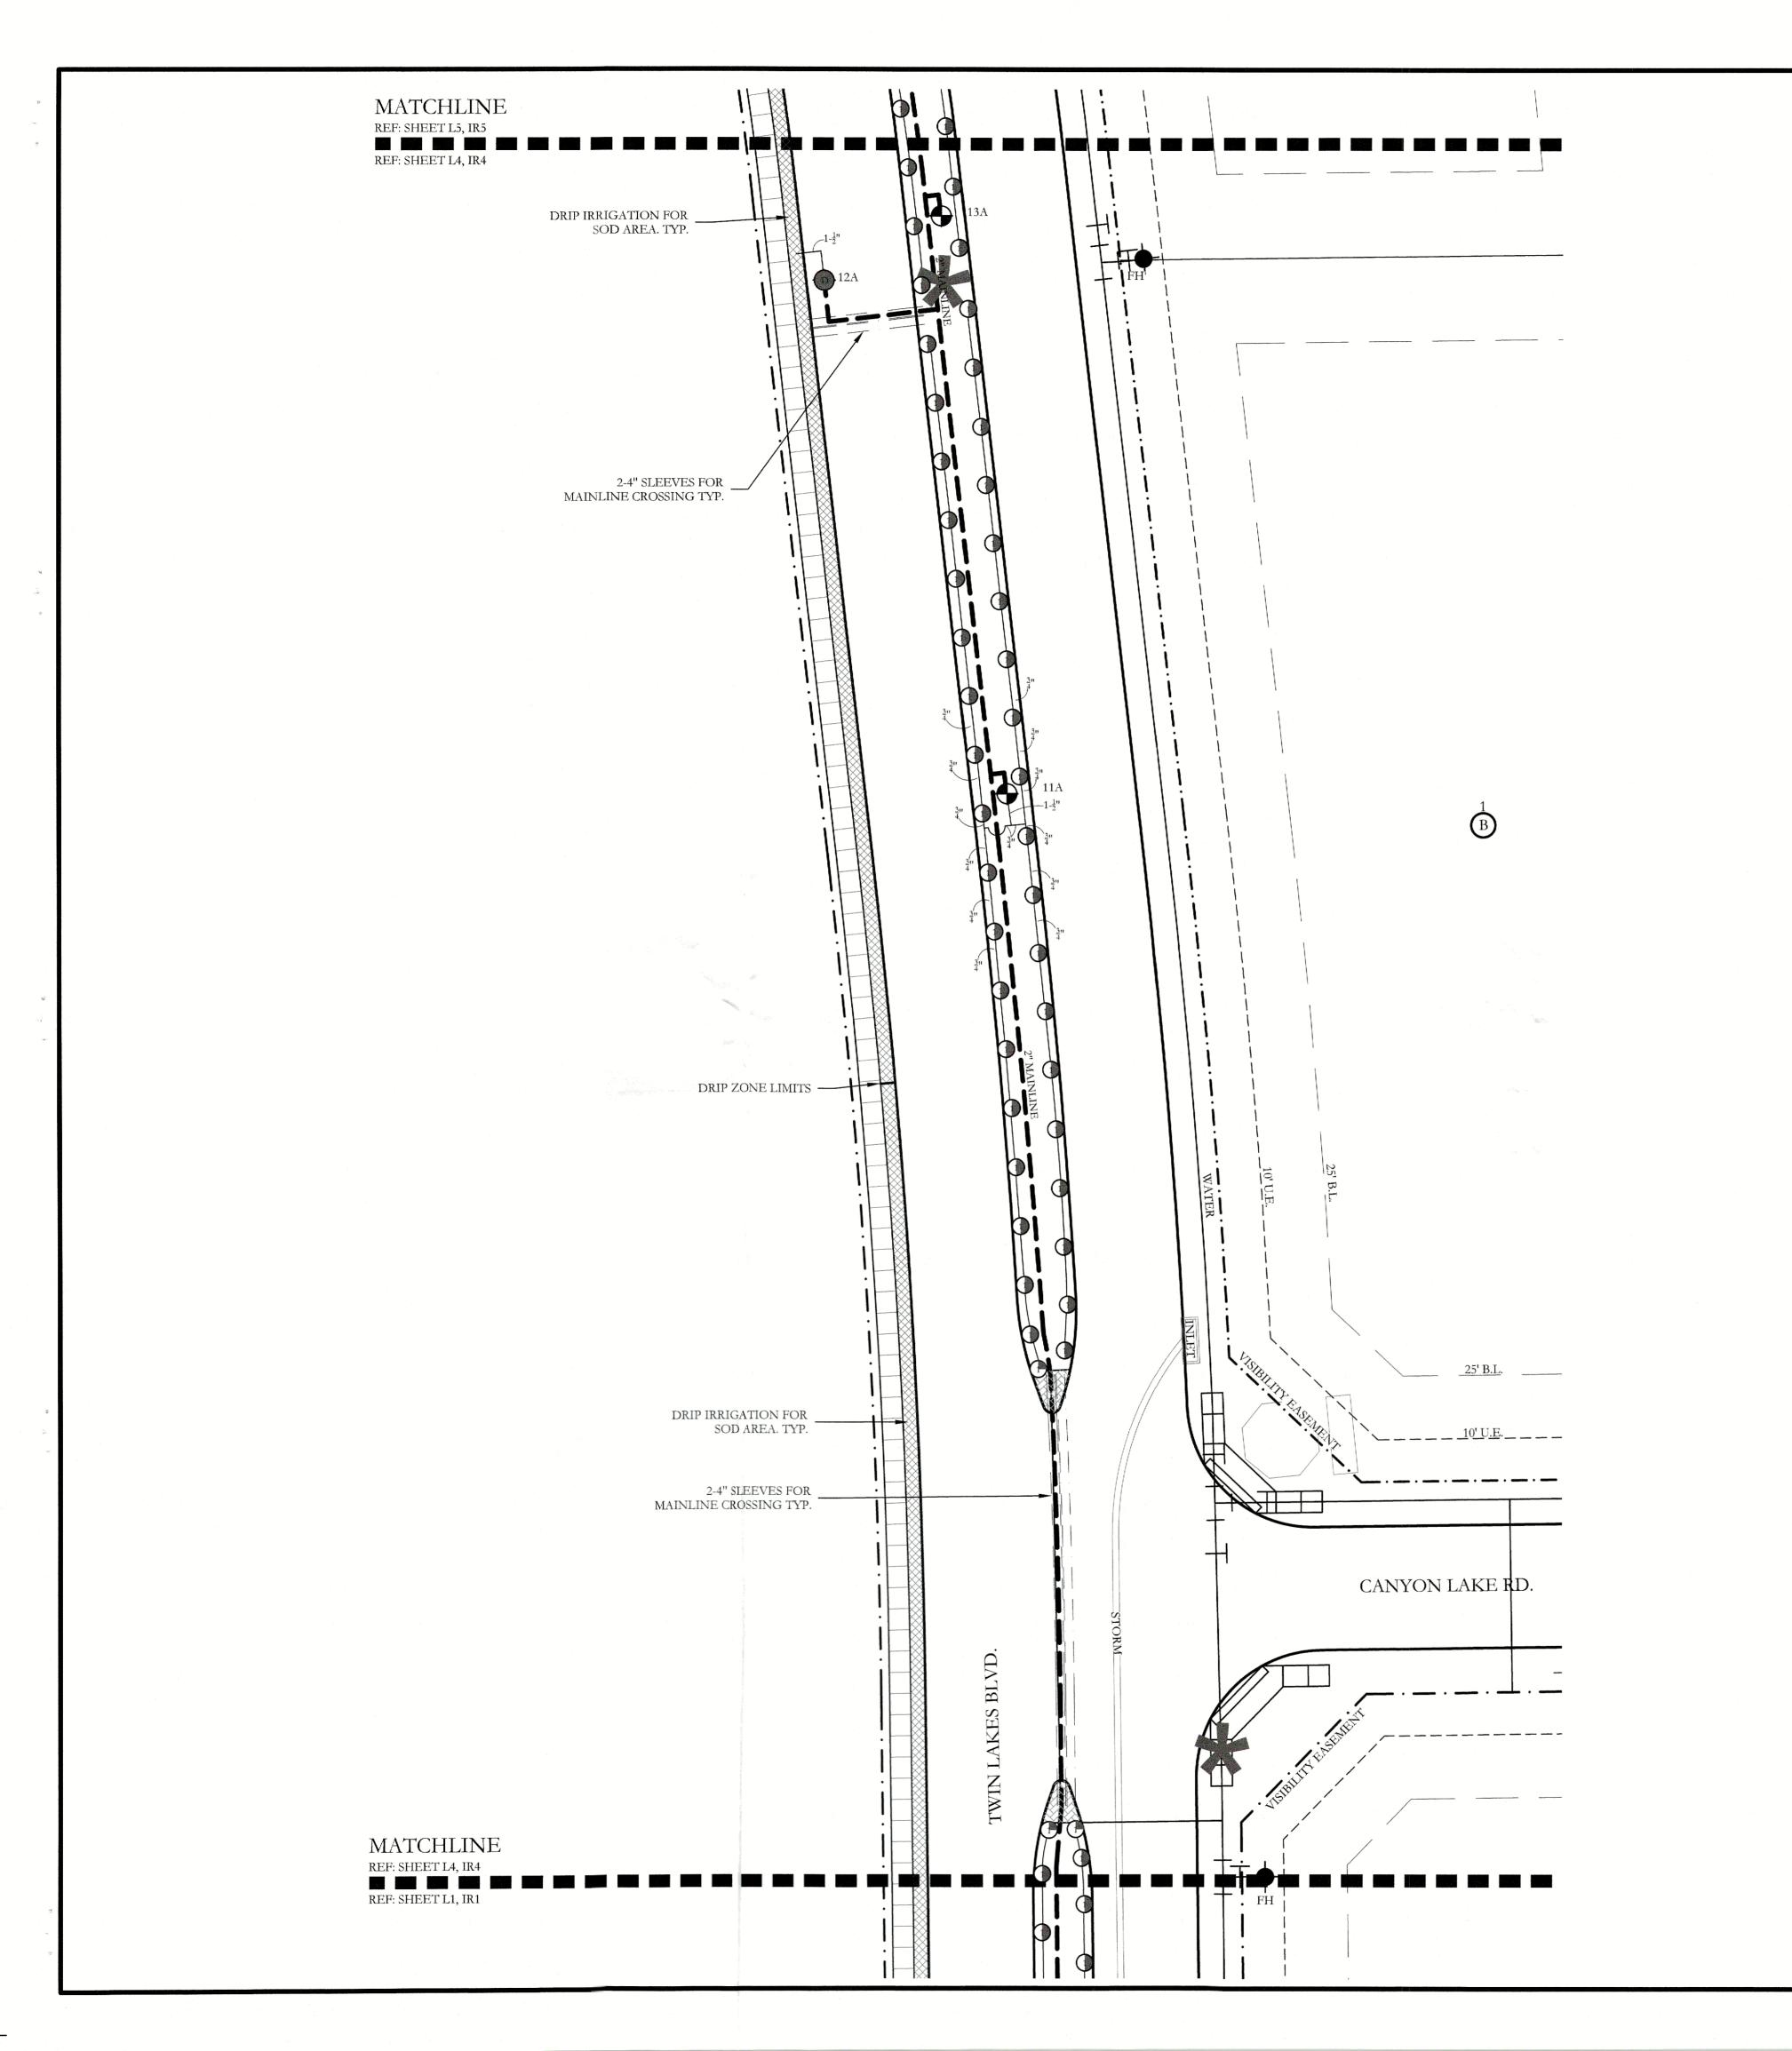

SYM	DESCRIPTION	MANUFACTURER	MODEL	SIZE / NOZZLE
С	AUTOMATIC CONTROLLER	HUNTER	REFER TO PLANS	N/A
(DRIP IRRIGATION CONTROL VALVE	HUNTER	ICZ-101	1"
	DRIP IRRIGATION (LANDSCAPE BEDS)	HUNTER	PLD-06-18	N/A
	DRIP IRRIGATION (TURF BEDS)	HUNTER	PLD-06-12	N/A
	DRIP IRRIGATION	HUNTER	AFB-ADJ BUBBLER (0.5 GPM EACH BUBBLER)	1/2"
•	REMOTE CONTROL VALVE	HUNTER	ICV-101G ICV-151G	REFER TO PLAN FOR SIZE
(1)	LAWN MP ROTATOR	HUNTER	MP ROTATOR	MP1000, MP2000, MP3000, MP3500
M	WATER METER		PER CITY	REFER TO PLAN FOR SIZE
>	DOUBLE CHECK VALVE	FEBCO	850-BV Series	REFER TO PLAN FOR SIZE
1	ISOLATION VALVE	NIBCO	*T-113	LINE SIZE
Ŷ	WYE STRAINER	FEBCO	*850	REFER TO PLAN FOR SIZE
M	MASTER VALVE	HUNTER	ICV-101G ICV-151G	REFER TO PLAN FOR SIZE
	IRRIGATION SLEEVE		SCH. 40 w/ 12 GA. PULL WIRE IN SLEEVE	REFER TO PLAN FOR SIZE
	IRRIGATION MAIN LINE		SCH. 40	REFER TO PLAN FOR SIZE
	IRRIGATION LATERAL LINE		CLASS 200	REFER TO PLAN FOR SIZE

PROGRAM AND STATION NUMBER FOR AUTOMATIC CONTROLLER VALVE SIZE IN INCHES GALLONS PER MINUTE, PER VALVE

REFER TO SHEET IR8 FOR FULL IRRIGATION LEGEND AND SCHEDULE

ALL LATERAL LINES SHALL BE 3/4" CLASS 200 PVC UNLESS OTHERWISE NOTED ON PLANS.

VALVE LEGEND


_																		
	1A		2A		3A	4A	5A	6A	7A	8A		9A		10A		11A	ſ	12A
	DRIP]	DRIP		OPEN	1.5" V	DRIP	OPEN	1.5" V	DRIP	ı	1.5" V	1	OPEN		1" V	ı	DRIP
L	4.50		6.35		<20.00	20.89	8.80	<20.00	20.02	19.92		23.10		<20.00		16.17	1	19.92
	13A		14A		15A	16A	17A	18A	19A	20A					•		Ī	
	OPEN		1" V		1" V	DRIP	OPEN	DRIP	1.5" V	DRIP								
	<20.00		17.01	1	15.33	13.80	<20.00	14.56	13.65	13.80								


ZONE VALVES LABELED AS 'OPEN" ARE INTENDED FOR THE USE BUBBLER HEAD LOCATION AND RECEIVE APPROVAL FROM THE OWNER AND/OR THE OWNER'S REPRESENTATIVE PRIOR TO INSTALLATION.

Director of Planning and Zoning

JOHNSON VOLK CONSULTING



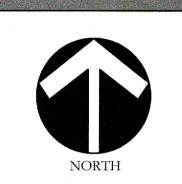

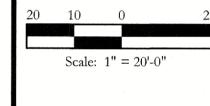

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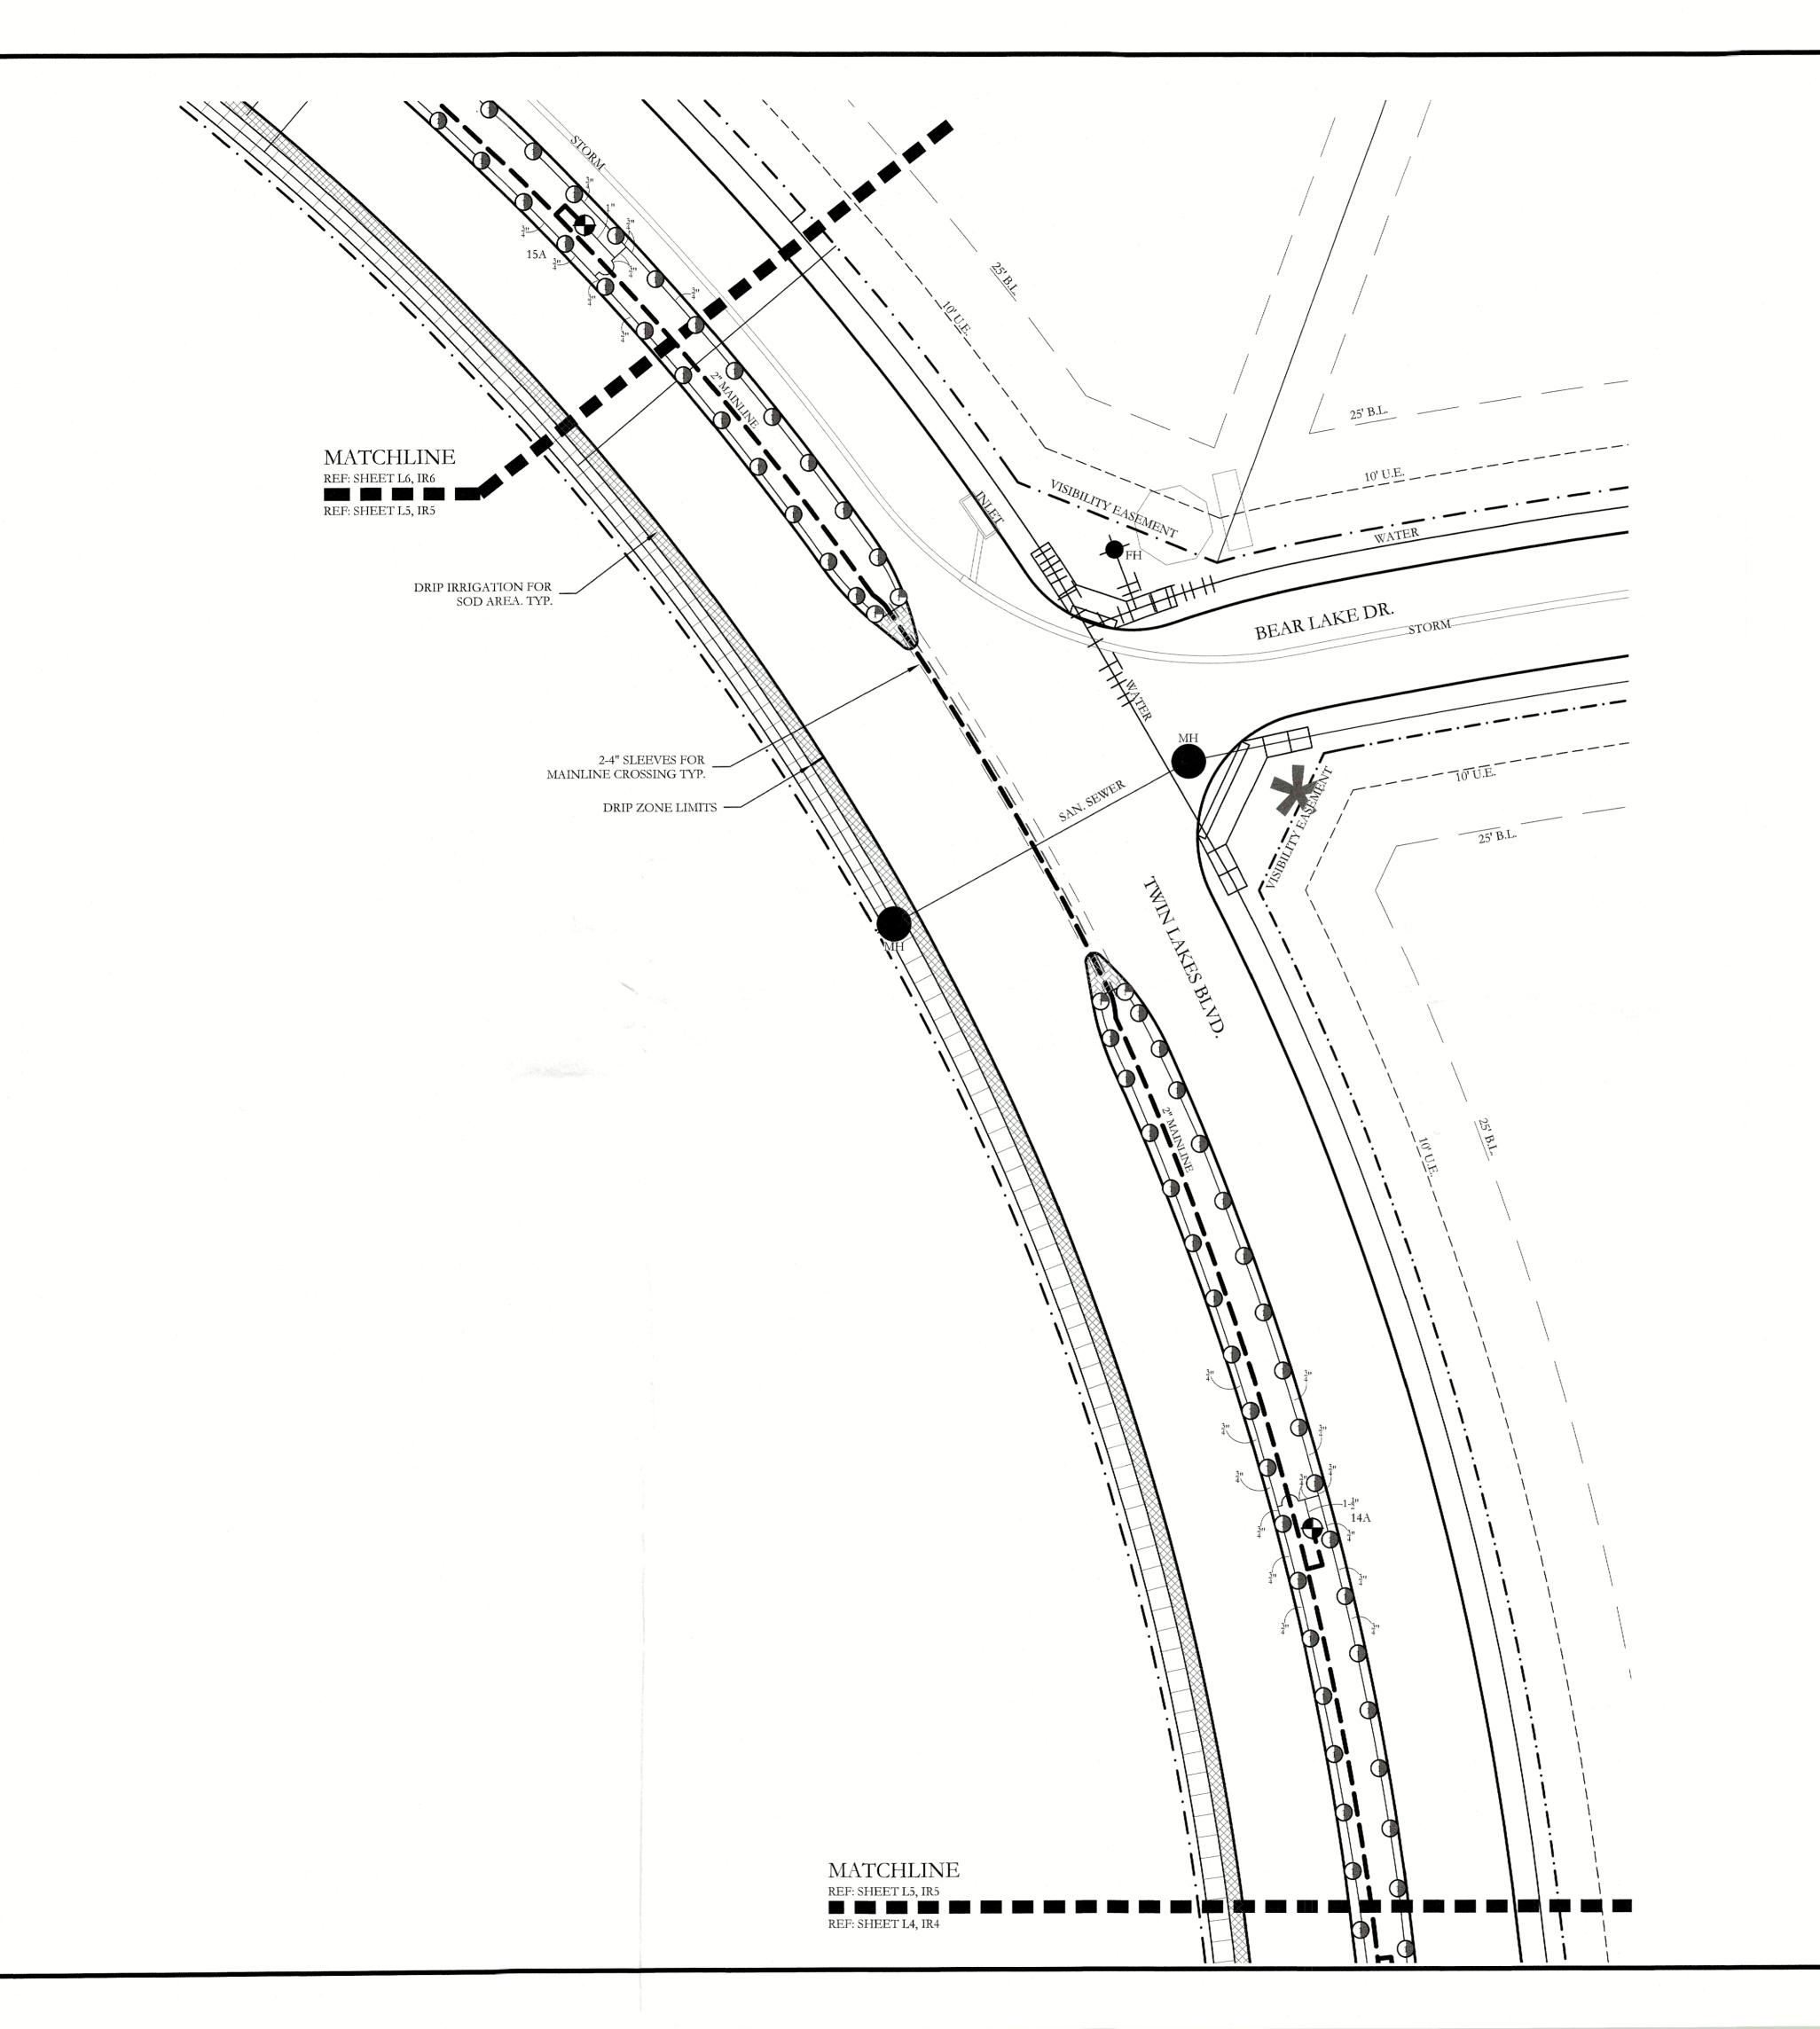
AND BUFFERING

Irrigation Plan SCREENING

CJS PROJECT NO.

SHEET NO. IR4 of <u>9</u>

DLL001



SYM	DESCRIPTION	MANUFACTURER	MODEL	SIZE / NOZZLE
С	AUTOMATIC CONTROLLER	HUNTER	REFER TO PLANS	N/A
(DRIP IRRIGATION CONTROL VALVE	HUNTER	ICZ-101	1"
	DRIP IRRIGATION (LANDSCAPE BEDS)	HUNTER	PLD-06-18	N/A
	DRIP IRRIGATION (TURF BEDS)	HUNTER	PLD-06-12	N/A
	DRIP IRRIGATION	HUNTER	AFB-ADJ BUBBLER (0.5 GPM EACH BUBBLER)	1/2"
•	REMOTE CONTROL VALVE	HUNTER	ICV-101G ICV-151G	REFER TO PLAN FOR SIZE
000	LAWN MP ROTATOR	HUNTER	MP ROTATOR	MP1000, MP2000, MP3000, MP3500
M	WATER METER		PER CITY	REFER TO PLAN FOR SIZE
>	DOUBLE CHECK VALVE	FEBCO	850-BV Series	REFER TO PLAN FOR SIZE
1	ISOLATION VALVE	NIBCO	*T-113	LINE SIZE
Ŷ	WYE STRAINER	FEBCO	*850	REFER TO PLAN FOR SIZE
M	MASTER VALVE	HUNTER	ICV-101G ICV-151G	REFER TO PLAN FOR SIZE
	IRRIGATION SLEEVE		SCH. 40 w/ 12 GA. PULL WIRE IN SLEEVE	REFER TO PLAN FOR SIZE
	IRRIGATION MAIN LINE		SCH. 40	REFER TO PLAN FOR SIZE
	IRRIGATION LATERAL LINE		CLASS 200	REFER TO PLAN FOR SIZE

PROGRAM AND STATION NUMBER FOR AUTOMATIC CONTROLLER VALVE SIZE IN INCHES GALLONS PER MINUTE, PER VALVE

REFER TO SHEET IR8 FOR FULL IRRIGATION LEGEND AND SCHEDULE

NOTE: ALL LATERAL LINES SHALL BE 3/4" CLASS 200 PVC UNLESS OTHERWISE NOTED ON PLANS.


VALVE LEGEND


										_		_		
1A	ſ	2A	3A	4A	5A	6A	7A	8A	9A		10A		11A	12A
DRIP		DRIP	OPEN	1.5" V	DRIP	OPEN	1.5" V	DRIP	1.5" V		OPEN		1" V	DRIP
4.50		6.35	<20.00	20.89	8.80	<20.00	20.02	19.92	23.10		<20.00		16.17	19.92
13A		14A	15A	16A	17A	18A	19A	20A						
OPEN		1" V	1" V	DRIP	OPEN	DRIP	1.5" V	DRIP						
<20.00	1	17.01	15.33	13.80	<20.00	14.56	13.65	13.80						

ZONE VALVES LABELED AS 'OPEN" ARE INTENDED FOR THE USE OF SUPPLYING HUNTER AFB-ADJ TREE BUBBLERS ON EACH PROPOSED TREE. IRRIGATION CONTRACTOR SHALL FIELD VERIFY THAT THESE ZONES DO NOT EXCEED 20 GALLONS PER MINUTE. THE IRRIGATION CONTRACTOR SHALL STAKE EACH TREE BUBBLER HEAD LOCATION AND RECEIVE APPROVAL FROM THE OWNER AND/OR THE OWNER'S REPRESENTATIVE PRIOR TO INSTALLATION.

Director of Planning and Zoning



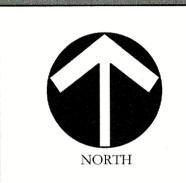

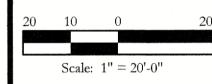

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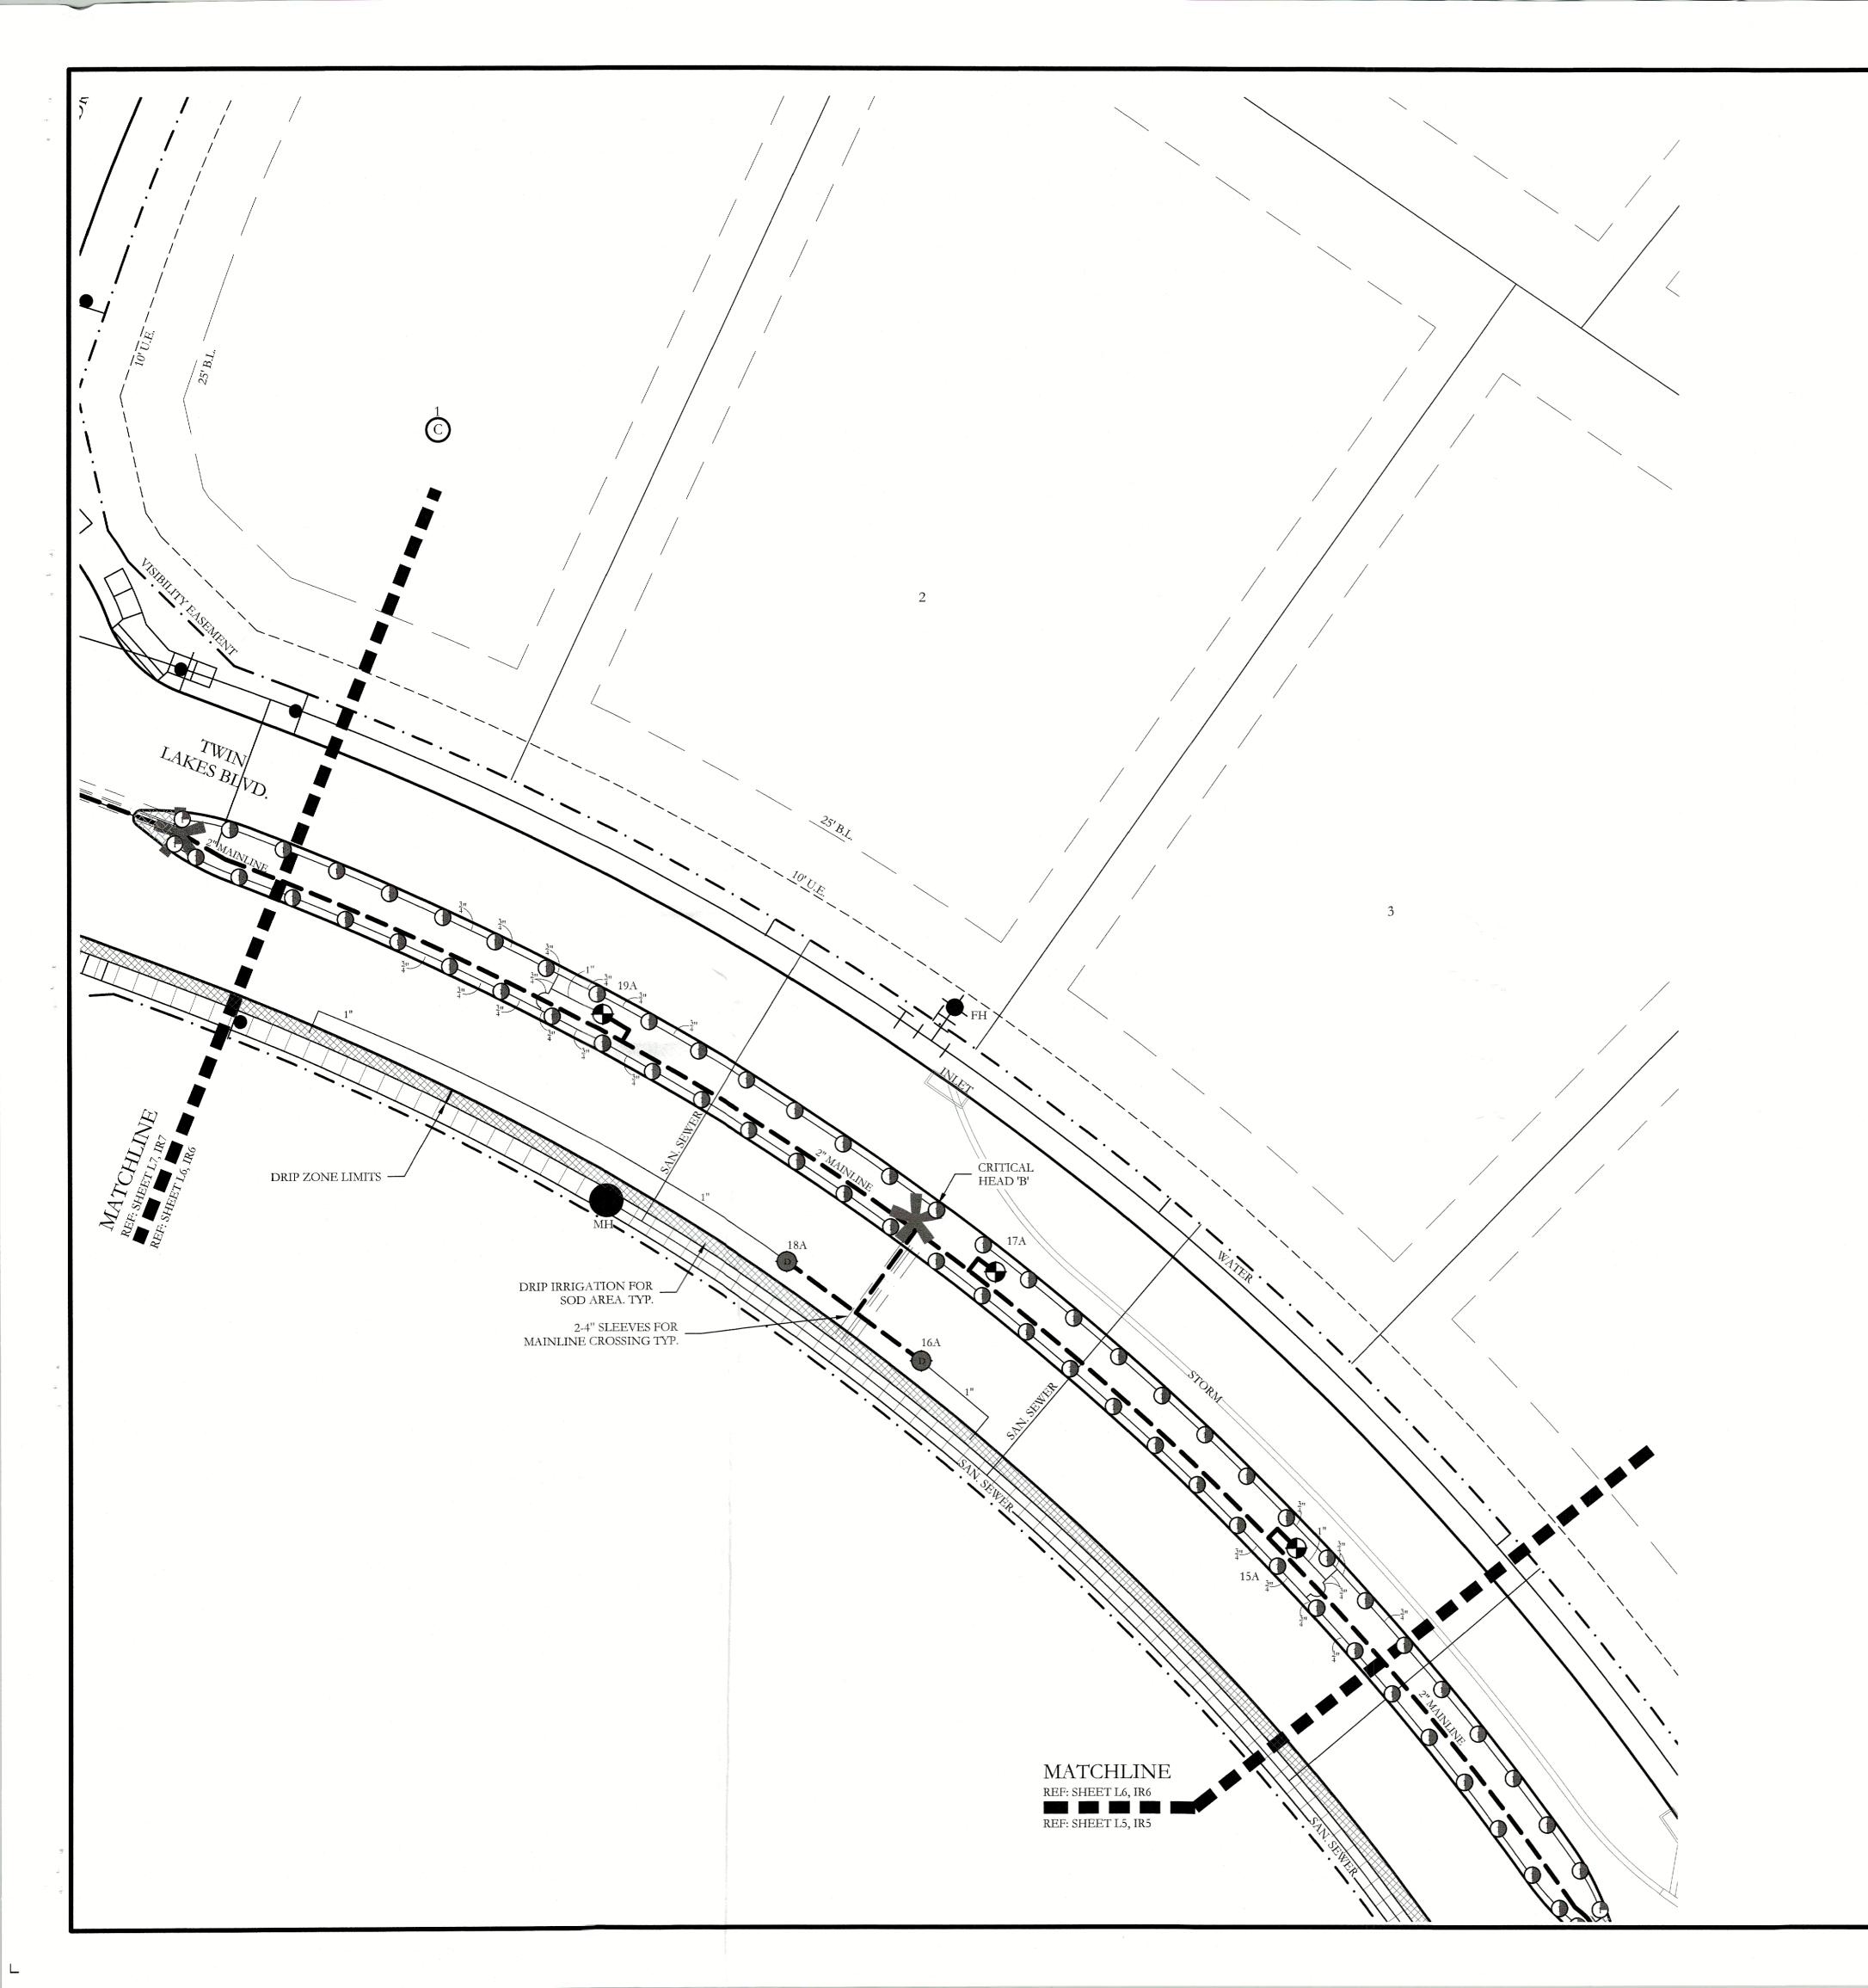
BUFFERING

SCREENING

CJS PROJECT NO. DLL001

SHEET NO.

IR5 of <u>9</u>



SYM	DESCRIPTION	MANUFACTURER	MODEL	SIZE / NOZZLE
С	AUTOMATIC CONTROLLER	HUNTER	REFER TO PLANS	N/A
D	DRIP IRRIGATION CONTROL VALVE	HUNTER	ICZ-101	1"
	DRIP IRRIGATION (LANDSCAPE BEDS)	HUNTER	PLD-06-18	N/A
	DRIP IRRIGATION (TURF BEDS)	HUNTER	PLD-06-12	N/A
	DRIP IRRIGATION	HUNTER	AFB-ADJ BUBBLER (0.5 GPM EACH BUBBLER)	1/2"
•	REMOTE CONTROL VALVE	HUNTER	ICV-101G ICV-151G	REFER TO PLAN FOR SIZE
00	LAWN MP ROTATOR	HUNTER	MP ROTATOR	MP1000, MP2000, MP3000, MP3500
M	WATER METER		PER CITY	REFER TO PLAN FOR SIZE
>	DOUBLE CHECK VALVE	FEBCO	850-BV Series	REFER TO PLAN FOR SIZE
I	ISOLATION VALVE	NIBCO	*T-113	LINE SIZE
Y	WYE STRAINER	FEBCO	*850	REFER TO PLAN FOR SIZE
M	MASTER VALVE	HUNTER	ICV-101G ICV-151G	REFER TO PLAN FOR SIZE
	IRRIGATION SLEEVE		SCH. 40 w/ 12 GA. PULL WIRE IN SLEEVE	REFER TO PLAN FOR SIZE
	IRRIGATION MAIN LINE		SCH. 40	REFER TO PLAN FOR SIZE
	IRRIGATION LATERAL LINE		CLASS 200	REFER TO PLAN FOR SIZE

PROGRAM AND STATION NUMBER FOR AUTOMATIC CONTROLLER

VALVE SIZE IN INCHES

—— GALLONS PER MINUTE, PER VALVE


REFER TO SHEET IR8 FOR FULL IRRIGATION LEGEND AND SCHEDULE

NOTE: ALL LATERAL LINES SHALL BE 3/4" CLASS 200 PVC UNLESS OTHERWISE NOTED ON PLANS.

VALVE LEGEND

	_		_							-		_					
1A		2A		3A	4A	5A	6A	7A	8A	ſ	9A	Γ	10A	ſ	11A	ſ	12A
DRIP		DRIP		OPEN	1.5" V	DRIP	OPEN	1.5" V	DRIP	ı	1.5" V	Ì	OPEN	t	1" V	t	DRIP
4.50		6.35		<20.00	20.89	8.80	<20.00	20.02	19.92		23.10	I	<20.00	I	16.17	Į	19.92
13A		14A		15A	16A	17A	18A	19A	20A							_	
OPEN		1" V		1" V	DRIP	OPEN	DRIP	1.5" V	DRIP								
<20.00		17.01	1	15 33	13.80	<20.00	14.56	13.65	13.80								

BUBBLER HEAD LOCATION AND RECEIVE APPROVAL FROM THE OWNER AND/OR THE OWNER'S REPRESENTATIVE PRIOR TO INSTALLATION.

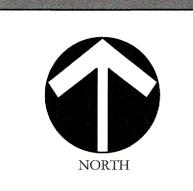

Bar is one inch on original drawing. If not one inch on this sheet, adjust scale as necessary.


AND BUFFERING

CJS PROJECT NO.

DLL001 SHEET NO.

Director of Planning and Zoning

IR6 of 9

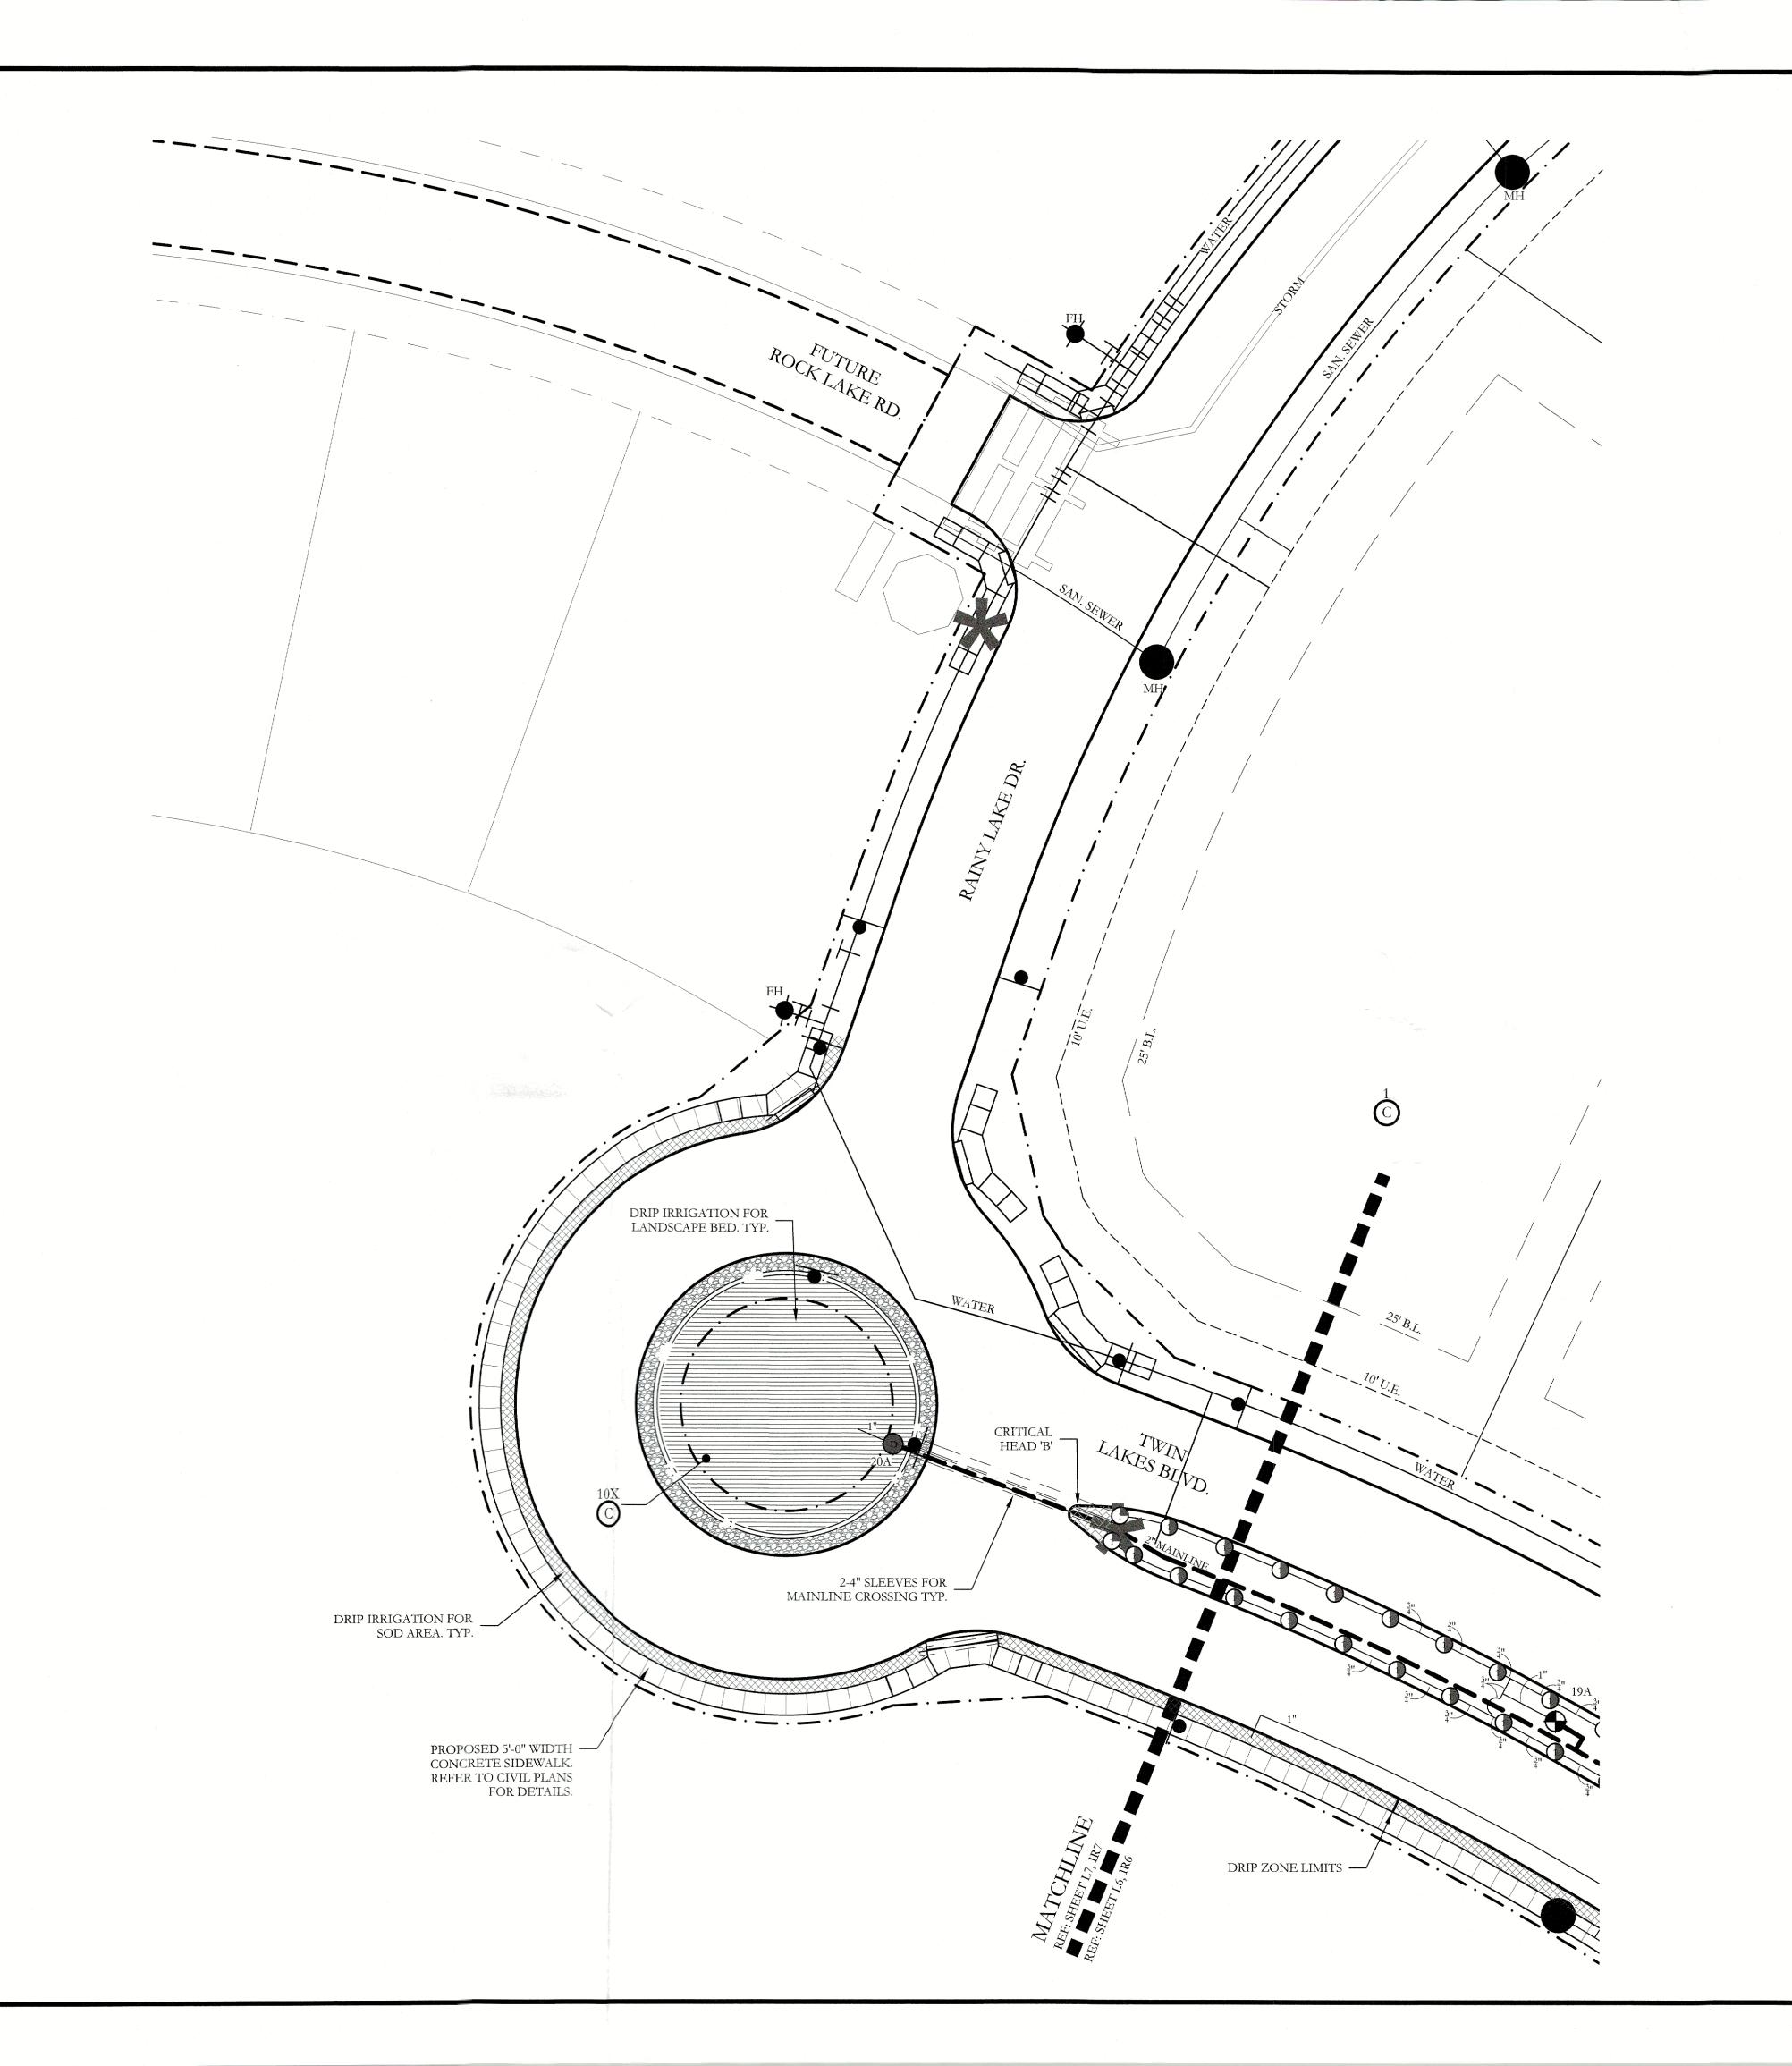

SYM	DESCRIPTION	MANUFACTURER	MODEL	SIZE / NOZZLE
С	AUTOMATIC CONTROLLER	HUNTER	REFER TO PLANS	N/A
D	DRIP IRRIGATION CONTROL VALVE	HUNTER	ICZ-101	1"
	DRIP IRRIGATION (LANDSCAPE BEDS)	HUNTER	PLD-06-18	N/A
	DRIP IRRIGATION (TURF BEDS)	HUNTER	PLD-06-12	N/A
	DRIP IRRIGATION	HUNTER	AFB-ADJ BUBBLER (0.5 GPM EACH BUBBLER)	1/2"
•	REMOTE CONTROL VALVE	HUNTER	ICV-101G ICV-151G	REFER TO PLAN FOR SIZE
	LAWN MP ROTATOR	HUNTER	MP ROTATOR	MP1000, MP2000, MP3000, MP3500
M	WATER METER		PER CITY	REFER TO PLAN FOR SIZE
>	DOUBLE CHECK VALVE	FEBCO	850-BV Series	REFER TO PLAN FOR SIZE
I	ISOLATION VALVE	NIBCO	*T-113	LINE SIZE
Ŷ	WYE STRAINER	FEBCO	*850	REFER TO PLAN FOR SIZE
M	MASTER VALVE	HUNTER	ICV-101G ICV-151G	REFER TO PLAN FOR SIZE
	IRRIGATION SLEEVE		SCH. 40 w/ 12 GA. PULL WIRE IN SLEEVE	REFER TO PLAN FOR SIZE
	IRRIGATION MAIN LINE		SCH. 40	REFER TO PLAN FOR SIZE
	IRRIGATION LATERAL LINE		CLASS 200	REFER TO PLAN FOR SIZE

PROGRAM AND STATION NUMBER FOR AUTOMATIC CONTROLLER • VALVE SIZE IN INCHES GALLONS PER MINUTE, PER VALVE

REFER TO SHEET IR8 FOR FULL IRRIGATION LEGEND AND SCHEDULE


NOTE: ALL LATERAL LINES SHALL BE 3/4" CLASS 200 PVC UNLESS OTHERWISE NOTED ON PLANS.

VALVE LEGEND

					-1468						
1A	2A	3A	4A	5A	6A	7A	8A	9A	10A	11A	12A
DRIP	DRIP	OPEN	1.5" V	DRIP	OPEN	1.5" V	DRIP	1.5" V	OPEN	1" V	DRIP
4.50	6.35	<20.00	20.89	8.80	<20.00	20.02	19.92	23.10	<20.00	16.17	19.92
13A	14A	15A	16A	17A	18A	19A	20A				
OPEN	1" V	1" V	DRIP	OPEN	DRIP	1.5" V	DRIP				
<20.00	17.01	15.33	13.80	<20.00	14.56	13.65	13.80				

ZONE VALVES LABELED AS 'OPEN" ARE INTENDED FOR THE USE OF SUPPLYING HUNTER AFB-ADJ TREE BUBBLERS ON EACH THE IRRIGATION CONTRACTOR SHALL STAKE EACH TREE BUBBLER HEAD LOCATION AND RECEIVE APPROVAL FROM THE OWNER AND/OR THE OWNER'S REPRESENTATIVE PRIOR TO INSTALLATION.



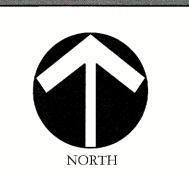

Scale: 1'' = 20'-0''

Bar is one inch on original drawing. If not one inch on this sheet, adjust scale as necessary.

CJS PROJECT NO.

DLL001

SHEET NO. IR7 of 9

TWO-WIRE IRRIGATION NOTES

PROVIDE A COMPLETE, FUNCTIONING AUTOMATIC IRRIGATION SYSTEM INCLUDING LABOR, MATERIALS, FEES, TAXES, EQUIPMENT, AND OTHER COSTS INCIDENTAL TO ACCOMPLISHING WORK.

ACQUIRE WRITTEN APPROVAL FROM THE LANDSCAPE ARCHITECT OR LICENSED IRRIGATOR FOR

MATERIAL SUBSTITUTES PRIOR TO BEGINNING INSTALLATION.

- FORTY EIGHT (48) HOURS BEFORE IRRIGATION CONSTRUCTION BEGINS, IRRIGATION CONTRACTOR MUST CALL (800) DIG-TESS AND IS RESPONSIBLE FOR LOCATING EXISTING UNDERGROUND UTILITIES AND/OR OBSTACLES PRIOR TO BEGINNING WORK. ANY DAMAGE TO UTILITIES AND/OR FINISHES FROM INFERIOR WORKMANSHIP BY THE IRRIGATION CONTRACTOR SHALL BE REPAIRED AT NO
- FROM INFERIOR WORKMANSHIP BY THE IRRIGATION CONTRACTOR SHALL BE REPAIRED AT NO ADDITIONAL COST TO THE OWNER.

 4. PIPING IS DIAGRAMMATIC AND SHOWN FOR CLARITY ONLY. ADJUST AS REQUIRED FOR EXISTING UTILITIES, OBSTRUCTIONS, TREE ROOT BALLS, ETC. PIPING AND VALVES SHOWN IN PAVING FOR
- CLARITY ONLY AND SHALL BE INSTALLED IN ADJACENT LANDSCAPE AREA. COORDINATE WITH THE CITY OR ENTITY INSPECTING THE IRRIGATION SYSTEM AND DETERMINE THE LOCAL RULES AND CODES TO ABIDE BY REGARDING MAINLINE AND LATERAL PIPING LOCATIONS.

 COORDINATE SLEEVE AND CONDUIT REQUIREMENTS WITH GENERAL CONTRACTOR. IRRIGATION SLEEVES SHALL BE AS FOLLOWS:
- 5.1. SLEEVES INTENDED FOR LATERAL LINES ARE TO BE ONE-FOUR INCH SLEEVE AND ARE TO BE NO MORE THAN A DEPTH OF TWO FEET BELOW TOP OF CURB. SLEEVES SHOULD EXTEND A MINIMUM OF 2'-0" BEYOND BACK OF CURB.
- 2. SLEEVES INTENDED FOR THE 2" MAINLINE ARE TO BE TWO-FOUR INCH SLEEVES SIDE BY SIDE AND ARE TO BE NO MORE THAN A DEPTH OF TWO FEET BELOW TOP OF CURB. SLEEVES SHOULD EXTEND A MINIMUM OF 2'-0" BEYOND BACK OF CURB.
- 6. LOCATE EACH END OF IRRIGATION SLEEVES DIMENSIONALLY ON THE RECORD "AS BUILT" DRAWINGS.
- 7. THE IRRIGATION CONTRACTOR SHALL COORDINATE THE INSTALLATION OF THE IRRIGATION SYSTEM WITH THE LANDSCAPE CONTRACTOR TO ENSURE ALL PLANT MATERIAL WILL BE WATERED IN ACCORDANCE WITH THE INTENT OF THE PLANS AND SPECIFICATIONS.
- THE IRRIGATION CONTRACTOR SHALL BE RESPONSIBLE FOR DAMAGE TO PLANT MATERIAL DUE TO SYSTEM FAILURE FROM INFERIOR WORKMANSHIP FOR THE DURATION OF THE INSTALLATION OF PLANT MATERIAL AND MAINTENANCE PERIOD FOLLOWING INSTALLATION.
- DIG WITHIN ALL EXISTING TREE DRIPLINE ZONES AT NO ADDITIONAL COST TO THE OWNER. THE IRRIGATION CONTRACTOR SHALL BE RESPONSIBLE TO STAKE AND RECEIVE APPROVAL FROM ALL DISCIPLINES PRIOR TO AN TRENCHING AND HAND DIGGING IN AREAS OF EXISTING TREE COVERAGE OR ANY ADDITIONAL AREAS THAT MIGHT BE QUESTIONABLE.
- 10. EXTEND EXTRA WIRE AND MAINLINE PAST THE FARTHEST VALVE, ROUTED PARALLEL AND PLACE IN 12"X17" PENTEK VALVE BOX WERE NOTED ON PLANS FOR FUTURE EXPANSION OF IRRIGATION SYSTEM AT A LATER DATE.
- 11. TWO WIRE PATH SHALL BE DIRECT BURIAL, 14 AWG OR STANDARD DECODER CABLE BY HUNTER WITH YELLOW JACKET (ID1YLW), RATED FOR DIRECT BURIAL APPLICATIONS, UF., UL., APPROVED. HUNTER ICD DECODERS SHALL BE USED ON ALL ZONE VALVE CONNECTIONS TO TWO WIRE PATH. CONTRACTOR TO USE MANUFACTURERS RECOMMENDATIONS OF WIRE SPLICING AND BURIAL TECHNIQUES AS DETAILED AT WWW.HUNTERINDUSTRIES.COM.
- 12. THE OWNER AND/OR LANDSCAPE ARCHITECT SHALL DETERMINE THE FINAL CONTROLLER LOCATION. THE IRRIGATION CONTRACTOR SHALL MAKE FINAL ELECTRICAL CONNECTION OF CONTROLLER PER LOCAL ELECTRICAL CODE. PROVIDE ALL NECESSARY FUSE BOXES, CONDUIT, FITTINGS, CONNECTORS OR OTHER ELECTRICAL DEVICES TO MAKE CONNECTION. OWNER SHALL PROVIDE ELECTRICAL SERVICE WITHIN 10 LINEAR FEET OF CONTROLLER LOCATION UNLESS NOTED OTHERWISE ON DRAWINGS.
- 13. CONNECT REMOTE SENSORS TO CONTROLLER WITH GROUND WIRE IN SERIES PRIOR TO
- CONNECTING TO REMOTE CONTROL VALVES.

 14. ALL P.V.C. MAINLINES AND LATERAL LINES SHALL RECEIVE AS FOLLOWS:
- 14.1. 18" MINIMUM COVER FOR MAIN LINES
- 14.2. 18" MINIMUM COVER FOR PIPING LOCATED UNDER PAVING14.3. 12" MINIMUM COVER FOR LATERAL LINES
- 15. THE MINIMUM DISTANCE BETWEEN THE MAINLINE AND LATERAL LINE FITTINGS (EXCEPT FOR REDUCER BUSHINGS) SHALL BE 18".
- 16. THE MINIMUM HORIZONTAL DISTANCE OF 36" SHALL BE MAINTAINED BETWEEN ANY VALVES THAT ARE INSTALLED SIDE BY SIDE.
- 17. WHERE SERVICE TREES ARE INSTALLED ON THE MAINLINE FOR INSTALLATION OF THE ELECTRIC VALVES AND/OR QUICK COUPLING VALVES, THE CONTRACTOR SHALL LIMIT THE NUMBER OF THESE PER SERVICE TEE. DO NOT INSTALL MORE THAN A TOTAL OF EITHER THREE ELECTRIC VALVES OR A COMBINATION OF TWO ELECTRIC VALVES AND ONE QUICK COUPLER VALVE AT EACH TEE. THE MINIMUM DISTANCE BETWEEN FITTINGS SHALL BE 18" AS REFERENCED IN THE ABOVE NOTES.
- 18. ALL PVC PIPE AND FITTINGS ARE TO BE PRIMED WITH PURPLE PVC PRIMER SOLVENT BEFORE APPLYING PVC CEMENT IN ACCORDANCE WITH THE UNIFORM PLUMBING CODE.
- APPLYING PVC CEMENT IN ACCORDANCE WITH THE UNIFORM PLUMBING CODE.

 19. INSTALL QUICK COUPLING VALVES IN 12"X17" PENTEK VALVE BOXES PER DETAIL SHOWN. CONNECT QUICK COUPLING VALVES TO MAINLINE PIPE WITH LASCO UNITIZED, O-RING SWING JOINTS PER DETAIL SHOWN, #T722-22. SUPPLY OWNER WITH THREE COUPLER KEYS WITH SWIVEL HOSE BIBB EACH, #33DK-10 AND #SH-0 RESPECTIVELY. VALVES TO BE INSTALLED SO THAT THE TOP OF THE QUICK COUPLER IS 2" BELOW BOTTOM OF VALVE BOX LID. PURPLE LID SHALL READ "NON-POTABLE, NOT SAFE FOR DRINKING" IN ENGLISH AND SPANISH.
- 20. ALL LATERAL LINES SHALL BE 3/4" CLASS 200 PVC UNLESS OTHERWISE NOTED ON PLANS.
 21. ZONE VALVES LABELED AS 'OPEN" ARE INTENDED FOR THE USE OF SUPPLYING HUNTER AFB-ADJ TREE BUBBLERS ON EACH PROPOSED TREE. IRRIGATION CONTRACTOR SHALL FIELD VERIFY THAT THESE ZONES DO NOT EXCEED 20 GALLONS PER MINUTE. THE IRRIGATION CONTRACTOR SHALL

STAKE EACH TREE BUBBLER HEAD LOCATION AND RECEIVE APPROVAL FROM THE OWNER AND/OR

- THE OWNER'S REPRESENTATIVE PRIOR TO INSTALLATION.

 22. ALL STATE OF TEXAS LAWS/RULES AND ALL LOCAL CODES/ORDINANCES AREA MADE PART OF THESE PLANS AND SPECIFICATIONS WHETHER SHOWN OR NOT. THESE LAWS AND ORDINANCES WILL SUPERCEDE THE PLANS, DETAILS, AND/OR SPECIFICATIONS FOR THIS PROJECT. THE
- IRRIGATION CONTRACTOR IS CAUTIONED THAT HE/SHE IS TO INCLUDE ANY AND ALL COST NECESSARY TO MEET OR EXCEED THE LAWS OF THE STATE OF TEXAS AND LOCAL CODES CONCERNING LANDSCAPE IRRIGATION.
 24. INCLUDE THE FOLLOWING ALLOWANCES FOR PROVIDING AND INSTALLING AIR RELIEF VALVES AND FLUSH VALVES FOR THE DRIP SYSTEM. EXACT QUANTITY AND LOCATION OF THESE DEVICES WILL BE DETERMINED AT THE TIME OF INSTALLATION. IN GENERAL, ALL AIR RELIEF VALVES WILL BE INSTALLED AT THE HIGH POINTS AND FLUSH VALVES WILL BE INSTALLED AT THE LOW POINTS
- FLUSH VALVE FOR EACH DRIP ZONE KIT.

 25. INCLUDE THE FOLLOWING ALLOWANCE FOR PROVIDING AND INSTALLING DRIP INDICATOR FOR THE DRIP SYSTEM. LOCATION OF DRIP INDICATOR SHOULD BE CENTERED IN DRIP ZONE.

OF EXHAUST HEADER. ALLOW FOR APPROXIMATELY (1) AIR RELIEF AND APPROXIMATELY ONE (1)

IRRIGATION LEGEND AND SCHEDULE

SYM	DESCRIPTION	MANUFACTURER	MODEL	SIZE / NOZZLE	NOTES
С	AUTOMATIC CONTROLLER	HUNTER	ICC 2200	N/A	INSTALL PER MANUFACTURER'S STANDARDS. IN ADDITION, INSTALL SOLAR-SYNC SYSTEM BY HUNTER.
(b)	DRIP IRRIGATION CONTROL VALVE	HUNTER	ICZ-101	1"	INSTALL PER DETAIL IN 10" ROUND BOX w/ BOLT DOWN LID. ROUT AND PAINT VALVE NUMBER ON LID.
	DRIP IRRIGATION (LANDSCAPE BEDS)	HUNTER	PLD-06-18	N/A	INSTALL PER DETAIL w/ 40 PSI AT OUTFLOW OF DRIP ZONE VALVE.
	DRIP IRRIGATION (TURF BEDS)	HUNTER	PLD-06-12	N/A	INSTALL PER DETAIL w/ 40 PSI AT OUTFLOW OF DRIP ZONE VALVE.
	DRIP IRRIGATION	HUNTER	AFB-ADJ BUBBLER (0.5 GPM EACH BUBBLER)	1/2"	INSTALL PER DETAIL w/ 40 PSI AT BASE OF HEAD. INSTALL 1.0 GPM/LARGE SHADE TREE AND 0.5 GPM/ORN. TREES INSTALL ON ALL PROPOSED TREES, SEE LANDSCAPE PLANS.
•	REMOTE CONTROL VALVE	HUNTER	ICV-101G ICV-151G	Refer to Plan for Size	INSTALL PER DETAIL IN 10" ROUND PENTEK VALVE BOX WITH BOLT DOWN LID. ROUT AND PAINT VALVE NUMBER ON LID.
(1)	LAWN MP ROTATOR	HUNTER	MP ROTATOR	MP1000, MP2000, MP3000, MP3500	INSTALL PER DETAIL w/ 40 PSI AT BASE OF HEAD. INSTALL ON IPS FLEX PIPE ALL SPRAY BODIES. INSTALL NOZZLES ON 4" PRS40 SPRAY BODIES.
M	WATER METER		PER CITY	REFER TO PLAN FOR SIZE	INSTALLED BY GENERAL CONTRACTOR
>	DOUBLE CHECK VALVE	FEBCO	850-BV Series	REFER TO PLAN FOR SIZE	FURNISH AND INSTALL PER LOCAL CODE BY LICENSED IRRIGATION CONTRACTOR.
<u> </u>	ISOLATION VALVE	NIBCO	*T-113	LINE SIZE	INSTALL PER DETAIL IN 12"x17" PENTEK VALVE BOX WITH BOLT DOWN LID.
Y	WYE STRAINER	FEBCO	*850	REFER TO PLAN FOR SIZE	INSTALL PER DETAIL IN 12"x17" PENTEK VALVE BOX WITH BOLT DOWN LID.
M	MASTER VALVE	HUNTER	ICV-101G ICV-151G	REFER TO PLAN FOR SIZE	INSTALL PER DETAIL IN 12"x17" PENTEK VALVE BOX WITH BOLT DOWN LID.
	IRRIGATION SLEEVE		SCH. 40 w/ 12 GA. PULL WIRE IN SLEEVE	REFER TO PLAN FOR SIZE	DRIVEWAY SLEEVES INSTALLED BY GENERAL CONTRACTOR. SIDEWALK SLEEVES INSTALLED BY IRRIGATION CONTRACTOR.
	IRRIGATION MAIN LINE		SCH. 40	REFER TO PLAN FOR SIZE	18" INSTALLATION DEPTH.
	IRRIGATION LATERAL LINE		CLASS 200	REFER TO PLAN FOR SIZE	12" INSTALLATION DEPTH STANDARD. 18" INSTALLATION DEPTH UNDER PAVING.

PROGRAM AND STATION NUMBER FOR AUTOMATIC CONTROLLER

■ VALVE SIZE IN INCHES

GALLONS PER MINUTE, PER VALVE


HYDRAULIC CALCULATION NOTES

TEN DAYS PRIOR TO COMMENCING WORK, VERIFY STATIC PRESSURE. IF STATIC PRESSURE IS LESS THAN THE ASSUMED STATIC PRESSURE DO NOT START WORK UNTIL NOTIFIED IN WRITING TO PROCEED BY OWNER. IF CONTRACTOR PROCEEDS WITH WORK WITHOUT AUTHORIZATION FROM OWNER, THE CONTRACTOR SHALL BE FINANCIALLY RESPONSIBLE TO CORRECT, MODIFY OR REPAIR ANY ITEMS OR MATERIALS THAT MAY BE REQUIRED TO PROVIDE A FULLY FUNCTIONING AND OPERATIONAL IRRIGATION SYSTEM IN COMPLIANCE WITH THE PLANS AND SPECIFICATIONS. HYDRAULIC CALCULATIONS FOR THIS SYSTEM ARE BASED ON THE STATIC PRESSURE AS STATED ABOVE. THE STATIC PRESSURE SHOWN IS AN ASSUMED PRESSURE, A PRESSURE MEASURED AT THE SITE, OR AN ESTIMATED PRESSURE PROVIDED BY THE COUNTY OR CITY. THE OWNER UNDERSTANDS THIS PROJECT MAY NOT PROVIDE 100% COVERAGE AT ALL TIMES.

ITEM	SIZE	PSI	NOTES
SERVICE	1"	3.56	TYPE "K" COPPER 20 LN. FT. (23.10 GPM)
WATER METER	1"	3.40	(23.10 GPM)
BALL VALVE	1"	1.00	(23.10 GPM)
WYE FILTER	1"	0.30	(23.10 GPM)
BACKFLOW PREVENTER	1"	4.00	(23.10 GPM)
MASTER VALVE	1.5"	1.50	(23.10 GPM)
MAIN LINE	2"	0.94	200 LINEAR FEET (23.10 GPM)
ZONE VALVE (9A)	1.5"	1.50	(23.10 GPM)
LATERAL PIPING	N/A	3.15	
CRITICAL HEAD 'A'	N/A	40.00	
TOTAL LOSS		59.35	
ASSUMED STATIC PRESSURE		70.00	
PRESSURE DIFFERENTIAL		-10.65	

HYDRAULIC CALCULATION (FARTHEST HEAD)					
ITEM	SIZE	PSI	NOTES		
SERVICE	1"	1.31	TYPE "K" COPPER 20 LN. FT. (13.65 GPM)		
WATER METER	1"	1.10	(13.65 GPM)		
BALL VALVE	1"	1.00	(13.65 GPM)		
WYE FILTER	1"	0.30	(13.65 GPM)		
BACKFLOW PREVENTER	1"	4.00	(13.65 GPM)		
MASTER VALVE	1.5"	3.00	(13.65 GPM)		
MAIN LINE	2"	2.38	1,400 LINEAR FEET (13.65 GPM)		
ZONE VALVE (19A)	1"	3.00	(13.65 GPM)		
LATERAL PIPING	N/A	0.86			
CRITICAL HEAD 'B'	N/A	40.00			
TOTAL LOSS		56.96			
ASSUMED STATIC PRESSURE		70.00			
PRESSURE DIFFERENTIAL		-13.04			

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Bar is one inch on original drawing. If not one inch on this sheet, adjust scale as necessary

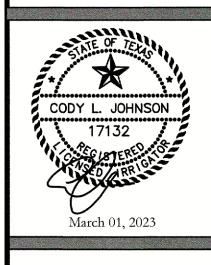One Inch


CREENING AND BUFFERING
Irrigation Details
Discovery Lakes Ph. 1

CJS PROJECT NO.

DLL001


SHEET NO.
IR8 of 9


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BACKFLOW PREVENTER CONNECTION

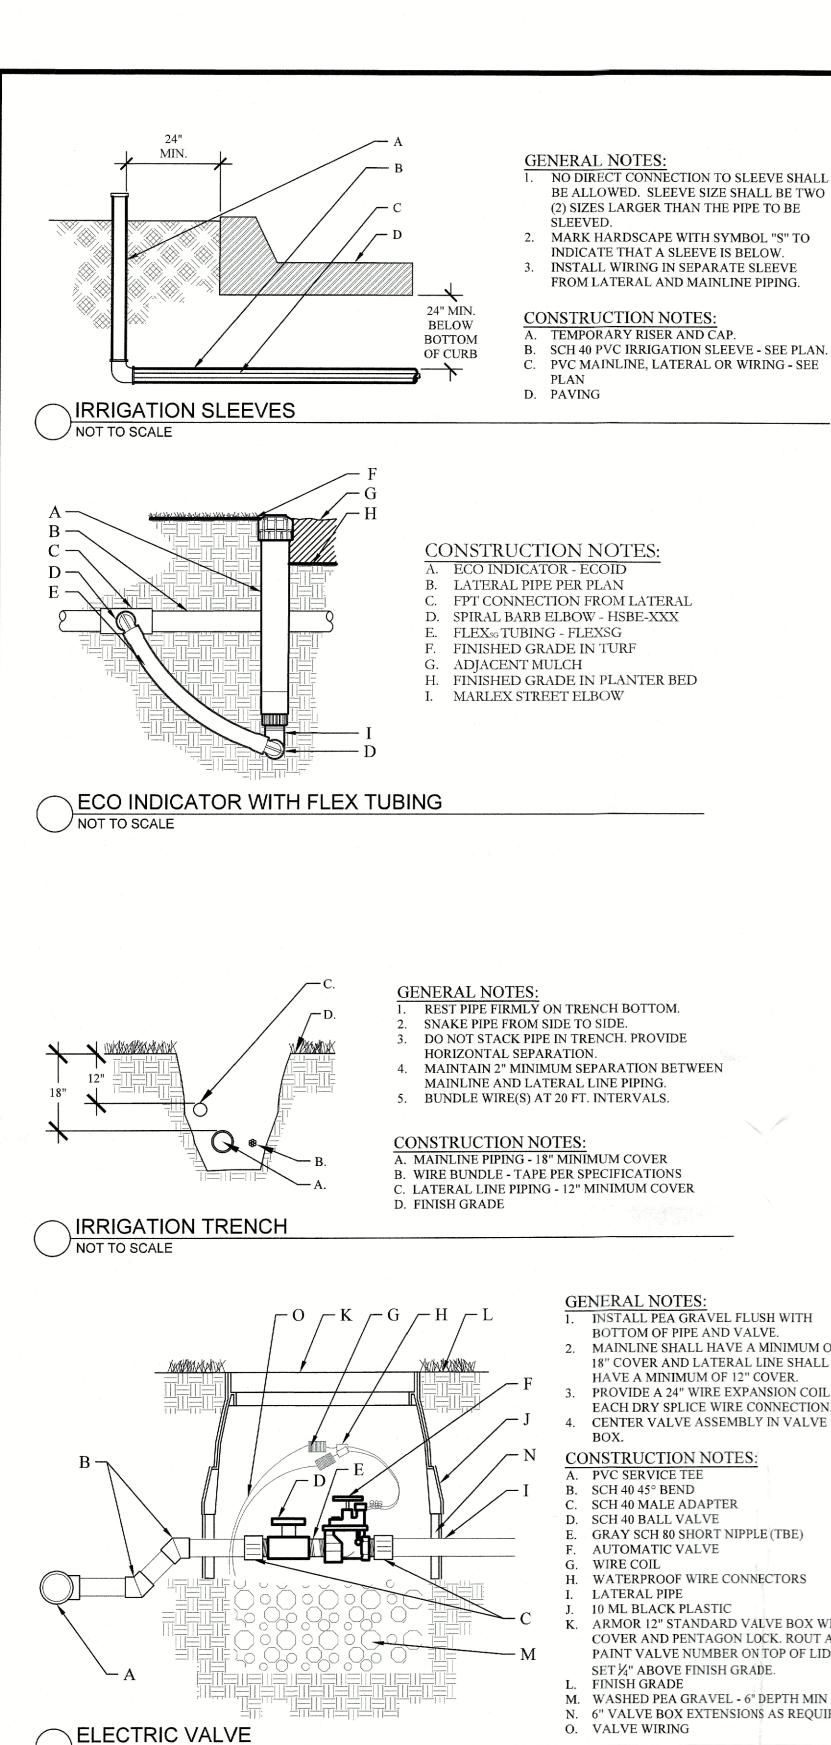NOT TO SCALE




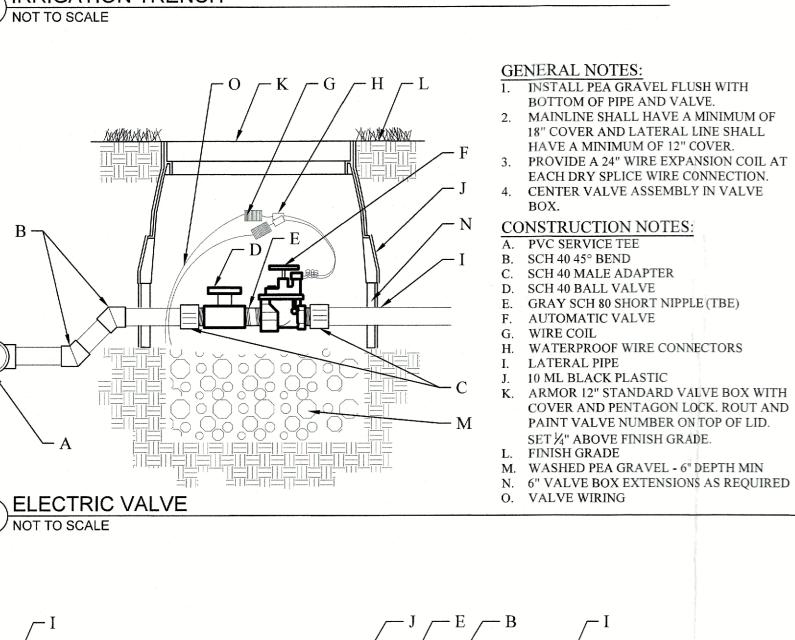


DRIP IRRIGATION - BED

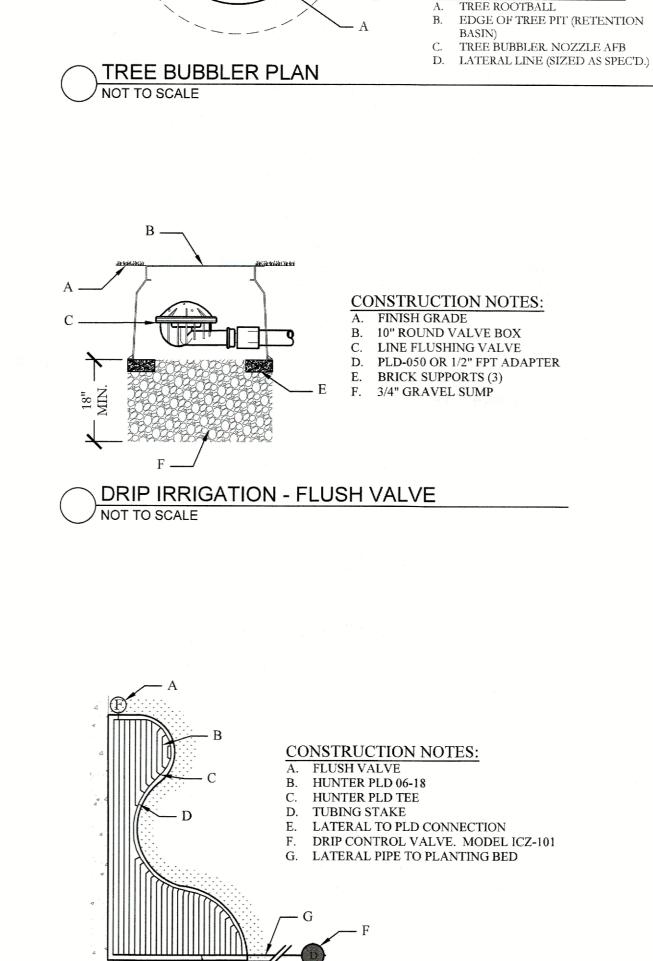DRIP CONTROL ZONE

NOT TO SCALE

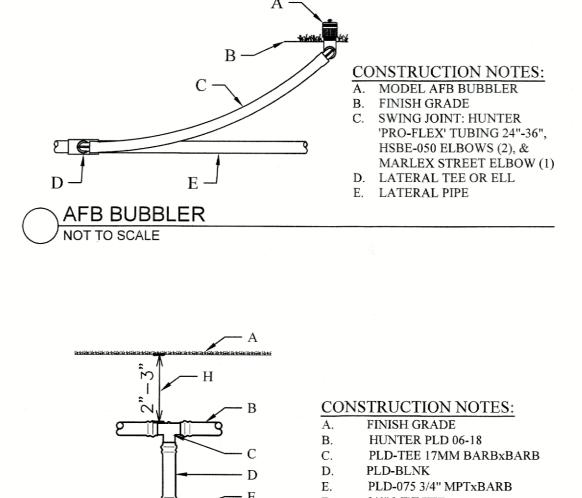

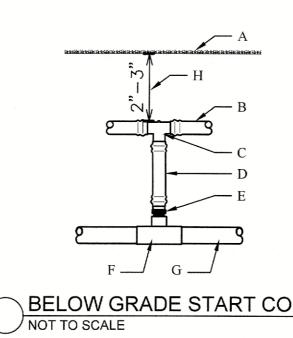

CONSTRUCTION NOTES:

DRIP ZONE KIT, MODEL ICZ-101

G. MAINLINE PIPING AND FITTINGS

I. 3/4" MINUS WASHED GRAVEL

D. WATERPROOF CONNECTORS (2)

A. JUMBO VALVE BOX

18-24" COILED WIRE

H. BRICK SUPPORTS (4)

J. PVC SLIP UNIONS (2)

GENERAL NOTES:

THE TREES ROOTBALL

3. TREE BUBBLERS TO BE ON UPHILI

SIDE OF THE TREE IN THE

4. COORDINATE THE LOCATION OF

LANDSCAPE PLANTING PLANS.

CONSTRUCTION NOTES:

TREE BUBBLERS TO BE ALIGNED PARALLEL WITH MEDIAN CURBS.

NO TRENCHING ALLOWED WITHIN

RETENTION BASIN OR AS SHOWN.

THE BUBBLERS WITH THE PROPOSED


TREE LOCATIONS AS SHOWN ON THE


SCH. 80 T.O.W. NIPPLE


B. FINISH GRADE


3/4" MPT TEE LATERAL PIPE MINIMUM DRIPLINE DEPTH

BELOW GRADE START CONNECTION

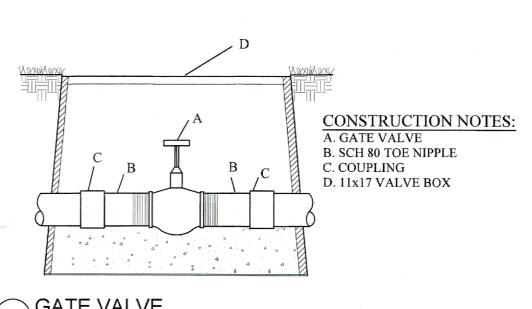

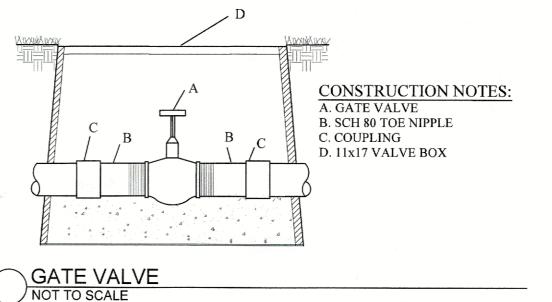


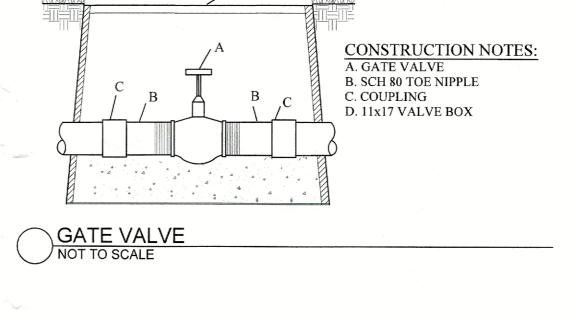

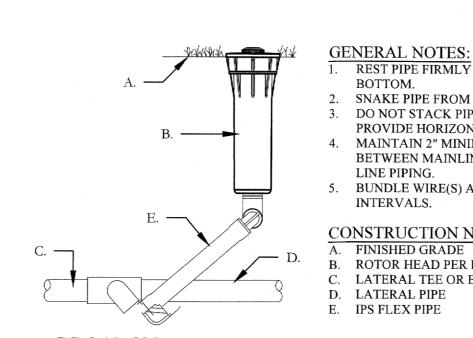

REST PIPE FIRMLY ON TRENCH BOTTOM. SNAKE PIPE FROM SIDE TO SIDE. DO NOT STACK PIPE IN TRENCH. PROVIDE HORIZONTAL SEPARATION 4. MAINTAIN 2" MINIMUM SEPARATION BETWEEN MAINLINE AND LATERAL LINE PIPING. 5. BUNDLE WIRE(S) AT 20 FT. INTERVALS.

CONSTRUCTION NOTES: A. FINISHED GRADE B. ROTOR HEAD PER PLANS . LATERAL TEE OR ELL D. LATERAL PIPE E. IPS FLEX PIPE PRS40-CV - MP ROTATOR SPRAY HEAD

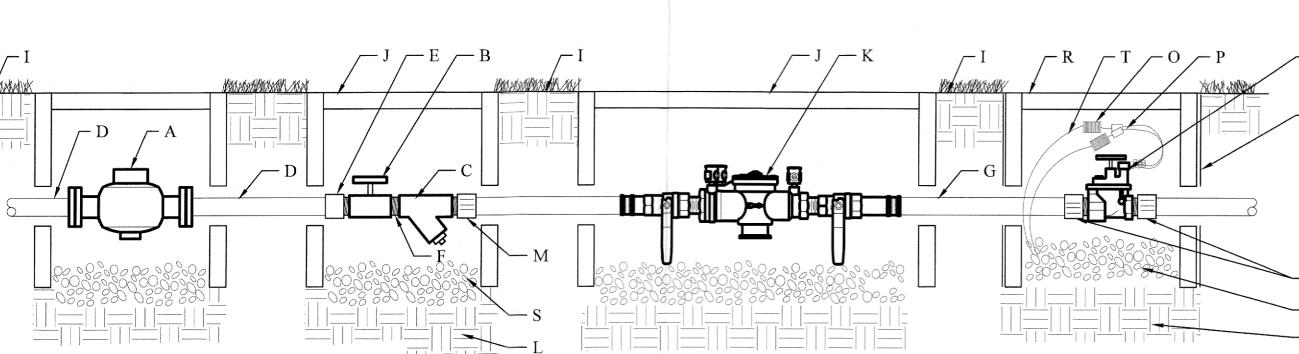

GENERAL NOTES: WATER METER (SIZE PER PLAN) B. BALL VALVE (SIZE PER LINE) C. WYE STRAINER (SIZE PER LINE)

NOT TO SCALE

CONSTRUCTION NOTES:

D. TYPE "K" COPPER PIPE

PIPE PER CITY CODE

L. COMPACTED SUBGRADE

N. MASTER ELECTRIC VALVE

Q. 10 ML BLACK PLASTIC

TBE NIPPLE

COUPLING

FINISH GRADE

FINISH GRADE

M. MALE ADAPTER

T. VALVE WIRING

O. WIRE COIL

COPPER SxT COUPLING

12"x17" VALVE BOX. SET FLUSH WITH


K. DOUBLE CHECK VALVE ASSEMBLY

P. WATERPROOF WIRE CONNECTORS

R. 10" RD VALVE BOX. SET 1/4" ABOVE FINISH

WASHED PEA GRAVEL - 6" DEPTH MIN

INSTALL WASHED PEA GRAVEL BELOW DCA TO ALLOW ACCESS TO TEST COCKS AND OPERATION OF BALL VALVES 2. INSTALL PEA GRAVEL FLUSH WITH ELECTRIC VALVE. 3. PROVIDE A 24" WIRE EXPANSION COIL AT EACH DRY SPLICE WIRE CONNECTION. CENTER VALVE ASSEMBLY IN VALVE BOX.

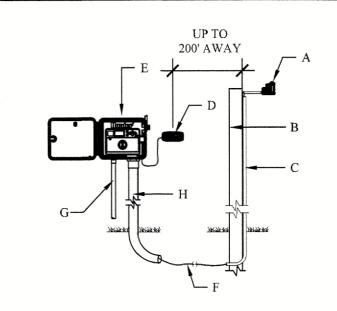

CONSTRUCTION NOTES: A. MODEL: SOLAR SYNC SENSOR B. SUITABLE POST, POLE, OR GUTTER MOUNT. MOUNT IN LOCATION WHERE SENSOR CAN RECEIVE FULL SUN, IS OPEN TO RAINFALL AND OUT OF SPRINKLER SPRAY PATTERN. CONTROLLER OR TO A POINT 12" BELOW GRADE


C. CONDUIT FROM SOLAR SYNC SENSOR TO D. MODEL SOLAR SYNC MODULE. MOUNT LESS THAN 6" AWAY FROM CONTROLLER, MODULE CAN BE MOUNTED INTERNALLY WHEN PAIRED

WITH THE PCC CONTROLLER.* HUNTER ICC2 CONTROLLER F. COMMUNICATION WIRE, 18-2(WIRE TYPE TO

MEET INSTALLATION CODE REQUIREMENTS) FROM MODULE TO SENSOR. MAXIMUM TOTAL WIRE DISTANCE, 200 FEET. G. POWER SOURCE

H. CONDUIT FOR VALVE CONTROL WIRE AND SOLAR SYNC COMMUNICATION WIRE

SOLAR SYNC SYSTEM (ICC2 CONTROLLER)

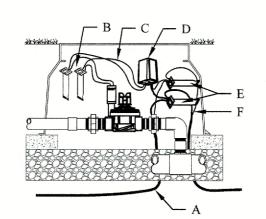

DUAL-1 DECODER

NOT TO SCALE

CONSTRUCTION NOTES:

A. JACKETED ID WIRE PATH TWISTED TO NEXT DECODER DBY-2


TWO BLACK WIRES TO VALVE SOLENOID/ UP TO 100 FT/30M MODEL DUAL-1 DECODER

DBR\T-6 (2) JACKETED ID: WIRE PATH FROM

Director of Planning and Zoning

WITNESS OUR HANDS, this 7 day of Pelony, 2023

CONTROLLER ALLOW 5 FT./1.5M SLACK PER DECODER/1/3 ON EITHER SIDE OF DECODER.

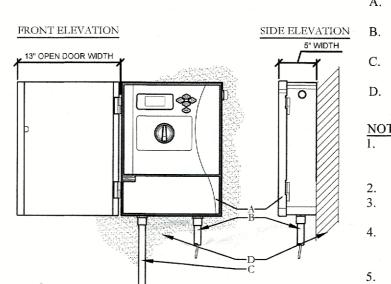

A. IRRIGATION CONTROLLER (12C-800-M) PER

IRRIGATION CONTROL WIRE IN CONDUIT SIZE AND TYPE PER LOCAL CODES ELECTRICAL SUPPLY CONDUIT, CONNECT TO POWER SOURCE, J-BOX INSIDE CONTROLLER ADJACENT SURFACE TO MOUNT CONTROLLER PER PLAN

INSTALLATION TO BE COMPLETED IN ACCORDANCE WITH MANUFACTURER'S SPECIFICATIONS CONTROLLER ACCEPTS 120 VOLTS AC

SEE PLAN LEGEND FOR MODEL NUMBER AND SPECIFICATIONS ALWAYS REFER TO PRODUCT INSTALLATION NOTES PRIOR TO

INSTALLATION 5. MOUNT CONTROLLER LCD SCREEN EYE LEVEL, CONTROLLER SHALL BE HARD WIRE TO GROUNDED 110 VAC POWER SOURCE

\ICC2 CONTROLLER - WALL MOUNT (NOT TO SCALE)

Bar is one inch on original drawing. If not one inch on this sheet, adjust scale as necessary.

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CODY L. JOHNSON

17132

March 01, 2023

One Inch

BUFFERIN SCREENINC

CJS PROJECT NO.

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DLL001