



SITE DATA	A SUMMARY TABLE		
PHYSICAL ADDRESS PORTOFINO DRIVE			
GROSS SITE AREA	287,476 S.F. / 6.60 ACRES		
NET AREA	T.B.D.		
ZONING	PD-22		
CURRENT USE	CONDOMINIMUMS		
PROPOSED USE	CONDOMINIMUMS		
LOT	COVERAGE DATA		
BUILDING COVERAGE	25,950 S.F.		
BUILDING FOOTPRINT	8,650 S.F.		
TOTAL BUILDING AREA	25,950 S.F.		
IMPERVIOUS COVERAGE	6,946 S.F.		
PERVIOUS COVERAGE 5,127 S.F.			
PAR	RKING SUMMARY		
PARKING SPACE REQUIREMENTS			
RESIDENTIAL PARKING - 2 SPACE	S PER UNIT		
TOTAL PARKING SPACES REQUIR	RED = 24		
TOTAL PARKING SPACES PROVID	PED = 27		
В	UILDING DATA		
BUILDINGS	2 BUILDINGS & 1 GARAGE		
STORIES	3		
PEAK HEIGHT	35'-0"		
TOTAL SQUARE FOOTAGE	25,950 S.F.		

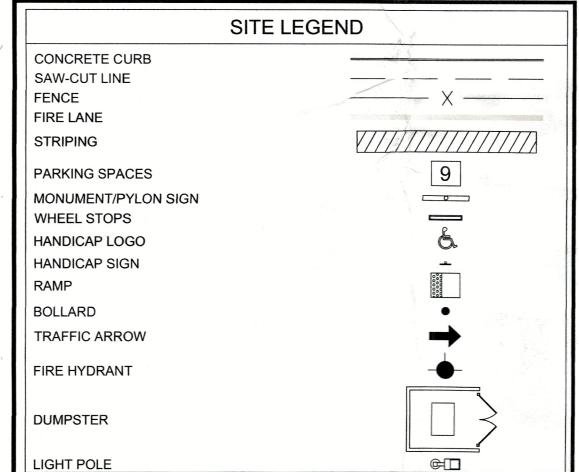

NOTE: PROPOSED BUILDING COLORS AND MATERIALS TO MATCH EXISTING BUILDINGS.

NOTE: TREES TO BE 5' AWAY FROM PUBLIC UTILITY LINES LESS THAN 10". TREES TO BE 10' AWAY FROM PUBLIC UTILITY LINES THAT ARE 10" OR GREATER.



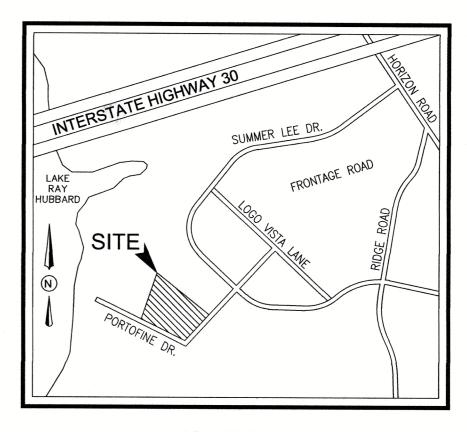

VICINITY MAP N.T.S.

GENERAL NOTES

1. ALL CONSTRUCTION SHALL BE IN STRICT ACCORDANCE WITH THE STANDARDS OF THE CITY OF ROCKWALL.

2. A PERMIT IS REQUIRED TO CUT A CITY STREET OR WORK WITHIN THE RIGHT-OF-WAY. THE PERMIT IS ISSUED BY THE PUBLIC WORKS DEPARTMENT.

3. THE LOCATION OF UNDERGROUND UTILITIES INDICATED ON THE PLANS IS TAKEN FROM PUBLIC RECORDS. IT IS THE CONTRACTOR'S RESPONSIBILITY TO MAKE ARRANGEMENTS WITH THE OWNERS OF SUCH UNDERGROUND UTILITIES PRIOR TO WORKING IN THE AREA TO CONFIRM THEIR EXACT LOCATION AND TO DETERMINE WHETHER ANY ADDITIONAL UTILITIES OTHER THAN THOSE SHOWN ON THE PLANS MAY BE PRESENT. THE CONTRACTOR SHALL PRESERVE AND PROTECT ALL UNDERGROUND UTILITIES. IF EXISTING UNDERGROUND UTILITIES ARE DAMAGED, THE CONTRACTOR WILL BE RESPONSIBLE FOR THE COST OF REPAIRING THE UTILITY.

4. WHERE EXISTING UTILITIES OR SERVICE LINES ARE CUT. BROKEN OR DAMAGED, THE CONTRACTOR SHALL REPLACE OR REPAIR THE UTILITIES OR SERVICE LINES WITH THE SAME TYPE OF ORIGINAL MATERIAL AND CONSTRUCTION, OR BETTER, UNLESS OTHERWISE SHOWN OR NOTED ON THE PLANS, AT HIS OWN COST AND EXPENSE. THE CONTRACTOR SHALL IMMEDIATELY NOTIFY THE ENGINEER AT ONCE OF ANY CONFLICTS IN GRADES AND ALIGNMENT.

5. ALL EXCAVATIONS, TRENCHING AND SHORING OPERATIONS SHALL COMPLY WITH THE REQUIREMENTS OF THE U. S. DEPARTMENT OF LABOR, OSHA, "CONST. SAFETY AND HEALTH REGULATIONS.", VOL. 29, SUBPART P. PG. 128 - 137, AND ANY AMENDMENTS THERETO.

6. ADEQUATE MEASURES SHALL BE TAKEN TO PREVENT EROSION. IN THE EVENT THAT SIGNIFICANT EROSION OCCURS AS A RESULT OF CONSTRUCTION THE CONTRACTOR SHALL RESTORE THE ERODED AREA TO ORIGINAL CONDITION OR BETTER.

7. THE CONTRACTOR SHALL RESTORE ALL AREAS DISTURBED BY CONSTRUCTION TO ORIGINAL CONDITION OR BETTER. RESTORED AREAS INCLUDE, BUT ARE NOT LIMITED TO TRENCH BACKFILL, SIDE SLOPES, FENCES, CULVERT PIPES, DRAINAGE DITCHES, DRIVEWAYS, PRIVATE YARDS AND ROADWAYS.

8. ANY CHANGES NEEDED AFTER CONSTRUCTION PLANS HAVE BEEN RELEASED, SHALL BE APPROVED BY THE CITY ENGINEER. THESE CHANGES MUST BE RECEIVED IN WRITING FROM THE DESIGN ENGINEER. THE DIRECTOR OF PUBLIC WORKS SHALL APPROVE ANY DEVIATIONS FROM STATE REGULATIONS.


9. THE CONTRACTOR SHALL PROVIDE "RED LINED" MARKED PRINTS TO THE ENGINEER PRIOR TO FINAL INSPECTION INDICATING ALL CONSTRUCTION WHICH DEVIATED FROM THE PLANS OR WAS CONSTRUCTED IN ADDITION TO THAT INDICATED ON THE PLANS.

WATER METER & SANITARY SEWER SCHEDULE						
ID	TYPE	SIZE	NO.	SAN. SEW.		
D	DOM.	1 1/2"	2	6"		
	IRR.	1"	1	N/A		

SITE PLAN SIGNATURE BLOCK


APPROVED: I hereby certify that the above and foregoing site plan for a


NO.	DATE	DESCRIPTION	BY	minning.
1	11/25/2019	1st CITY SUBMITTAL	KP	See The Control of th
2	01/16/2020	2nd CITY SUBMITTAL	KP	**
3	05/13/2020	3rd CITY SUBMITTAL	KP	KARTAVYA S. PATEL
4	09/04/2020	4th CITY SUBMITTAL	KP	% 97534 <i>;</i> €
5	08/08/2023	5th CITY SUBMITTAL	НК	MOS SICENSED IN

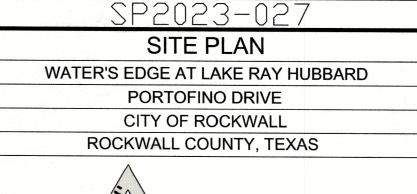




VV. U	langle-en	gr.com 10:1	784 W. MCDe	rmott Drive, Suite 110), Allen, 1X /5013
Plann	ning	Civil Engir	neering	Construction !	Vanagement
DESIGN	DRAWN	DATE	SCALE	PROJECT NO.	SHEET NO.
KP	MLM	11/7/2019	SEE SCALE BAR	040-19	2
		3			

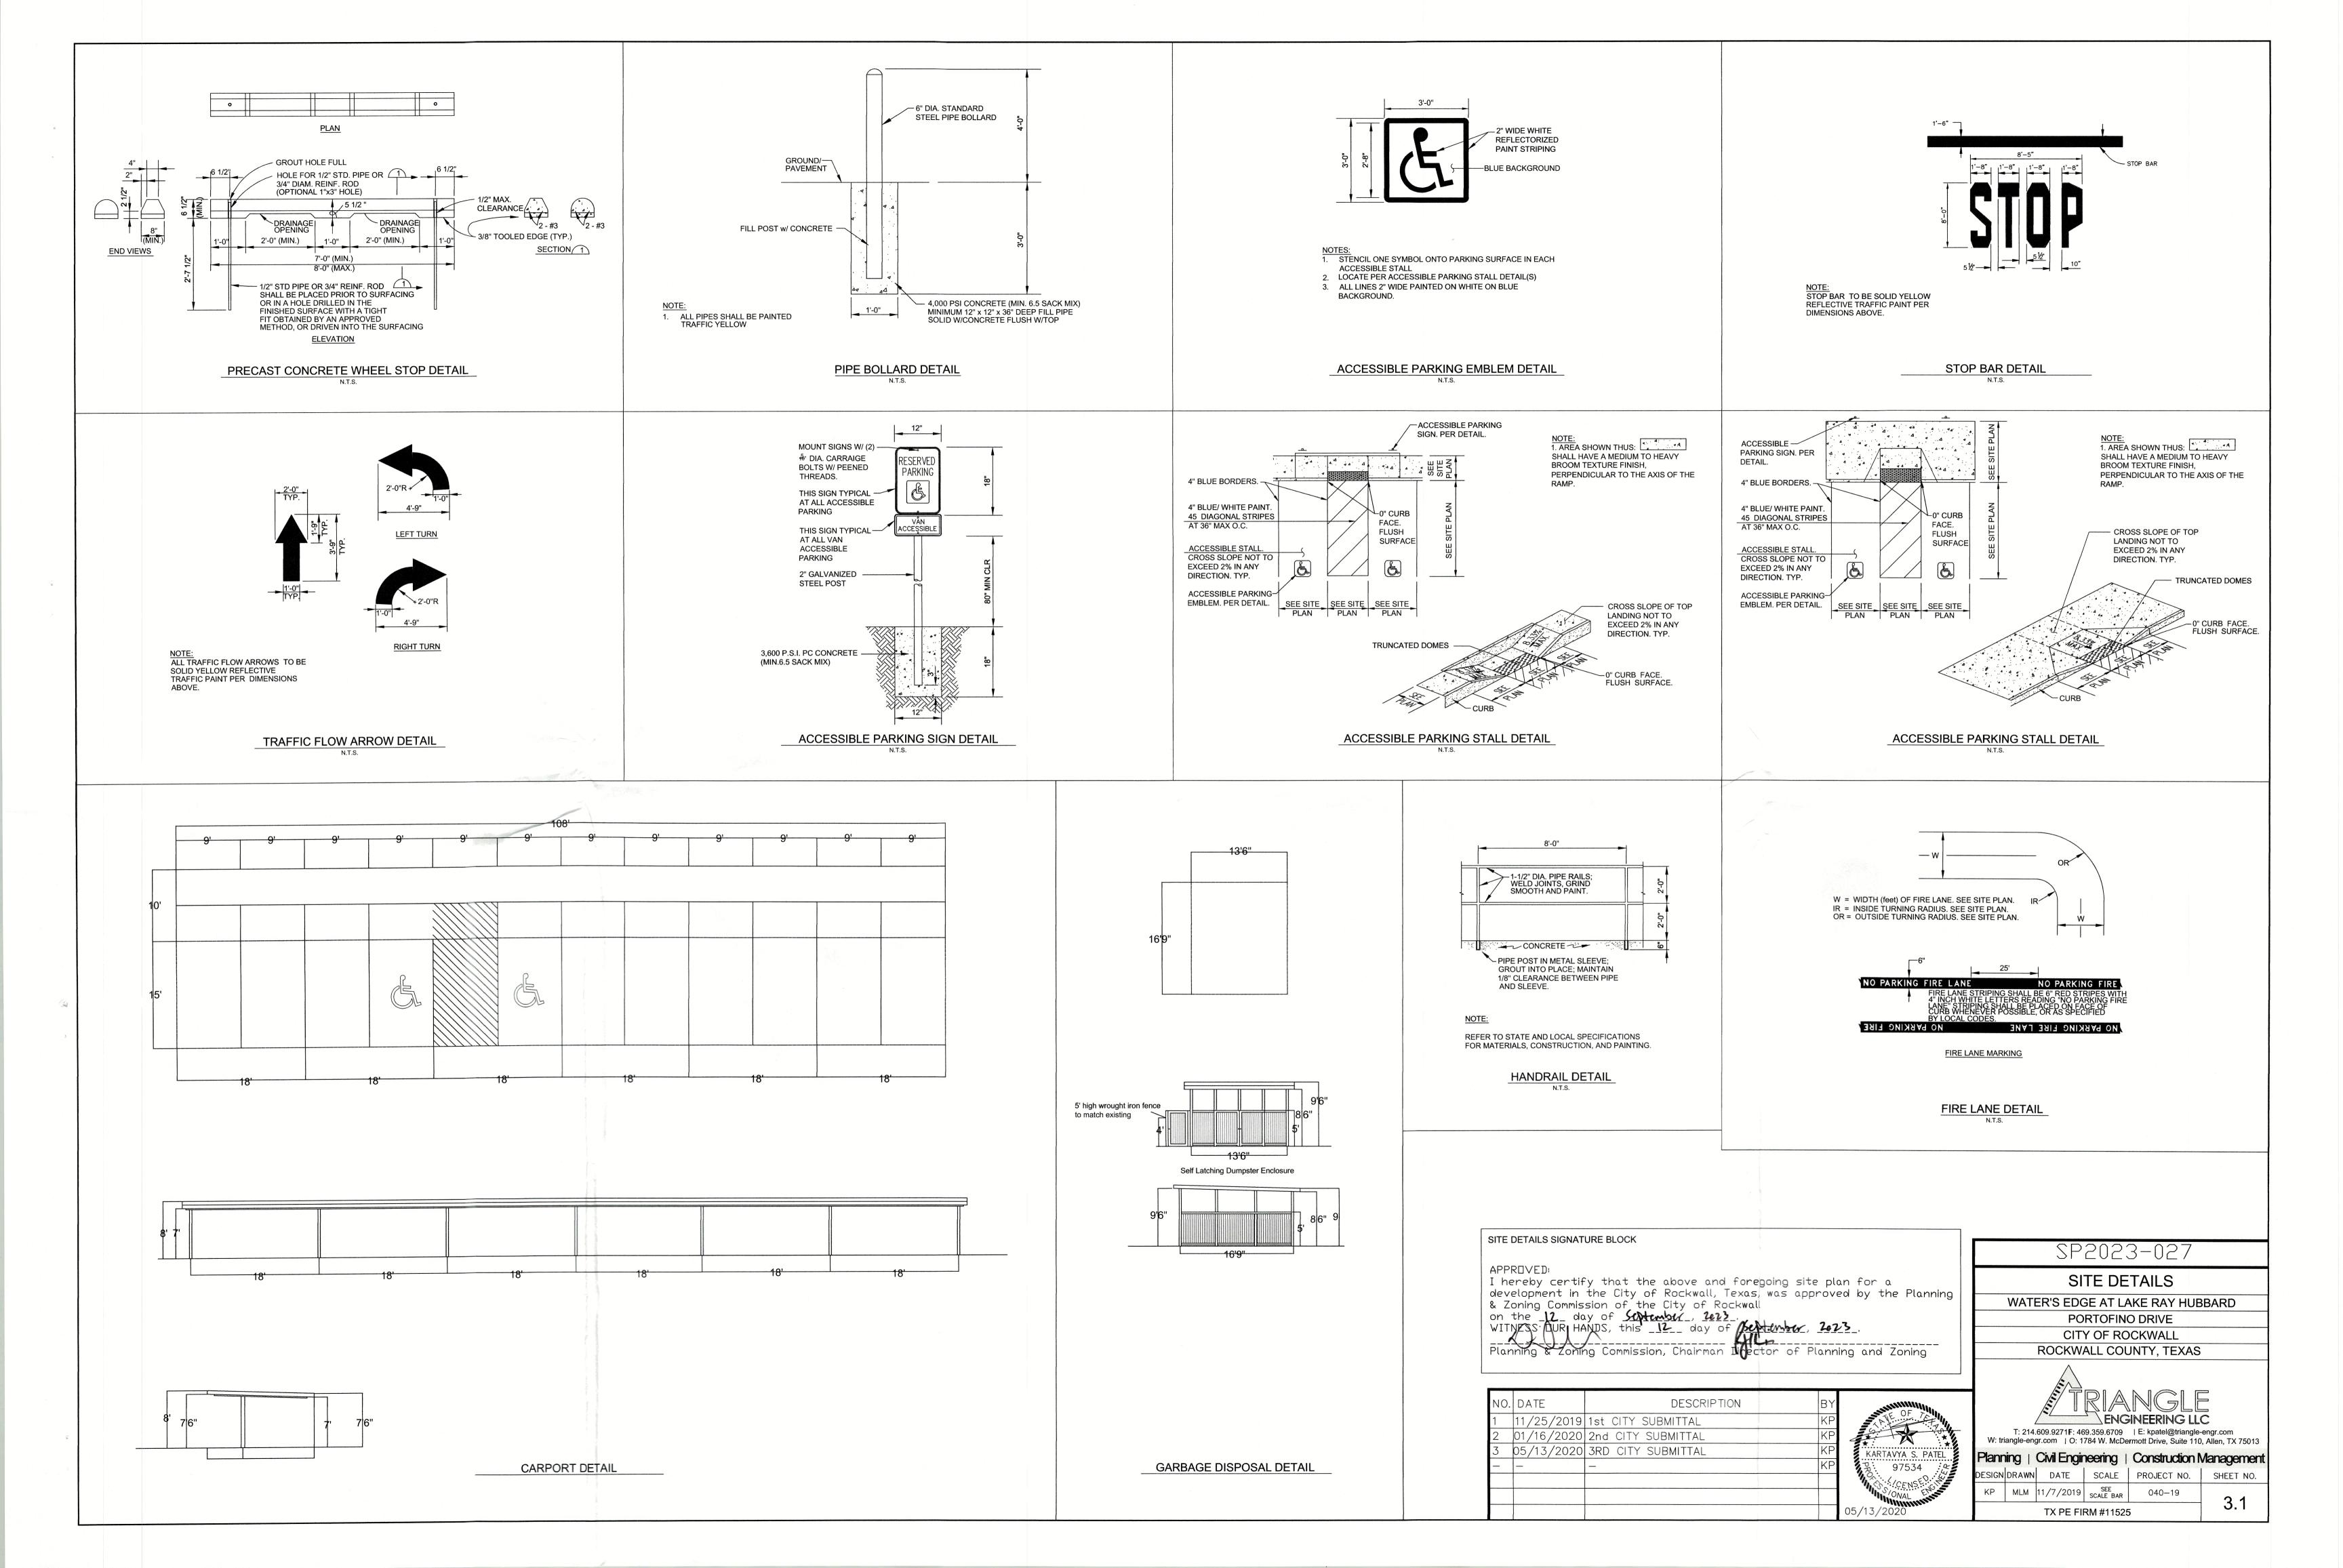

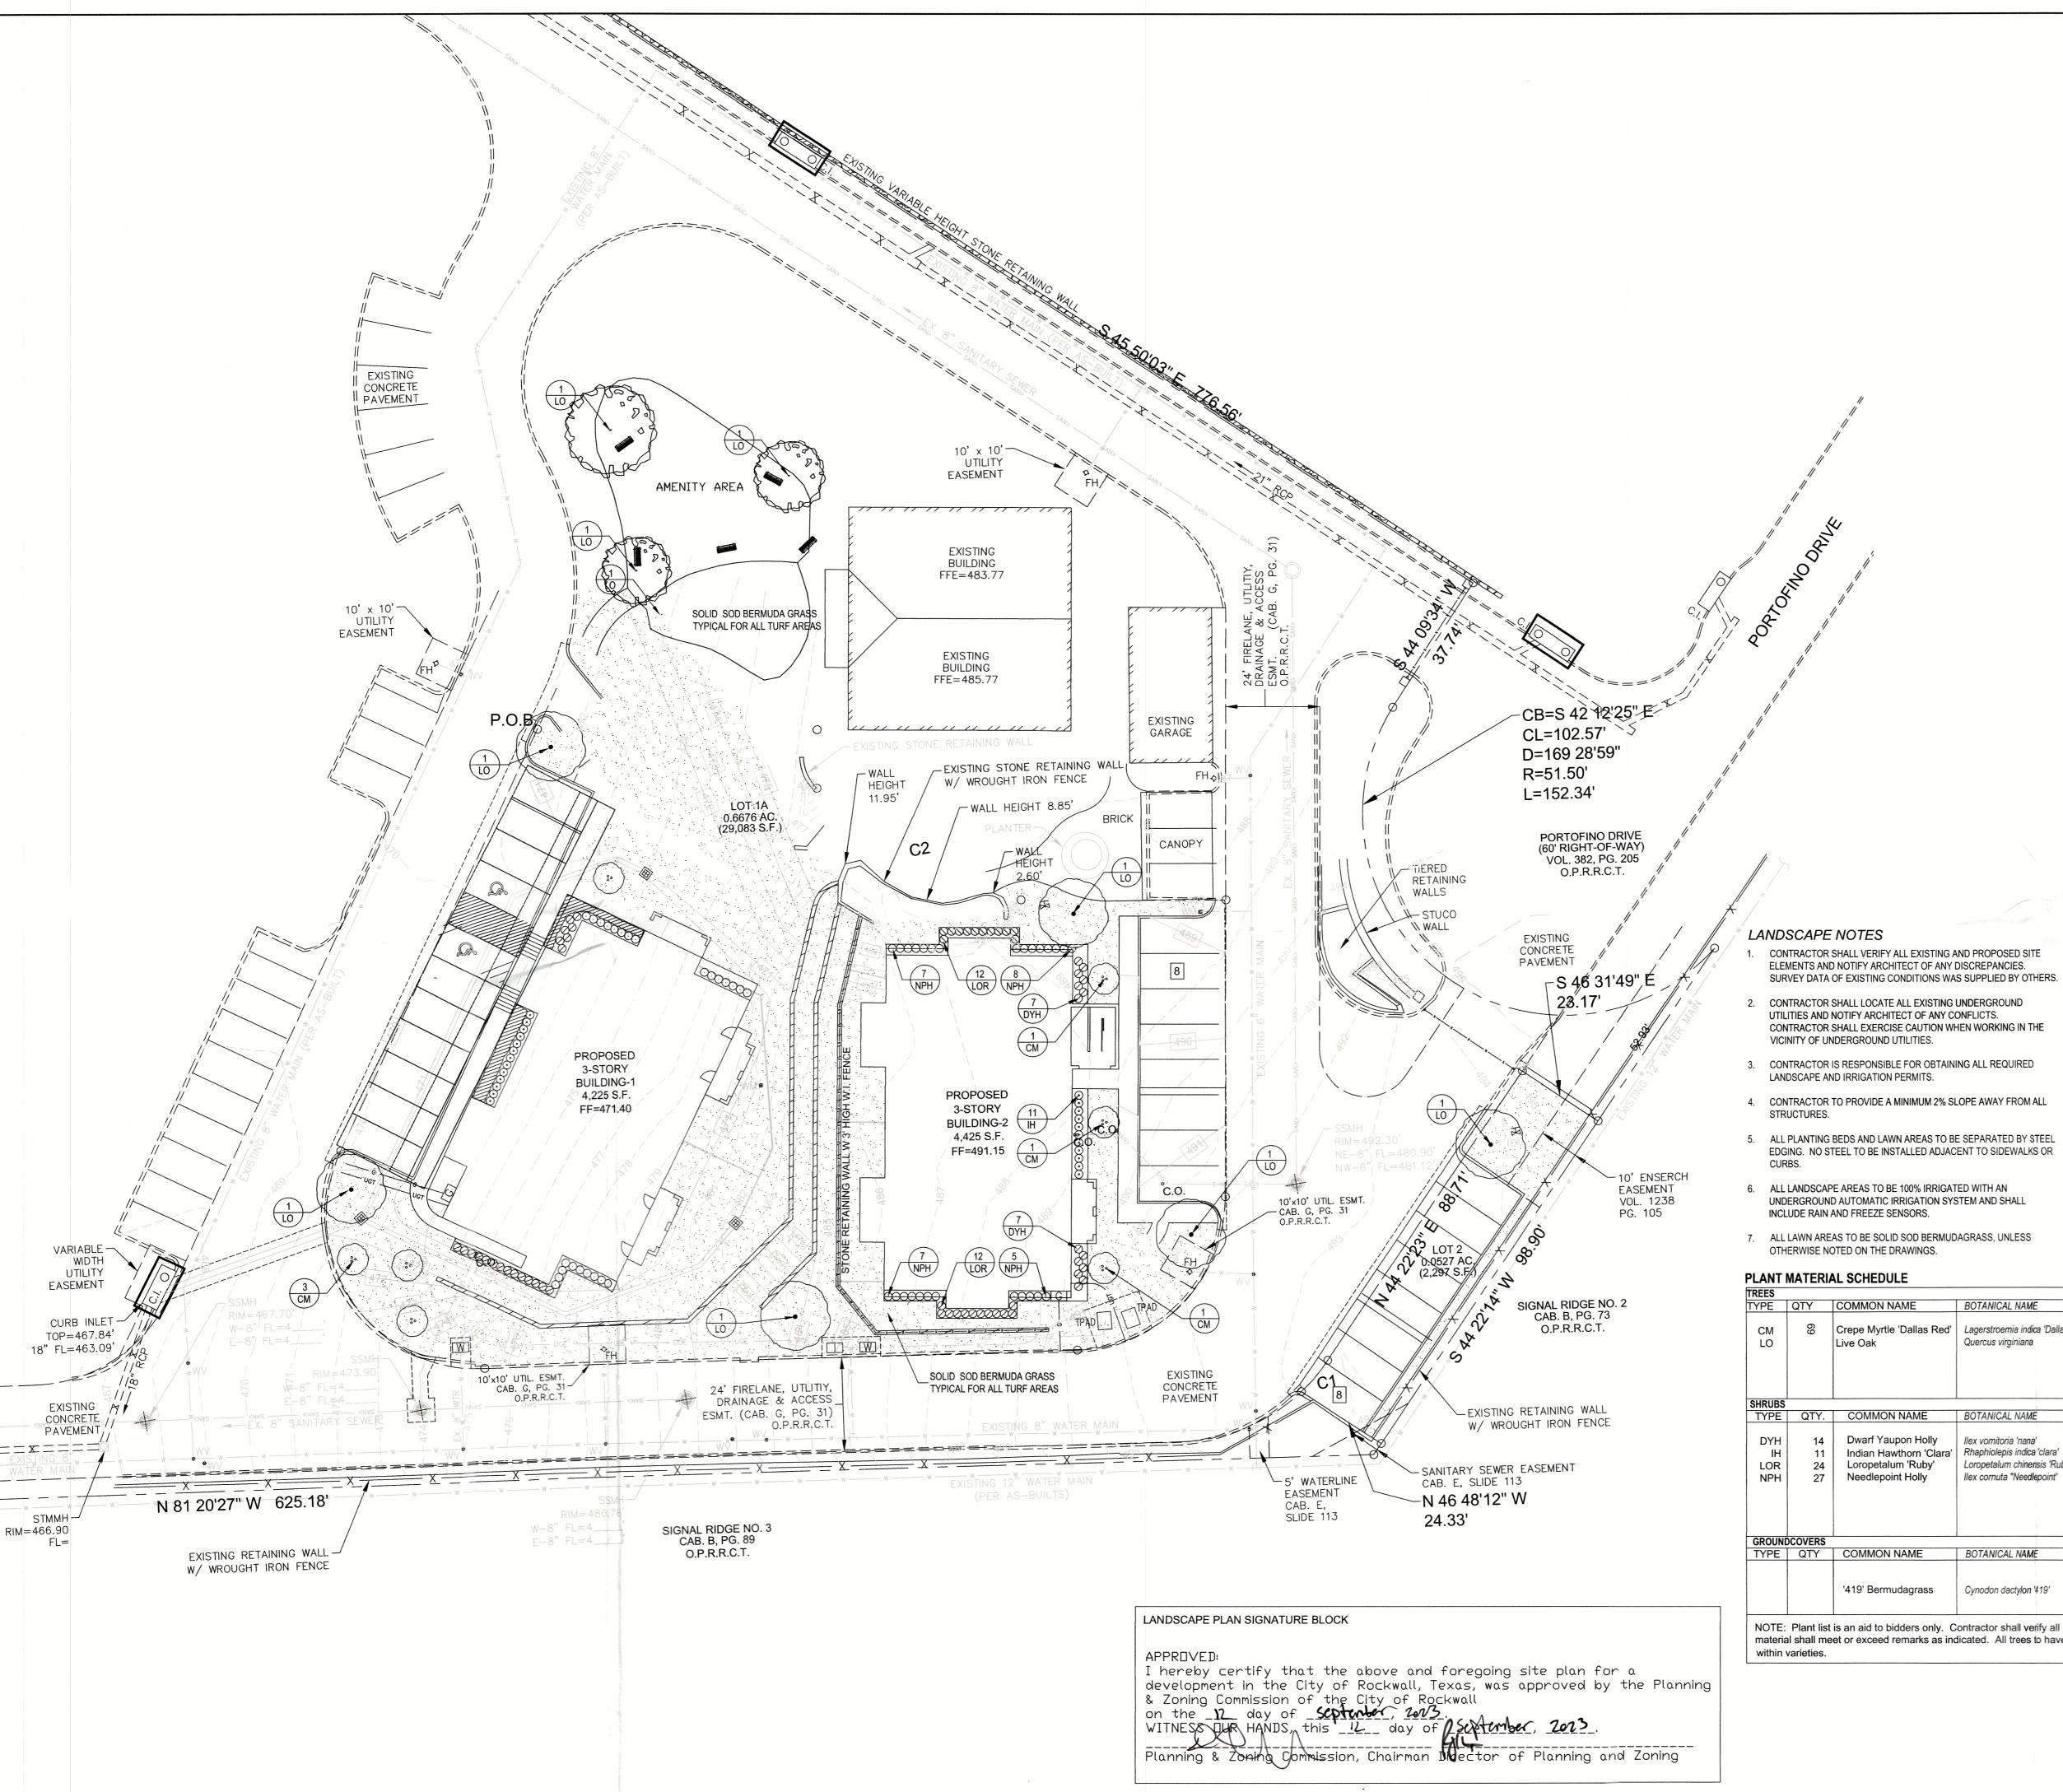

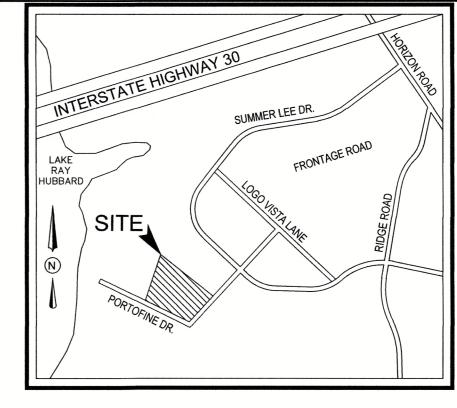

VICINITY MAP

N.T.S.

GENERAL LAWN NOTES

- 1. FINE GRADE AREAS TO ACHIEVE FINAL CONTOURS INDICATED ON CIVIL
- 2. ADJUST CONTOURS TO ACHIEVE POSITIVE DRAINAGE AWAY FROM BUILDINGS. PROVIDE UNIFORM ROUNDING AT TOP AND BOTTOM OF SLOPES AND OTHER BREAKS IN GRADE. CORRECT IRREGULARITIES AND AREAS WHERE WATER MAY STAND.
- ALL LAWN AREAS TO RECEIVE SOLID SOD SHALL BE LEFT IN A MAXIMUM OF 1" BELOW FINAL FINISH GRADE. CONTRACTOR TO COORDINATE OPERATIONS WITH ON-SITE CONSTRUCTION MANAGER.
- IMPORTED TOPSOIL SHALL BE NATURAL, FRIABLE SOIL FROM THE REGION, KNOWN AS BOTTOM AND SOIL, FREE FROM LUMPS, CLAY, TOXIC SUBSTANCES, ROOTS, DEBRIS, VEGETATION, STONES, CONTAINING NO SALT AND BLACK TO BROWN IN COLOR.
- ALL LAWN AREAS TO BE FINE GRADED, IRRIGATION TRENCHES COMPLETELY SETTLED, AND FINISH GRADE APPROVED BY THE OWNER'S CONSTRUCTION MANAGER OR ARCHITECT PRIOR TO INSTALLATION.
- ALL ROCKS 3/4" DIAMETER AND LARGER, DIRT CLODS, STICKS, CONCRETE SPOILS, ETC. SHALL BE REMOVED PRIOR TO PLACING TOPSOIL AND ANY LAWN INSTALLATION
- CONTRACTOR SHALL PROVIDE (1") ONE INCH OF IMPORTED TOPSOIL ON ALL AREAS TO RECEIVE LAWN.


SOLID SOD NOTES

- 1 FINE GRADE AREAS TO ACHIEVE FINAL CONTOURS INDICATED. LEAVE AREAS TO RECEIVE TOPSOIL 3" BELOW FINAL DESIRED GRADE IN PLANTING AREAS AND 1" BELOW FINAL GRADE IN TURF
- ADJUST CONTOURS TO ACHIEVE POSITIVE DRAINAGE AWAY FROM BUILDINGS. PROVIDE UNIFORM ROUNDING AT TOP AND BOTTOM OF SLOPES AND OTHER BREAKS IN GRADE. CORRECT IRREGULARITIES AND AREAS WHERE WATER MAY STAND.
- ALL LAWN AREAS TO RECEIVE SOLID SOD SHALL BE LEFT IN A MAXIMUM OF 1" BELOW FINAL FINISH GRADE. CONTRACTOR TO COORDINATE OPERATIONS WITH ON-SITE CONSTRUCTION
- CONTRACTOR TO COORDINATE WITH ON-SITE CONSTRUCTION MANAGER FOR AVAILABILITY OF EXISTING TOPSOIL.
- PLANT SOD BY HAND TO COVER INDICATED AREA COMPLETELY. INSURE EDGES OF SOD ARE TOUCHING. TOP DRESS JOINTS BY HAND WITH TOPSOIL TO FILL VOIDS.
- ROLL GRASS AREAS TO ACHIEVE A SMOOTH, EVEN SURFACE, FREE FROM UNNATURAL UNDULATIONS.
- WATER SOD THOROUGHLY AS SOD OPERATION PROGRESSES.
- CONTRACTOR SHALL MAINTAIN ALL LAWN AREAS UNTIL FINAL ACCEPTANCE. THIS SHALL INCLUDE, BUT NOT LIMITED TO: MOWING, WATERING, WEEDING, CULTIVATING, CLEANING AND REPLACING DEAD OR BARE AREAS TO KEEP PLANTS IN A VIGOROUS, HEALTHY CONDITION.
- CONTRACTOR SHALL GUARANTEE ESTABLISHMENT OF AN ACCEPTABLE TURF AREA AND SHALL PROVIDE REPLACEMENT FROM LOCAL SUPPLY IF NECESSARY.
- IF INSTALLATION OCCURS BETWEEN SEPTEMBER 1 AND MARCH 1. ALL SOD AREAS TO BE OVER-SEEDED WITH WINTER RYEGRASS, AT A RATE OF (4) POUNDS PER ONE THOUSAND (1000) SQUARE FEET.

PLANT MATERIAL SCHEDULE

TREES			· · · · · · · · · · · · · · · · · · ·		
TYPE	QTY	COMMON NAME	BOTANICAL NAME	SIZE	REMARKS
CM LO	69	Crepe Myrtle 'Dallas Red' Live Oak	Lagerstroemia indica 'Dallas Red' Quercus virginiana	6' ht. 4" cal.	container, 3 or 5 trunks, 4' spread min.,tree for container, 13' ht., 5' spread, 5' clear straight to k
SHRUBS					
TYPE	QTY.	COMMON NAME	BOTANICAL NAME	SIZE	REMARKS
DYH IH LOR NPH	14 11 24 27	Dwarf Yaupon Holly Indian Hawthorn 'Clara' Loropetalum 'Ruby' Needlepoint Holly	llex vomitoria 'nana' Rhaphiolepis indica 'clara' Loropetalum chinensis 'Ruby' llex cornuta "Needlepoint'	5 gal. 5 gal. 5 gal. 5 gal.	container, 18" ht., 18" spread container, 20" ht., 20" spread container, 20" ht., 20" spread container , 24" ht., 20" spread
GROUND	COVERS		- 1710		
TYPE	QTY	COMMON NAME	BOTANICAL NAME	SIZE	REMARKS
		'419' Bermudagrass	Cynodon dactylon '419'		Solid Sod refer to notes

NOTE: Plant list is an aid to bidders only. Contractor shall verify all quantities on plan. All heights and spreads are minimums. All plant material shall meet or exceed remarks as indicated. All trees to have straight trunks and be matching

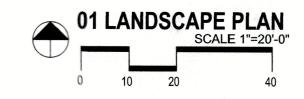

LANDSCAPE ARCHITECT STUDIO GREEN SPOT, INC 1784 W. McDERMOTT DR. SUITE 110 ALLEN, TEXAS 75013 (469) 369-4448 CHRIS@STUDIOGREENSPOT.



2 $\mathbf{\omega}$ & AKE EDGE

DRIVE TEXAS

PORTOFINO I

SP2023-02

WATER'S

DATE: 11.21.2019

SHEET NAME: LANDSCAPE PLAN

SHEET NUMBER:

PART 1 - GENERAL

REFERENCED DOCUMENTS

Refer to bidding requirements, special provisions, and schedules for additional requirements.

DESCRIPTION OF WORK

Work included: Furnish all supervision, labor, materials, services, equipment and appliances required to complete the work covered in conjunction with the landscaping covered in these specifications and landscaping plans, including:

- 1. Planting (trees, shrubs, and grass)
- Bed preparation and fertilization Notification of sources
- 4. Water and Maintenance until final acceptance Guarantee

REFERENCE STANDARDS

ART 3 - EXECUTION

BED PREPARATION & FERTILIZATION

(1,000) square feet.

C. Grass Areas:

INSTALLATION

B. All planting areas shall be conditioned as follows:

batter board against the bed areas.

- American Standard for Nursery Stock published by American Association of Nurserymen 27 October 1980, Edition; by American National Standards Institute, Inc. (Z60.1) - plant
- American Joint Committee on Horticultural Nomenclature: 1942 Edition of Standardized
- Texas Association of Nurserymen, Grades and Standards.
- Hortis Third, 1976 Cornell University

NOTIFICATION OF SOURCES AND SUBMITTALS

- The Contractor shall, within ten (10) days following acceptance of bid, notify the Architect/Owner of the sources of plant materials and bed preparation required for the
- Samples: Provide representative quantities of sandy loam soil, mulch, bed mix material, gravel, and crushed stone. Samples shall be approved by Architect before use on
- Product Data: Submit complete product data and specifications on all other specified materials.
- Submit three representative samples of each variety of ornamental trees, shrubs, and groundcover plants for Architect's approval. When approved, tag, install, and maintain as representative samples for final installed plant materials.
- File Certificates of Inspection of plant material by state, county, and federal authorities with Architect, if required.

Landscape Contractor to inspect all existing conditions and report any deficiencies to the

1. Prepare new planting beds by scraping away existing grass and weeds as necessary.

Apply fertilizer as per manufacturers recommendations. Add six (6") inches of

3. Backfill for tree pits shall be as follows: Use existing top soil on site (use imported

1. Areas to be Solid Sod Bermudagrass: Blocks of sod should be laid joint to joint,

topsoil where they are evidently gaped open, then watered thoroughly

(staggered joints) after fertilizing the ground first. Roll grass areas to achieve a smooth, even surface. The joints between the blocks of sod should be filled with

2. Areas to be Hydromulch Common Bermudagrass: Hydromulch with bermudagrass

Maintenance of plant materials shall begin immediately after each plant is delivered to the

Plant materials shall be delivered to the site only after the beds are prepared and area

ready for planting. All shipments of nursery materials shall be thoroughly protected from

the drying winds during transit. All plants which cannot be planted at once, after delivery

to the site, shall be well protected against the possibility of drying by wind and sun. Balls

of earth of B & B plants shall be kept covered with soil or other acceptable material. All

Notify the Landscape Architect for inspection and approval of all positioning of plant

depth that, when planted and settled, the crown of the plant shall bear the same

relationship to the finish grade as it did to soil surface in original place of growth.

Excavate pits with vertical sides and horizontal bottom. Tree pits shall be large enough to

permit handling and planting without injury to balls of earth or roots and shall be of such

plants remain the property of the Contractor until final acceptance.

Position the trees and shrubs in their intended location as per plan.

site and shall continue until all construction has been satisfactorily accomplished.

seed at a rate of two (2) pounds per one thousand (1,000) square feet. Use a 4' x 8'

topsoil as needed) free from large clumps, rocks, debris, caliche, subsoils, etc.,

All planting areas shall receive a two (2") inch layer of specified mulch.

placed in nine (9") inch layers and watered in thoroughly.

Till existing soil to a depth of six (6") inches prior to placing compost and fertilizer.

compost and till into a depth of six (6") inches of the topsoil. Apply organic fertilizer

such as Sustane or Green Sense at the rate of twenty (20) pounds per one thousand

F. Soil Analysis: Provide sandy loam soil analysis if requested by the Architect.

JOB CONDITIONS

- General Contractor to complete the following punch list: Prior to Landscape Contractor initiating any portion of landscape installation, General Contractor shall leave planting bed areas three (3") inches below finish grade of sidewalks, drives and curbs as shown on the drawings. All lawn areas to receive solid sod shall be left one (1") inch below the finish grade of sidewalks, drives, and curbs. All construction debris shall be removed prior to Landscape Contractor beginning any work.
- General Contractor shall provide topsoil as described in Section 02200 Earthwork.
- Storage of materials and equipment at the job site will be at the risk of the Landscape Contractor. The Owner cannot be held responsible for theft or damage.

MAINTENANCE AND GUARANTEE

A. Maintenance:

- 1. The Landscape Contractor will be held responsible for the maintenance of all work from the time of planting until final acceptance by the Owner. No trees, shrubs, groundcover or grass will be accepted unless they show a healthy growth and satisfactory foliage conditions.
- 2. Maintenance shall include watering of trees and plants, cultivation, weeding spraying, edging, pruning of trees, mowing of grass, cleaning up and all other work necessary
- 3. A written notice requesting final inspection and acceptance should be submitted to the Owner at least seven (7) days prior to completion. An on-site inspection by
- Owner and Landscape Contractor will be completed prior to written acceptance. 4. After final acceptance of installation, the Landscape Contractor will not be required to do any of the above listed work.

cases, the opinion of the Owner shall be final.

- 1. Trees shall be guaranteed for a twelve (12) month period after acceptance. Shrubs and groundcover shall be guaranteed for twelve (12) months. The Contractor shall replace all dead materials as soon as weather permits and upon notification of the Owner. Plants, including trees, which have partially died so that shape, size, or symmetry has been damaged, shall be considered subject to replacement. In such
- a. Plants used for replacement shall be of the same size and kind as those originally planted and shall be planted as originally specified. All work, including materials, labor and equipment used in replacements, shall carry a twelve (12) month guarantee. Any damage, including ruts in lawn or bed areas, incurred as a result of making replacements shall be immediately
- b. At the direction of the Owner, plants may be replaced at the start of the next year's planting season. In such cases, dead plants shall be removed from the premises immediately.
- c. When plant replacements are made, plants, soil mix, fertilizer and mulch are to be utilized as originally specified and reinspected for full compliance with Contract requirements. All replacements are to be included under "Work" of this section.

Shrub and tree pits shall be no less than two (2') feet, twenty-four (24") inches, wider than

the lateral dimension of earth ball and six (6") inches deeper than it's vertical dimension.

Remove and haul from site all rocks and stones over one (1") inch in diameter. Plants

the surface of the ground. The sides of the hole should be rough and jagged, never slick

hours, the tree needs to move to another location or have drainage added. Install a PVC

Backfill only with 5 parts existing soil or sandy loam and 1 part bed preparation. When

the hole is dug in solid rock, topsoil from the same area should not be used. Carefully

settle by watering to prevent air pockets. Remove the burlap from the top 1/3 of the ball,

Mulch the top of the ball. Do not plant grass all the way to the trunk of the tree. Leave the

area above the top of the ball and mulch with at least two (2") inches of specified mulch.

All plant beds and trees to be mulched with a minimum settled thickness of two (2")

Obstruction below ground: In the event that rock, or underground construction work or

obstructions are encountered in any plant pit excavation work to be done under this

section, alternate locations may be selected by the Owner. Where locations cannot be

changed, the obstructions shall be removed to a depth of not less than three (3') feet

properly set at the required grade. The work of this section shall include the removal from

below grade and no less than six (6") inches below the bottom of ball when plant is

Trees and large shrubs shall be staked as site conditions require. Position stakes to

Pruning and Mulching. Pruning shall be directed by the Architect and shall be pruned in

accordance with standard horticultural practice following Fine Pruning, Class I pruning

1. Dead wood or suckers and broken badly bruised branches shall be removed. Genera

Immediately after planting operations are completed, all tree pits shall be covered wit

a layer of organic material two (2") inches in depth. This limit of the organic material

1. Curbing shall be aligned as indicated on plans. Stake out limits of steel curbing and

Stakes are to be installed on the planting bed side of the curbing, as opposed to the

tipping of the branched is not permitted. Do not cut terminal branches.

the site of such rock or underground obstructions encountered at the cost of the

as well as all nylon, plastic string and wire mesh. Container trees will usually be pot

G. Dig a wide, rough sided hole exactly the same depth as the height of the ball, especially at

H. Percolation Test: Fill the hole with water. If the water level does not percolate within 24

stand pipe per tree planting detail as approved by the Landscape Arch

bound, if so follow standard nursery practice of 'root scoring'.

Do not wrap trees

inches over the entire bed or pit.

secure tree against seasonal prevailing winds.

standards provided by National Arborist Association.

Pruning shall be done with clean, sharp tools.

obtain Owners approval prior to installation.

Do not install steel edging along sidewalks.

All steel curbing shall be free of kinks and abrupt bends Top of curbing shall be 3/4" maximum height above grade.

areas clean by sweeping or hosing at end of each days work.

Cut steel edging at 45 degree angle where edging meets sidewalk.

END OF SECTION

Cleanup: During the work, the premises shall be kept neat and orderly at all times. Storage areas for all materials shall be so organized that they, too, are neat and orderly. All trash and debris shall be removed from the site as work progresses. Keep paved

Landscape Contractor.

CLEANUP AND ACCEPTANCE

K. Do not over prune

should be thoroughly moist before removing containers.

The Owner agrees that for the guarantee to be effective, he will water plants at least twice a week during dry periods and cultivate beds once a month after final

- 3. The above guarantee shall not apply where plants die after acceptance because of injury from storms, hail, freeze, insects, diseases, injury by humans, machines or
- Acceptance for all landscape work shall be given after final inspection by the Owner provided the job is in a completed, undamaged condition, and there is a stand of grass in all lawn areas. At this time, the Owner will assume maintenance on the accepted work.
- Repairs: Any necessary repairs under the Guarantee must be made within ten (10) days after receiving notice, weather permitting, and in the event the Landscape Contractor does not make repairs accordingly, the Owner, without further notice to Contractor, may provide materials and men to make such repairs at the expense of the Landscape Contractor.

QUALITY ASSURANCE

- General: Comply with applicable Federal, State, County and Local regulations governing landscape materials and work
- Personnel: Employ only experienced personnel who are familiar with the required work. Provide full time supervision by a qualified foreman acceptable to Landscape Architect.

Selection of Plant Material:

- 1. Make contact with suppliers immediately upon obtaining notice of contract acceptance to select and book materials. Develop a program of maintenance (pruning and fertilization) which will insure the purchased materials will meet and/or exceed project specifications
- 2. Landscape Architect will provide a key identifying each tree location on site. Written verification will be required to document material selection, source and delivery schedules to site.
- 3. Owner and/or Architect shall inspect all plant materials when reasonable at place of growth for compliance with requirements for genus, species, cultivar/variety, size and

4. Owner and/or Architect retains the right to further inspect all plant material upon

arrival at the site and during installation for size and condition of root balls, limbs, branching habit insects injuries and latent defects. 5. Owner and/or Architect may reject unsatisfactory or defective material at any time during the process of work. Remove rejected materials from the site immediately.

PRODUCT DELIVERY, STORAGE AND HANDLING

Preparation:

4" DIA. PERFORATED

PVC PIPE W/ CAP -

PAINTED BLACK

- Balled and Burlapped (B&B) Plants: Dig and prepare shipment in a manner that will not damage roots, branches, shape, and future development.
- 2. Container Grown Plants: Deliver plants in rigid container to hold ball shape and

Plants damaged in transit or at job site shall be rejected.

- 1. Deliver packaged materials in sealed containers showing weight, analysis and name of manufacturer. Protect materials from deterioration during delivery and while stored
- 2. Deliver only plant materials that can be planted in one day unless adequate storage
- and watering facilities are available on job site. 3. Protect root balls by heeling in with sawdust or other approved moisture retaining
- material if not planted within 24 hours of delivery. 4. Protect plants during delivery to prevent damage to root balls or desiccation of leaves.
- Keep plants moist at all times. Cover all materials during transport. 5. Notify Architect of delivery schedule 72 hours in advance so plant material may be observed upon arrival at job site.
- Remove rejected plant material immediately from site. 7. To avoid damage or stress, do not lift, move, adjust to plumb, or otherwise
- manipulate plants by trunk or stems.

PART 2 - PRODUCTS

2.1 PLANTS

- General: Well-formed No. 1 grade or better nursery grown stock. Listed plant heights are from tops of root balls to nominal tops of plants. Plant spread refers to nominal outer width of the plant, not to the outer leaf tips. Plants will be individually approved by the Architect and his decision as to their acceptability shall be final.
- Quantities: The drawings and specifications are complimentary. Anything called for on one and not the other is as binding as if shown and called for on both. The plant schedule is an aid to bidders only. Confirm all quantities on plan.
- Quality and size: Plant materials shall conform to the size given on the plan, and shall be healthy, symmetrical, well-shaped, full branched, and well rooted. The plants shall be free from injurious insects, diseases, injuries to the bark or roots, broken branches, objectionable disfigurements, insect eggs and larvae and are to be of specimen quality.
- Approval: All plant materials shall be subject to the approval of the Owner. All plants which are found unsuitable in growth, or in any unhealthy, badly shaped, or undersized condition, will be rejected by the Landscape Architect, either before or after planting, and shall be removed at the expense of the Landscape Contractor and replaced with acceptable plants as specified.
- Trees shall be healthy, full-branched, well-shaped and shall meet the trunk diameter and height requirements of the plant schedule. Balls shall be firm, neat, slightly tapered, and well wrapped in burlap. Any tree loose in the ball or with broken ball at time of planting will be rejected. Balls shall be ten (10") inched in diameter for each one (1") inch of trunk diameter, Measured six (6") inched above ball. Nomenclature conforms to the customary nursery usage: for clarification, the term
- Pruning: All pruning of trees and shrubs, as directed by the Landscape Architect, shall be executed by the Landscape Contractor at no additional cost to the Owner.

"multi-trunk" defines a plant having three (3) or more trunks of nearly equal diameter

2.2 SOIL PREPARATION MATERIALS


- A. Sandy Loam:
- 1. Friable, fertile, dark, loamy soil, free of clay lumps, subsoil, stones and other extraneous material and reasonably free of weeds and foreign grasses. Loam containing Dallasgrass or Nutgrass shall be rejected.
- 2. Physical properties as follows: Clay - between 7-27 percent Silt - between 15-25 percent
- Sand less than 52 percent 3. Organic matter shall be 3%-10% of total dry weight. 4. If requested, provide a certified soil analysis conducted by an approved soil testing
- laboratory verifying that sandy loam meets the above requirements. Organic Material: Compost with a mixture of 80% vegetative matter and 20% animal
- waste. Ingredients should be a mix of course and fine textured material.
- Premixed Bedding Soil as supplied by Vital Earth Resources, Gladewater, Texas; Professional Bedding Soil as supplied by Living Earth Technology, Dallas, Texas or Acid Gro Municipal Mix as supplied by Soil Building Systems, Dallas, Texas or approved equal.


Mulch: Double Shredded Hardwood Mulch, partially decomposed, dark brown. Living

- Sharp Sand: Sharp sand must be free of seeds, soil particles and weeds.
- Earth Technologies or approved equal.
- Organic Fertilizer: Fertilaid, Sustane, or Green Sense or equal as recommended for required applications. Fertilizer shall be delivered to the site in original unopened containers, each bearing the manufacturer's guaranteed statement of analysis.
- Commercial Fertilizer: 10-20-10 or similar analysis. Nitrogen source to be a minimum 50% slow release organic Nitrogen (SCU or UF) with a minimum 8% sulphur and 4% iron,
- Peat: Commercial sphagnum peat moss or partially decomposed shredded pine bark or other approved organic material.

MISCELLANEOUS MATERIALS

- A. Steel Edging: Shall be Ryerson "Estate Curbing", 1/8" x 4" with stakes 4' on center.
- Staking Material for Shade Trees:
- 1. Post: Studded T-Post, #1 Armco with anchor plate; 6'-0" length; paint green.
- Wire: 12 gauge, single strand, galvanized wire. 3. Rubber hose: 2 ply, fiber reinforced hose, minimum ½ inch inside diameter. Color:
- Gravel: Washed native pea gravel, graded 1 in. to 1-1/2 in.
- Filter Fabric: Mirafi 140N by Celanese Fibers Marketing Company, available at Loftland Co., (214) 631-5250 or approved equal.

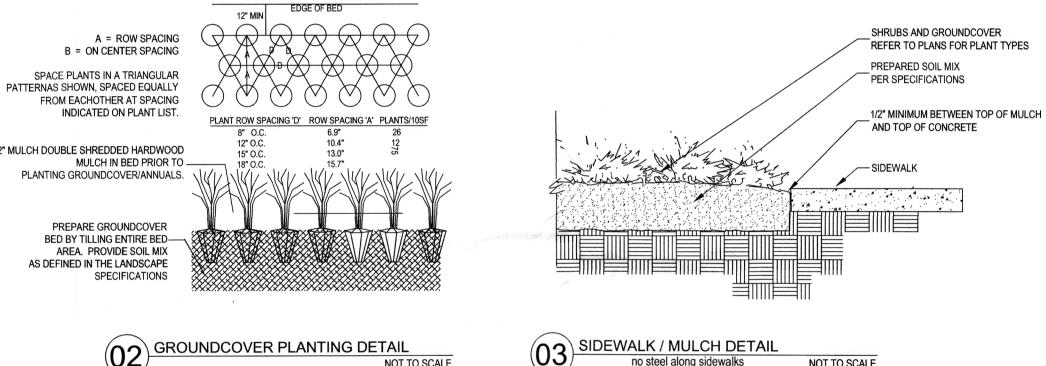

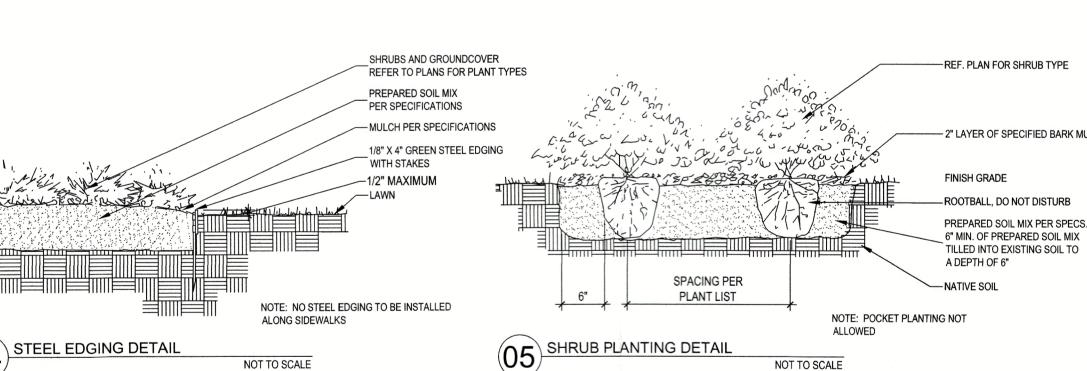

INDICATED ON PLANT LIST 2" MULCH DOUBLE SHREDDED HARDWOOD PLANTING GROUNDCOVER/ANNUALS. PREPARE GROUNDCOVER BED BY TILLING ENTIRE BED--DO NOT CUT CENTRAL LEADER AREA. PROVIDE SOIL MIX AS DEFINED IN THE LANDSCAPE -REFERENCE PLAN FOR TREE TYPE -RUBBER HOSE 2 STRANDS NO. 12 GAUGE GALVANIZED WIRE, TWISTED -2" LAYER MULCH, REF. SPECIFICATIONS

- 2" HIGH WATERING RING

(3) METAL T-POST PAINTED

GREEN TRIANGULAR SPACING.

INISH GRADE SCARIFY SIDES

ROOTBALL, DO NOT DISTURB. TOP

OF ROOTBALL TO BE SET 1" ABOVE

-NATIVE SOIL, REF. SPECIFICATIONS

NOTE: LOCATE STAKES OUTSIDE

OF TREE WELL. POSITION STAKES

TO SECURE TREE AGAINST SEASONAL

- CRUSHED ROCK

PREVAILING WINDS.

EXISTING GRADE. REMOVE TOP 1/3 BURLAP.

STEEL EDGING DETAIL

- 2" LAYER OF SPECIFIED BARK MULCH PREPARED SOIL MIX PER SPECS.

NOT TO SCALE

TREE PLANTING DETAIL

OF ROOTBALL

LANDSCAPE SPECIFICATIONS SIGNATURE BLOCK

I hereby certify that the above and foregoing site plan for a development in the City of Rockwall, Texas, was approved by the Planning & Zoning Commission of the City of Rockwall on the 12 day of September, 2023. WITNESS DUR HANDS, this 12 day of September, 2003.

Planning & Zoning Commission, Chairman Director of Planning and Zoning

LANDSCAPE ARCHITECT STUDIO GREEN SPOT, INC 1784 W. McDERMOTT DR. SUITE 110 ALLEN, TEXAS 75013 (469) 369-4448 CHRIS@STUDIOGREENSPOT.



UB AKE AT GE Ш S 2 WATE

DRIVI TEXA

 α

Ø


 $\mathbf{\omega}$

DATE:

11.21.2019

SHEET NAME: LANDSCAPE SPECIFICATIONS

SHEET NUMBER:

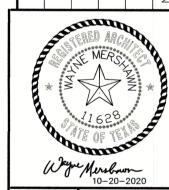

PLUTUS 21 E AT LAKE RAY I

Scale: 3/16" = 1'-0"

04/21/2023 Project No.: Designed: GW

Checked: WM SHEET

WITHOUT PERMISSION FROM MERSHAWN.

SIONE WAIER LABLE

ELEVATION PLAN SIGNATURE BLOCK

- STUCCO TO MATCH EXISTING

EAST ELEVATION

100% MASONRY 9% STONE 91% STUCCO

STUCCO SILL

PRICING & CONSTRUCTION GENERAL NOTES:

- THESE DRAWINGS ARE DIAGRAMMATIC IN NATURE AND ARE NOT INTENDED TO INDICATE EACH AND EVERY FITTING, OFFSET, OR OTHER APPURTENANCE NECESSARY TO COMPLETE THE SYSTEM.
- 2. IT IS THE SUBCONTRACTOR'S RESPONSIBILITY TO REVIEW THE DOCUMENTS AND INCLUDE ALL NECESSARY ITEMS TO PROVIDE A COMPLETE OPERATIONAL SYSTEM.
- 3. ANY DISCREPANCIES NOTED BY THE SUBCONTRACTOR SHALL BE BROUGHT TO THE ATTENTIONS OF THE ARCHITECT (IN WRITING) BEFORE BIDDING THIS PROJECT.
- 4. AFTER BIDS ARE TURNED IN, THE SUBCONTRACTOR SHALL COMPLETE THE SYSTEMS AT NO ADDITIONAL COST.
- 5. PLUMBING, MECHANICAL, AND ELECTRICAL SUBCONTRACTORS ARE RESPONSIBLE FOR COORDINATING ALL COMPONENTS TO INSURE COMPLETE AND WORKING SYSTEMS
 EACH SUBCONTRACTOR SHALL REVIEW ALL
 DRAWINGS FOR COMPLIANCE.
- 6. THE ARCHITECT WILL BE RESPONSIBLE TO DETERMINE WHICH TRADE SHALL PROVIDE AND INSTALL ANY COMPONENTS MISSED FOR WORKING SYSTEMS AS NEEDED.

OWNER
PLUTUS21 DEVELOPMENT

6116 N. CENTRAL EXPWY #700 DALLAS, TEXAS 75206


CASE #SP2020-000

© COPYRIGHT 2019 MERSHAWN ARCHITECTS, INC. NO PRINTING OR COPING IS ALLOWED WITHOUT PERMISSION FROM MERSHAWN,

PLUT E AT

Scale: 3/16" = 1'-0" 04/21/2023 Project No.: 190602 Designed: GW

Drawn: Checked: WM SHEET

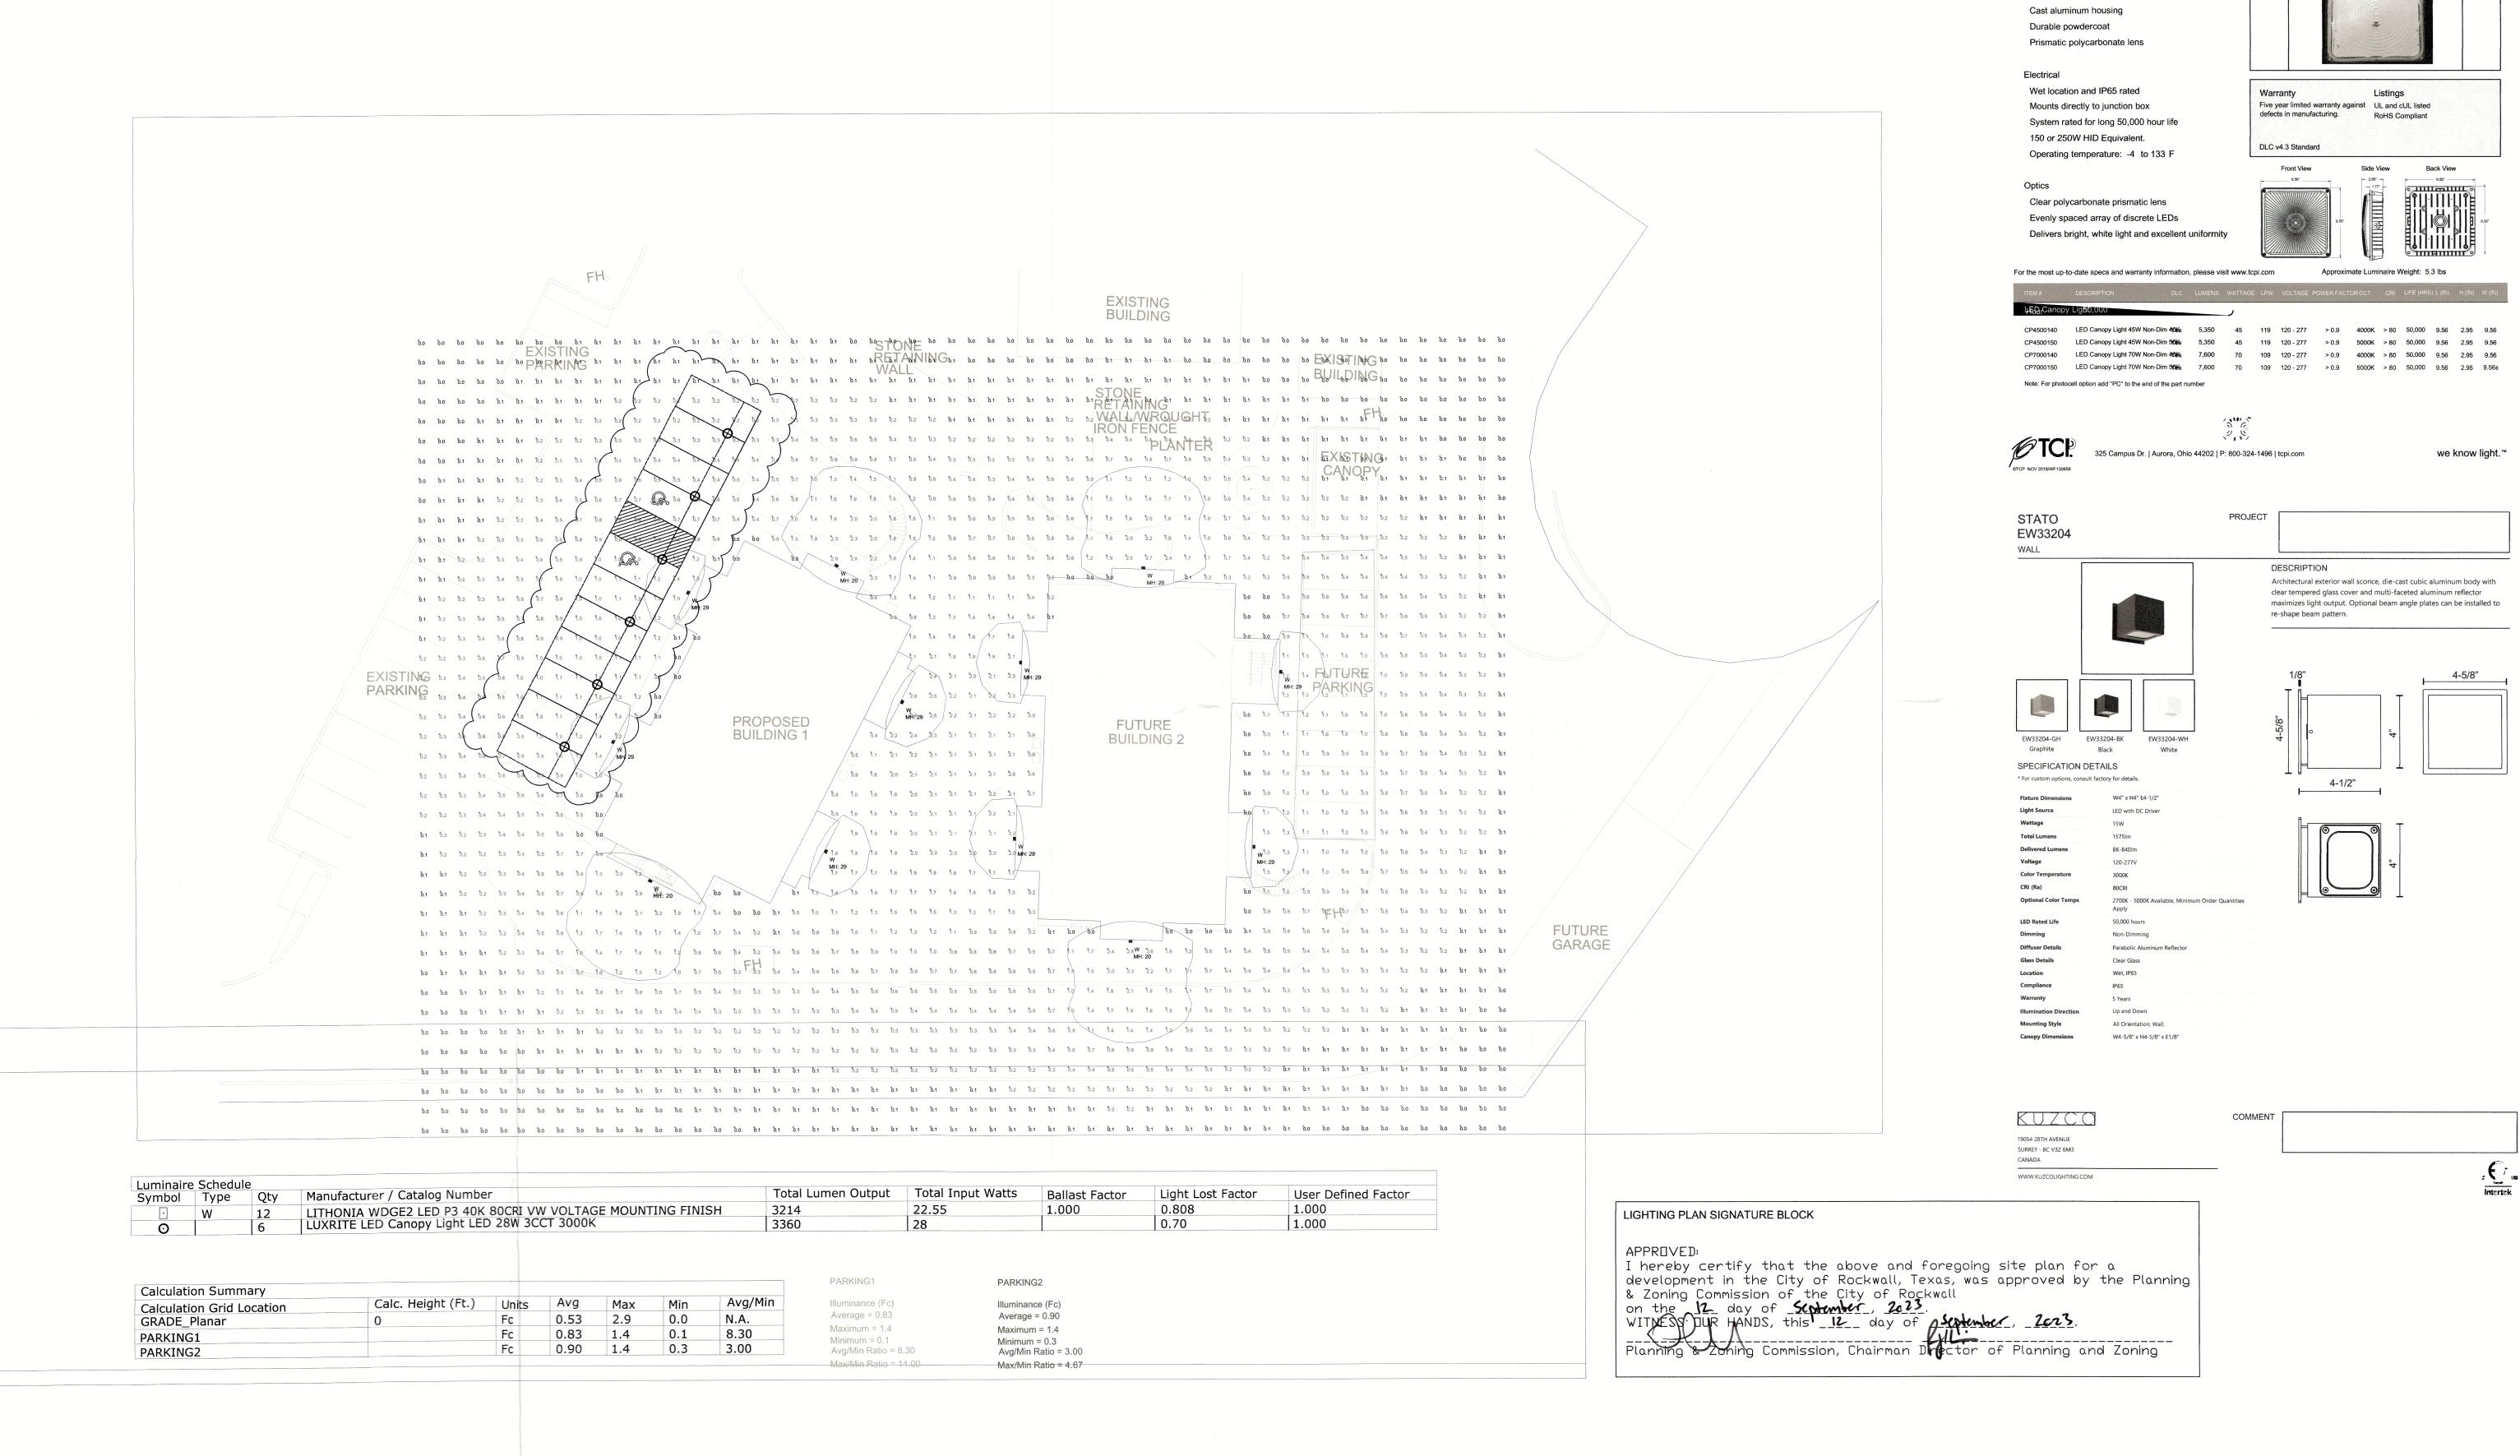

Elements

LED Technical Data

LED Canopy Lights

This product family can be effectively used in outdoor ceiling mount locations. Commercial, industrial, retail

awnings, canopies, security lighting, etc.

and healthcare exterior lighting; Parking garages,

Construction

