

C.E.C.I.

C.E.C.I.

1''=20'

SMOOTHIE KING ROCKWALL

Project No.

20089

CITY OF ROCKWALL, TEXAS



ARCHITECTURAL ELEMENTS:

1. CANOPIES

2. DISPLAY WINDOWS

3. OUTDOOR PATIO

4. ARCHITECTURAL DETAILS - ACCENT BANDS

5. REVEALS



100%


23.8%

SOUTH

WEST

TOTAL FACADE = 2,123.6 SF 100% TOTAL GLASS = 193.7 SF 9.1% -TOTAL DOORS = 72.6 SF 3.4% NET FACADE = 1,857.3 SF

TOTAL BRICK/CAST STONE = 371.6 SF 20.0% TOTAL NATURAL STONE = 794.9 SF 42.8% = 590.4 SF = 99.9 SF TOTAL STUCCO TOTAL METAL

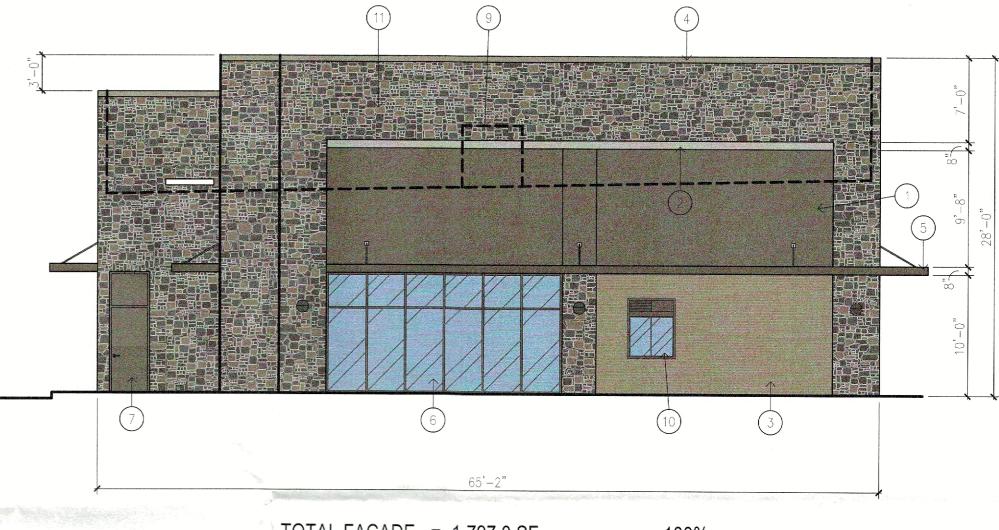


TOTAL FACADE = 1,797.0 SF -TOTAL GLASS = 216.6 SF 12.0% TOTAL DOORS = 24.2 SF

NET FACADE = 1,556.2 SF 1.3%

TOTAL BRICK/CAST STONE = 204.6 SF 13.1% TOTAL NATURAL STONE = 877.8 SF TOTAL STUCCO = 407.6 SF = 66.0 SF 26.2% TOTAL METAL

APPROVED:

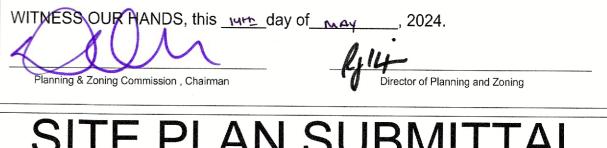


I hearby certify that the above and foregoing site plan for a development in the city of Rockwall, Texas, was approved by the

Planning & Zoning Commission of the City of Rockwall on the 14th day of _______, 2024.

SITE PLAN SUBMITTAI

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		OWNEF CC ROCKWA	₹: ALL, LLC		
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	8350 SUITE	OWNER CC ROCKWA O NORTH CENTRA E 1300 DAL	R: ALL, LLC L EXPRES LAS, TEXA	SWAY, S 75206	
	8350 SUITE	OWNER CC ROCKWA O NORTH CENTRA E 1300 DAL BOSE 214-701-84	R: ALL, LLC L EXPRES LAS, TEXA 55 chad@f	SWAY, S 75206	
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SPECIFICATIONS

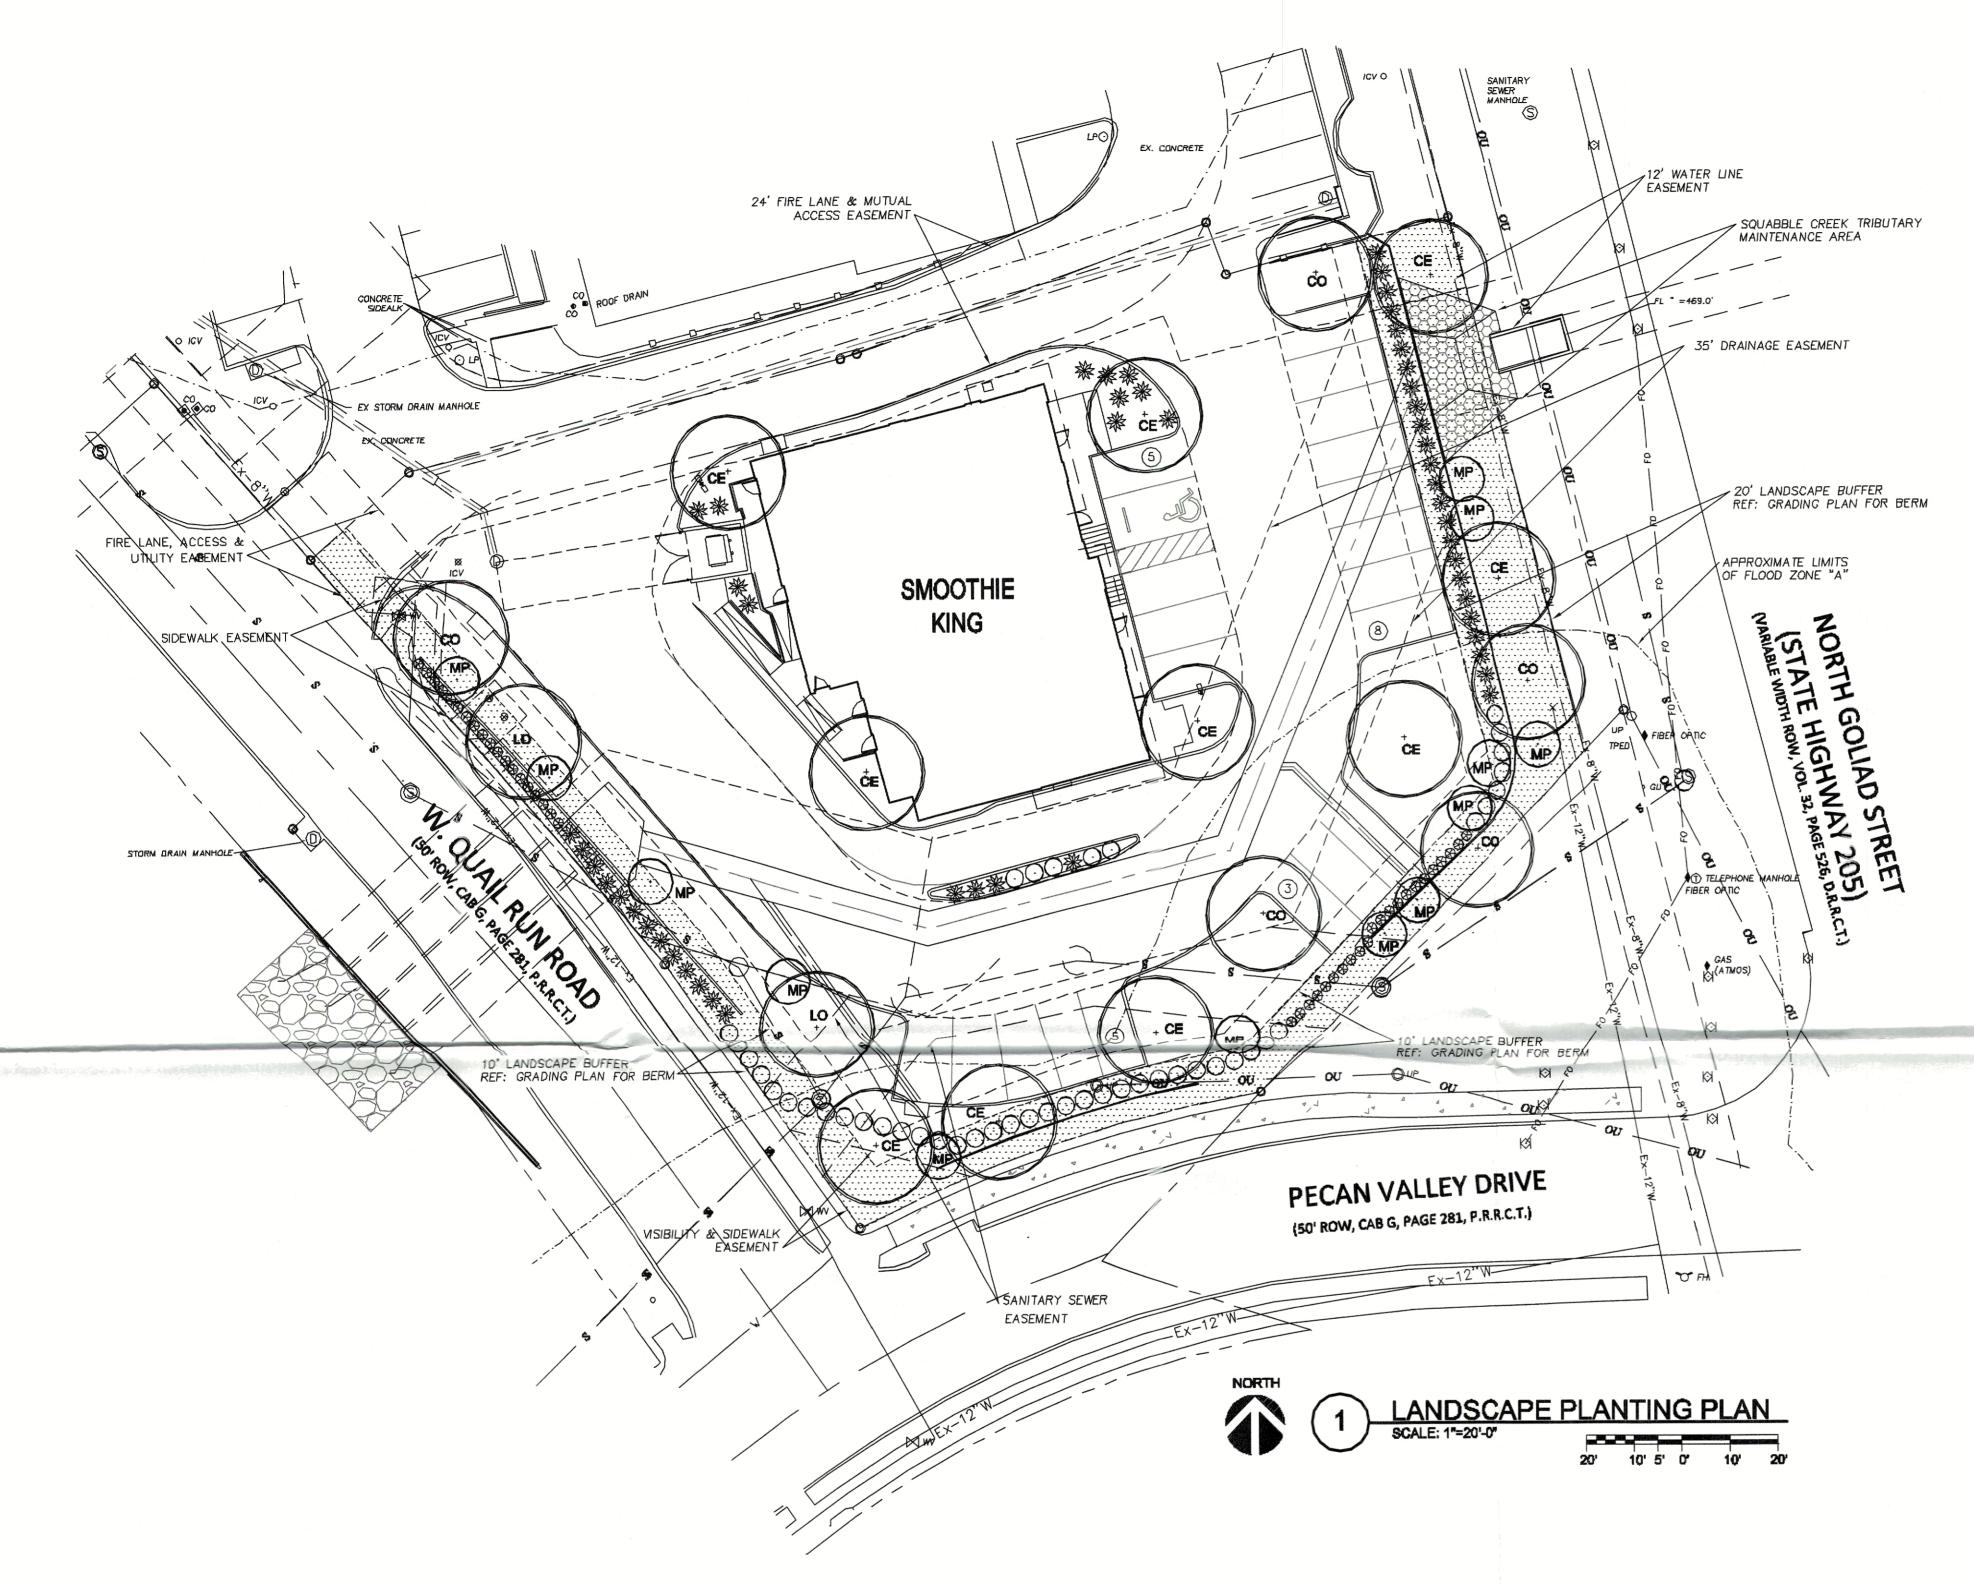Leucophyllum frutescens "Compacta" | 5 gallon, 48" on center.

5" cal. 12'-14' tall, b&b.

5" cal. 12'-14' tall, b&b.

5" cal. 12'-14' tall, b&b.

5 gallon, 30" on center.

5 gallon, 48" on center.

1 gallon, 18" on center.

solid sod

2" cal., 6'-8' tall, container

PLANT MATERIAL SCHEDULE

KEY QUAN COMMON NAME

CANOPY TREES

CO | 5 | CHINQUAPIN OAK

MP | 13 | MEXICAN PLUM

ORNAMENTAL TREES

CTS | 45 | COMPACT TEXAS SAGE

TIFF TURF BERMUDA

CE | 10 | CEDAR ELM

LO 2 LIVE OAK

RM 41 ROSEMARY

RY | 54 | RED YUCCA

TURF GRASS

SROUNDCOVER

SHRUBS

BOTANICAL NAME

Quercus muhlenbergi

Ulmus crassifolia

Quercus virginiana

Prunis mexicana

Rosemary officinalis

Hesperaloe parvifolia

Cynodon spp. "Tiff Turf"

PW | - | PURPLE MNTERCREEPER | Euonymus fortunei 'Coloratus'

MAINTENANCE NOTE:

THE OWNER, TENANT AND THEIR AGENT, IF ANY, SHALL BE JOINTLY AND SEVER-ALLY RESPONSIBLE FOR THE MAINTENANCE OR ALL LANDSCAPING, ALL REQUIRED LANDSCAPING SHALL BE MAINTAINED IN A NEAT AND ORDERLY MANNER AT ALL TIMES. THIS SHALL INCLUDE, BUT NOT BE LIMITED TO: MOWING (OF TURF GRASS SIX (6") INCHES OR HIGHER), EDGING, PRUNING, FERTILIZING, WATERING, WEEDING. AND OTHER SUCH ACTIVITIES COMMON TO THE MAINTENANCE OF LANDSCAPING. LANDSCAPED AREAS SHALL BE KEPT FREE OF ALL TRASH, LITTER, WEEDS, AND OTHER SUCH MATERIALS OR PLANTS THAT ARE NOT A PART OF THE LAND-SCAPING, ALL PLANT MATERIALS SHALL BE MAINTAINED IN A HEALTHY AND GROWING CONDITION AS IS APPROPRIATE FOR THE SEASON OF THE YEAR. PLANT MATERIALS WHICH DIE SHALL BE REPLACED WITH PLANT MATERIAL OF SIMILAR SIZE, WITHIN NINETY (90) DAYS. TREES WITH A TRUNK DIAMETER IN EXCESS OF SIX (6") INCHES MEASURED TWENTY-FOUR (24") INCHES ABOVE THE GROUND MAY BE REPLACED WITH ONES (THAT HAVE BEEN PRE-APPROVED) OF SIMILAR VARIETY, HAVING A TRUNK DIAMETER OF ND LESS THAN THREE (3") INCHES MEASURED TWENTY-FOUR (24") INCHES ABOVE THE CROUND. A TIME EXTENTION MAY BE GRANTED BY CITY STAFF IF SUBSTANTIAL EVIDENCE IS PRESENTED TO INDICATE ABNORMAL CIRCUMSTANCES BEYOND THE CONTROL OF THE OWNER OR HIS AGENT.

LANDSCAPE CALCULATIONS

ZONING - COMM (20%) LANDSCAPE AREA REQUIRED. LOT AREA - 32,676 SF 20% = 6.535 SF

LANDSCAPE AREA PROVIDED = 9,308 SF = 28.4% WITH 7,513 SF = IN FRONT YARD.

LANDSCAPE BUFFER AT STREET R.O.W. = 10' WITH 1-CANOPY TREE & 1-ACCENT TREE/50' AND A ROW OF SHRUBS AND A BERM.

180'/50' = 4+4QUAIL RUN = 180' 3-CANOPY TREES* & 4 ORN, TREES PROVIDED. PECAN VALLEY = 185' 185'/50' = 4+4

4-CANOPY TREES & 4 ORN, TREES PROVIDED. LANDSCAPE BUFFER AT SH-205 = 20' WITH 2-CANOPY TREE & 4-ACCENT TREE/100' AND A ROW OF SHRUBS AND A BERM. SH-205 (N. GOLIAD ST.) = 110' 110'/100' = 3+5

11 CANOPY TREES REQUIRED.
13 ACCENT TREES REQUIRED.

118 SHRUBS PROVIDED. INTERIOR PARKING LOT LANDSCAPING: 4.374 SE PARKING LOT AREA 1,120 SF LANDSCAPE AREA PROVIDED = 25%

NOTES:

ALL TREES MUST BE PLANTED AT LEAST FIVE (5) FEET FROM WATER, SEWER AND STORM LINES.

IRRIGATION SYSTEM WILL MEET

REQUIREMENTS OF UDC.

ALL RETAINING WALLS SHALL BE

FINISHED IN ROCK OR STONE. HEADLIGHT SCREENING ALONG SH 205

DRIVE MEETS REQUIREMENTS OF S.U.P S-293. BERMS SHALL NOT BE PLACED IN AREAS THAT WILL BLOCK DRAINAGE OF SQUABBLE

(N. GOLIAD STREET) AND PECAN VALLEY

CREEK TRIBUTARY. * 1 OF THE 4 CANOPY STREET TREES ON QUAIL RUN IS RELOCATED TO PARK SITE.

LANDSCAPE NOTES:

- 01. ALL LANDSCAPE REQUIREMENTS AND UNDERGROUND IRRIGATION SYSTEM WILL CONFORM TO THE LOCAL CITY ORDINANCE AND DESIGN STANDARDS AND ANY REQUIREMENTS OF THE STATE, IF APPLICABLE.
- 02. NO PLANT MATERIAL SHALL BE PLANTED UNTIL THE LANDSCAPE IRRIGATION SYSTEM HAS BEEN INSTALLED AND IS OPERATING WITH 100% COVERAGE OF PROPOSED LANDSCAPE AREAS.
- 03. THE LANDSCAPE CONTRACTOR SHALL BE RESPONSIBLE FOR MAKING HIMSELF FAMILIAR WITH ALL UNDERGROUND UTILITIES, PIPES, CABLES, STRUCTURES
- 04. THE CONTRACTOR IS RESPONSIBLE FOR VERIFICATION OF ALL QUANTITIES BASED ON THE DRAWING(S) AND ACTUAL FIELD DIMENSIONS. PLANT QUANTITIES HAVE BEEN PROVIDED AS A CONVENIENCE ONLY TO THE OWNER(S) AND SHALL NOT BE CONSIDERED ABSOLUTE, CONTRACTOR SHALL FOLLOW DESIGN INTENT.
- 05. NOTIFY THE OWNER OF ANY DISCREPANCIES THAT ARISE DURING THE CONSTRUCTION PERIOD. FAILURE TO MAKE SUCH DISCREPANCIES KNOWN TO OWNER WILL RESULT IN THE CONTRACTOR'S LIBILITY TO REDO WORK AS NECESSARY TO ACHIEVE THE DESIGN INTENT.
- 06. PROTECT EXISTING VEGETATION, EQUIPMENT, STRUCTURES, UTILITIES, AND OTHER IMPROVEMENTS AT THE PROJECT SITE AND ON ADJACENT PROPERTIES, EXCEPT THOSE INDICATED TO BE REMOVED OR ALTERED. ALL AREAS DISTURBED BY DEMOLITION AND CONSTRUCTION ACTIVITIES SHALL BE REPAIRED AND RESTORED TO THEIR PRE-CONSTRUCTION CONDITION INCLUDING: PAVEMENTS, LANDSCAPE AREAS, IRRIGATION AND LIGHTING.
- 07. PROVIDE MEASURES AS REQUIRED TO PREVENT EROSION AND DISCHARGE OF SOIL-BEARING RUNOFF AND AIRBORNE DUST TO UNDISTURBED AREAS AND ADJACENT PROPERTIES, SIDEWALKS, STREETS, AND OTHER PAVED SURFACES.
- 08. ALL PROPOSED SUBSTITUTIONS MUST BE APPROVED BY THE LANDSCAPE ARCHITECT PRIOR INSTALLATION.
- 09. NOTIFY THE LANDSCAPE ARCHITECT IF LAYOUT OF TREES, BEDS AND/OR PLANTS REQUIRE ALTERATION FROM THE LANDSCAPE PLAN. NOTIFICATION WILL BE REQUIRED PRIOR TO ALTERING THE LAYOUT.
- 10. TREES SHALL BE HANDLED BY ROOT BALLS ONLY, DO NOT DAMAGE BALL, TRUNK, OR LOOSEN TRUNK FROM BALL. TREE TRUNKS ARE TO BE PLANTED STRAIGHT AND MAY BE REQUIRED BY THE OWNER AND/OR THE LANDSCAPE ARCHITECT
- 11. WHERE NEWLY PLANTED TREES ARE NOT ABLE TO STAND ON THEIR OWN, TREES SHALL BE STAKED WITH AN AT-GRADE ROOT BALL SECURING SYSTEM. THE SYSTEM SHALL SECURELY ANCHOR THE ROOT BALL, WHILE ALLOWING THE TRUNK AND CROWN TO MOVE NATURALLY, THE SYSTEM SHALL NOT USE MATERIALS AND METHODS THAT PENETRATE OR DAMAGE THE ROOT BALL, ABOVE GRADE STAKEING SYSTEMS SUCH AS 'T' POSTS WITH WIRES, HOSES, STRAPS, OR GUY WIRES WRAPPED AROUND THE TREE TRUNK SHAL NOT BE ALLOWED UNLESS AUTHORIZED BY THE LANDSCAPE ARCHITECT.
- 12. ALL TREES TO BE UNIFORM BY SPECIES WITH STRAIGHT TRUNKS AND MATCHING CHARACTER AND BRANCHING STRUCTURE,
- 13. ALL TREE LOCATIONS SHALL BE APPROVED BY THE OWNER OR OWNER'S REPRESENTATIVE PRIOR TO PLANTING.
- 14. FINAL LOCATIONS OF PLANT MATERIAL IS SUBJECT FOR REVIEW AND APPROVAL BY OWNER PRIOR TO PLANTING.
- 15. PROVIDE POSITIVE DRAINAGE THROUGHOUT THE PROJECT AREA, NO PONDING
- OR STANDING WATER IS ACCEPTABLE. 16. CONTRACTOR SHALL PROVIDE A MINIMUM 2% SLOPE AWAY FROM ALL BUILDINGS.
- 17. AT NO TIME WILL ANY PLANT MATERIAL BE ALLOWED TO SETTLE BEYOND THE TOP OF THE ROOT FLARE OR POTTED SOIL LINE. SHOULD PLANT MATERIAL SETTLE, THE PLANT(S) WILL BE REPLANTED AT THE PROPER HEIGHT AND/OR REPLACED IF NECESSARY AT THE CONTRACTOR'S COST.
- 18. ALL PROPOSED BED AREAS SHALL BE TILLED TO A DEPTH OF SIX INCHES (6"), ADDING A THREE INCH (3") MINIMUM LAYER OR ORGANIC COMPOST DURING THE PROCESS, THE LEVEL OF THE BED AREAS SHOULD BE LEFT THREE INCHES (3") ABOVE THE PROPOSED FINISHED GRADE TO ALLOW FOR COMPACTION AND SETTLEMENT.
- 19. ALL BED AREAS SHALL BE SEPARATED FROM TURF AREAS USING 1/8" X 4" STEEL EDGING, PAINTED GREEN. ALL ENDS OF STEEL EDGE RUNS SHALL HAVE A RADIUS OR 45 DEGREE ANGLE TO ELIMINATE SHARP EDGES. HAND FILING MAY BE REQUIRED TO ACHIEVE A SMOOTH EDGE.
- 20. TRIM STEEL EDGING AT A 45 DEGREE ANGLE WHEN EDGING INTERSECTS WITH A WALK OR CURB. DO NOT INSTALL EDGING ALONG CURBS OR WALKS.
- 21. ALL LANDSCAPE BEDS SHALL RECEIVE A TWO INCH (2") TOP DRESS LAYER OF HARDWOOD MULCH AND ALL TREE WELLS SHALL RECEIVE A THREE INCH (3") LAYER OF SHREDDED HARDWOOD MULCH. DO NOT COVER ROOT FLARE.
- 22. TOP OF MULCH SHALL BE 1/2" MINIMUM BELOW THE TOP OF WALKS AND CURBS.
- 23. TURF AREAS SHALL BE CLEAN OF DEBRIS AND RAKED (GRADED) SMOOTH PRIOR TO HYDROMULCH OR SOD INSTALLATION. LANDSCAPE CONTRACTOR TO RECEIVE GRADE WITHIN APPROX. 1/10th OF FINAL GRADE.
- 24. OWNER RESPONSIBLE TO PROVIDE ELECTRICAL SERVICE FOR THE IRRIGATION SYSTEM, WHICH INCLUDES A HARDWIRE OF 110 VOLTS AT MINIMUM FOR THE
- 25. ALL LANDSCAPING LOCATED WITHIN THE VISIBILITY TRIANGLES SHALL COMPLY WITH THE VISIBILITY TRIANGLE REQUIREMENTS AS PER THE CITY STANDARDS.
- 26. ALL LIGHT POLES MAY NOT BE SHOWN ON THE PROJECT SITE OR ADJACENT PROPERTIES. IF A PROPOSED TREE IS IN CONFLICT WITH ANY LIGHT OR UTILITY POLE, THE CONTRACTOR SHALL CONTACT THE LANDSCAPE
- ARCHITECT, TO DETERMINE OPTIONS, PRIOR TO PLANTING. 27. ALL PLANTS AND TREES ARE TO CONFORM TO AMERICAN ASSOCIATION OF NURSERYMEN AND TEXAS ASSOCIATION OF NURSERYMEN STANDARDS.
- 28. THE LANDSCAPE ARCHITECT RESERVES THE RIGHT TO REFUSE ANY LANDSCAPE

SP2024-008

APPROVED:

DATE:

4-26-24

I hereby certify that the above and foregoing site plan for a development in the City of Rockwall, Texas, was approved by the Planning & Zoning Commission of the City of Rockwall on the ______ day of MAY_____.

WITNESS OUR HANDS, this who day of May ... 2024.

Planning & Zoning Commission, Chairman



PLAN PREPARED BY: DON C. WHEELER, RLA PO BOX 470865 FT. WORTH, TX 76147 817, 335, 1405 don@dcwla.com

Sheet No.


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			P.O. Box			Fort Wo	orth, Texas 761		
		-	Office 817		<i>i</i>)		don@dcwla.co		

PROJECT NO.

2K22-45

EOFT 05/08/24

LANDSCAPE PLAN SMOOTHIE KING ROCKWALL DA Goliad Partners. L.P. CITY OF ROCKWALL, TEXAS

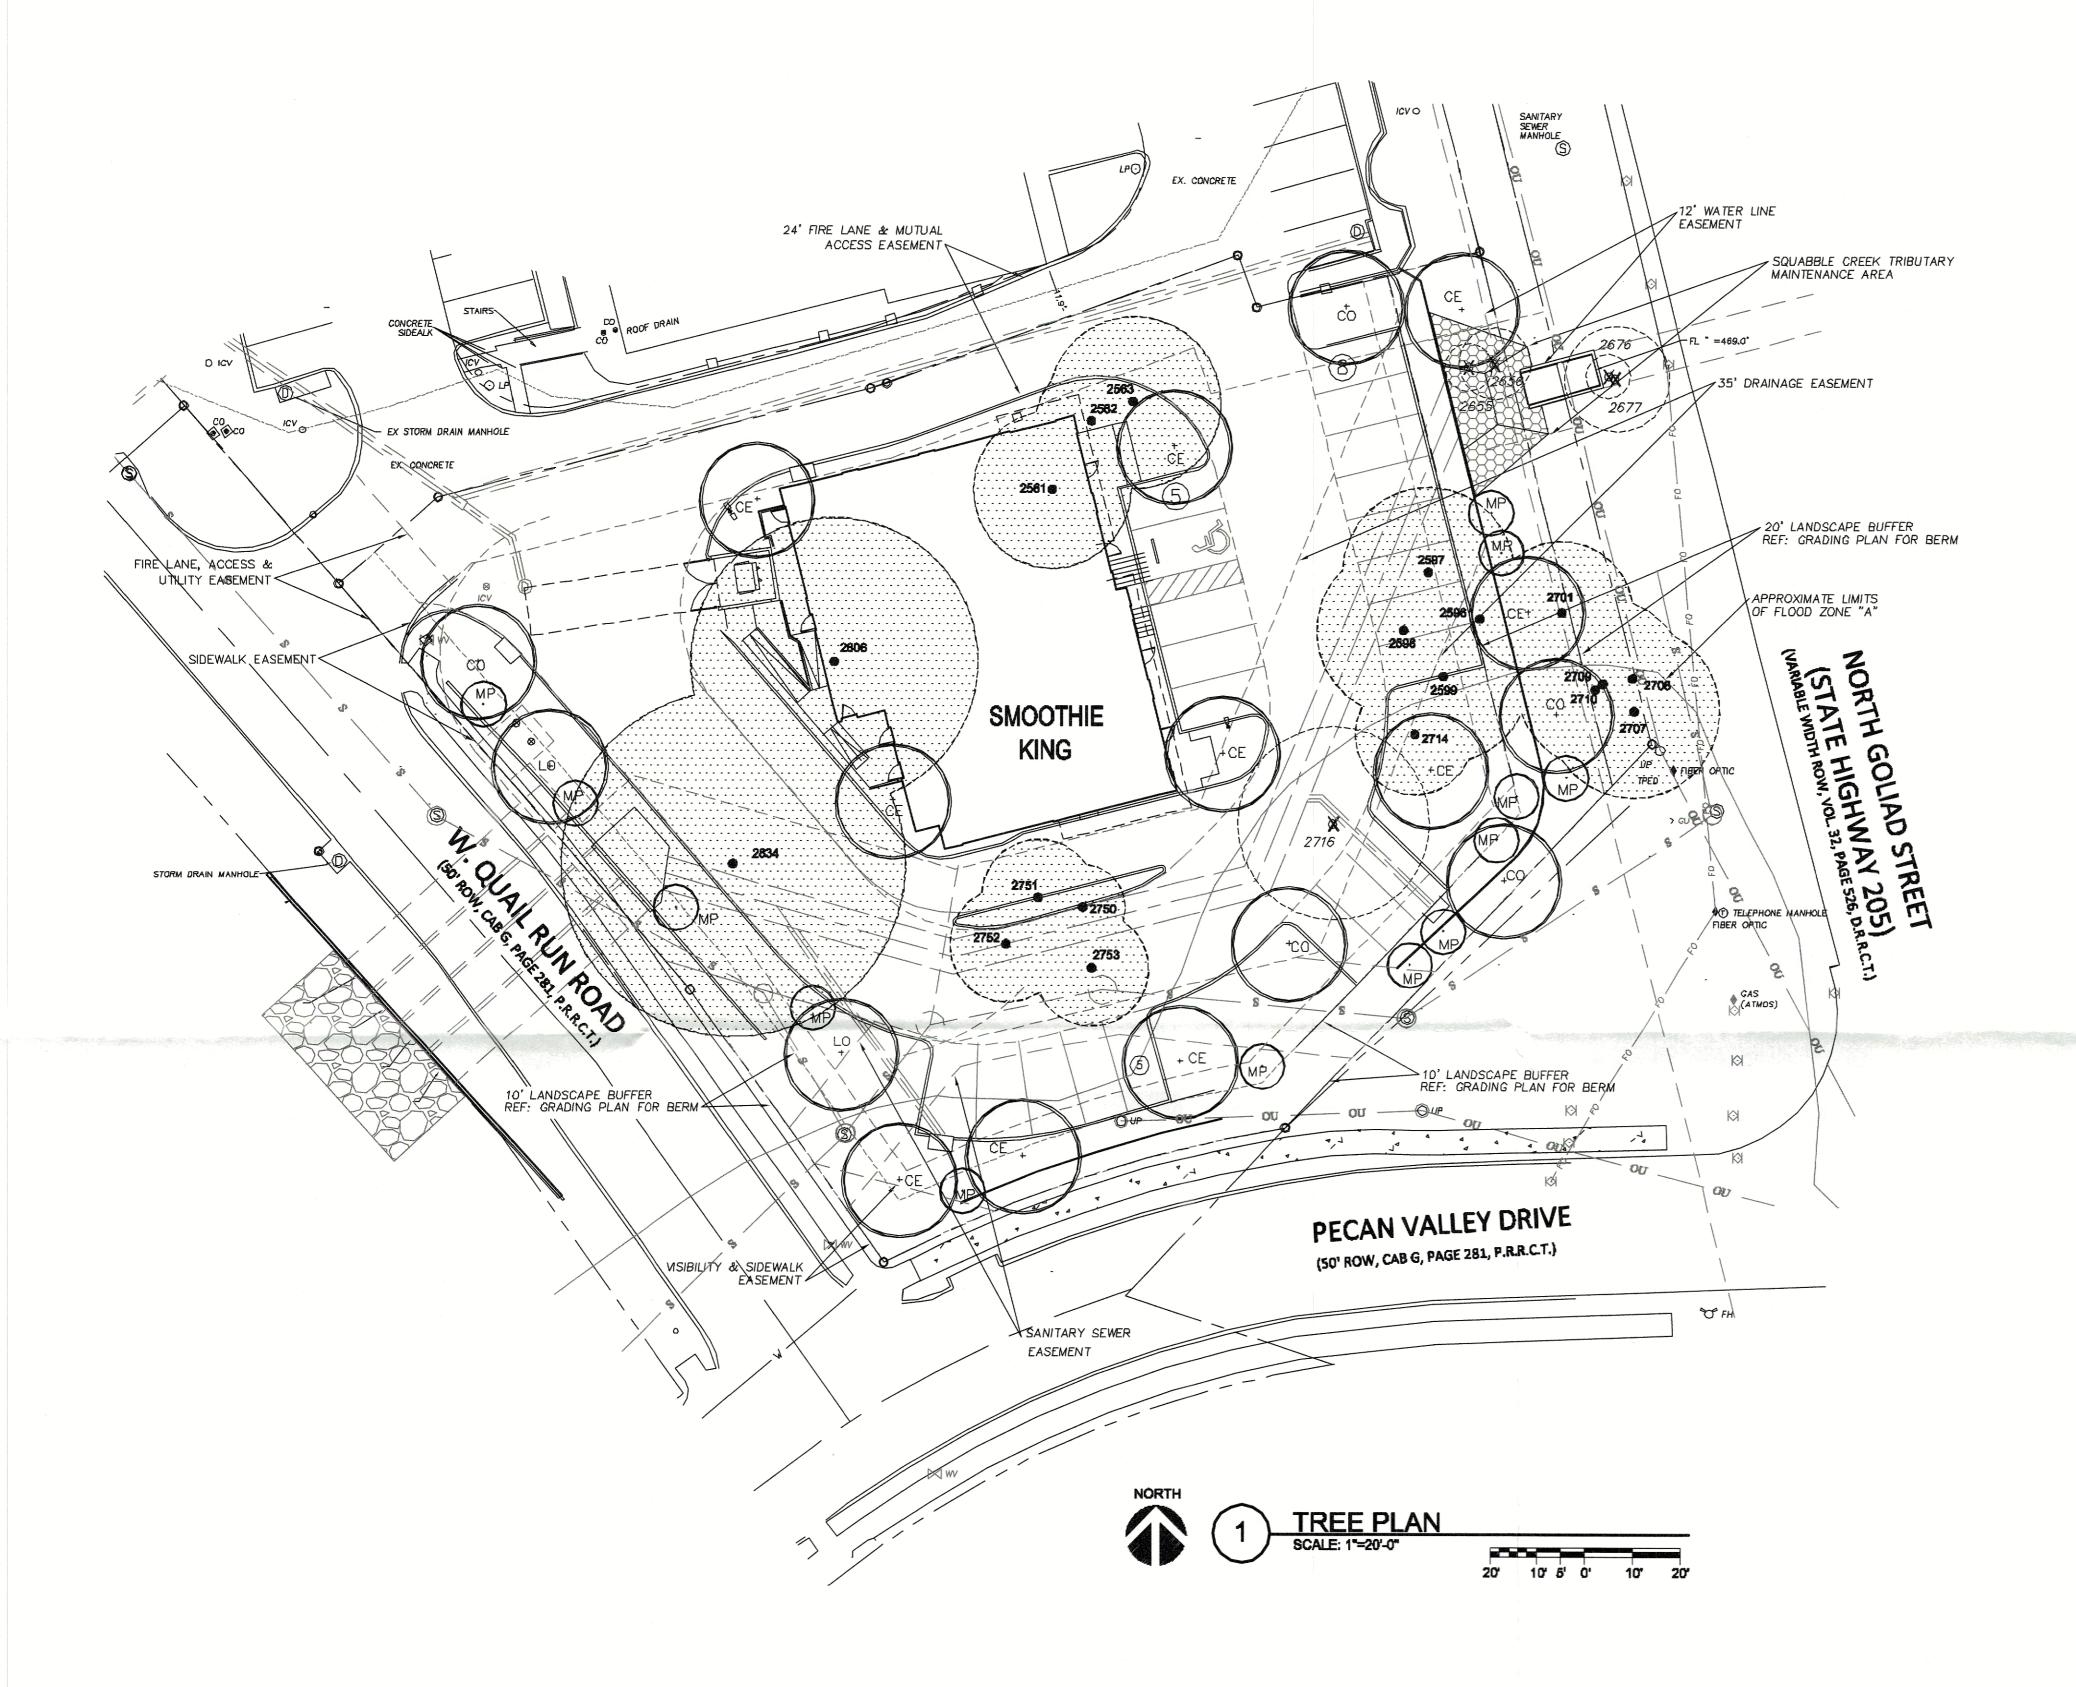

Course	Bearing	Distance
L 1	N 35*33*55" W	69.89
L 2	N 18*54'05" W	<i>37.43</i> ′
-		

Curve	Radius	Length	Delta	Chord	Chord Bear.
C 1	275.00'	<i>88.33</i> '	18 * 24'13"	87.95'	S 71°24'38" W

TREE LEGEND

(5) EXISTING TREES (NOT PROTECTED) TO BE REMOVED BUT NOT MITIGATED.



EXISTING PROTECTED TREES TO BE REMOVED AND MITIGATED.

17-NEW 5" TREES PLANTED = 85"

(10) CEDAR ELM ,CE, (5) CHINQUAPIN OAK 'CO' (2) LIVE OAK LO'

(13) MEXICAN PLUM 'MP'

EXISTING TREE SCHEDULE

#	SPECIE	CALIPER	PROTECT OR REMOVE	*TREE HEALTH (1-5)	*DISEASE (Y/N)	*INSECT (Y/N)	*STRUCTURAL (Y/N)	MITIGATION REQ'D (IN.)
2561	PECAN	22	REMOVE	4	N	N	N	22
2562	PECAN	16					· •	16
2563	PECAN	24	•	•			•	24
2596	PECAN	8				•	•	8
2597	PECAN	24						24
2598	PECAN	20				89	8	20
2599	PECAN	24		•			•	24
2655	CHINABERRY	6	•		pp.	89	•	0
2656	CHINABERRY	9	•	æ	17	10		o
2676	CHINABERRY	5				85		Õ
2677	CHINABERRY	15			**	10		ō
2701	PECAN	19	•			B	a	19
2707	PEÇAN	24	•		10	10		24
2708	PECAN	16	=		89	100	•	16
2709	PECAN	24		(* 1	10	SP		24
2710	PECAN	7		88			4	7
2714	PECAN	17	•		#	87	•	17
2716	BOIS D'ARC	27	• ,				•	0
2750	ELM	12			**	æ	•	12
2751	ELM	16		8				16
2752	ELM	16	•	葡			•	16
2753	ELM	16	•	•			•	16
2806	ELM	40	•					80
2834	ELM	48	•				•	96

"ASSUMED DUE TO LACK OF INFO PROVIDED ON TREE SURVEY.

TOTAL = 481°

(19) PROTECTED TREES TO MITIGATE = 481 INCHES LESS (17) NEW 5" TREES TO PLANT = 85 INCHES

SUB-TOTAL = 396 INCHES

396" x 20% = 79" x \$200 = \$15,800 PAID INTO TREE FUND. REMAINING INCHES TO MITIGATE = 396-79= 317.

317"/4" = (80) 4" TREES - PLANTED IN PARK.

APPROVED:

I hereby certify that the above and foregoing site plan for a development in the City of Rockwall, Texas, was approved by the Planning & Zoning Commission of the City of Rockwall on the ______ day of MAY___.

MINESS OUR HANDS, this ALT day of MAY , 2024. Planning & Zoling Commission, Chairman

Gillector of Planning and Zoning

\$P2024-008

TREE SURVEY BY: STOVALL & ASSOCIATES P.O. BOX 202 GREENVILLE, TEXAS 75403 PHONE (903) 450-1120 DON C. WHEELER, RLA PO BOX 470865 FT. WORTH, TX 76147 info@stovallassociates.com 817.335.1405 SEPT. 24, 2015 don@dcwla.com

TREE PLAN SMOOTHIE KING ROCKWALL

DA Goliad Partners. L.P. CITY OF ROCKWALL, TEXAS TP1

Sheet No.


PLAN PREPARED BY:

Don C. Wheeler
Landscape Architect
Landscape Architecture Planning Integration Design P.O. Box 470865 Fort Worth, Texas 76147 don@dcwla.com Office 817.335.1405

DATE: 12-15-2023

PROJECT NO. 2K22-45

REVISION

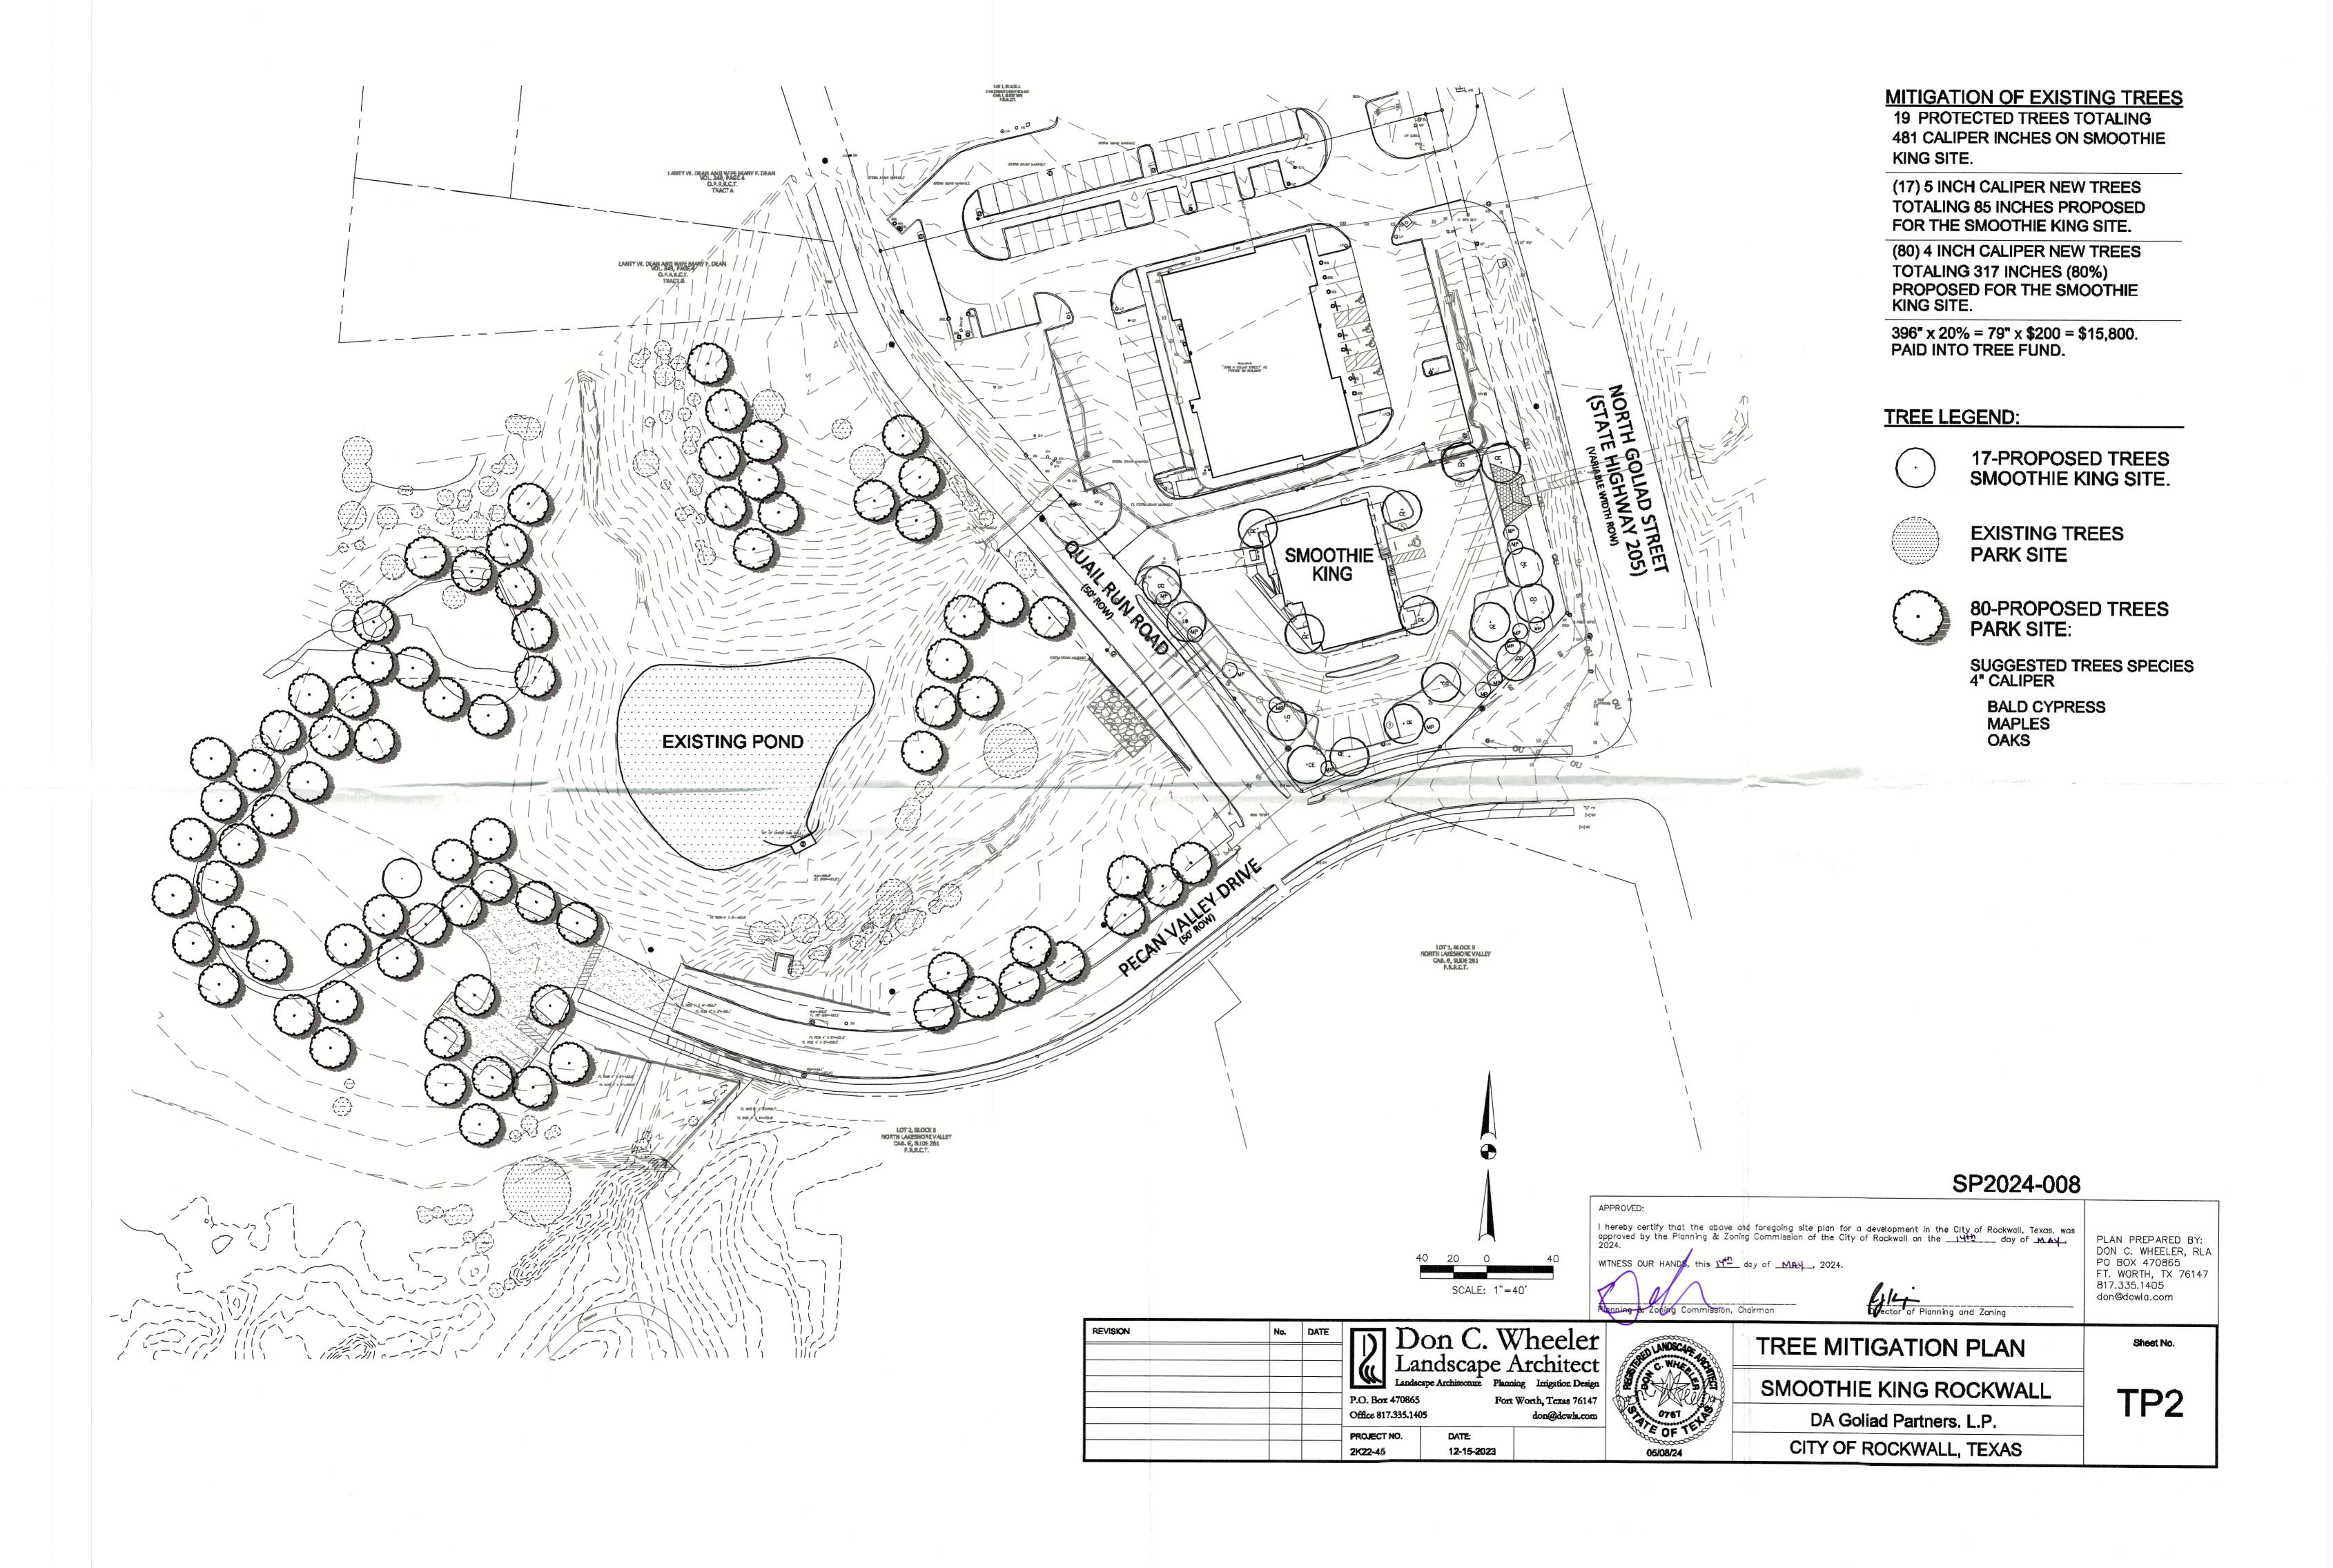

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-ASSUMED REFLECTANCE- OF CEILINGS, AS VALLS, AS FLOORS

-THIS CALCULATION IS BASED ON AN OPEN AREA. OBJECTS AND OBSTRUCTIONS VITHIN THIS AREA VILL AFFECT FINAL LIGHTING LEVELS.

-THE CALCULATED FOOTCAMBLE LEVELS INSICATE LUMBNAIRE PERFORMANCE BASED ON THE INFORMATION PROVIDED TO TEXAS LIGHTING SALES, INC. VE MAKE NO CLAIMS OF COMPLIANCE WITH ANY STATE OR LOCAL LIGHTING CODES.

-CALCULATIONS ARE PROVIDED USING INDUSTRY RECOGNISED SOFTWARE AND ARE PROVIDED FOR ESTIMATION PURPOSES ONLY. INPUT DATA FOR THE CALCULATIONS CORRESPONDS TO THE INFORMATION PROVIDED TO US (ASSUMPTIONS MAY BE MADE FOR INFORMATION THAT IS NOT PROVIDED). IT IS THE RESPONSIBILITY OF THOSE USING THIS SERVICE TO VERIFY OUR INPUT DATA IS CONSISTANT VITH EXPECTED FIELD CONDITIONS. RESULTS OF THE LIGHTING CALCULATIONS ACCURATELY REFLECT THE INPUT DATA HOVEVER, ACTUAL LIGHTING LEVELS VILL VARY REPENDING ON FIELD CONDITIONS SUCH AS ROOM CHARACTERISTICS, TEMPERATURE, VOLTAGE AND LAMP/BALLAST DUTPUT AND OTHER FACTORS. CALCULATIONS ARE ALSO SUBJECT TO THE LIMITATIONS OF THE SOFTWARE, DUE TO THE ABOVE CONSIDERATIONS, TEXAS LIGHTING SALES CANNOT GUARANTY THAT ACTUAL LIGHT LEVELS NEASURED IN THE FIELD VILL MATCH OUR INITIAL CALCULATIONS.

APF	ROVE	:D:						
								was approved by the
Planning	& Zoning C	ommission o	of the City of F	Rockwall on the	144	day of	MAY	_, 2024.
WITN	ESS O	JR HAN	DS, this	اط ^{ائ} day	of May	, 2	024.	
					1.	11:		
Dha	nning & for	ing Commics	ion , Chairma	an	- [7]	Director	of Planning a	nd Zoning

SITE PLAN SUBMITTAL

REVISION NO:		DATE:
Р	SHEET TITLE: HOTOMETRIC F	PLAN
SUITE	OWNER: CC ROCKWALL, LLC NORTH CENTRAL EXPRES 1300 DALLAS, TEXA BOSE 214-701-8455 chad@f	S 75206
1030 SUI	ARCHITECT: F. SOPRANZI, AIA, LEED-AF 00 NORTH CENTRAL EXPRE TE 450 DALLAS, TEXA PRANZI 817-903-6663 dons(SSWAY, AS 75231
	e e e e e e e e e e e e e e e e e e e	CASE NUMBER:
SCALE: 1" = 10'-0"		SP 2024-008

